SUBMITTAL INFORMATION

GENERAL NOTES

CALIFORNIA STATE:

CODES: 2013 CALIFORNIA RESIDENTIAL BLDG. CODE

> 2013 CALIFORNIA MECHANICAL CODE 2013 CALIFORNIA PLUMBING CODE 2013 CALIFORNIA ELECTRIC CODE

2013 CALIFORNIA ENERGY CODE (TITLE 24) 2013 CALIFORNIA GREEN BUILDING STDS. CODE

DESIGN CRITERIA

BUILDING TYPE: OCCUPANCY CATAGORY: SEISMIC DESIGN CATAGORY:

CONSTRUCTION TYPE: VB SPRINKLER PROTECTED

NOTE: BUILDING IS FIRE SPRINKLERED AND THE INSPECTIONS BY THE AHJ OF THE SPRINKLER SYSTEM INCLUDING A ROUGH INSPECTION AT FRAME INSPECTION AND A FINAL INSPECTION SHALL BE COMPLETED AND APPROVED PRIOR TO REQUESTING THE

CORRESPONDING BUILDING INSPECTION.

GRAVITY LOAD PARAMETERS

TOTAL 40 PSF ROOF LOAD: 55 PSF FLOOR LOAD: WALL (INT): 15 PSF WALL (EXT);

WIND DESIGN SREED:

110 MPH (EXPOSURE C)

ROOF PITCH: 10/12, 3/12

SUBMITTAL DWG. INDEX

C1 - COVER PAGE

E1 - ELEVATIONS E2 - ELEVATIONS

A1 - MAIN LEVEL FLOORPLAN

A2 - UPPER LEVEL FLOORPLAN EL1 - MAIN LEVEL ELECTRIC LAYOUT

EL2 - UPPER LEVEL ELECTRIC LAYOUT

P1 - PLUMBING INFORMATION

P2 - DWV/PLUMB SUPPLY SCHEMATICS

SE1 - SECTIONS AND DETAILS

SUBMITTAL TITLE 24 INDEX SUPPLIED BY PLANT



ILLUSTRATION SHOWN FOR REFERENCE ONLY

CALIFORNIA (WILDLAND-URBAN INTERFACE)

HOME WILL BE PLACED IN FIRE HAZARD SEVERITY ZONE SEE CBC NOTES FROM CHAPTER 7A ON PAGE E1

SUBMITTAL STRUCTURAL INDEX

SCS - STRUCTURAL COVER SHEET

SN1 - STRUCTURAL GENERAL NOTES

STRUCTURAL GENERAL NOTES

S1 - GARAGE FOUNDATION PLAN

S2 - GARAGE FRAMING PLAN

MODULAR FOUNDATION PLAN

1ST FLOOR FRAMING PLAN

S5 - LOWFLOOR/CEILING FRAMING PLAN

2ND FLOOR FRAMING PLAN

2ND FLOOR ROOF/CEILING FRAMING PLAN

ROOF CAP FRAMING PLAN

STRUCTURAL FOUNDATION DETAILS

STRUCTURAL FOUNDATION DETAILS

SD2 - STRUCTURAL GENERAL DETAILS

MODULAR FLOOR DETAILS

SD4 - STRUCTURAL ROOF DETAILS

SD5 - MISCELLANEOUS DETAILS

STRUCTURAL DESIGN BY: INNOVATIVE STRUCTURAL ENGINEERING P.E. SEALED BY: - SHAWN LOTHROP

THIS HOME AND ALL ITS ENTIRETY SHALL BE BUILT TO THE TO THE HCD REQUIREMENTS OF THE FACTORY-BUILT HOUSING PROGRAM IN THE FACTORY AND ON-SITE

STATE AND THIRD PARTY LABELS ON PAGE A1 & A2


SUBMITTAL SPRINKLER INDEX

SUPPLIED BY PLANT

SUBMITTAL HVAC INDEX

SUPPLIED BY PLANT

PLANT LOCATION: SKYLINE HOMES 1720 E. BEAMER STREET WOODLAND, CA. 95776

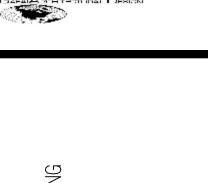

DEVELOPMENT

1689 DALEWOOD COURT FAIRFIELD, CA 94534 (707) 429.3300

SUBMITTAL CONSULTANT:

GAEA DESIGN
POWER HOUSE DESIGN GROUP
6608 DEVON DRIVE
LIBERTY TOWNSHIP, OH 45044
(513) 444.0519

MANUFACTURER:

DRAWN BY: LCL DATE: 8.10.16 SCALE: NONE NO: DATE: DESCRIPTION: 1. 10.5.16 REDLINES

APPROVAL STAMPS:

SHEET TITLE

COVER SHEET



TO THESE PLANS. ANY PLAN SET WHICH DOES NOT INCLUDE AN ATTACHMENT ENTITLED SET-UP INSTRUCTIONS IS INCOMPLETE. IN ADDITION TO THE SET-UP THE FOLLOWING INSTRUCTIONS AND/OR INSTALLATIONS ARE SPECIFIED AND/OR REQUIRED IF APPLICABLE TO PROPERLY INSTALL THE BUILDING.

- 1. ON-SITE RAMPS, STAIRS AND GENERAL ACCESS TO THE BUILDING.
- 2. THE COMPLETED FOUNDATION SUPPORT SYSTEM, TIEDOWNS, AND/OR ANCHORAGE SYSTEMS.
- 3. ON-SITE FASTENINGS AT THE FLOOR AND ROOF RIDGE AT MATE LINES. 4. ON-SITE INSTALLATION OF INSULATION AT MATE LINES FOR FLOORS, CEILINGS AND ENDWALLS.
- 5. ALL EXPOSED ON-SITE PLUMBING (IE: CRAWL SPACE) SHOULD BE INSULATED TO PROTECT FROM FREEZING.
- 6. ATTIC VENTILATION (MIN. 1/150) ACHIEVED BY RIDGE AND GABLE VENT (SITE INSTALLED). VENTILATION OF THE LOWER 1/2 OF ATTIC SPACE WILL BE MET THROUGH GABLE VENTS.
- 7. ON-SITE ELECTRICAL, PLUMBING, AND GAS INTERMODULE CONNECTIONS.
- 8. BUILDING DRAINS, CLEANOUTS, HOOK-UPS TO ON-SITE PLUMBING SYSTEMS. 9. ON-SITE HVAC INTERMODULE DUCT AND SYSTEM CONNECTIONS.
- 10. ON-SITE COMPLETION OF ROOF.
- 11. ON-SITE CONSTRUCTION OF COVERED PORCH(ES).
- 12. IF GUTTERS ARE INSTALLED BY MFG. OR SITE INSTALLED THEY SHALL ALSO HAVE GUTTER COVERS INSTALLED.
- 13. ON-SITE COMPLETION OF STAIRS IF APPLICABLE

ELEVATION NOTES:

IF APPLICABLE, HANDICAP RAMP(S), STAIR(S), AND HANDRAILS ARE SITE INSTALLED, DESIGNED BY OTHERS AND SUBJECT TO LOCAL CODES. THIS STRUCTURE IS A MODULAR (FACTORY BUILT) BUILDING WHICH IS TO BE CONSTRUCTED AND INSPECTED IN ACCORDANCE WITH AN APPROVED THIRD PARTY QUALITY ASSURANCE PROGRAM TO INSURE COMPLIANCE WITH THE REFERENCED CODES.

ALL ROOFING, VENTILATION, SOFFIT, EAVES AND DECKING THAT WILL BE SITE INSTALLED WILL MEET ALL FIRE RATING REQUIREMENTS.

HCD GIVES AUTHORITY TO THE APPROVED THIRD PARTY INSPECTOR TO HAVE JURISDICTION OVER PLAN APPROVALS AND PLAN INSPECTORS. THIRD PARTY STAMPED PLANS ARE FINAL AND CANNOT BE SUBJECT TO CHANGE BY OTHER AGENCIES.



CHAPTER 7A WUIC GUIDELINES NOTES:

ROOFS AND ROOF EDGES A NONCOMBUSTIBLE (TILE OR METAL) OR CLASS "A" ROOFING ASSEMBLY AREA IS REQUIRED
IN SRA OR LRA - VERY HIGH SEVERITY ZONES. CLASS "B" ROOFING ASSEMBLIES ARE REQUIRED
IN ALL OTHER AREAS IN SANTA CRIZ COUNTY. IN ALL OTHER AREAS IN SANTA CRUZ COUNTY.
WHERE THE ROOF PROFILE ALLOWS A SPACE BETWEEN THE ROOF COVERING AND THE ROOF
DECKING, THE SPACES SHALL: BE CONSTRUCTED TO PREVENT THE INTRUSION OF FLAMES
EMBERS, BE FIRESTOPPED WITH APPROVED MATERIAL, OR HAVE ONE LAYER OF NO. 72 CAP
SHEET INSTALLED OVER THE COMBUSTIBLE DECKING.
WHERE PROVIDED, VALLEY FLASHING MUST BE NOT LESS THAT 26 GAUGE GALVANIZED SHEET
METAL OVER A 36" WIDE NO. 72 ASTM CAP SHEET.

ROOF EAVE CONSTRUCTION AND ATTIC VENTS/ROOF VENTS -NO VENTS ARE ALLOWED IN EAVES OR CORNICES. EAVES AND SOFFITS MUST BE IGNITION-RESISTANT OR NONCOMBUSTIBLE.

EXTERIOR WALLS/SIDING NONCOMBUSTIBLE (NO METAL OR VINYL SIDING UNLESS APPROVED), LISTED IGNITION-RESISTANT
MATERIAL, HEAVY TIMBER, OR LOG WALL CONSTRUCTION ALLOWED.
EXTERIOR WALL VENT OPENINGS MUST RESIST THE INTRUSION OF FLAME AND EMBERS OR MUST BE 1/4" CORROSION-RESISTANT, NONCOMBUSTIBLE WIRE MESH OR EQUIVALANT.

WINDOWS AND EXTERIOR DOORS -WINDOWS AND EXTERNIOR BOOKS
WINDOWS MUST BE INSULATED GLASS WITH A MINIMUM OF 1 TEMPERED PANE OR GLASS BLOCK.
EXTERNOLOGY DATA NATION

DECKING, SURFACES, STAIR TREADS, RISERS AND LANDINGS -DECKING, SON ACES, STAIN TREADS, RISERS AND LANDINGS DECKS, PORCHES AND BALCONY SURFACES WITHIN 10 FEET OF THE PRIMARY STRUCTURE MUST
BE CONSTRUCTED OF NONCOMBUSTIBLE, FIRE RETARDANT TREATED OR HEAVY TIMBER
CONSTRUCTION. ALTERNATE MATERIALS CAN BE USED IF THEY ARE IGNITION-RESISTANT AND PASS
PERFORMANCE REQUIREMENTS SPECIFIED BY THE STATE FIRE MARSHALL.

UNDERFLOOR PROTECTION -THE UNDERSIDE OF CANTILEVERED AND HANGING DECKS, BALCONIES AND SIMILAR APPENDAGES MUST MAINTAIN THE SAME IGNITION-RESISTANCE OF EXTERIOR WALLS OR BE ENCLOSED TO GRADE. NOTE: IGNITION RESISTANT MATERIALS ARE THOSE TESTED BY A FACILITY RECOGNIZED BY THE STATE FIRE MARSHALL OR ICC-EVALUATION SERVICE TO HAVE A FLAME SPREAD RATING NOT OVER 25, AND COMPLY WITH ACCELERATED WEATHERING TESTS.

MANUFACTURER:

1689 DALEWOOD COURT FAIRFIELD, CA 94534 (707) 429.3300


SUBMITTAL CONSULTANT: GAEA DESIGN
POWER HOUSE DESIGN GROUP
6608 DEVON DRIVE
LIBERTY TOWNSHIP, OH 45044
(513) 444.0519



DRAWN BY: LCL DATE: 6.16.16 SCALE: NONE REVISIONS: NO: DATE: DESCRIPTION: REDLINES 2. | 8.3.16 GARAGE 3. | 9.25.16 SIDING CHANGES 4. | 10.18.16 | GARAGE APPROVAL STAMPS:

SHEET TITLE FRONT & LEFT ELEVATIONS



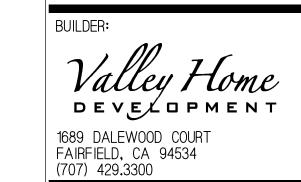

SUBMITTAL CONSULTANT:
GAEA DESIGN
POWER HOUSE DESIGN GROUP
6608 DEVON DRIVE
LIBERTY TOWNSHIP, OH 45044
(513) 444.0519



PROJECT NAME: NEW CONSTRUCTION FOR CHARLES ARMSTRONG


DRAWN BY: LCL DATE: 7.13.16 SCALE: 1/4" = 1'-0" REVISIONS: NO: DATE: DESCRIPTION: 1. 7.21.16 DORMER 2. 8.3.16 GARAGE 2. 9.25.16 SIDING CHANGES						
SCALE: 1/4" = 1'-0" REVISIONS: NO: DATE: DESCRIPTION: 1. 7.21.16 DORMER 2. 8.3.16 GARAGE	DRAWN BY: LCL					
REVISIONS: NO: DATE: DESCRIPTION: 1. 7.21.16 DORMER 2. 8.3.16 GARAGE	DATE	: 7.13.16				
NO: DATE: DESCRIPTION: 1. 7.21.16 DORMER 2. 8.3.16 GARAGE	SCALE	=: 1/4" = 1 ⁻	'-0"			
1. 7.21.16 DORMER 2. 8.3.16 GARAGE	REVIS	IONS:				
2. 8.3.16 GARAGE	NO:	DATE:	DESCRIPTION:			
	1.	7.21.16	DORMER			
2. 9.25.16 SIDING CHANGES	2.	8.3.16	GARAGE			
	2.	9.25.16	SIDING CHANGES			

APPROVAL STAMPS:

SHEET TITLE
RIGHT & REAR
ELEVATIONS

DRAWING NUMBER

F2

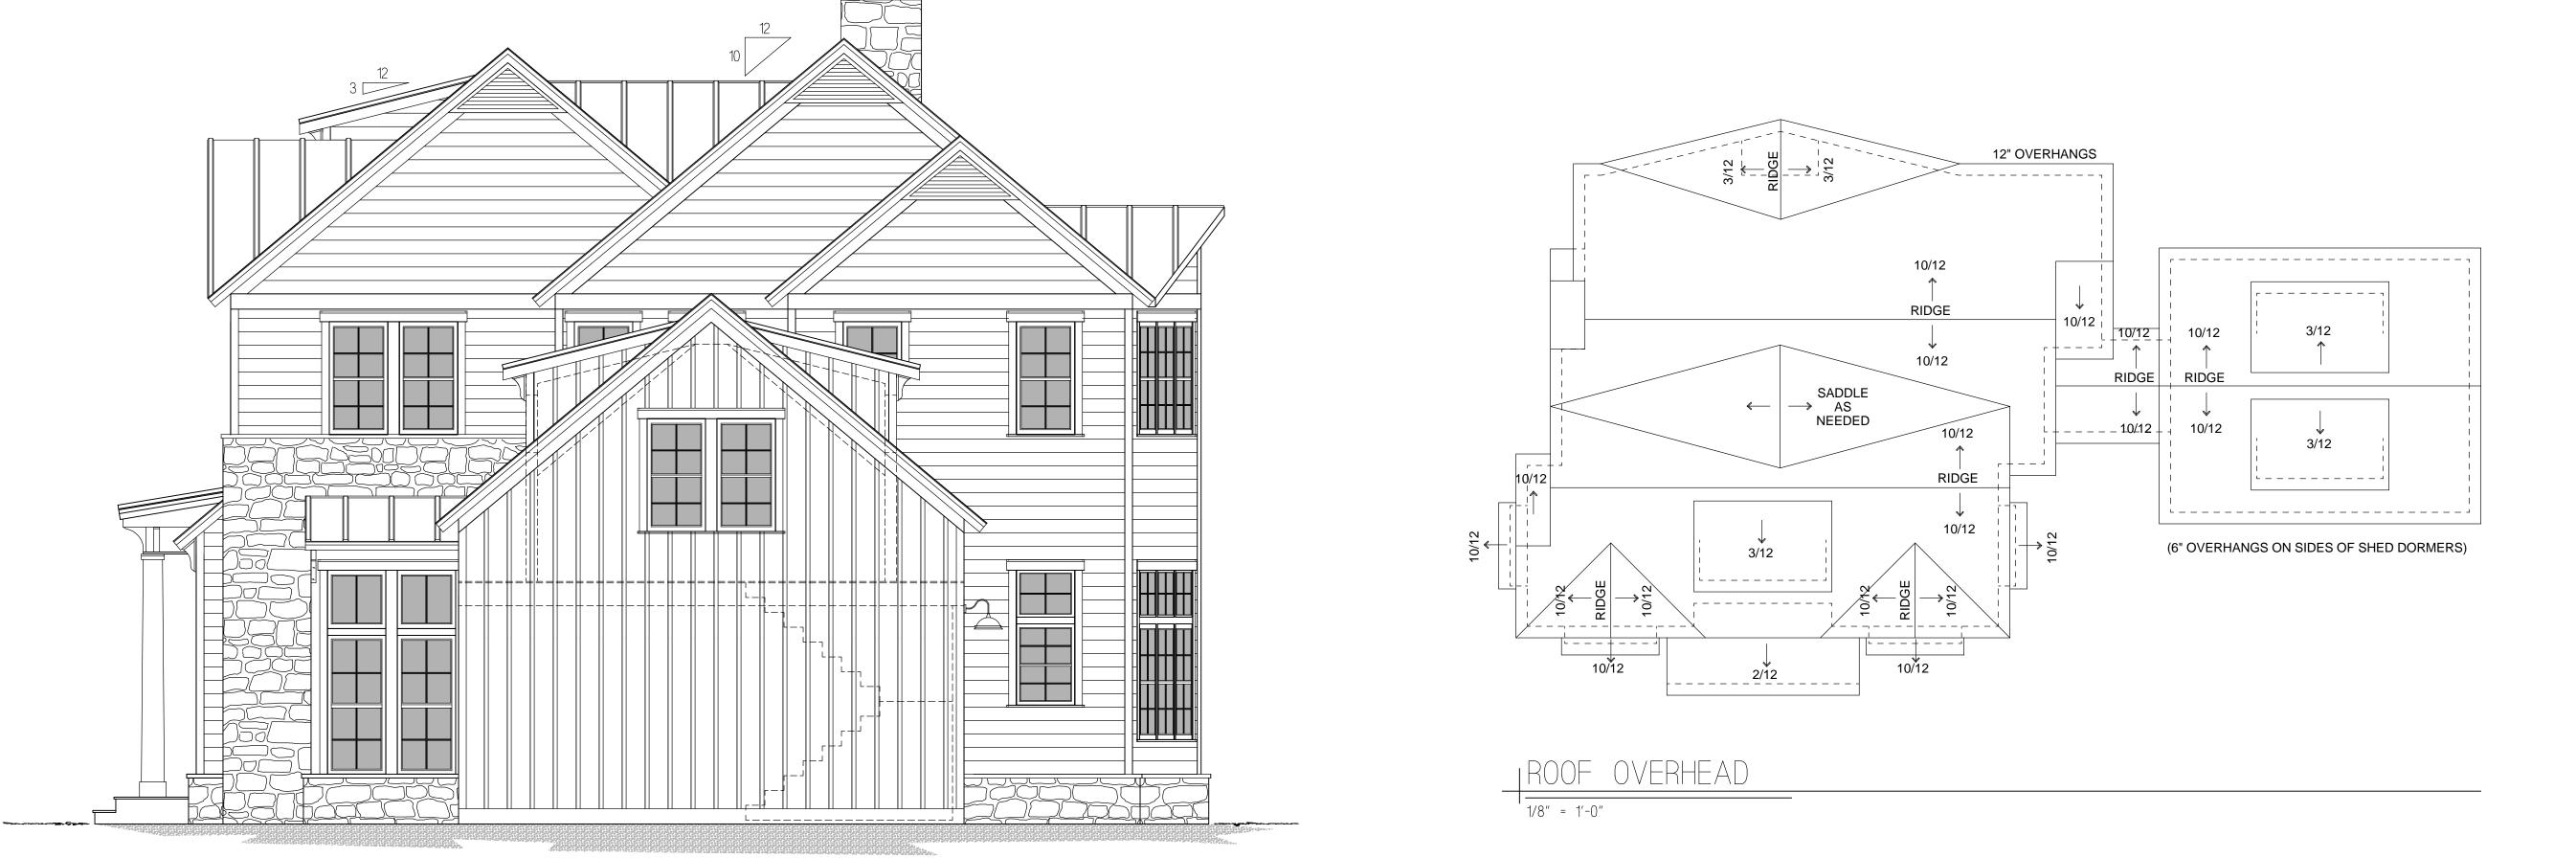





1. LABELS PER PRINT.

2. THE SUPPORT AND FIRE STOPPING FOR FLUES AND DUCTS FOR SITE INSTALLED HEATING SYSTEMS, WATER HEATERS, FIREPLACES, ETC. SHALL BE INSTALLED BY OTHERS.

3. THIS HOME MAY BE BUILT PARTIALLY OR COMPLETELY REVERSED.

4. ALL HALLWAYS ARE 36" MIN. IN WIDTH.

5. FURNACE, WATER HEATER, AND VENTS MAY BE SITE INSTALLED. (COMBUSTION AIR & FRESH AIR TO BE SUPPLIED ON SITE BY OTHERS.

6. ALL FIREPLACES TO BE INSTALLED PER MANUFACTURERS SPECIFICATIONS AND BE PROVIDED WITH GLASS DOORS.

7. ALL HOSE BIBS AND LAWN SPRINKLER SYSTEMS SHALL HAVE BACKFLOW PREVENTION DEVICES.

8. ALL SHOWER AND BATHTUB SLIDING OR SWINGING DOORS SHALL BE TEMPERED.

9. PROVIDE OUTSIDE COMBUSTION AIR AT EXTERIOR WALL AT ALL FIREPLACES.

10. BATHTUB AND SHOWER FLOORS AND WALLS SHALL BE FINISHED WITH A NONABSORBENT SURFACE UP TO A HEIGHT OF 6'-0" ABOVE THE FLOOR PER CRC 307.2.

11. EXTERIOR LIGHTS MAY BE SHIPPED LOOSE FOR ON-SITE INSTALLATION BY OTHERS.

12. SIDING FOR ENDS IS SHIPPED LOOSE FOR ON-SITE INSTALLATION BY OTHERS.

13. BOTTOM ROW OF SIDING MAY BE SHIPPED LOOSE FOR ON-SITE INSTALLATION BY OTHERS.

14. SMOKE ALARMS/DETECTORS SHALL BE HARDWIRED INTERCONNECTED, AND HAVE BATTERY BACK-UP.

DETAIL NOTES:

1. CROWN MOLDING THROUGHOUT


2. BATHROOM FLOORS TO BE HERRINGBONE TILE

3. GAS FIREPLACE SHALL BE PROPANE FUELED

. STONE AT ENTRY WILL WRAP THE TWO INTERIOR WALLS

5. SMALL GOOSENECK LIGHTS AND HORIZONTAL PANELING ON INSIDE OF BUILDOUTS (LIGHTS ON

EACH SIDE) 6. PANELED WALL IN STAIRWELL AND IN MASTER BEDROOM AS NOTED.

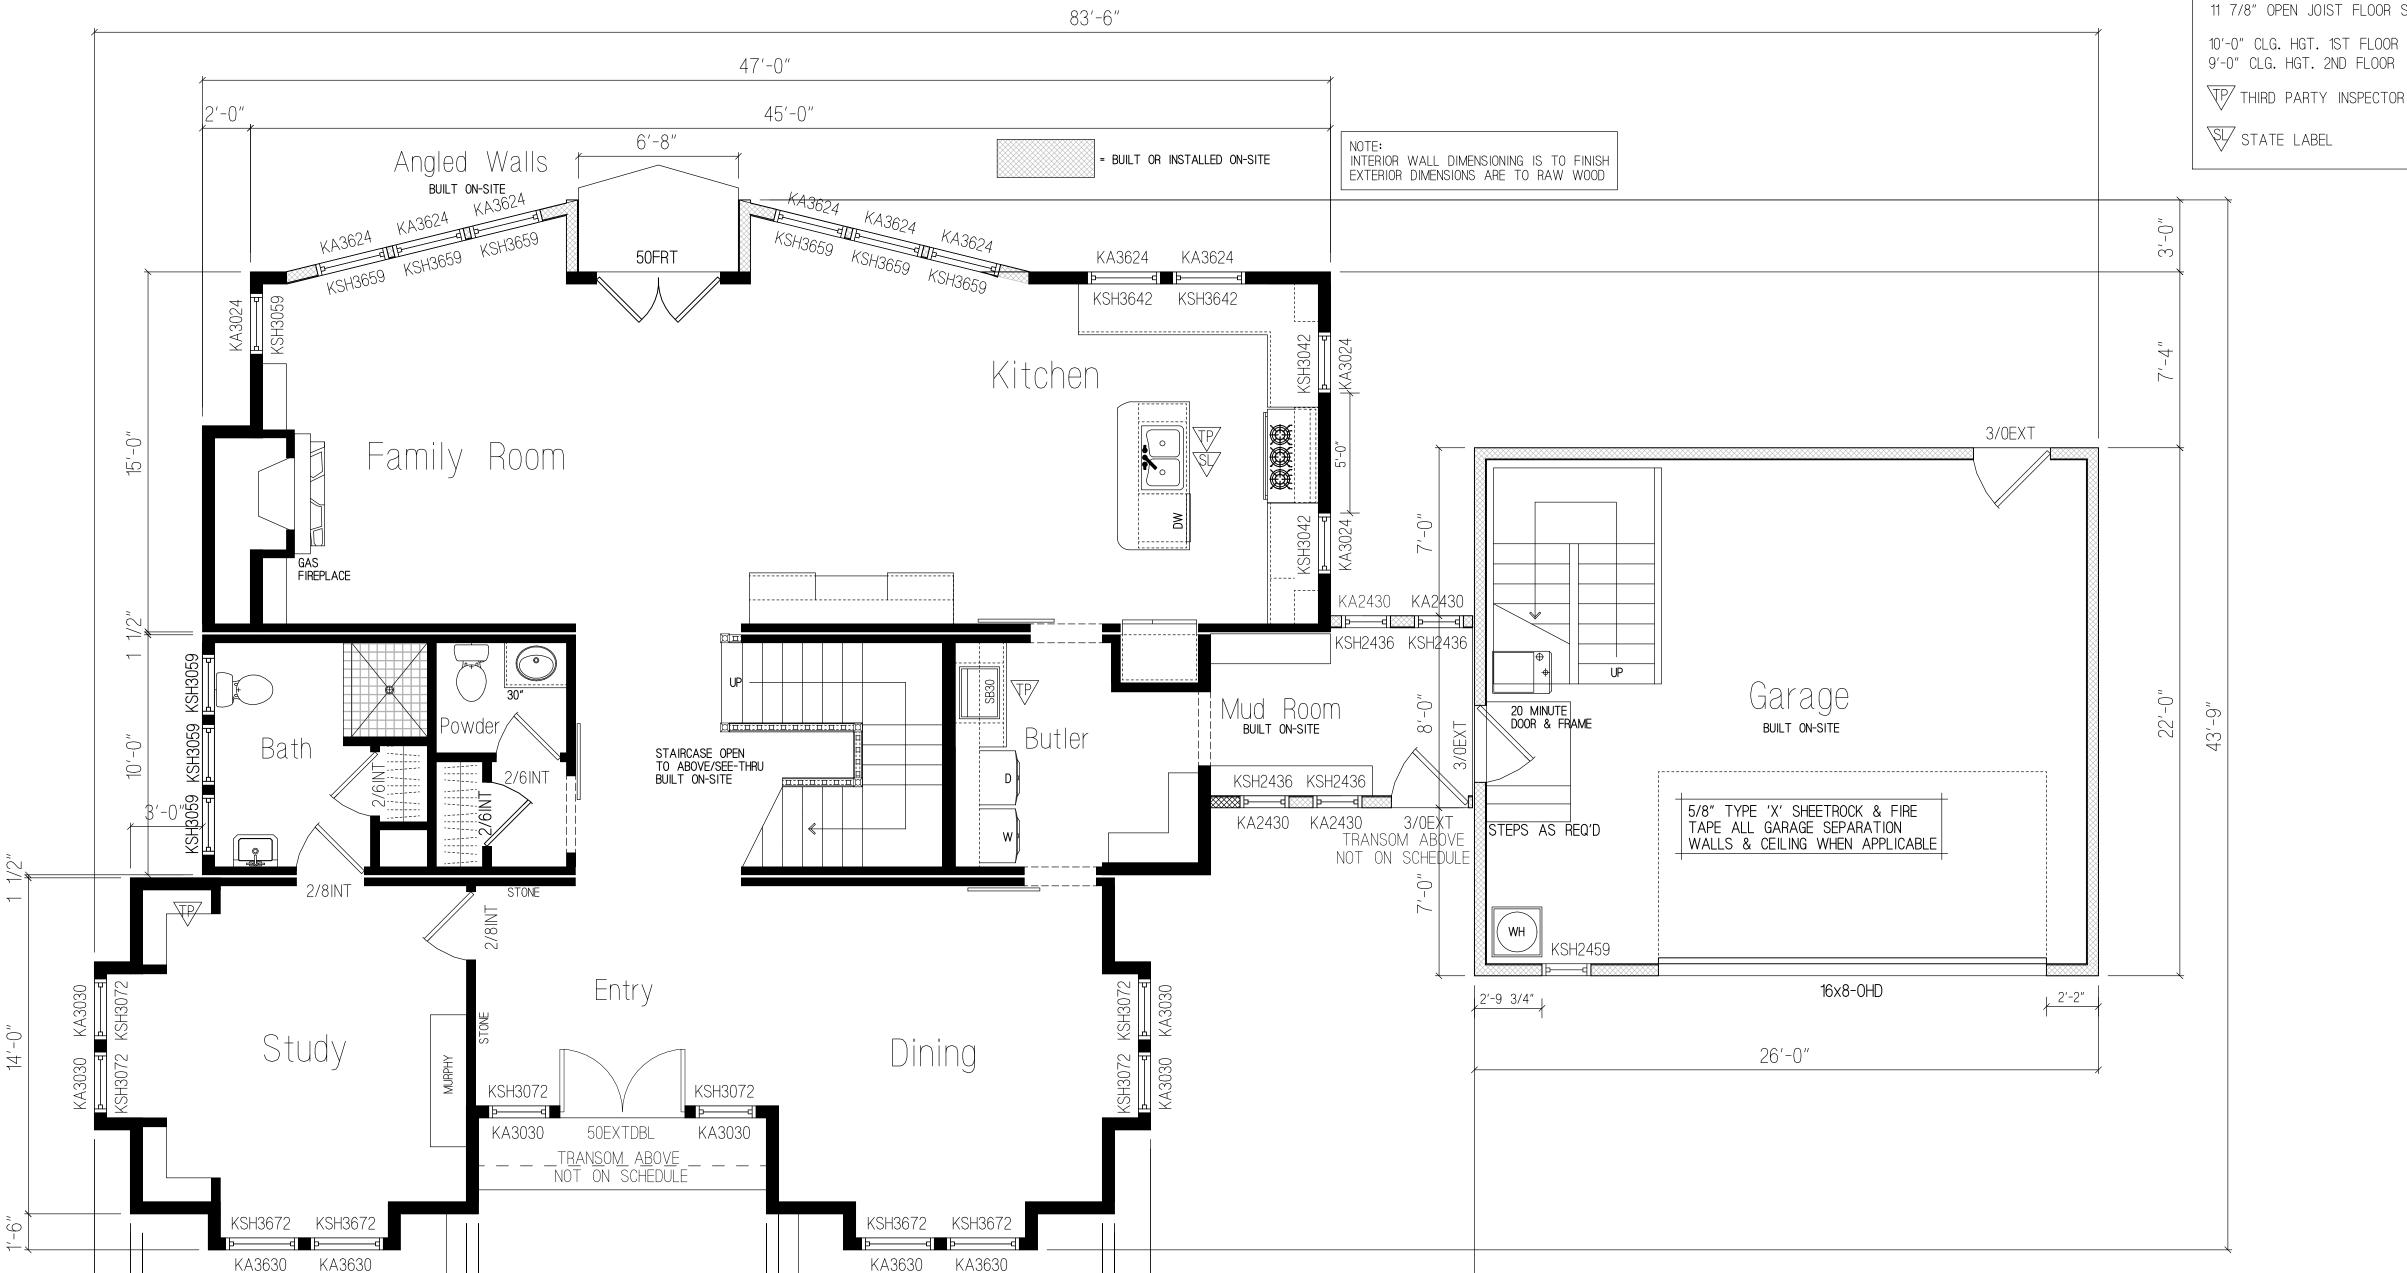

IMAIN LEVEL PLAN

13'-6"

1,729.84 MAIN FLOOR SQ. FT. LIVING AREA 1,667 UPPER FLOOR SQ. FT. LIVING AREA 3,396.84 TOTAL SQ. FT. LIVING AREA 85 SQ. FT. MUD ROOM 572 SQ. FT. GARAGE

12'-0"

41'-0"

44'-0"

13'-6"

ROUGH OPENING SIZES ARE LISTED ON SCHEDULE ALL EXTERIOR GARAGE DOORS WILL BE FACTORY LABELED FOR A MIN. 20 MIN. FIRE RATING ESCAPE OR RESCUE WINDOWS SHALL HAVE A MINIMUM NET CLEAR OPENABLE AREA OF 5.7 SQ, FT., 5'-0" SQ. FT. ALLOWABLE AT GRADE. THE MINIMUM NET CLEAR OPENABLE
HEIGHT DIMENSION SHALL BE 24 INCHES. THE NET CLEAR
OPENABLE WIDTH SHALL BE 20 INCHES. FINISH SILL HEIGHT
SHALL BE NOT MORE THAN 44 INCHES ABOVE THE FINISHED FLOOR.

13'-6"

NAME	TYPE	QTY.	WIDTH	HEIGHT	HEADER HEIGHT	DESCRIPTION
16x8-0HD	EXTERIOR DOOR	1	16'-2"	8'-2"	8'-2"	16' X 8' OVERHEAD DOOR
3/0EXT	EXTERIOR DOOR	2	3'-2 1/2"	6'-11 1/4"	6'-11 1/4"	3-0 EXTERIOR DOOR GARAGE
3/0EXT	EXTERIOR DOOR	1	3'-2 1/2"	6'-11 1/4"	6'-11 1/4"	3-0 EXTERIOR DOOR
50EXTDBL	EXTERIOR DOOR	1	5'-2 1/2"	6'-11"	6'-11"	6-0 EXTERIOR DOUBLE ENTRANCE DOORS
50FRT	EXTERIOR DOOR	1	5'-2"	9'-3 1/2"	9'-3 1/2"	5'-0" EXTERIOR FRENCH DOORS W/TRANSOMS
2/6INT	INTERIOR DOOR	3	2'-8"	6'-10 1/2"	6'-10 1/2"	2'-6" INTERIOR SWINGING DOOR
2/8INT	INTERIOR DOOR	2	2'-10"	6'-10 1/2"	6'-10 1/2"	2'-8" INTERIOR SWINGING DOOR
KA2430	WINDOW	4	2'-1/2"	2'-6 1/2"	9'-3 1/2"	KINRO AWNING
KA3024	WINDOW	3	2'-6 1/2"	2'-1/2"	9'-3 1/2"	KINRO AWNING
KA3030	WINDOW	6	2'-6 1/2"	2'-6 1/2"	9'-3 1/2"	KINRO AWNING
KA3624	WINDOW	8	3'-1/2"	2'-1/2"	9'-3 1/2"	KINRO AWNING
KA3630	WINDOW	4	3'-1/2"	2'-6 1/2"	9'-3 1/2"	KINRO AWNING
KSH2436	WINDOW	4	2'-1/2"	3'-1/2"	6'-5 1/2"	KINRO SINGLE HUNG
KSH2459	WINDOW	1	2'-1/2"	4'-10 7/8"	8'-3"	KINRO SINGLE HUNG GARAGE
KSH3042	WINDOW	2	2'-6 1/2"	3'-6 1/2"	6'-11 1/2"	KINRO SINGLE HUNG
KSH3059	WINDOW	1	2'-6 1/2"	4'-10 7/8"	6'-11 1/2"	KINRO SINGLE HUNG
KSH3059	WINDOW	3	2'-6 1/2"	4'-10 7/8"	9'-3 1/2"	KINRO SINGLE HUNG
KSH3072	WINDOW	6	2'-6 1/2"	6'-1/2"	6'-5 1/2"	KINRO SINGLE HUNG WINDOW
KSH3642	WINDOW	2	3'-1/2"	3'-6 1/2"	6'-11 1/2"	KINRO SINGLE HUNG
KSH3659	WINDOW	6	3'-1/2"	4'-10 7/8"	6'-11 1/2"	KINRO SINGLE HUNG
KSH3672	WINDOW	4	3'-1/2"	6'-1/2"	6'-5 1/2"	KINRO SINGLE HUNG WINDOW

ROUGH OPENING SCHEDULE

MANUFACTURER:

11 7/8" OPEN JOIST FLOOR SYS. STD. DEVELOPMENT

THIRD PARTY INSPECTOR INSIGNIA

FLOOR: 15'-0" x 47'-0"

10'-0" × 42'-0" 15'-6" × 44'-0"

15'-0" × 45'-0"

10'-0" × 42'-0"

 $14'-0'' \times 41'-0''$

SUBMITTAL CONSULTANT: GAEA DESIGN POWER HOUSE DESIGN GROUP 6608 DEVON DRIVE LIBERTY TOWNSHIP, OH 45044 (513) 444.0519

1689 DALEWOOD COURT

FAIRFIELD, CA 94534 (707) 429.3300



DRAWN BY: LCL					
DATE	: 4.19.16				
SCALE: NONE					
REVIS	SIONS:				
NO:	DATE:	DESCRIPTION:			
1.	5.4.16	REDLINES			
2.	5.17.16	REDLINES			
3.	6.26.16	WINDOWS			
4.	7.1.16	WINDOWS/STAIRS			
5.	7.18.16	WINDOWS			
6.	8.2.16	GARAGE			
7.	10.5.16	DETAILS			
APPR	OVAL STAM	IPS:			

SHEET TITLE MAIN LEVEL FLOORPLAN

DRAWING NUMBER

LEVEL A



KSH3659 KSH3659

13'-6"

14'-6"

9'-0"

GENERAL NOTES:

1. LABELS PER PRINT.

2. THE SUPPORT AND FIRE STOPPING FOR FLUES
AND DUCTS FOR SITE INSTALLED HEATING SYSTEMS,
WATER HEATERS, FIREPLACES, ETC. SHALL BE
INSTALLED BY OTHERS.

- 3. THIS HOME MAY BE BUILT PARTIALLY OR COMPLETELY REVERSED.
- 4. ALL HALLWAYS ARE 36" MIN. IN WIDTH.
- 5. FURNACE, WATER HEATER, AND VENTS MAY BE SITE INSTALLED. (COMBUSTION AIR & FRESH AIR TO BE SUPPLIED ON SITE BY OTHERS.
- 6. ALL FIREPLACES TO BE INSTALLED PER MANUFACTURERS SPECIFICATIONS AND BE PROVIDED WITH GLASS DOORS.
- 7. ALL HOSE BIBS AND LAWN SPRINKLER SYSTEMS SHALL HAVE BACKFLOW PREVENTION DEVICE^.
- 8. ALL SHOWER AND BATHTUB SLIDING OR SWINGING DOORS SHALL BE TEMPERED.
- 9. PROVIDE OUTSIDE COMBUSTION AIR AT EXTERIOR WALL AT ALL FIREPLACES.

10. BATHTUB AND SHOWER FLOORS AND WALLS SHALL

- BE FINISHED WITH A NONABSORBENT SURFACE UP TO A HEIGHT OF 6'-0" ABOVE THE FLOOR PER CRC 307.2.
- 11. EXTERIOR LIGHTS MAY BE SHIPPED LOOSE FOR ON-SITE INSTALLATION BY OTHERS.
- 12. SIDING FOR ENDS IS SHIPPED LOOSE FOR ON-SITE INSTALLATION BY OTHERS.
- 13. BOTTOM ROW OF SIDING MAY BE SHIPPED LOOSE FOR ON-SITE INSTALLATION BY OTHERS.
- 14. SMOKE ALARMS/DETECTORS SHALL BE HARDWIRED INTERCONNECTED, AND HAVE BATTERY BACK-UP.

JUPPER LEVEL PLAN

KSH3659 KSH3659

7'-0"

2'-10 1/2"

12'-0"

41'-0"

1,667 SQ. FT. LIVING AREA

ROUGH OPENING SIZES ARE LISTED ON SCHEDULE

ALL EXTERIOR DOORS TO GARAGE WILL BE FACTORY
LABELED FOR A MIN. 20 MIN. FIRE RATING

ESCAPE OR RESCUE WINDOWS SHALL HAVE A MINIMUM
NET CLEAR OPENABLE AREA OF 5.7 SQ, FT., 5'-0" SQ. FT.
ALLOWABLE AT GRADE. THE MINIMUM NET CLEAR OPENABLE
HEIGHT DIMENSION SHALL BE 24 INCHES. THE NET CLEAR
OPENABLE WIDTH SHALL BE 20 INCHES. FINISH SILL HEIGHT
SHALL BE NOT MORE THAN 44 INCHES ABOVE THE FINISHED FLOOR
OR LESS THAN 18" ABOVE FINISHED FLOOR (UNLESS TEMPERED).

ROUGH OPENING SCHEDULE

								NAME	TYPE		QTY.	WIDTH	HEIGHT	HEADER HEIGHT	DESCRIPTION	
								50FR	EXTERIOR	DOOR	1	5'-2"	6'-11"	6'-11"	5'-0" FRENCH DOOR	1
								2/6INT	INTERIOR I	DOOR	4	2'-8"	6'-10 1/2"	6'-10 1/2"	2'-6" INTERIOR SW	INGING DOOR
								2/6PKT	INTERIOR I	DOOR	2	2'-8"	7'-0"	7'-0"	2'-6" POCKET DOOF	}
								2/6PKT	INTERIOR I	DOOR	1	2'-8"	7'-0"	7'-0"	2'-6" POCKET DOOF	}
								2/8INT	INTERIOR I	DOOR	3	2'-10"	6'-10 1/2"	6'-10 1/2"	2'-8" INTERIOR SW	INGING DOOR
							1 1	2/8PKT	INTERIOR I	DOOR	1	2'-10"	7'-0"	7'-0"	2'-8" POCKET DOOF	}
	_	HOUSE DO	ORMERS R	OUGH OPENII	NG SCHEDULE (NO	· · · · · · · · · · · · · · · · · · ·	LEVEL B	5/0SL	INTERIOR I	DOOR	1	5'-1"	7'-1/4"	7'-1/4"	5'-0" SLIDE-BY DO	ORS
NAME	TYPE	QTY.	WIDTH	HEIGHT	HEADER HEIGHT	DESCRIPTION		KSH3059	WINDOW		16	2'-6 1/2"	4'-10 7/8"	7'-6"	KINRO SINGLE HUNG	ì
KA1818	WINDOW	10	1'-6"	1'-6"	T.B.D.	KINRO AWNING		KSH3659	WINDOW		11	3'-1/2"	4'-10 7/8"	7'-6"	KINRO SINGLE HUNG	ì

Valley Home
DEVELOPMENT

1689 DALEWOOD COURT
FAIRFIELD, CA 94534
(707) 429.3300

SUBMITTAL CONSULTANT:
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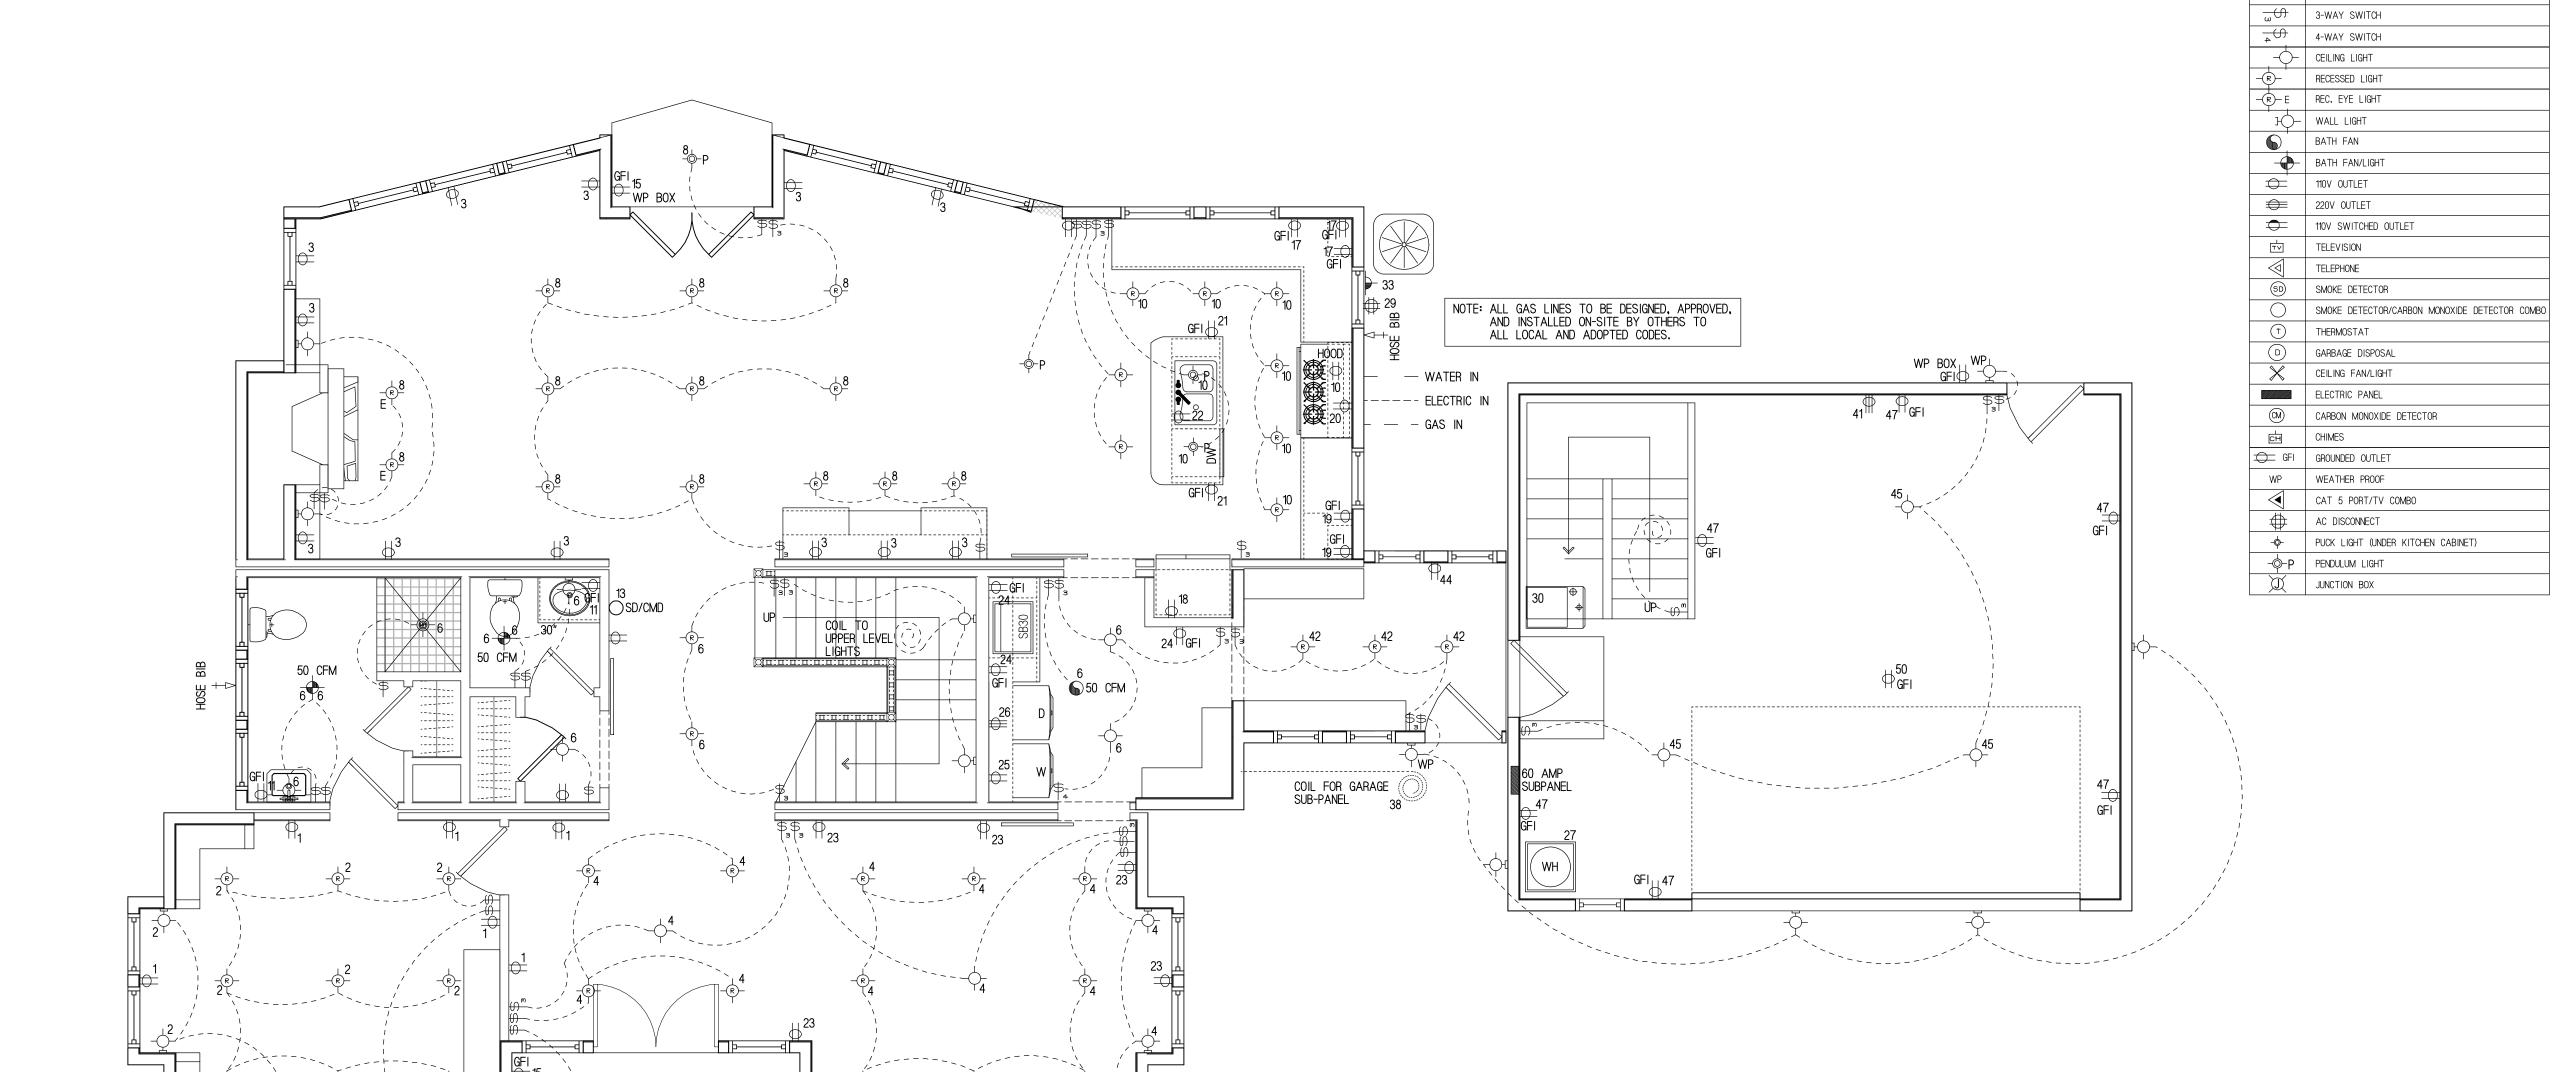
PROJECT NAME: NEW CONSTRUCTION FOR CHARLES ARMSTRONG

DRAWN BY: LCL					
DATE: 4.19.16					
SCALE: NONE					
REVIS	IONS:				
NO:	DATE:	DESCRIPTION:			
1.	5.4.16	REDLINES			
2.	5.17.16	REDLINES			
3.	6.26.16	WINDOWS			
4.	7.1.16	STAIRS			
5.	7.13.16	WINDOWS			
6.	7.21.16	BONUS			
7.	8.2.16	BONUS			
8.	9.25.16	TRAYS			

APPROVAL STAMPS:

SHEET TITLE
UPPER LEVEL
FLOORPLAN

LEVEL B



IMAIN LEVEL ELECTRIC PLAN

4053 SQ. FT. @ 3 WATTS/SQ. FT.	12.1 KW
3 - 20 AMP APPL. CIRCUITS	5.1 KW
LAUNDRY CIRCUIT	1.5 KW
GAS WATER HEATER	.5 KW
GAS FURNACE (BLOWER)	1.0 KW
GAS RANGE	1.0 KW
GAS DRYER	.4 KW
DISHWASHER	2.0 KW
TOTAL	23.6 KW
40 1/14/ 0 4009/	10.0

LOAD CALCULATIONS

| TOTAL | 23.6 KW | 10 KW @ 100% | 10.0 | 10.22 | ASSUMED HVAC | 20.00 | TOTAL LOAD | 33.6 | 33600 W/240 V.=140.0 AMPERES | 200 AMP SERVICE STANDARD | 2.0 KW | 20.00 | 20.00 
NOTE:
-AFCI SHALL SERVE ALL BRANCH CIRCUITS SUPPLYING 15 AND 20 AMP
OUTLETS INSTALLED IN DWELLING UNIT FAMILY ROOMS, DINING ROOMS,
LIVING ROOMS, PARLORS, LIBRARIES, DENS, BEDROOMS, SUNROOMS.
RECREATION ROOMS, CLOSETS, HALLWAYS OR SIMILAR ROOMS.

-ALL SWITCHES IN LIVING AREAS TO HAVE DIMMER SWITCHES TYP PER TITLE 24.

COIL FOR ON-SITE EXTERIOR LIGHTING

		ELECTRI	C CIR	CUIT	SCHEDULE		200 AMP
AMPS	WIRE-CU	DESCRIPTION	CIR	CUIT	DESCRIPTION	WIRE-CU	AMPS
15	NM 14-2/WG	MAIN RECPTS.	1	2	MAIN LIGHTING	NM 14-2/WG	15
15	NM 14-2/WG	MAIN RECPTS.	3	4	MAIN LIGHTING	NM 14-2/WG	15
15	NM 14-2/WG	UPPER RECPTS.	5	6	MAIN LIGHTING	NM 14-2/WG	15
15	NM 14-2/WG	UPPER RECPTS.	7	8	MAIN LIGHTING	NM 14-2/WG	15
15	NM 14-2/WG	UPPER RECPTS.	9	10	MAIN LIGHTING	NM 14-2/WG	15
20	NM 12-2/WG	BATH GFI'S	11	12	UPPER LIGHTING	NM 14-2/WG	15
15	NM 14-2/WG	SMOKE DETECTORS/CMD	13	14	UPPER LIGHTING	NM 14-2/WG	15
20	NM 12-2/WG	EXTERIOR GFI'S	15	16	UPPER LIGHTING	NM 14-2/WG	15
20	NM 12-2/WG	KITCHEN APPL.	17	18	REFRIGERATOR	NM 12-2/WG	20
20	NM 12-2/WG	KITCHEN APPL.	19	20	GAS RANGE	NM 12-2/WG	20
20	NM 12-2/WG	KITCHEN APPL.	21	22	DISHWASHER	NM 12-2/WG	20
20	NM 12-2/WG	DINING ROOM	23	24	LAUNDRY ROOM	NM 12-2/WG	20
20	NM 12-2/WG	WASH MACHINE	25	26	ELECTRIC DRYER	NM 10-3/WG	30
20	NM 12-2/WG	GAS WATER HEATER	27	28	и и	н н	н н
40	NM 8-2/WG	AC DISCONNECT	29	30	GAS FAU	NM 12-2/WG	20
11 11	н н	н н	31	32	OPT. EXT. POWER	NM 12-2/WG	20
15	NM 14-2/WG	SPRINKLER POWER	33	34			
			35	36			
			37	38	GARAGE SUB-PANEL	NM 6-3/WG	60
			39	40	н п	н н	11 11

		ELECTRI	C CIR	CUIT	SCHEDULE	60 AMP S	SUBPANEL
AMPS	WIRE-CU	DESCRIPTION	CIRO	CUIT	DESCRIPTION	WIRE-CU	AMPS
30	NM 10-3/WG	ELECTRIC CAR CHARGER	41	42	MUD ROOM LIGHTING	NM 14-2/WG	15
11 11	и и	и и	43	44	MUD ROOM RECPTS.	NM 12-2/WG	20
15	NM 14-2/WG	GARAGE LIGHTING	45	46	BONUS ROOM LIGHTING	NM 14-2/WG	15
20	NM 12-2/WG	GARAGE RECPTS.	47	48	BONUS ROOM RECPTS.	NM 14-2/WG	15
			49	50	GARAGE DOOR OPENER	NM 14-2/WG	15
			51	52			
			53	54			
			55	56			
			57	58			
			59	60			

MANUFACTURER:

ELECTRICAL LEGEND

- (∫) | SWITCH

Valley Home

1689 DALEWOOD COURT FAIRFIELD, CA 94534 (707) 429.3300

SUBMITTAL CONSULTANT:
GAEA DESIGN
POWER HOUSE DESIGN GROUP
6608 DEVON DRIVE
LIBERTY TOWNSHIP, OH 45044
(513) 444.0519



ROJECT NAME: EW CONSTRUCTION


DRAV	VN BY: BHS	5				
DATE	DATE: 8.20.16					
SCALE: NONE						
REVIS	SIONS:					
NO:	DATE:	DESCRIPTION:				
1.	9.25.16	ADDITIONAL LIGHTIN				

200 AMP
APPROVAL STAMPS:

SHEET TITLE

MAIN LEVEL

ELECTRIC PLAN

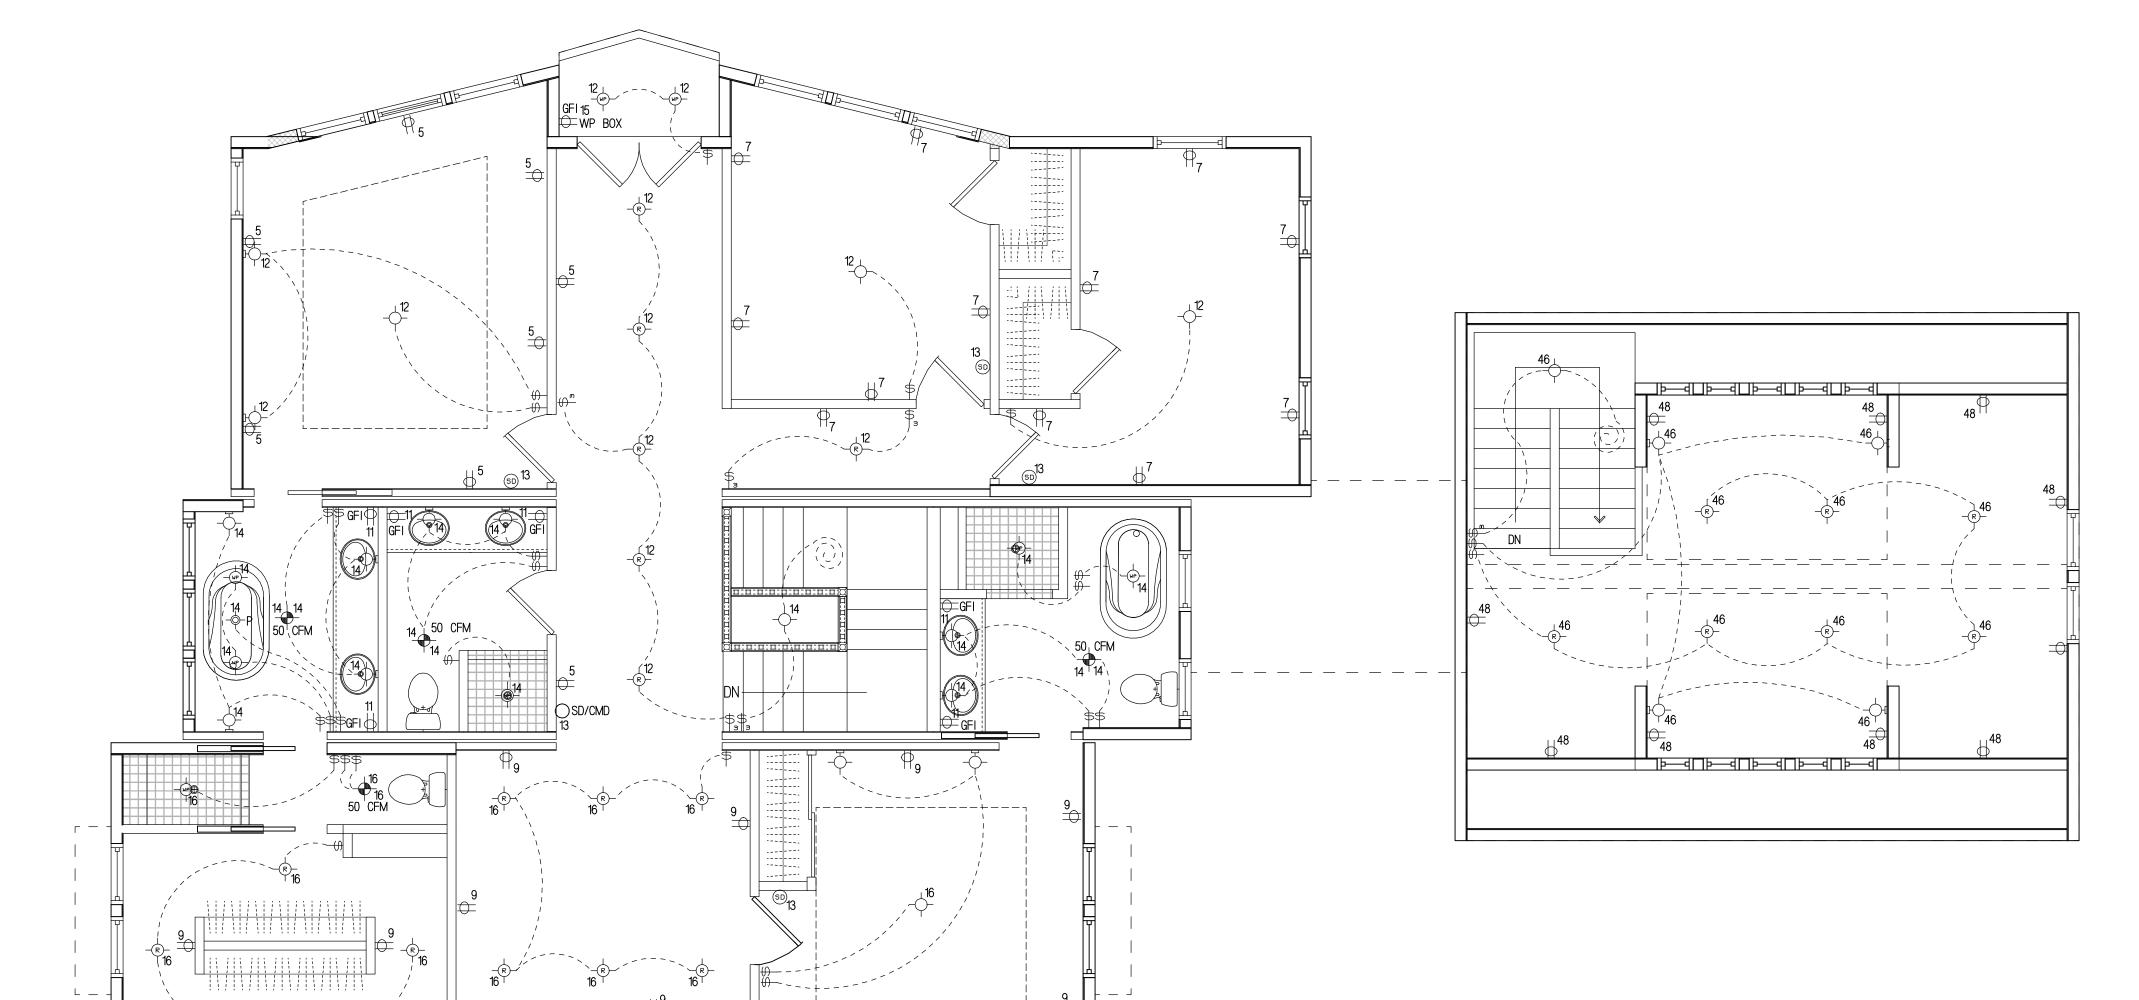

i_____j

JUPPER LEVEL ELECTRIC PLAN

-AFCI SHALL SERVE ALL BRANCH CIRCUITS SUPPLYING 15 AND 20 AMP OUTLETS INSTALLED IN DWELLING UNIT FAMILY ROOMS, DINING ROOMS, LIVING ROOMS, PARLORS, LIBRARIES, DENS, BEDROOMS, SUNROOMS. RECREATION ROOMS, CLOSETS, HALLWAYS OR SIMILAR ROOMS.

-ALL SWITCHES IN LIVING AREAS TO HAVE DIMMER SWITCHES TYP PER TITLE 24.

-0	SWITCH
~ ()	3-WAY SWITCH
Q	4-WAY SWITCH
	CEILING LIGHT
-R-	RECESSED LIGHT
-R-E	REC. EYE LIGHT
10-	WALL LIGHT
	BATH FAN
-	BATH FAN/LIGHT
	110V OUTLET
=	220V OUTLET
	110V SWITCHED OUTLET
+	TELEVISION
	TELEPHONE
SD	SMOKE DETECTOR
	SMOKE DETECTOR/CARBON MONOXIDE DETECTOR COMBO
T	THERMOSTAT
D	GARBAGE DISPOSAL
\times	CEILING FAN/LIGHT
	ELECTRIC PANEL
CM	CARBON MONOXIDE DETECTOR
CH	CHIMES
→ GFI	GROUNDED OUTLET
WP	WEATHER PROOF
	CAT 5 PORT/TV COMBO
#	AC DISCONNECT
-ф-	PUCK LIGHT (UNDER KITCHEN CABINET)
- ∳ -P	PENDULUM LIGHT
) I	JUNCTION BOX

ELECTRICAL LEGEND

ELECTRICAL NOTES: 2013 CEC IS BASED ON THE 2011 NEC

1. ALL CONDUCTORS WILL BE COPPER. 2. RECEPTACLE OUTLET SPACING CONFORMS TO 2013 CA. ELEC. CODE.

3. USE LIGHTWEIGHT STEEL CLAD CABLE THIN 600 V RATED. 4. SMOKE DETECTORS SHALL BE WIRED SO THAT ACTUATION OF ONE ALARM WILL ACTUATE ALL SMOKE DETECTOR ALARMS IN THE HOME. *IN MODELS WITH A BASEMENT, A JUNCTION BOX WILL BE INSTALLED

UNDER THE FLOOR AND A SMOKE DETECTOR WILL BE SHIPPED

LOOSE FOR SITE INSTALLATION. 5. CEILING LIGHTS MAY BE REPLACED WITH CEILING FAN/LIGHT COMBINATIONS IF THEY ARE INSTALLED PER MANUFACTURERS INSTRUCTIONS AND CODE REQUIREMENTS.

6. LIGHTING FIXTURES INSTALLED IN CLOSETS WILL BE IN ACCORDANCE WITH THE 2013 CA. ELEC. CODE.

7. *LIGHTS AND ELECTRICAL CIRCUITS FOR BASEMENT, CRAWL SPACE, AND/OR GARAGE ARE TO BE PROVIDED ON SITE BY OTHERS. 8. SPACES ARE PROVIDED IN THE PANEL BOX FOR EXPANSION.

9. *ELECTRICAL INTERCONNECTION BETWEEN MODULES SHALL BE MADE IN THE BASEMENT OR CRAWL SPACE USING JUNCTION BOXES BY A QUALIFIED ELECTRICIAN ON SITE, JUNCTION BOXES AT THE MATE-LINES SHALL BE IDENTIFIED BY CIRCUIT.

10. ELECTRICAL BOXES SHALL BE LISTED FOR THE SPECIFIC PURPOSE. BOXES FOR FIXTURE ATTACHMENTS SHALL BE DESIGNED FOR THAT PURPOSE WITH PROPER FIXTURE ATTACHMENT MEANS. ALL FIXTURES SHALL BE ADEQUATELY SUPPORTED PER THE FIXTURE MANUFACTURERS INSTRUCTIONS AND THEIR LISTING REPORT.

11. THE METHOD OF MOUNTING FIXTURES AND WIRING INSTALLATION SHALL BE PER THE LISTING REPORT AND THE MANUFACTURERS INSTALLATION INSTRUCTIONS.

12. SMOKE DETECTORS SHALL BE INSTALLED OUTSIDE OF EACH SLEEPING AREA AND MUST BE INSTALLED IN EACH BEDROOM. AT LEAST ONE (1) SMOKE DETECTOR MUST BE INSTALLED ON EACH LEVEL, INCLUDING BASEMENTS. ALL SMOKE DETECTORS WITHIN A DWELLING UNIT SHALL BE HARD WIRED TO THE HOME ELECTRICAL AND INTERCONNECTED TO PROVIDE SIMULTANEOUS ACTIVATION.

EACH SMOKE DETECTOR WILL BE EQUIPPED WITH A BATTERY BACK-UP 13. ALL BRANCH CIRCUITS THAT SUPPLY 125-V SINGLE PHASE, 15 & 20 AMP OUTLETS INSTALLED IN DWELLING LIVING AREAS SHALL BE PROTECTED BY AN ARC-FAULT CIRCUIT INTERRUPTER TO PROVIDE PROTECTION OF THE ENTIRE BRANCH CIRCUIT.

14. ALL 15 AND 20 AMP RECEPTACLES ARE TO BE TAMPER RESISTANT. 15. BATHROOM EXHAUST FANS SHALL BE CONTROLLED BY HUMIDISTAT.

16. ALL RECEPTACLES PLACED IN CRAWL SPACE WILL BE GFCI. 17. ALL CONCEALED LIGHT FIXTURES WILL BE I.C. RATED WHEREVER INSULATION IS REQUIRED. THE HOUSING OF THE LUMINARIES SHALL BE AIR TIGHT. 18. A CO ALARM SHALL BE CENTRALLY LOCATED OUTSIDE OF EACH SEPARATE

SLEEPING AREA IN THE IMMEDIATE VICINITY OF THE BEDROOMS. THE ALARMS SHOULD BE LOCATED AT LEAST 6" FROM ALL EXTERIOR WALLS AND AT LEAST 3'-0" FROM SUPPLY OR RETURN VENTS. 19. CARBON MONOXIDE ALARMS SHALL BE HARD WIRED TO THE HOME ELECTRICAL

AND SHALL BE EQUIPPED WITH A BATTERY BACKUP.

ADDED CEC ELECTRICAL NOTES:

4.106.4.1 NEW ONE- AND TWO-FAMILY DWELLINGS AND TOWNHOUSES WITH ATTACHED PRIVATE GARAGES. FOR EACH DWELLING UNIT, INSTALL A LISTED RACEWAY TO ACCOMODATE A DEDICATED 208240-VOLT BRANCH CIRCUIT. THE RACEWAY SHALL NOT BE LESS THAN TRADE SIZE 1 (NOMINAL 1-INCH INSIDE DIAMETER). THE RACEWAY SHALL ORIGINATE AT THE MAIN SERVICE OR SUBPANEL AND SHALL TERMINATE INTO A LISTED CABINET, BOX OR OTHER ENCLOSURE IN CLOSE PROXIMITY TO THE PROPOSED LOCATION OF AN EV CHARGER. RACEWAYS ARE REQUIRED TO BE CONTINUOUS AT ENCLOSED. INACCESSIBLE OR CONCEALED APEAS AND SPACES. ENCLOSED, INACCESSIBLE OR CONCEALED AREAS AND SPACES. THE SERVICE PANEL AND/OR SUBPANEL SHALL PROVIDE CAPACITY TO INSTALL A 40-AMPERE MINIMUM DEDICATED BRANCH CIRCUIT AND SPACE(S) RESERVED TO PERMIT INSTALLATION OF A BRANCH CIRCUIT OVERCURRENT PROTECTIVE DEVICE.

4.106.4.1.1 IDENTIFICATION. THE SERVICE PANEL OR SUBPANEL CIRCUIT DIRECTORY SHALL IDENTIFY THE OVERCURRENT PROTECTIVE DEVICE SPACE(S) RESERVED FOR FUTURE EV CHARGING AS "EV CAPABLE". THE RACEWAY TERMINATION LOCATION SHALL BE PERMANENTLY AND VISABLY MARKED AS "EV CAPABLE".

ALL CONDUCTORS AND CABLES MUST BE PROPERLY TERMINATED IN APPROVED BOXES BEFORE CONNECTING THE CIRCUIT TO THE BREAKER AND BEFORE RECEIVING FINAL INSPECTION APPROVAL IN THE FACTORY, NEC30015

ALL 15 & 20 AMP RECEPTACLES TO BE TAMPER RESISTANT.

ALL 15 AND 20 AMP BRANCH CIRCUITS IN FAMILY ROOMS, DINING ROOMS, LIVING ROOMS, PARLORS, LIBRARIES, DENS, BEDROOMS, SUNROOMS, RECEASTION ROOMS, CLOSETS, HALLWAYS, OR SIMILAR ROOMS SHALL BE AFCI PROTECTED. NEC 210.12(B) A MINIMUM OF 50% OF THE KITCHEN LIGHTING IS REQUIRED TO BE

HIGH EFFICIENCY. (DINING ROOMS AND NOOKS ARE CONSIDERED PART OF THE KITCHEN AREA) 150.0 (K)3

A MINIMUM OF ONE HIGH EFFICIENCY LUMINAIRE SHALL BE INSTALLED IN EACH BATHROOM, AND ALL OTHER LIGHTING INSTALLED IN EACH BATHROOM 150 O. ACE SENSORS. 150.0 (K)5 LIGHTING INSTALLED IN ATTACHED AND DETACHED GARAGES, LAUNDRY ROOMS AND UTILITY ROOMS SHALL BE HIGH EFFICIENCY LUMINAIRES

AND CONTROLLED BY VACANCY SENSORS. 150.0 (K)6 ALL OTHER ROOMS (OTHER THAN KITCHENS, BATHROOMS, GARAGES, AND UTILITY ROOMS) SHALL BE HIGH EFFICIENCY LIGHTING OR CONTROLLED BY DIMMERS OR VACANCY SENSORS. 150.0 (K)7 OUTDOOR LIGHTING SHALL BE HIGH EFFICIENCY. BATHROOM ESHAUST FANS SHALL BE ENERGY STAR COMPLIANT WITH

HUMIDISTATE CONTROLS.

MANUFACTURER:

BUILDER: DEVELOPMENT

1689 DALEWOOD COURT FAIRFIELD, CA 94534 (707) 429.3300


SUBMITTAL CONSULTANT: GAEA DESIGN POWER HOUSE DESIGN GROUP 6608 DEVON DRIVE LIBERTY TOWNSHIP, OH 45044 (513) 444.0519



<u> </u>		
DRAV	WN BY: BHS	
DATE	E: 8.10.16	
SCAL	E: NONE	
REVI	SIONS:	
NO:	DATE:	DESCRIPTION:
1.	9.25.16	ADDITIONAL LIGHTING

APPROVAL STAMPS:

SHEET TITLE UPPER LEVEL

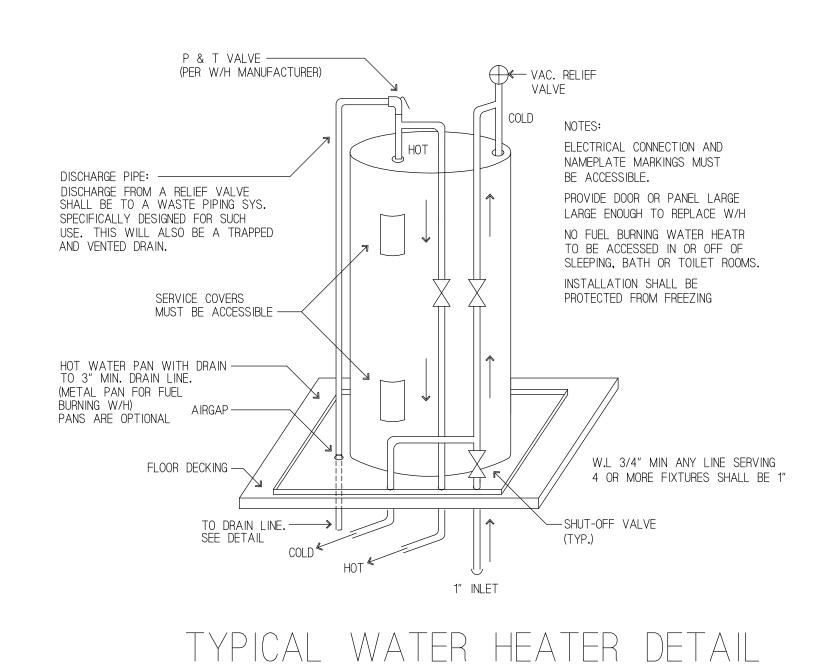

PLUMBING NOTES:

- 1. WHEN WATER HEATERS OR HOT WATER STORAGE TANKS ARE INSTALLED IN LOCATIONS WHERE TANK OR CONNECTION LEAKAGE COULD CAUSE DAMAGE, THE TANK OR THE WATER HEATER SHALL BE INSTALLED IN A GALVANIZED STEEL OR OTHER METAL PAN OF EQUAL CORROSION RESISTANCE HAVING A MINIMUM THICKNESS OF 24 GAUGE, 0.0276 INCH. ELECTRICAL WATER HEATERS SHALL BE INSTALLED IN A METAL PAN AS REQUIRED OR IN A HIGH-IMPACT PLASTIC PAN OF AT LEAST 0.0625 INCH THICKNESS.
- 2. THE PAN SHALL NOT BE LESS THAN 1 1/2 DEEP AND SHALL BE OF SUFFICIENT SIZE AND SHAPE TO RECEIVE ALL DRIPPING OR CONDENSATE FROM THE TANK OR WATER HEATER, THE PAN SHALL BE DRAINED BY AN INDIRECT WASTE PIPE HAVING A MINIMUM DIAMETER OF 1 INCH OR THE OUTLET DIAMETER OF THE REQUIRED RELIEF VALVE, WHICHEVER
- 3. THE PAN SHALL EXTEND FULL-SIZE AND TERMINATE OVER A SUITABLY LOCATED INDIRECT WASTE RECEPTOR OR FLOOR DRAIN OR EXTEND TO THE EXTERIOR OF THE BUILDING AND TERMINATE NOT LESS THAN 6 INCHES AND NOT MORE THAN 24 INCHES ABOVE THE ADJACENT GROUND SURFACE.
- 4. IN CONCEALED LOCATIONS WHERE PIPING IS INSTALLED THROUGH HOLES OR NOTCHES IN STUDS, JOISTS, RAFTERS OR SIMILAR MEMBERS LESS THAN 1 1/2 INCHES FROM THE NEAREST EDGE OF THE MEMBER, THE PIPE SHALL BE PROTECTED BY SHIELD PLATES. PROTECTIVE SHIELD PLATES SHALL BE A MINIMUM OF 1/16 INCH THICK STEEL, SHALL COVER THE AREA OF THE PIPE WHERE THE MEMBER IS NOTCHED OR BORED, AND SHALL EXTEND A MINIMUM OF 2 INCHES ABOVE SOLE PLATES AND BELOW TOP PLATES.
- 5. FIXTURES, INCLUDING P TRAPS, WITH CONCEALED SLIP-JOINT CONNECTIONS SHALL BE PROVIDED WITH ON ACCESS PANEL OR UTILITY SPACE AT LEAST 12 INCHES IN ITS SMALLEST DIMENSION OR OTHER APPROVED ARRANGEMENT SO AS TO PROVIDE ACCESS TO THE SLIP CONNECTIONS FOR INSPECTION AND REPAIR.
- 6. THE DISCHARGE FROM AN AUTOMATIC CLOTHES WASHER SHALL BE THROUGH AN AIR BREAK AND CONNECTED TO A STANDPIPE.

- 7. STANDPIPES SHALL BE INDIVIDUALLY TRAPPED. STANDPIPES SHALL EXTEND A MINIMUM OF 18 INCHES AND A MAXIMUM OF 30 INCHES ABOVE THE TRAP. ACCESS SHALL BE PROVIDED TO ALL STANDPIPE TRAPS AND DRAINS FOR RODDING.
- 8. THE PUMP SHALL BE ACCESSIBLE ON ALL WHIRLPOOL BATHTUBS.
- 9. SHOWER AND TUB-SHOWER COMBINATION VALVES SHALL BE BALANCED PRESSURE, THERMOSTATIC OR COMBINATION MIXING VALVES. SUCH VALVES SHALL BE EQUIPPED WITH HANDLE POSITION STOPS THAT ARE FIELD ADJUSTED IN ACCORDANCE WITH THE MANUFACTURERS INSTRUCTIONS TO A MAXIMUM HOT WATER SETTING OF 120 DEGREES F.
- 10. THE FLOW VELOCITY OF THE WATER DISTRIBUTION SYSTEM SHALL BE CONTROLLED TO REDUCE THE POSSIBILITY OF WATER HAMMER. A WATER HAMMER ARRESTER SHALL BE INSTALLED WHERE QUICK CLOSING VALVES ARE UTILIZED, UNLESS OTHERWISE APPROVED. THE ARRESTER SHALL BE LOCATED WITHIN AN EFFECTIVE RANGE OF A QUICK CLOSING VALVE. WATER HAMMER ARRESTERS SHALL CONFORM TO ASSE 1010. ACCESS SHALL BE PROVIDED TO WATER HAMMER ARRESTERS.
- 11. HOSE BIBB VALVES INSTALLED IN PLANT AND SHALL BE IDENTIFIED WITH A HANG TAG. WASHER AND HOSE BIBS SHALL HAVE A VACUUM BREAKER INSTALLED.
- 12. DRAIN WASTE AND VENT LINES SHALL MEET ASTM D2662-89A REQUIREMENTS AND BE COMPLIANT WITH ALL APPLICABLE STATE
- 13. ALL PLUMBING VENTS TO BE A MINIMUM OF 10 FEET AWAY FROM OR AT LEAST 3'-0" ABOVE ANY OPERABLE SKYLIGHTS.
- 14. CLEANOUTS IN BUILDING SEWERS SHALL BE PROVIDED IN ACCORDANCE WITH THE RULES, REGULATIONS AND ORDINANCES OF THE CITY. ALL CLEANOUTS SHALL BE MAINTAINED WATERTIGHT.
- 15. WATER DISTRIBUTION SYSTEM SUPPLY LINES WILL BE COMPLIANT WITH ALL STATE CODES.

ALL PLUMBING IS STUBBED THRU

DWV GENERAL NOTES:

- 1. ALL PIPES WILL CONSIST OF PVC AND BE COMPLIANT WITH ALL APPLICABLE STATE CODES.
- 2. ALL PIPES AND FITTINGS TO BE 1 1/2 DIA. UNLESS SPECIED OTHERWISE
- 3, A COPY OF THIS DRAWING SHALL BE INCLUDED IN THE INSTALLATION INSTRUCTIONS FOR SITE INSTALLATION OF PIPE AND FITTINGS.
- 4. DRAIN DUMP MAY BE DLTL OR 90 DEGREES DBL. L OR WYE. 5. ----- DENOTES SHIP LOOSE FOR ON SITE INSTALLATION.
- 6. STOOL TRAP ARM MAX. 6.
- 7. DENOTES PLBG. THRU FLOOR.
- 8. MIN. HORIZONTAL SLOPE FOR DRAIN LINES IS 1/4" PER 1'-0". 9. ALL 1 1/2" P-TRAPS TO HAVE A MAXIMUM LENGTH OF
- 42" FOR TRAP ARM PER CPC CHAPTER 10 10. ALL 2" P-TRAPS TO HAVE A MAXIMUM LENGTH OF 60" FOR TRAP ARM PER CPC CHAPTER 10

ALL PLUMBING BELOW SHIPPED FLOOR IS INSTALLED ON SITE BY OTHERS.

SUPPLY GENERAL NOTES:

- 1. ALL SUPPLY LINES WILL CONSIST OF PEX PIPE / FLAIR-IT FITTINGS (PEX SHALL NOT BE USED WITHIN THE FIRST 18" 18" OF PIPING CONNECTED TO THE WATER HEATER PER CPC 604.13)
- 2. EXTERIOR FAUCETS TO BE PROVIDED WITH ANTI-SIPHON DEVICES AND FROST PROOF.
- 3. PROVIDE A WATERTIGHT PAN OF CORROSION RESISTANT MATERIALS SHALL BE INSTALLED BENEATH THE WATER HEATER WITH A MINIMUM THREE-QUARTER INCH (20 mm) DIAMETER DRAIN TO AN APPROVED LOCATION CPC 507.4
- 4. SHOWERS AND TUBS: SHOWERS IN ALL BUILDINGS SHALL BE PROVIDED INDIVIDUAL CONTROL VALVES THAT LIMIT TEMPERATURE TO A MAXIMUM OF 120^ (49^c). THE WATER HEATER THERMOSTAT SHALL NOT BE CONSIDERED A SUITABLE CONTROL CPC 408.3
- 5. WATER CONSERVING PLUMBING FIXTURES ARE REQUIRED BY CAL GREEN 4.303.
 - TOILETS: 1.28 GPF SHOWER HEADS: 2.0 GPM @ 80 PSI LAVY FAUCETS: 1.5 GPM @ 60 PSI
- KITCHEN FAUCETS: 1.8 GPM @ 60 PSI 6. ALL COLD WATER PIPING SHALL BE LOCATED WITHIN CONDITIONED SPACE OR OTHERWISE PROTECTED FROM FREEZING IN ACCORDANCE WITH LOCAL ADOPTED CODES. -CPC 312.6

- 7. ALL DOMESTIC HOT WATER PIPING CONDITIONS LISTED BELOW MUST BE INSULATED AND THE INSULATION THICKNESS SHALL BE BASED ON THE CONDUCTIVITY RANGE IN TABLE 120.3-A AND THE INSULATION LEVEL SHALL BE SELECTED FROM THE FLUID TEMPERATURE RANGE. 150.0 (J) THE FIRST 5 FEET OF HOT AND COLD WATER PIPES
- FROM THE STORAGE TANK ALL PIPING WITH A NOMINAL DIAMETER OF 3/4" OR
- ALL HOT WATER PIPING FROM THE HEATING SOURCE TO THE KITCHEN FIXTURES
- FLUID TEMPERATURE RANGE = 105^ 140^ F CONDUCTIVITY RANGE = 0.22 - 0.28
- REQUIRED THICKNESS -1" INSULATION FOR PIPES LESS THAN 1" NOMINAL DIAMETER -
- 1-1/2" INSULATION FOR PIPES 1" TO 1-1/2" NOMINAL DIAMETER -SEE WATER HEATER CUT SHEETS FOR REQUIRED ENERGY
- EFFICIENT WATER HEATER 8. STRAP WATER HEATER FOR SEISMIC RESTRAINT-CPC 507.2
- 9. STORAGE GAS WATER HEATERS WITH AN ENERGY FACTOR EQUAL TO OR LESS THAN THE FEDERAL MINIMUM STANDARDS SHALL BE EXTERNALLY WRAPPED WITH INSULATION HAVING AN INSTALLED THERMAL RESISTANCE OF R-12 OR GREATER. 150.0 J

DEVICE	QTY.	COLD F.U.'s	HOT F.U.'s	COM- BINED	INLET
WATER CLOSET	6	2.5	0	2.5	15.0
LAV *	9	0.75	0.75	1.0	9.0
TUB/SHOWER *	0	3.0	3.0	4.0	0
SHOWER *	5	1.5	1,5	2.0	5.0
TUB *	2	3.0	3.0	4.0	8.0
SINK *	1	1,25	1,25	1.5	1.5
OPT. DISHWASHER	1	0	1.5	1.5	1.5
WASHER *	1	3.0	3.0	4.0	4.0
MISC.	0	0	0	0	0
OPT. H.B. (ONE)	1	2.5	0	2.5	2.5
OPT. H.B. (ADDT'L)	1	1.0	0	1.0	1.0
OPT. L SINK *	1	1,25	1,25	1.5	1.5
OPT. SINK *	0	1.25	1,25	1.5	0
OPT. LAV *	0	0.75	0.75	1.0	0
OPT. BAR SINK *	0	0.75	0.75	1.0	0
		TOTAL	FIXTURE	UNITS	49.

WATERPROOF FLANGE -

ROOF LINE

REDUCER -

ROOF VENT DETAIL (REDUCER)

TYPICAL-ADJOINING

VENT

--- 1-1/2″

610.3 (FOOTNOTE 3)

010.5 (10011101	L 3/	
PIPE SIZE (ID)	MAX. F.U.'s	
1/2"	6	
3/4"	19	
1"	36	
1 1/4"	39	

TABLE 610.4 UPC 46-60 PSI PRESSURE - 80' MAX. LENGTH 3/4" METER SERVICE 1" BUILDING SERVICE

RESIDENCE WILL HAVE A MINIMUM DESIGN PRESSURE OF 40 PSI FOR A MAXIMUM DEVELOPED LENGTH OF 68 FEET

MANUFACTURER:

BUILDER: DEVELOPMENT 1689 DALEWOOD COURT

SUBMITTAL CONSULTANT: GAEA DESIGN POWER HOUSE DESIGN GROUP 6608 DEVON DRIVE LIBERTY TOWNSHIP, OH 45044

FAIRFIELD, CA 94534

(707) 429.3300





(513) 444.0519

DRAW	N BY: BHS			
DATE:	E: 8.15.16			
SCALE	: NONE			
REVIS	IONS:			
NO:	DATE:	DESCRIPTION:		
1.				

APPROVAL STAMPS:

SHEET TITLE PLUMBING NOTES & DETAILS

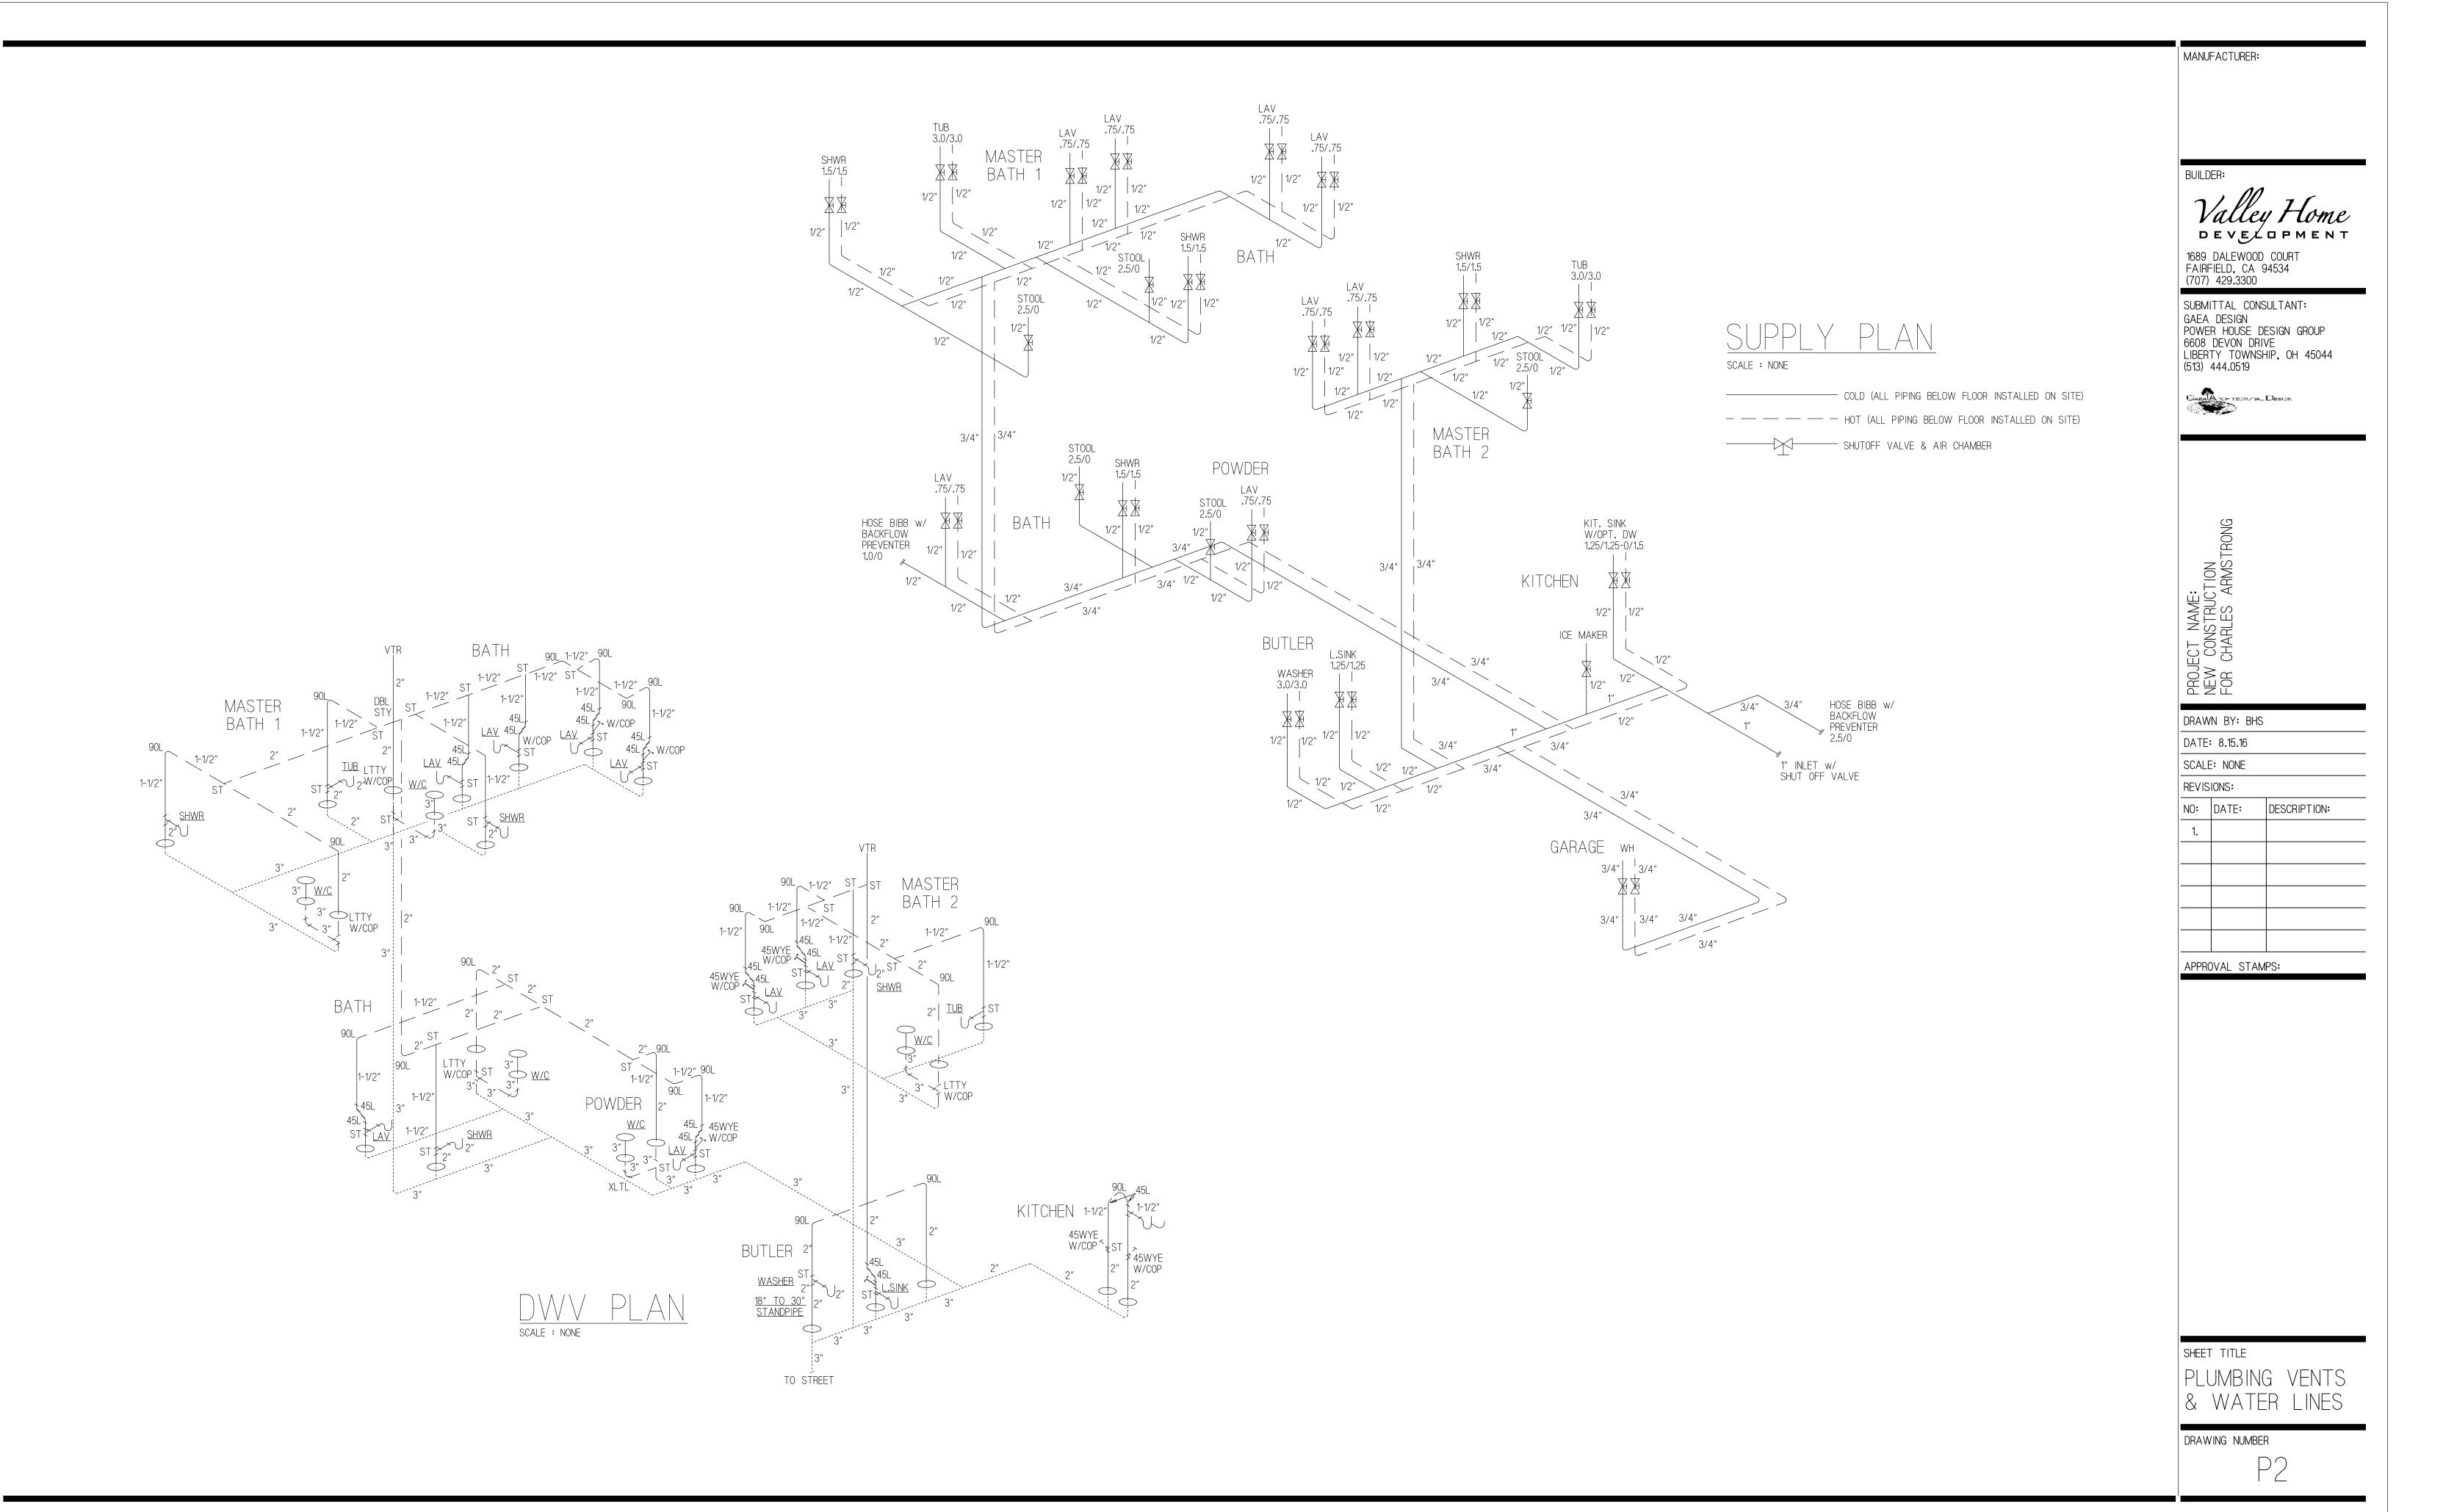

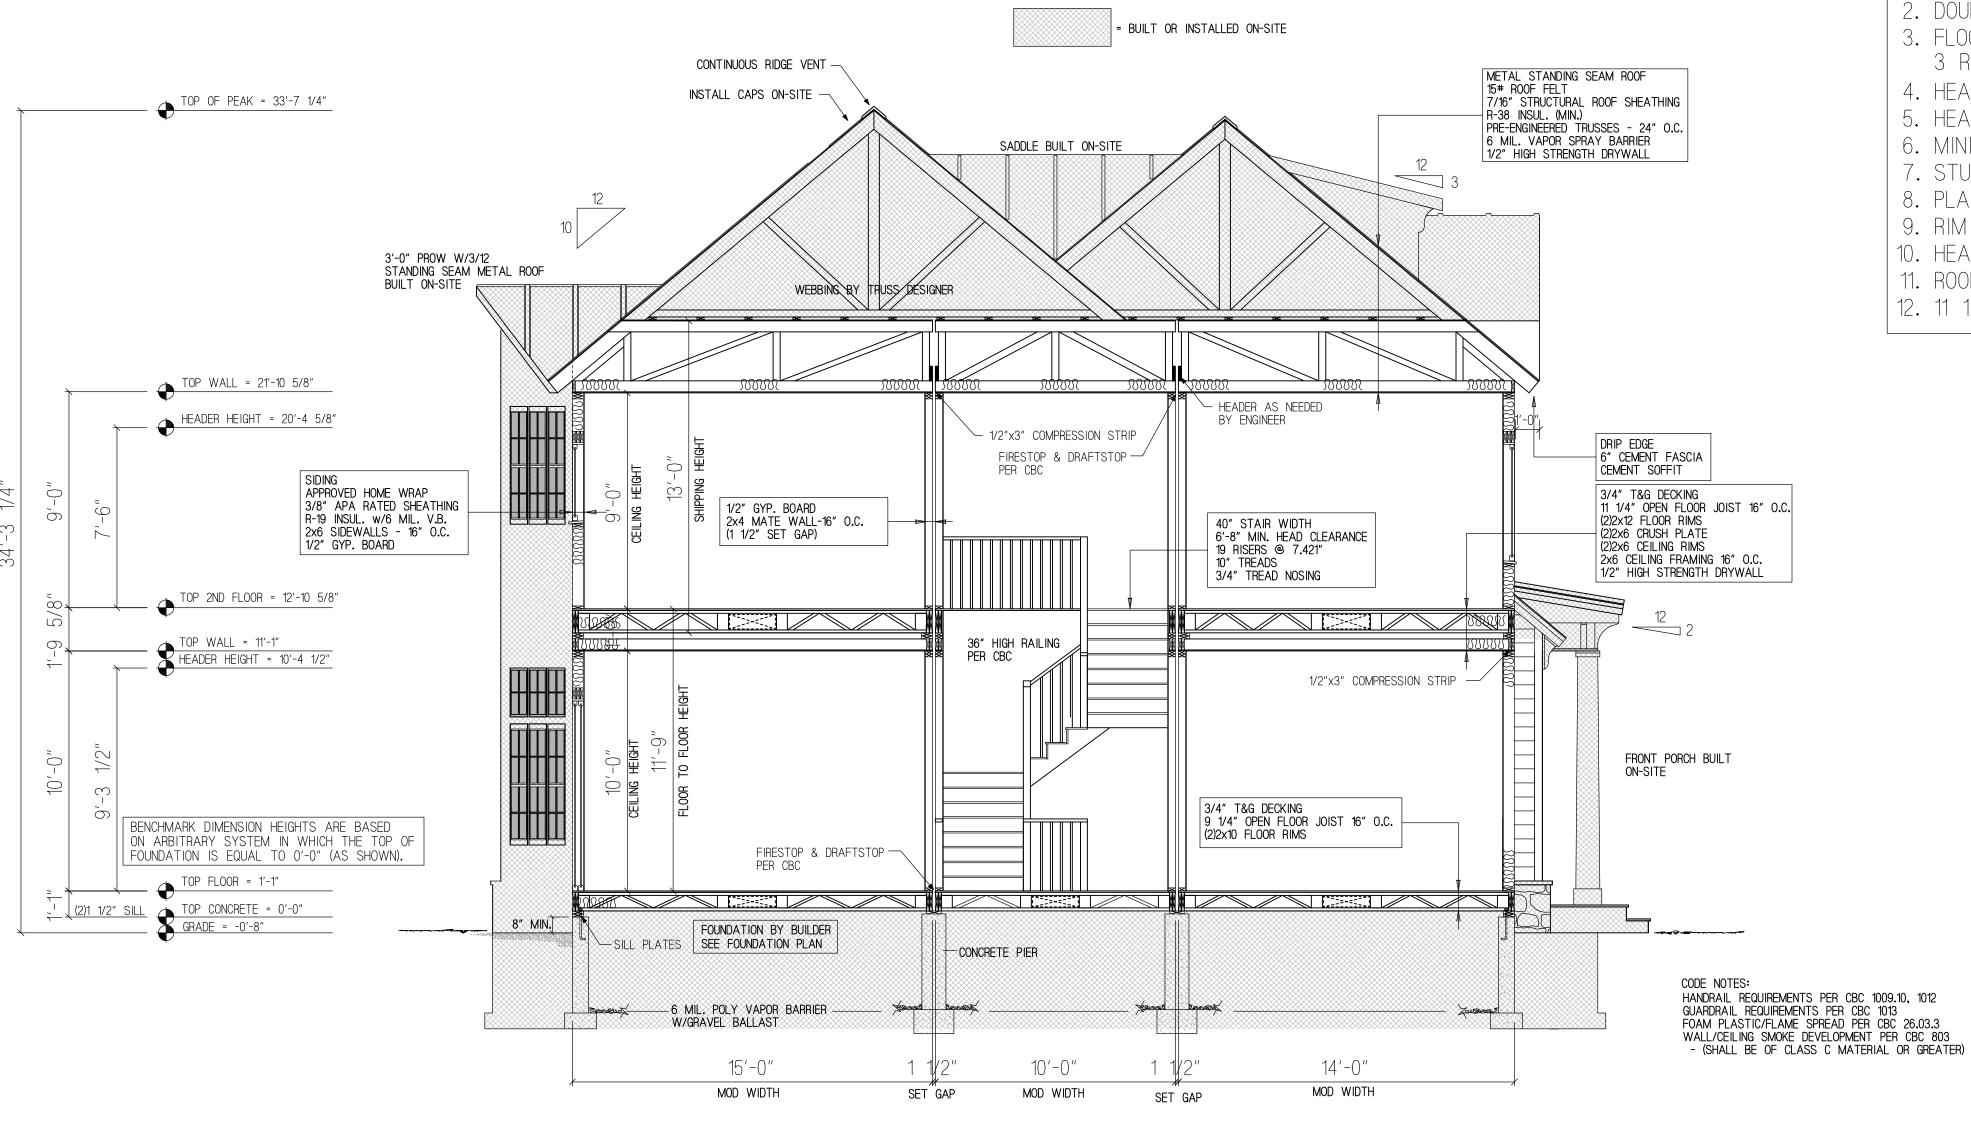

STAIR REQUIREMENTS

31. Provide and reference a detail for the proposed stairs showing the following minimum code requirements: (Sec 1003.3.3.)

31.1. Maximum 7 3/4" inch rise and minimum 9 inch run.

31.2. Minimum 6 feet 8 inch vertical headroom measured at stairway tread nosings. (Sec 1003.3.3.)

- 31.3. Minimum 36 inch clear width. (Sec 1003.3.2.)
- 31.4. There shall be a floor or a landing at the top and bottom of each stairway or stair run.
- 31.5. At least one intermediate landing shall be provided for each 12 feet of vertical stairway rise measured between the horizont
- 32. Provide and reference a detail for the proposed Winding Stairway showing the following code minimums:
- 32.1. The required width of the run (9 inches minimum) (11 inches minimum, commercial) is provided at a point not more than 12 inc where the treads are narrower.
- 32.2. The width of the run shall not be less than 6 inches at any point.
- 33. Provide and reference a detail for the proposed Spiral Stairway showing the following code minimums:
- 33.1. Treads shall provide a clear walking area measuring at least 26 inches from the outer edge of the supporting column to the i
- 33.2. A run of at least 7½ inches shall be provided at a point 12 inches from where the tread is the narrowest.
- 33.3. Tread rise shall not exceed 9½ inches.
- 33.4. Head room shall be a minimum of 6 feet 6 inches.
- 33.5. A spiral stairway cannot be used as a required exit from areas exceeding 400 square feet. (Sec 1003.3.3.8.3.)
- 34. Indicate at stairs with 4 or more risers the installation of a Handrail and provide and reference a detail showing the followi 34.1. Handrail to be continuous.
- 34.2. Handrail shall be 34 inches to 38 inches above the nosing of treads.
- 34.3. Open guardrails shall have intermediate rails such that a sphere 4 inches in diameter cannot pass through. The triangular op bottom element of a guardrail at the open side of a stairway may be of such size such that a sphere 6 inches in diameter cannot pa
- 34.4. The handgrip portion of handrail shall not be less than 11/4 inch nor more than 2 inches in cross-sectional dimension.
- 35. Indicate a minimum 36 inch high protective Guardrail at unenclosed floor and roof openings, open and glazed sides of stairways or porches, which are more than 30 inches above grade or floor below, and roofs used for other than service of the building, shall construction detail indicating:
- 35.1. Open guardrails shall have intermediate rails or an ornamental pattern such that a sphere 4 inches in diameter cannot pass t 36. Indicate on Floor Plans at walls and soffits of useable space under interior stairs, one-hour fire-resistive construction on t Fire-Resistance Design Manual. (Sec 1003.3.3.9 and Table 7-C Footnote #1)

BUILDING SECTION DETAIL

SCALE: 1/4" = 1'-0"

* FLAME SPREAD RATING FOR MAIN AREAS IS CLASS 3
FLAME SPREAD RATING FOR ENTRY AND HALLS IS CLASS 2

FRAMING NOTES:

- 1. STUD TO PLATE 2x6 3-10d, 2x4 2-10d,
- 2. DOUBLE 2x6 OR 2x4 TWO ROWS 2d @16" STAGGERED.
- 3. FLOOR RIM AND BEAM PLYS TO BE FASTENED WITH 3 ROWS 10d NAILS @ 12".
- 4. HEADER PLYS TO BE FASTENED WITH 3 ROWS 10d @8"
- 5. HEADERS TO BE (3) 2x W/1/2" OSB FILLERS.
- 6. MINIMUM TOP PLATE LAP TO BE 48".
- 7. STUD GRADE TO BE SPF#2 OR BETTER.
- 8. PLATE GRADE TO BE SPF#2 OR BETTER
- 9. RIM GRADE TO BE SPF#2 OR BETTER.
- 10. HEADER GRADE TO BE SPF#2 OR BETTER.
- 11. ROOF TRUSSES PLACED @ 24" O.C.
- 12. 11 1/4" FLOOR TRUSSES PLACED @ 16" O.C.

BUILDER:

MANUFACTURER:

Valley Home

1689 DALEWOOD COURT FAIRFIELD, CA 94534 (707) 429.3300

SUBMITTAL CONSULTANT:
GAEA DESIGN
POWER HOUSE DESIGN GROUP
6608 DEVON DRIVE
LIBERTY TOWNSHIP, OH 45044
(513) 444.0519



PRUJECT NAME: NEW CONSTRUCTION FOR CHARLES ARMSTRONG

DRAWN BY: LCL
DATE: 8.23.16

SCALE: NONE

REVISIONS:

REVISIONS:			
NO:	DATE:	DESCRIPTION:	
1.	10.10.16	CRAWLSPACE	

APPROVAL STAMPS:

GENERAL NOTES

EXTERIOR JOINTS IN THE BUILDING ENVELOPE
THAT ARE SOURCES OF AIR LEAKAGE SUCH AS
ROUND WINDOWS AND DOOR FRAMES, BETWEEN
WALLS AND FOUNDATIONS, BETWEEN WALLS AND
ROOF/CEILING AND BETWEEN WALL PANELS,
OPENINGS AT PENETRATIONS OF UTILITY SERVICES
THROUGH WALLS, FLOORS, AND ROOFS AND ALL
OTHER SUCH OPENINGS IN THE BUILDING ENVELOPE
SHALL BE CAULKED, GASKETED, WEATHER STRIPPED,
OR OTHERWISE SEALED IN AN APPROVED MANNER

SOFFIT VENTS AND RIDGE VENTS EQUAL TO 1/150 OF TOTAL ROOF AREA (THIS FACTOR MAY BE REDUCED TO 1/300 WHEN A VAPOR BARRIER OF 1 PERM OR LESS IS INSTALLED IN ATTIC)

CONSTRUCTION WILL BE COMPLIANT WITH ALL STATE CODES

SHEET TITLE
SECTIONS &
DETAILS

DRAWING NUMBER

SE1