

MODIFICATION TO USE PERMIT AND SITE APPROVAL 0671-17P-17A

PROJECT NAME :

ANTIOCHIAN ORTHODOX CHURCH OF THE REDEEMER

ADDRESS: 380 MAGDALENA AVE, LOS ALTOS, CA

CONTACT

OWNER ANTIOCHIAN ORTHODOX CHURCH OF THE REDEEMER 380 MAGDALENA DRIVE LOS ALTOS, CA	
ARCHITECT LPMD ARCHITECTS 1288 KIFER ROAD, SUITE 206 SUNNYVALE, CA. 94086 PHONE (408) 992-0280 FAX (408) 992-0281	CIVIL ENGINEER OSUNA ENGINEERING INC. 117 BERNAL RD. SUITE 70-336 SAN JOSE, CA 95119 PHONE (408) 772-4381 Info@osunaengineering.com

SCOPE OF WORK IN MODIFICATION :

ADJUST FIRST FLOOR OF FELLOWSHIP HALL TO MOVE OUT OF "DISCOVERED FAULT AREA"
ADJUST SECOND FLOOR TO FOLLOW MODIFICATION TO FIRST FLOOR AREA
ADJUST EXTERIOR ELEVATIONS DUE TO FAULT MODIFICATIONS
REVISE FRONT EXTERIOR ELEVATIONS TO PROVIDE COVERED WALKWAY ALONG FELLOWSHIP HALL
REVISE FRONT AND SIDE EXTERIOR ELEVATIONS TO FOLLOW NEW FOOTPRINT OF FELLOWHIP HALL

PROJECT INFORMATION:

ADDRESS : 380 MAGDALENA AVE, LOS ALTOS HILLS, CA 94024
APN : 331-03-073
LOT SIZE : 92,120 S.F.
EXISTING CHURCH STRUCTURE : 6,614 S.F.

PROPOSED FELLOWSHIP STRUCTURE		
1ST FLOOR	FELLOWSHIP HALL ADMINISTRATION OFFICE	12,225 S.F.
2ND FLOOR	DAY CARE /CLASSROOMS	5,409 S.F.
		17,634 S.F.

DRAWING INDEX:


ARCHITECTURAL

A0	TITLE SHEET
A1	SITE PLAN
A2	1ST FLOOR PLAN
A3	2ND FLOOR PLAN
A4	ELEVATIONS AND SECTIONS

CIVIL

C0	TITLE SHEET
C1	CONCEPTUAL GRADING & DRAINAGE PLAN
C2.1	CONCEPTUAL GRADING & DRAINAGE PLAN
C3	CONSTRUCTION DETAILS
C4.1	SANTA CLARA COUNTY BMP SHEET
C4.2	SANTA CLARA COUNTY BMP SHEET

LOCATION MAP

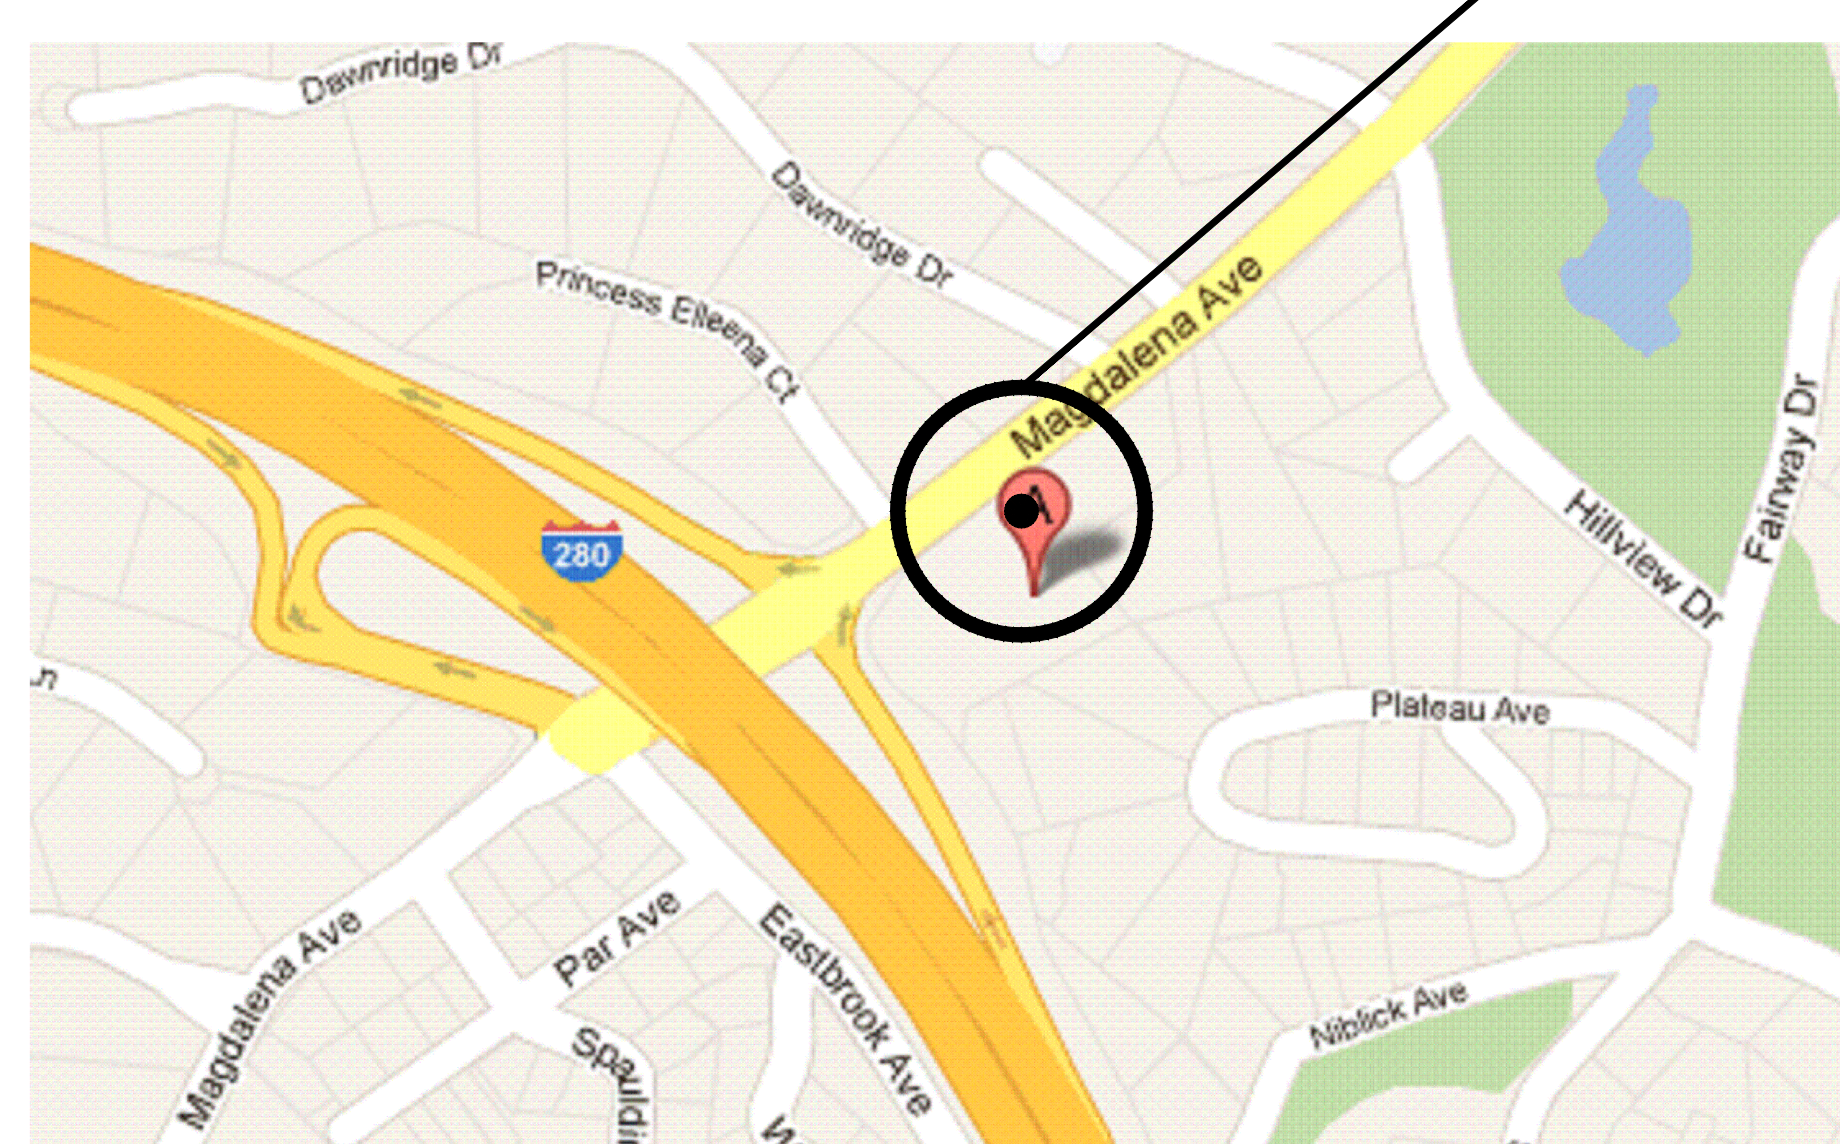

EXISTING PARKING PROVIDED FUR CHURCH USE:	
4 ACCESSIBLE	
22 COMPACT	
65 STANDARD	
TOTAL:	91

PARKING REQUIRED FOR FELLOWSHIP HALL:
FELLOWSHIP HALL (A3 OCCUPANCY) : 361 OCCUPANTS/4 = REQUIRED 90.25 < 91 PROVIDED

CLASSROOM/DAYCARE (E OCCUPANCY) :
CHILDREN (81 CHILDREN/15 = 5.4
STAFF (81 CHILDREN/4) = 20.25
25.65 REQUIRED < 91 REQUIRED

(CHURCH SITE WILL BE UTILIZING SHARED PARKING AS ALL USES ARE NOT OCCUPIED AT SAME TIME)

NEW BUILDING FOOTPRINT: 12,225 S.F.
RATIO : 13.32 % OF SITE AREA

LANDSCAPED AREA: EXISTING

DEVELOPMENT SCHEDULE:
TIME OF COMMENCEMENT OF CONSTRUCTION :
COMPLETION OF CONSTRUCTION :

DEFERRED SUBMITTAL FOR FIRE SPRINKLERS DESIGNED PER NFPA 13 WILL BE REQUIRED AND SUBMITTED TO SANTA CLARA COUNTY FIRE DEPARTMENT FOR APPROVAL DURING BUILDING PERMIT PROCESS

Revisions:

MAY 2020 CHURCH BOARD REVISIONS
DECEMBER 2020 PLANNING COMMENTS

ANTIOCHIAN ORTHODOX
CHURCH OF THE REDEEMER
380 MAGDALENA AVE
LOS ALTOS, CALIFORNIA


Project No: Date: 10-20-2020
Sheet Title:

FELLOWSHIP BUILDING TITLE SHEET

Scale:
Sheet No:

A0

of 20 Sheets

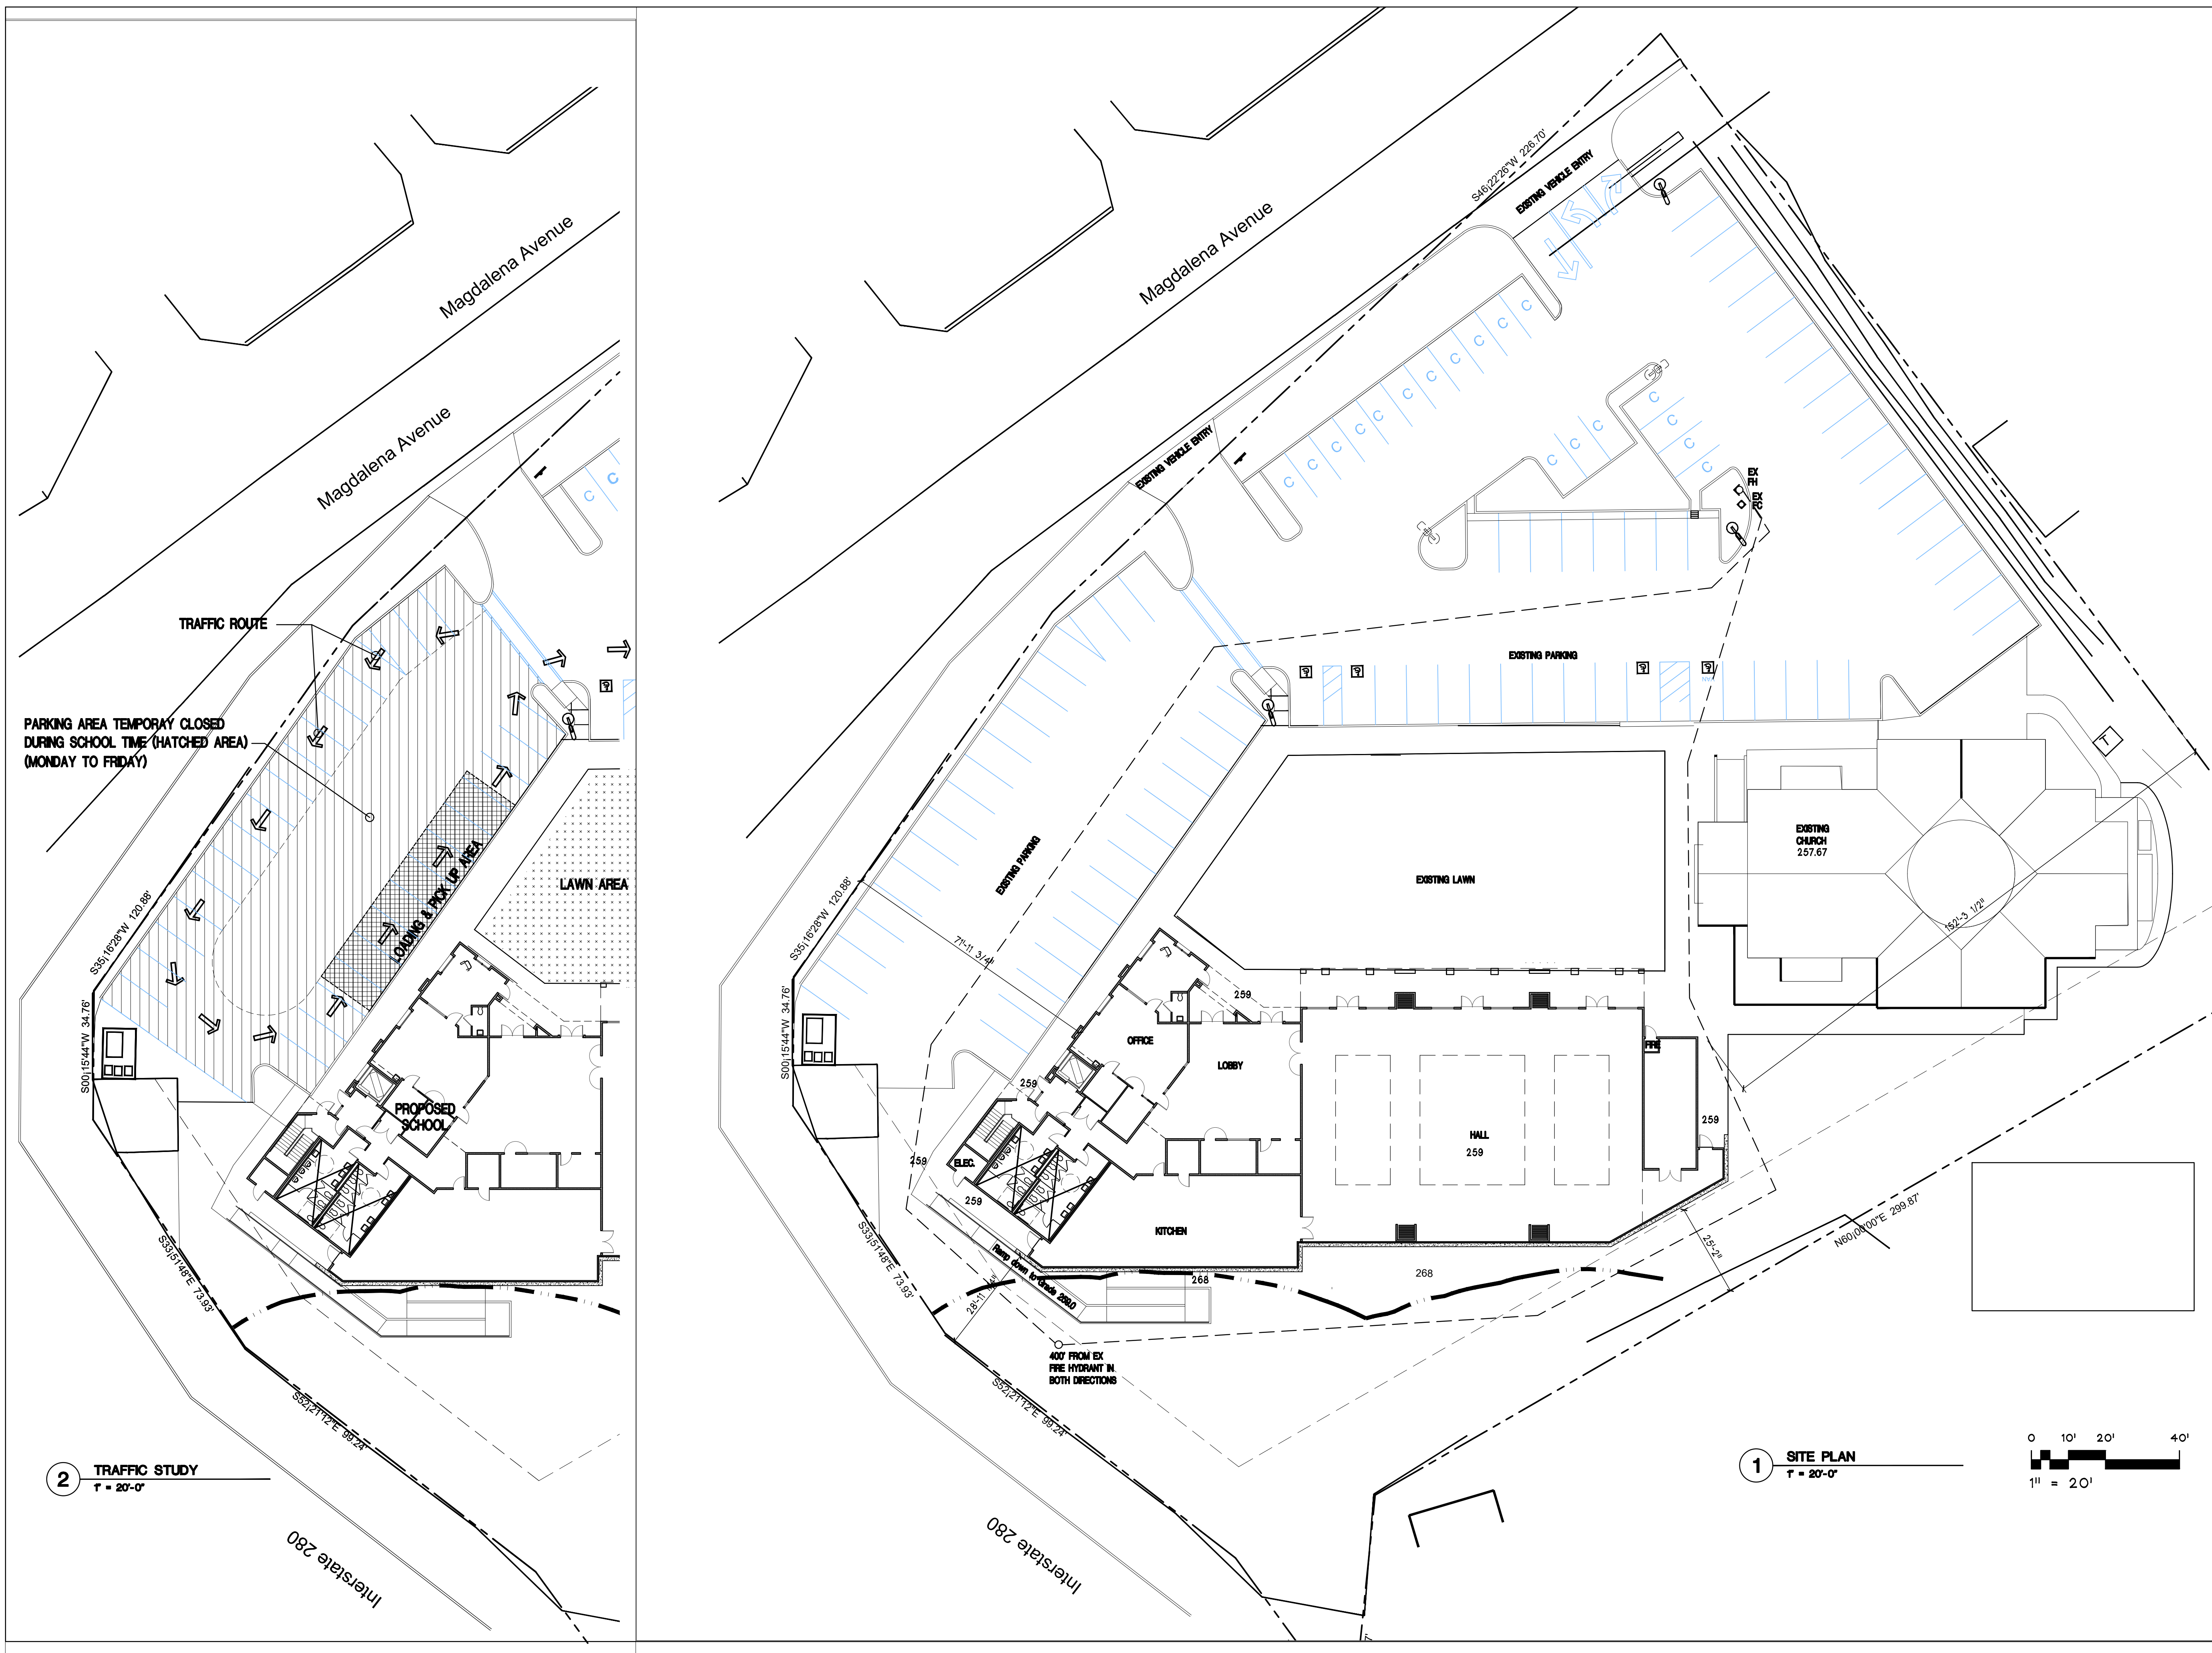

Revisions:
MAY 2020 CHURCH BOARD REVISIONS
DECEMBER 2020 PLANNING COMMENTS


ANTIOCHIAN ORTHODOX
CHURCH OF THE REDEEMER
380 MAGDALENA AVE
LOS ALTOS, CALIFORNIA

Project No: Date: 10-20-2020
Sheet Title:

SITE
PLAN

Scale:
Sheet No:

A1

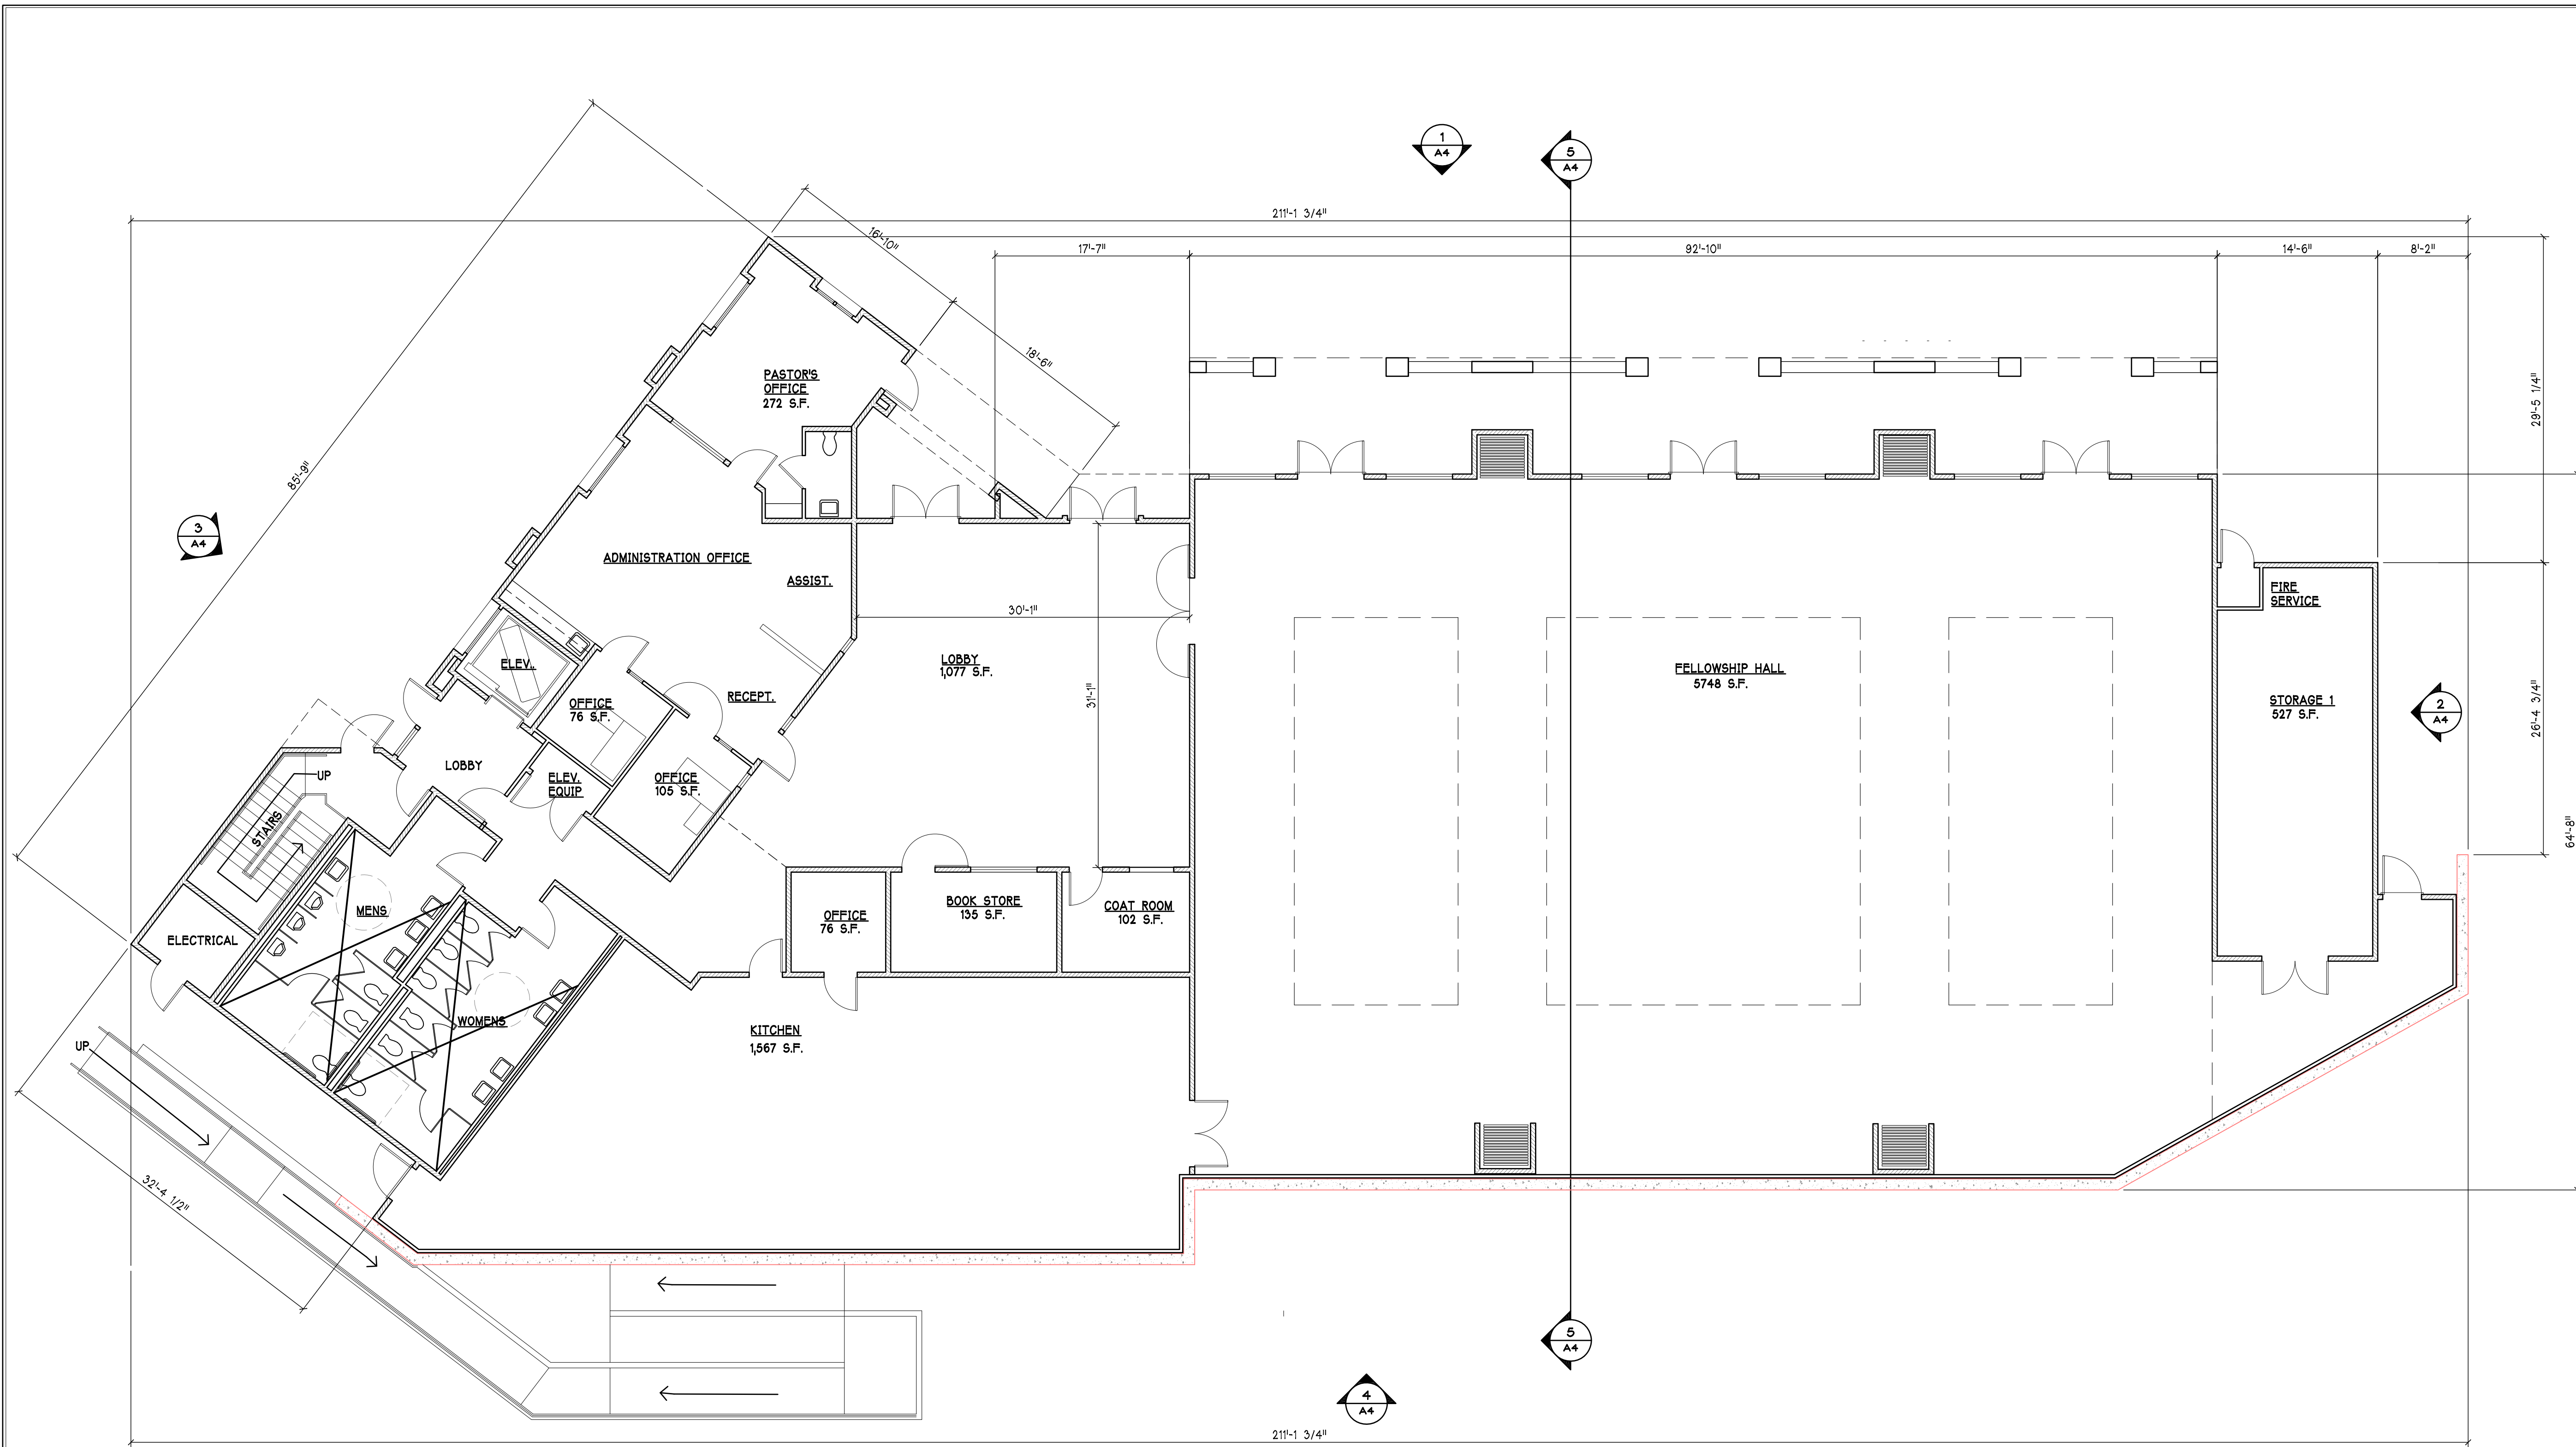

1 FIRST FLOOR
1/8" = 1'-0" 12,255 S.F.

Revisions:
1 MAY 2020 CHURCH BOARD REVISIONS


**ANTIOCHIAN ORTHODOX
CHURCH OF THE REDEEMER**
380 MAGDALENA AVE
LOS ALTOS, CALIFORNIA

Project No: Date: 10-20-2020
Sheet Title:

FIRST FLOOR

Scale:
Sheet No:

A2

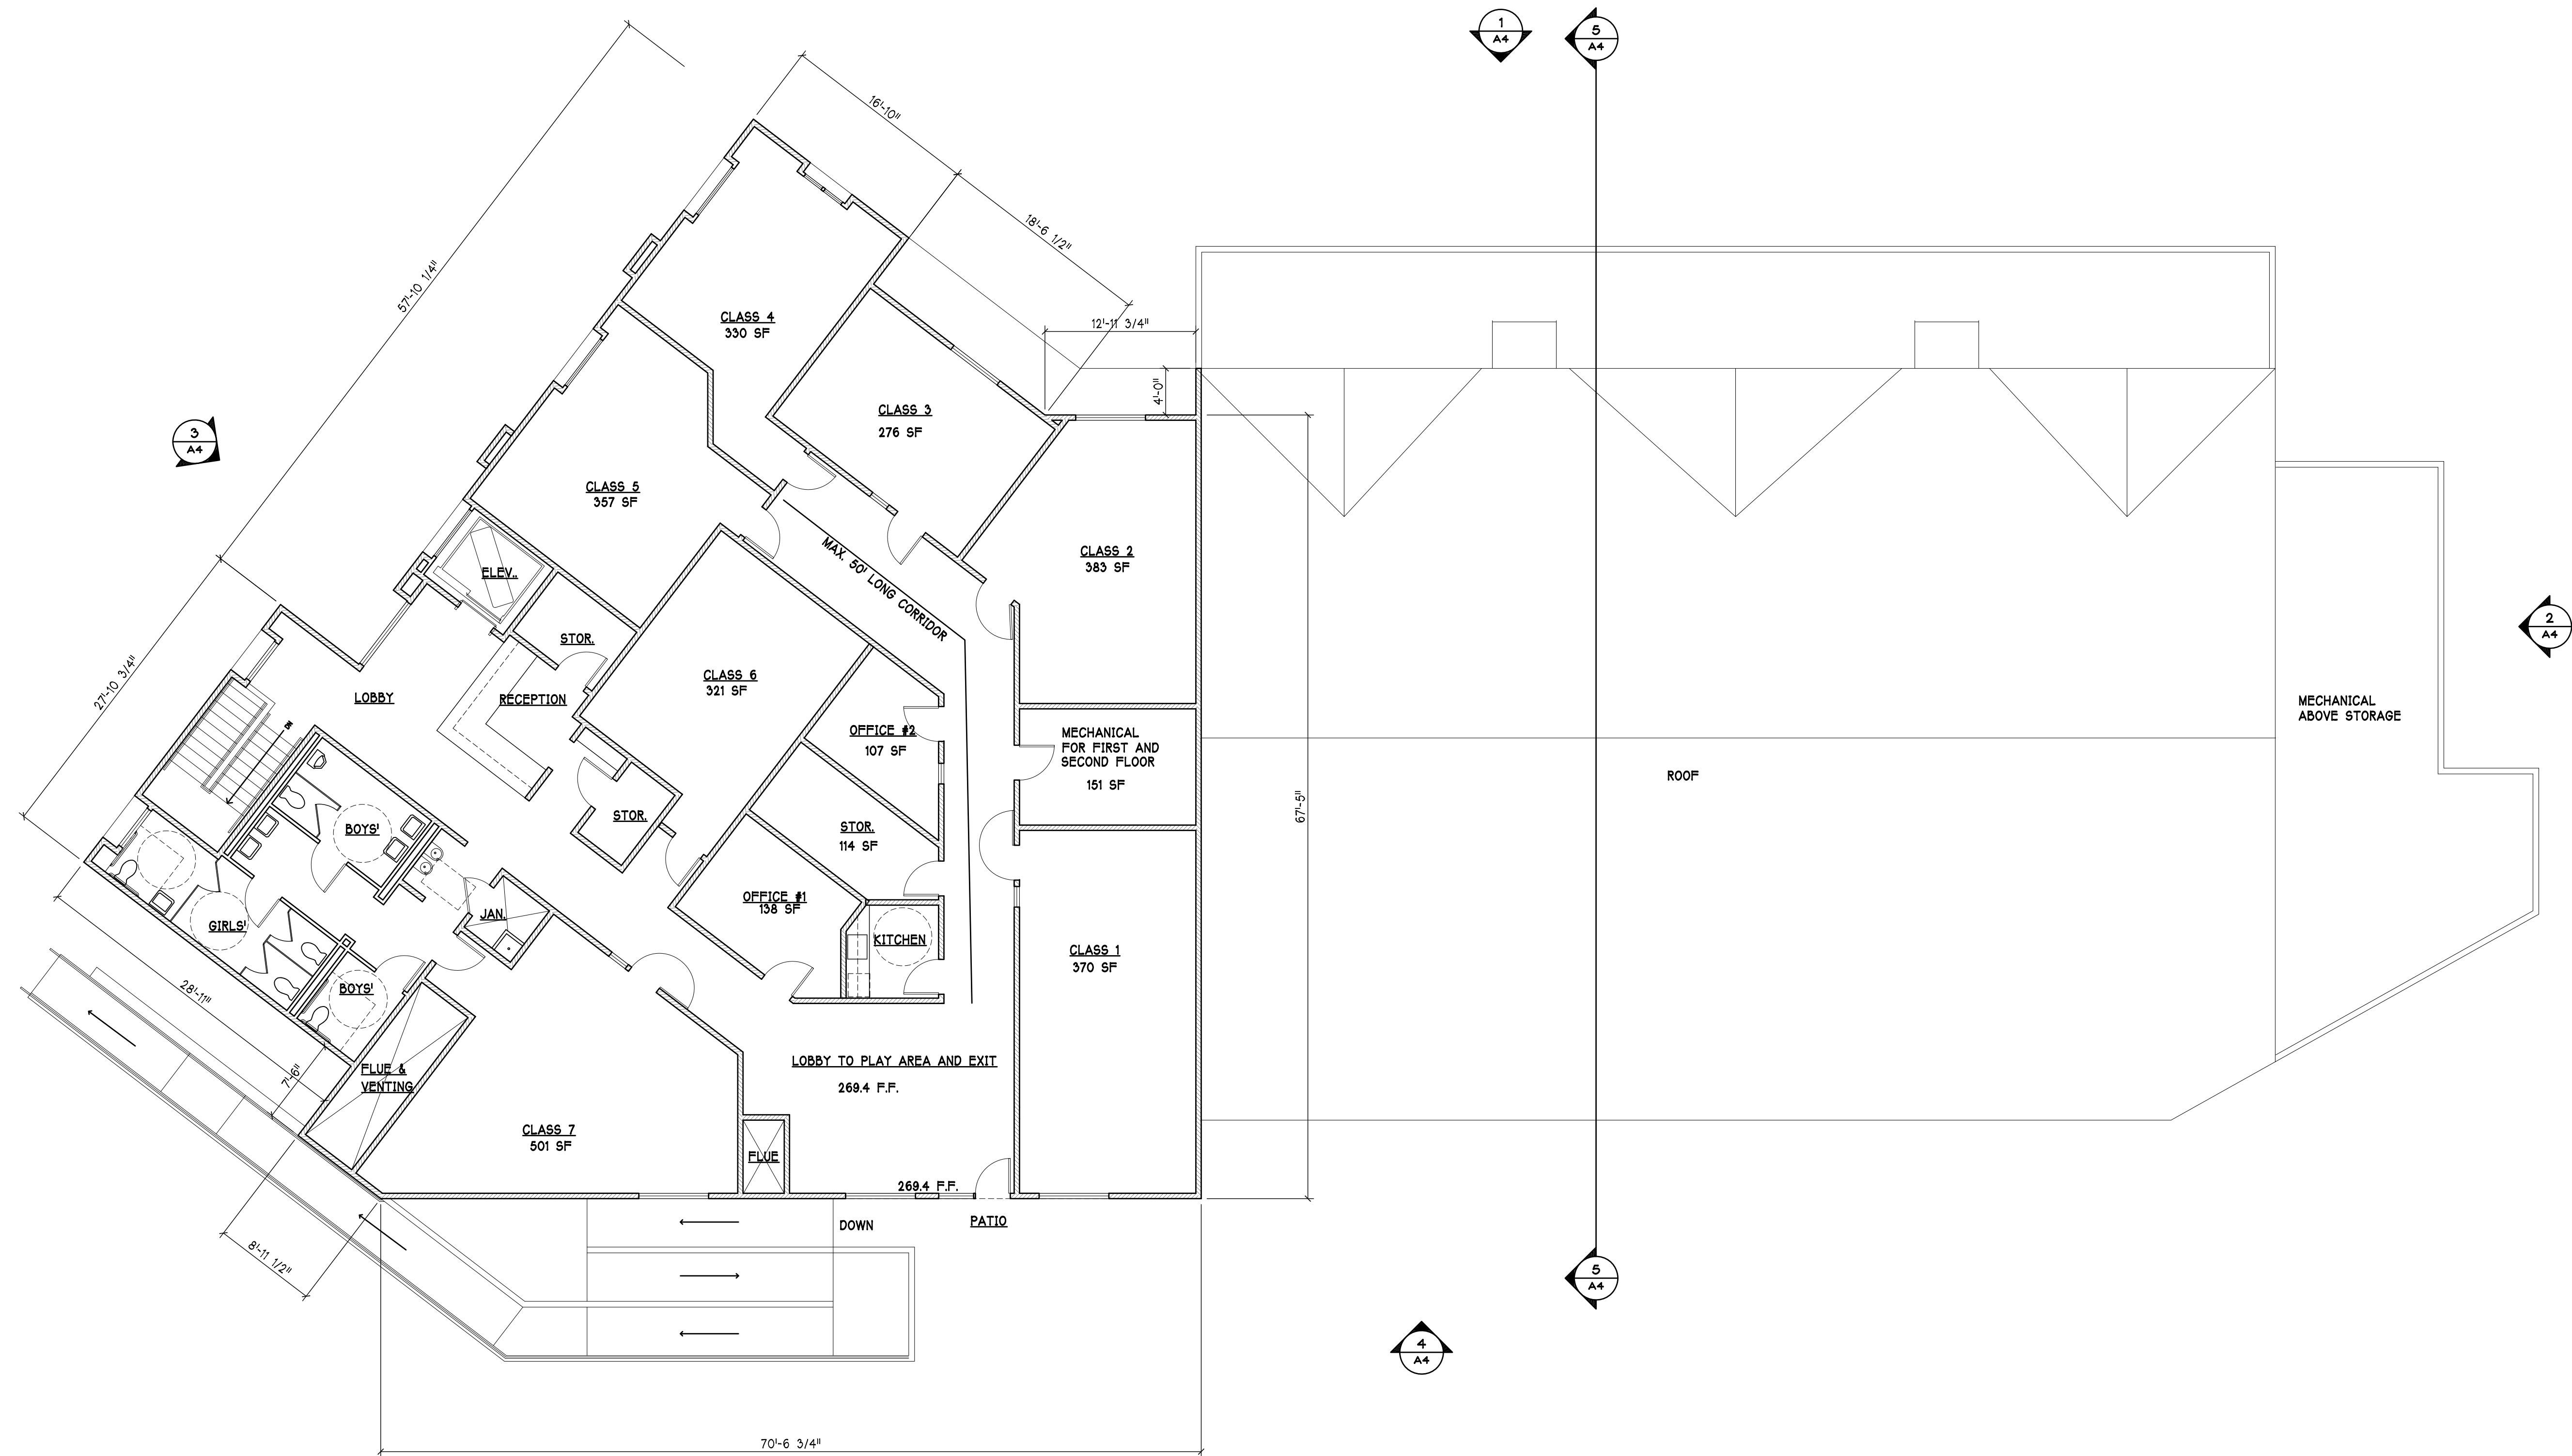

1 SECOND FLOOR 5,409 S.F.
1/8" = 1'-0"

Revisions:

1	MAY 2020 CHURCH BOARD REVISIONS


**ANTIOCHIAN ORTHODOX
CHURCH OF THE REDEEMER**
380 MAGDALENA AVE
LOS ALTOS, CALIFORNIA

Project No: Date: 10-20-2020
Sheet Title:


SECOND FLOOR

Scale: _____
Sheet No: _____


A3

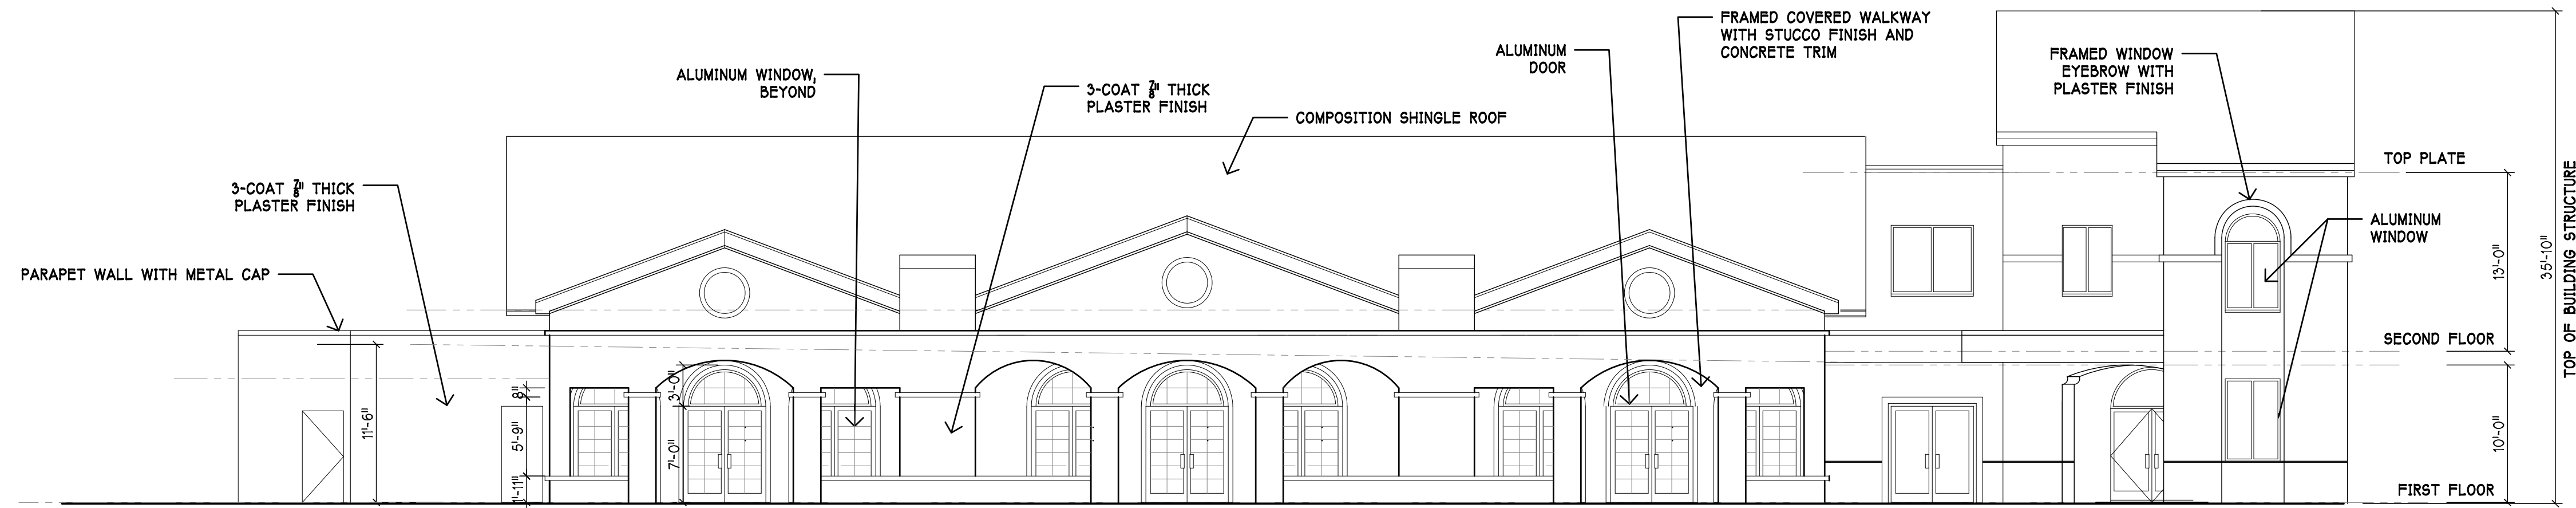


1 NORTH ELEVATION
1/8" = 1'-0"

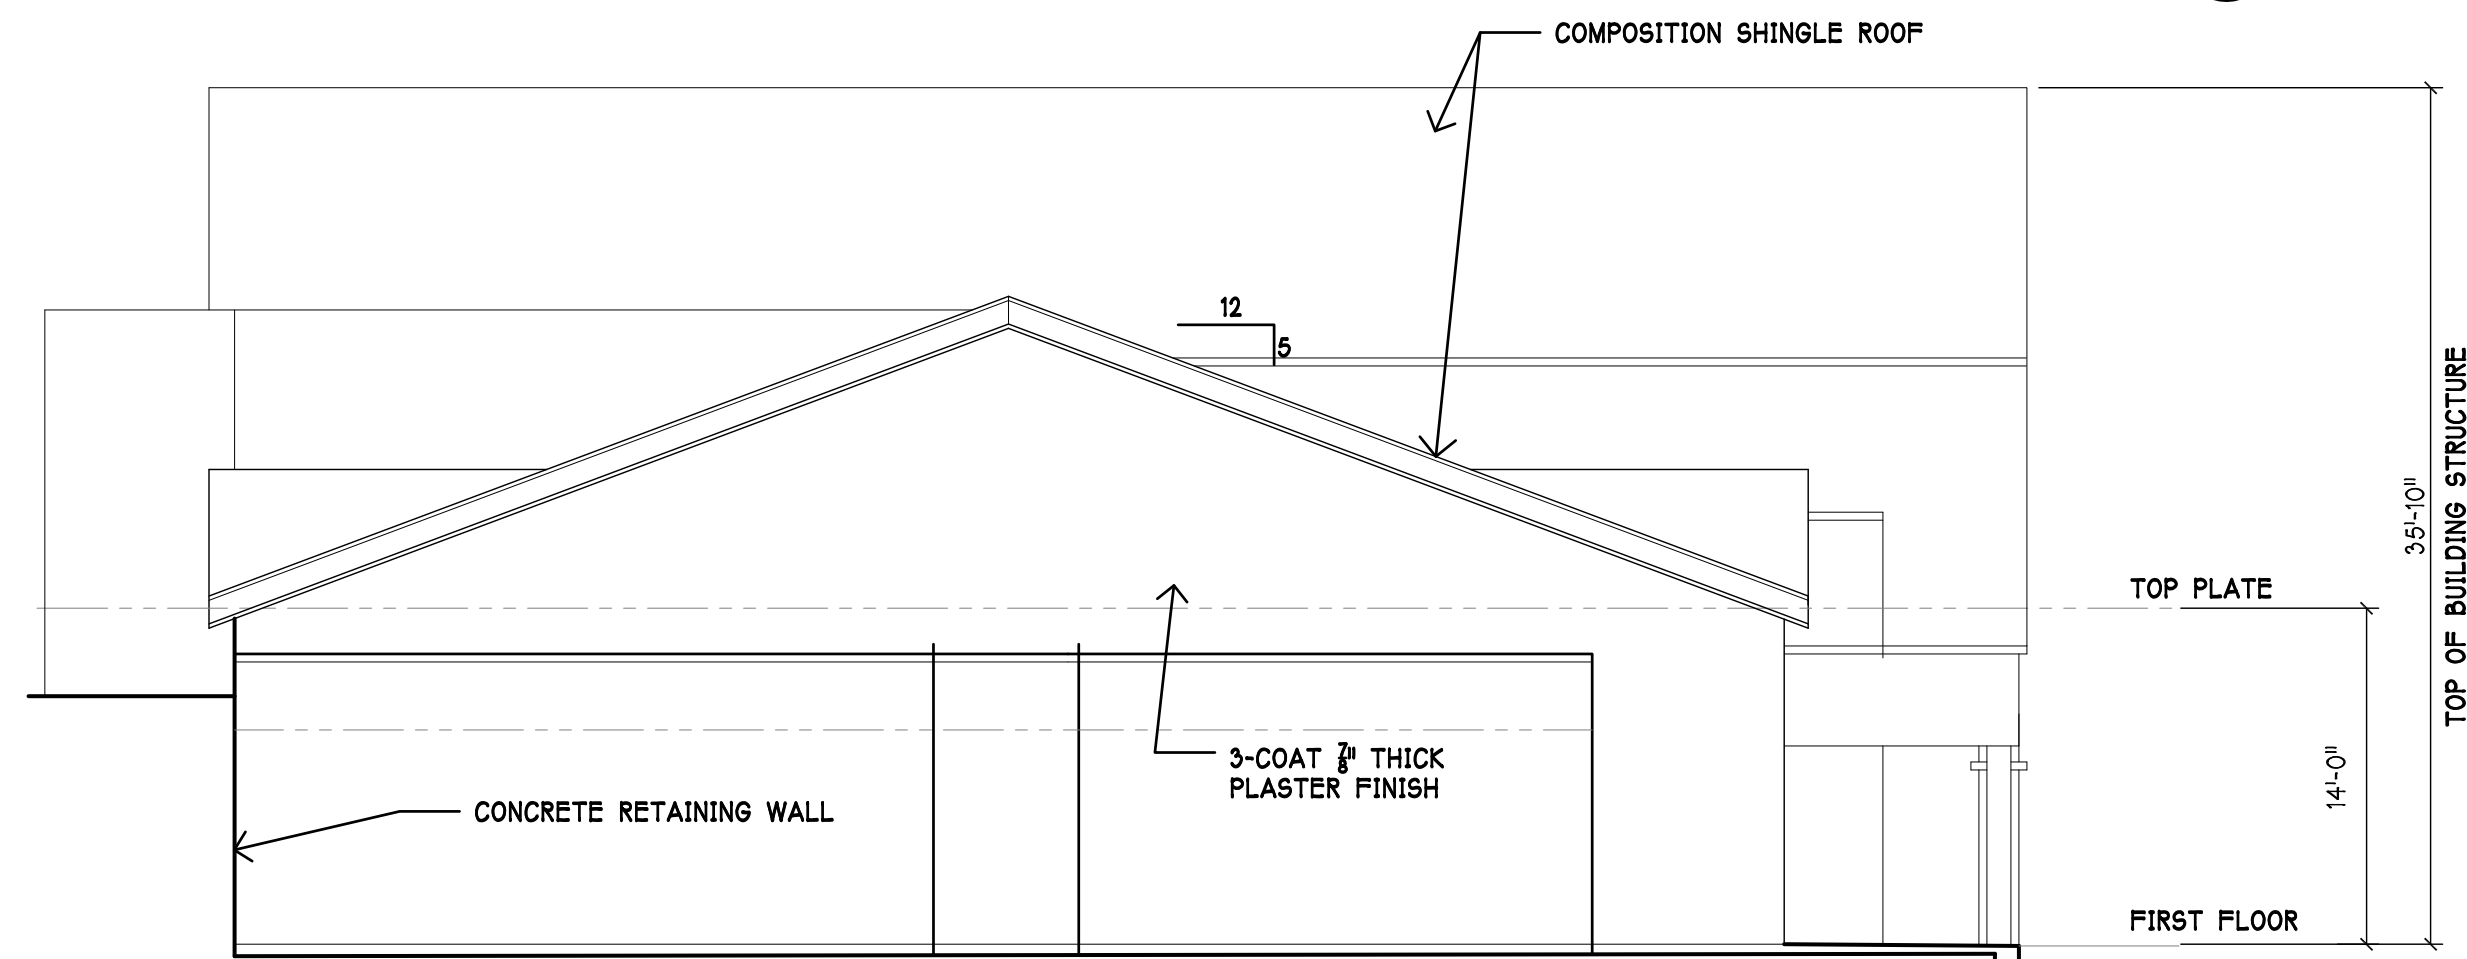


2 NORTH ELEVATION
1/8" = 1'-0"

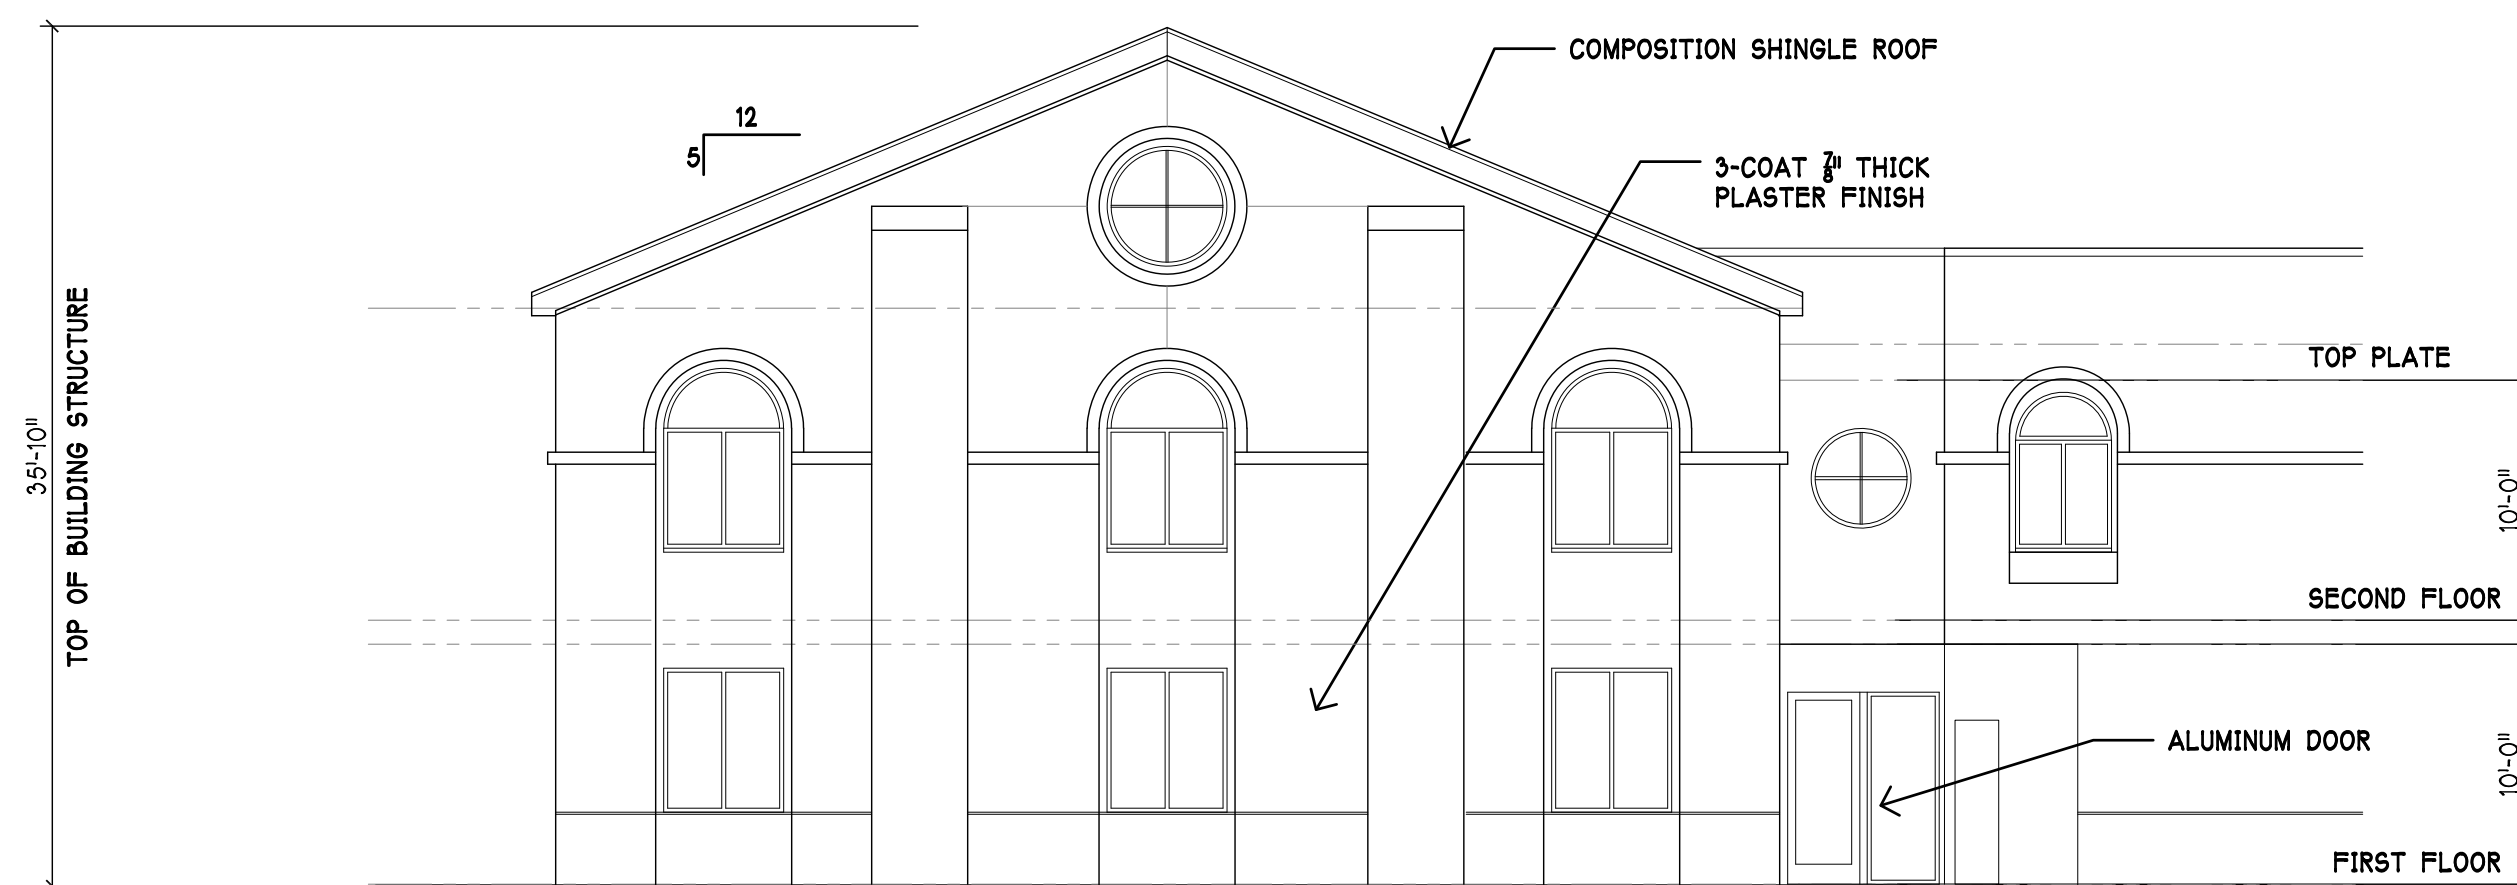

3 WEST ELEVATION
1/8" = 1'-0"

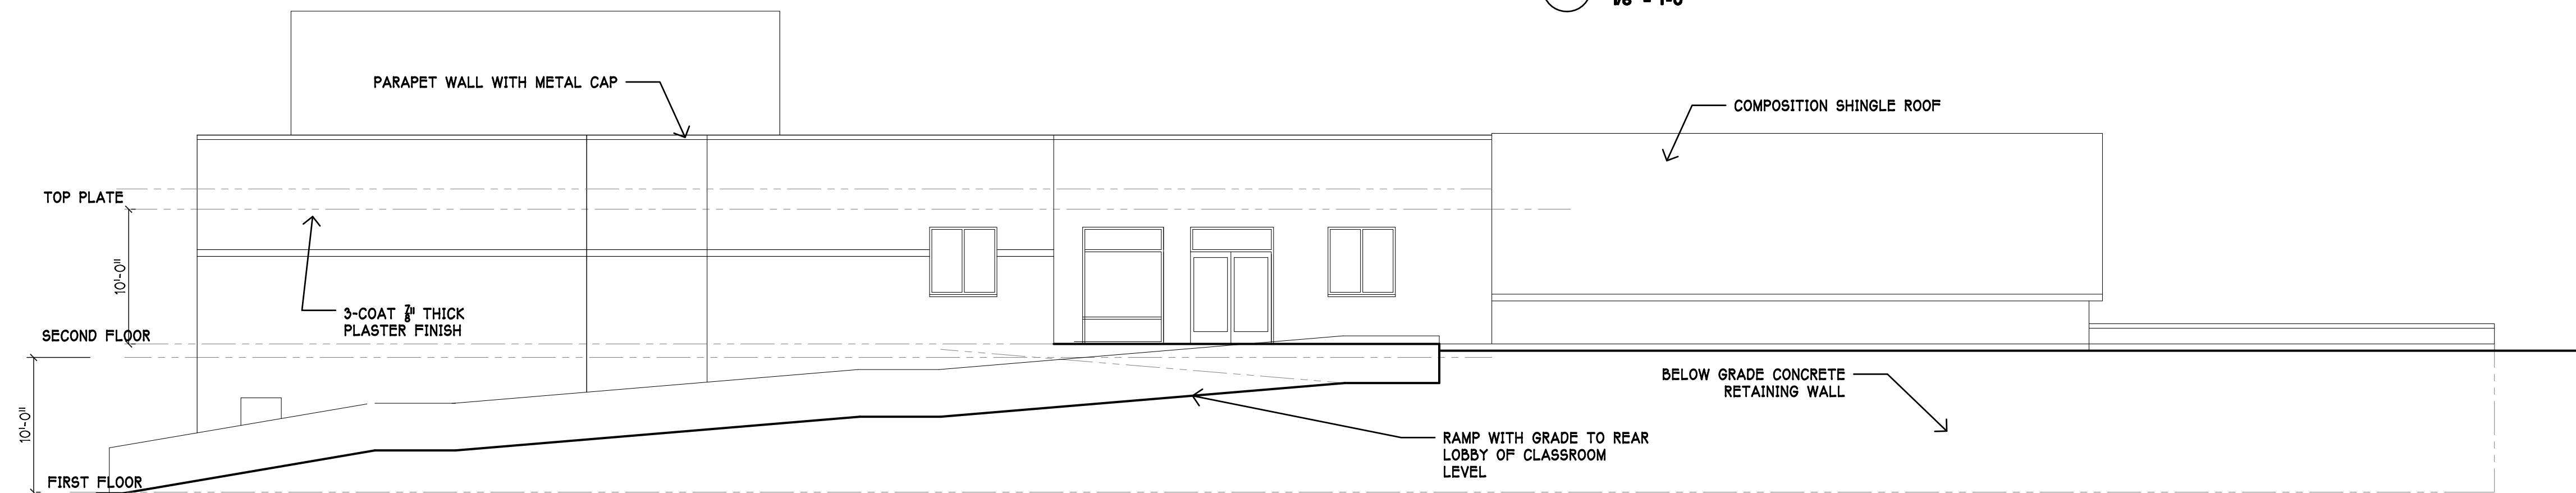

4 EAST ELEVATION
1/8" = 1'-0"

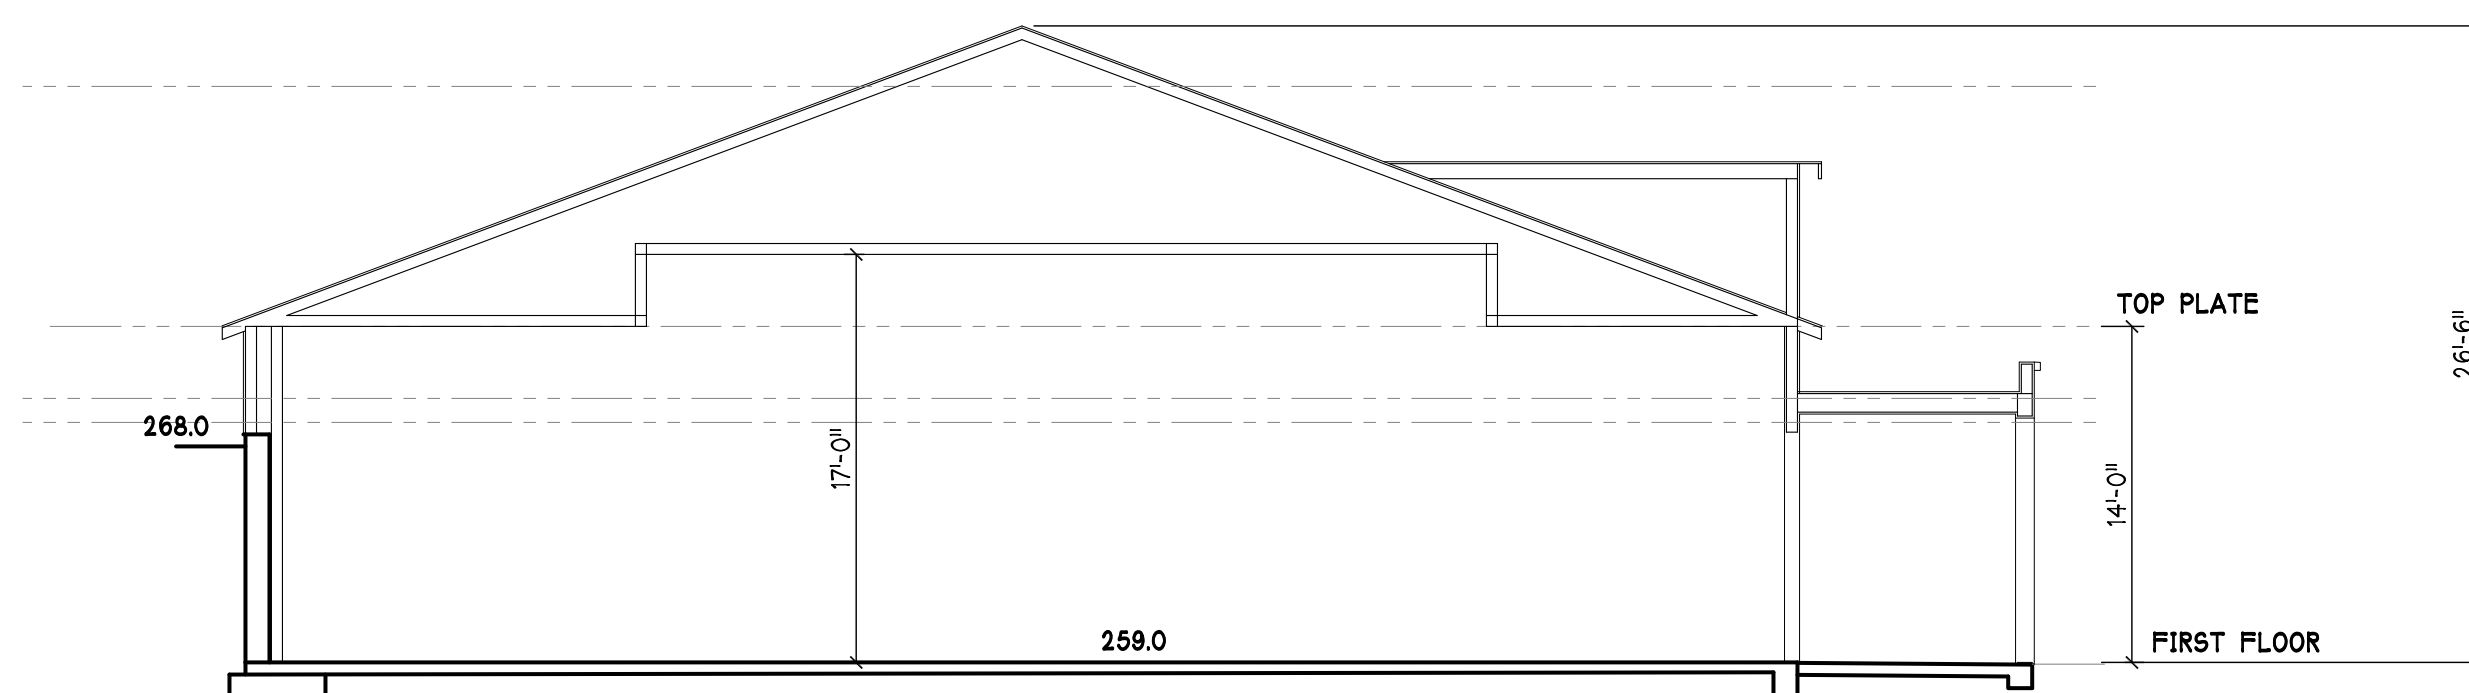

5 BUILDING SECTION
1/8" = 1'-0"

Revisions:
1 MAY 2020 CHURCH BOARD REVISIONS

**ANTIOCHIAN ORTHODOX
CHURCH OF THE REDEEMER**
380 MAGDALENA AVE
LOS ALTOS, CALIFORNIA

Project No: Date: 10-20-2020
Sheet Title:

ELEVATIONS

Scale:
Sheet No:

A4

General Construction Specifications

1. ALL CONSTRUCTION WORK SHALL BE PERFORMED IN ACCORDANCE WITH THE SOILS AND/OR GEOTECHNICAL REPORT PREPARED BY: CORNERSTONE EARTH GROUP, 259 OAKMEAD PARKWAY, SUNNYVALE CA 94085, TEL: (415) 600-0000. THESE PLANS SHALL BE DATED MAY 25, 2019. THIS SPECIFICATION IS SUPPLEMENTED BY: 1) THESE PLANS AND SPECIFICATIONS, 2) THE COUNTY OF SANTA CLARA STANDARD DETAILS, 3) THE COUNTY OF SANTA CLARA STANDARD SPECS, 4) STATE OF CALIFORNIA STANDARD DETAILS, 5) STATE OF CALIFORNIA STANDARD SPECIFICATIONS, IN THE EVENT OF CONFLICT, THE CONTRACT DOCUMENTS SHALL PREVAIL. THE QUALITY, PERFORMANCE AND COMPLETION OF ALL WORK MUST BE TO THE SATISFACTION OF THE COUNTY.
2. DEVELOPER IS RESPONSIBLE FOR INSTALLATION OF THE IMPROVEMENTS SHOWN ON THESE PLANS AND HE OR HIS SUCCESSOR PROPERTY OWNERS ARE RESPONSIBLE FOR THEIR CONTINUED MAINTENANCE.
3. DEVELOPER SHALL BE RESPONSIBLE FOR CORRECTION OF ANY ERRORS OR OMISSIONS IN THESE PLANS. THE COUNTY IS NOT AUTHORIZED TO REQUIRE DISCONTINUANCE OF ANY WORK AND SUCH CORRECTION AND MODIFICATION OF PLANS AS MAY BE NECESSARY TO COMPLY WITH COUNTY STANDARDS OR CONDITIONS OF DEVELOPMENT APPROVAL.
4. EVERY YEARLY MAINTENANCE PERMITS FROM THE SANTA CLARA VALLEY WATER DISTRICT AND CALIFORNIA DEPARTMENT OF TRANSPORTATION WHERE NEEDED, COPIES OF THESE PERMITS SHALL BE KEPT AT THE JOB SITE FOR REVIEW BY THE COUNTY'S INSPECTOR.
5. DEVELOPER SHALL REMAIN RESPONSIBLE FOR TREES TO PROVIDE AN UNOBSTRUCTED FIFTEEN (15) FOOT VERTICAL CLEARANCE FOR ROADWAY AREA. THIS PLAN AUTHORIZES THE REMOVAL OF ONLY THOSE TREES WITH TRUNK DIAMETERS GREATER THAN 12 INCHES MEASURED 4.5 FEET ABOVE THE GROUND THAT ARE SHOWN TO BE REMOVED UNLESS AN AMENDMENT TO THIS PLAN IS OBTAINED FROM THE COUNTY ENGINEER. THE COUNTY ENGINEER'S TRAVEL FROM THE PLANNING OFFICE, IS THE CONTRACTOR'S RESPONSIBILITY TO ENSURE THAT REMOVAL OF ADDITIONAL TREES HAS BEEN PERMITTED.
6. DEVELOPER SHALL PROVIDE ADEQUATE DUST CONTROL AS REQUIRED BY THE COUNTY INSPECTOR.
7. ALL PERSONS MUST COMPLY WITH SECTION 4442 OF THE PUBLIC RESOURCES CODE AND SECTION 13005 OF THE HEALTH AND SAFETY CODE RELATING TO THE USE OF SILENCE ARRESTERS.
8. UPON UNCOVERING OF ANYTHING ANY BURIAL SITE AS EVIDENCED BY HUMAN SKELETAL REMAINS OR ARTIFACTS, THE PERSON MAKING SUCH DISCOVERY SHALL IMMEDIATELY NOTIFY THE COUNTY CORONER AT (408) 454-2520 AND LAND DEVELOPMENT ENGINEERING OFFICE AT (408) 299-5730. THE COUNTY ENGINEER'S DUTY SHALL BE TO ADVISE THE COUNTY ENGINEER AUTHORIZED BY THE LAND DEVELOPMENT OFFICE IN ACCORD WITH PROVISIONS OF THIS ORDINANCE (COUNTY ORDINANCE CODE SECTION B6-18).
9. THESE PLANS ARE FOR THE WORK DESCRIBED IN THE SCOPE OF WORK ONLY. ANY OTHER WORK NOT DESCRIBED IN THE SCOPE OF WORK IS NOT FOR CONSTRUCTION.
10. ANY DEVIATION FROM THESE APPROVED PLANS SHALL BE RE-APPROVED IN WRITING BY THE COUNTY ENGINEER PRIOR TO CONSTRUCTION.

1. THE DEVELOPER'S ENGINEER IS RESPONSIBLE FOR THE INITIAL PLACEMENT AND REPLACEMENT OF CONSTRUCTION GRADE STAKES. THE STAKES ARE TO BE ADEQUATELY IDENTIFIED, LOCATED, STABILIZED, ETC. FOR THE CONVENIENCE OF THE COUNTY INSPECTOR. LATERAL STAKES SET FOR CURBS AND GUTTERS SHALL NOT EXCEED 2 1/2 FEET FROM BACK OF CURB.
2. ANY PROPERTY LINE STAKES OR ROAD MONUMENTS DISTURBED DURING CONSTRUCTION SHALL BE REPLACED BY DEVELOPER'S ENGINEER AND LICENSED LAND SURVEYOR.
3. PROPERTY LINE STAKING MUST BE PERFORMED BY THE PROJECT ENGINEER OR LAND SURVEYOR TO ESTABLISH OR RE-ESTABLISH THE PROJECT BOUNDARY AND SHALL BE INSPECTED BY THE COUNTY INSPECTOR PRIOR TO THE BEGINNING OF THE WORK.
4. PROPERTY CONSTRUCTION STAKES SHALL BE SET IN THE FIELD BY THE PROJECT ENGINEER OR LAND SURVEYOR AND VERIFIED BY THE COUNTY INSPECTOR PRIOR TO THE COMMENCEMENT OF GRADING.

1. CONTRACTOR SHALL NOTIFY PERMIT INSPECTION UNIT, SANTA CLARA COUNTY PRIOR TO COMMENCING WORK AND FOR FINAL INSPECTION OF WORK AND SITE.
2. CONTRACTOR SHALL ADVISE PERMIT INSPECTION UNIT, SANTA CLARA COUNTY FOR GENERAL INSPECTION, 48 HOURS FOR ASPHALT CONCRETE INSPECTION.
3. INSPECTION BY SANTA CLARA COUNTY SHALL BE LIMITED TO INSPECTION OF MATERIALS AND PROCESSES OF CONSTRUCTION TO OBSERVE THEIR COMPLIANCE WITH PLANS AND SPECIFICATIONS AND TO ENFORCE THE RESPONSIBILITY FOR THE SUPERINTENDENT OF CONSTRUCTION, SITE CONDITIONS, EQUIPMENT OR PERSONNEL. CONTRACTOR SHALL NOTIFY THE COUNTY LAND DEVELOPMENT DEPARTMENT, 1000 NORTH 1ST AVE., SUITE 200, SAN JOSE, CA 95113, PRIOR TO COMMENCING WORK AND FOR FINAL INSPECTION OF WORK AND SITE.
4. DEVELOPER AND/OR HIS AUTHORIZED REPRESENTATIVE MUST SUBMIT WRITTEN REQUEST FOR INSPECTION AND ACCOMPANYING ADVISORY REPORT. REQUEST SHALL BE DIRECTED TO THE INSPECTION OFFICE NOTED ON THE PERMIT FORM.
5. THE CONTRACTOR SHALL PROVIDE TO THE COUNTY CONSTRUCTION INSPECTOR WITH PAD EVIDENCE AND LOCATION CERTIFICATES, PREPARED BY THE COUNTY CONSTRUCTION INSPECTOR AND COUNTY LAND SURVEYOR, PRIOR TO COMMENCEMENT OF THE BUILDING FOUNDATION.

1. EXISTING TREES AUTHORIZED FOR REMOVAL, ROOTS, AND FOREIGN MATERIAL IN AREAS TO BE IMPROVED WILL BE REMOVED TO AN AUTHORIZED DISPOSAL SITE AS FOLLOWS:

1. CONTRACTOR SHALL NOTIFY USA (UNDERGROUND SERVICE ALERT) AT 1-800-277-2600 A MINIMUM OF 24 HOURS BEFORE BEGINNING UNDERGROUND WORK FOR VERIFICATION OF THE LOCATION OF UNDERGROUND UTILITIES.
2. ACCURATE VERIFICATION AS TO SIZE, LOCATION, AND DEPTH OF EXISTING UNDERGROUND CONDUITS OR FACILITIES SHALL BE THE INDIVIDUAL CONTRACTORS RESPONSIBILITY. PLAN LOCATIONS ARE APPROXIMATE AND FOR INFORMATION ONLY.
3. ALL UNDERGROUND INSTALLATIONS SHALL BE IN PLACE AND THE TRENCH BACKFILLED AND COMPACTED BEFORE PLACING AGGREGATE BASE MATERIAL OR SURFACE STRUCTURES. SURFACING MAY BE DONE IF THE UTILITY COMPANY OR INDIVIDUAL INSTALLER IS NOTIFIED BY THE COUNTY AND EXPRESSLY AUTHORIZED BY THE COUNTY, GAS AND WATER MAINS SHALL BE INSTALLED OUTSIDE THE PAVED AREAS.
4. ALL EXISTING PAVEMENT AREAS SHALL BE SAND MATERIAL IN ACCORDANCE WITH THE APPLICABLE PROVISIONS OF THE STATE SPECIFICATIONS. THE STRUCTURAL SECTION FOR TRENCH REPLACEMENT SHALL BE SAND NOT COMPACTED TO A RELATIVE COMPACTION OF AT LEAST 90% AND MATERIAL COMPACTED TO A RELATIVE COMPACTION OF AT LEAST 95% AND 4 INCHES OF HOT ASPHALT CONCRETE PLACED IN TWO LIFTS. TRENCH RESTORATION FOR HIGHER TYPE PAVEMENTS SHALL BE MADE IN KIND OR AS SPECIFIED BY THE COUNTY.
5. TRENCH BACKFILL IN NEW CONSTRUCTION AREAS SHALL BE SAND MATERIAL COMPACTED TO A RELATIVE COMPACTION OF AT LEAST 90% OF THE MATERIAL SELECTED FOR THE TRENCH. IF THE SAND IS NOT FOUND TO BE THE NATIVE SOIL IS SUITABLE FOR USE AS TRENCH BACKFILL BUT THE COMPACTION REQUIREMENTS WILL NOT BE THEREBY WAIVED.
6. BACKFILL AND TRENCH RESTORATION REQUIREMENTS SHALL APPLY AS A MINIMUM TO AREAS TO UNDERGROUND FACILITIES INSTALLED BY OTHER FIRMS OR PUBLIC AGENCIES.

1. REINFORCED CONCRETE AND CONCRETE MASONRY UNIT RETAINING WALLS SHALL HAVE FOUNDATION AND REINFORCEMENT INSPECTED BY THE COUNTY ENGINEERING INSPECTOR AND ENGINEER OF RECORD PRIOR TO POURING THE FOUNDATION AND FORMING THE WALL.
2. SEGMENTAL BLOCK RETAINING WALLS SHALL HAVE FOUNDATION AND REINFORCEMENT INSPECTED BY THE COUNTY ENGINEERING INSPECTOR.

1. EXCAVATED MATERIAL SHALL BE PLACED IN THE FILL AREAS DESIGNATED OR SHALL BE HAULED AWAY FROM THE SITE TO A COUNTY APPROVED DISPOSAL AREA. THE FILL MATERIAL SHALL BE PLACED IN LIFTS OF 6" MAXIMUM. IT SHALL BE STRIPPED OF ALL VEGETATION, TO ACHIEVE A PROPER BOND WITH THE FILL MATERIAL, THE SURFACE OF THE GROUND SHALL BE SCARIFIED TO DEPTH OF 6" BEFORE FILL IS PLACED. WHERE NATURAL GROUND IS STEEPER THAN 2:1, THE FILL SHALL BE PLACED IN LIFTS OF 4" MAXIMUM. WHEN NEW FILL IS TO BE PLACED ON EXISTING FILL, THE EXISTING FILL SHALL BE REMOVED UNTIL MATERIAL COMPACTED TO 90% RELATIVE COMPACTION IS REACHED. WHEN NEW FILL IS TO BE PLACED ON EXISTING SUBGRADE, SEE CONSTRUCTION NOTES. FILL MATERIAL SHALL BE PLACED IN UNIFORM LIFTS NOT EXCEEDING 6" IN UNCOMPACTED THICKNESS. BEFORE COMPACTION BEGINS, THE FILL SHALL BE BROUGHT TO A WATER CONTENT THAT WILL PERMIT EFFECTIVE COMPACTION BY EITHER HAND OR MECHANICAL MEANS. (SEE FOOTNOTES FOR 2.)
2. MOISTENING THE FILL WITH WATER IF IT IS TOO DRY. EACH LIFT SHALL BE THOROUGHLY MIXED BEFORE COMPACTION TO ENSURE A UNIFORM DISTRIBUTION OF MOISTURE.
3. EXCESS MATERIAL SHALL NOT BE SPREAD OR STOCKPILED ON THE SITE.
4. SURPLUS EARTH FILL MATERIAL SHALL BE PLACED IN A SINGLE (8" MAX) THIN LAYER COMPACTED TO WITHSTAND WEATHERING IN THE AREA(S) DELINEATED ON THE PLAN.
5. THE UPPER 6" OF SUBGRADE BELOW DRIVEWAY ACCESS ROAD OR PARKING AREA SHALL BE COMPACTED TO 95% OF MAXIMUM DENSITY.
6. THE SLOPE SHALL BE PLACED TO 1 HORIZONTAL TO VERTICAL. MAXIMUM FILL SLOPE SHALL BE 2 HORIZONTAL TO 1 VERTICAL.

EXCESS MATERIAL SHALL BE OFF HAULED TO A COUNTY APPROVED DUMP SITE.

7. NOTIFY SOILS ENGINEER TWO (2) DAYS PRIOR TO COMMENCEMENT OF ANY GRADING WORK TO COORDINATE THE WORK IN THE FIELD.

8. ALL MATERIALS FOR FILL SHOULD BE APPROVED BY THE SOILS ENGINEER BEFORE IT IS BROUGHT TO THE SITE.

9. THE UPPER 6" OF THE SUBGRADE SOIL SHALL BE SCARIFIED, MOISTURE ADJUSTED AND COMPACTIONED TO A MINIMUM RELATIVE COMPACTION OF 95%.

10. ALL AGGREGATE BASE MATERIAL SHALL BE COMPACTED TO A MINIMUM 95% RELATIVE COMPACTION.

11. THE GEOTECHNICAL REVIEW LETTER MUST BE REVIEWED AND APPROVED BY THE COUNTY GEOLOGIST PRIOR TO FINAL APPROVAL BY THE COUNTY ENGINEER FOR BUILDING OCCUPANCY.

12. THE PROJECT GEOTECHNICAL ENGINEER SHALL PERFORM COMPACTION TESTING AND PRESENT THE RESULTS TO THE COUNTY ENGINEERING INSPECTOR PRIOR TO THE CONSTRUCTION OF ANY PAVED AREA.

13. GRADING WORK BETWEEN OCTOBER 15TH AND APRIL 15TH IS AT THE DISCRETION OF THE SANTA CLARA COUNTY GRADING OFFICIAL.

14. TOTAL DISTURBED AREA FOR THE PROJECT

42,304 SF

15. WID NO. N/A

16. THE INSPECTOR MAY VERIFY THAT A VALID NOTICE OF INTENT (NOI) HAS BEEN ISSUED BY THE STATE AND THAT A CURRENT AND UP TO DATE STORM WATER POLLUTION PREVENTION PLAN (SWPPP) IS AVAILABLE ON SITE.

1. FOR ALL TREES TO BE RETAINED WITH A CANOPY IN THE DEVELOPMENT AREA OR INTERSECTING THE DEVELOPMENT, THE TREE SHALL BE PROTECTED BY THE DEVELOPMENT ON SITE. THE TREES SHALL BE PROTECTED BY THE PLACEMENT OF RIGID TREE PROTECTIVE FENCING, CONSISTENT WITH THE COUNTY INTEGRATED LANDSCAPE GUIDELINES, AND INCLUDE THE FOLLOWING:
 - A. FENCING SHOULD BE PLACED ON THE OUTSIDE EDGE OF THE DRIPLINE OF THE TREE OR GROVE OF TREES.
 - B. THE FENCING SHALL BE MAINTAINED THROUGHOUT THE SITE CONSTRUCTION. PERSONNEL SHALL BE INSPECTED PERIODICALLY FOR DAMAGE AND PROPER FUNCTION.
 - C. FENCING SHALL BE REPAIRED, AS NECESSARY, TO PROVIDE A PHYSICAL BARRIER FROM CONSTRUCTION ACTIVITIES.
 - D. SIGNAGE STATING, "WARNING: TREES SHALL NOT BE REMOVED WITHOUT PERMISSION FROM THE SANTA CLARA COUNTY PLANNING OFFICE (408) 299-5770. COUNTY OF SANTA CLARA TREE PROTECTION MEASURES SHOULD BE FOUND AT <http://www.sccplanning.org>" SHALL BE PLACED ON THE TREE PROTECTIVE FENCING UNTIL FINAL OCCUPANCY.
2. PRIOR TO COMMENCEMENT OF ANY CONSTRUCTION ACTIVITY, TREE PROTECTIVE FENCING SHALL BE SECURELY IN PLACED AND INSPECTED BY THE LAND DEVELOPER OR TREE ENGINEERING CONSULTANT.
3. SEE EXISTING TREE PROTECTION DETAILS FOR MORE INFORMATION.

1. DRIVEWAY LOCATIONS SHALL BE AS SHOWN ON THE IMPROVEMENT PLANS WITH CENTERLINE STATIONING. THE MINIMUM CONCRETE THICKNESS SHALL BE 6 INCHES THROUGHOUT (WITH A MAXIMUM APPROACH SLOPE OF 1 1/4 INCHES PER FOOT).
2. ALL DRIVEWAY OR COMMON ACCESS ROAD SECTIONS IN EXCESS OF 15' LONGITUDINAL SLOPE MUST BE PAVED WITH A MINIMUM 2-INCH ASPHALT LIFT OR FULL DEPTH CONCRETE LIFT PRIOR TO ANY COMBUSTIBLE FRAMING.
3. ALL DRIVEWAYS AND COMMON ACCESS ROADS SHALL BE CONSIDERED AS PART OF THE PROJECT SITE ACCESS AND NEIGHBORHOOD ACCESS FOR EMERGENCY VEHICLES AND LOCAL RESIDENTS.
4. ROADWAYS DESIGNATED AS NOT COUNTY MAINTAINED ROADS AS SHOWN ON THE MAPS SHALL BE ELIGIBLE FOR COUNTY MAINTENANCE UNTIL THE ROADWAYS ARE IMPROVED (AT NO COST TO THE COUNTY) TO THE PUBLIC MAINTENANCE ROAD STANDARDS APPROVED BY THE BOARD OF SUPERVISORS AND IN EFFECT AT SUCH TIME THAT THE ROADWAYS ARE CONSIDERED FOR COUNTY MAINTENANCE.
5. ALL WORK IN THE COUNTY ROAD RIGHT-OF-WAY REQUIRES AN ENCROACHMENT PERMIT FROM THE ROADS AND AIRPORTS DEPARTMENT. EACH INDIVIDUAL ACTIVITY REQUIRES A SEPARATE PERMIT (E.G. CABLE, ELECTRICAL, LANDSCAPING, TREE REMOVAL, STORM DRAINAGE IMPROVEMENTS, ETC.).

1. PACIFIC GAS & ELECTRIC ELECTROLIER SERVICE FEE SHALL BE PAID BY THE DEVELOPER AND/OR HIS AUTHORIZED REPRESENTATIVE.

1. THE SANITARY SEWER AND WATER UTILITIES SHOWN ON THESE PLANS ARE NOT PART OF THIS GRADING PERMIT AND ARE SHOWN FOR REFERENCE ONLY.
2. ALL MATERIALS AND METHODS OF CONSTRUCTION OF SANITARY SEWERS SHALL CONFORM TO THE SPECIFICATIONS OF THE JURISDICTION INVOLVED. INSPECTION OF SANITARY SEWER WORK SHALL BE DONE BY SAID JURISDICTION.

1. CONCRETE USED FOR STRUCTURAL PURPOSES SHALL BE CLASS "A" (6 SACK PER CUBIC YARD) AS SPECIFIED IN THE STATE STANDARD SPECIFICATIONS. CONCRETE PLACED MUST DEVELOP A MINIMUM STRENGTH FACTOR OF 2800 PSI IN A SEVEN-DAY PERIOD. THE CONCRETE MIX DESIGN SHALL BE UNDER THE CONTINUAL CONTROL OF THE COUNTY INSPECTOR.

1. WATER ALL ACTIVE CONSTRUCTION AREAS AT LEAST TWICE DAILY.
2. COVER ALL TRUCKS HAULING SOIL, SAND, AND OTHER LOOSE MATERIALS OR DIRT ON TRUCKS TO PREVENT DUST FROM BEING RELEASED INTO THE AIR.
3. PAVE, APPLY WATER THREE TIMES DAILY, OR APPLY (NON-TOXIC) SOIL STABILIZERS ON ALL UNPAVED ACCESS ROADS, PARKING AREAS AND STAGING AREAS FOR CONSTRUCTION.
4. SWEEP DAILY (WITH WATER SWEEPERS) ALL PAVED ACCESS ROADS, PARKING AREAS AND STAGING AREAS AT CONSTRUCTION SITES. THE USE OF DRY POWDER SWEEPING IS PROHIBITED.
5. SWEEP DAILY (WITH WATER SWEEPERS) IF VISIBLE SOIL MATERIAL IS CARRIED ON ADJACENT PUBLIC STREETS. THE USE OF DRY POWDER SWEEPING IS PROHIBITED.
6. ALL CONSTRUCTION VEHICLES, EQUIPMENT AND DELIVERY TRUCKS SHALL HAVE A MAXIMUM IDLING TIME OF 5 MINUTES (AS REQUIRED BY THE CALIFORNIA AIRBORNE TOXIC CONTROL MEASURE TITLE 13, SECTION 2485 OF CALIFORNIA CODE OF REGULATIONS (CCR)). ENGINES SHALL BE SHUT OFF IF IDLING FOR LONGER PERIODS THAN REQUIRED BY THE RULES UNLESS NECESSARY FOR PROPER OPERATION OF THE VEHICLE.
7. ALL VEHICLE SPEEDS ON UNPAVED ROADS SHALL BE LIMITED TO 15 MILES PER HOUR.
8. ALL CONSTRUCTION EQUIPMENT SHALL BE MAINTAINED AND PROPERLY TUNED IN ACCORDANCE WITH MANUFACTURER'S SPECIFICATIONS. ALL EQUIPMENT SHALL BE CHECKED BY A CERTIFIED MECHANIC AND DETERMINED TO BE RUNNING AT PROPER CONDITIONS.
9. POST A SIGN THAT IS AT LEAST 32 SQUARE FEET MINIMUM 2 INCHES LETTER HEIGHT VISIBLE NEAR THE ENTRANCE OF CONSTRUCTION SITE THAT IDENTIFIES THE DUST MINIMIZATION PLAN AND THE CONTACT PERSON FOR THE DUST MINIMIZATION FROM ROADS DEPARTMENT OR OTHER APPLICABLE AGENCY IF REQUIRED.

10. POLLUTION COMPLAINT HOTLINE OF 1-800-334-6367.
11. ALL FILL SLOPES SHALL BE COMPACTED AND LEFT IN A SMOOTH AND FIRM CONDITION CAPABLE OF WITHSTANDING WEATHERING.
12. ALL EXPOSED DISTURBED AREAS SHALL BE SEEDING WITH BROME SEED SPREAD AT THE RATE OF 5 LB. PER 1000 SQUARE FEET (OR APPROVED EQUAL). SEEDING AND WATERING SHALL BE MAINTAINED AS REQUIRED TO ENSURE GROWTH.
13. ALL DITCHES SHALL BE LINED PER COUNTY STANDARD SDB.
14. ALL STORM DRAINAGE STRUCTURES SHALL BE INSTALLED WITH EFFECTIVE ENTRANCE & OUTFALL EROSION CONTROLS E.G. SACKED CONCRETE RIP-RAP. ENERGY DISSIPATORS SHALL BE INSTALLED AT ALL DITCH OUTFALLS, WHERE OUTFALLS ARE NOT INTO AN EXISTING CREEK OR WATER COURSE, RUNOFF SHALL BE RELEASED TO THE CREEK OR WATER COURSE.
15. PRIOR TO GRADING COMPLETION AND RELEASE OF THE BOND, ALL GRADED AREAS SHALL BE RESEEDING IN CONFORMANCE WITH THE COUNTY GRADING ORDINANCE TO MINIMIZE THE VISUAL IMPACTS OF THE GRADE SLOPES AND REDUCE EROSION POTENTIAL. EROSION CONTROL MEASURES SHALL BE INSTALLED.
16. PERMANENT LANDSCAPING SHOWN ON THE ATTACHED LANDSCAPE PLAN MUST BE INSTALLED AND FIELD APPROVED BY THE COUNTY PLANNING OFFICE PRIOR TO FINAL APPROVAL BY THE COUNTY ENGINEER, AND FINAL OCCUPANCY PERMIT OF THE BUILDING INSPECTION OFFICE.
17. THE OWNER SHALL PREPARE AND PRESENT AN ANNUAL WATERIZATION REPORT TO THE COUNTY INSPECTOR FOR REVIEW PRIOR TO OCTOBER 15TH OF EVERY YEAR.

INCLUDING SEDIMENT, CONSTRUCTION MATERIALS, EXCAVATED MATERIALS, AND WASTE INTO THE SANTA CLARA COUNTY RIGHT-OF-WAY, STORM SEWER WATERWAYS, ROADWAY INFRASTRUCTURE. SMPs SHALL INCLUDE, BUT NOT BE LIMITED TO THE FOLLOWING;

- A. PREVENTION OF POLLUTANTS IN STORM WATER DISCHARGES FROM THE CONSTRUCTION SITE AND THE CONTRACTOR'S MATERIAL AND EQUIPMENT LAYDOWN STAGING AREAS.
- B. PREVENTION OF TIPPING OF MUD, DIRT, AND CONSTRUCTION MATERIALS ONTO THE PUBLIC ROAD RIGHT-OF-WAY.
- C. PREVENTION OF DISCHARGE OF WATER RUN-OFF DURING DRY AND WET WEATHER CONDITIONS ONTO THE PUBLIC ROAD RIGHT-OF-WAY.

18. THE OWNER, CONTRACTOR AND PERSONS PERFORMING CONSTRUCTION ACTIVITIES SHALL ENSURE THAT ALL TEMPORARY CONSTRUCTION FACILITIES, INCLUDING BUT NOT LIMITED TO CONSTRUCTION MATERIALS, DELIVERIES, HAZARDOUS AND NON-HAZARDOUS MATERIAL STORAGE, EQUIPMENT, TOOLS, AND SUPPLIES, TOILETS, AND WASH AREAS, ARE LOCATED OUTSIDE THE YARDS, SECONDARY CONTAINMENT AREAS, ETC. ARE LOCATED OUTSIDE THE SANTA CLARA COUNTY ROAD RIGHT-OF-WAY.

19. EROSION CONTROL PLAN IS A GUIDE AND SHALL BE MODIFIED AS NECESSARY TO PREVENT EROSION. EROSION CONTROL MEASURES MAY VARY BASED UPON DEPENDING ON THE SEASON, WEATHER, AND FIELD CONDITIONS. EROSION CONTROL MEASURES IN ADDITION TO THOSE NOTED IN THE PERMITTED PLANS MAY BE NECESSARY. FAILURE TO INSTALL SITE AND SITUATIONALLY APPROPRIATE EROSION CONTROL MEASURES MAY RESULT IN VIOLATIONS, FINES, AND A STOPPAGE OF WORK.

1. DEVELOPER IS RESPONSIBLE FOR ALL NECESSARY DRAINAGE FACILITIES WHETHER SHOWN ON THE PLANS OR NOT AND HE OR HIS SUCCESSOR PROPERTY OWNERS ARE RESPONSIBLE FOR THE ADEQUACY AND CONTINUED MAINTENANCE OF DRAINAGE FACILITIES. DRAINAGE FACILITIES SHALL BE NO HAZARD TO LIFE, HEALTH, OR DAMAGE TO ADJOINING PROPERTY, CONSISTENT WITH NPDES PERMIT C45612008 / ORDER NO. R2-2009-0047 AND NPDES PERMIT C456120000 / ORDER NO. R2-2009-0047.
2. DRAIN INLETS SHALL BE CONSTRUCTED TO STANDARD TYPE "S" UNLESS OTHERWISE NOTED ON THE PLANS. THE DEVELOPER'S ENGINEER SHALL BE RESPONSIBLE FOR THE PROPER LOCATION OF DROP INLETS, WHERE STREET PROFILE GRADE EXCEEDS 1.5% AND CULVERTS SHALL BE INSTALLED AT 500' MAXIMUM CURB LINE TO ACCEPT WATER OR AS SHOWN ON THE PLANS.
3. WHERE CULVERTS ARE INSTALLED THE DEVELOPER SHALL BE RESPONSIBLE FOR GRADING THE OUTLET PAVEMENT TO DRAIN TO AN EXISTING SWALE OR TO AN ADJACENT STREET OR DRAINAGE FACILITY.
4. UPON INSTALLATION OF DRAINAGE CONNECTIONS, PROPERTY OWNERS SHALL PROVIDE FOR THE UNINTERRUPTED FLOW OF WATER IN ROADSIDE DITCHES, CULVERTS, AND DRAINAGE FACILITIES. THE DEVELOPER SHALL PROVIDE FOR STORMWATER MANAGEMENT FEATURES PRIOR TO BACKFILL.

THIS IS A TRUE COPY OF THE AS-BUILT PLANS. THERE (___ WERE) (___ WERE NOT) MINOR FIELD CHANGES - MARKED WITH THE SYMBOL (^). THERE (___ WERE) (___ WERE NOT) PLAN REVISIONS INDICATING SIGNIFICANT CHANGES REVIEWED BY THE COUNTY ENGINEER AND MARKED WITH THE SYMBOL Δ.

NOTE: THIS STATEMENT IS TO BE SIGNED BY THE PERSON AUTHORIZED BY THE COUNTY ENGINEER TO PERFORM THE INSPECTION WORK. A REPRODUCIBLE COPY OF THE AS-BUILT PLANS MUST BE FURNISHED TO THE COUNTY ENGINEER AFTER CONSTRUCTION.

1. A CONSTRUCTION OBSERVATION LETTER FROM THE RESPONSIBLE GEOTECHNICAL ENGINEER AND ENGINEERING GEOLOGIST DETAILING CONSTRUCTION OBSERVATIONS AND CERTIFYING THAT THE WORK WAS DONE IN ACCORDANCE WITH THE RECOMMENDATIONS IN THE GEOTECHNICAL AND GEOLOGIC REPORTS SHALL BE SUBMITTED PRIOR TO THE GRADING COMPLETION AND RELEASE OF THE BOND.



1. PRIOR TO THE COMMENCEMENT OF ANY GRADING, TREE PROTECTIVE FENCING SHALL BE IN PLACE IN ACCORDANCE WITH THE TREE PRESERVATION PLAN AND SHALL BE MAINTAINED BY THE CONTRACTOR'S PERSONNEL. THE FENCE SHALL BE CONSTRUCTION ACTIVITY TO ENSURE THAT THE TREE PROTECTION MEASURES ARE IMPLEMENTED AND ADHERED TO DURING CONSTRUCTION. THIS CONDITION SHALL BE INCORPORATED INTO THE GRADING PLANS.
2. FENCE SHALL BE MINIMUM 4" X 4" POSTS AND 2" X 4" OF STUDY MATERIAL (CHAIN-LINK OR EQUIVALENT STRENGTH/ DURABILITY).
3. FENCE SHALL BE SUPPORTED BY VERTICAL POSTS DRIVEN 2 FEET (MIN) INTO THE GROUND AND SPACED NOT MORE THAN 10 FEET APART.
4. TREE TRUNKS SHALL BE PROTECTED BY FENCING DURING THE CONSTRUCTION PERIOD, INSPECTED PERIODICALLY FOR DAMAGE AND PROPER FUNCTION, REPAIRED AS NECESSARY TO PROVIDE A PHYSICAL BARRIER FROM CONSTRUCTION ACTIVITIES, AND REMAIN IN PLACE UNTIL THE FINAL INSPECTION.
5. A SIGN THAT INCLUDES THE WORDS, "WARNING: THIS FENCE SHALL NOT BE REMOVED WITHOUT THE EXPRESSED PERMISSION OF THE SANTA CLARA COUNTY PLANNING DEPT." SHALL BE SECURELY ATTACHED TO THE FENCE IN A VISUALLY PROMINENT LOCATION.

NO WORK SHALL BE DONE IN THE COUNTY'S RIGHT-OF-WAY WITHOUT AN ENCROACHMENT PERMIT, INCLUDING THE STAGING OF CONSTRUCTION MATERIAL AND THE PLACEMENT OF PORTABLE TOILETS.

HEREBY STATE THAT THESE PLANS ARE IN COMPLIANCE WITH ADOPTED COUNTY STANDARDS, THE APPROVED TENTATIVE MAP (OR PLAN) AND CONDITIONS OF APPROVAL PERTAINING THERETO DATED FILE(S) NO. CONDITIONS OF APPROVAL FILE NO. 671-17P-17A, DATED 8/16/17

DATE 12/18/20 _____
SIGNATURE _____

70829
R.C.E. NO.
6-30-21
EXPIRATION DATE





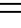

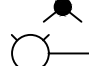












ISSUANCE OF A PERMIT AUTHORIZING CONSTRUCTION DOES NOT RELEASE THE DEVELOPER, PERMITEE OR ENGINEER FROM RESPONSIBILITY FOR THE CORRECTION OF ERRORS OR OMISSIONS CONTAINED IN THE PLANS. IF, DURING THE COURSE OF CONSTRUCTION, THE PUBLIC INTEREST REQUIRES A MODIFICATION OF (OR DEPARTURE FROM) THE SPECIFICATIONS OF THE PLANS, THE COUNTY SHALL HAVE THE AUTHORITY TO REQUIRE THE SUSPENSION OF WORK, AND THE NECESSARY MODIFICATION OR DEPARTURE AND TO SPECIFY THE MANNER IN WHICH THE SAME IS TO BE MADE.

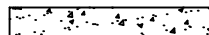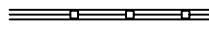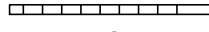DATE	CHRISTOPHER L. FREITAS	
	42107	3/31/20
	R.C.E. NO.	EXPIRATION DATE

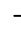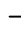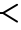PROJECT NAME:
ANTIOCHIAN ORTHODOX CHURCH OF THE
REDEEMER

DESCRIPTION	SYMBOL
BOUNDARY LINE	— — — — —
LOT LINE	— — — — —
EASEMENT LINE	— — — — —
SIDEWALK	
WOOD FENCE	— X — X — X — X —
CHAIN LINK FENCE	— ○ — ○ — ○ — ○ —
RETAINING WALL	
DRIVEWAY DRAIN INLET	
AREA DRAIN	
DROP INLET	
MANHOLE	
FIRE HYDRANT	
ELECTROLIER	
WATER METER	
AC UNIT	
SANITARY SEWER LATERAL	
STORM DRAIN	SD — — — — —
SANITARY SEWER	SS — — — — —
STREET LIGHT CONDUITS	SL — — — — —
WATER	W — — — — —
JOINT TRENCH	JT — — — — —
HOUSE SERVICE	SVC — — — — —
SLOPE ARROW	— — — — — 
EXISTING CONTOUR	100 — — — — —
PROPOSED CONTOUR	 — — — — —
OVERLAND RELEASE	
DIRECTION OF SURFACE DRAINAGE	— — — — — 
5% SLOPE AWAY FROM BUILDING	>>

C0	TITLE SHEET
C1	CONCEPTUAL GRADING & DRAINAGE PLAN
C2.1—C2.2	CONCEPTUAL STORMWATER MANAGEMENT PLAN
C3	SECTIONS & DETAILS
C4.1—C4.2	COUNTY BMP SHEET 1

ENGINEER'S NAME: PORFIRIO OSCAR OSUNA

ADDRESS: 117 BERNAL RD, #70-336
SAN JOSE, CA 95119

PHONE NO. 408-772-4381

EMAIL: info@osunaengineering.com

Revision 1	APN	Sheet C0 of 7
Revision 2	331-03-073	
Revision 3	Co. File	

PLANNING SUBMITTAL – NOT FOR CONSTRUCTION



APPLICANT: _____ ROAD: _____

ROAD: _____

COUNTY FILE NO.: _____

CONTRACTOR AGREES THAT HE SHALL ASSUME SOLE AND COMPLETE RESPONSIBILITY FOR JOB SITE CONDITIONS DURING THE COURSE OF CONSTRUCTION OF THIS PROJECT, INCLUDING SAFETY OF ALL PERSONS AND PROPERTY. THIS REQUIREMENT SHALL APPLY CONTINUOUSLY AND NOT BE LIMITED TO NORMAL WORKING HOURS AND THAT THE CONTRACTOR SHALL BE RESPONSIBLE FOR THE PROTECTION OF ALL EXISTING UTILITIES AND STRUCTURES ON THE PROJECT, EXCEPTING FOR LIABILITY ARISING FROM THE SOLE NEGLIGENCE OF THE OWNER OR THE ENGINEER.

• TOPOGRAPHIC SURVEY STATEMENT
ALL TOPOGRAPHIC FEATURES AND ELEVATIONS HAD BEEN TAKEN FROM SURVEYS BY OTHERS, PROVIDED BY THE OWNER

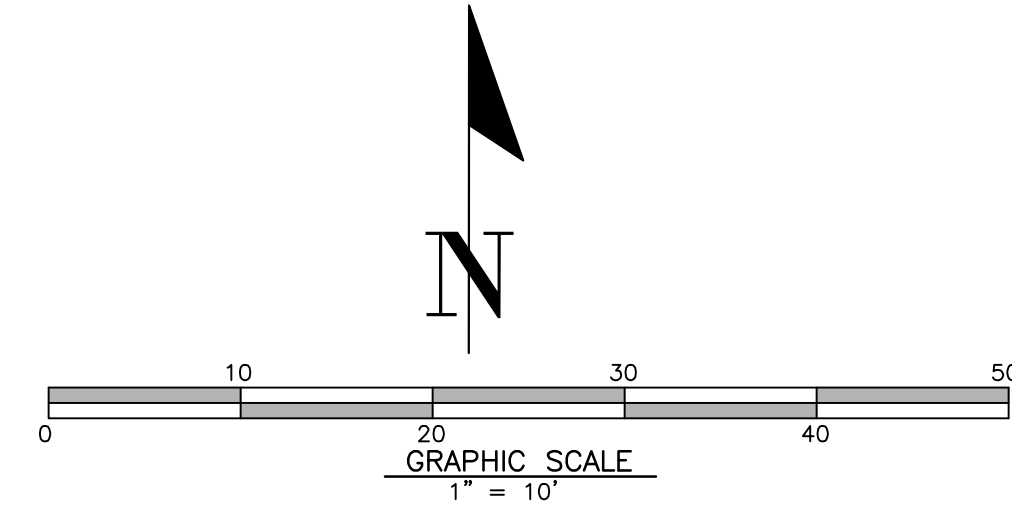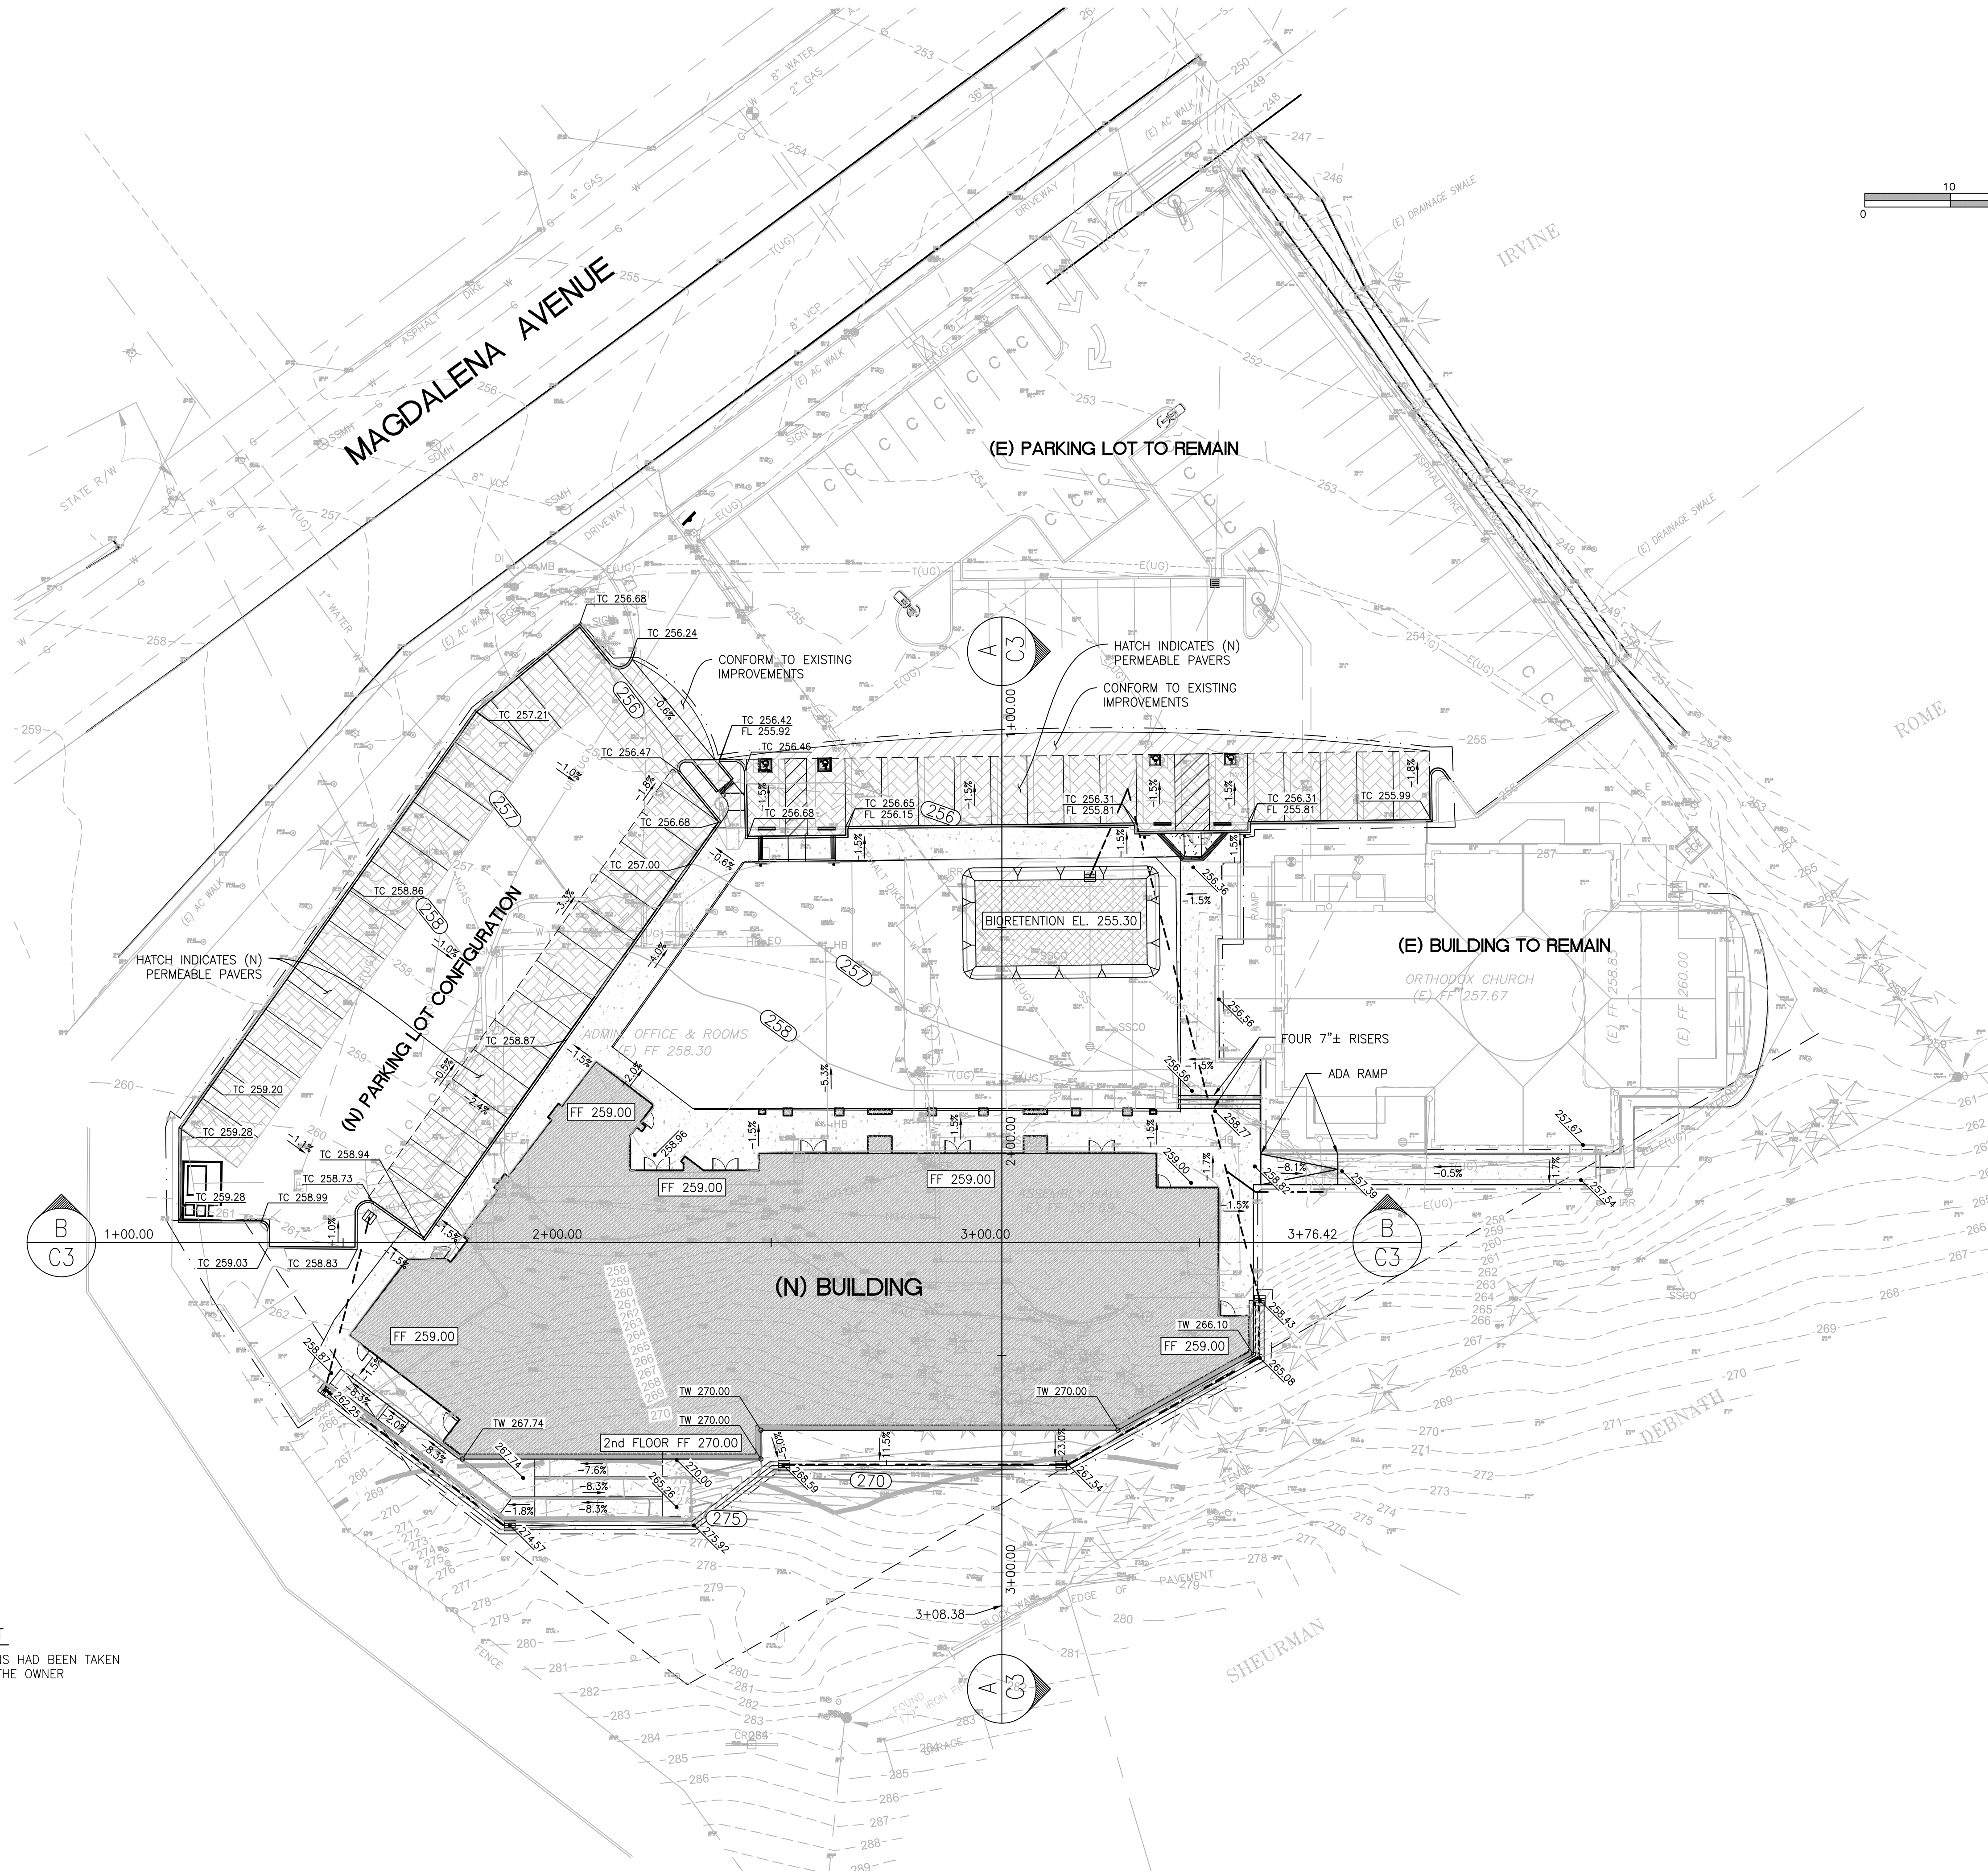


PLANNING SUBMITTAL - NOT FOR CONSTRUCTION


CONCEPTUAL
GRADING & DRAINAGE PLAN

380 MAGDALENA AVE.

LOS ALTOS, CALIFORNIA
Project No.: 1799
Designed: J.O.
Checked: J.O.
Date: 12/18/20

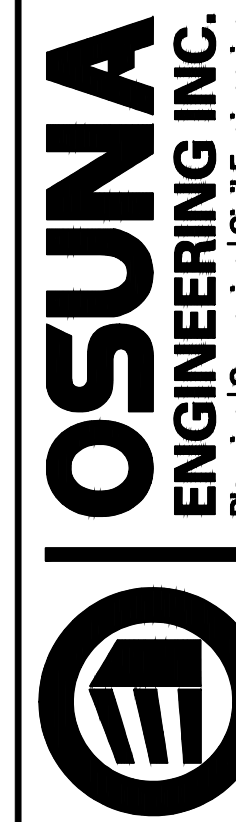

OSUNA
ENGINEERING INC.
Planning | Surveying | Civil Engineering
CONSULTING CIVIL ENGINEERS & LAND SURVEYORS
117 BERNAL RD. STE. 70-336
SAN JOSE, CA 95119
TEL: (408) 772-4381
info@osunaeengineering.com

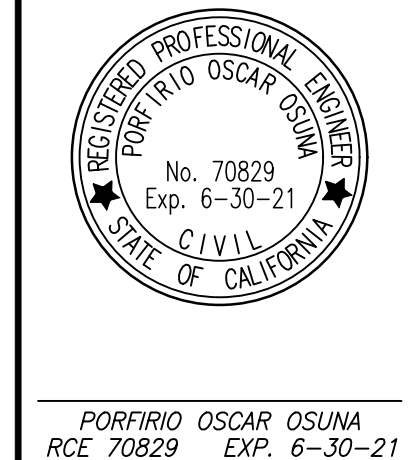


PORFIRIO OSCAR OSUNA
RCE 70829 EXP. 6-30-21

REVISIONS	DATE	CITY	BY

SHEET
C1
OF 7 SHEETS

APPLICANT: _____ ROAD: _____ COUNTY FILE NO.: _____

CONTRACTOR AGREES THAT HE SHALL ASSUME SOLE AND COMPLETE RESPONSIBILITY FOR JOB SITE CONDITIONS DURING THE COURSE OF CONSTRUCTION OF THIS PROJECT, INCLUDING SAFETY OF ALL PERSONS AND PROPERTY. THIS REQUIREMENT SHALL APPLY CONTINUOUSLY AND NOT BE LIMITED TO NORMAL WORKING HOURS. AND THAT THE CONTRACTOR SHALL BE RESPONSIBLE FOR THE PROTECTION OF ALL EXISTING UTILITIES AND STRUCTURES ON THE SITE. THE CONTRACTOR SHALL BE RESPONSIBLE FOR THE PROTECTION OF ALL EXISTING UTILITIES AND STRUCTURES ON THE SITE. THE CONTRACTOR SHALL BE RESPONSIBLE FOR THE PROTECTION OF ALL EXISTING UTILITIES AND STRUCTURES ON THE SITE.

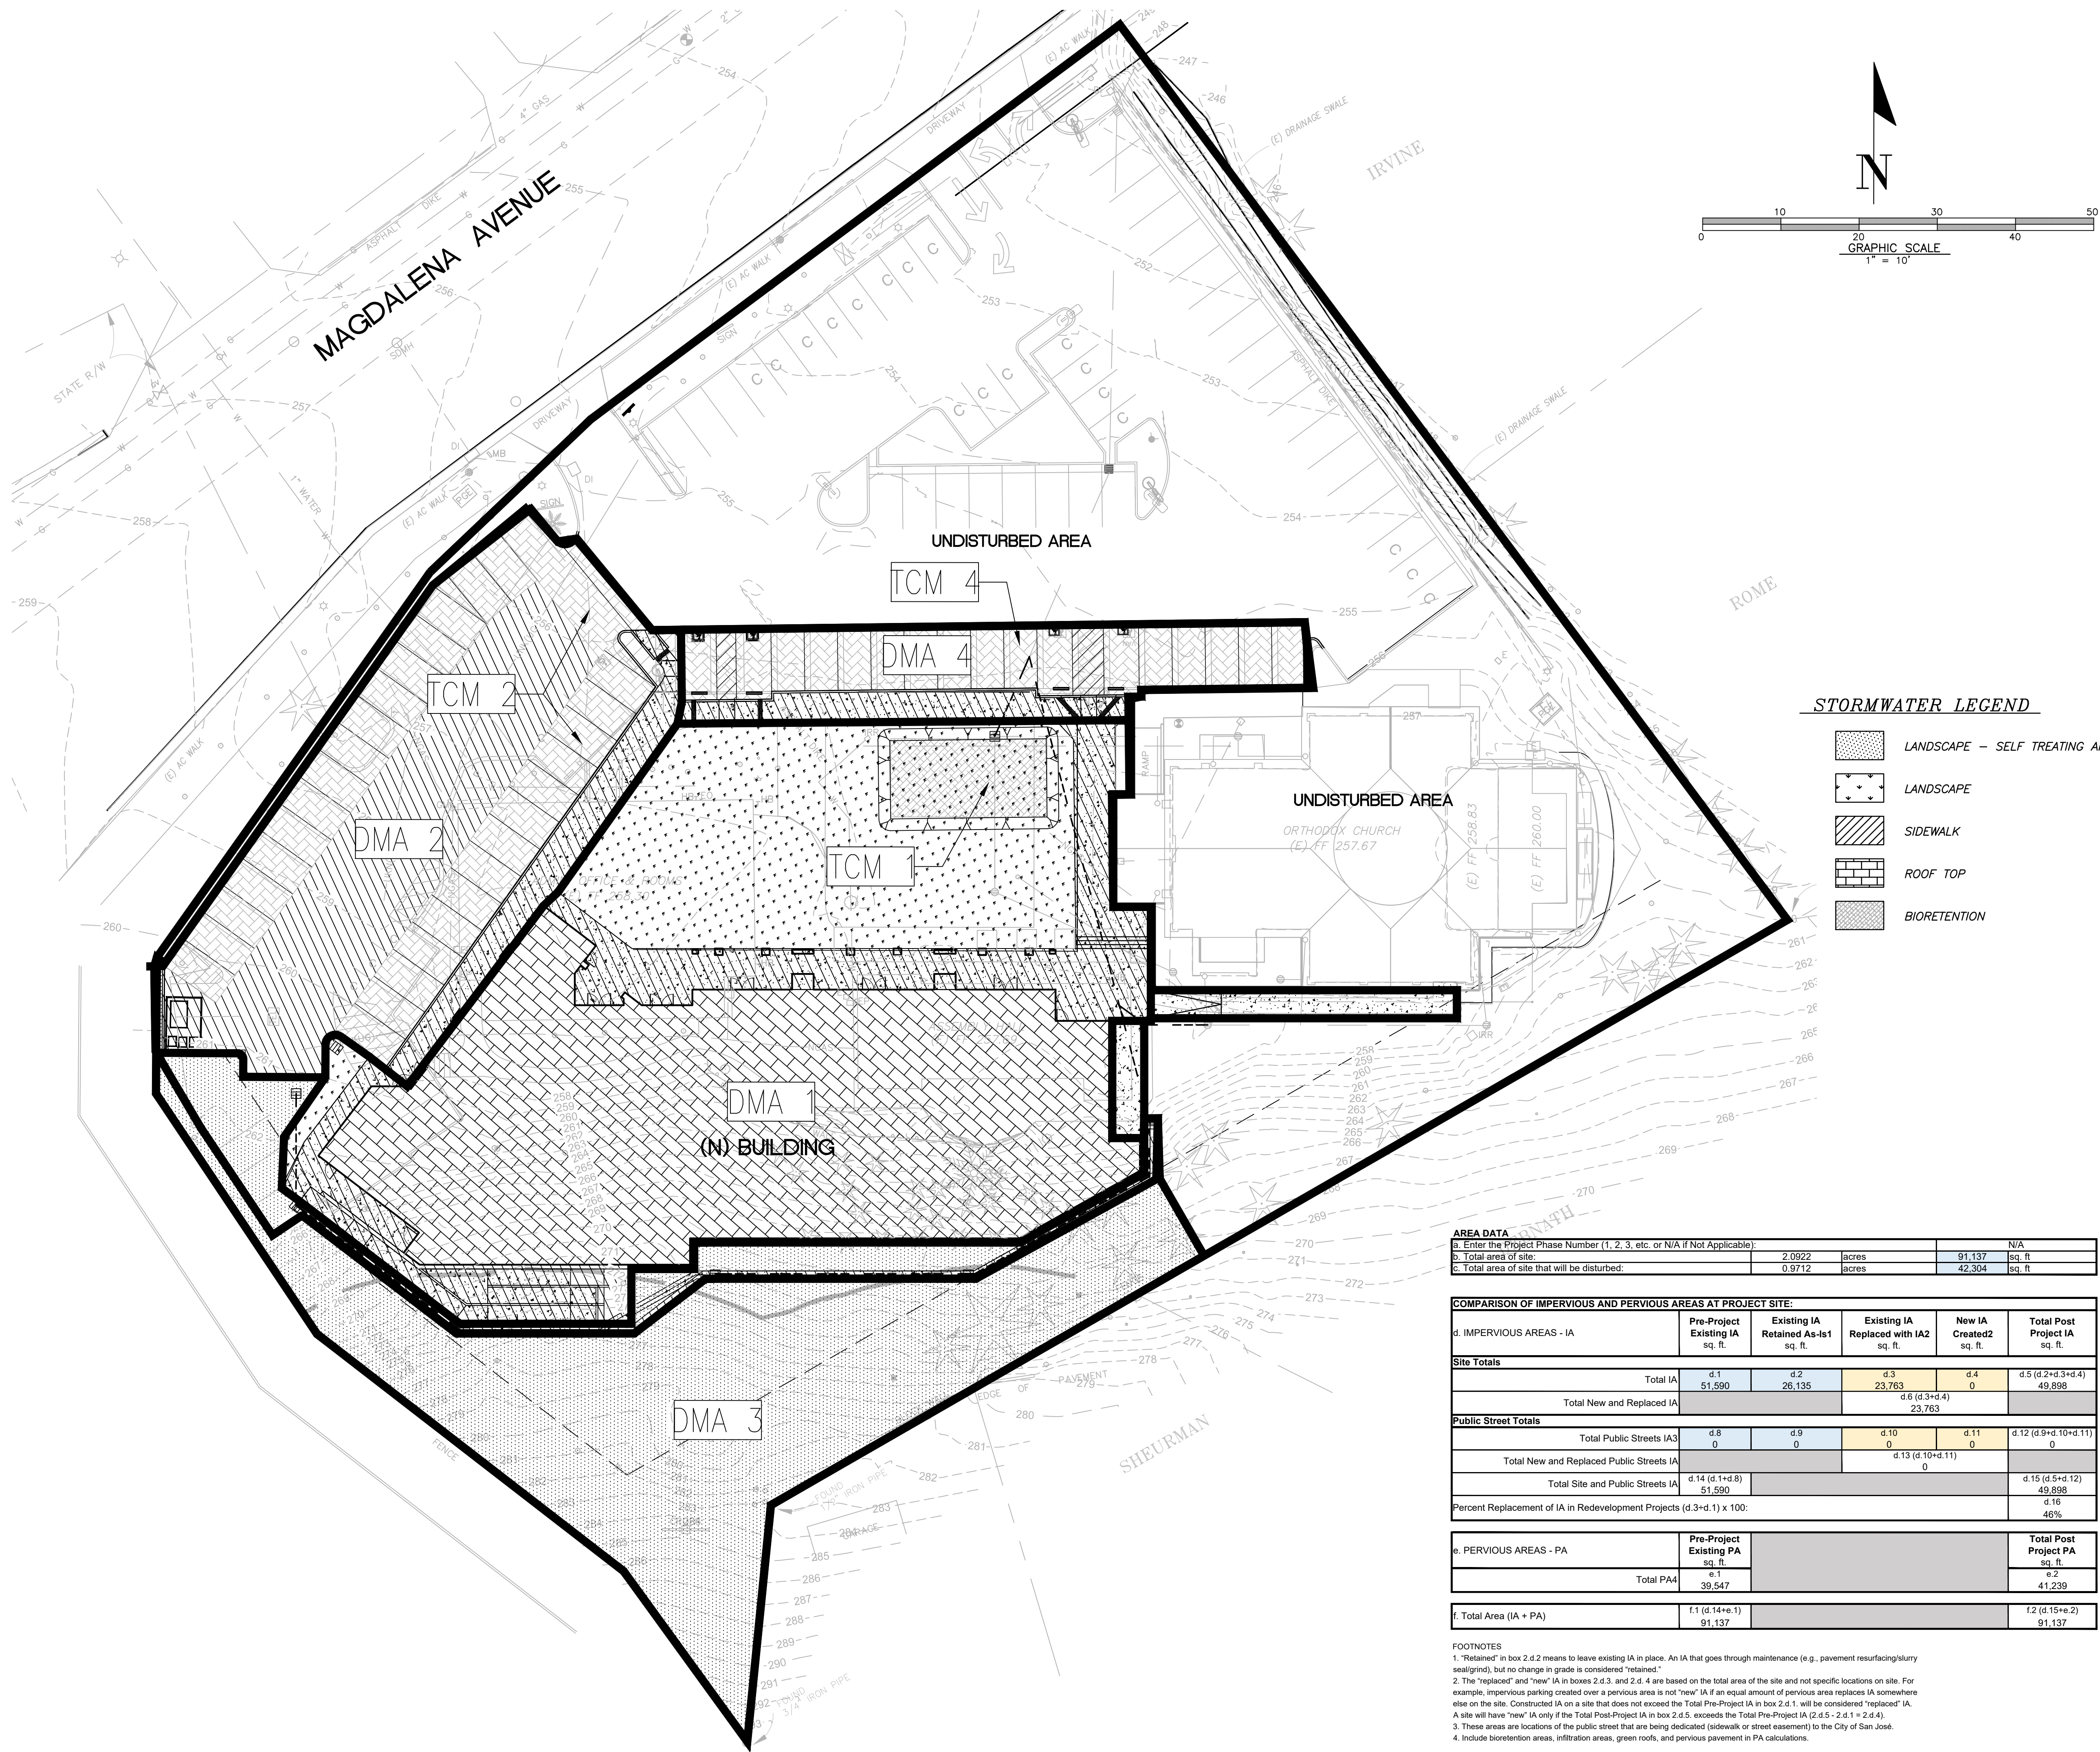

AREA DATA			
a. Enter the Project Phase Number (1, 2, 3, etc. or N/A if Not Applicable):	2.0922	acres	91,137
b. Total area of site:	0.9712	acres	42,304
c. Total area of site that will be disturbed:			

COMPARISON OF IMPERVIOUS AND PERVIOUS AREAS AT PROJECT SITE:					
d. IMPERVIOUS AREAS - IA	Pre-Project Existing IA sq. ft.	Existing IA Retained As-Is1 sq. ft.	Existing IA Replaced with IA2 sq. ft.	New IA Created2 sq. ft.	Total Post Project IA sq. ft.
Site Totals	d.1 51,590	d.2 26,135	d.3 23,763	d.4 0	d.5 (d.2+d.3+d.4) 49,898
Total New and Replaced IA			d.6 (d.3+d.4) 23,763		
Public Street Totals	d.8 0	d.9 0	d.10 0	d.11 0	d.12 (d.8+d.10+d.11) 0
Total New and Replaced Public Streets IA			d.13 (d.10+d.11) 0		
Total Site and Public Streets IA	d.14 (d.1+d.8) 51,590				d.15 (d.5+d.12) 49,898
Percent Replacement of IA in Redevelopment Projects (d.3+d.1) x 100:					d.16 46%

e. PERVIOUS AREAS - PA	Pre-Project Existing PA sq. ft.	Total Post Project PA sq. ft.
Total PA4	e.1 39,547	e.2 41,239

f. Total Area (IA + PA)	f.1 (d.14+e.1) 91,137	f.2 (d.15+e.2) 91,137
-------------------------	--------------------------	--------------------------

- FOOTNOTES
- "Retained" in box 2.d.2 means to leave existing IA in place. An IA that goes through maintenance (e.g., pavement resurfacing/stripping/seal/grind), but no change in grade is considered "retained."
 - The "replaced" and "new" IA in boxes 2.d.3 and 2.d.4 are based on the total area of the site and not specific locations on site. For example, impervious parking created over a pervious area is not "new" IA if an equal amount of pervious area replaces IA somewhere else on the site. Constructed IA on a site that does not exceed the Total Pre-Project IA in box 2.d.1, will be considered "replaced" IA. A site will have "new" IA only if the Total Post-Project IA in box 2.d.5 exceeds the Total Pre-Project IA (2.d.5 - 2.d.1 = 2.d.4).
 - These areas are locations of the public street that are being dedicated (sidewalk or street easement) to the City of San Jose.
 - Include bioretention areas, infiltration areas, green roofs, and pervious pavement in PA calculations.

REVISIONS

DATE	CITY	BY

REGISTERED PROFESSIONAL ENGINEER
PORFIRIO OSCAR OSUNA
No. 70829
Exp. 6-30-21
CIVIL
STATE OF CALIFORNIA

PORFIRIO OSCAR OSUNA
RCE 70829 EXP. 6-30-21

OSUNA
ENGINEERING INC.
Planning | Surveying | Civil Engineering

CONSULTING CIVIL ENGINEERS & LAND SURVEYORS
TEL. (408) 772-4381
info@osunaeengineering.com

117 BERNAL RD. STE. 70-336
SAN JOSE, CA 95119


CALIFORNIA
Project No.: 1799
Design: J.O
Check: J.O
Date: 12/18/20

CONCEPTUAL
GRADING & DRAINAGE PLAN
380 MAGDALENA AVE.
LOS ALTOS, CA


SHEET
C2.1
OF 7 SHEETS

PLANNING SUBMITTAL - NOT FOR CONSTRUCTION


CONTRACTOR AGREES THAT HE SHALL ASSUME SOLE AND COMPLETE RESPONSIBILITY FOR JOB SITE CONDITIONS DURING THE COURSE OF CONSTRUCTION OF THIS PROJECT, INCLUDING BUT NOT LIMITED TO NORMAL WORKING HOURS AND THAT THE CONTRACTOR SHALL BE RESPONSIBLE FOR OBTAINING ALL NECESSARY PERMITS AND APPROVALS FROM THE LOCAL, STATE AND FEDERAL AGENCIES AND SHALL BE RESPONSIBLE FOR THE PERFORMANCE OF WORK ON THIS PROJECT, EXCEPTING FOR LIABILITY ARISING FROM THE SOLE NEGLIGENCE OF THE ENGINEER.

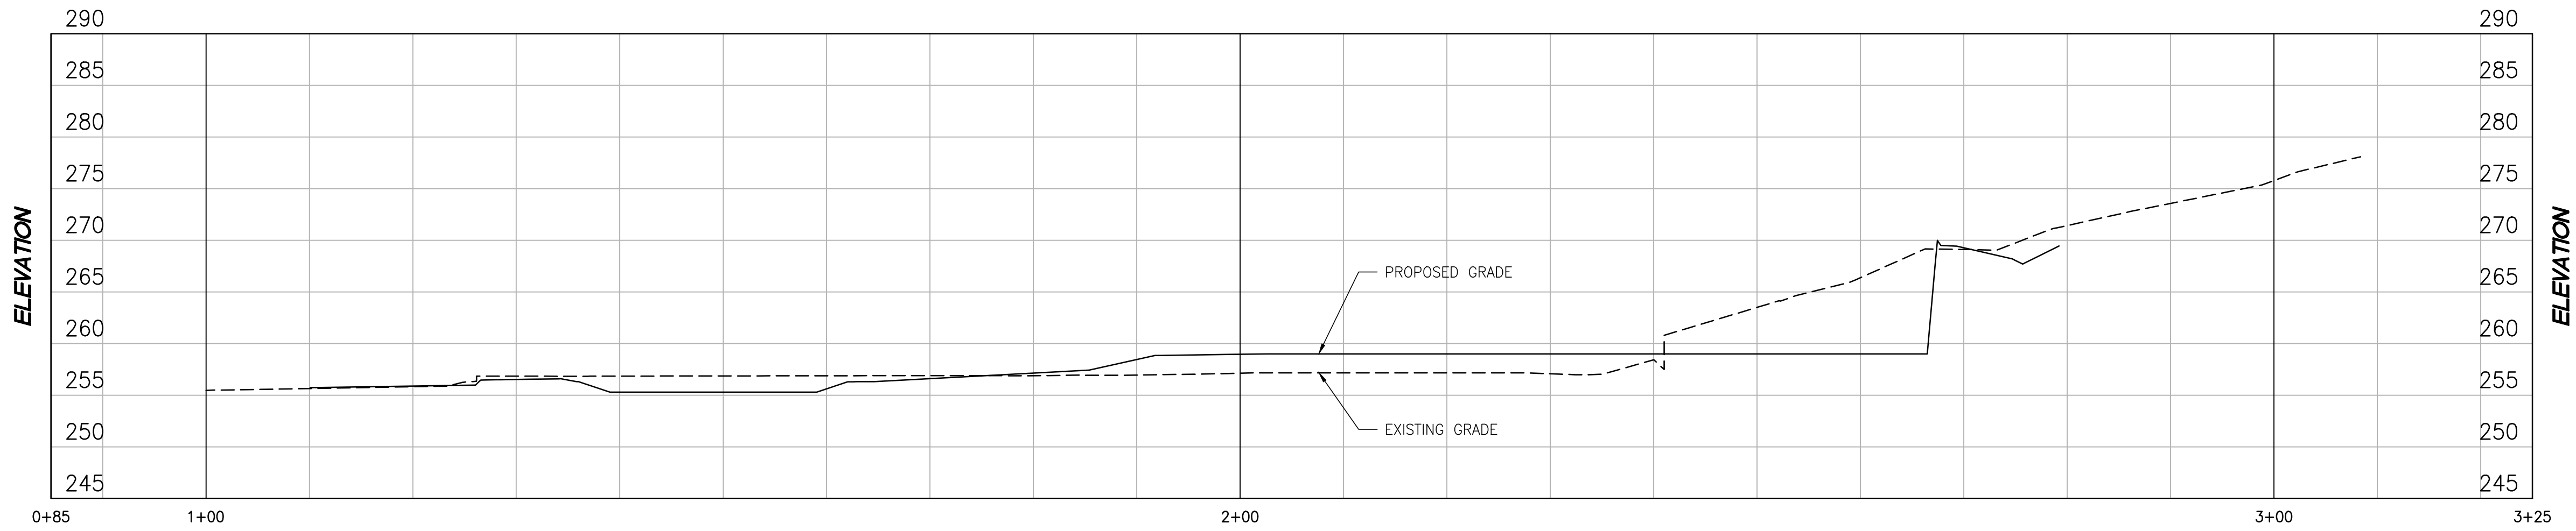


A SECTION A

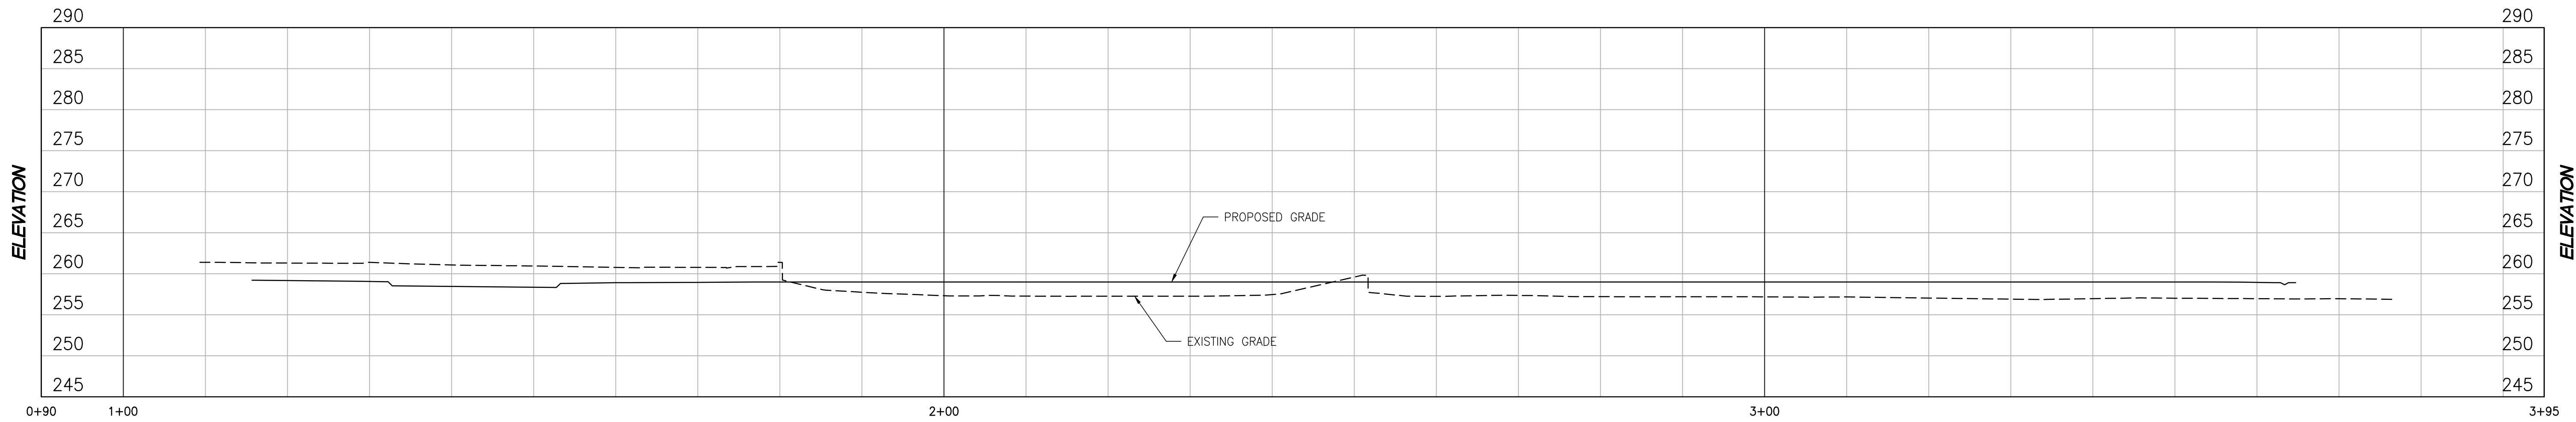


B SECTION B

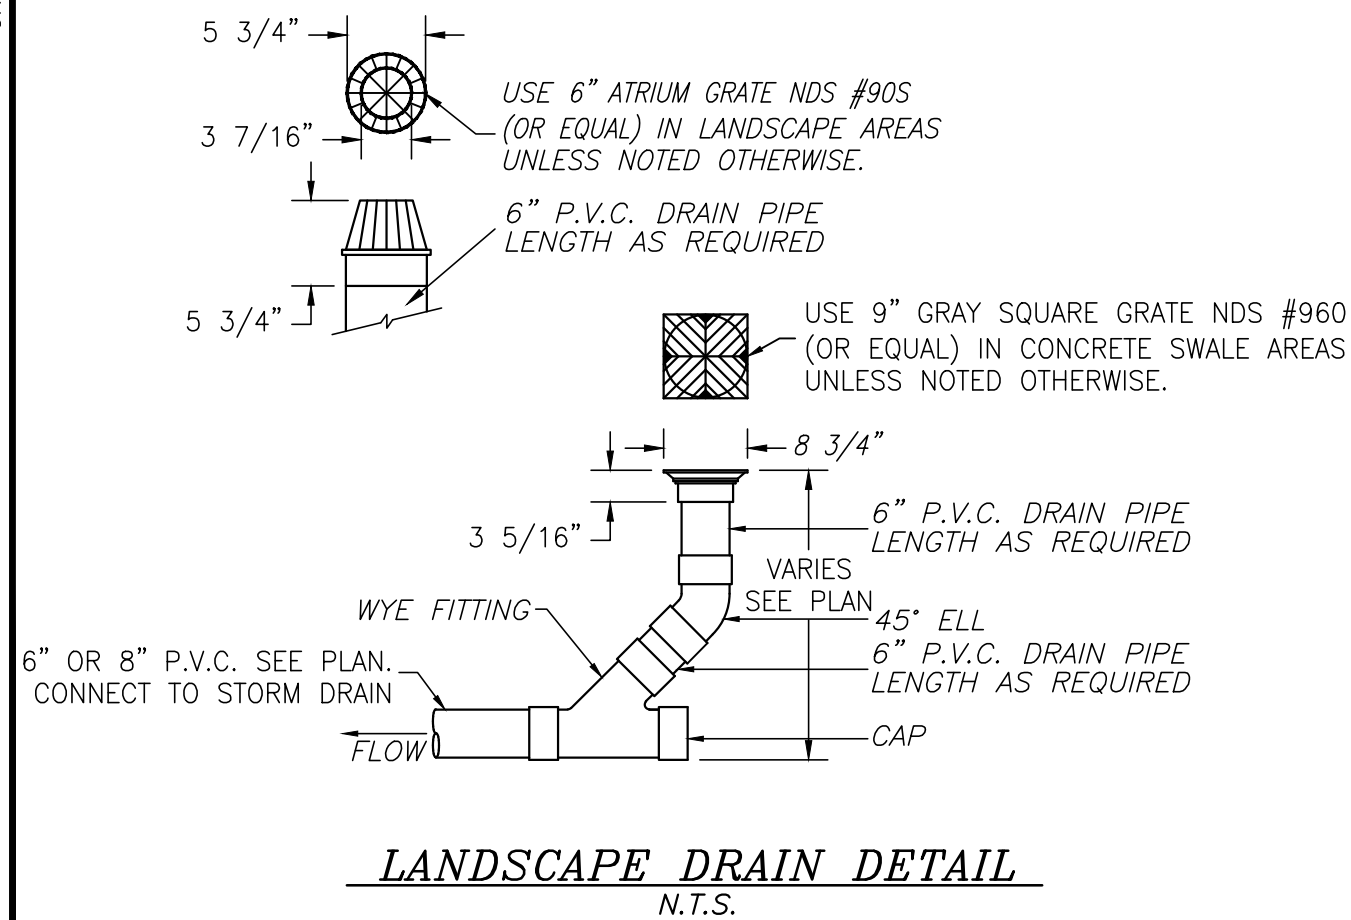

N.T.S.

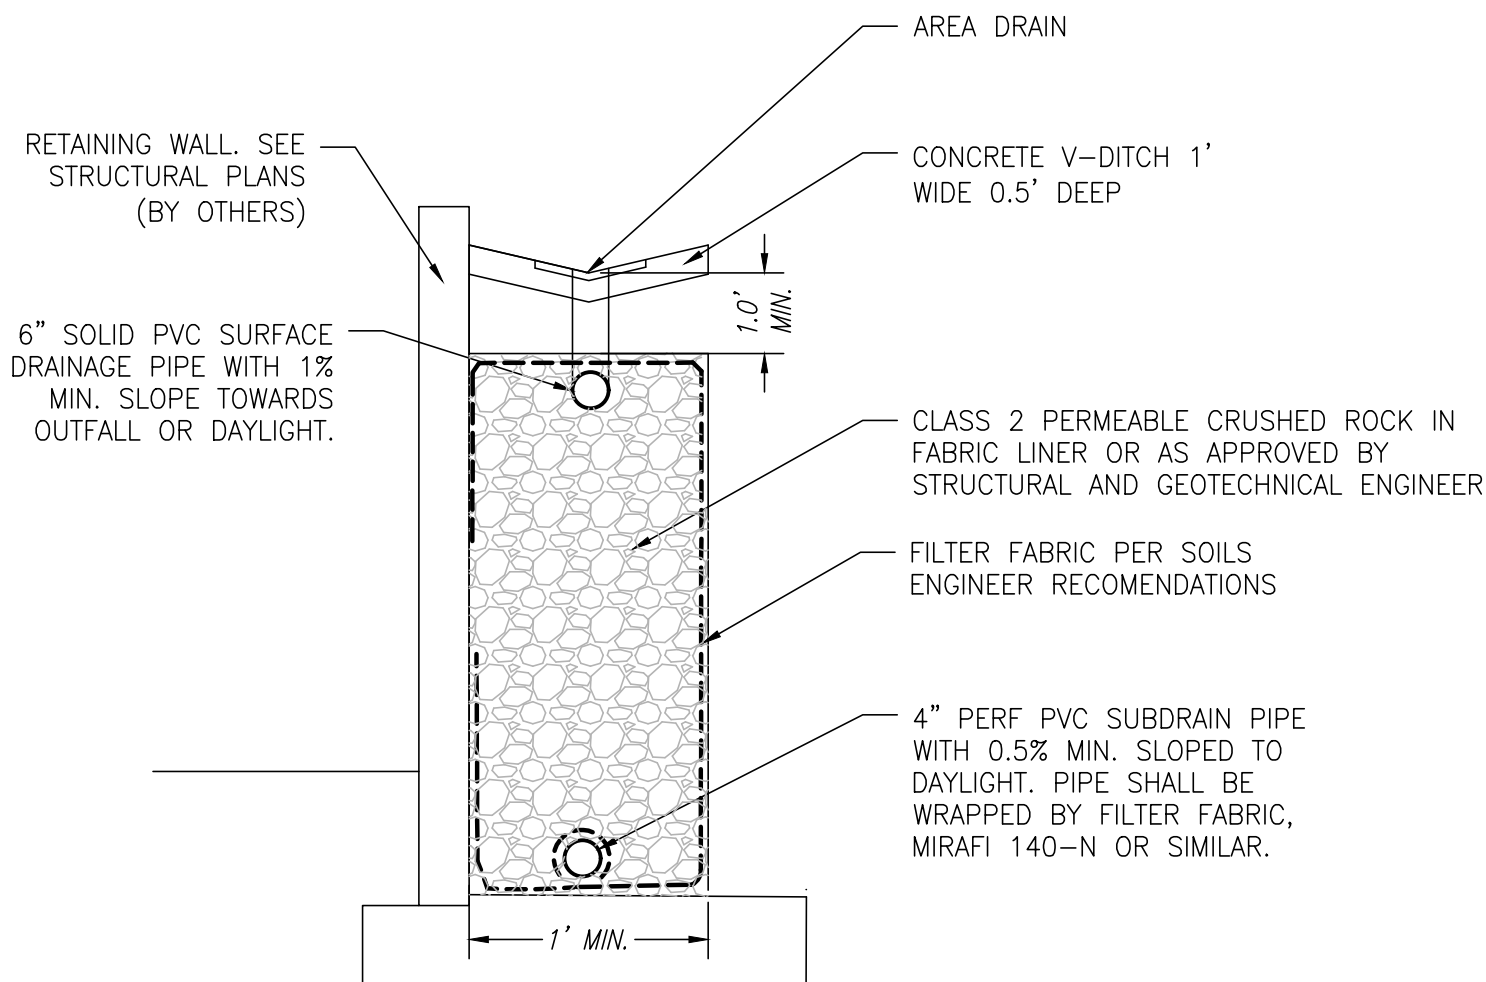

N.T.S.

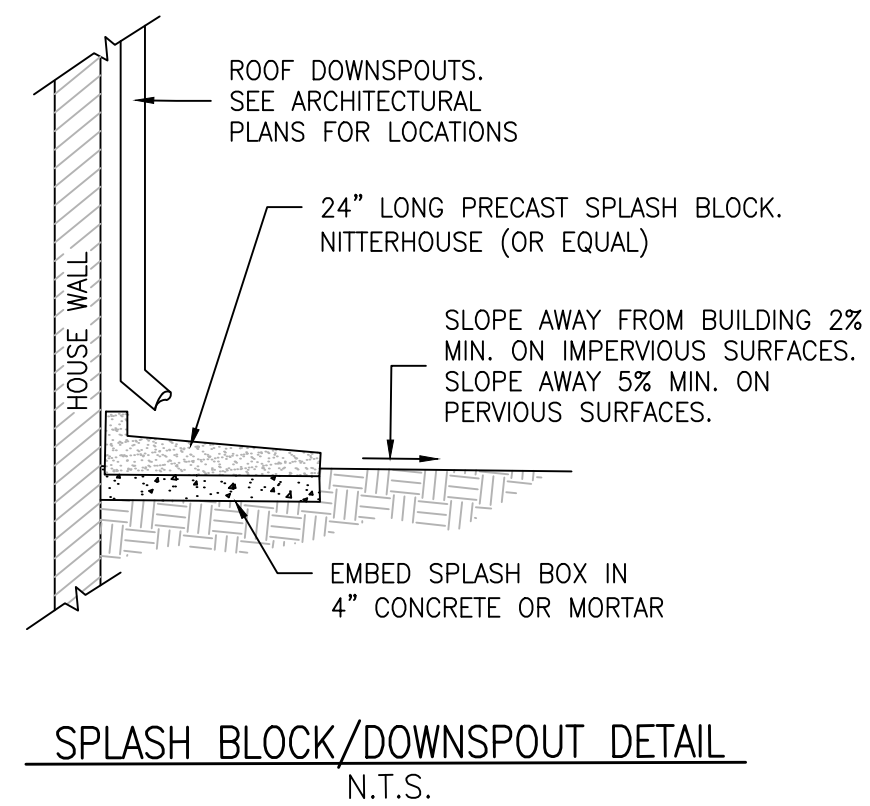

N.T.S.

C AREA DRAIN DETAIL

D CONCRETE V-DITCH

E SPLASH BLOCK/DOWNSPOUT DETAIL

F NOT USED

PLANNING SUBMITTAL - NOT FOR CONSTRUCTION

CONCEPTUAL
GRADING & DRAINAGE PLAN
CONSTRUCTION DETAILS
380 MAGDALENA AVE.









OSUNA
ENGINEERING INC.
Planning | Surveying | Civil Engineering
CONSULTING CIVIL ENGINEERS & LAND SURVEYORS
117 BERNAL RD. STE. 70-336
SAN JOSE, CA 95119
TEL. (408) 772-4381
info@osunaengineering.com



PORFIRIO OSCAR OSUNA
RCE 70829 EXP. 6-30-21

SHEET
C3
OF 7 SHEETS

CONTRACTOR AGREES THAT HE SHALL ASSUME SOLE AND COMPLETE RESPONSIBILITY FOR JOB SITE CONDITIONS DURING THE COURSE OF CONSTRUCTION OF THIS PROJECT, INCLUDING BUT NOT LIMITED TO NORMAL WORKING HOURS AND THAT THE CONTRACTOR SHALL BE RESPONSIBLE FOR OBTAINING ALL NECESSARY PERMITS AND APPROVALS FROM THE APPROPRIATE AGENCIES AND AGENCIES OF THE COUNTY OF SANTA CLARA. THE CONTRACTOR SHALL BE RESPONSIBLE FOR OBTAINING ALL NECESSARY PERMITS AND APPROVALS FROM THE APPROPRIATE AGENCIES AND AGENCIES OF THE COUNTY OF SANTA CLARA. THE CONTRACTOR SHALL BE RESPONSIBLE FOR OBTAINING ALL NECESSARY PERMITS AND APPROVALS FROM THE APPROPRIATE AGENCIES AND AGENCIES OF THE COUNTY OF SANTA CLARA.

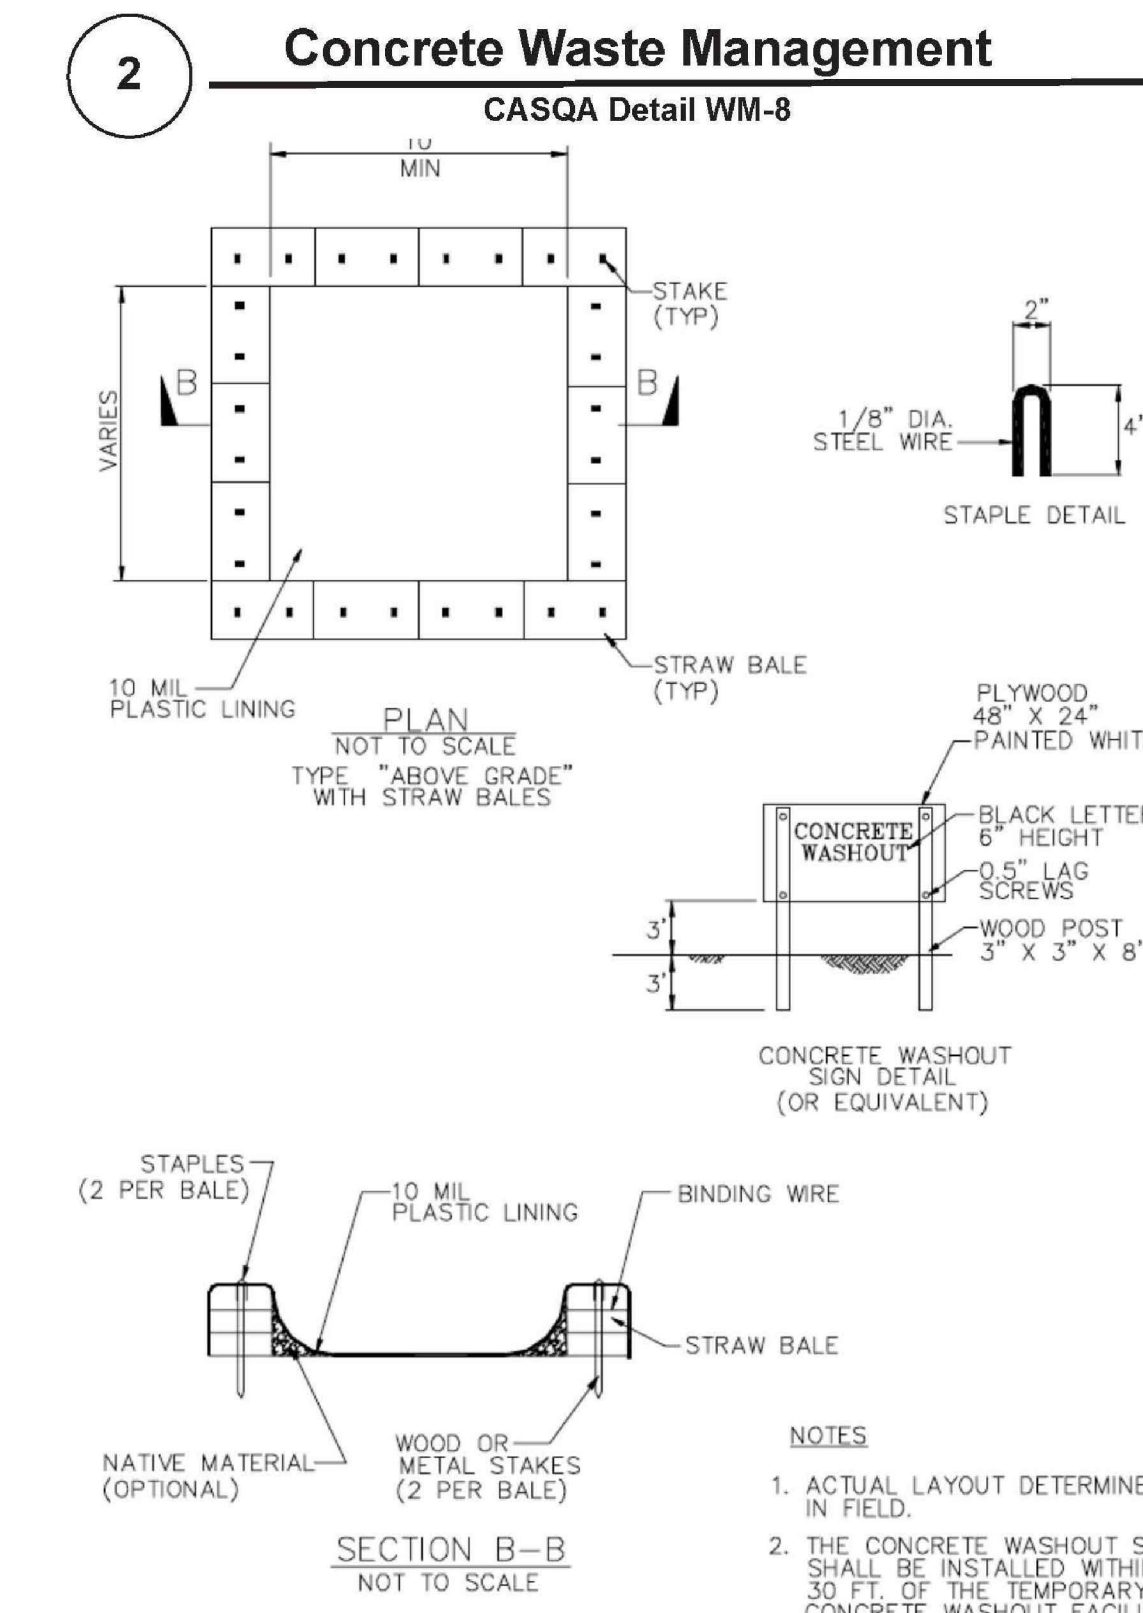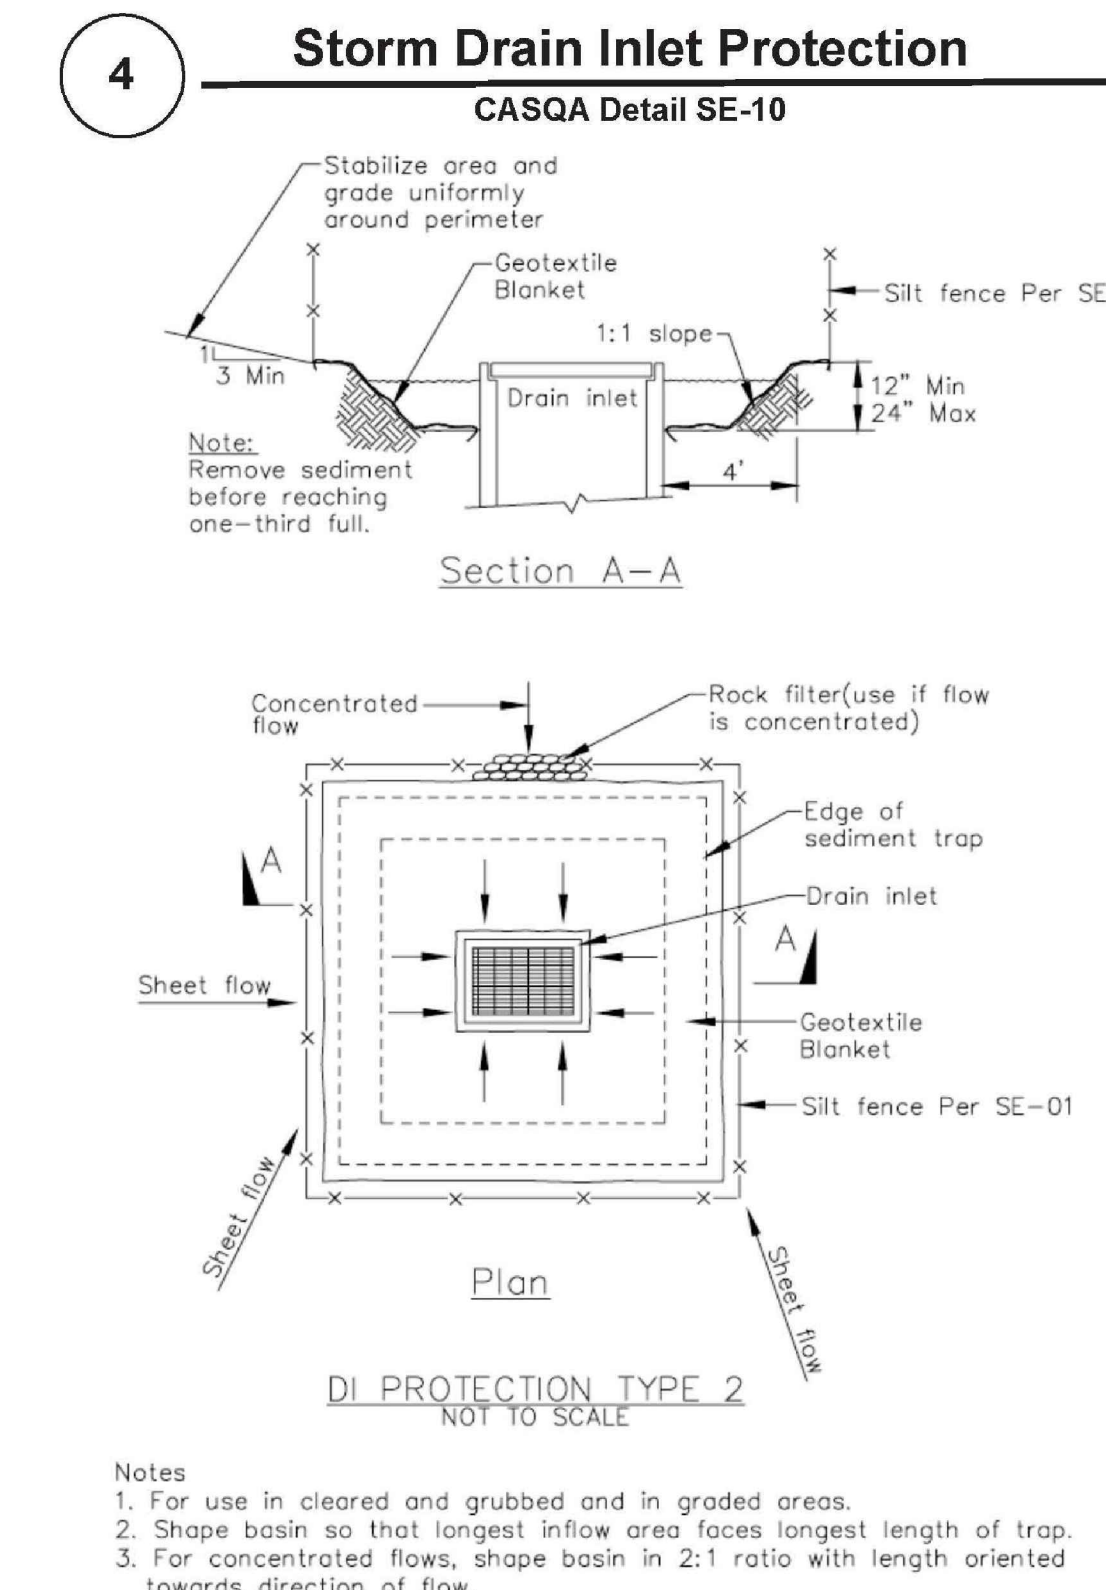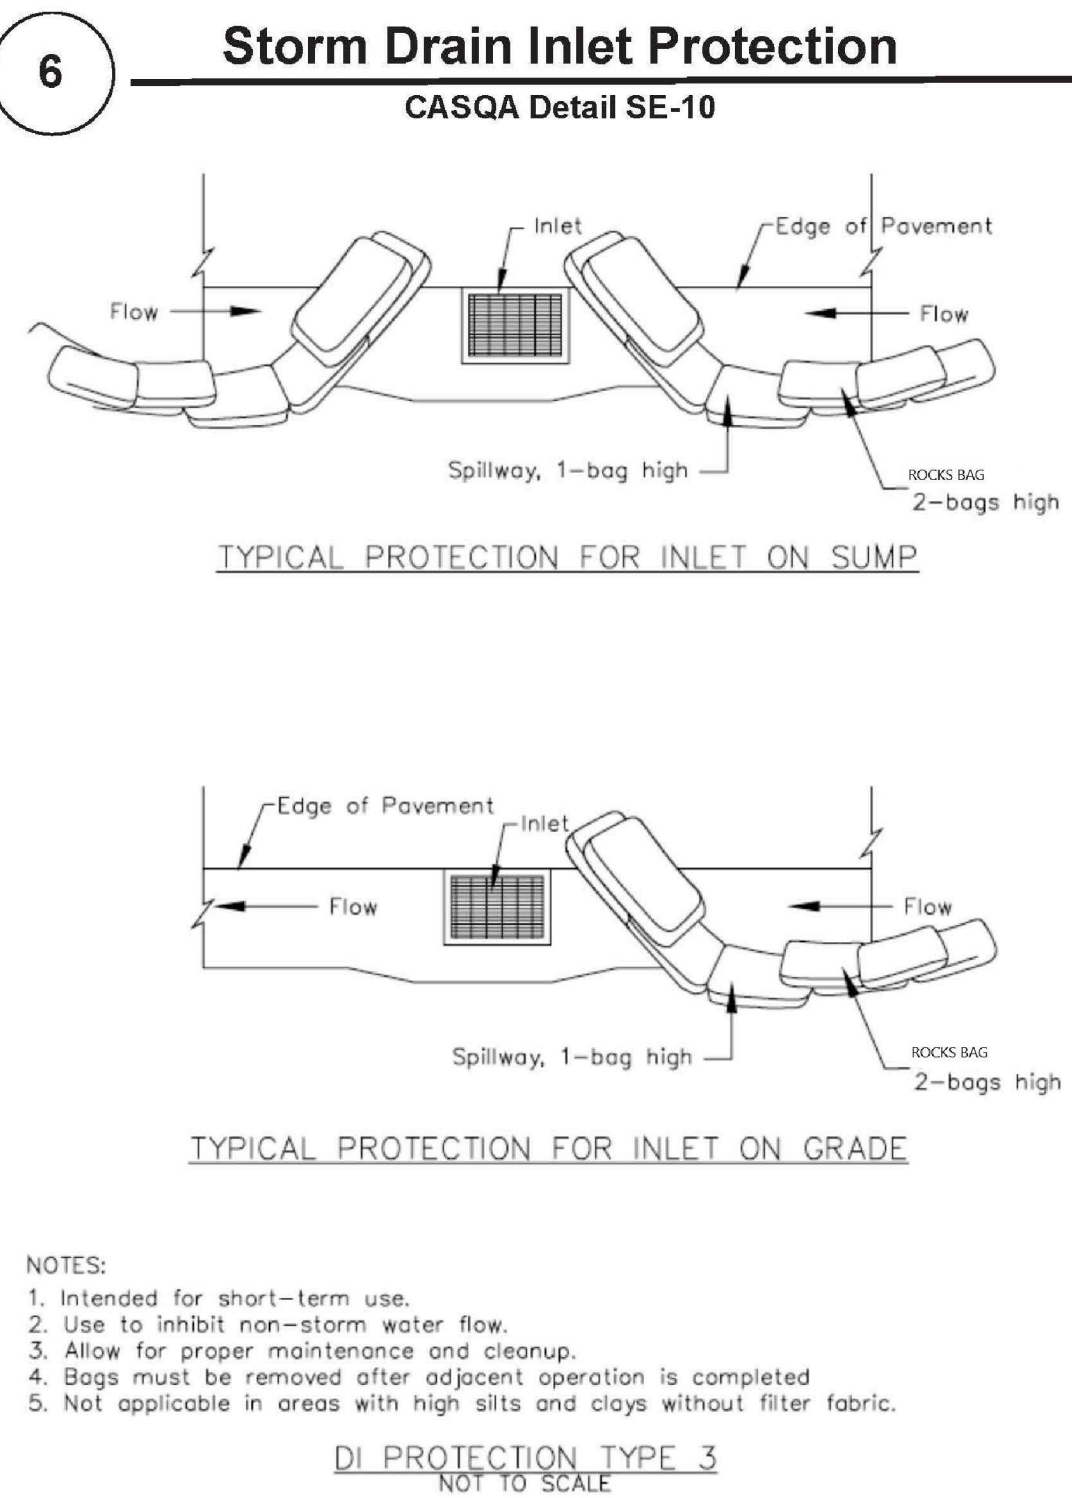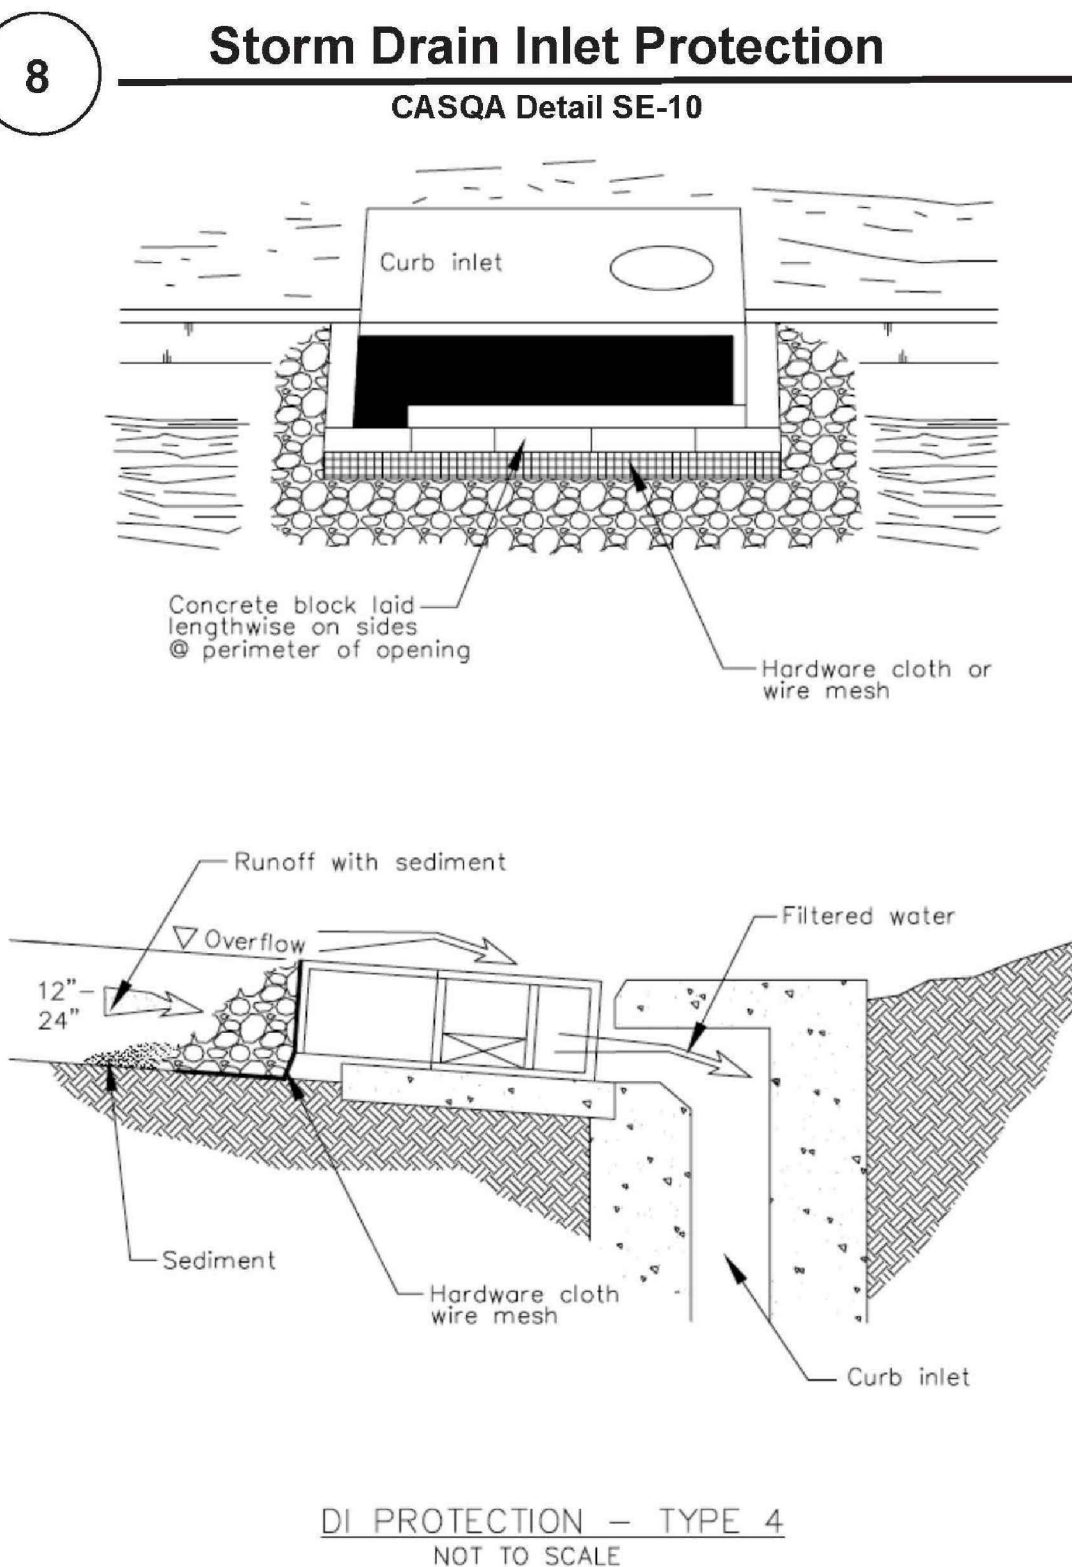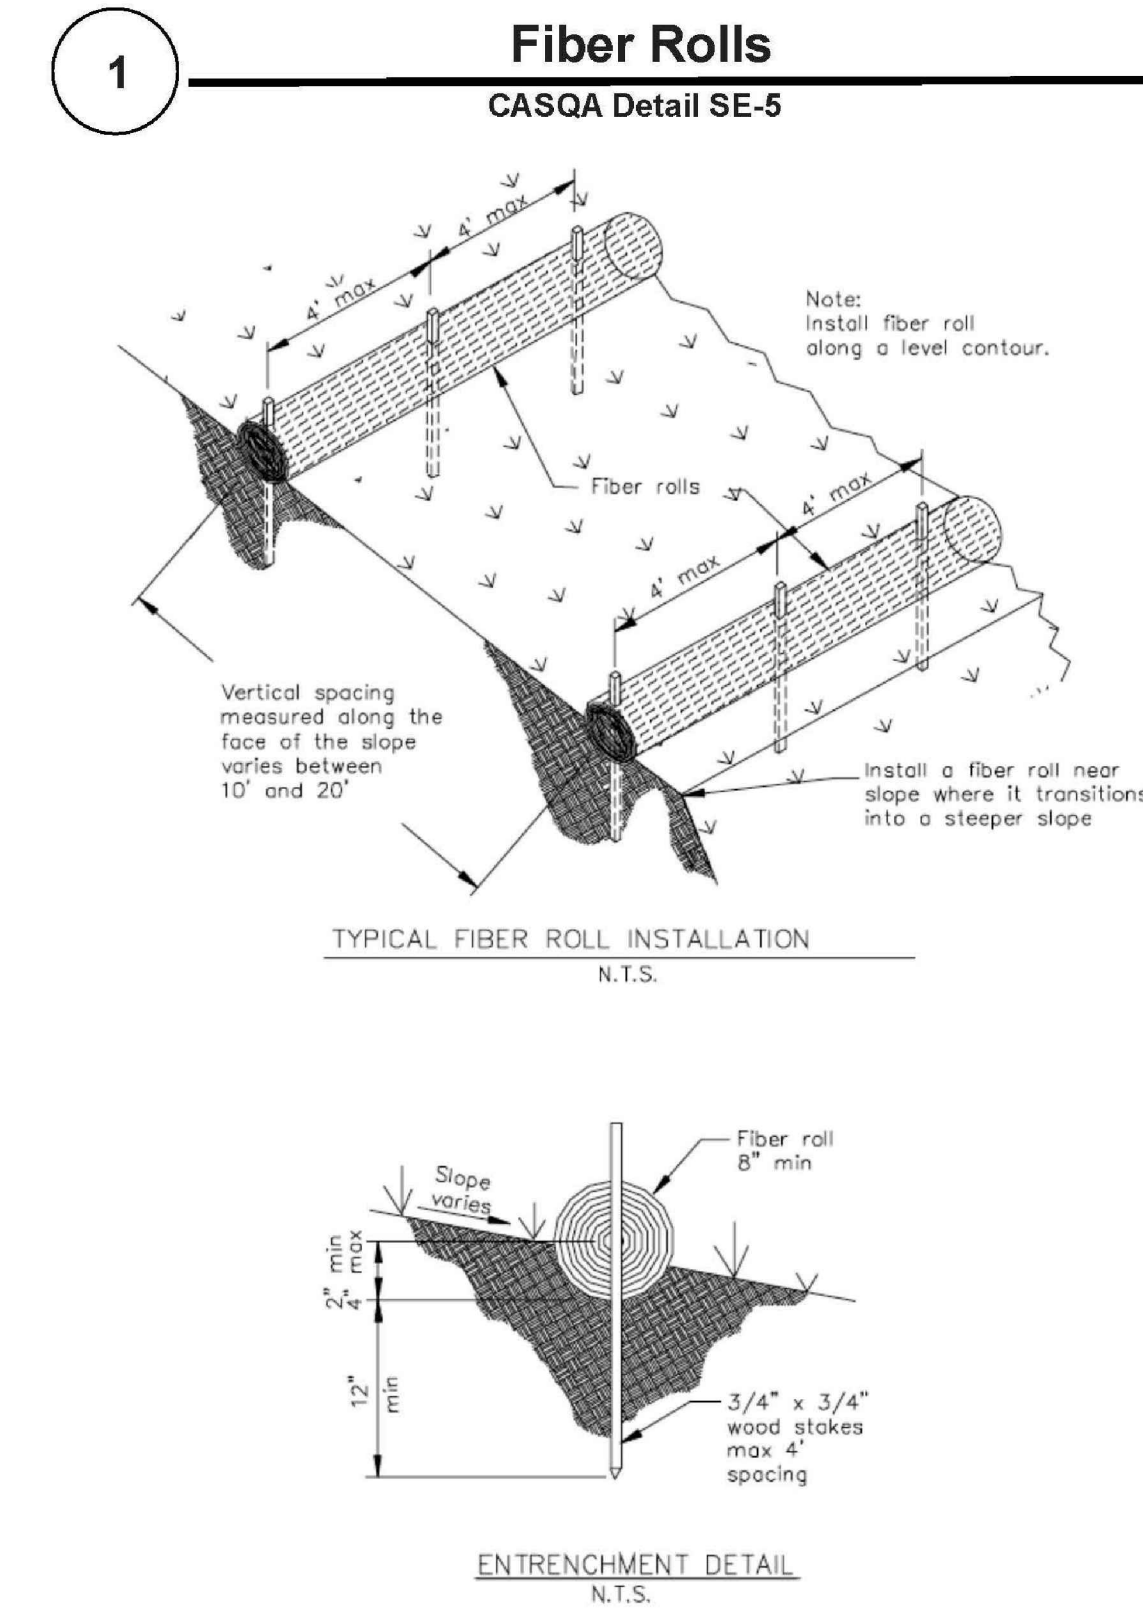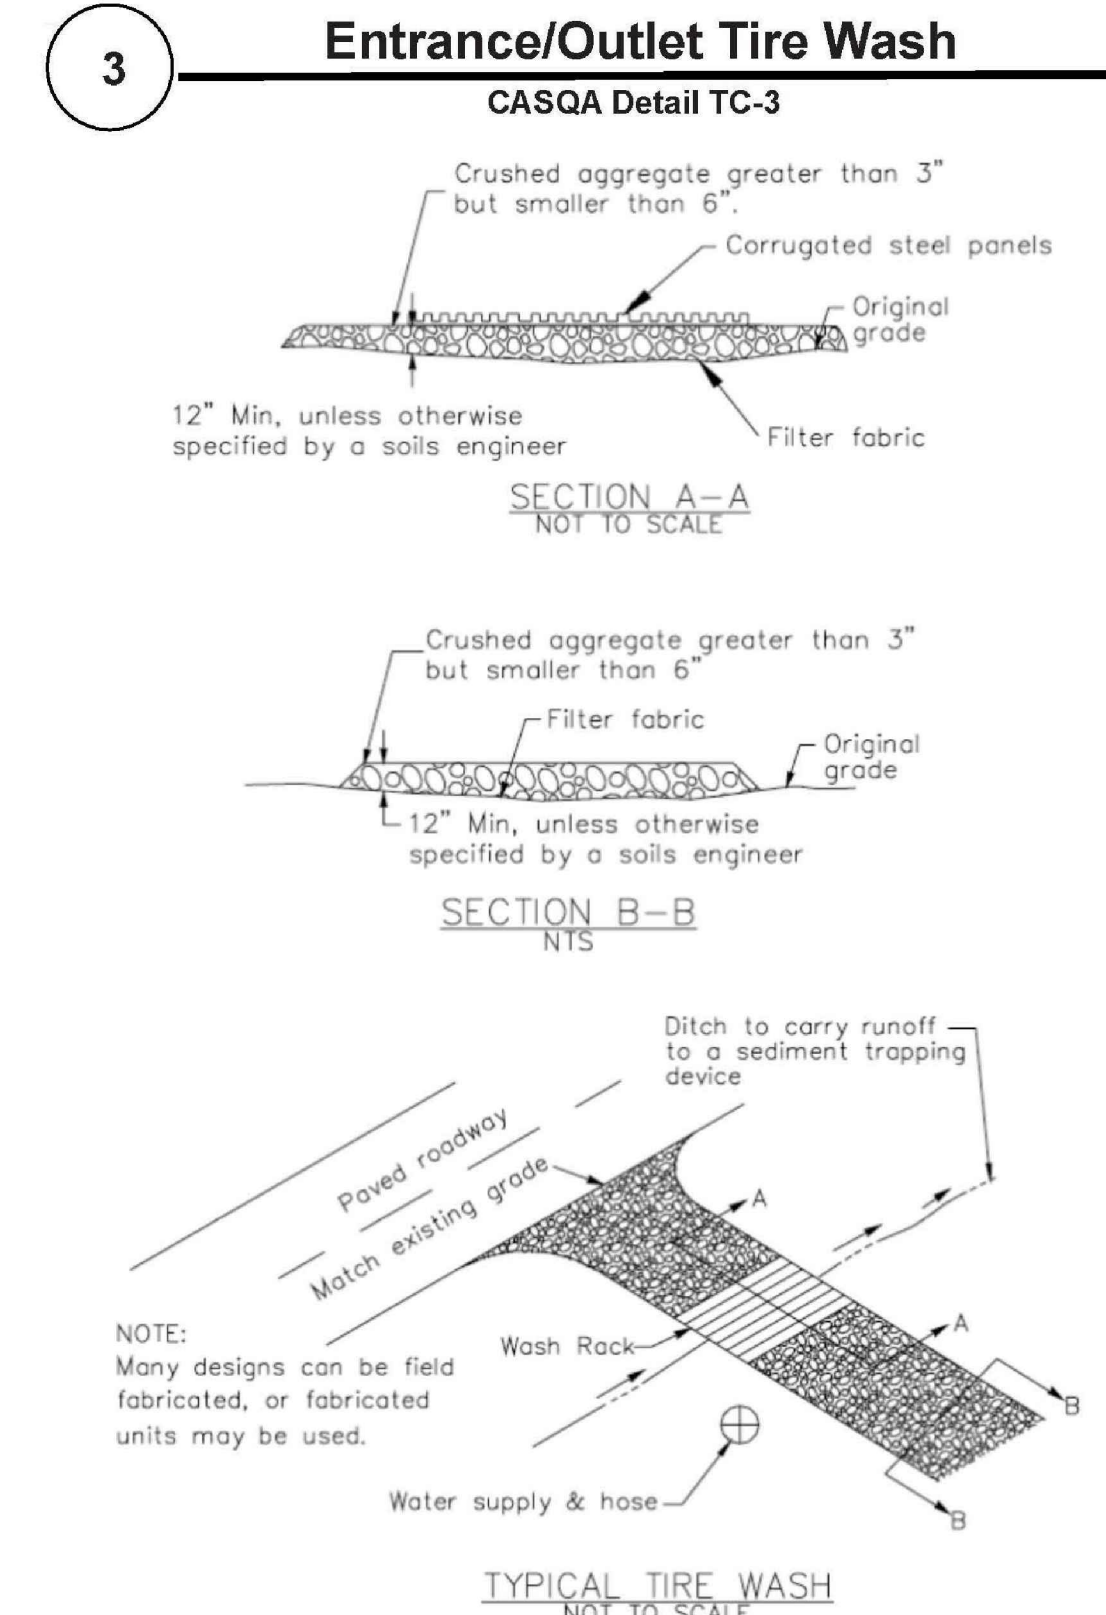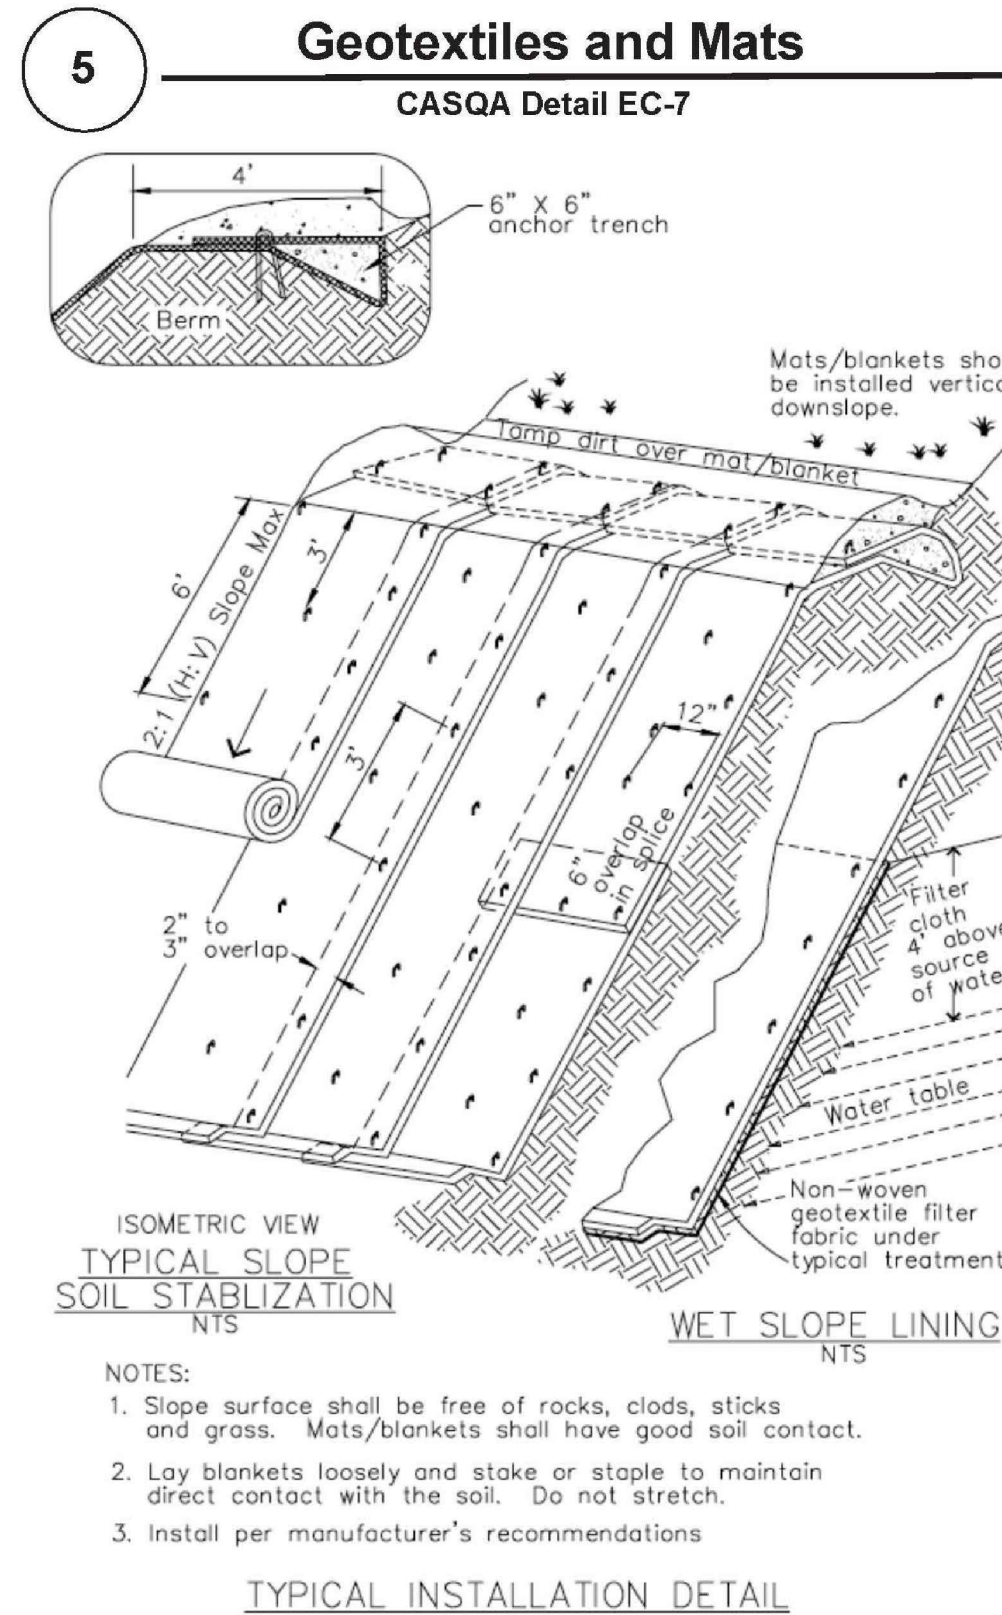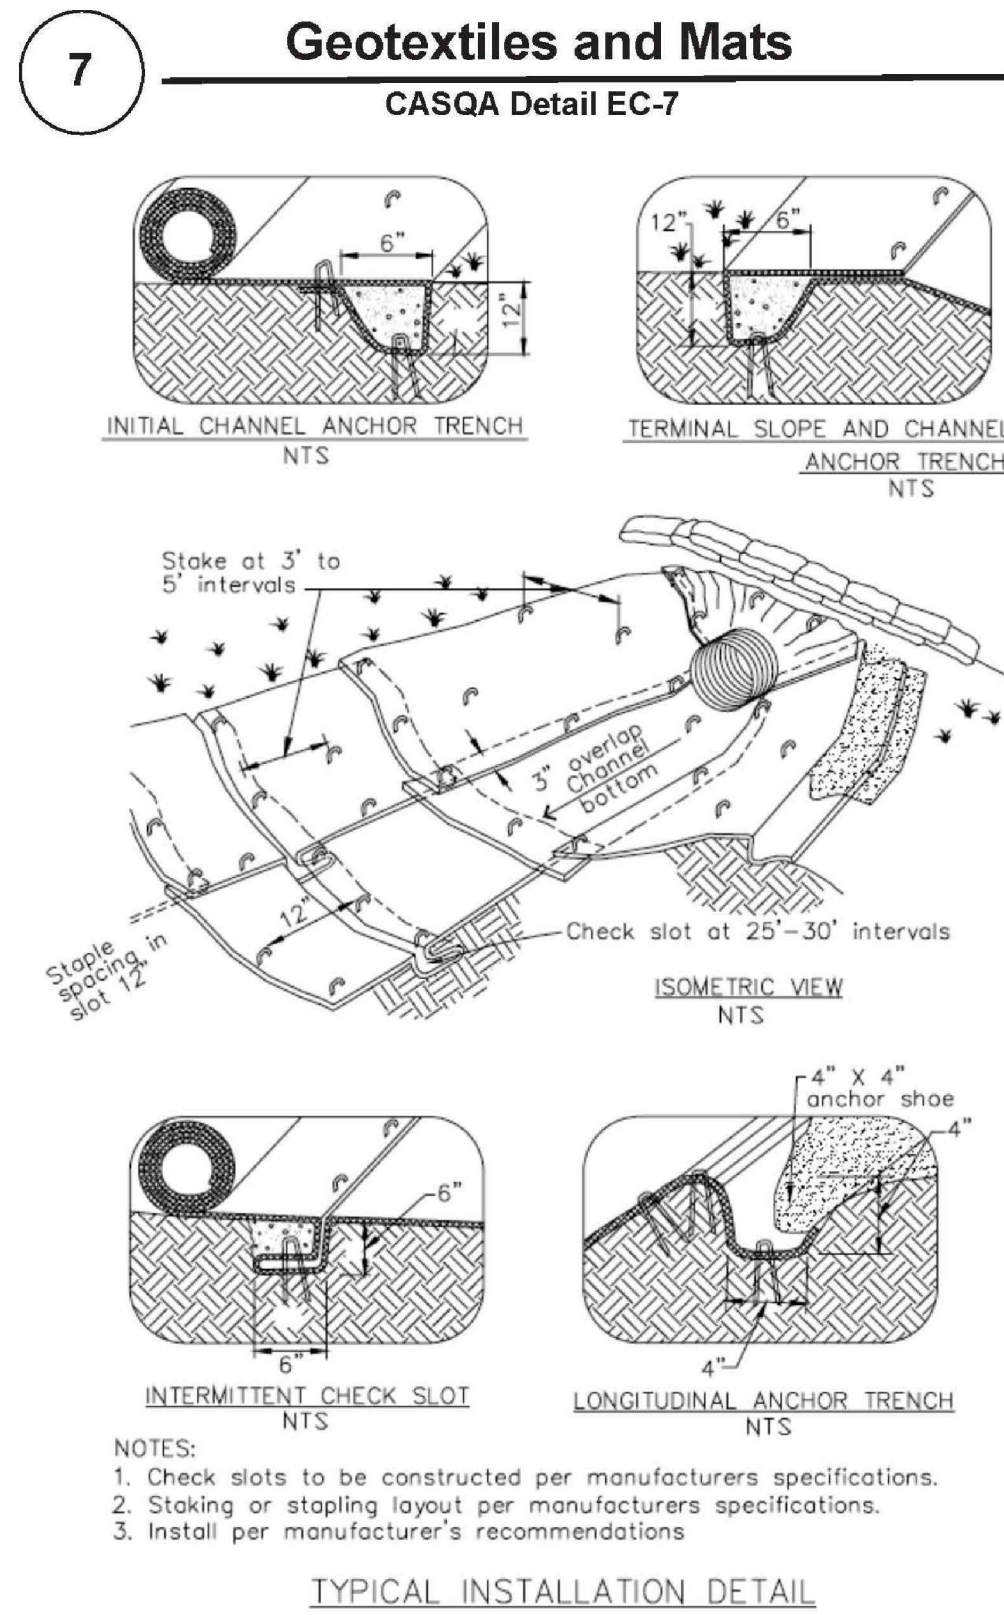

Project Information

Source for Graphics: California Stormwater BMP Handbook, California Stormwater Quality Association, January 2003.
Available from www.cabmphandbooks.com.

Best Management Practices and Erosion Control Details Sheet 2
County of Santa Clara



BMP-2

CONCEPTUAL GRADING & DRAINAGE PLAN
SANTA CLARA COUNTY BMP SHEET
380 MAGDALENA AVE.

SHEET
C4.2
OF 7 SHEETS

PLANNING SUBMITTAL - NOT FOR CONSTRUCTION

OSUNA
ENGINEERING INC.
Planning | Surveying | Civil Engineering
CONSULTING CIVIL ENGINEERS & LAND SURVEYORS
117 BERNAL RD. STE. 70-336
SAN JOSE, CA 95119
TEL (408) 772-4381
info@osunaengineering.com

REGISTERED PROFESSIONAL ENGINEER
No. 70829
Exp. 6-30-21
CIVIL
STATE OF CALIFORNIA
PORFIRIO OSCAR OSUNA
RCE 70829 EXP. 6-30-21

REVISIONS	DATE	CITY	BY