PURPOSE:

THE PURPOSE OF THIS PLAN IS TO STABILIZE THE SITE TO PREVENT EROSION OF GRADED AREAS AND TO PREVENT SEDIMENTATION FROM LEAVING THE CONSTRUCTION AREA AND AFFECTING NEIGHBORING SITES, NATURAL AREAS, PUBLIC FACILITIES OR ANY OTHER AREA THAT MIGHT BE AFFECTED BY EROSION AND SEDIMENTATION. IT IS ALSO INTENDED TO PROTECT THE SITE, PUBLIC DRAINAGE FACILITIES AND NEIGHBORING PROPERTIES FROM OTHER POSSIBLE NON-STORMWATER POLLUTANTS. A DESCRIPTION OF POSSIBLE POLLUTANTS AND BEST MANAGEMENT PRACTICES IS PROVIDED IN THE PROJECT SWPPP.


ALL MEASURES SHOWN ON THIS PLAN SHOULD BE CONSIDERED THE MINIMUM REQUIREMENTS NECESSARY. SHOULD FIELD CONDITIONS DICTATE ADDITIONAL MEASURES, SUCH MEASURES SHALL BE PER CALIFORNIA REGIONAL WATER QUALITY CONTROL BOARD'S FIELD MANUAL FOR EROSION AND SEDIMENTATION CONTROL AND THE CALIFORNIA STORM WATER QUALITY ASSOCIATION BEST MANAGEMENT PRACTICES HANDBOOK FOR CONSTRUCTION. LEA & BRAZE ENGINEERING SHOULD BE NOTIFIED IMMEDIATELY SHOULD CONDITIONS CHANGE.

EROSION CONTROL NOTES:

- 1. IT SHALL BE THE OWNER'S/CONTRACTOR'S RESPONSIBILITY TO MAINTAIN CONTROL OF THE ENTIRE CONSTRUCTION OPÉRATION AND TO KEEP THE ENTIRE SITE IN COMPLIANCE WITH THIS EROSION CONTROL PLAN.
- 2. THE INTENTION OF THIS PLAN IS FOR INTERIM EROSION AND SEDIMENT CONTROL ONLY. ALL EROSION CONTROL MEASURES SHALL CONFORM TO CALIFORNIA REGIONAL WATER QUALITY CONTROL BOARD'S FIELD MANUAL FOR EROSION AND SEDIMENTATION CONTROL, THE CALIFORNIA STORM WATER QUALITY ASSOCIATION BEST MANAGEMENT PRACTICES HANDBOOK FOR CONSTRUCTION, AND THE LOCAL GOVERNING AGENCY FOR THIS PROJECT.
- 3. OWNER/CONTRACTOR SHALL BE RESPONSIBLE FOR MONITORING EROSION AND SEDIMENT CONTRÔL MEASURES PRIOR TO, DURING, AND AFTER STORM EVENTS. PERSON IN CHARGE OF MAINTAINING EROSION CONTROL MEASURES SHOULD WATCH LOCAL WEATHER REPORTS AND ACT APPROPRIATELY TO MAKE SURE ALL NECESSARY MEASURES ARE IN PLACE.
- 4. SANITARY FACILITIES SHALL BE MAINTAINED ON THE SITE AT ALL TIMES.
- 5. DURING THE RAINY SEASON, ALL PAVED AREAS SHALL BE KEPT CLEAR OF EARTH MATERIAL AND DEBRIS. THE SITE SHALL BE MAINTAINED SO AS TO MINIMIZE SEDIMENT-LADEN RUNOFF TO ANY STORM DRAINAGE SYSTEM, INCLUDING EXISTING DRAINAGE SWALES AND WATERCOURSES.
- CONSTRUCTION OPERATIONS SHALL BE CARRIED OUT IN SUCH A MANNER THAT EROSION AND WATER POLLUTION WILL BE MINIMIZED. COMPLIANCE WITH FEDERAL, STATE AND LOCAL LAWS CONCERNING POLLUTION SHALL BE MAINTAINED AT ALL TIMES.
- 7. CONTRACTOR SHALL PROVIDE DUST CONTROL AS REQUIRED BY THE APPROPRIATE FEDERAL, STATE AND LOCAL AGENCY REQUIREMENTS.
- 8. ALL MATERIALS NECESSARY FOR THE APPROVED EROSION CONTROL MEASURES SHALL BE IN PLACE BY OCTOBER 15TH.
- 9. EROSION CONTROL SYSTEMS SHALL BE INSTALLED AND MAINTAINED THROUGHOUT THE RAINY SEASON, OR FROM OCTOBER 15TH THROUGH APRIL 15TH, WHICHEVER IS LONGER.
- 10. IN THE EVENT OF RAIN, ALL GRADING WORK IS TO CEASE IMMEDIATELY AND THE SITE IS TO BE SEALED IN ACCORDANCE WITH THE APPROVAL EROSION CONTROL MEASURES AND APPROVED EROSION CONTROL PLAN.
- 11. THE CONTRACTOR SHALL BE RESPONSIBLE FOR CHECKING AND REPAIRING EROSION CONTROL SYSTEMS AFTER EACH STORM.
- 12. ADDITIONAL EROSION CONTROL MEASURES MAY BE REQUIRED BY CITY'S ENGINEERING DEPARTMENT OR BUILDING OFFICIALS.
- 13. MEASURES SHALL BE TAKEN TO COLLECT OR CLEAN ANY ACCUMULATION OR DEPOSIT OF DIRT MUD, SAND, ROCKS, GRAVEL OR DEBRIS ON THE SURFACE OF ANY STREET, ALLEY OR PUBLIC PLACE OR IN ANY PUBLIC STORM DRAIN SYSTEMS. THE REMOVAL OF AFORESAID SHALL BE DONE BY STREET SWEEPING OR HAND SWEEPING. WATER SHALL NOT BE USED TO WASH SEDIMENTS INTO PUBLIC OR PRIVATE DRAINAGE FACILITIES.
- 14. EROSION CONTROL MEASURES SHALL BE ON-SITE FROM SEPTEMBER 15TH THRU APRIL 15TH.
- 15. ALL EROSION CONTROL MEASURES SHALL BE INSTALLED AND MAINTAINED THROUGHOUT THE RAINY SEASON OR FROM OCTOBER 15 THRU APRIL 15, WHICHEVER IS GREATER.

EROSION CONTROL MEASURES:

- 1. THE FACILITIES SHOWN ON THIS PLAN ARE DESIGNED TO CONTROL EROSION AND SEDIMENT DURING THE RAINY SEASON, OCTOBER 15TH TO APRIL 15. EROSION CONTROL FACILITIES SHALL BE IN PLACE PRIOR TO OCTOBER 15TH OF ANY YEAR. GRADING OPERATIONS DURING THE RAINY SEASON WHICH LEAVE DENUDED SLOPES SHALL BE PROTECTED WITH EROSION CONTROL MEASURES IMMEDIATELY FOLLOWING GRADING ON THE SLOPES. GRADING WORK BETWEEN OCTOBER 15 AND APRIL 15 IS AT THE DISCRETION OF THE LOCAL AGENCY BUILDING OFFICIAL.
- 2. SITE CONDITIONS AT TIME OF PLACEMENT OF EROSION CONTROL MEASURES WILL VARY. APPROPRIATE ACTION INCLUDING TEMPORARY SWALES, INLETS, HYDROSEEDING, STRAW BALES, ROCK SACKS, ETC. SHALL BE TAKEN TO PREVENT EROSION AND SEDIMENTATION FROM LEAVING SITE. EROSION CONTROL MEASURES SHALL BE ADJUSTED AS THE CONDITIONS CHANGE AND THE NEED OF CONSTRUCTION SHIFT.
- CONSTRUCTION ENTRANCES SHALL BE INSTALLED PRIOR TO COMMENCEMENT OF GRADING. ALL CONSTRUCTION TRAFFIC ENTERING ONTO THE PAVED ROADS MUST CROSS THE STABILIZED CONSTRUCTION ENTRANCES. CONTRACTOR SHALL MAINTAIN STABILIZED ENTRANCE AT EACH VEHICLE ACCESS POINT TO EXISTING PAVED STREETS. ANY MUD OR DEBRIS TRACKED ONTO PUBLIC STREETS SHALL BE REMOVED DAILY AND AS REQUIRED BY THE GOVERNING AGENCY.
- 4. ALL EXPOSED SLOPES THAT ARE NOT VEGETATED SHALL BE HYDROSEEDED. IF HYDROSEEDING IS NOT USED OR IS NOT EFFECTIVE BY OCTOBER 15, THEN OTHER IMMEDIATE METHODS SHALL BE IMPLEMENTED, SUCH AS EROSION CONTROL BLANKETS, OR A THREE-STEP APPLICATION OF 1) SEED, MULCH, FERTILIZER 2) BLOWN STRAW 3) TACKIFIER AND MULCH. HYDROSEEDING SHALL BE IN ACCORDANCE WITH THE PROVISIONS OF SECTION 20" EROSION CONTROL AND HIGHWAY PLANTING" OF THE STANDARD SPECIFICATION OF THE STATE OF CALIFORNIA DEPARTMENT OF TRANSPORTATION, AS LAST REVISED. REFER TO THE EROSION CONTROL SECTION OF THE GRADING SPECIFICATIONS THAT ARE A PART OF THIS PLAN SET FOR FURTHER INFORMATION.
- INLET PROTECTION SHALL BE INSTALLED AT OPEN INLETS TO PREVENT SEDIMENT FROM ENTERING THE STORM DRAIN SYSTEM. INLETS NOT USED IN CONJUNCTION WITH EROSION CONTROL ARE TO BE BLOCKED TO PREVENT ENTRY OF SEDIMENT, MINIMUM INLET PROTECTION SHALL CONSIST OF A ROCK SACKS OR AS SHOWN ON THIS PLAN
- 6. THIS EROSION AND SEDIMENT CONTROL PLAN MAY NOT COVER ALL THE SITUATIONS THAT MAY ARISE DURING CONSTRUCTION DUE TO UNANTICIPATED FIELD CONDITIONS. VARIATIONS AND ADDITIONS MAY BE MADE TO THIS PLAN IN THE FIELD. A REPRESENTATIVE OF LEA & BRAZE ENGINEERING SHALL PERFORM A FIELD REVIEW AND MAKE RECOMMENDATIONS AS NEEDED. CONTRACTOR IS RESPONSIBLE TO NOTIFY LEA & BRAZE ENGINEERING AND THE GOVERNING AGENCY OF ANY CHANGES.
- 7. THE EROSION CONTROL MEASURES SHALL CONFORM TO THE COUNTY STANDARDS AND THE APPROVAL OF THE COUNTY'S ENGINEERING DEPARTMENT.
- 8. STRAW ROLLS SHALL BE PLACED AT THE TOE OF SLOPES AND ALONG THE DOWNSLOPE PERIMETER OF THE PROJECT. THEY SHALL BE PLACED AT 25 FOOT INTERVALS ON GRADED SLOPES. PLACEMENT SHALL RUN WITH THE CONTOURS AND ROLLS SHALL BE TIGHTLY ENDBUTTED. CONTRACTOR SHALL REFER TO MANUFACTURES SPECIFICATIONS FOR PLACEMENT AND INSTALLATION INSTRUCTIONS.

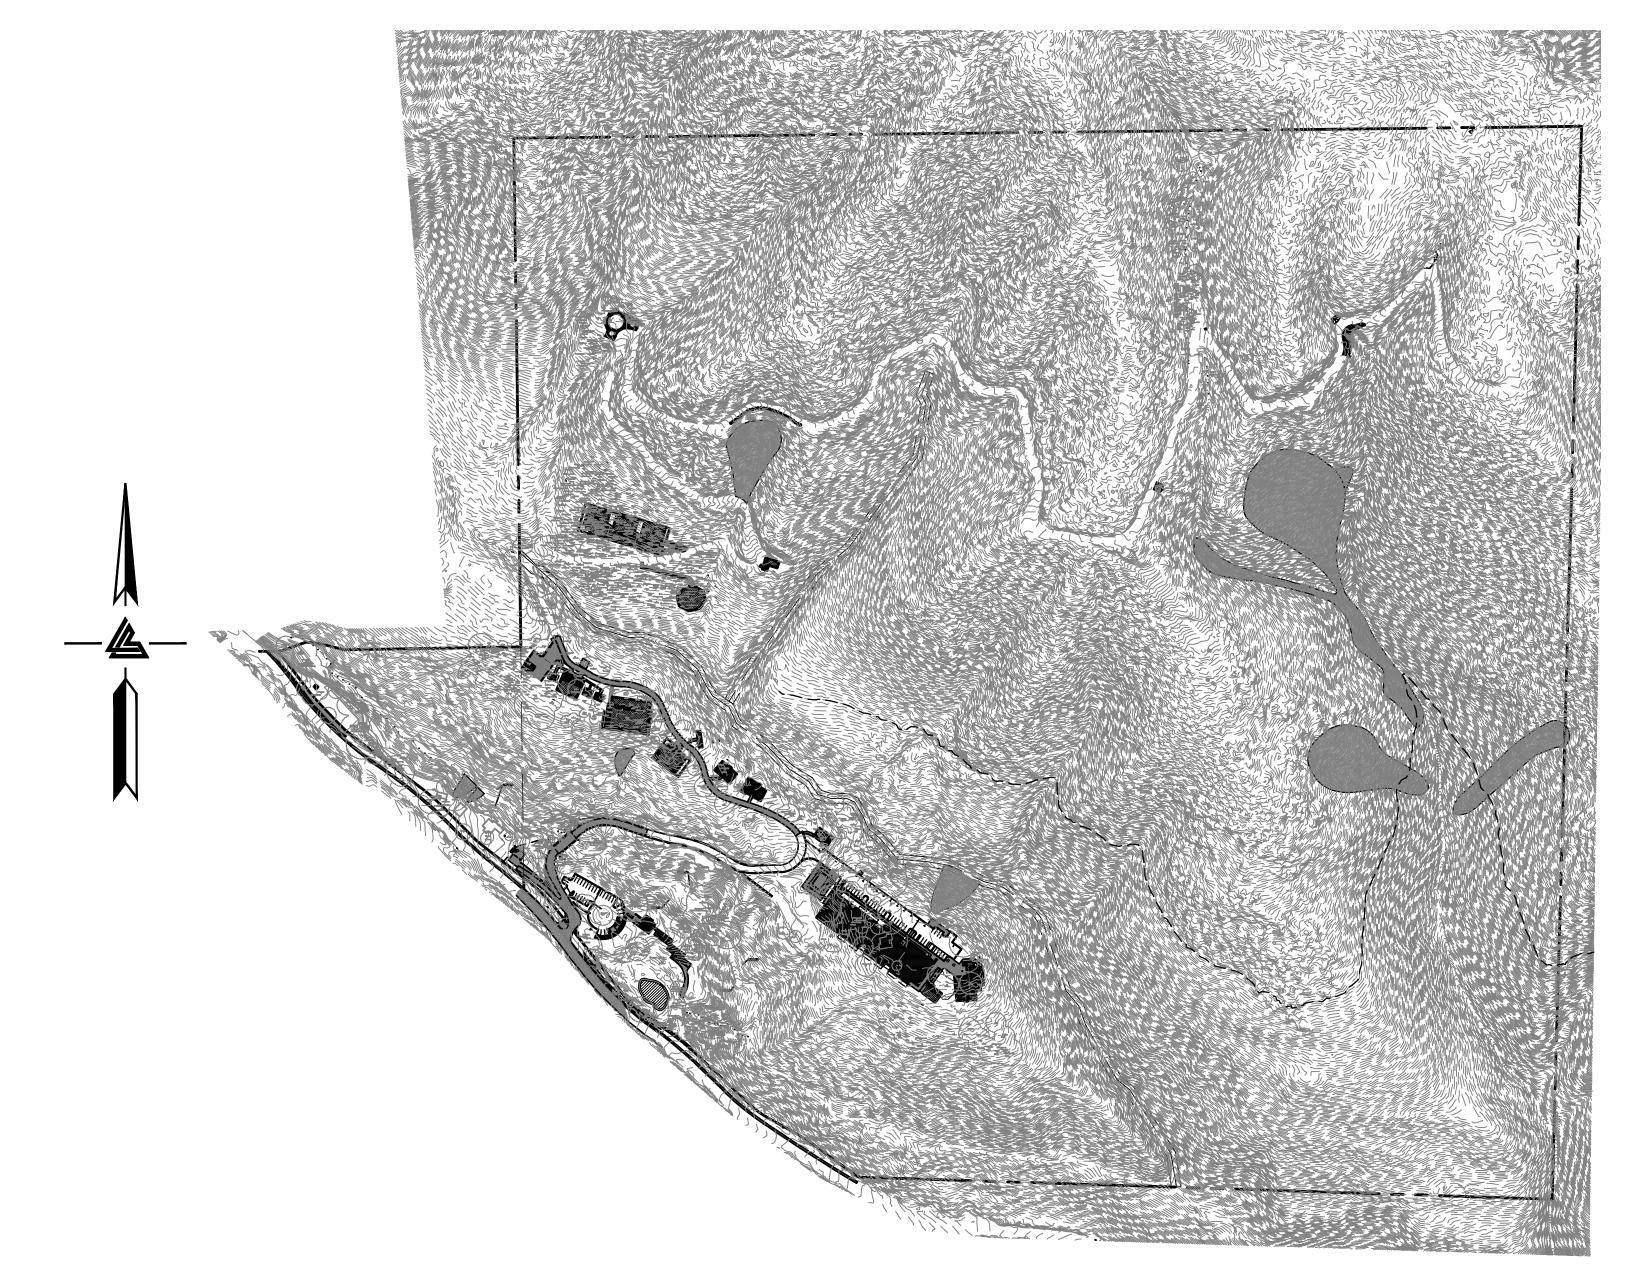

REFERENCES:

METHODS.

- 1. CALIFORNIA REGIONAL WATER QUALITY CONTROL BOARD'S FIELD MANUAL FOR EROSION AND SEDIMENTATION CONTROL
- 2. CALIFORNIA STORM WATER QUALITY ASSOCIATION BEST MANAGEMENT PRACTICES HANDBOOK FOR CONSTRUCTION

SOURCE CONTROL MEASURES:

- 1. STORE, HANDLE, AND DISPOSE OF CONSTRUCTION MATERIALS AND WASTES PROPERLY, SO AS TO PREVENT THEIR CONTACT WITH STORMWATER.
- 2. CONTROL AND PREVENT THE DISCHARGE OF ALL POTENTIAL POLLUTANTS, INCLUDING PAVEMENT CUTTING WASTES, PAINTS, CONCRETE, PETROLEUM PRODUCTS, CHEMICALS, WASHWATER OF SEDIMENTS, AND NON-STORMWATER DISCHARGES TO STORM DRAINS AND WATERCOURSES.
- 3. USE SEDIMENT CONTROLS OR FILTRATION TO REMOVE SEDIMENT WHEN DEWATERING SITE AND OBTAIN ALL NECESSARY PERMITS.
- 4. AVOID CLEANING, FUELING, OR MAINTAINING VEHICLES ON-SITE, EXCEPT IN A DESIGNATED AREA WHERE WASHWATER IS CONTAINED AND TREATED.
- 5. DELINEATE WITH FIELD MARKERS LIMITS ON CLEARING, EASEMENTS, SETBACKS, SENSITIVE OR CRITICAL AREAS, BUFFER ZONES, TREES AND DRAINAGE COURSES.
- 6. PROTECT ADJACENT PROPERTIES AND UNDISTURBED AREAS FROM CONSTRUCTION IMPACTS USING VEGETATIVE BUFFER STRIPS, SEDIMENT BARRIERS OR FILTERS, DIKES, MULCHING, OR OTHER MEASURES AS APPROPRIATE.
- 7. PERFORM CLEARING AND EARTH MOVING ACTIVITIES ONLY DURING DRY WEATHER.
- 8. LIMIT AND TIME APPLICATIONS OF PESTICIDES AND FERTILIZERS TO PREVENT POLLUTED RUNOFF.
- ACCESS POINTS. 10. AVOID TRACKING DIRT OR OTHER MATERIALS OFF-SITE. CLEAN

OFF-SITE PAVED AREAS AND SIDEWALKS USING DRY SWEEPING

9. LIMIT CONSTRUCTION ACCESS ROUTES AND STABILIZE DESIGNATED

KEY MAP

1"=250'

ALL SITE GRADING AND CONSTRUCTION OPERATIONS PREFORMED DURING THE RAINY SEASON (OCTOBER 01 TO APRIL 30) SHALL BE AT THE DISCRETION OF THE TOWN ENGINEER. IF GRADING OR CONSTRUCTION ACTIVITIES ARE PERFORMED

DURING THE RAINY SEASON, ADDITIONAL SITE BMPS MAY BE REQUIRED BY THE QSD/QSP BASED ON WEATHER CONDITIONS, SITE CONDITIONS, AND CONSTRUCTION ACTIVITIES BEING PREFORMED.

SITE DESIGN MEASURES:

- 1. PROTECT SENSITIVE AREAS AND MINIMIZE CHANGES TO THE NATURAL TOPOGRAPHY.
- 2. MINIMIZE IMPERVIOUS SURFACE AREAS.
- 3. MINIMIZE IMPERVIOUS AREAS FROM BEING DIRECTLY CONNECTED TO THE STORM DRAIN SYSTEM WHERE FEASIBLE.
- 4. MAXIMIZE PERMEABILITY BY PRESERVING OPEN SPACE.
- 5. USE PERMEABLE PAVEMENT SURFACES WHERE FEASIBLE.
- 6. USE LANDSCAPE AREAS AND SWALES TO TREAT STORM
- 7. PROVIDE PERMANENT EROSION CONTROL MEASURES.
- 8. PROVIDE A STORM WATER DESIGN THAT DOES NOT INCREASE POST-CONSTRUCTION RUNOFF.

PERIODIC MAINTENANCE: . MAINTENANCE IS TO BE PERFORMED AS FOLLOWS:

- A. DAMAGES CAUSED BY SOIL EROSION OR CONSTRUCTION SHALL BE REPAIRED AT THE END OF EACH WORKING DAY.
- B. SWALES SHALL BE INSPECTED PERIODICALLY AND MAINTAINED AS NEEDED.
- INSPECTED AFTER EACH STORM AND REPAIRS MADE AS

D. SEDIMENT SHALL BE REMOVED AND SEDIMENT TRAP

RESTORED TO ITS ORIGINAL DIMENSIONS WHEN SEDIMENT

C. SEDIMENT TRAPS, BERMS, AND SWALES ARE TO BE

- HAS ACCUMULATED TO A DEPTH OF 1' FOOT. E. SEDIMENT REMOVED FROM TRAP SHALL BE DEPOSITED IN
- A SUITABLE AREA AND IN SUCH A MANNER THAT IT WILL NOT ERODE.
- F. FILLS AND GULLIES MUST BE REPAIRED.
- 2. SAND BAG INLET PROTECTION SHALL BE CLEANED OUT WHENEVER SEDIMENT DEPTH IS ONE HALF THE HEIGHT OF ONE SAND BAG.
- 3. STRAW ROLLS SHALL BE PERIODICALLY CHECKED TO ASSURE PROPER FUNCTION AND CLEANED OUT WHENEVER THE SEDIMENT DEPTH REACHED HALF THE HEIGHT OF THE ROLL.
- 4. SILT FENCE SHALL BE PERIODICALLY CHECKED TO ASSURE PROPER FUNCTION AND CLEANED OUT WHENEVER THE SEDIMENT DEPTH REACHES ONE FOOT IN HEIGHT.
- 5. CONSTRUCTION ENTRANCE SHALL BE REGRAVELED AS NECESSARY FOLLOWING SILT/SOIL BUILDUP.
- 6. ANY OTHER EROSION CONTROL MEASURES SHOULD BE CHECKED AT REGULAR INTERVALS TO ASSURE PROPER

VICINITY MAP

ARCHITECTS

ELLISON CONSERVATION CENTER FOR WILDLIFE CARE

ISSUES AND REVISIONS DESCRIPTION

GRADING PERMIT

PLAN CHECK 4 12-21-18 PERMIT RESUBMITTAL PERMIT MODIFICATION

04-11-19 ASA DELTA 2 04-22-19 BID SET

05-10-19 BID SET ADDENDUM 05-22-19 UTILITY PLAN CHECK 1

08-06-19 PHASE 4 - PERMIT SUBMITTAL 09-20-19 CONSTRUCTION SET 1 01-28-20 PERMIT MODIFICATION 2

05-29-20 PLAN CHECK RESPONSE PERMIT MODIFICATION 2

07-22-20 UTILITY PLAN SUBMITTAL

SANTA CLARA COUNTY RECORD INFORMATION APPLICANT: PENINSULA HUMANE SOCIETY

ROAD: CONGRESS SPRINGS LDE FILE: 6943-17-17G GRADING PERMIT: DEV19-1838 UTILITY PERMIT: DEV19-0220

> PROJECT NUMBER 16011.00

SHEET TITLE

EROSION CONTROL OVERALL SITE PLAN

SCALE 1" = 250'PC / CA Designed By Checked By PC / JL

18, 2017 18, 2017

31, 2017

30, 2019

01. 2019

14, 2019

OCTOBER

OCTOBER

OCTOBER

OCTOBER

OCTOBER

SEPTEMBER

2130712

C-9.0

SHEET NUMBER

ASA/USE PERMIT MODIFICATION #3 PLN-17-6943

PLOT: 2/16/2021 11:38:44 AM

CONSTRUCTION SCHEDULE

CONSTRUCTION START DATE:

GRADING START DATE DATE:

GRADING COMPLETION DATE:

CONSTRUCTION END DATE:

IMPLEMENT CONSTRUCTION BMPS:

IMPLEMENT POST-CONSTRUCTION BMPS:

ALL DRAWINGS AND WRITTEN MATERIAL APPEARING HEREIN CONSTITUTE ORIGINAL AND UNPUBLISHED WORK OF THE ARCHITECT AND MAY NOT BE DUPLICATED, USED OR DISCLOSED WITHOUT WRITTEN CONSENT OF THE ARCHITECT

CONSTRUCTION BEST MANAGEMENT PRACTICES SUPERVISOR GUIDELINES:

- REFER TO THE CALIFORNIA STORMWATER QUALITY ASSOCIATION HANDBOOK FOR CONSTRUCTION BMP FACT SHEETS FOR A COMPLETE DESCRIPTION OF THE BEST MANAGEMENT PRACTICES TO BE USED.
- 2. CONSTRUCTION BMP FACT SHEETS FROM THE HANDBOOK FOR BMPS USED ON THIS PROJECT ARE LOCATED IN APPENDIX E OF THE EROSION POLLUTION PREVENTION PLAN.

EROSION CONTROL BMPS:

- CONSTRUCTION SCHEDULING
- **GEOTEXTILES & MATS**
- DRAINAGE SWALES
- WND EROSION CONTROL

SEDIMENT CONTROL BMPS:

- SILT FENCE
- GRAVEL BAG CHECK DAM
- STREET SWEEPING AND VACUUMING
- STORM DRAIN INLET PROTECTION

TRACKING CONTROL BMPS:

STABILIZED CONSTRUCTION ENTRANCE

NON-STORMWATER CONTROL BMPS:

- WATER CONSERVATION PRACTICES
- PAVING AND GRINDING OPERATIONS
- ILLICIT CONNECTION / DISCHARGES
- POTABLE WATER / IRRIGATION
- VEHICLE AND EQUIPMENT CLEANING
- VEHICLE AND EQUIPMENT FUELING
- VEHICLE AND EQUIPMENT MAINTENANCE
- NS-12) CONCRETE CURING

MATERIALS POLLUTION AND WASTE MANAGEMENT **CONTROL BMPS:**

MATERIAL DELIVERY AND STORAGE

- MW-2MATERIAL USE
- STOCKPILE MANAGEMENT
- SPILL PREVENTION AND CONTROL
- SOLID WASTE MANAGEMENT
- HAZARDOUS WASTE MANAGEMENT
- CONCRETE WASTE MANAGEMENT
- SANITARY AND SEPTIC WASTE MANAGEMENT

REFERENCES:

1. CALIFORNIA REGIONAL WATER QUALITY CONTROL BOARD'S FIELD MANUAL FOR EROSION AND SEDIMENTATION CONTROL

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2. CALIFORNIA STORM WATER QUALITY ASSOCIATION BEST MANAGEMENT PRACTICES HANDBOOK FOR CONSTRUCTION

NOTE:
ALL SITE GRADING AND CONSTRUCTION OPERATIONS PREFORMED DURING THE RAINY SEASON (OCTOBER 01 TO APRIL 15) SHALL BE AT THE DISCRETION OF THE TOWN ENGINEER. IF GRADING OR CONSTRUCTION ACTIVITIES ARE PERFORMED DURING THE RAINY SEASON, ADDITIONAL SITE BMPS MAY

BE REQUIRED BY THE QSD/QSP BASED ON WEATHER

CONDITIONS, SITE CONDITIONS, AND CONSTRUCTION

ACTIVITIES BEING PREFORMED.

GENERAL CONSTRUCTION AND SITE

- A. STABILIZE ALL DENUDED AREAS AND MAINTAIN EROSION CONTROL MEASURES CONTINUOUSLY BETWEEN OCTOBER 1 AND APRIL 30 AND AS NEEDED YEAR ROUND TO MAINTAIN EFFECTIVE STORMWATER MANAGEMENT. STABILIZING SHALL INCLUDE BOTH PROACTIVE MEASURES, SUCH AS THE PLACEMENT OF FIBER ROLLS AND/OR COIR NETTING, AND THE USE OF PASSIVE MEASURES, SUCH AS RE-VEGETATING DISTURBED AREAS WITH PLANTS NATIVE TO THE GENERAL AREA. CLEARING AND EARTH MOVING ACTIVITIES SHALL OCCUR ONLY DURING DRY WEATHER.
- B. SEQUENCE CONSTRUCTION TO INSTALL SEDIMENT—CAPTURING DEVICES FIRST, FOLLOWED BY RUNOFF CONTROL MEASURES AND RUNOFF CONVEYANCES. NO CONSTRUCTION ACTIVITIES SHALL BEGIN UNTIL AFTER ALL PROPOSED MEASURES ARE IN
- C. MINIMIZE THE AREA OF BARE SOIL EXPOSED AT ONE TIME (PHASED GRADING). CLEAR ONLY AREAS ESSENTIAL FOR
- D. WITHIN FIVE DAYS OF CLEARING OR INACTIVITY IN CONSTRUCTION, STABILIZE BARE SOILS THROUGH EITHER NON-VEGETATIVE BMPS, SUCH AS MULCHING, OR VEGETATIVE EROSION CONTROL METHODS, SUCH AS SEEDING. VEGETATIVE EROSION CONTROL MEASURES SHALL BE ESTABLISHED WITHIN TWO WEEKS OF SEEDING/PLANTING.
- E. CONSTRUCTION ENTRANCES AND ACCESS ROUTES SHALL BE LIMITED AND STABILIZED AT DESIGNATED ACCESS POINTS IMMEDIATELY AFTER GRADING AND FREQUENTLY MAINTAINED TO PREVENT EROSION AND CONTROL DUST.
- F. AVOID TRACKING DIRT OR OTHER MATERIALS OFF-SITE: CLEAN OFF-SITE PAVED AREAS AND SIDEWALKS USING DRY SWEEPING
- G. CONTROL WIND-BORN DUST THROUGH THE INSTALLATION OF WIND BARRIERS SUCH AS HAY BALES AND/OR SPRINKLING.
- H. SOIL AND/OR OTHER CONSTRUCTION-RELATED MATERIAL STOCKPILED ON-SITE SHALL BE PLACED AT A MINIMUM OF 200 FEET FROM ALL WETLANDS AND DRAIN COURSES. STOCKPILED SOILS SHALL BE COVERED WITH TARPS AT ALL TIMES OF THE
- INTERCEPT RUNOFF ABOVE DISTURBED SLOPES AND CONVEY IT TO A PERMANENT CHANNEL OR STORM DRAINS BY USING EARTH DIKES, PERIMETER DIKES OR SWALES, OR DIVERSIONS. USE CHECK DAMS WHERE APPROPRIATE.
- J. PROVIDE PROTECTION FOR RUNOFF CONVEYANCE OUTLETS BY REDUCING FLOW VELOCITY AND DISSIPATING FLOW ENERGY.
- K. INSTALL STORM DRAIN INLET PROTECTION THAT TRAPS SEDIMENT BEFORE IT ENTERS ANY ADJACENT STORM SEWER SYSTEMS. THIS BARRIER SHALL CONSIST OF FILTER FABRIC, STRAW BALES, GRAVEL, OR SAND BAGS.
- L. PROTECTING ADJACENT PROPERTIES AND UNDISTURBED AREAS FROM CONSTRUCTION IMPACTS USING VEGETATIVE BUFFER STRIPS, SEDIMENT BARRIERS OR FILTERS, DIKES, MULCHING, OR OTHER MEASURES AS APPROPRIATE.
- M. INSTALL SEDIMENT TRAPS/BASINS AT OUTLETS OF DIVERSIONS. CHANNELS, SLOPE DRAINS, OR OTHER RUNOFF CONVEYANCES C-9.16, C-9.27THAT DISCHARGE SEDIMENT-LADEN WATER. SEDIMENT TRAPS/BASINS SHALL BE CLEANED OUT WHEN 50% FULL (BY VOLUME).
- N. USE SILT FENCE AND/OR VEGETATED FILTER STRIPS TO TRAP SEDIMENT CONTAINED IN SHEET FLOW. THE MAXIMUM DRAINAGE AREA TO THE FENCE SHOULD BE 0.5-ACRE OR LESS PER 100 FEET OF FENCE. SILT FENCES SHALL BE INSPECTED REGULARLY AND SEDIMENT REMOVED WHEN IT REACHES 1/3 OF THE FENCE HEIGHT. VEGETATED FILTER STRIPS SHOULD HAVE RELATIVELY FLAT SLOPES AND BE VEGETATED WITH EROSION RESISTANT SPECIES.
- O. THROUGHOUT THE CONSTRUCTION PERIOD, THE APPLICANT SHALL CONDUCT REGULAR INSPECTIONS OF THE CONDITION AND OPERATIONAL STATUS OF ALL STRUCTURAL BMPS REQUIRED BY THE APPROVED EROSION CONTROL PLAN.
- P. STORE, HANDLE AND DISPOSE OF CONSTRUCTION MATERIALS AND WASTES PROPERLY, SO AS TO PREVENT THEIR CONTACT WITH STORMWATER.
- Q. CONTROL AND PREVENT THE DISCHARGE OF ALL POTENTIAL POLLUTANTS, INCLUDING PAVEMENT CUTTING WASTES, PAINTS, CONCRETE, PETROLEUM PRODUCTS, CHEMICALS, WASH WATER OR SEDIMENTS, AND NON-STORMWATER DISCHARGES TO STORM DRAINS AND WATERCOURSES.
- R. USE SEDIMENT CONTROLS OR FILTRATION TO REMOVE SEDIMENT WHEN DE-WATERING SITE AND OBTAIN ALL NECESSARY
- S. AVOID CLEANING, FUELING, OR MAINTAINING VEHICLES ON-SITE, EXCEPT IN A DESIGNATED AREA WHERE WASH WATER IS CONTAINED AND TREATED.
- T. DELINEATE WITH FIELD MARKERS CLEARING LIMITS, EASEMENTS, SETBACKS, SENSITIVE OR CRITICAL AREAS, BUFFER ZONES, TREES, AND DRAINAGE COURSES.
- U. LIMIT AND TIME APPLICATIONS OF PESTICIDES AND FERTILIZERS TO PREVENT POLLUTED RUNOFF.
- V. THE CONTRACTOR SHALL TRAIN AND PROVIDE INSTRUCTION TO ALL EMPLOYEES AND SUBCONTRACTORS REGARDING THE CONSTRUCTION BEST MANAGEMENT PRACTICES, INCLUDING, BUT NOT LIMITED TO, THOSE LISTED ABOVE.
- W. THE PROJECT CONTRACTOR SHALL TRAIN AND PROVIDE INSTRUCTION TO ALL EMPLOYEES AND SUBCONTRACTORS REGARDING THE CONSTRUCTION BEST MANAGEMENT PRACTICES INCLUDING, BUT NOT LIMITED TO, THOSE LISTED ABOVE.
- X. ADDITIONAL BEST MANAGEMENT PRACTICES, IN ADDITION TO THOSE SHOWN ON THE APPROVED PLANS, MAY BE REQUIRED BY THE BUILDING INSPECTOR TO MAINTAIN EFFECTIVE STORMWATER MANAGEMENT DURING CONSTRUCTION ACTIVITIES AND FOR POST-CONSTRUCTION SITE STABILIZATION. ANY WATER LEAVING THE SITE SHALL BE CLEAR AND RUNNING SLOWLY AT ALL TIMES.

AREA OF DETAIL LIMIT OF DISTURBED AREA SEE SHEET C-9.2, 10.72 ACRES C-9.13, C-9.24**SCALE:** 1" = 200' AREA OF DETAIL SEE SHEET C-9.3, AREA OF C-9.14, C-9.25**DETAIL SEE** SHEET C-9.12, AREA OF DETAIL C-9.23, C-9.34SEE SHEET AREA OF DETAIL C-9.6, C-9.17,-SEE SHEET C-9.4, C - 9.28C-9.15, C-9.26AREA OF DETAIL -SEE SHEET C-9.7 C-9.18, C-9.29AREA OF DETAIL -SEE SHEET C-9.9, C-9.20, C-9.31AREA OF DETAIL SEE AREA OF DETAIL SHEET C-9.5, SEE SHEET C-9.11, C-9.22, C-9.33AREA OF DETAIL SEE SHEET C-9.8, C-9.19, C-9.30AREA OF DETAIL SEE SHEET C-9.10,-C-9.21, C-9.32

DUST CONTROL GUIDELINES:

- A. ALL GRADED SURFACES AND MATERIALS, WHETHER FILLED, EXCAVATED, TRANSPORTED OR STOCKPILED, SHALL BE WETTED, PROTECTED OR CONTAINED IN SUCH A MANNER AS TO PREVENT ANY SIGNIFICANT NUISANCE FROM DUST, OR SPILLAGE UPON ADJOINING WATER BODY, PROPERTY, OR STREETS. EQUIPMENT AND MATERIALS ON THE SITE SHALL BE USED IN SUCH A MANNER AS TO AVOID EXCESSIVE DUST. A DUST CONTROL PLAN MAY BE REQUIRED AT ANY TIME DURING THE COURSE OF THE PROJECT.
- B. A DUST PALLIATIVE SHALL BE APPLIED TO THE SITE (ALL GRADED/DISTURBED AREAS, PRIVATE ROADS AND, IF APPLICABLE, PUBLIC COUNTY ROADWAYS) WHEN REQUIRED BY THE COUNTY. THE TYPE AND RATE OF APPLICATION SHALL BE RECOMMENDED BY THE SOILS ENGINEER AND APPROVED BY THE DEPARTMENT OF PUBLIC WORKS, THE PLANNING AND BUILDING DEPARTMENT'S GEOTECHNICAL ENGINEER, AND THE REGIONAL WATER QUALITY CONTROL BOARD.

ALL SITE GRADING AND CONSTRUCTION OPERATIONS PREFORMED DURING THE RAINY SEASON (OCTOBER 01 TO APRIL 15) SHALL BE AT THE DISCRETION OF THE TOWN ENGINEER.

IF GRADING OR CONSTRUCTION ACTIVITIES ARE PERFORMED DURING THE RAINY SEASON, ADDITIONAL SITE BMPS MAY BE REQUIRED BY THE QSD/QSP BASED ON WEATHER CONDITIONS. SITE CONDITIONS, AND CONSTRUCTION ACTIVITIES BEING

SITE INFORMATION:

169.8 AC SITE AREA: DISTURBED AREA: 10.72 AC GRADED AREA: 8.00 AC % SITE TO BE DISTURBED: 6.0 % % SITE TO BE GRADED: 4.7 % % IMPERVIOUS BEFORE PROJECT: 0.02 % % IMPERVIOUS AFTER PROJECT: 2.20 %

NOTE: SEAL ALL OTHER INLETS NOT INTENDED TO ACCEPT STORM WATER AND DIRECT FLOWS TEMPORARILY TO FUNCTIONAL SEDIMENTATION BASIN INLETS. -TYP

PROVIDE STRAW MULCH ON ALL EXPOSED AREAS NOT UNDER ACTIVE CONSTRUCTION. PROVIDE LANDSCAPE PLANTING FOR PERMANENT EROSION CONTROL IMMEDIATELY AFTER COMPLETION OF CONSTRUCTION. ENSURE THAT ALL VEGETATION IS HEALTHY AND FULLY ESTABLISHED PRIOR TO PROJECT COMPLETION.

(WE-1

EROSION CONTROL LEGEND

SEDIMENTATION

INLET PROTECTION

SILT FENCE

GRAVEL BAG



CONCRETE WASHOUT

EROSION CONTROL

ASA/USE PERMIT MODIFICATION #3

PLOT: 2/16/2021 11:39:24 AM

BLANKET

CENTER FOR WILDLIFE CARE



ELLISON CONSERVATION



ISSUES AND REVISIONS

GRADING PERMIT PLAN CHECK 4 12-21-18 PERMIT RESUBMITTAL PERMIT MODIFICATION

04-11-19 ASA DELTA 2 04-22-19 BID SET 05-10-19 BID SET ADDENDUM

05-22-19 UTILITY PLAN CHECK 08-06-19 PHASE 4 - PERMIT SUBMITTAL

09-20-19 CONSTRUCTION SET 1 01-28-20 PERMIT MODIFICATION 2 05-29-20 PLAN CHECK RESPONSE PERMIT MODIFICATION 2

07-22-20 UTILITY PLAN SUBMITTAL

RECORD INFORMATION APPLICANT: PENINSULA HUMANE SOCIETY ROAD: CONGRESS SPRINGS LDE FILE: 6943-17-17G

GRADING PERMIT: DEV19-1838 UTILITY PERMIT: DEV19-0220 PROJECT NUMBER

16011.00

SANTA CLARA COUNTY

SHEET TITLE **EROSION CONTROL**


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NO SCALE PC / CA Designed By Checked By PC / JL 2130712

SHEET NUMBER

C-9.1

PLN-17-6943

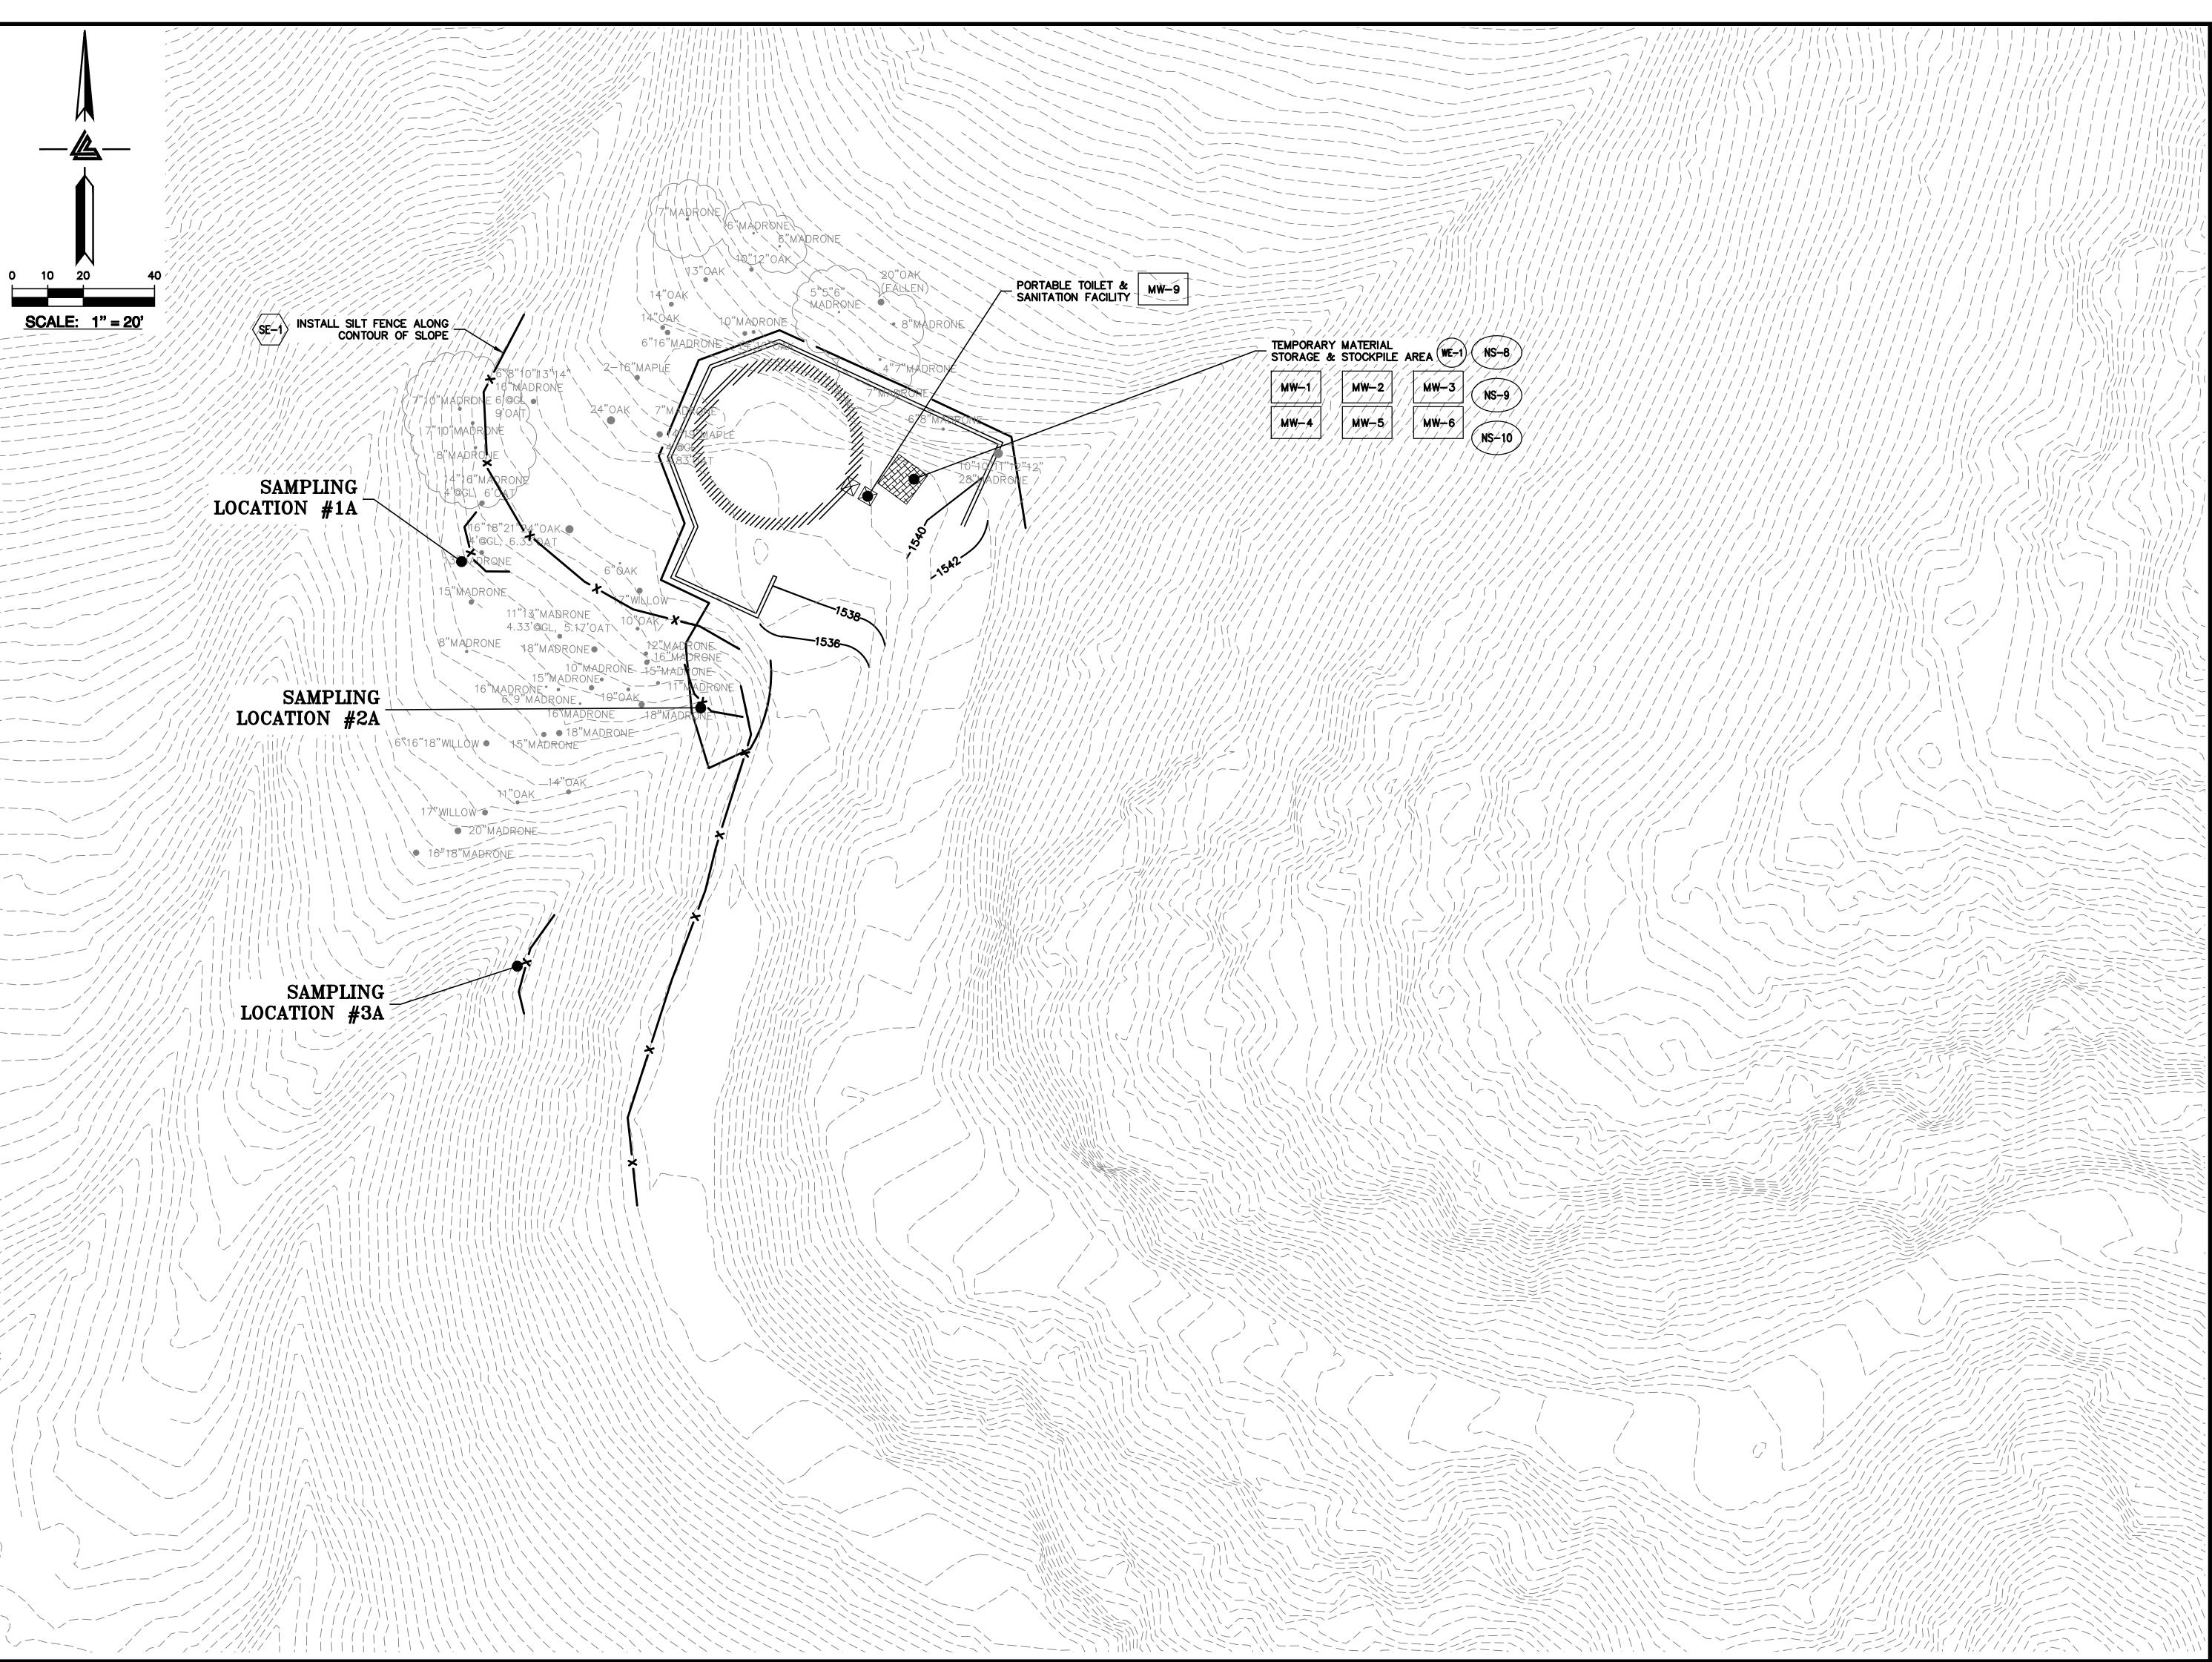

ELLISON CONSERVATION CENTER FOR WILDLIFE CARE SARATOGA, CA





ARCHITECTS KORTH SUNSERI HAGEY

ISSUES AND REVISIONS

12-21-18 PERMIT RESUBMITTAL

05-10-19 BID SET ADDENDUM 1 05-22-19 UTILITY PLAN CHECK 1 08-06-19 PHASE 4 - PERMIT SUBMITTAL

09-20-19 CONSTRUCTION SET 1 01-28-20 PERMIT MODIFICATION 2 05-29-20 PLAN CHECK RESPONSE PERMIT MODIFICATION 2

07-22-20 UTILITY PLAN SUBMITTAL

SANTA CLARA COUNTY RECORD INFORMATION APPLICANT: PENINSULA HUMANE SOCIETY ROAD: CONGRESS SPRINGS

LDE FILE: 6943-17-17G GRADING PERMIT: DEV19-1838 UTILITY PERMIT: DEV19-0220

PROJECT NUMBER

SHEET TITLE


PHASE 1 BMP PLAN DEMOLITION, GRADING & STAGING

> SCALE 1" = 20'

PC / CA PC / JL 2130712

SHEET NUMBER

C-9.2

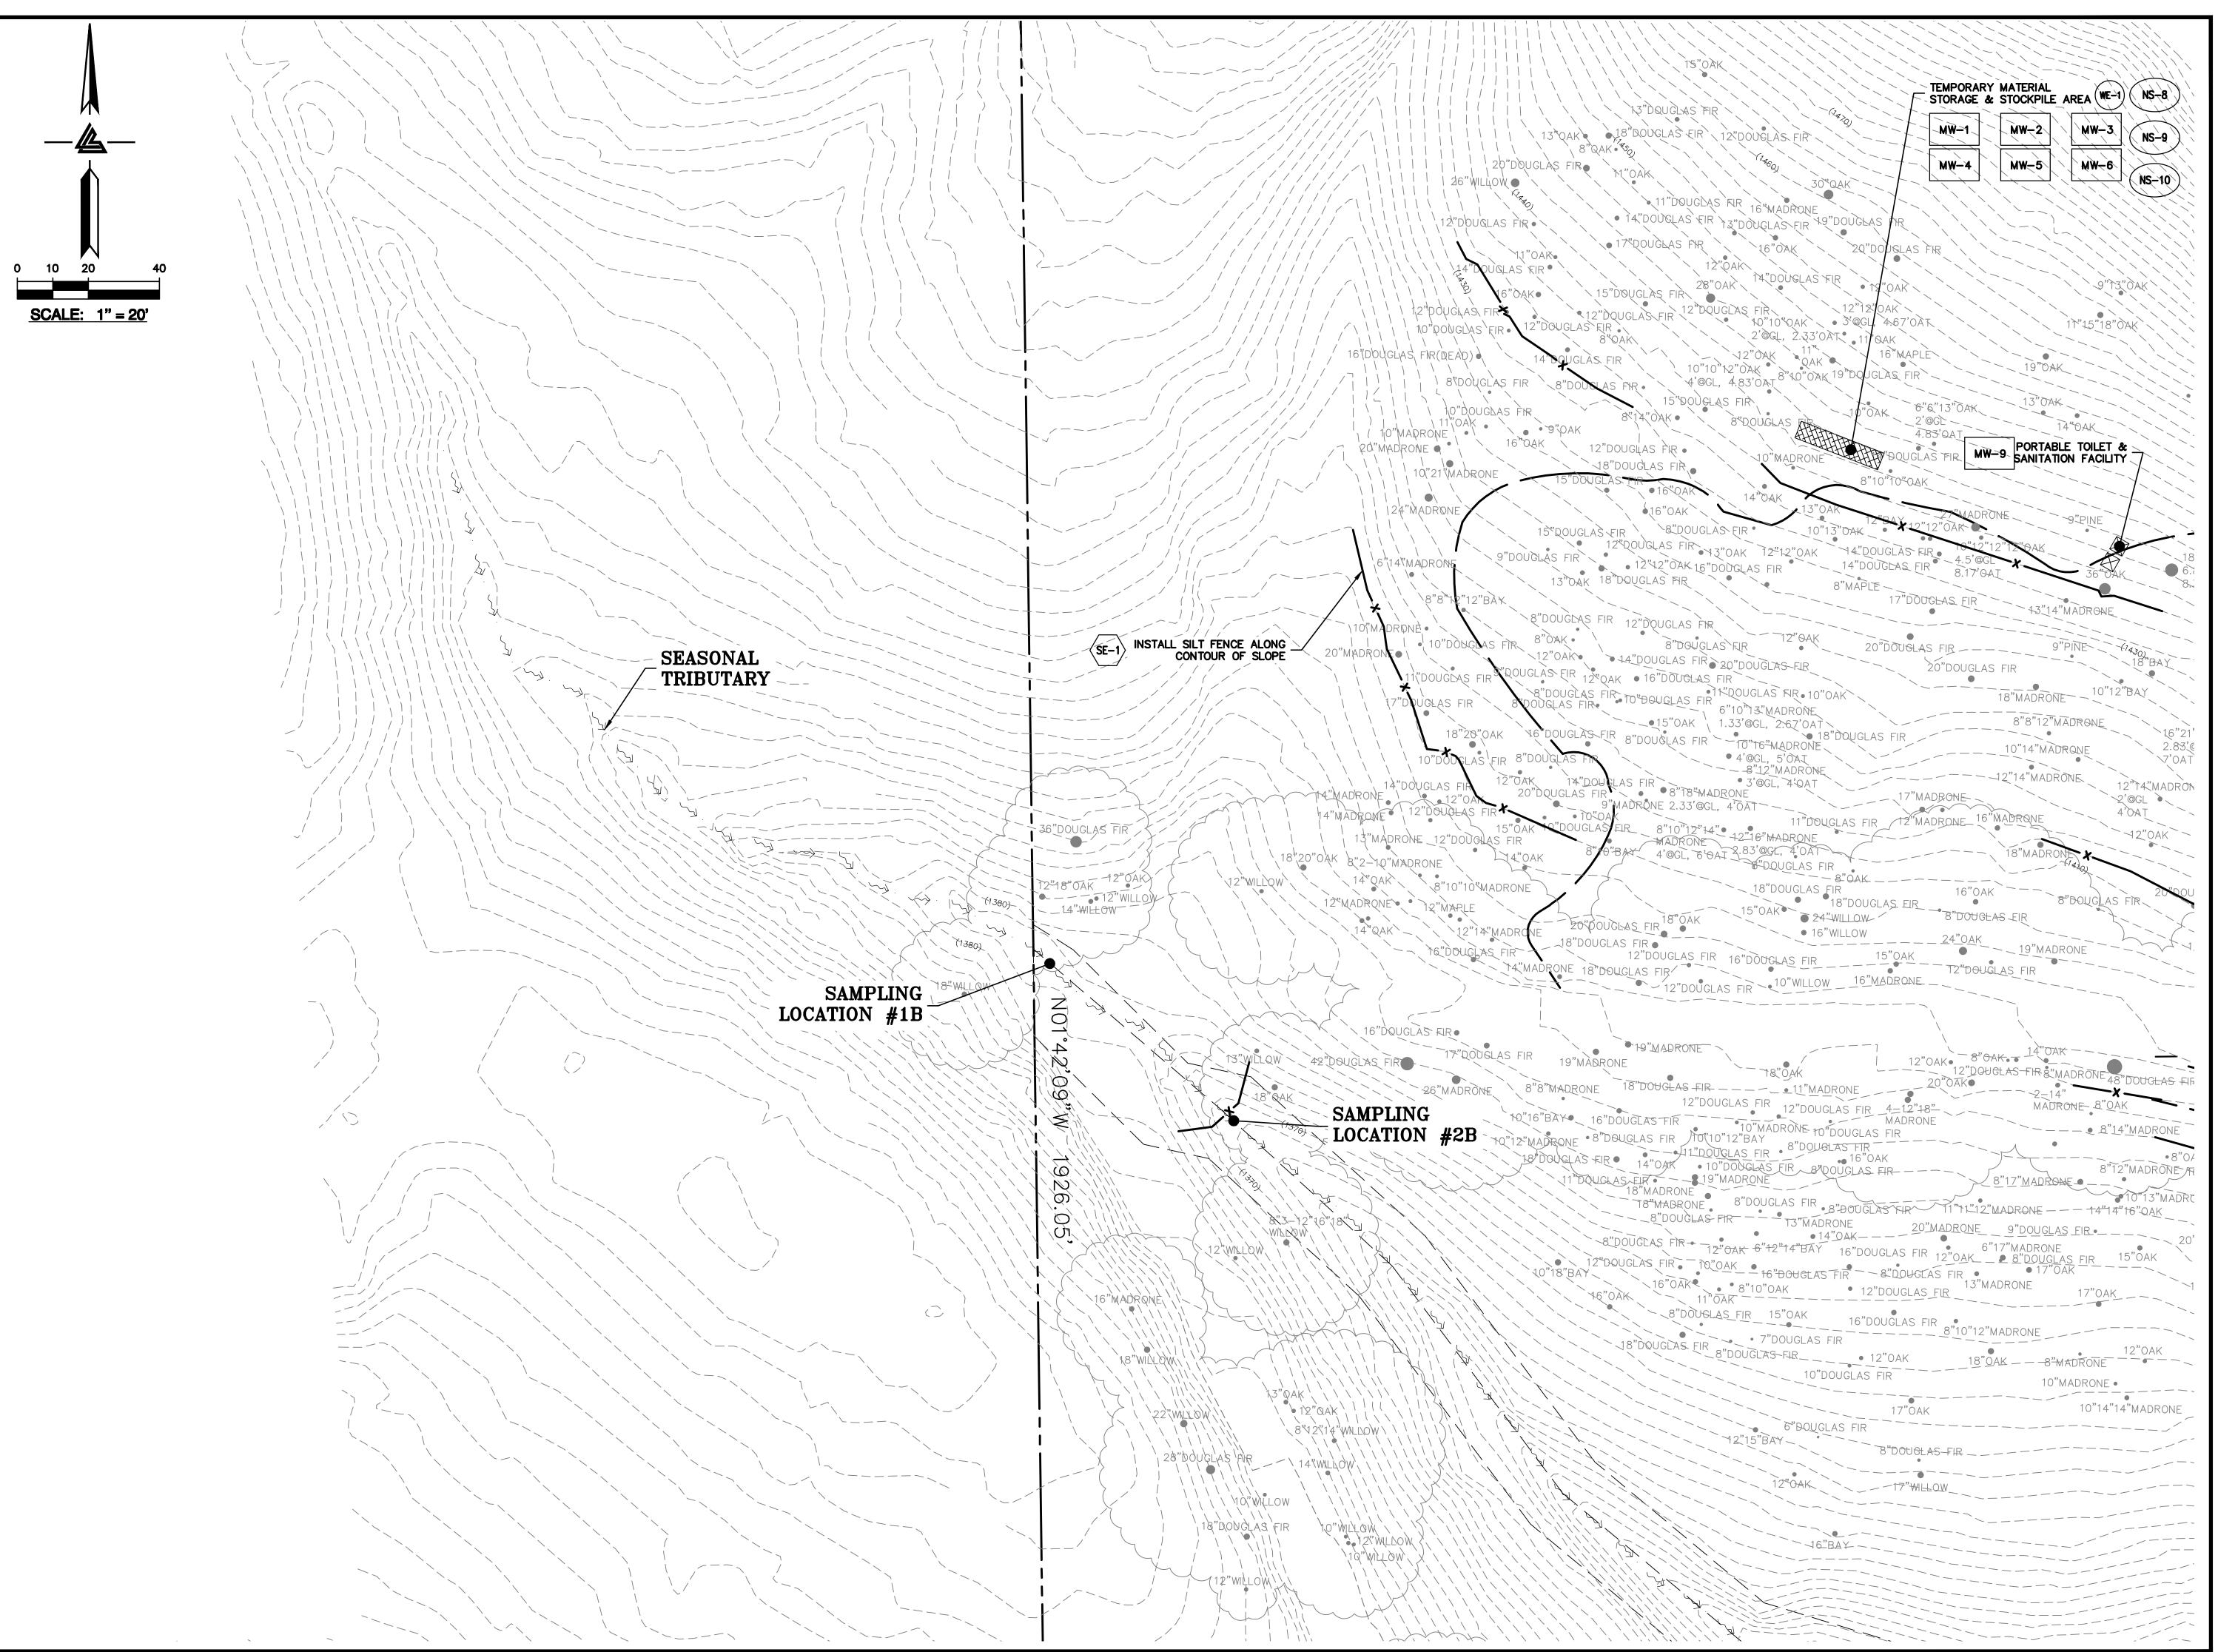

ELLISON CONSERVATION CENTER FOR WILDLIFE CARE





ARCHITECTS



09-06-18 GRADING PERMIT PLAN CHECK 4 12-21-18 PERMIT RESUBMITTAL PERMIT MODIFICATION 03-26-19 PLAN CHECK 1 04-11-19 ASA DELTA 2 04-22-19 BID SET

05-22-19 UTILITY PLAN CHECK 1 08-06-19 PHASE 4 - PERMIT SUBMITTAL

09-20-19 CONSTRUCTION SET 1 01-28-20 PERMIT MODIFICATION 2 05-29-20 PLAN CHECK RESPONSE PERMIT MODIFICATION 2 07-22-20 UTILITY PLAN SUBMITTAL

SANTA CLARA COUNTY **RECORD INFORMATION** APPLICANT: PENINSULA HUMANE SOCIETY

ROAD: CONGRESS SPRINGS LDE FILE: 6943-17-17G GRADING PERMIT: DEV19-1838 UTILITY PERMIT: DEV19-0220

> PROJECT NUMBER 16011.00

SHEET TITLE PHASE 1 BMP PLAN DEMOLITION, GRADING & STAGING

SCALE 1" = 20'PC / CA PC / JL 2130712


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SHEET NUMBER


ASA/USE PERMIT MODIFICATION #3

PLN-17-6943

PLOT: 2/16/2021 11:40:27 AM



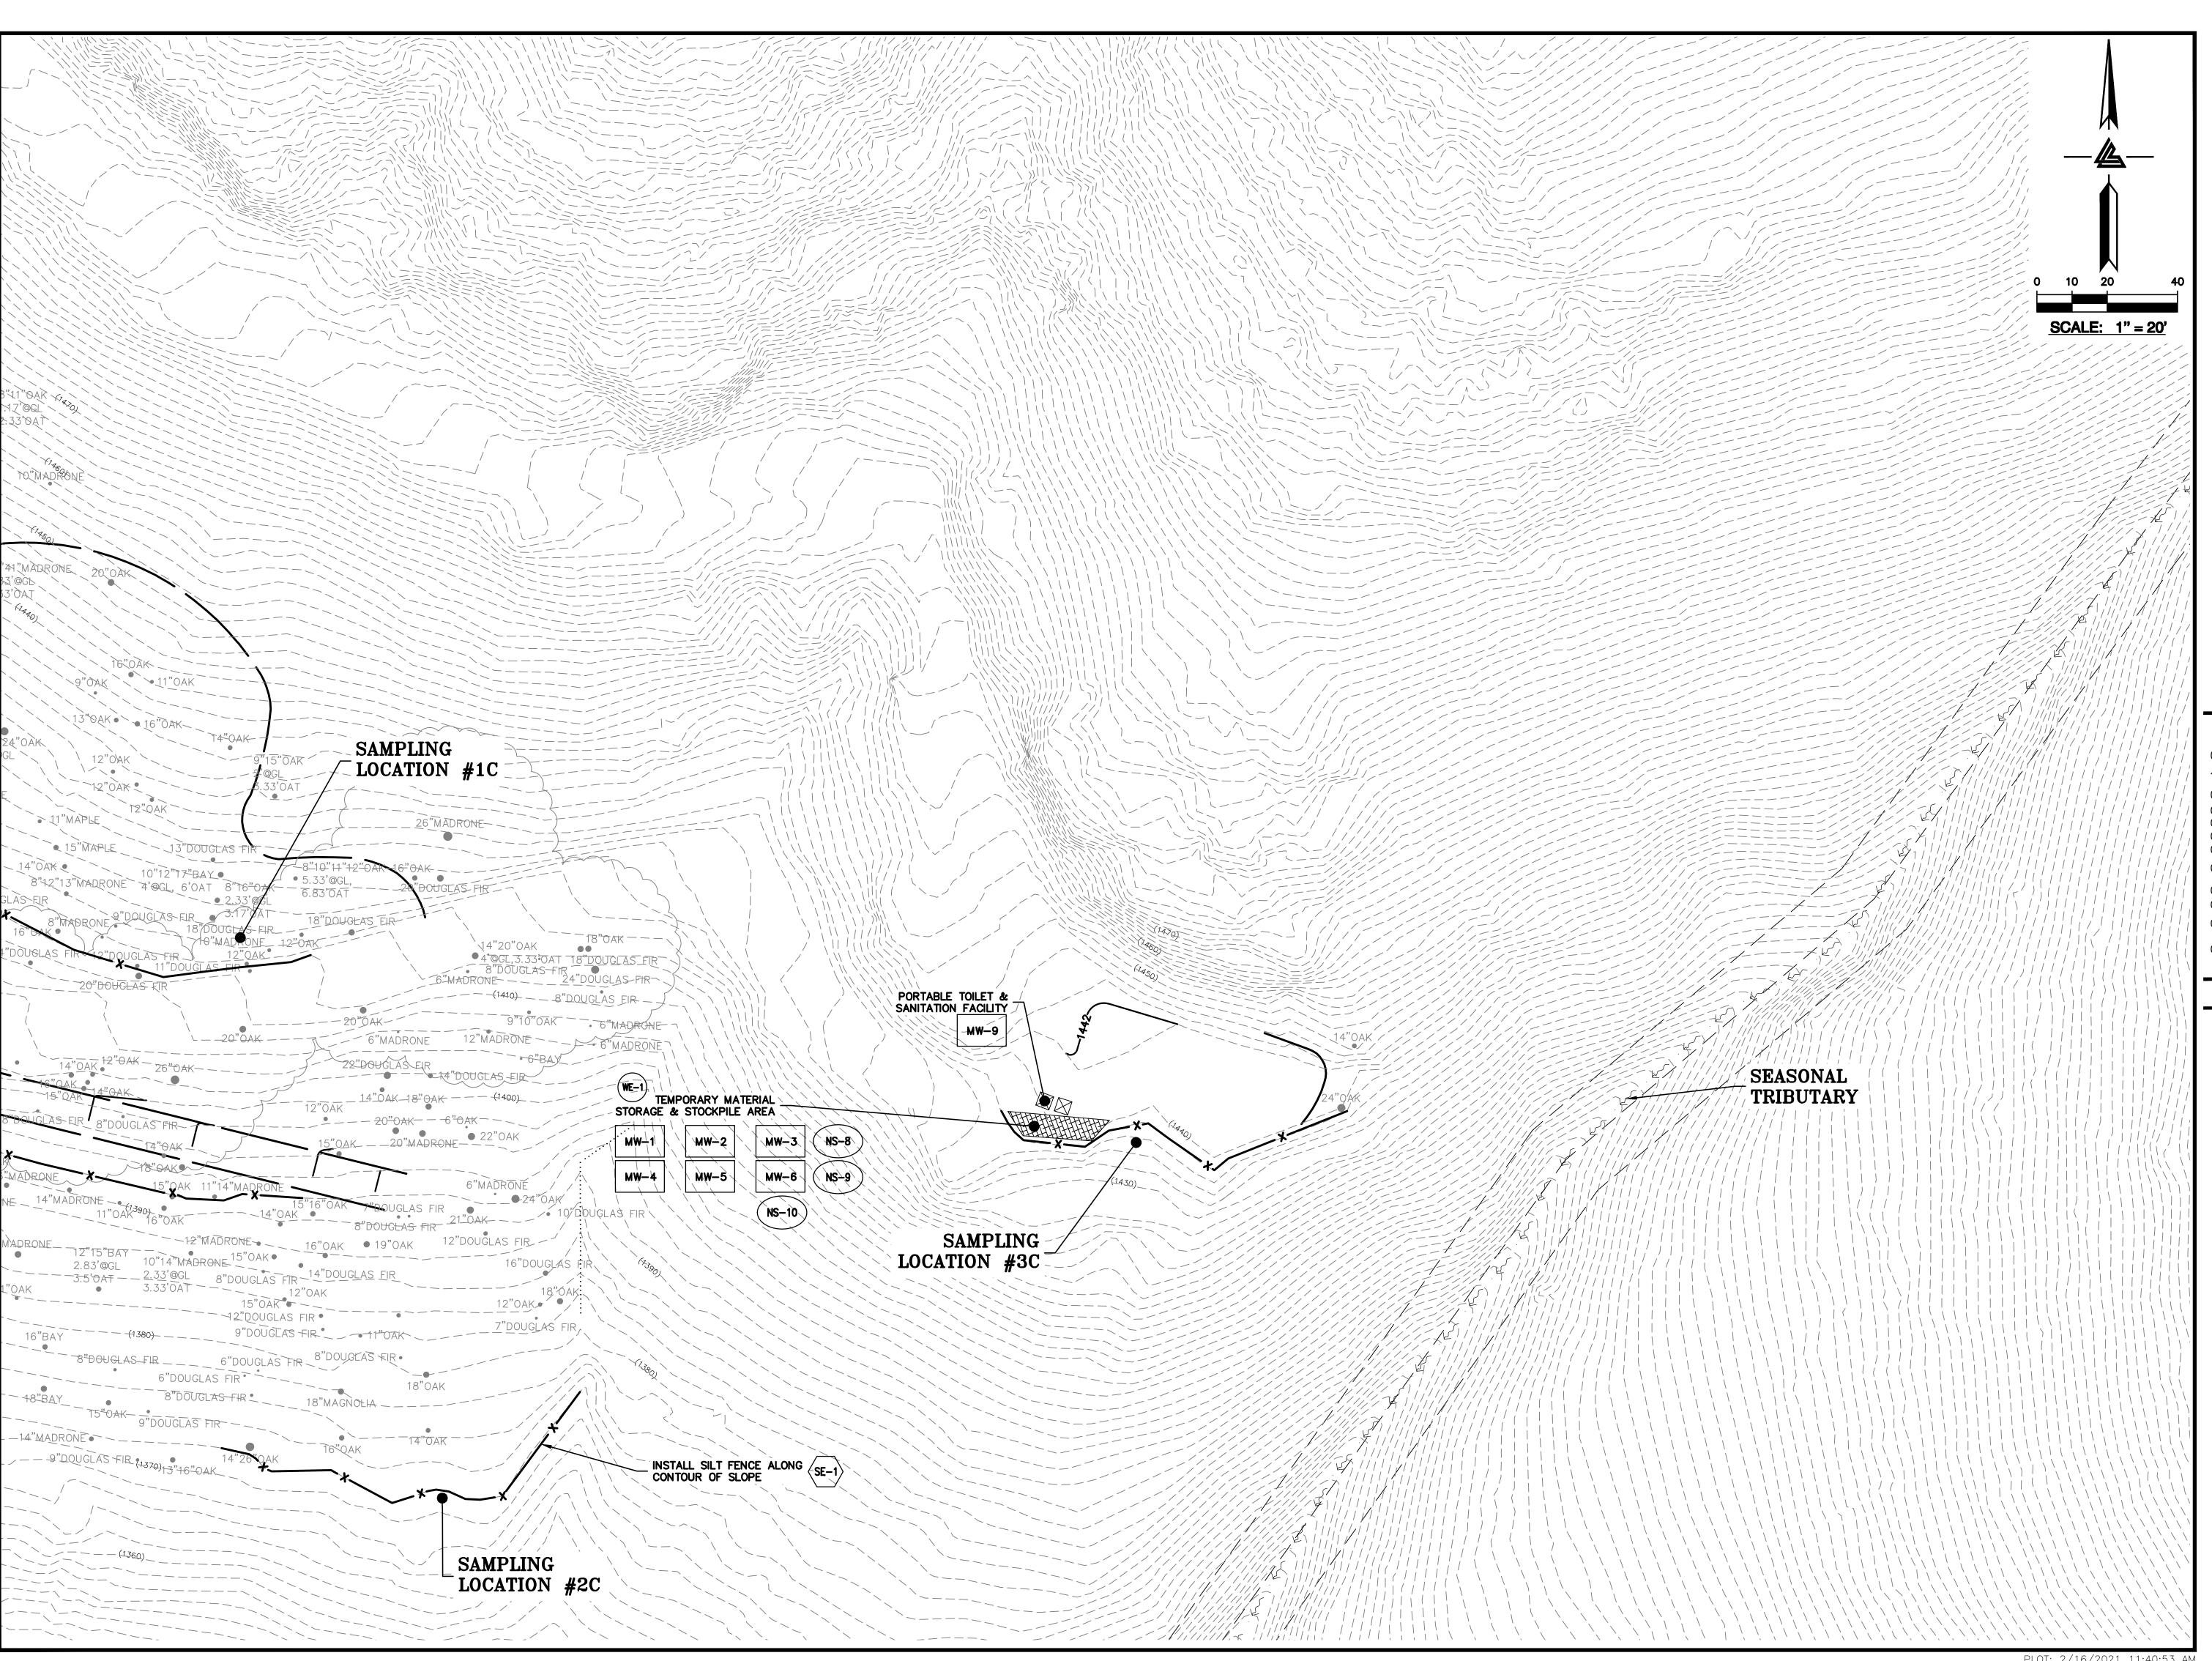

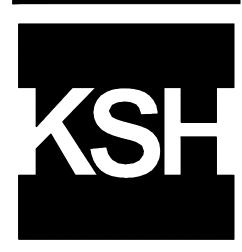

ARCHITECTS KORTH SUNSERI HAGEY



12-21-18 PERMIT RESUBMITTAL

04-11-19 ASA DELTA 2

05-22-19 UTILITY PLAN CHECK 1 08-06-19 PHASE 4 - PERMIT SUBMITTAL

09-20-19 CONSTRUCTION SET 1 01-28-20 PERMIT MODIFICATION 2 05-29-20 PLAN CHECK RESPONSE PERMIT MODIFICATION 2

07-22-20 UTILITY PLAN SUBMITTAL

SANTA CLARA COUNTY RECORD INFORMATION APPLICANT: PENINSULA HUMANE SOCIETY

ROAD: CONGRESS SPRINGS LDE FILE: 6943-17-17G GRADING PERMIT: DEV19-1838 UTILITY PERMIT: DEV19-0220

> PROJECT NUMBER 16011.00


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DEMOLITION, GRADING & STAGING

1" = 20'PC / CA PC / JL 2130712

SHEET NUMBER



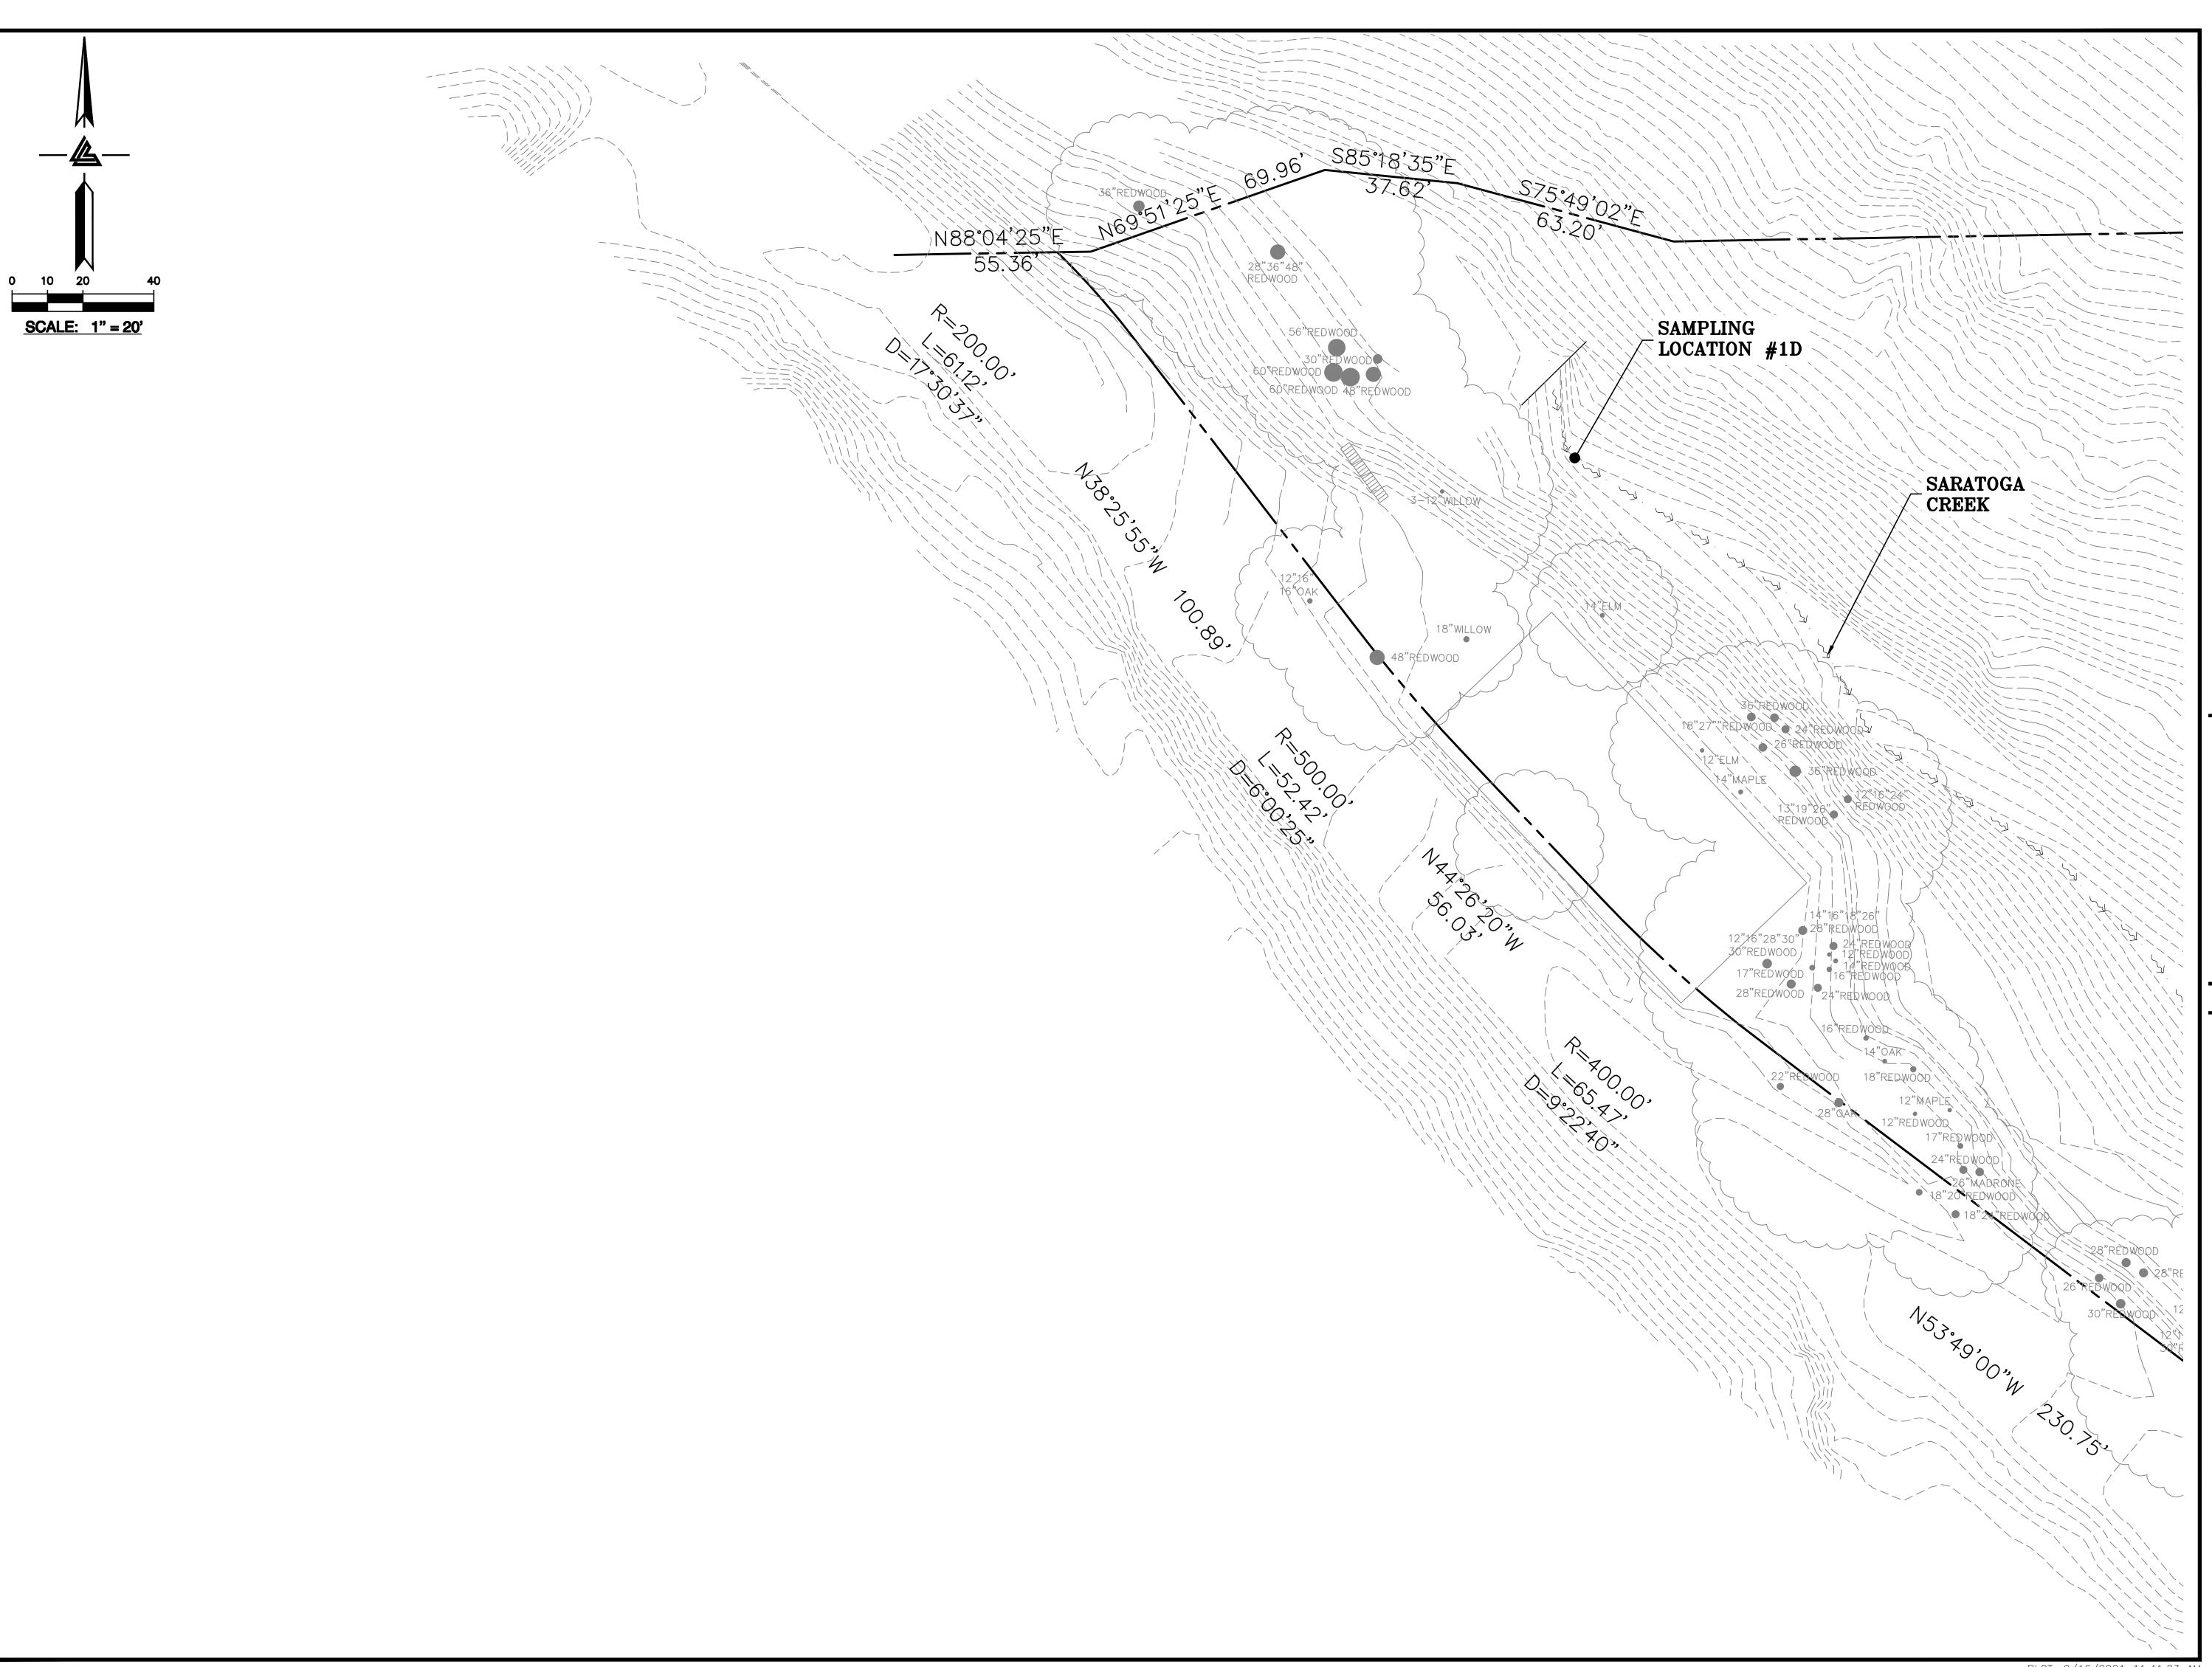

ELLISON CONSERVATION CENTER FOR WILDLIFE CARE SARATOGA, CA





ARCHITECTS KORTH SUNSERI HAGEY



ISSUES AND REVISIONS
DESCRIPTION

09-06-18 GRADING PERMIT PLAN CHECK 4 12-21-18 PERMIT RESUBMITTAL

03-26-19 PERMIT MODIFICATION
PLAN CHECK 1

04-11-19 ASA DELTA 2

04-22-19 BID SET

05-10-19 BID SET ADDENDUM 1

05-22-19 UTILITY PLAN CHECK 1

08-06-19 PHASE 4 - PERMIT
SUBMITTAL

09-20-19 CONSTRUCTION SET 1 01-28-20 PERMIT MODIFICATION 2 05-29-20 PLAN CHECK RESPONSE PERMIT MODIFICATION 2

07-22-20 UTILITY PLAN SUBMITTAL

SANTA CLARA COUNTY RECORD INFORMATION APPLICANT: PENINSULA HUMANE SOCIETY

ROAD: CONGRESS SPRINGS LDE FILE: 6943-17-17G GRADING PERMIT: DEV19-1838 UTILITY PERMIT: DEV19-0220

> PROJECT NUMBER 16011.00


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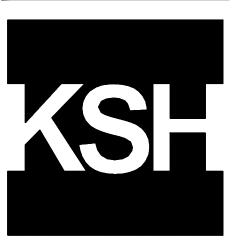
SHEET NUMBER

C-9.5



ELLISON CONSERVATION CENTER FOR WILDLIFE CARE



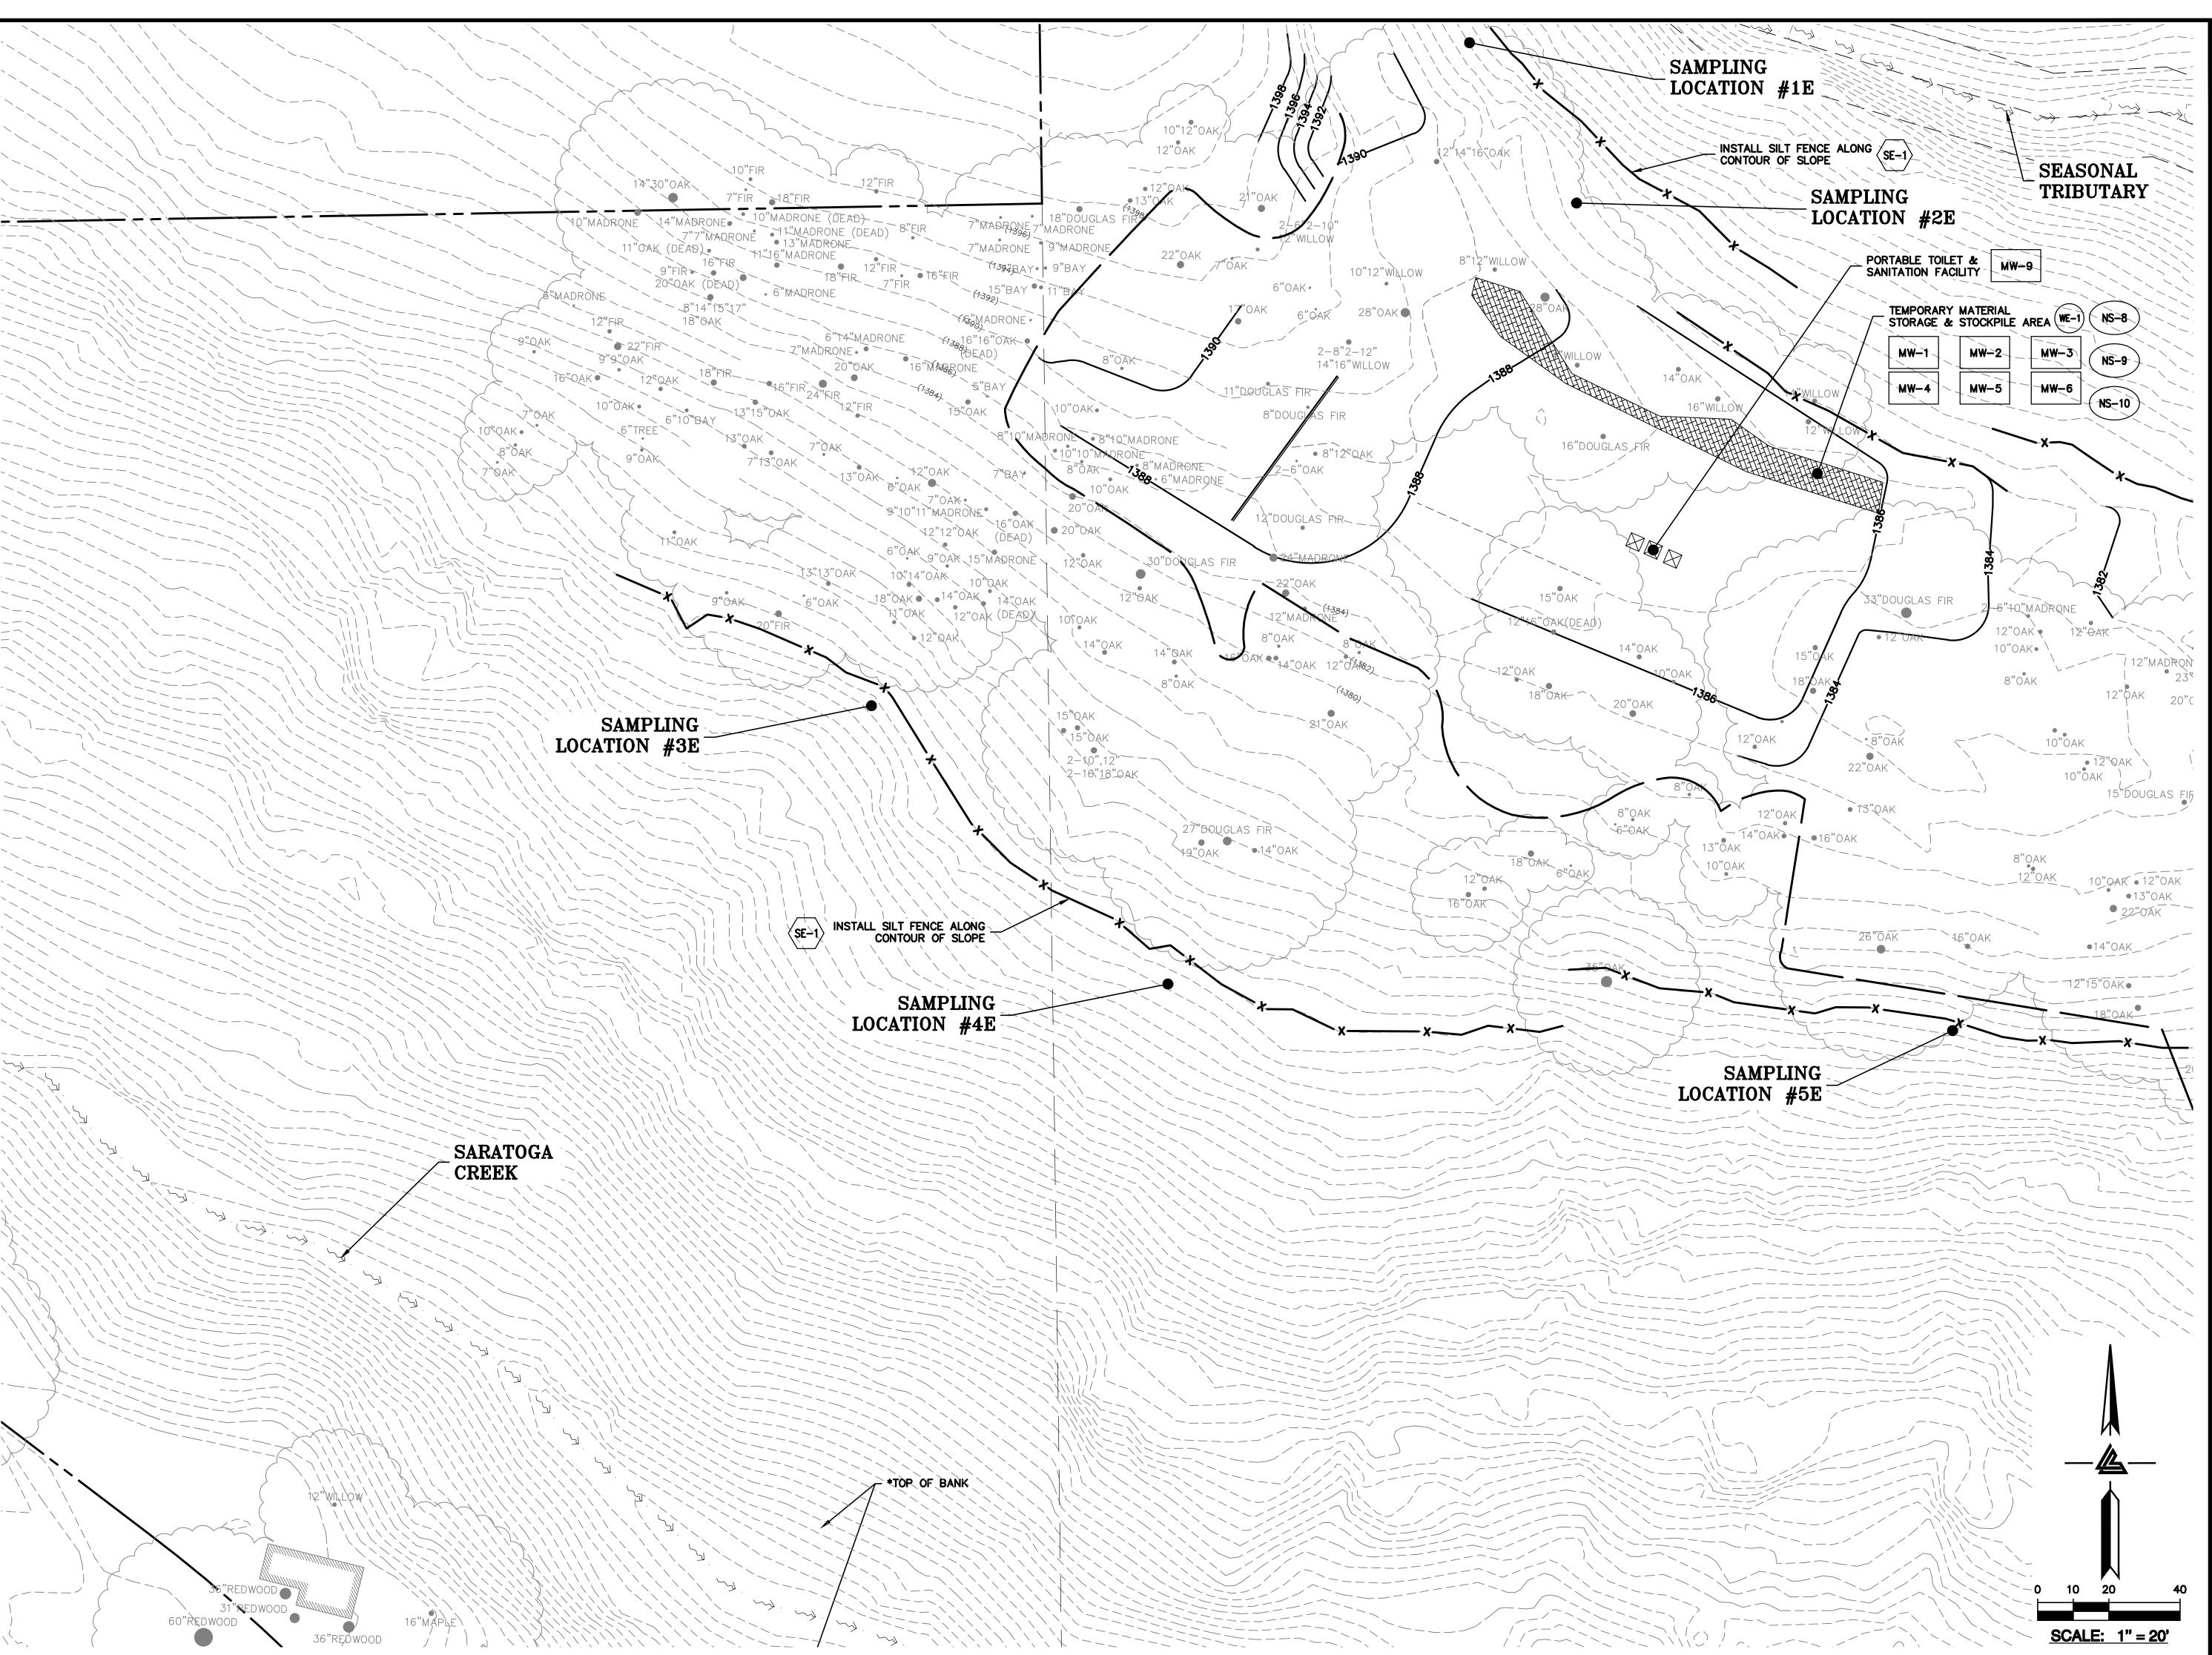

ARCHITECTS



ISSUES AND REVISIONS TE DESCRIPTION

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12-21-18 PERMIT RESUBMITTAL PERMIT MODIFICATION

03-26-19 PERMIT MODIFICATION PLAN CHECK 1 04-11-19 ASA DELTA 2 04-22-19 BID SET

05-10-19 BID SET ADDENDUM 1 05-22-19 UTILITY PLAN CHECK 1

08-06-19 PHASE 4 - PERMIT SUBMITTAL
09-20-19 CONSTRUCTION SET 1
01-28-20 PERMIT MODIFICATION 2

05-29-20 PLAN CHECK RESPONSE PERMIT MODIFICATION 2

07-22-20 UTILITY PLAN SUBMITTAL

SANTA CLARA COUNTY RECORD INFORMATION APPLICANT: PENINSULA HUMANE SOCIETY ROAD: CONGRESS SPRINGS LDE FILE: 6943-17-17G

GRADING PERMIT: DEV19-1838

UTILITY PERMIT: DEV19-0220

PROJECT NUMBER 16011.00

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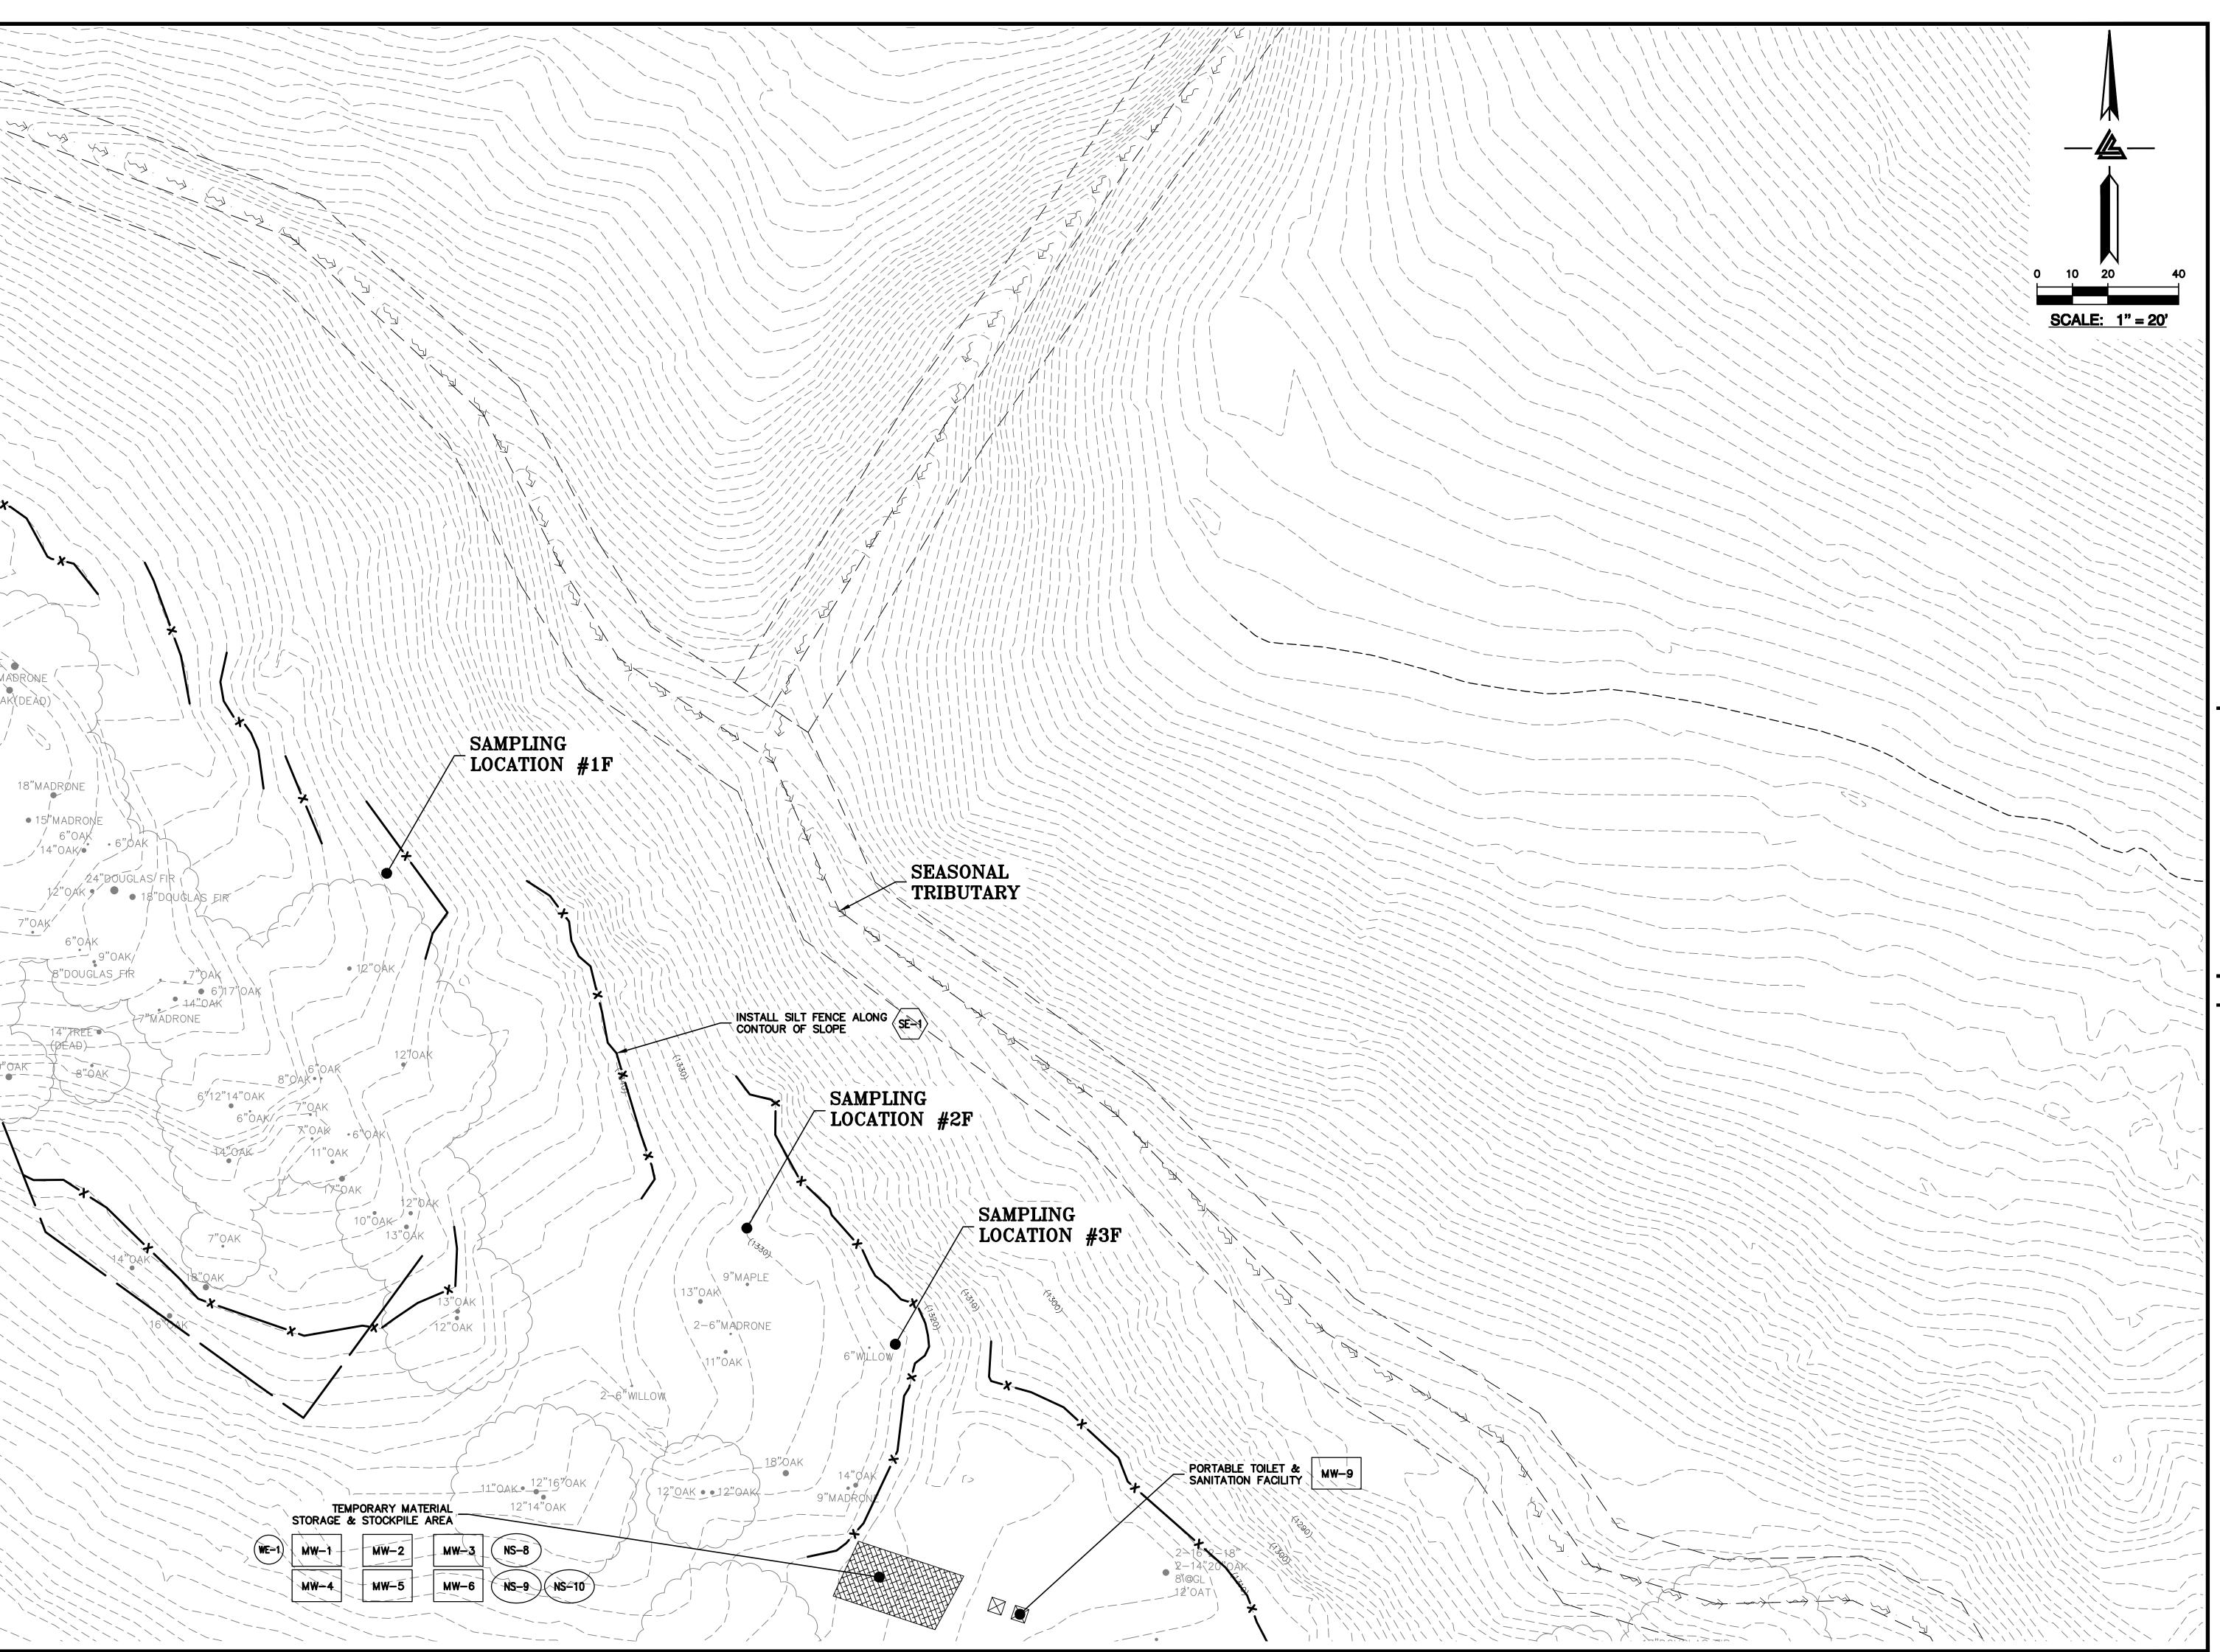
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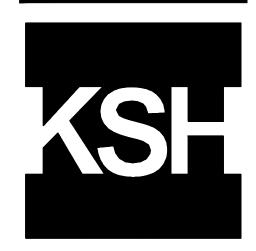
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hecked By PC / JL
3 Job No. 2130712

SHEET NUMBER

C-9.6







ARCHITECTS KORTH SUNSERI HAGEY

12-21-18 PERMIT RESUBMITTAL

05-22-19 UTILITY PLAN CHECK 1 08-06-19 PHASE 4 - PERMIT SUBMITTAL

09-20-19 CONSTRUCTION SET 1 01-28-20 PERMIT MODIFICATION 2 05-29-20 PLAN CHECK RESPONSE PERMIT MODIFICATION 2

07-22-20 UTILITY PLAN SUBMITTAL

SANTA CLARA COUNTY RECORD INFORMATION APPLICANT: PENINSULA HUMANE SOCIETY ROAD: CONGRESS SPRINGS

LDE FILE: 6943-17-17G GRADING PERMIT: DEV19-1838 UTILITY PERMIT: DEV19-0220

PROJECT NUMBER 16011.00


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PC / JL 2130712


SHEET NUMBER

C-9.7



ELLISON CONSERVATION CENTER FOR WILDLIFE CARE SARATOGA, CA

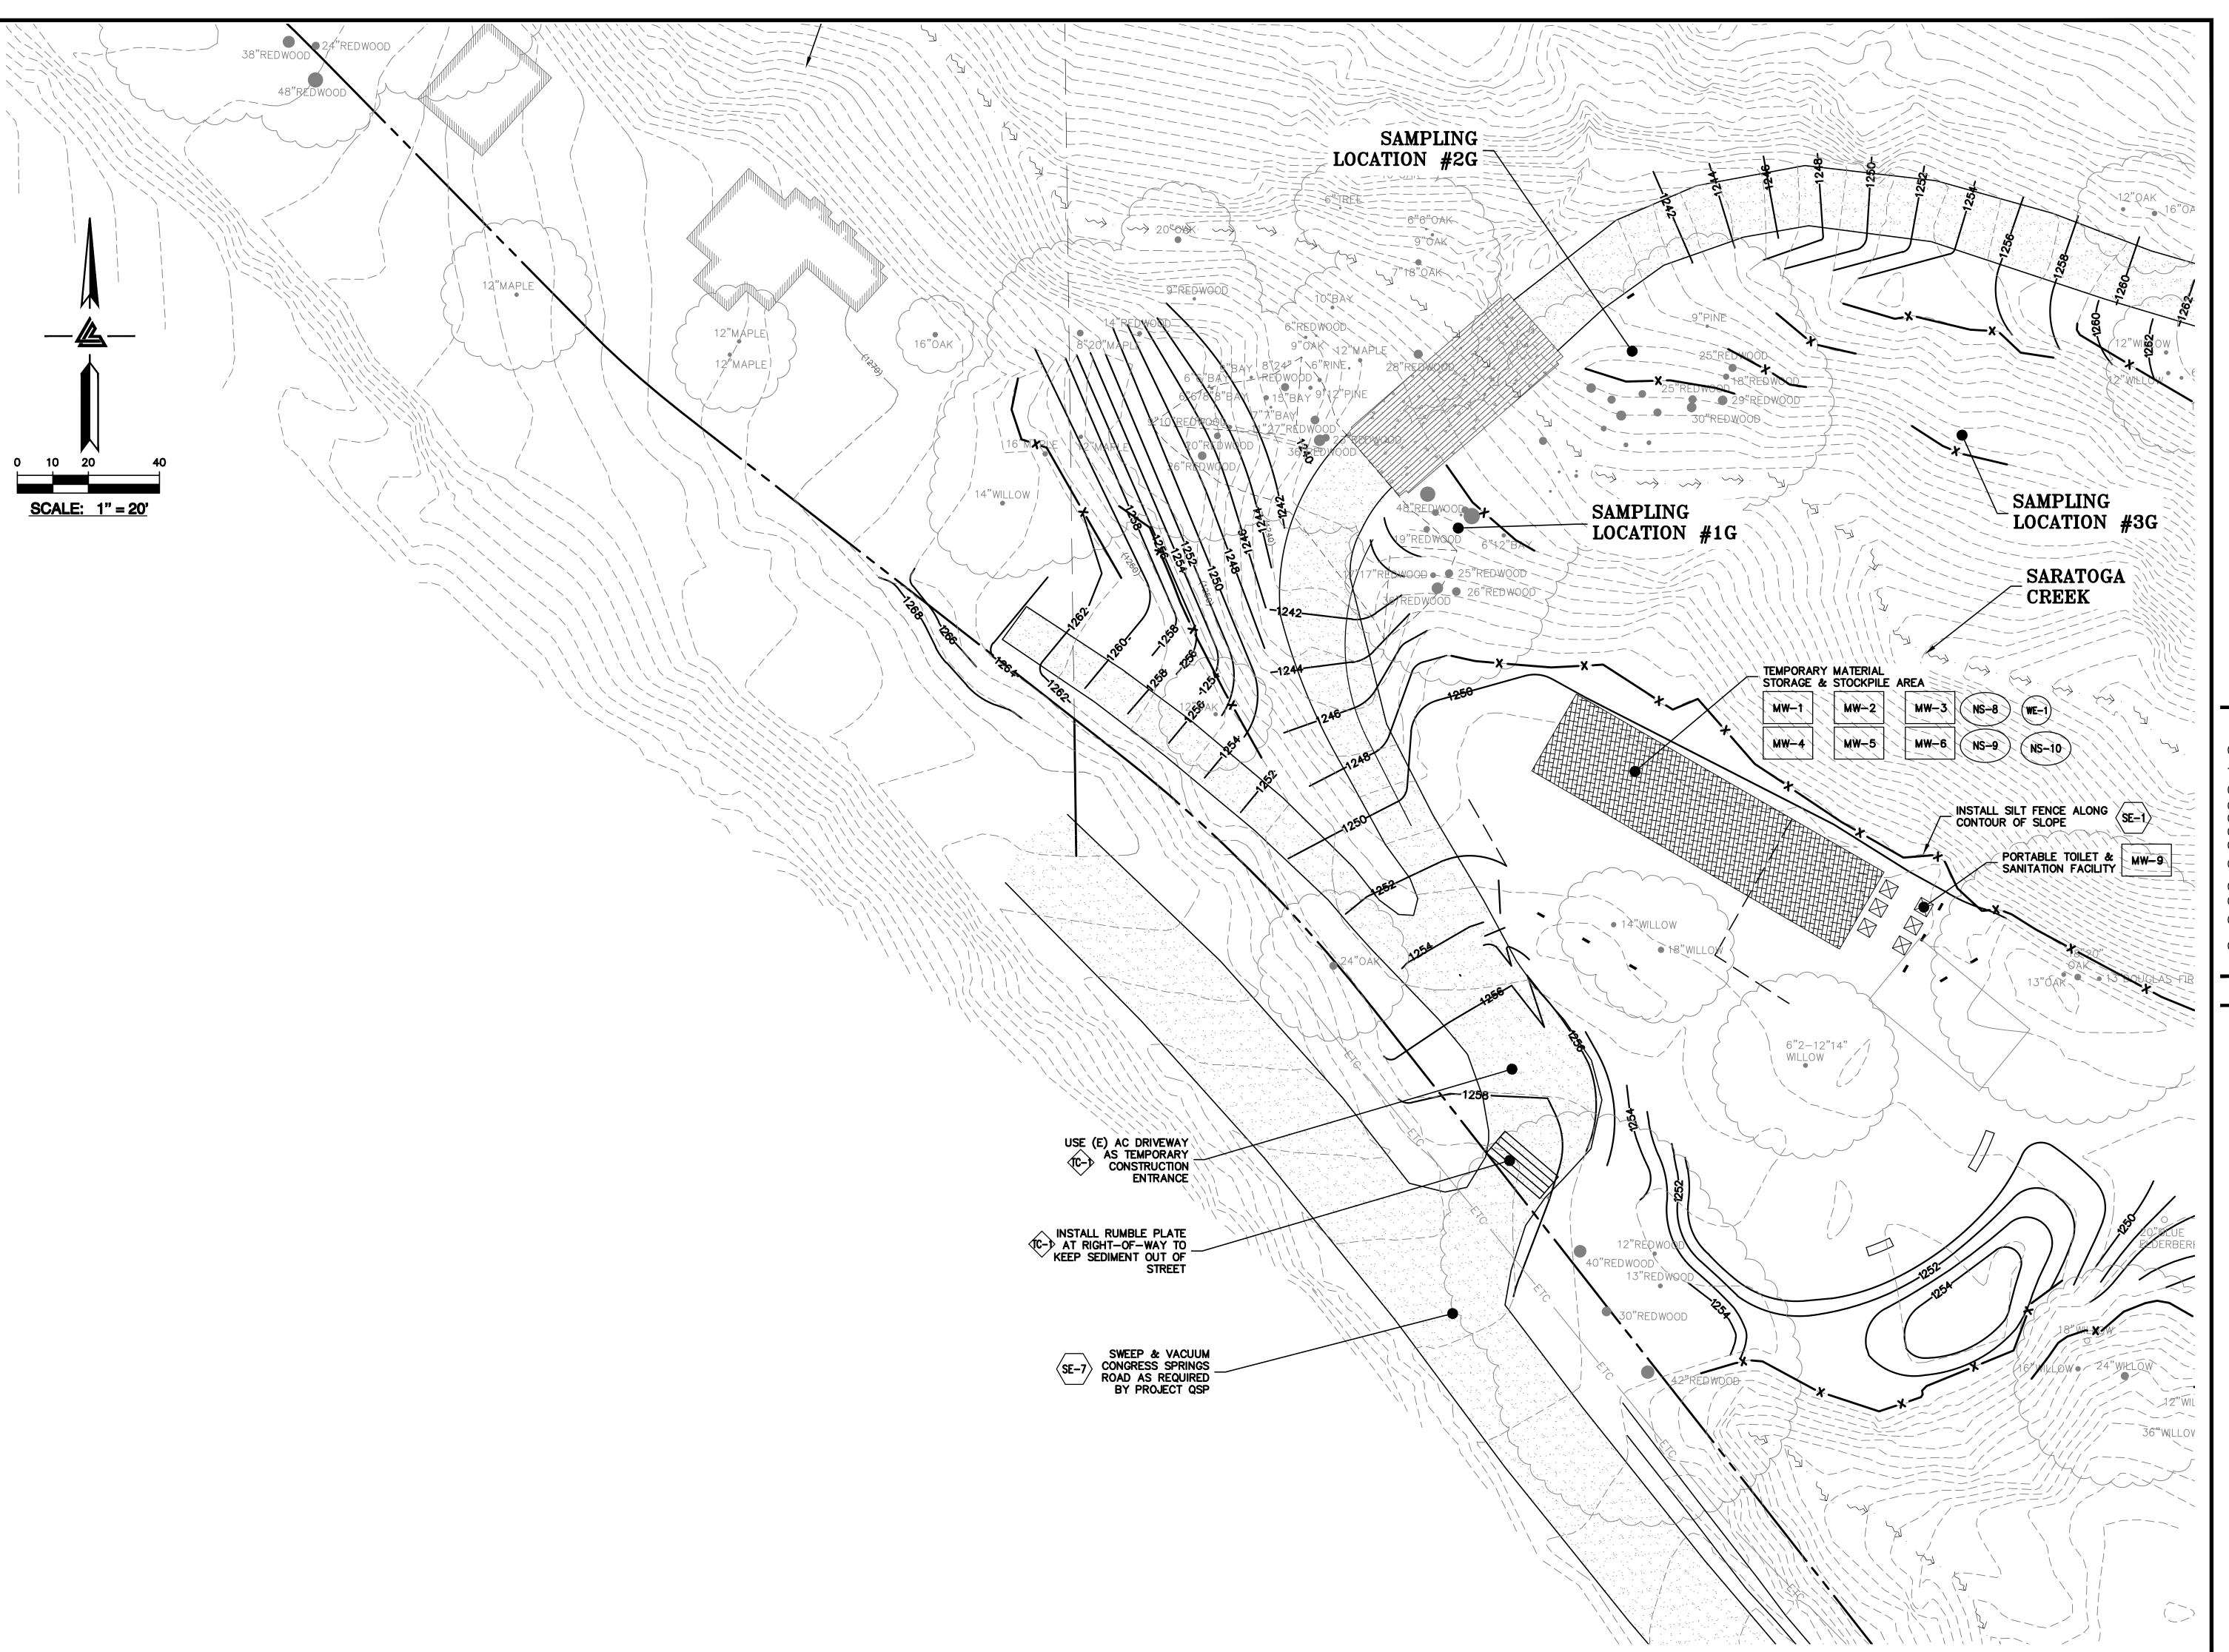

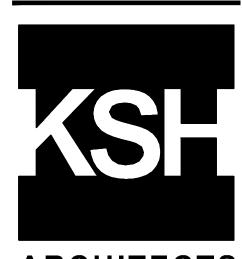

ARCHITECTS KORTH SUNSERI HAGEY



ISSUES AND REVISIONS

09-06-18 GRADING PERMIT PLAN CHECK 4

12-21-18 PERMIT RESUBMITTAL
03-26-19 PERMIT MODIFICATION
PLAN CHECK 1
04-11-19 ASA DELTA 2
04-22-19 BID SET

05-10-19 BID SET ADDENDUM 1 05-22-19 UTILITY PLAN CHECK 1 08-06-19 PHASE 4 - PERMIT SUBMITTAL

09-20-19 CONSTRUCTION SET 1 01-28-20 PERMIT MODIFICATION 2 05-29-20 PLAN CHECK RESPONSE PERMIT MODIFICATION 2

07-22-20 UTILITY PLAN SUBMITTAL

SANTA CLARA COUNTY RECORD INFORMATION APPLICANT: PENINSULA HUMANE SOCIETY

ROAD: CONGRESS SPRINGS LDE FILE: 6943-17-17G GRADING PERMIT: DEV19-1838 UTILITY PERMIT: DEV19-0220

> PROJECT NUMBER 16011.00


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& STAGING SCALE

1" = 20' PC / CA PC / JL 2130712 LB Job No.

SHEET NUMBER

C-9.8



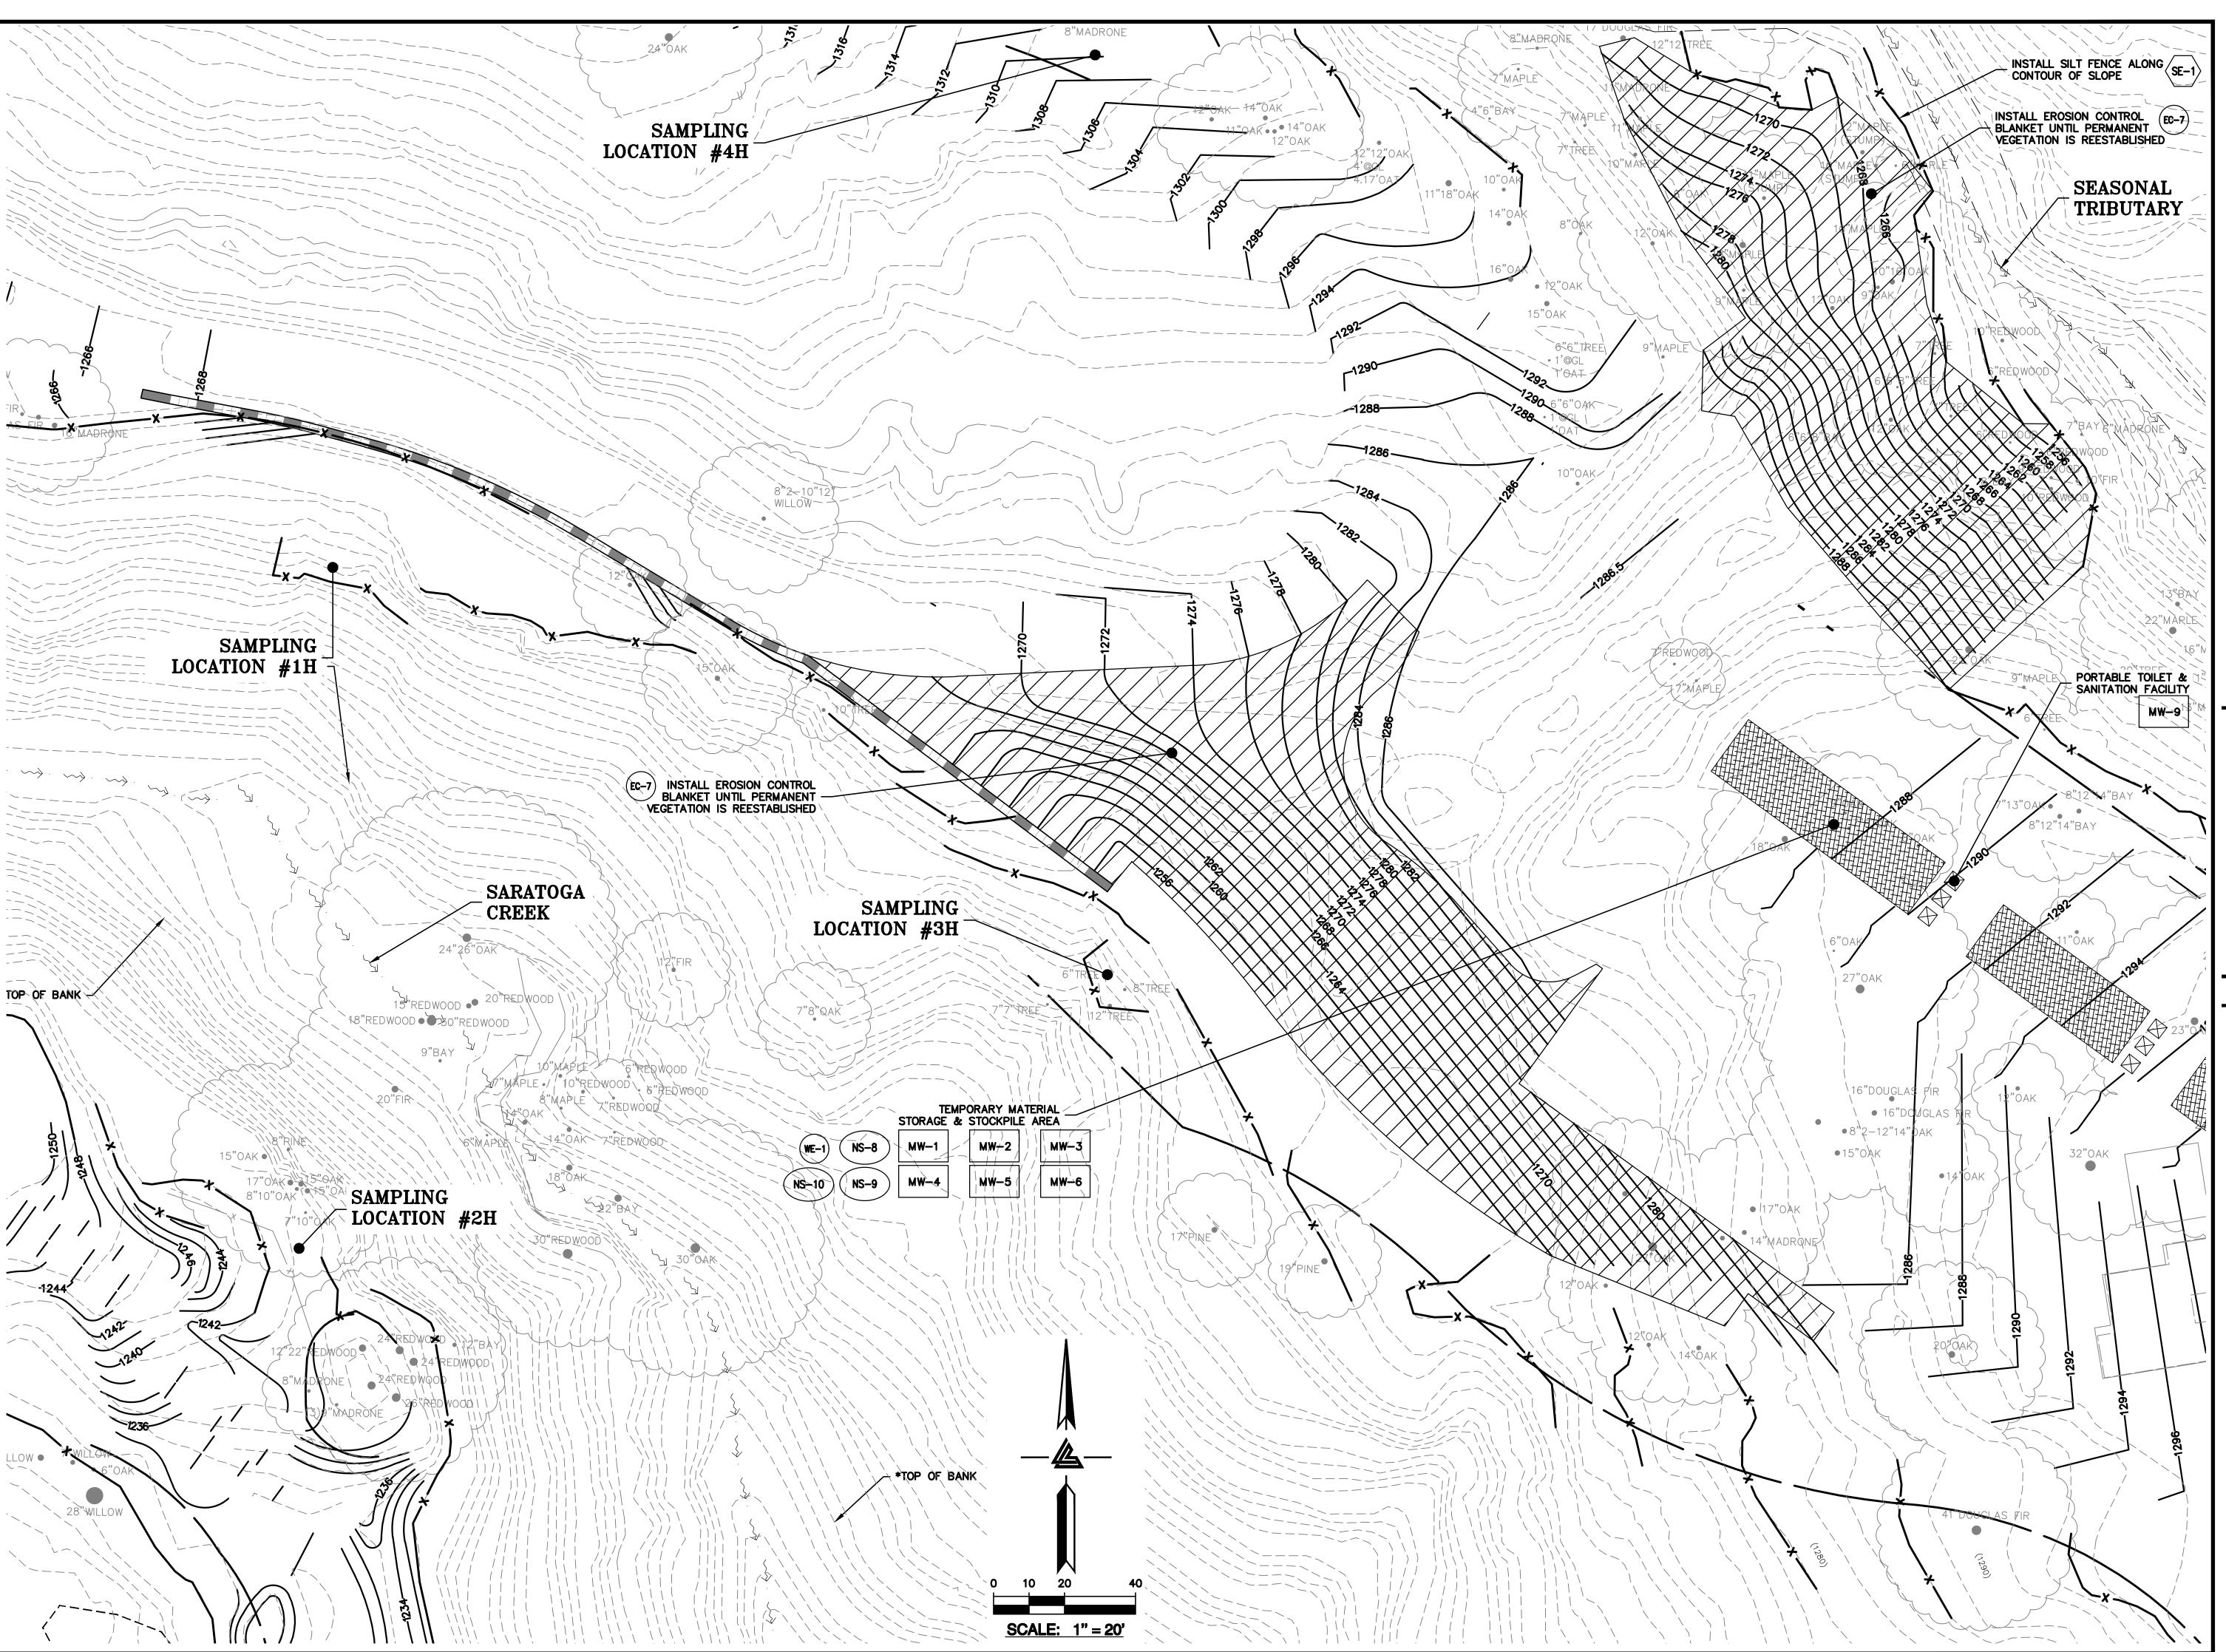



ARCHITECTS KORTH SUNSERI HAGEY



ISSUES AND REVISIONS

09-06-18 GRADING PERMIT PLAN CHECK 4

12-21-18 PERMIT RESUBMITTAL 03-26-19 PERMIT MODIFICATION PLAN CHECK 1 04-11-19 ASA DELTA 2 04-22-19 BID SET

05-22-19 UTILITY PLAN CHECK 1

09-20-19 CONSTRUCTION SET 1 01-28-20 PERMIT MODIFICATION 2

05-29-20 PLAN CHECK RESPONSE PERMIT MODIFICATION 2

07-22-20 UTILITY PLAN SUBMITTAL

SANTA CLARA COUNTY RECORD INFORMATION APPLICANT: PENINSULA HUMANE SOCIETY ROAD: CONGRESS SPRINGS

LDE FILE: 6943-17-17G GRADING PERMIT: DEV19-1838 UTILITY PERMIT: DEV19-0220

> PROJECT NUMBER 16011.00

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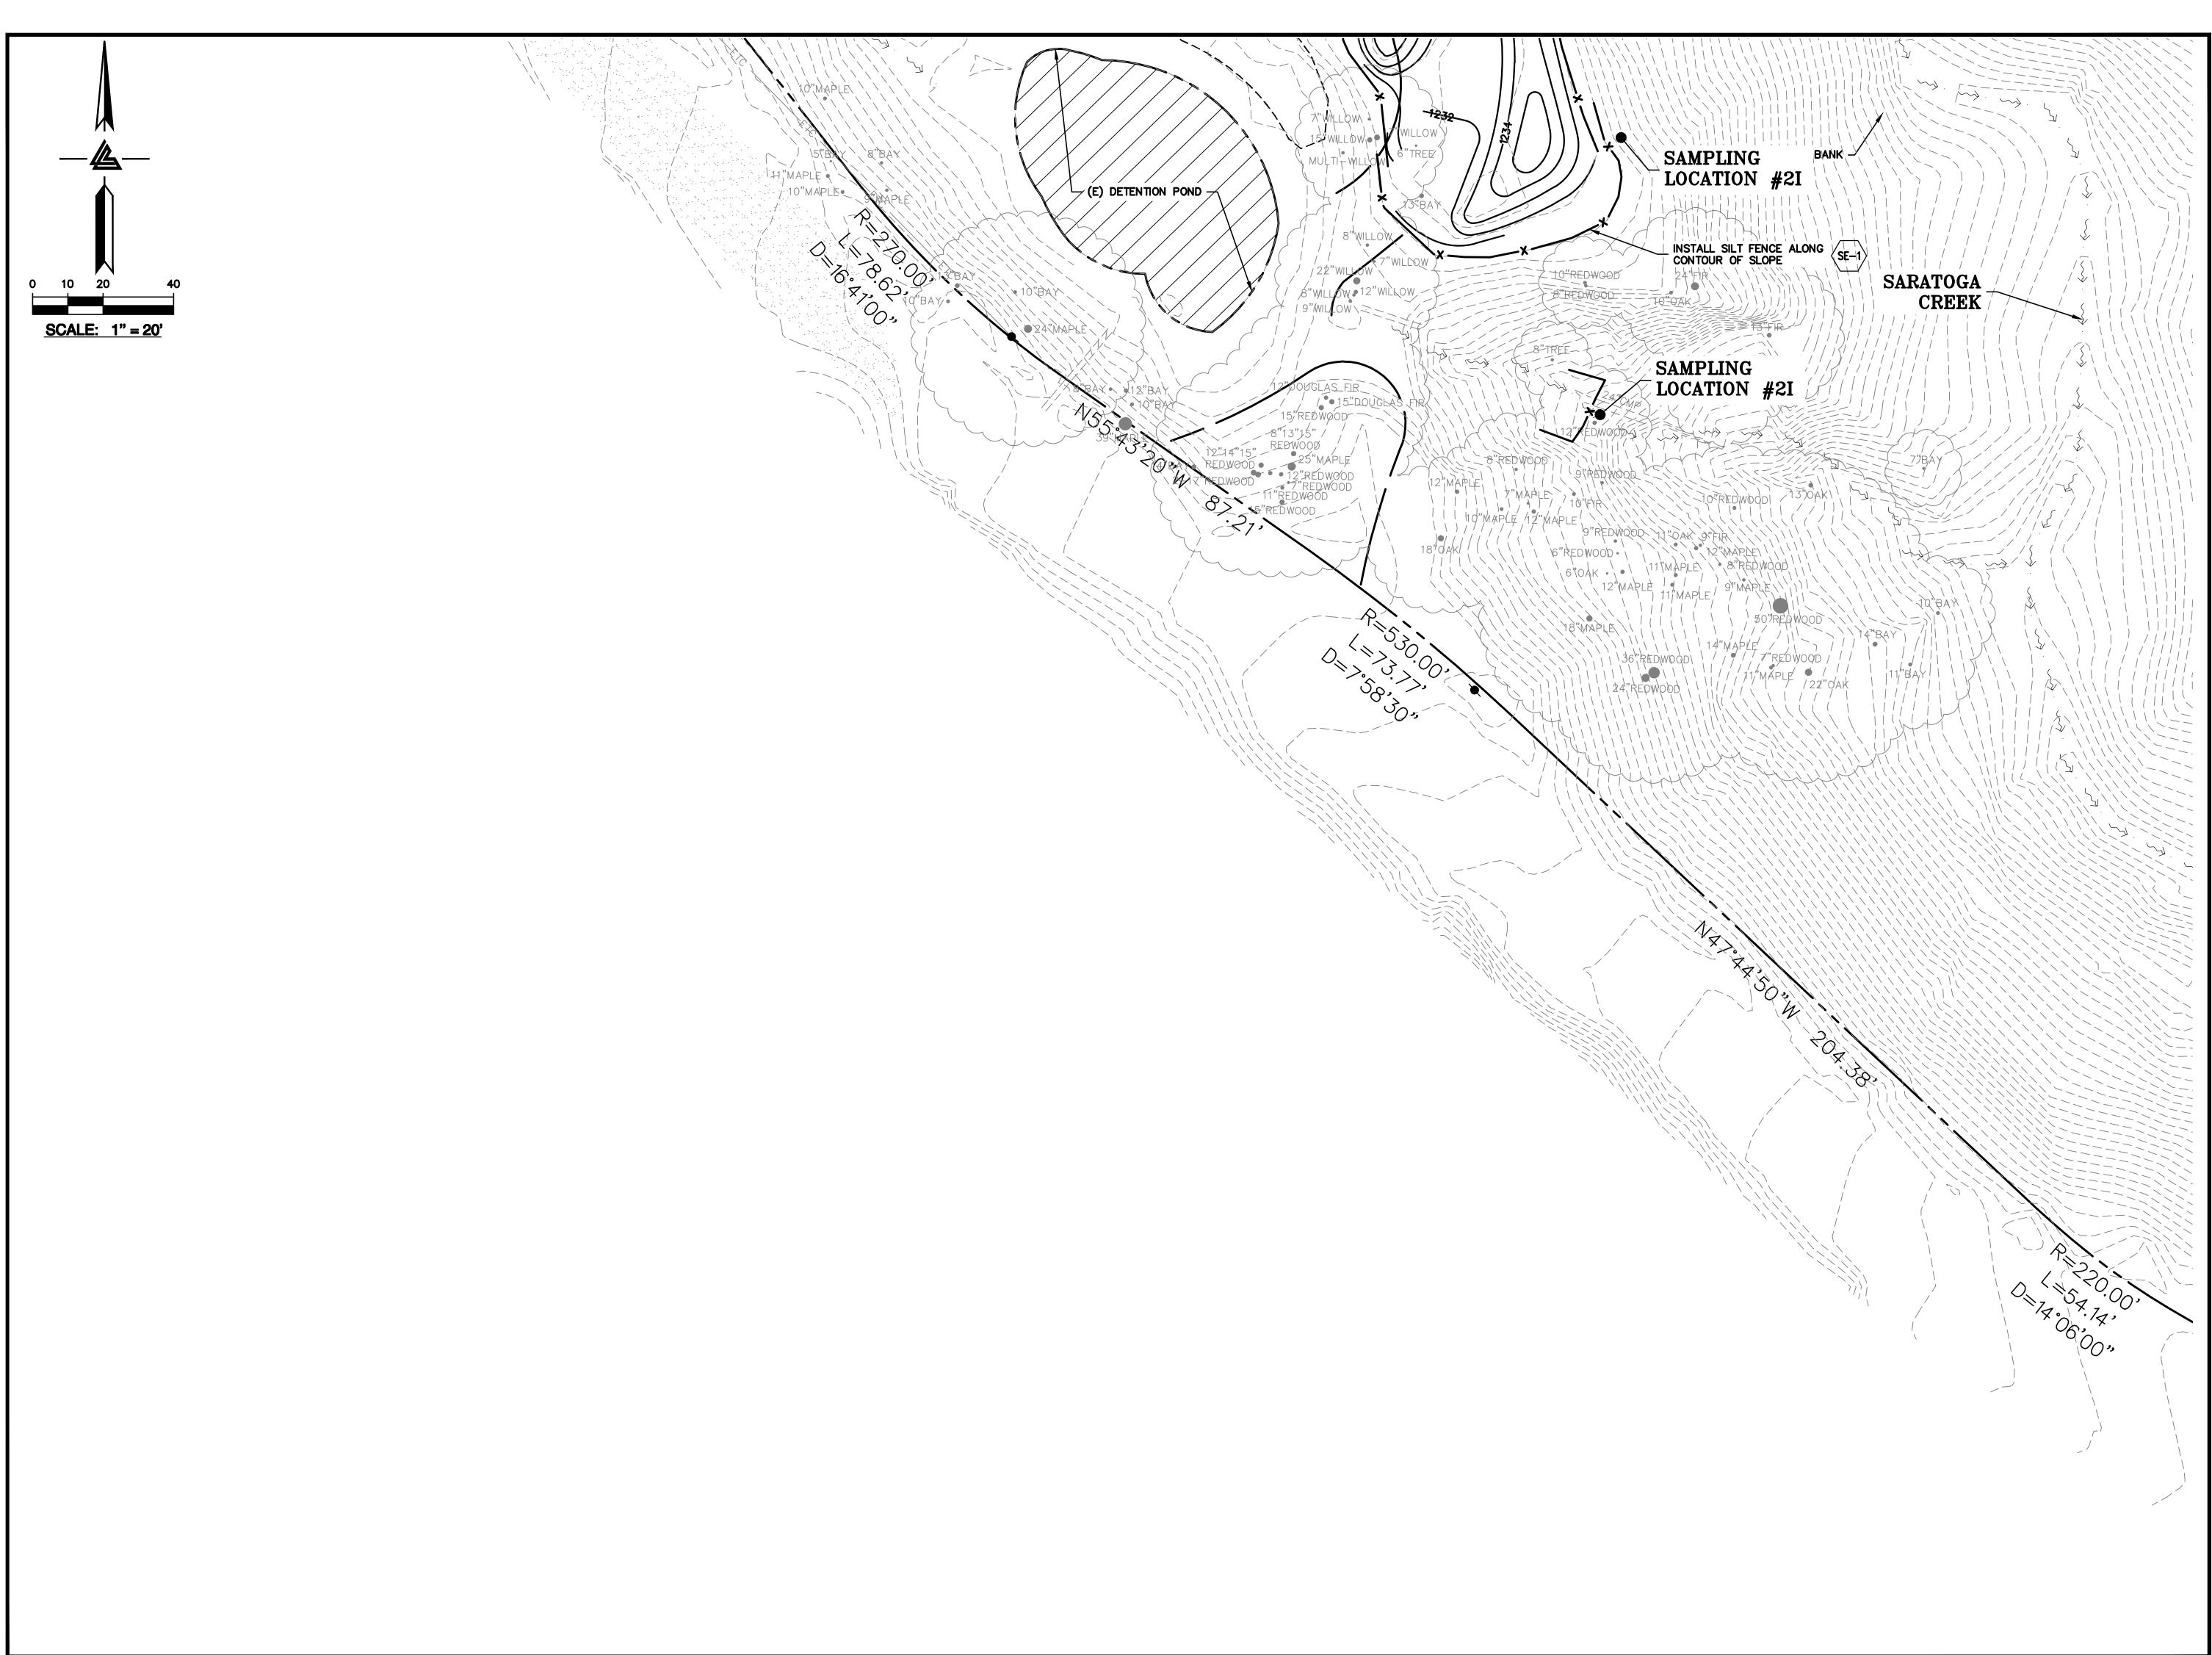
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PC / JL 2130712


SHEET NUMBER

C-9.9



ELLISON CONSERVATION CENTER FOR WILDLIFE CARE



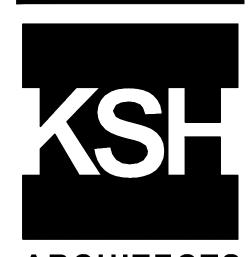

ARCHITECTS KORTH SUNSERI HAGEY



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12-21-18 PERMIT RESUBMITTAL 03-26-19 PERMIT MODIFICATION PLAN CHECK 1 04-11-19 ASA DELTA 2 04-22-19 BID SET

05-10-19 BID SET ADDENDUM 1 05-22-19 UTILITY PLAN CHECK 1 08-06-19 PHASE 4 - PERMIT SUBMITTAL

09-20-19 CONSTRUCTION SET 1 01-28-20 PERMIT MODIFICATION 2

05-29-20 PLAN CHECK RESPONSE PERMIT MODIFICATION 2

07-22-20 UTILITY PLAN SUBMITTAL

SANTA CLARA COUNTY RECORD INFORMATION APPLICANT: PENINSULA HUMANE SOCIETY ROAD: CONGRESS SPRINGS

LDE FILE: 6943-17-17G GRADING PERMIT: DEV19-1838 UTILITY PERMIT: DEV19-0220

> PROJECT NUMBER 16011.00

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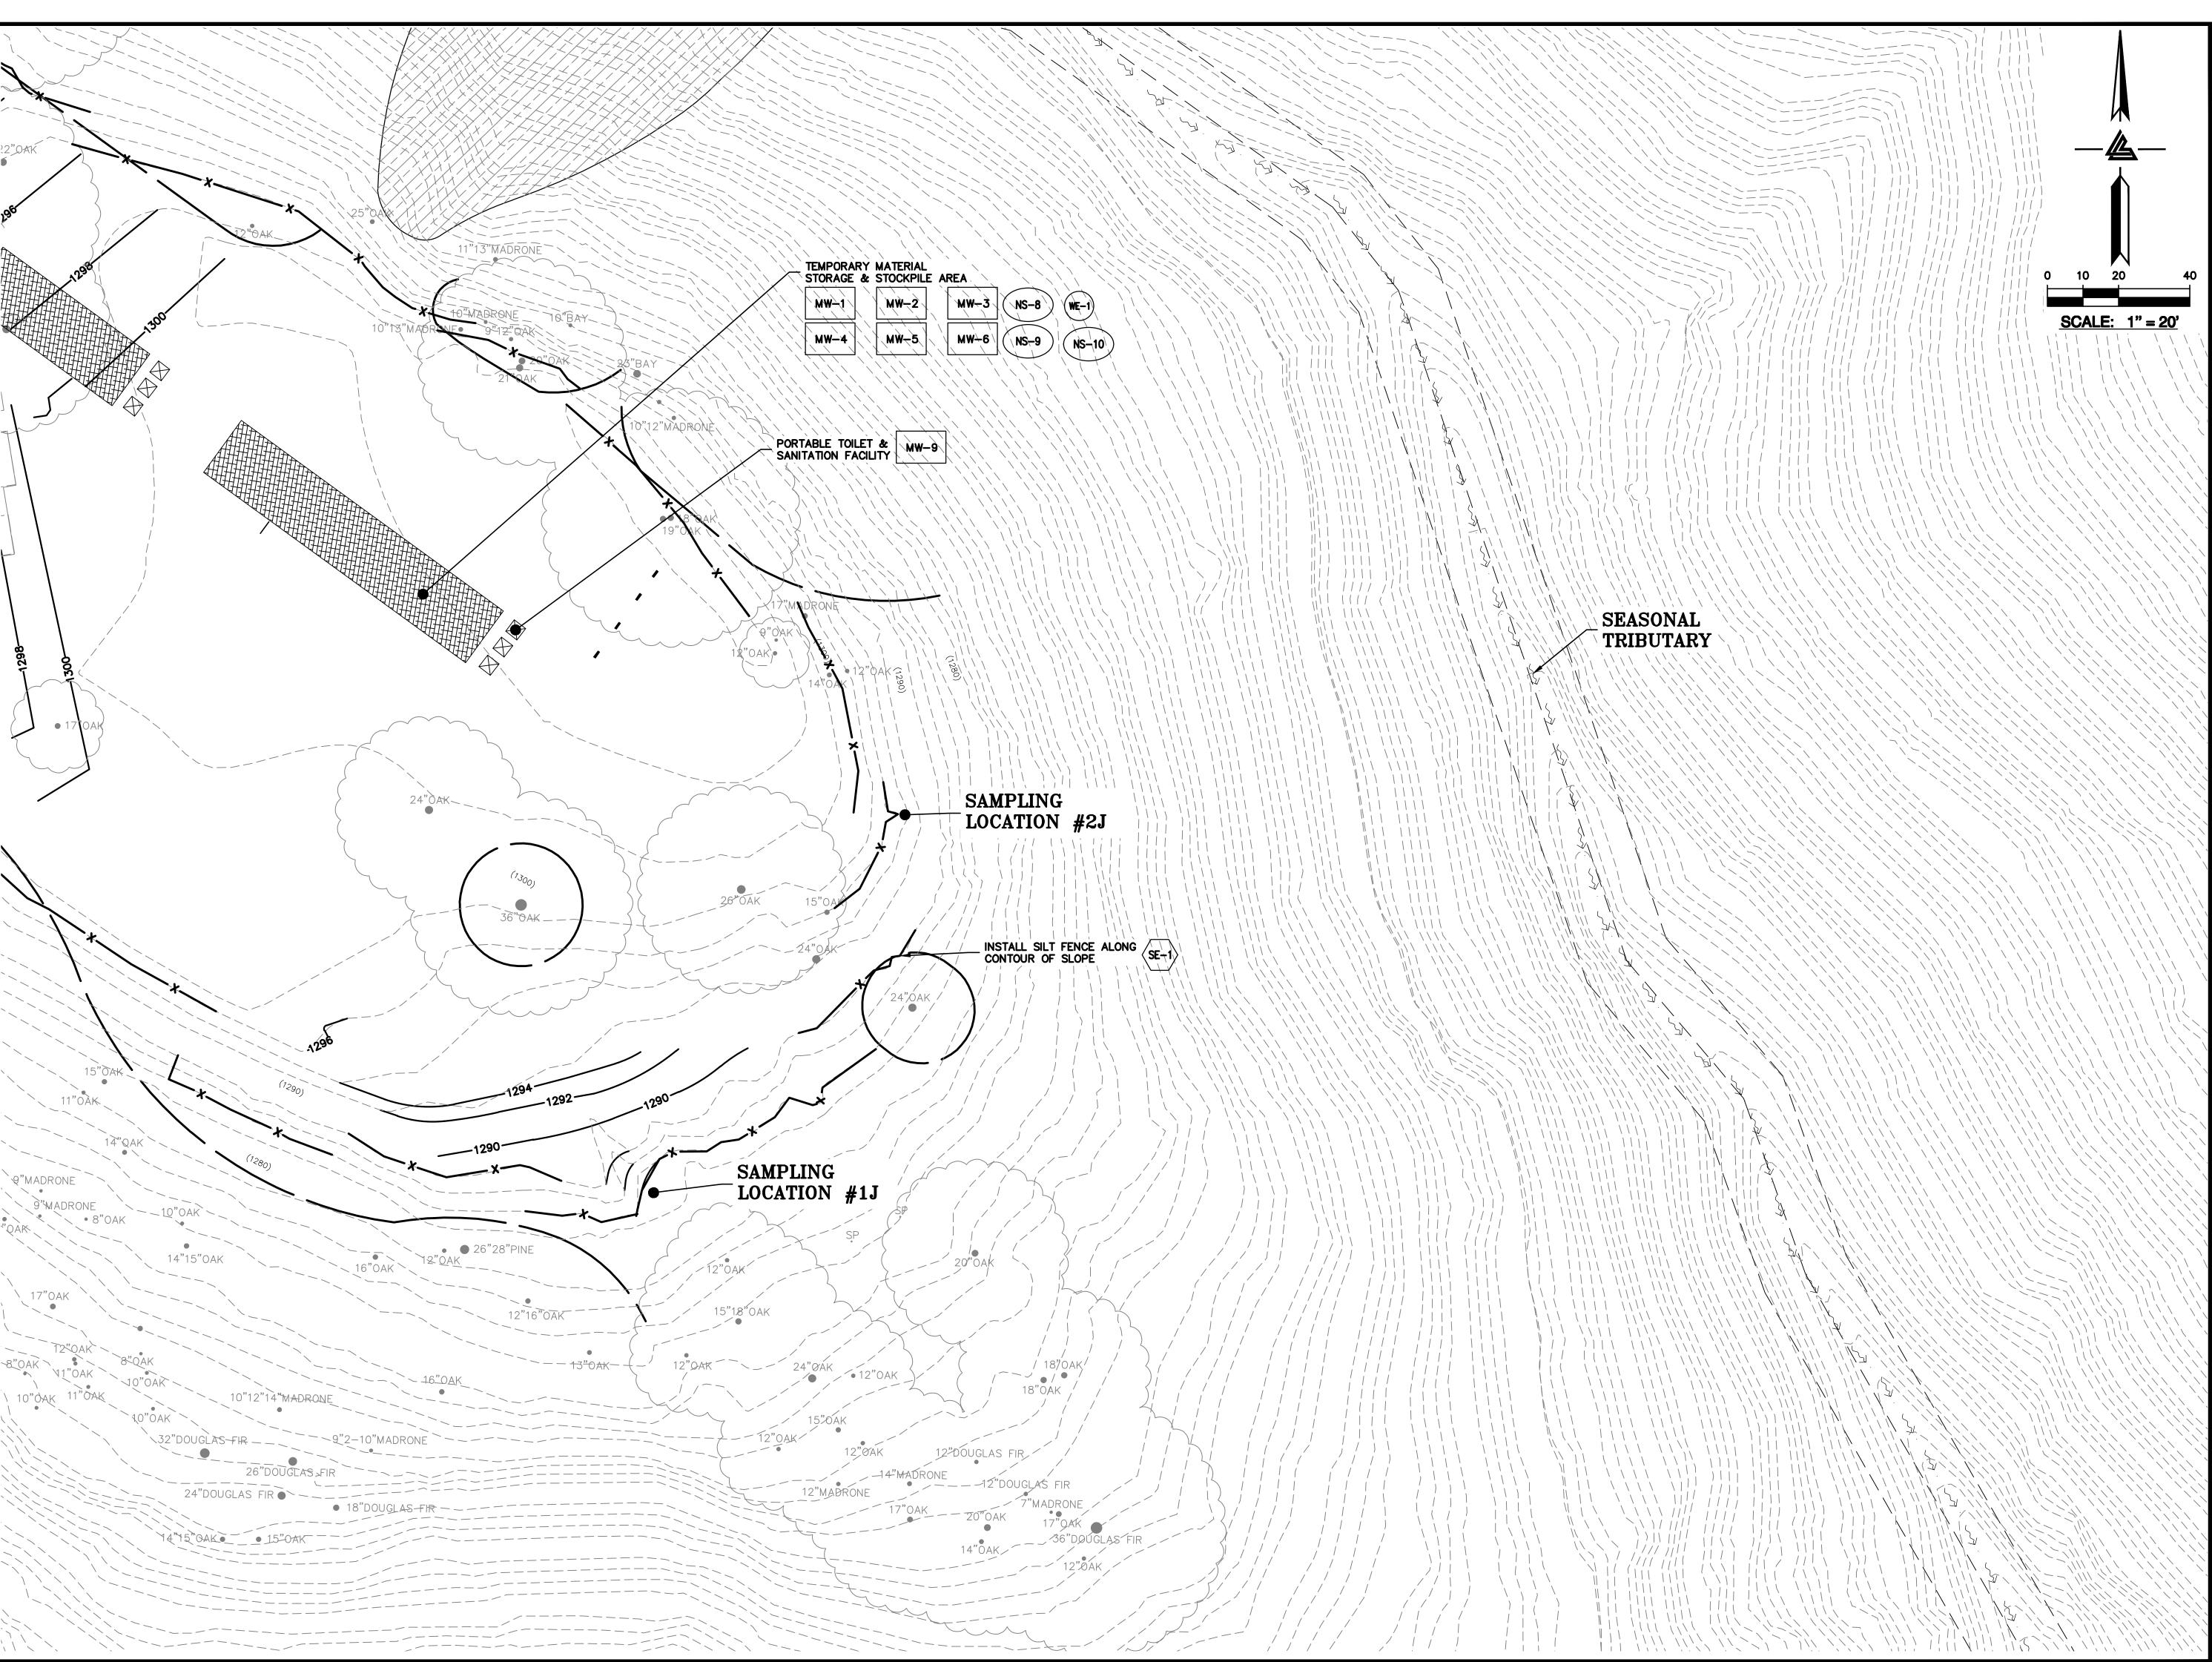
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Checked By 2130712


SHEET NUMBER

C-9.10



ELLISON CONSERVATION CENTER FOR WILDLIFE CARE



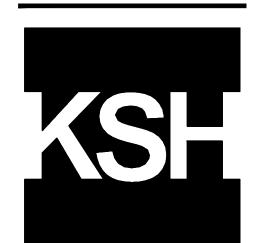

ARCHITECTS KORTH SUNSERI HAGEY

CIVIL ENGINEERS - LAND SURVEYORS
BAY AREA REGION
2495 INDUSTRIAL PKWY WEST
3017 DOUGLAS BLYD, # 300
HAYWARD, CALIFORNIA 94545 ROSEVILLE, CA 95661
(P) (510) 887-4086
(P) (916)797-7363
(F) (510) WWW.LEABRAZE.COM

ISSUES AND REVISIONS
DATE DESCRIPTION

GRADING PE

9-06-18 GRADING PERMIT PLAN CHECK 4

12-21-18 PERMIT RESUBMITTAL
03-26-19 PERMIT MODIFICATION
PLAN CHECK 1

03-26-19 PLAN CHECK 1 04-11-19 ASA DELTA 2 04-22-19 BID SET

05-10-19 BID SET ADDENDUM 1 05-22-19 UTILITY PLAN CHECK 1

08-06-19 PHASE 4 - PERMIT SUBMITTAL

09-20-19 CONSTRUCTION SET 1

01-28-20 PERMIT MODIFICATION 2

05-29-20 PLAN CHECK RESPONSE PERMIT MODIFICATION 2

07-22-20 UTILITY PLAN SUBMITTAL

SANTA CLARA COUNTY RECORD INFORMATION APPLICANT: PENINSULA HUMANE SOCIETY

ROAD: CONGRESS SPRINGS LDE FILE: 6943-17-17G GRADING PERMIT: DEV19-1838

UTILITY PERMIT: DEV19-0220

PROJECT NUMBER 16011.00

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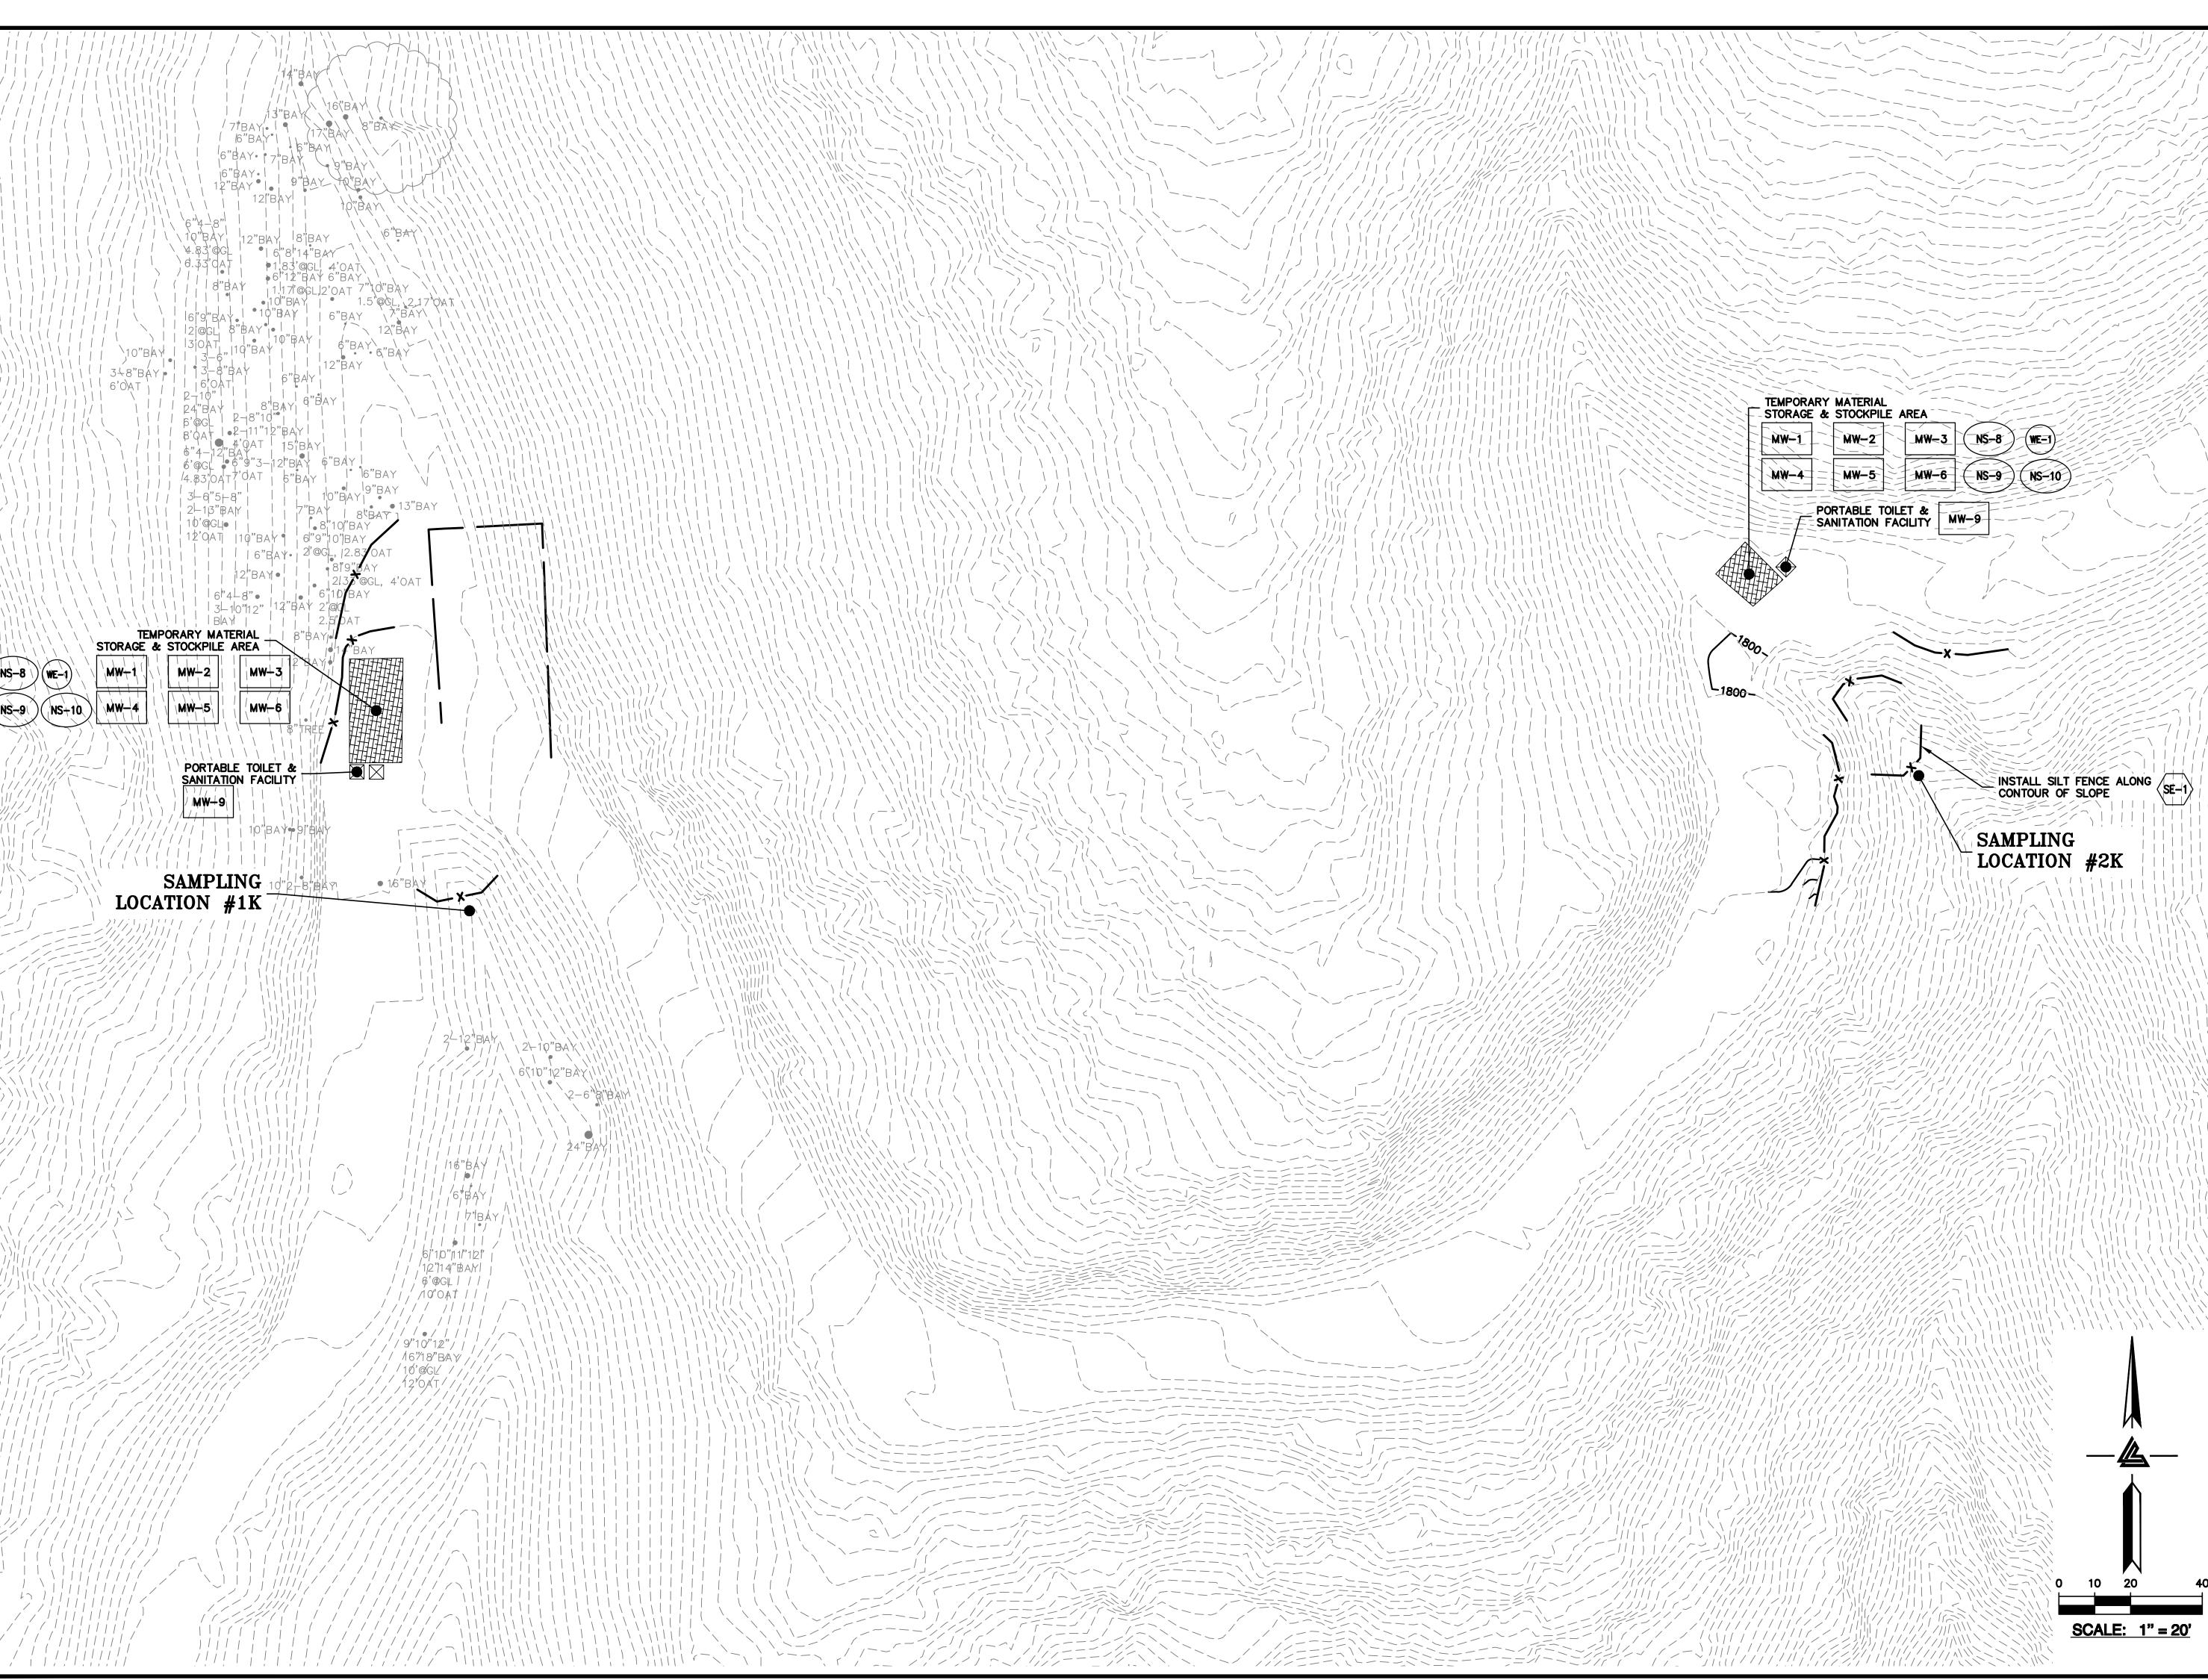
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SCALE 1" = 20'

Designed By PC / CA
Checked By PC / JL
LB Job No. 2130712

SHEET NUMBER

C-9.11







ARCHITECTS KORTH SUNSERI HAGEY



ISSUES AND REVISIONS

09-06-18 GRADING PERMIT PLAN CHECK 4

12-21-18 PERMIT RESUBMITTAL 03-26-19 PERMIT MODIFICATION PLAN CHECK 1 04-11-19 ASA DELTA 2

04-22-19 BID SET

05-22-19 UTILITY PLAN CHECK 1 08-06-19 PHASE 4 - PERMIT SUBMITTAL

09-20-19 CONSTRUCTION SET 1

01-28-20 PERMIT MODIFICATION 2

05-29-20 PLAN CHECK RESPONSE PERMIT MODIFICATION 2

07-22-20 UTILITY PLAN SUBMITTAL

SANTA CLARA COUNTY RECORD INFORMATION APPLICANT: PENINSULA HUMANE SOCIETY ROAD: CONGRESS SPRINGS

LDE FILE: 6943-17-17G GRADING PERMIT: DEV19-1838 UTILITY PERMIT: DEV19-0220

PROJECT NUMBER


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DEMOLITION, GRADING

1" = 20'PC / CA PC / JL 2130712

& STAGING

SHEET NUMBER C-9.12

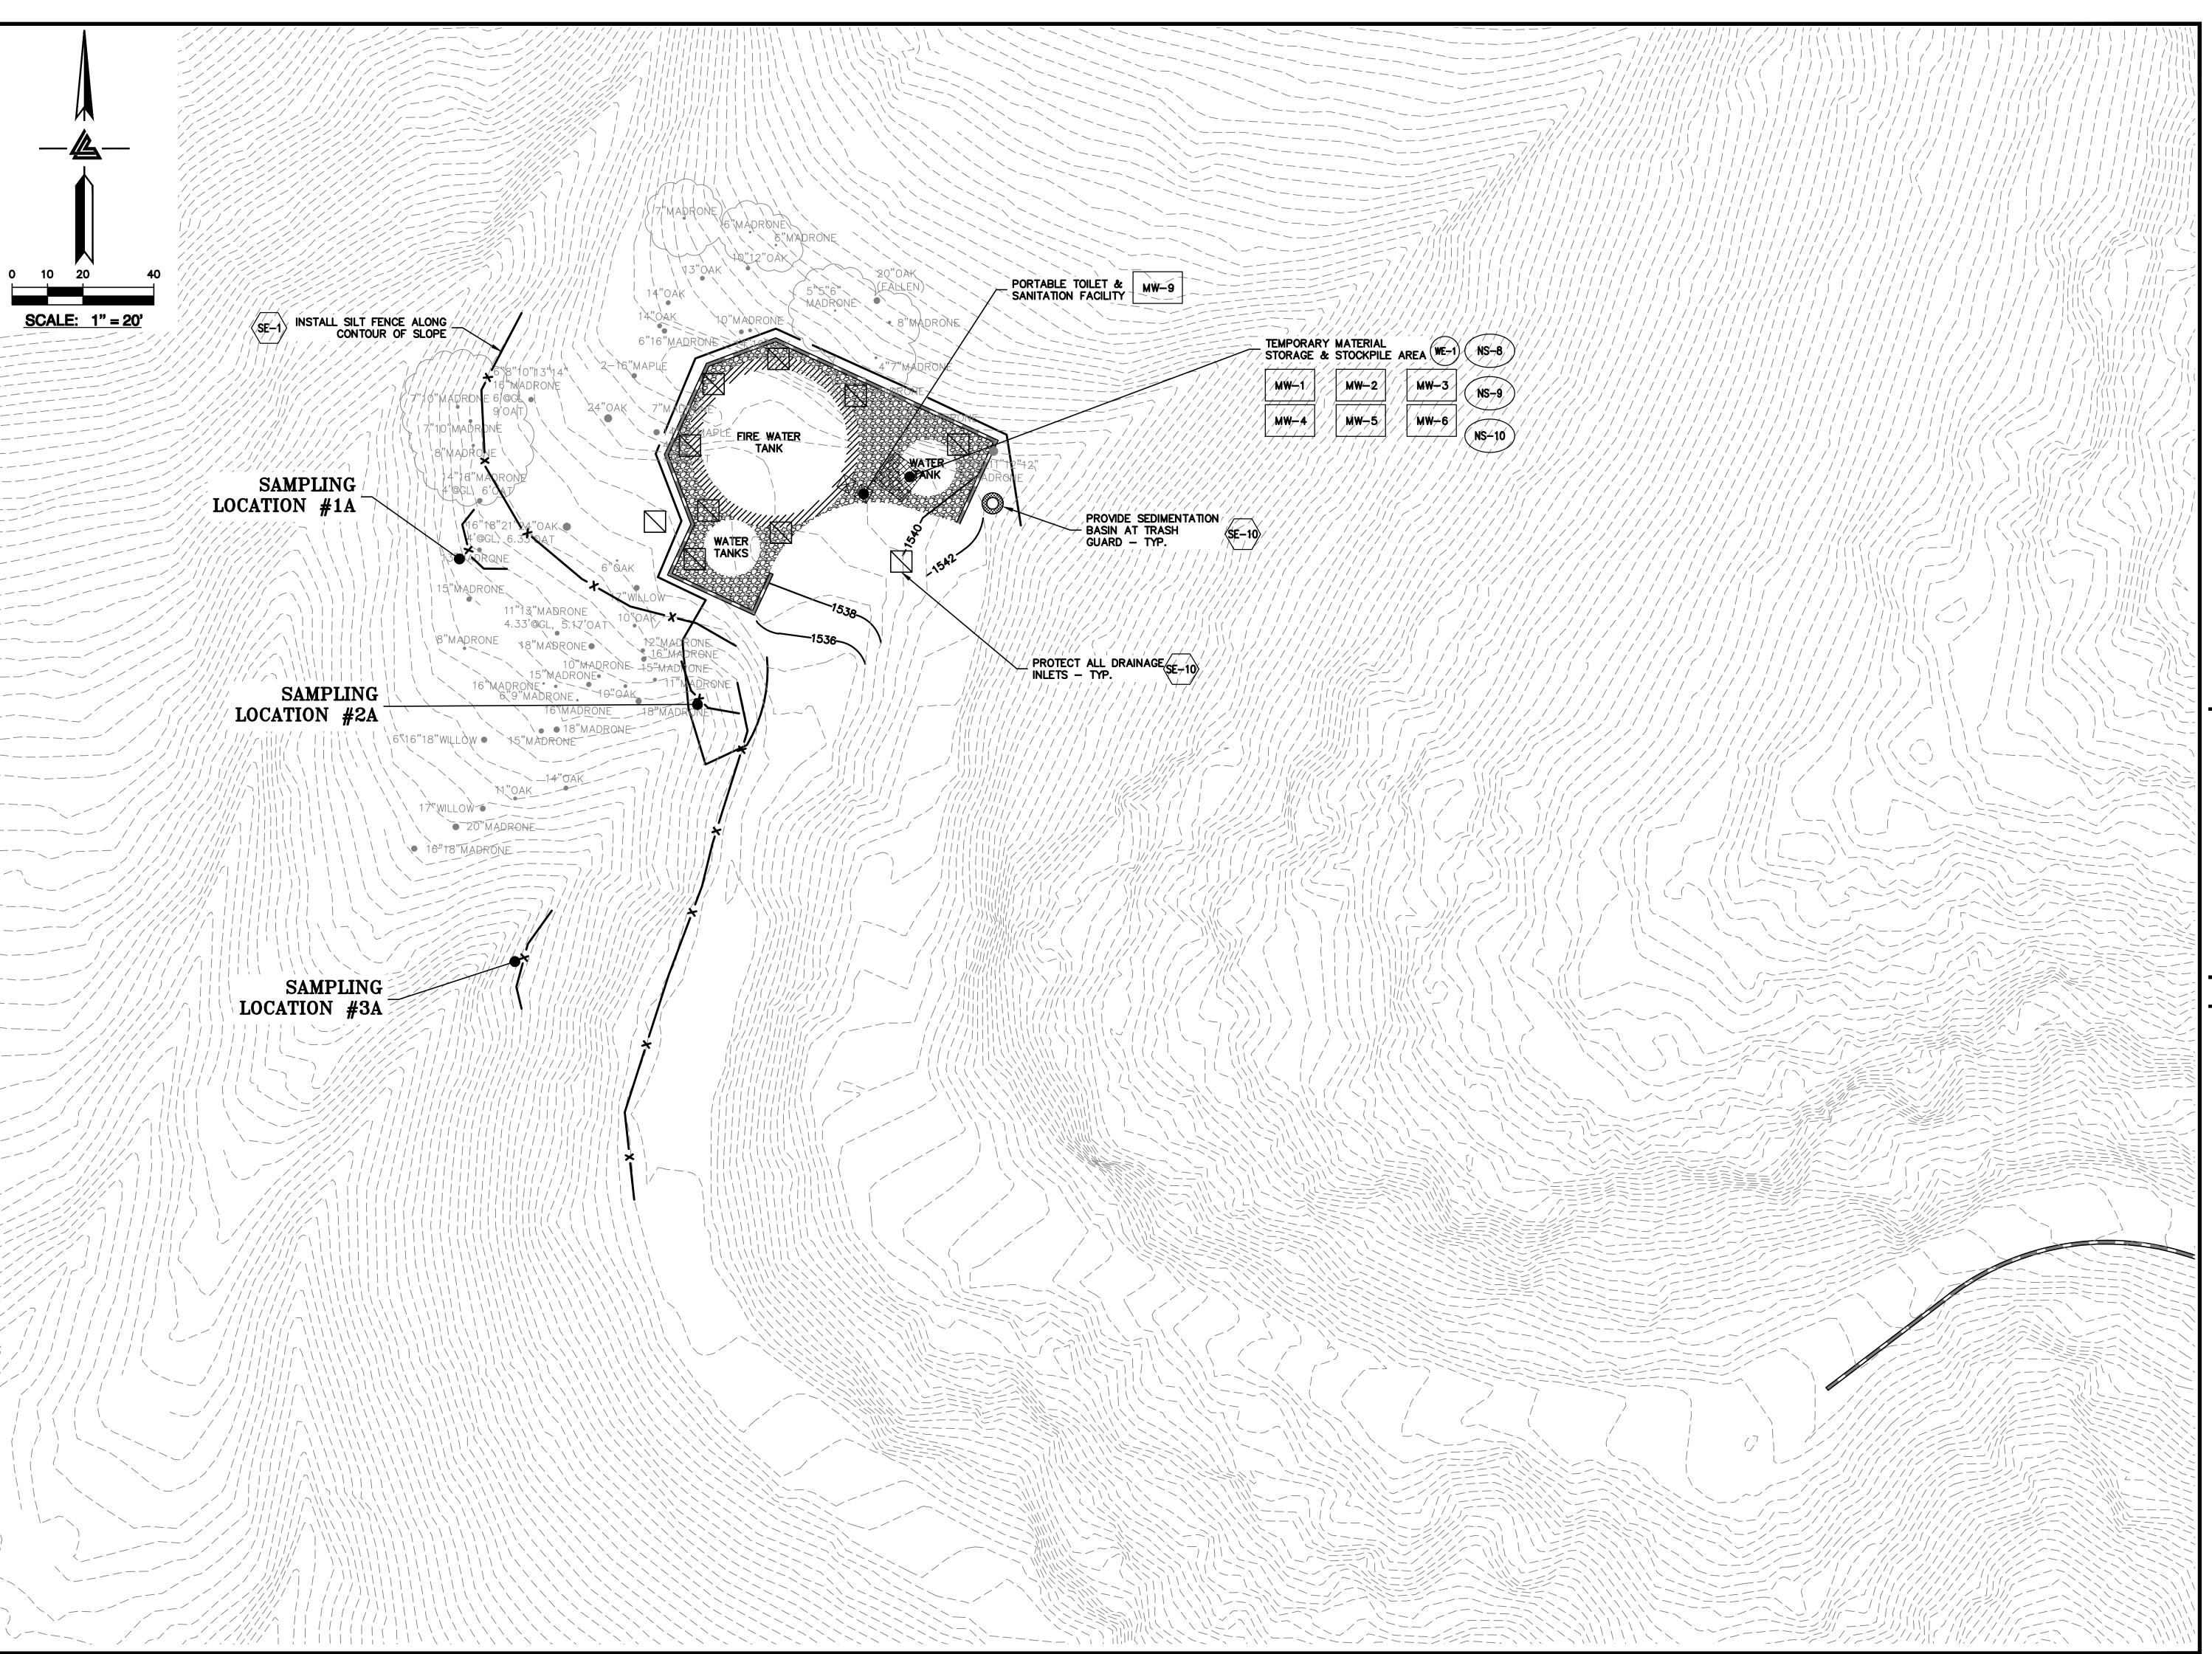

ELLISON CONSERVATION CENTER FOR WILDLIFE CARE SARATOGA, CA





ARCHITECTS KORTH SUNSERI HAGEY

ISSUES AND REVISIONS

12-21-18 PERMIT RESUBMITTAL

03-26-19 PERMIT MODIFICATION PLAN CHECK 1 04-11-19 ASA DELTA 2 04-22-19 BID SET

05-10-19 BID SET ADDENDUM 1 05-22-19 UTILITY PLAN CHECK 1 08-06-19 PHASE 4 - PERMIT SUBMITTAL

09-20-19 CONSTRUCTION SET 1 01-28-20 PERMIT MODIFICATION 2 05-29-20 PLAN CHECK RESPONSE PERMIT MODIFICATION 2

07-22-20 UTILITY PLAN SUBMITTAL

SANTA CLARA COUNTY RECORD INFORMATION APPLICANT: PENINSULA HUMANE SOCIETY ROAD: CONGRESS SPRINGS

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PROJECT NUMBER


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1" = 20'

PC / CA PC / JL 2130712


SHEET NUMBER

C-9.13

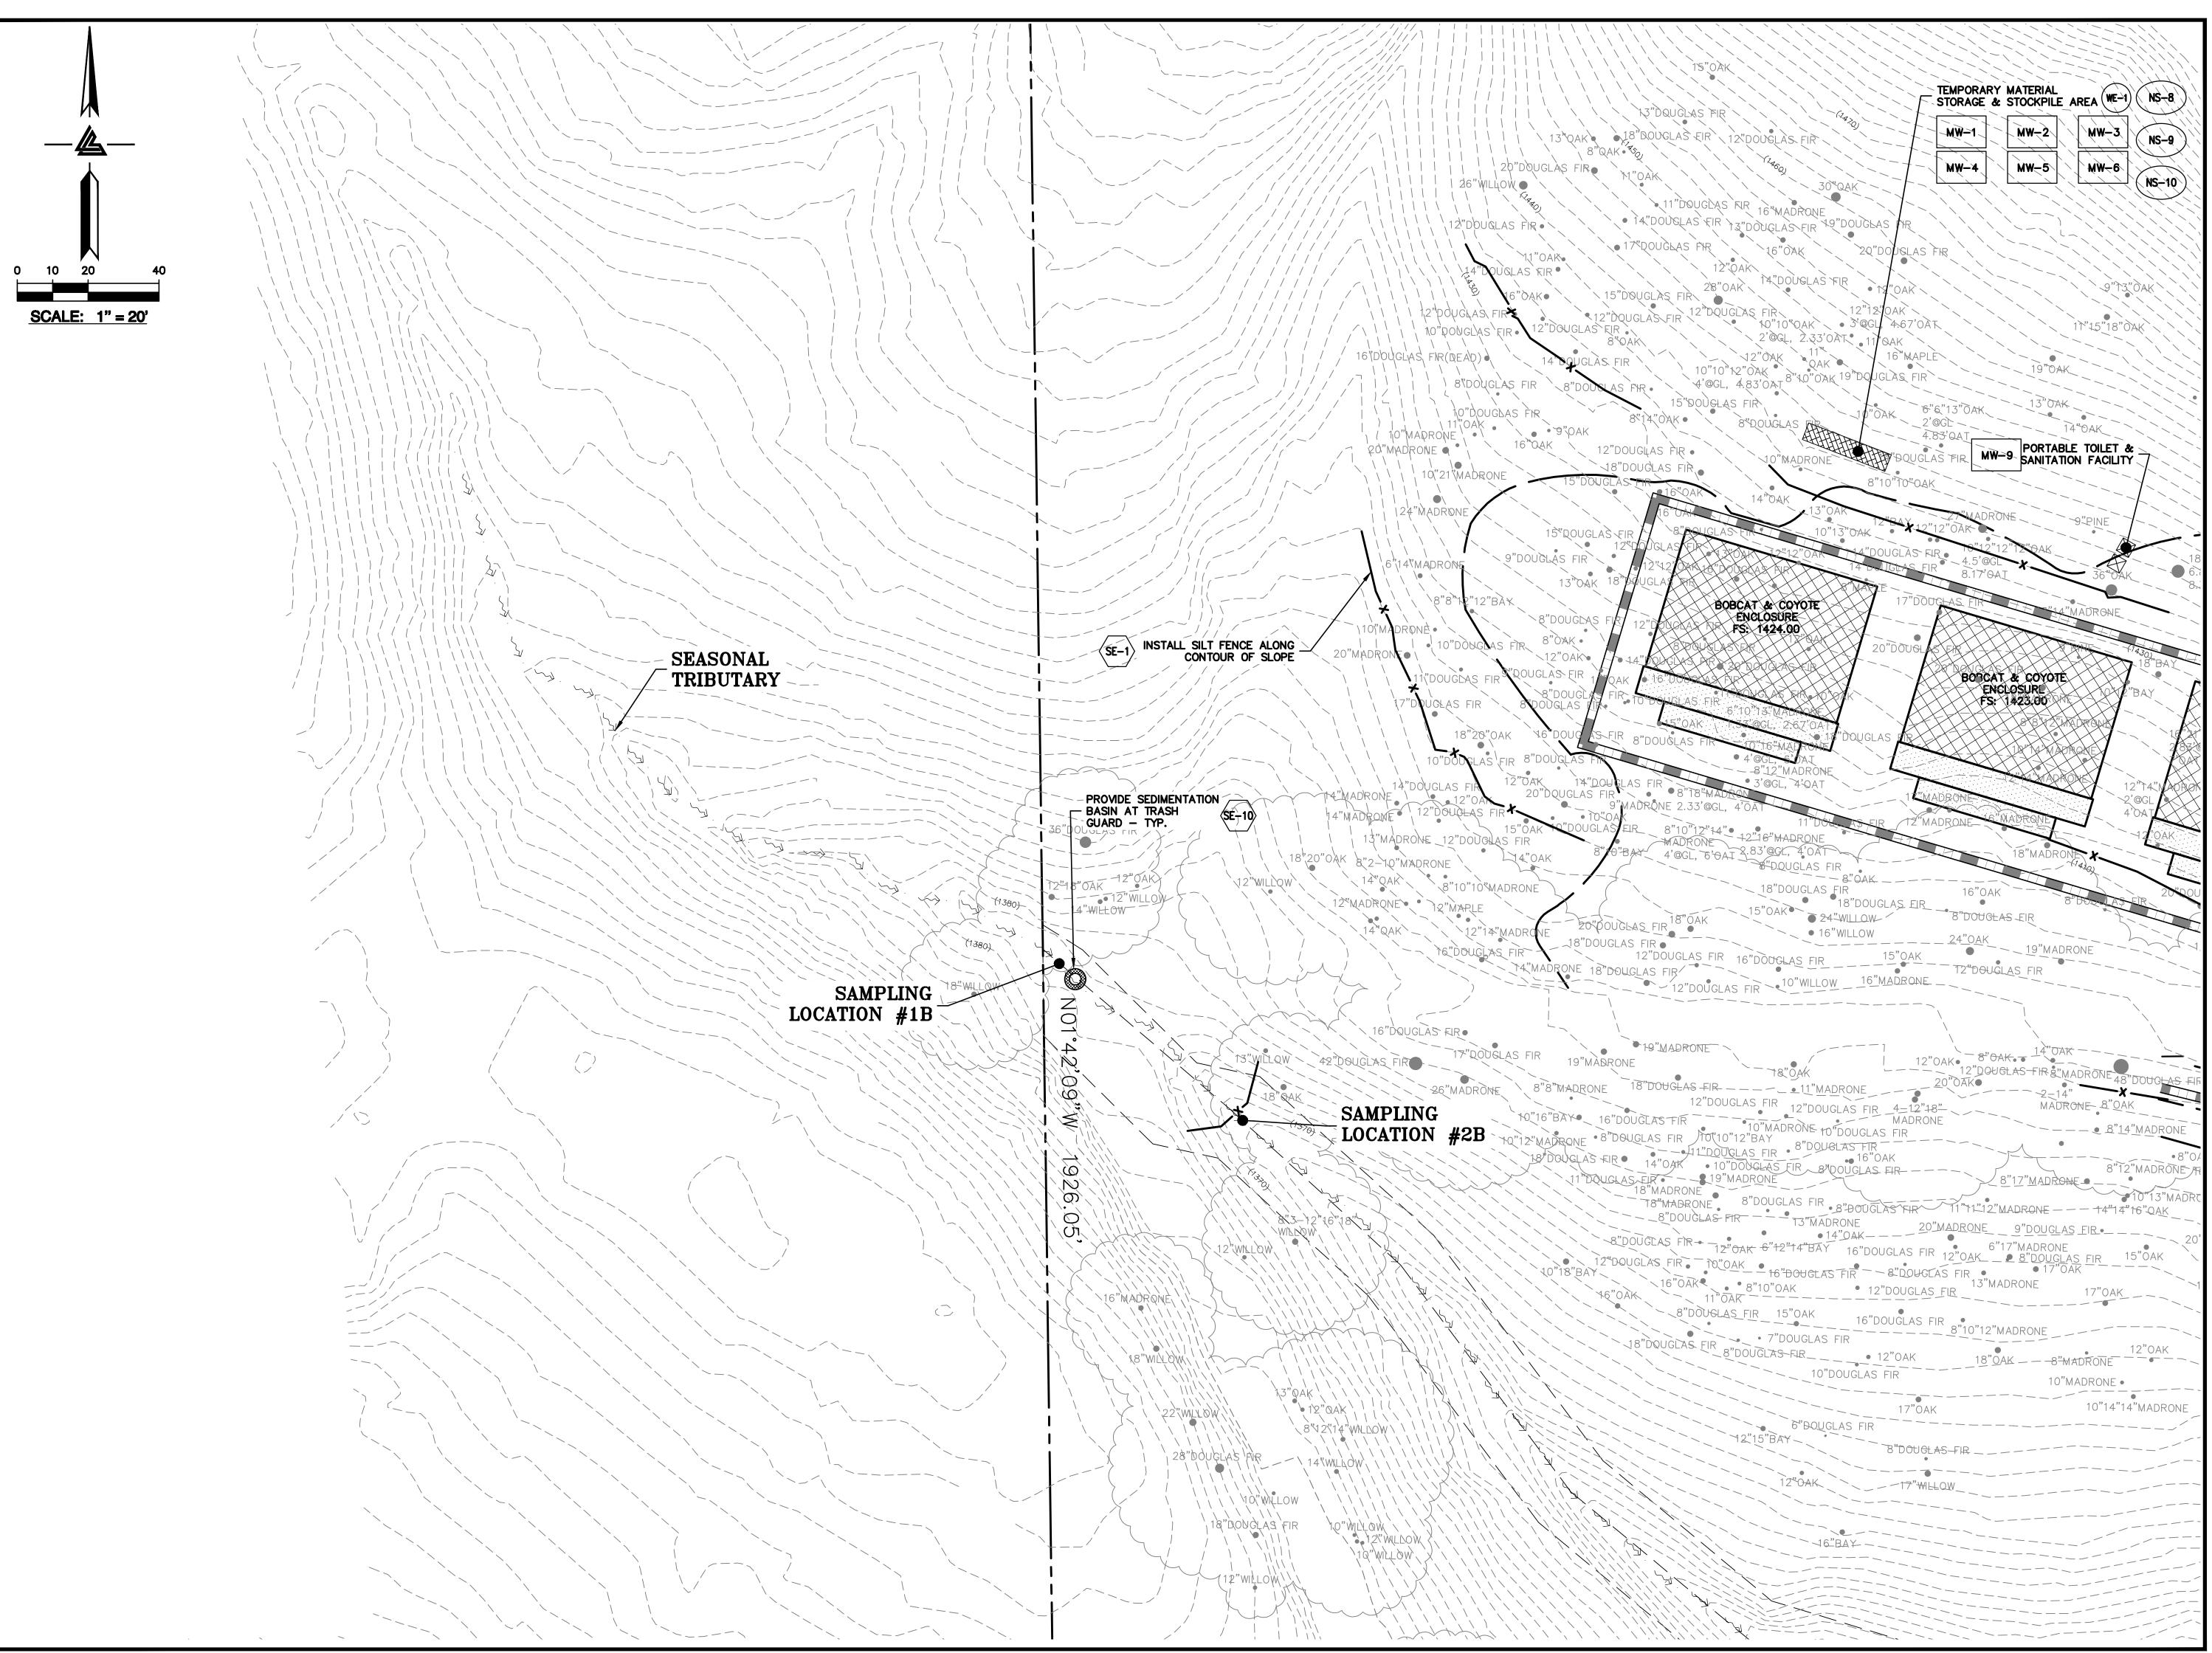

ELLISON CONSERVATION CENTER FOR WILDLIFE CARE



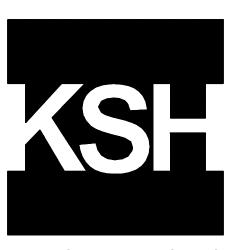

ARCHITECTS



GRADING PERMIT PLAN CHECK 4 12-21-18 PERMIT RESUBMITTAL PERMIT MODIFICATION 04-11-19 ASA DELTA 2 04-22-19 BID SET 05-22-19 UTILITY PLAN CHECK 08-06-19 PHASE 4 - PERMIT SUBMITTAL 09-20-19 CONSTRUCTION SET 1 01-28-20 PERMIT MODIFICATION 2 05-29-20 PLAN CHECK RESPONSE PERMIT MODIFICATION 2

07-22-20 UTILITY PLAN SUBMITTAL

SANTA CLARA COUNTY **RECORD INFORMATION** APPLICANT: PENINSULA HUMANE SOCIETY ROAD: CONGRESS SPRINGS LDE FILE: 6943-17-17G GRADING PERMIT: DEV19-1838 UTILITY PERMIT: DEV19-0220

> PROJECT NUMBER 16011.00

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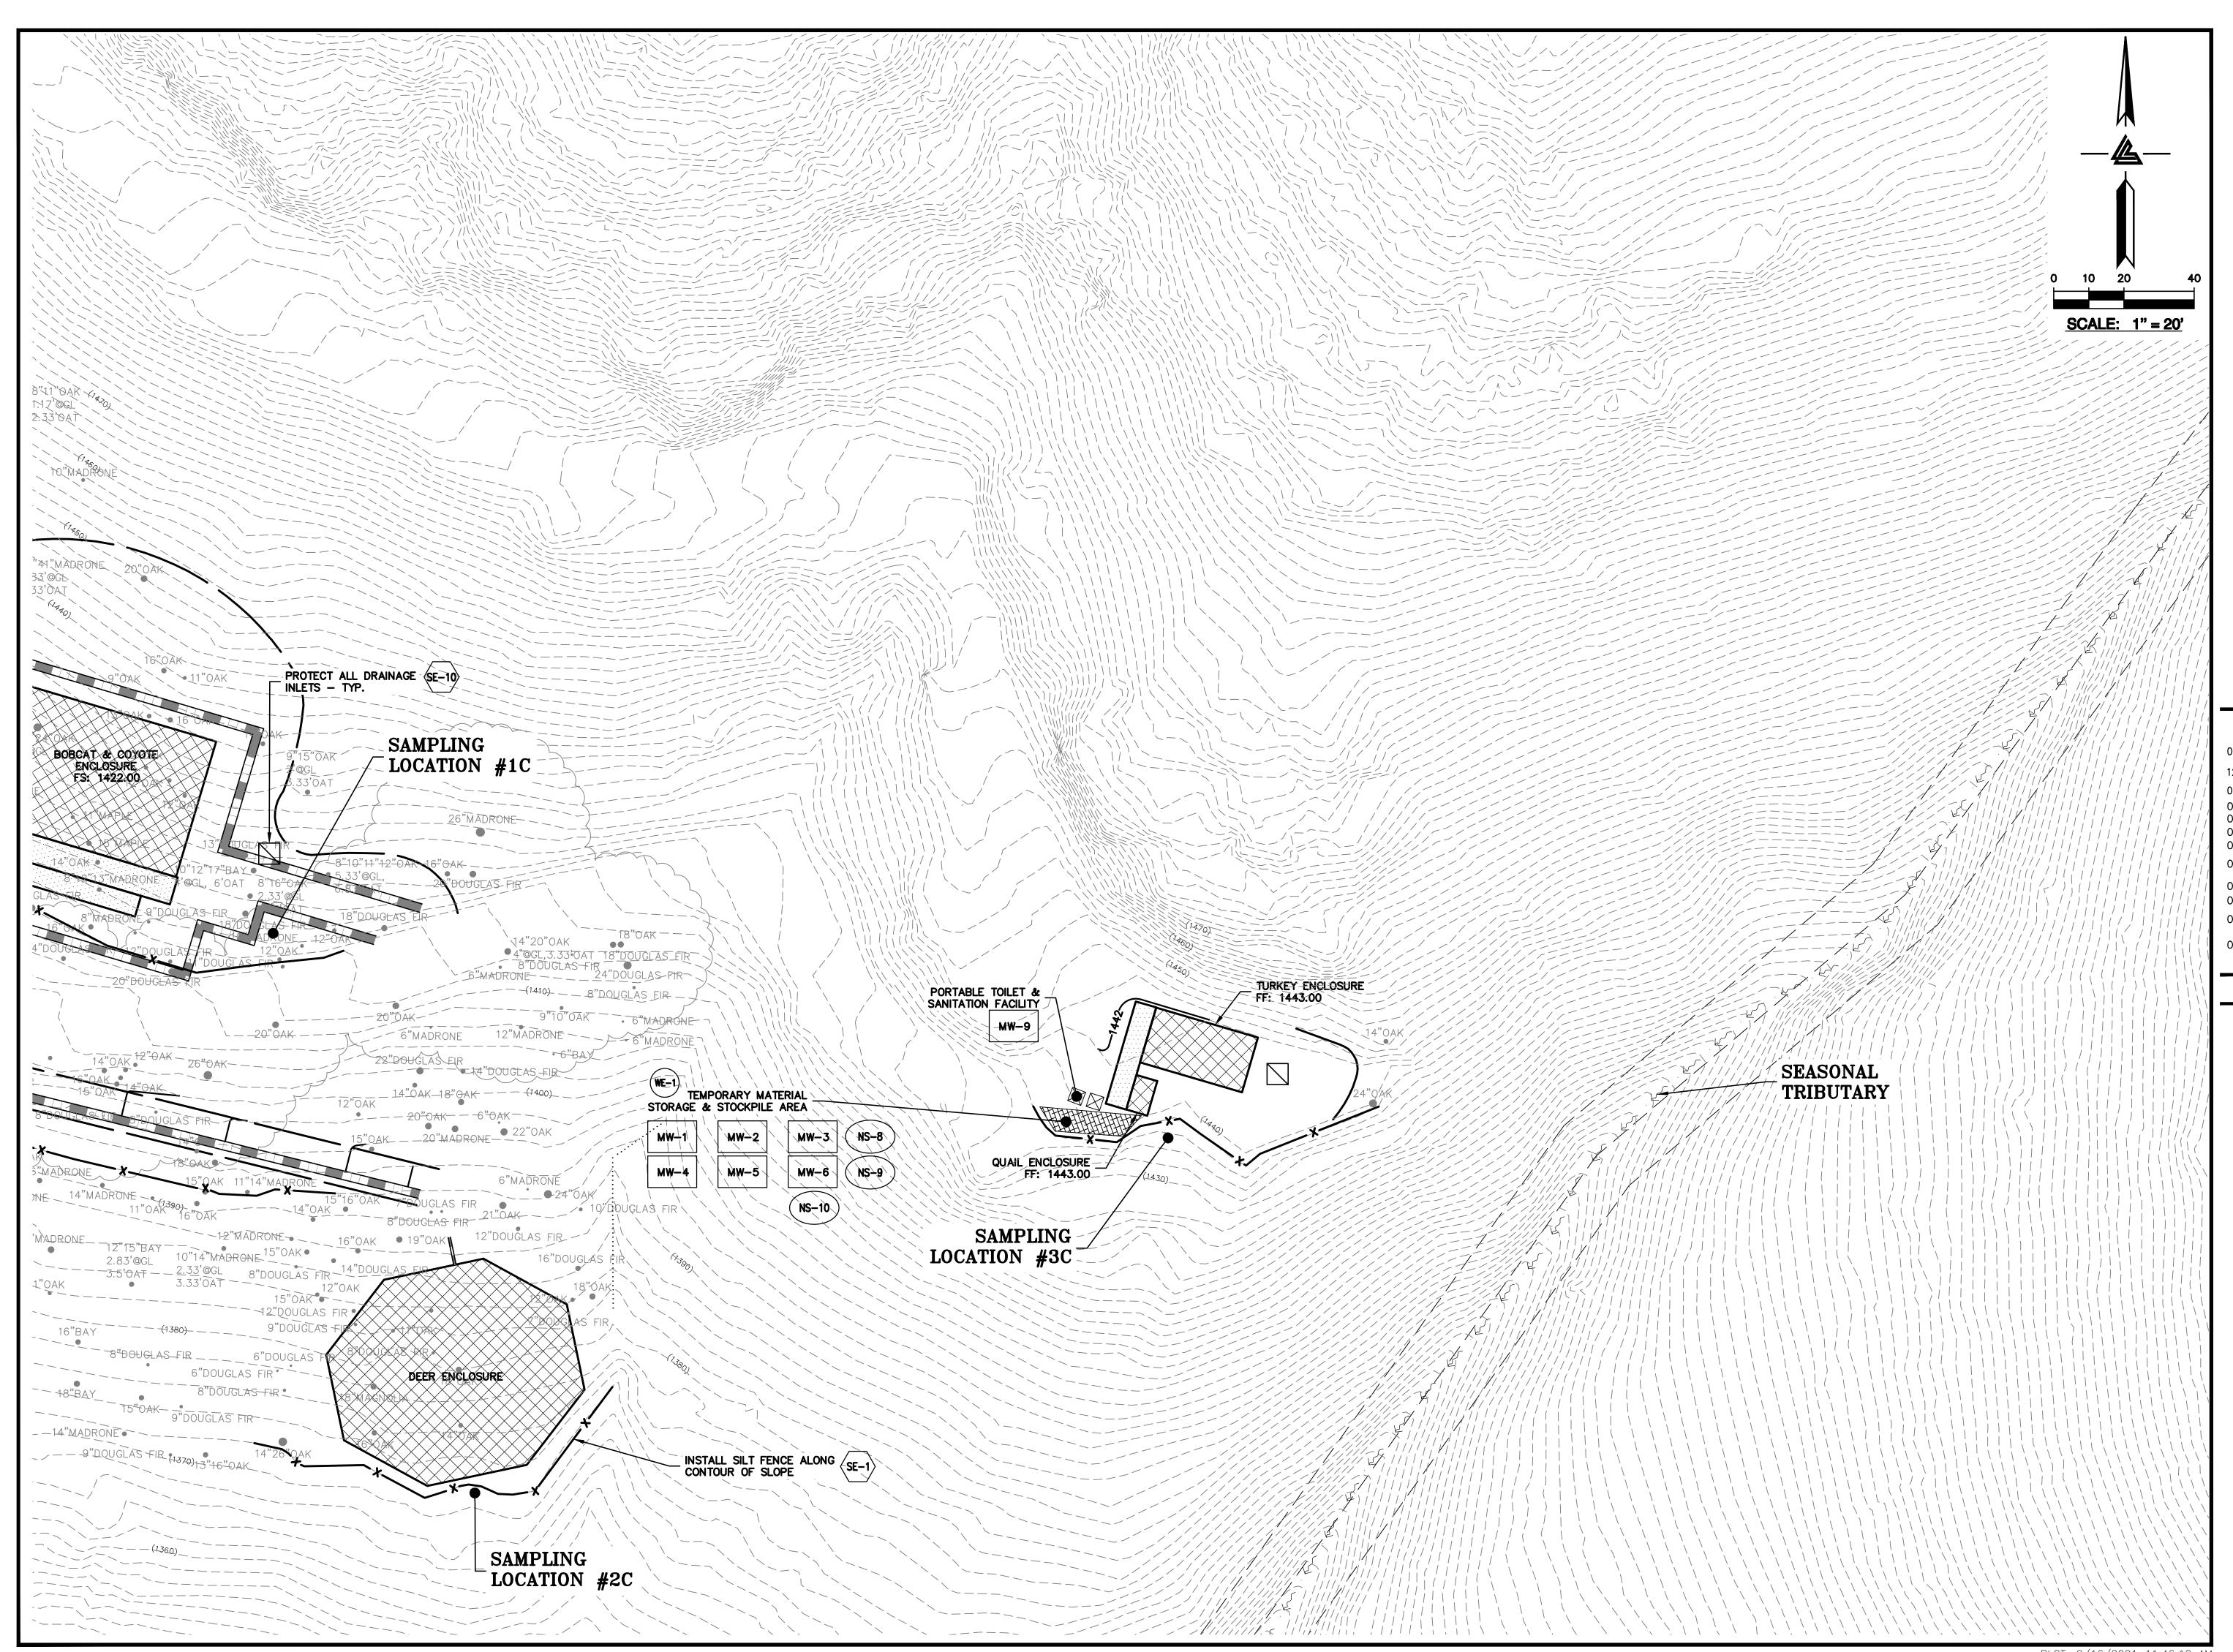
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SHEET NUMBER

C-9.14

ASA/USE PERMIT MODIFICATION #3 PLN-17-6943

PLOT: 2/16/2021 11:45:38 AM



ELLISON CONSERVATION CENTER FOR WILDLIFE CARE





ARCHITECTS KORTH SUNSERI HAGEY



DATE DESCRIPTION

09-06-18 GRADING PERMIT
PLAN CHECK 4

12-21-18 PERMIT RESUBMIT

12-21-18 PERMIT RESUBMITTAL
03-26-19 PERMIT MODIFICATION
PLAN CHECK 1
04-11-19 ASA DELTA 2
04-22-19 BID SET

05-10-19 BID SET ADDENDUM 1 05-22-19 UTILITY PLAN CHECK 1 08-06-19 PHASE 4 - PERMIT SUBMITTAL

09-20-19 CONSTRUCTION SET 1
01-28-20 PERMIT MODIFICATION 2
05-29-20 PLAN CHECK RESPONSE
PERMIT MODIFICATION 2

07-22-20 UTILITY PLAN SUBMITTAL

-22-20 SUBMITTAL

SANTA CLARA COUNTY RECORD INFORMATION APPLICANT: PENINSULA HUMANE SOCIETY ROAD: CONGRESS SPRINGS LDE FILE: 6943-17-17G

GRADING PERMIT: DEV19-1838
UTILITY PERMIT: DEV19-0220
PROJECT NUMBER

16011.00


PHASE 2 BMP PLAN
BUILDING & UTILITIES

SCALE 1'' = 20' PC / CA PC / JL

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hecked By PC / JL
B Job No. 2130712

SHEET NUMBER

C-9.15

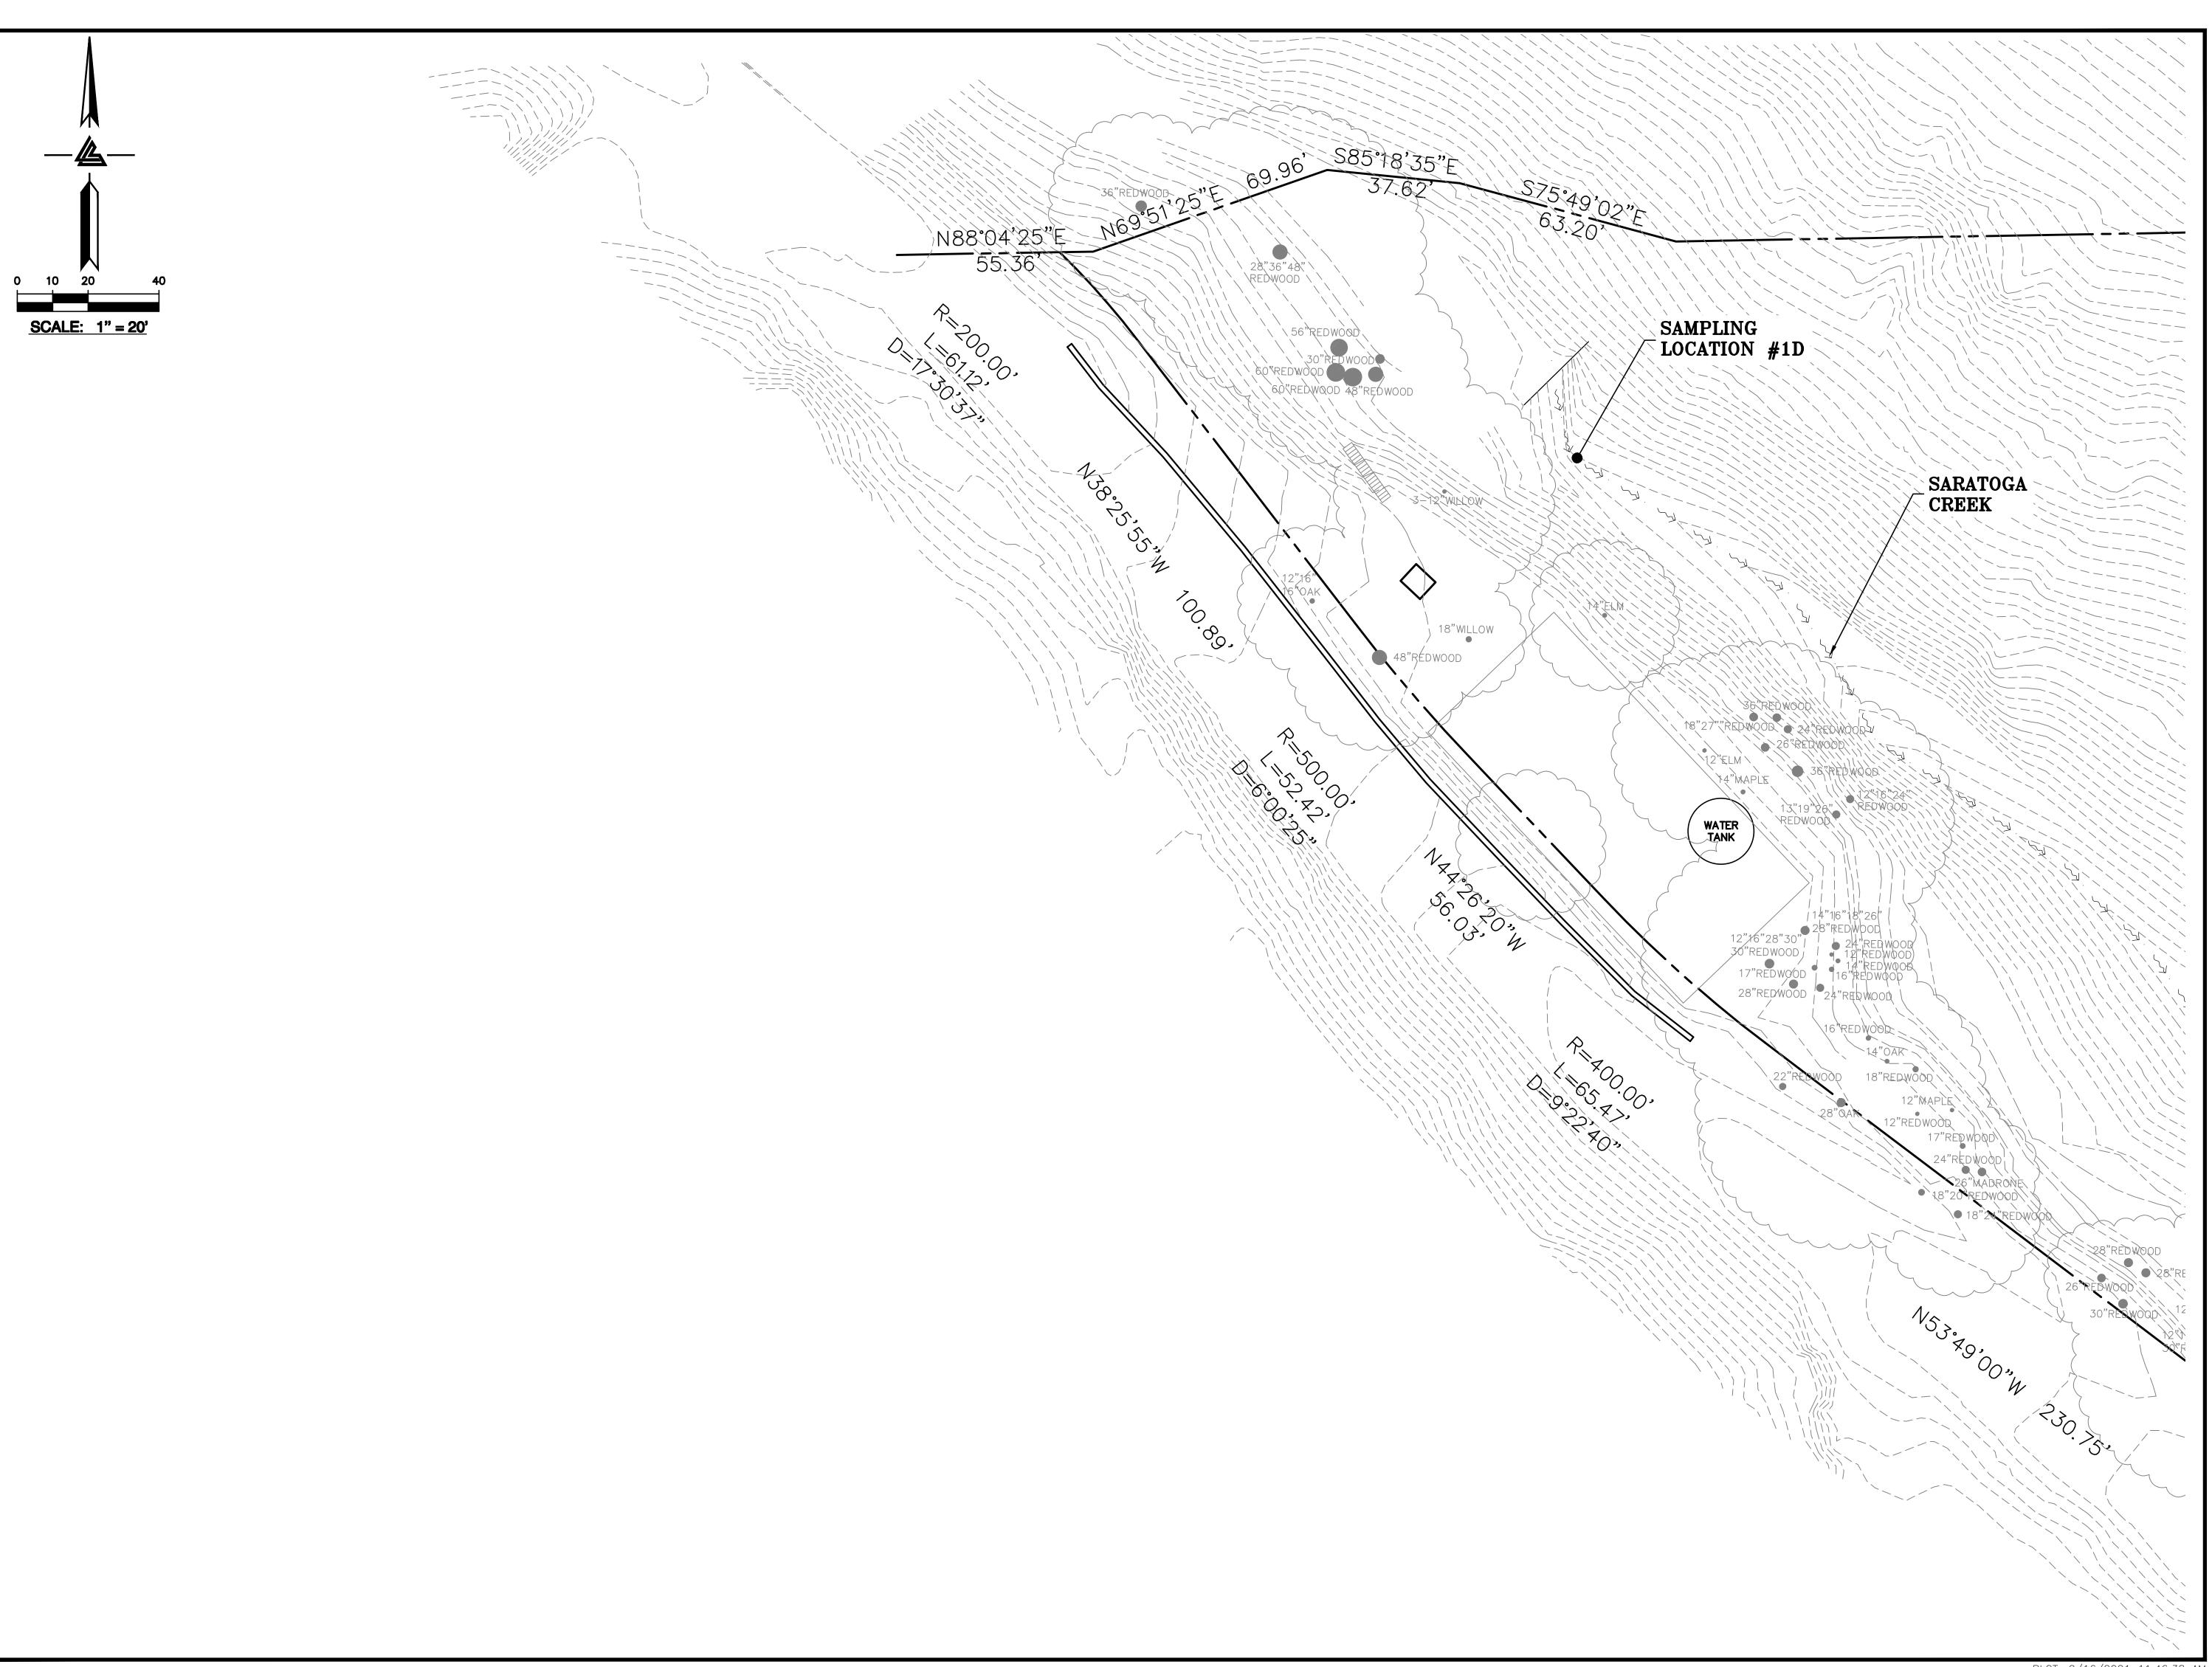

ELLISON CONSERVATION CENTER FOR WILDLIFE CARE SARATOGA, CA





ARCHITECTS KORTH SUNSERI HAGEY



09-06-18 GRADING PERMIT PLAN CHECK 4

12-21-18 PERMIT RESUBMITTAL

03-26-19 PERMIT MODIFICATION
PLAN CHECK 1

04-11-19 ASA DELTA 2

04-22-19 BID SET

05-10-19 BID SET ADDENDUM 1

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08-06-19 PHASE 4 - PERMIT
SUBMITTAL

09-20-19 CONSTRUCTION SET 1 01-28-20 PERMIT MODIFICATION 2 05-29-20 PLAN CHECK RESPONSE PERMIT MODIFICATION 2

07-22-20 UTILITY PLAN SUBMITTAL

SANTA CLARA COUNTY RECORD INFORMATION APPLICANT: PENINSULA HUMANE SOCIETY

ROAD: CONGRESS SPRINGS LDE FILE: 6943-17-17G GRADING PERMIT: DEV19-1838 UTILITY PERMIT: DEV19-0220

> PROJECT NUMBER 16011.00

SHEET TITLE PHASE 2 BMP PLAN


SCALE

BUILDING & UTILITIES

1" = 20' PC / CA PC / JL 2130712

SHEET NUMBER

C-9.16

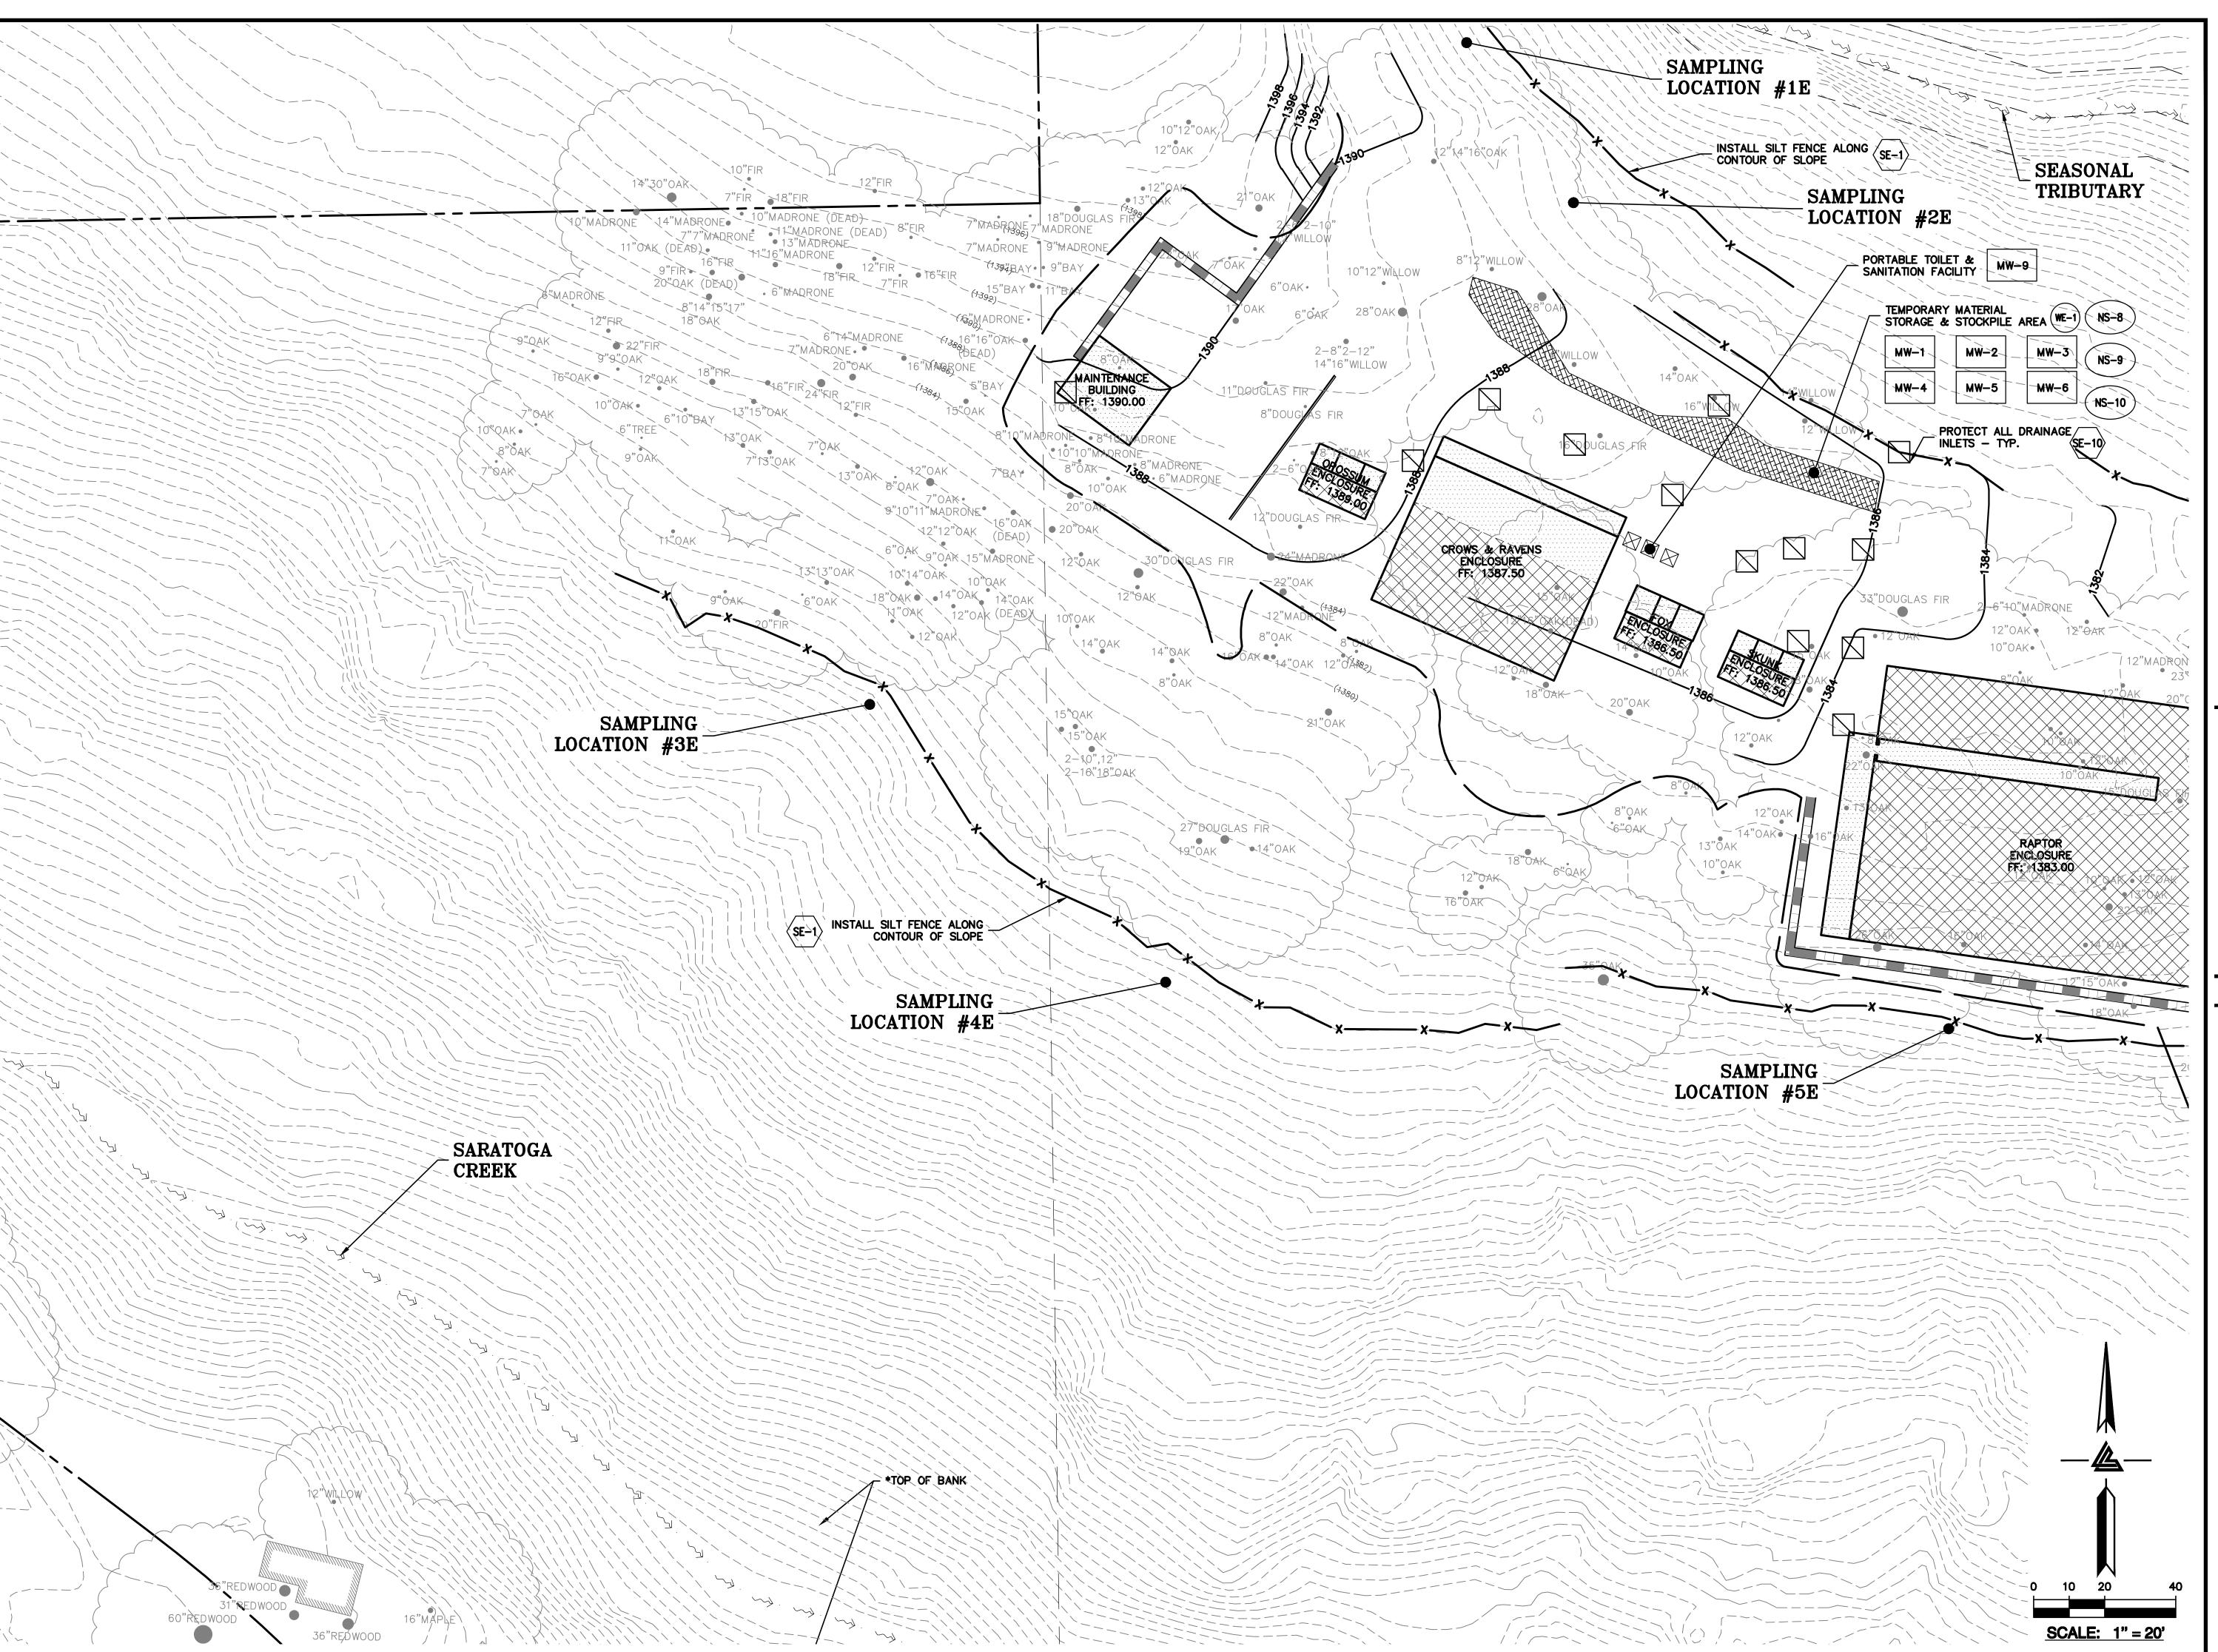

ELLISON CONSERVATION CENTER FOR WILDLIFE CARE





ARCHITECTS



ISSUES AND REVISIONS DESCRIPTION

09-06-18 GRADING PERMIT PLAN CHECK 4

12-21-18 PERMIT RESUBMITTAL 03-26-19 PERMIT MODIFICATION PLAN CHECK 1 04-11-19 ASA DELTA 2 04-22-19 BID SET

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09-20-19 CONSTRUCTION SET 1 01-28-20 PERMIT MODIFICATION 2 05-29-20 PLAN CHECK RESPONSE PERMIT MODIFICATION 2

07-22-20 UTILITY PLAN SUBMITTAL

SANTA CLARA COUNTY

RECORD INFORMATION APPLICANT: PENINSULA HUMANE SOCIETY ROAD: CONGRESS SPRINGS LDE FILE: 6943-17-17G GRADING PERMIT: DEV19-1838

UTILITY PERMIT: DEV19-0220


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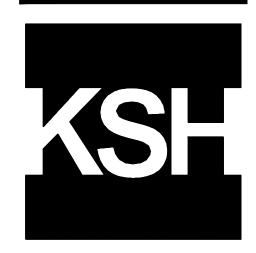
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2130712

SHEET NUMBER C-9.17





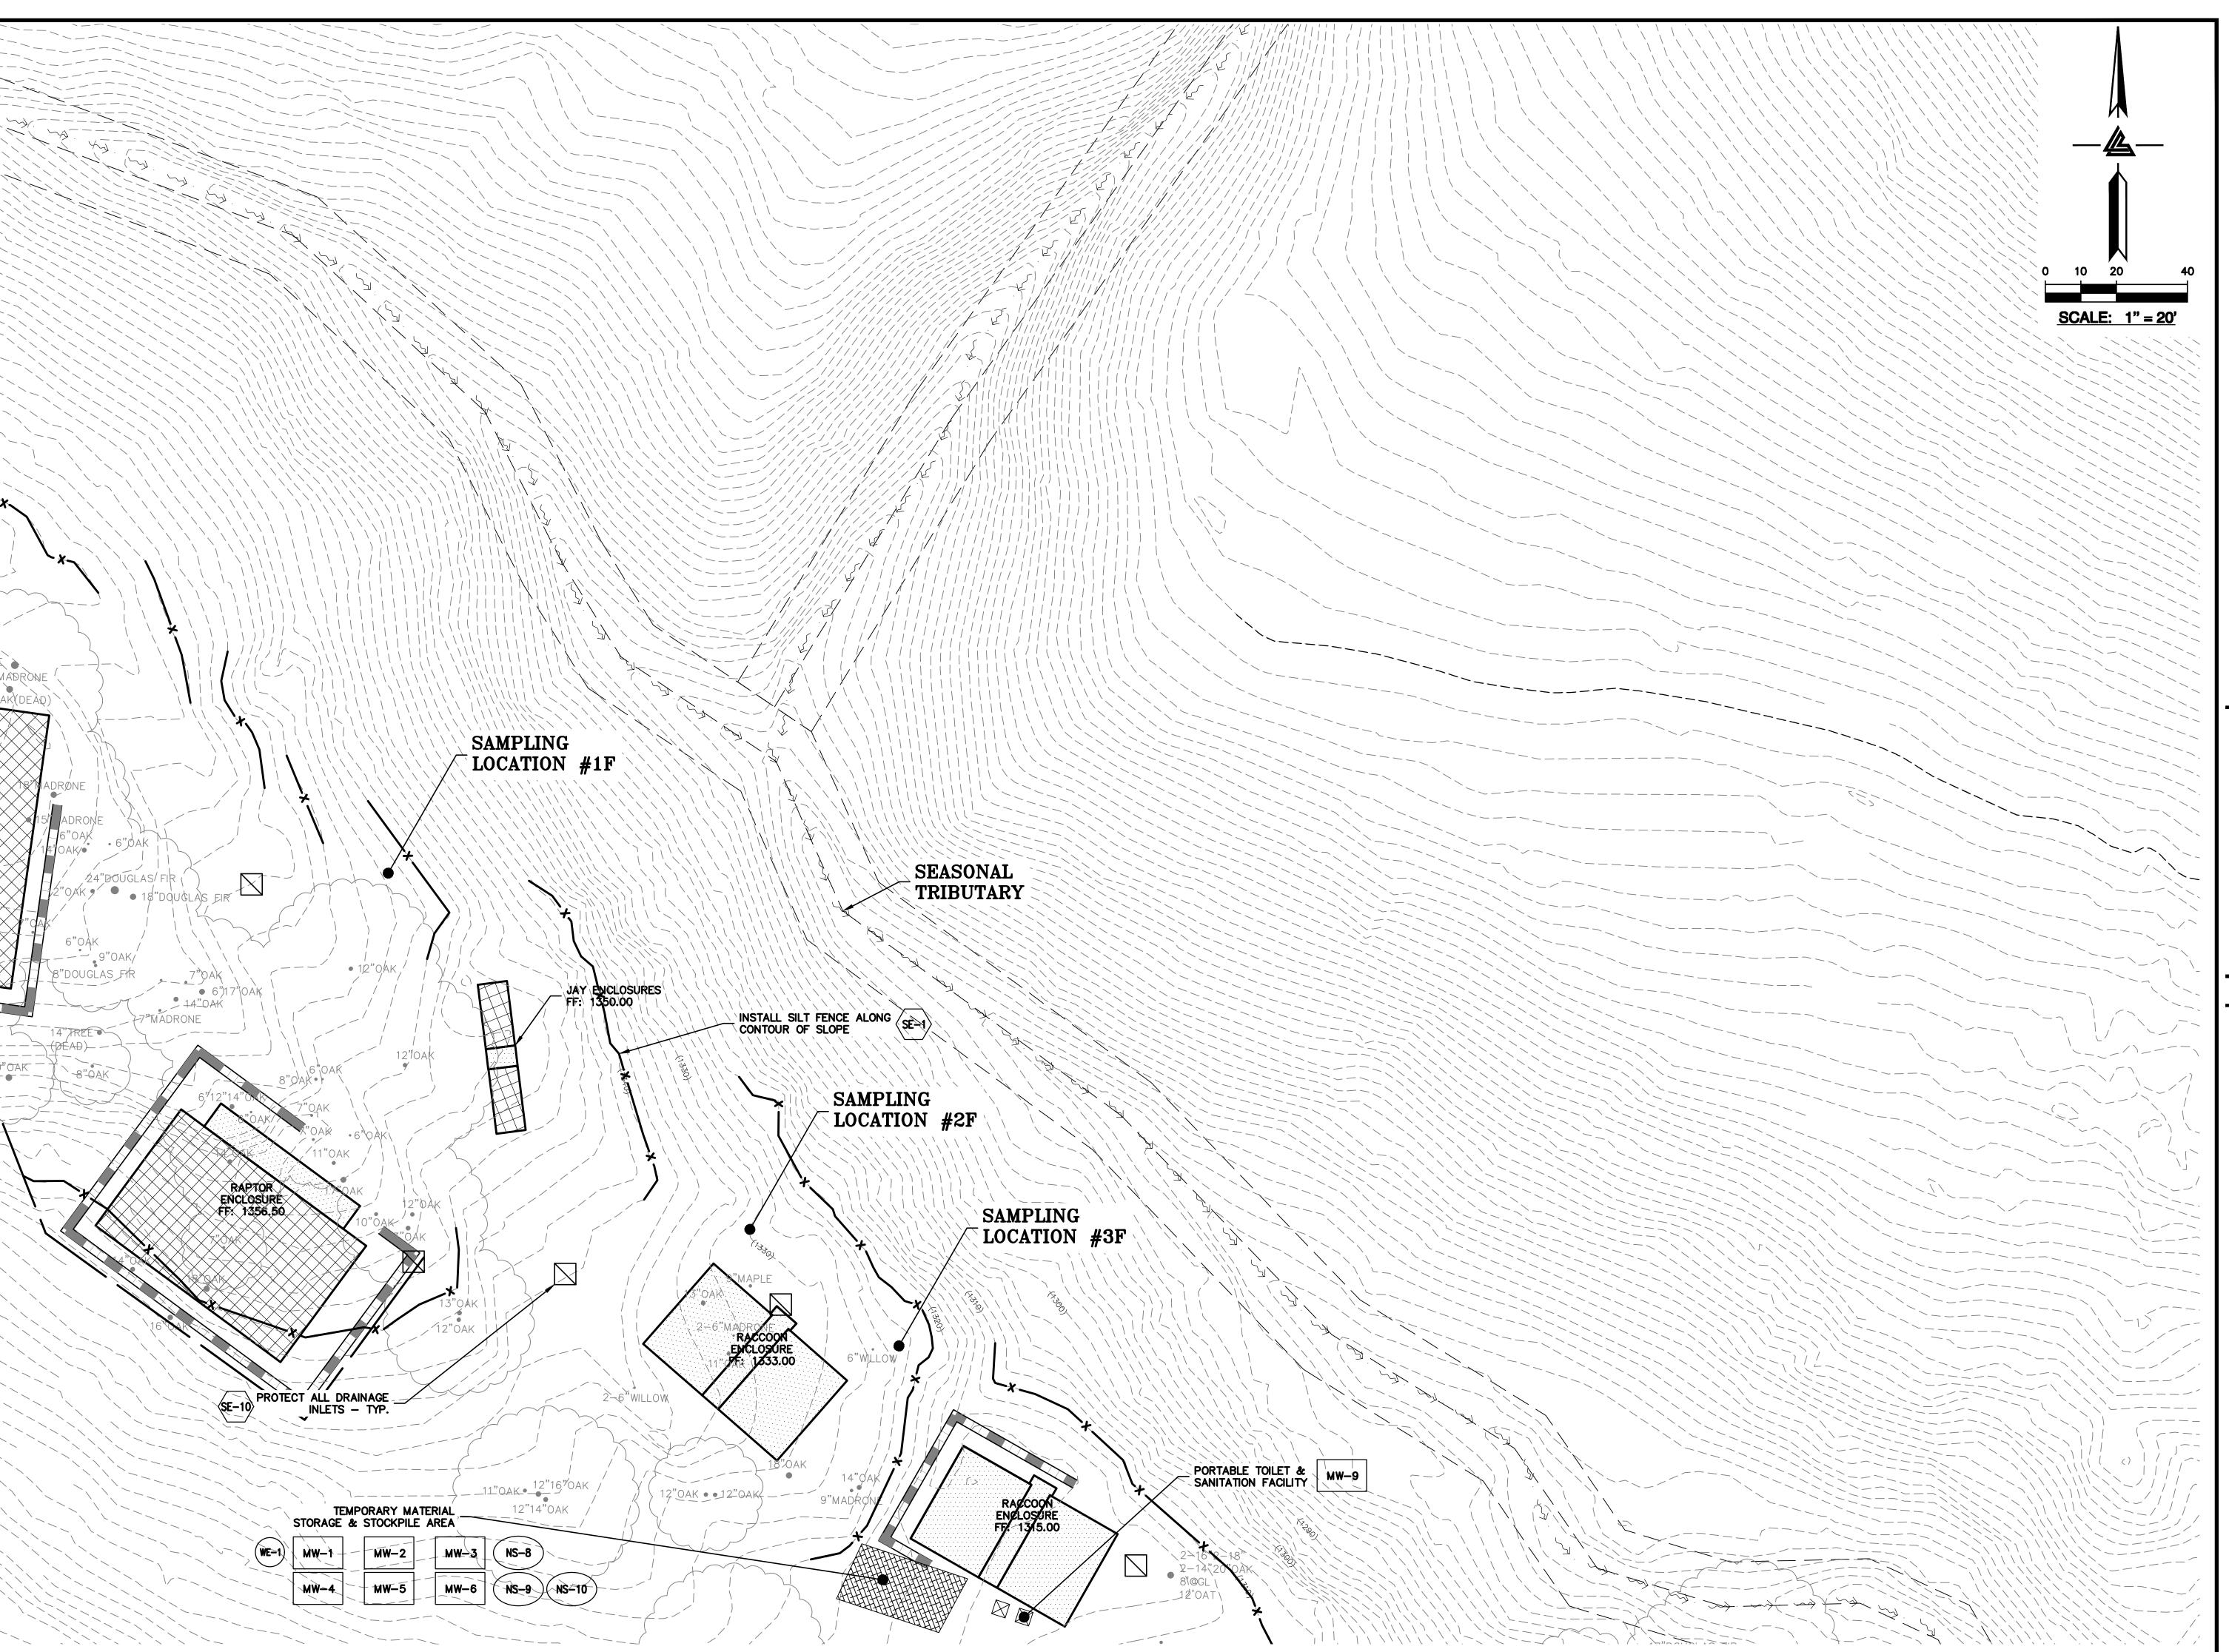

ARCHITECTS KORTH SUNSERI HAGEY

08-06-19 PHASE 4 - PERMIT SUBMITTAL

09-20-19 CONSTRUCTION SET 1 01-28-20 PERMIT MODIFICATION 2 05-29-20 PLAN CHECK RESPONSE PERMIT MODIFICATION 2

07-22-20 UTILITY PLAN SUBMITTAL

SANTA CLARA COUNTY RECORD INFORMATION APPLICANT: PENINSULA HUMANE SOCIETY ROAD: CONGRESS SPRINGS

LDE FILE: 6943-17-17G GRADING PERMIT: DEV19-1838 UTILITY PERMIT: DEV19-0220

PROJECT NUMBER 16011.00


SHEET TITLE PHASE 2 BMP PLAN BUILDING & UTILITIES

1" = 20'

PC / CA PC / JL 2130712

SHEET NUMBER

C-9.18

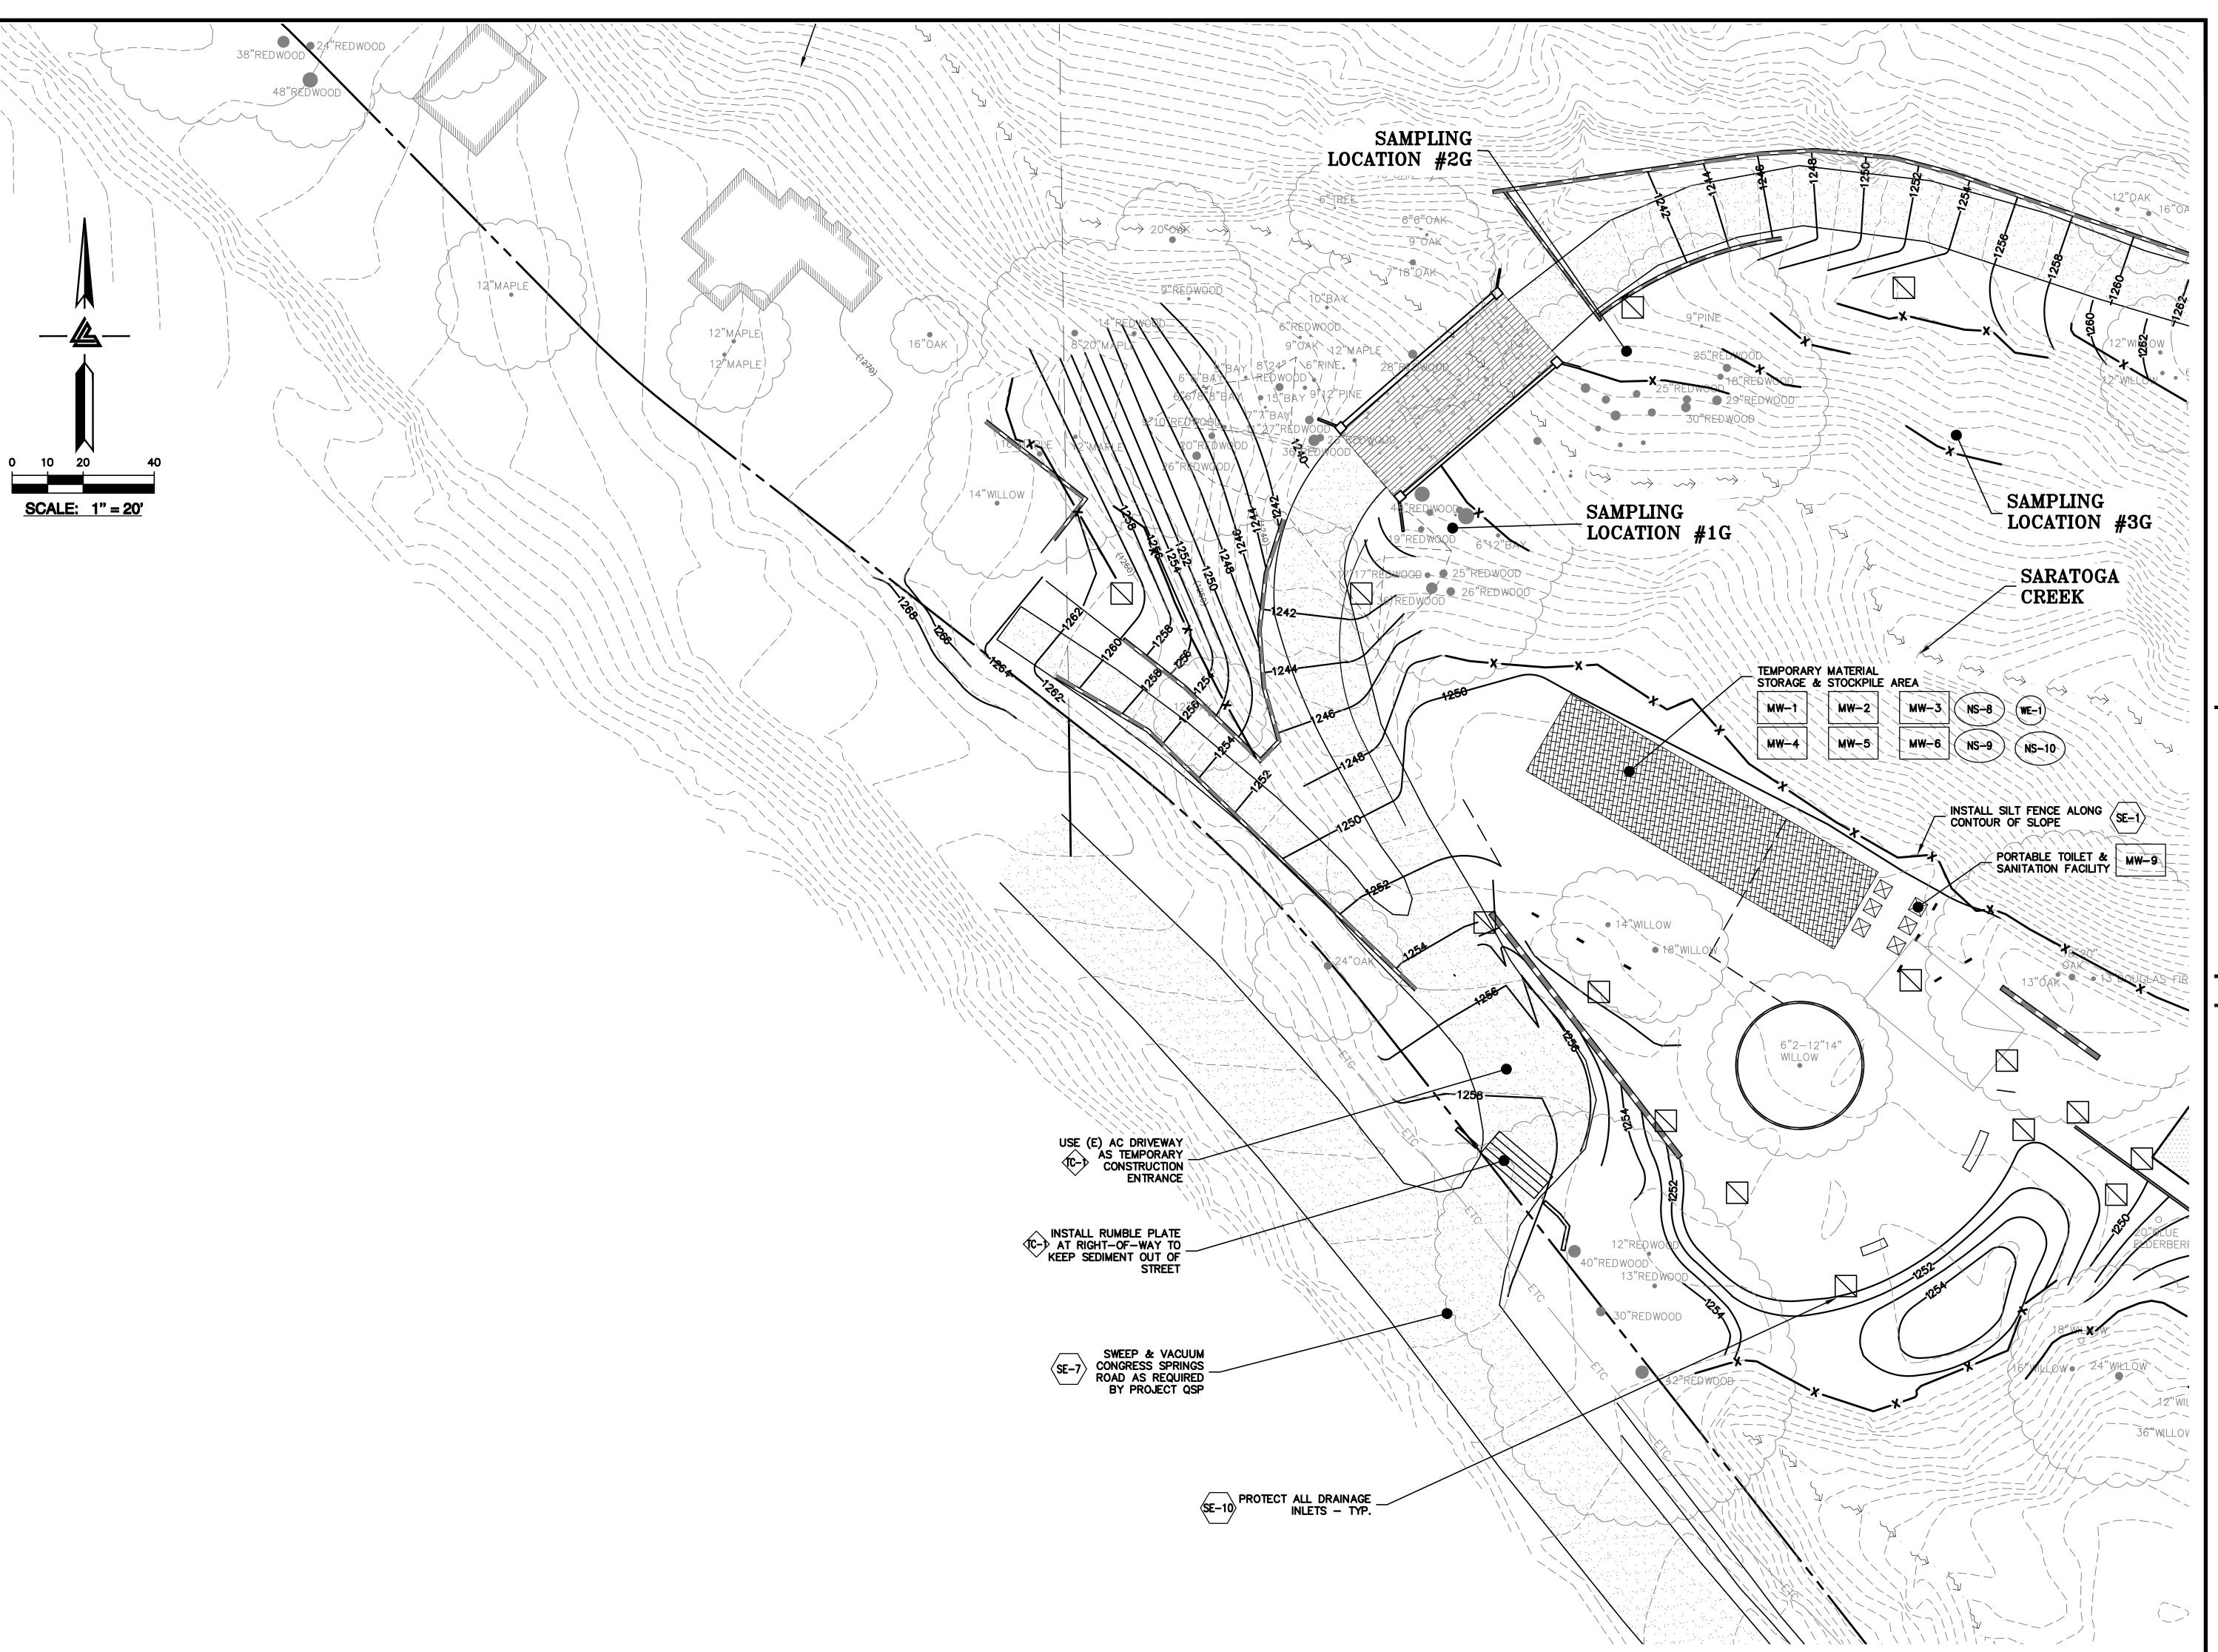

ELLISON CONSERVATION CENTER FOR WILDLIFE CARE SARATOGA, CA





ARCHITECTS KORTH SUNSERI HAGEY



ISSUES AND REVISIONS

09-06-18 GRADING PERMIT PLAN CHECK 4

12-21-18 PERMIT RESUBMITTAL
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PLAN CHECK 1
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08-06-19 PHASE 4 - PERMIT SUBMITTAL 09-20-19 CONSTRUCTION SET 1

01-28-20 PERMIT MODIFICATION 2 05-29-20 PLAN CHECK RESPONSE PERMIT MODIFICATION 2

07-22-20 UTILITY PLAN SUBMITTAL

SANTA CLARA COUNTY RECORD INFORMATION APPLICANT: PENINSULA HUMANE SOCIETY

ROAD: CONGRESS SPRINGS LDE FILE: 6943-17-17G GRADING PERMIT: DEV19-1838 UTILITY PERMIT: DEV19-0220

> PROJECT NUMBER 16011.00

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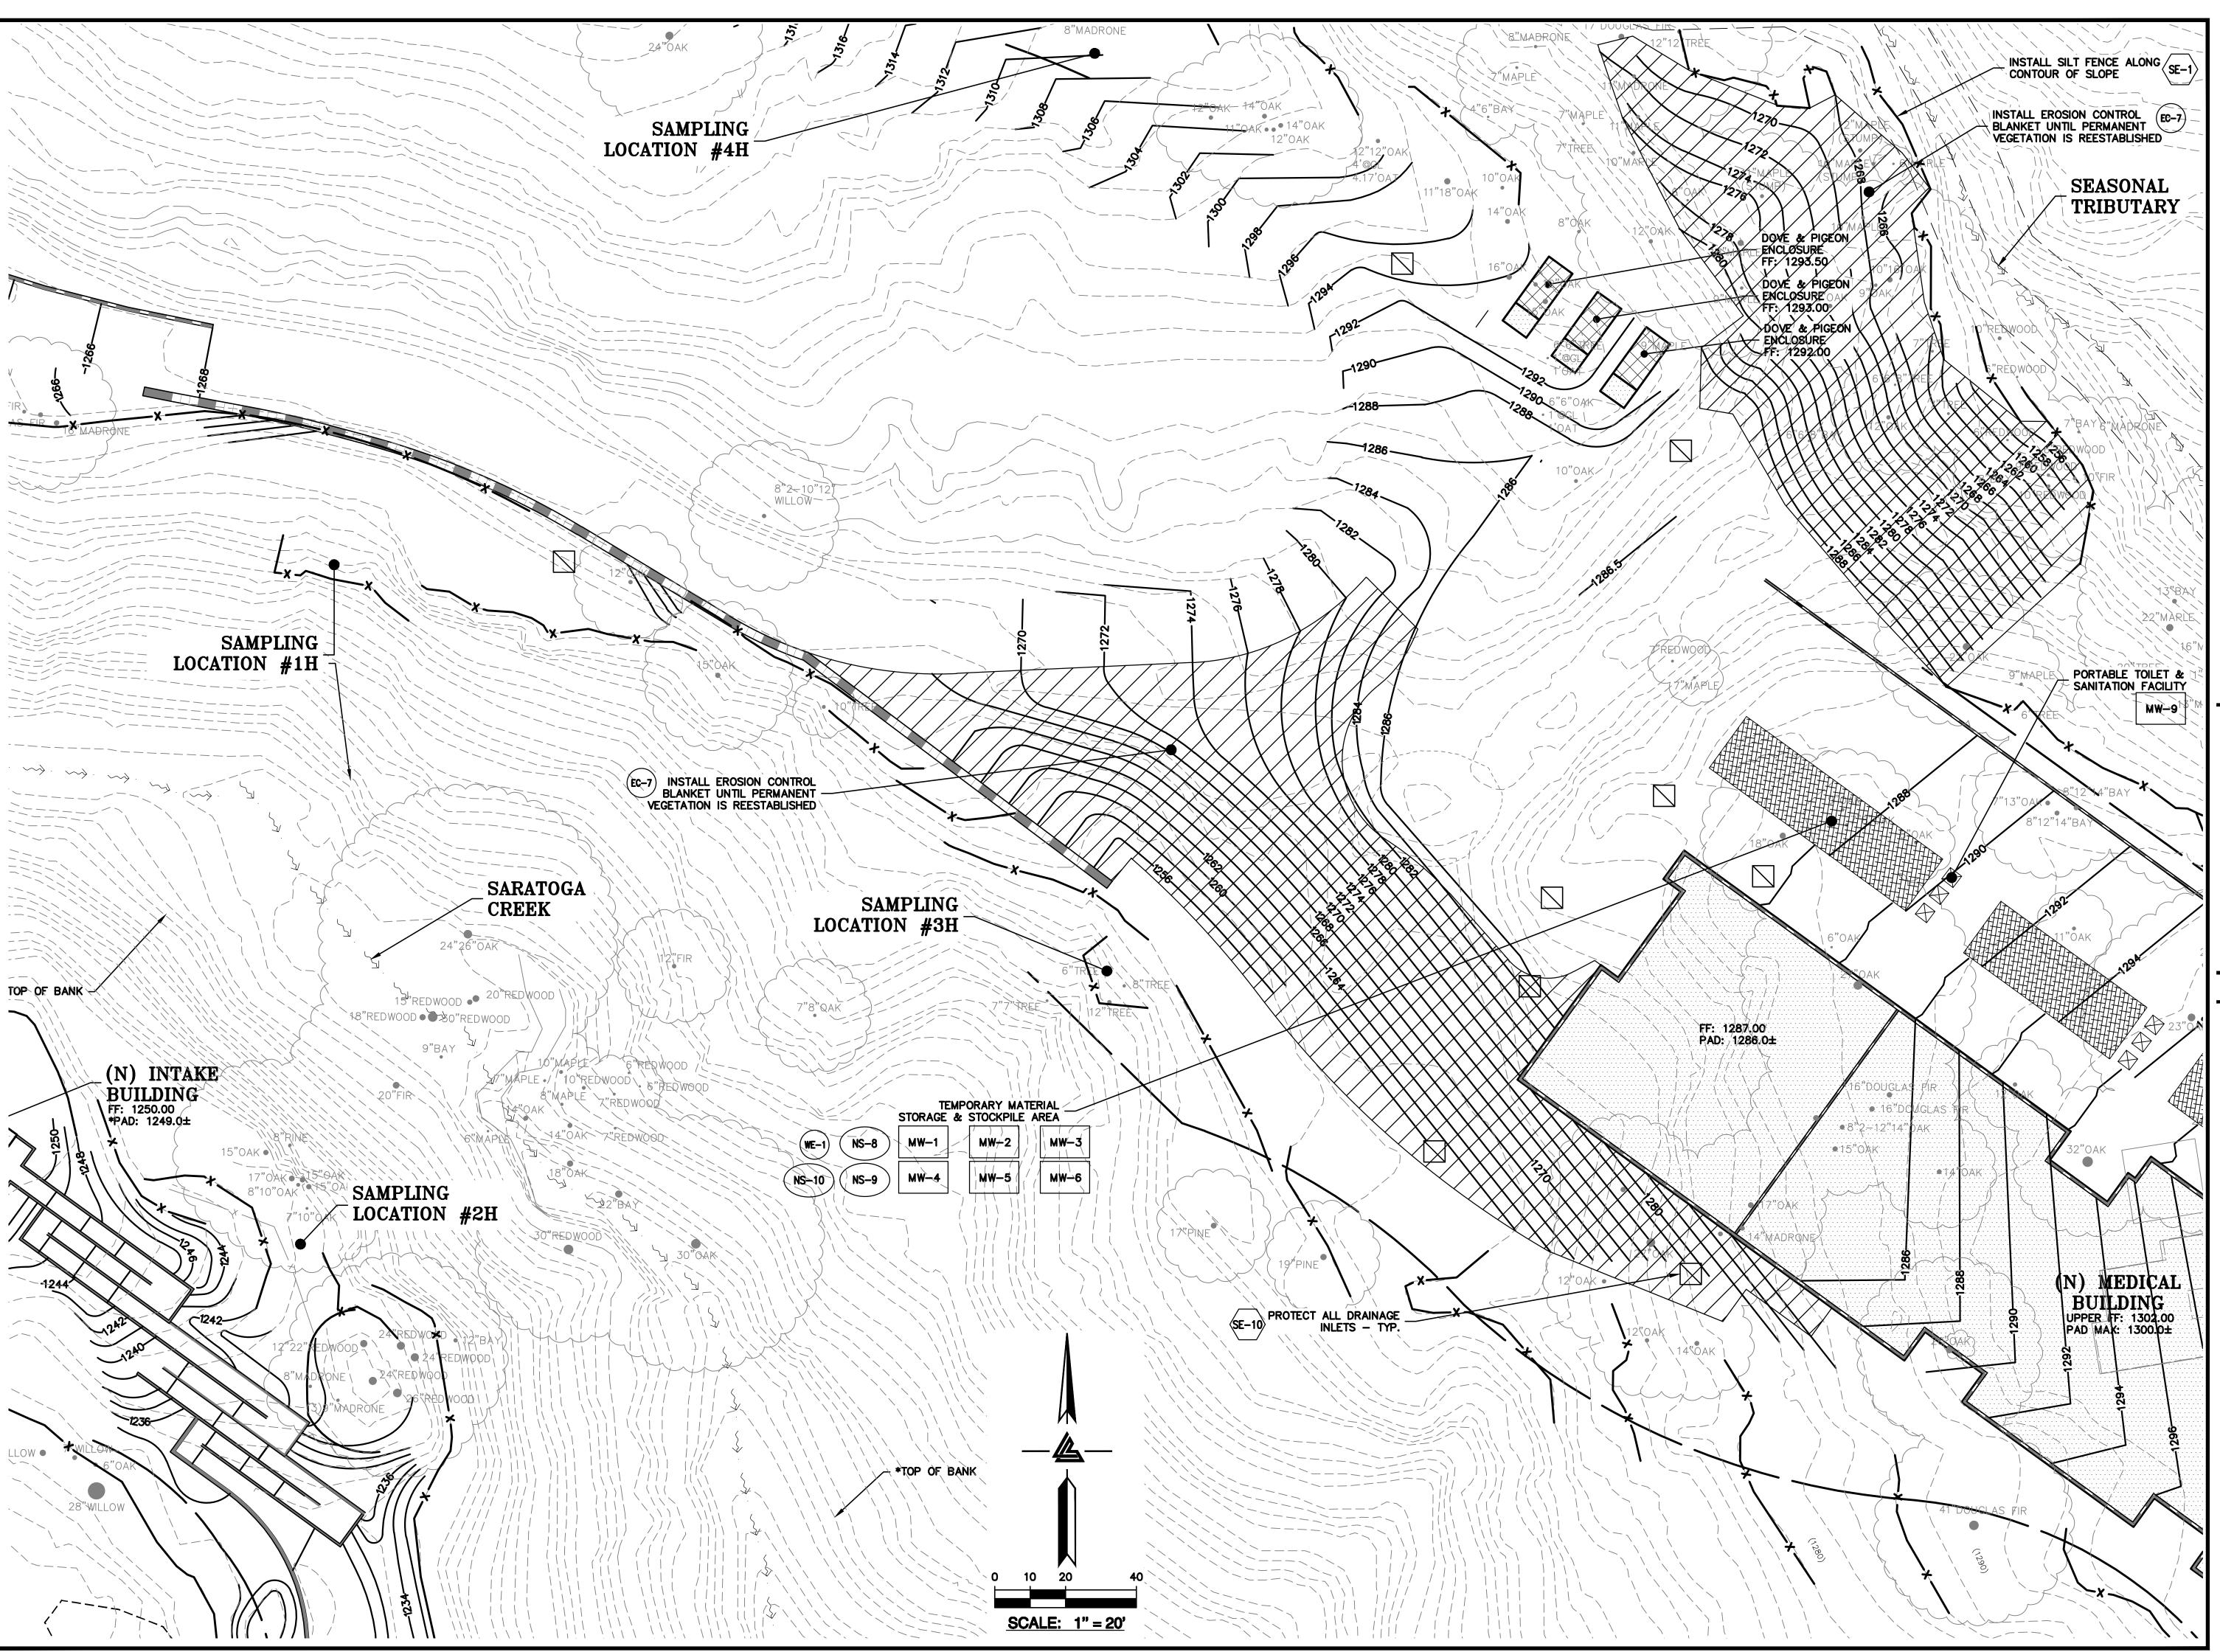
PC / JL 2130712 LB Job No.

SHEET NUMBER

C-9.19

ASA/USE PERMIT MODIFICATION #3 PLN-17-6943

PLOT: 2/16/2021 11:47:58 AM







ARCHITECTS



ISSUES AND REVISIONS

09-06-18 GRADING PERMIT PLAN CHECK 4

12-21-18 PERMIT RESUBMITTAL PERMIT MODIFICATION 03-26-19 PLAN CHECK 1 04-11-19 ASA DELTA 2 04-22-19 BID SET

05-22-19 UTILITY PLAN CHECK 1

09-20-19 CONSTRUCTION SET 1 01-28-20 PERMIT MODIFICATION 2 05-29-20 PLAN CHECK RESPONSE PERMIT MODIFICATION 2

07-22-20 UTILITY PLAN SUBMITTAL

SANTA CLARA COUNTY RECORD INFORMATION APPLICANT: PENINSULA HUMANE SOCIETY

ROAD: CONGRESS SPRINGS LDE FILE: 6943-17-17G GRADING PERMIT: DEV19-1838 UTILITY PERMIT: DEV19-0220

> PROJECT NUMBER 16011.00


SHEET TITLE PHASE 2 BMP PLAN BUILDING & UTILITIES

SCALE

1" = 20' PC / CA PC / JL 2130712

SHEET NUMBER

C-9.20

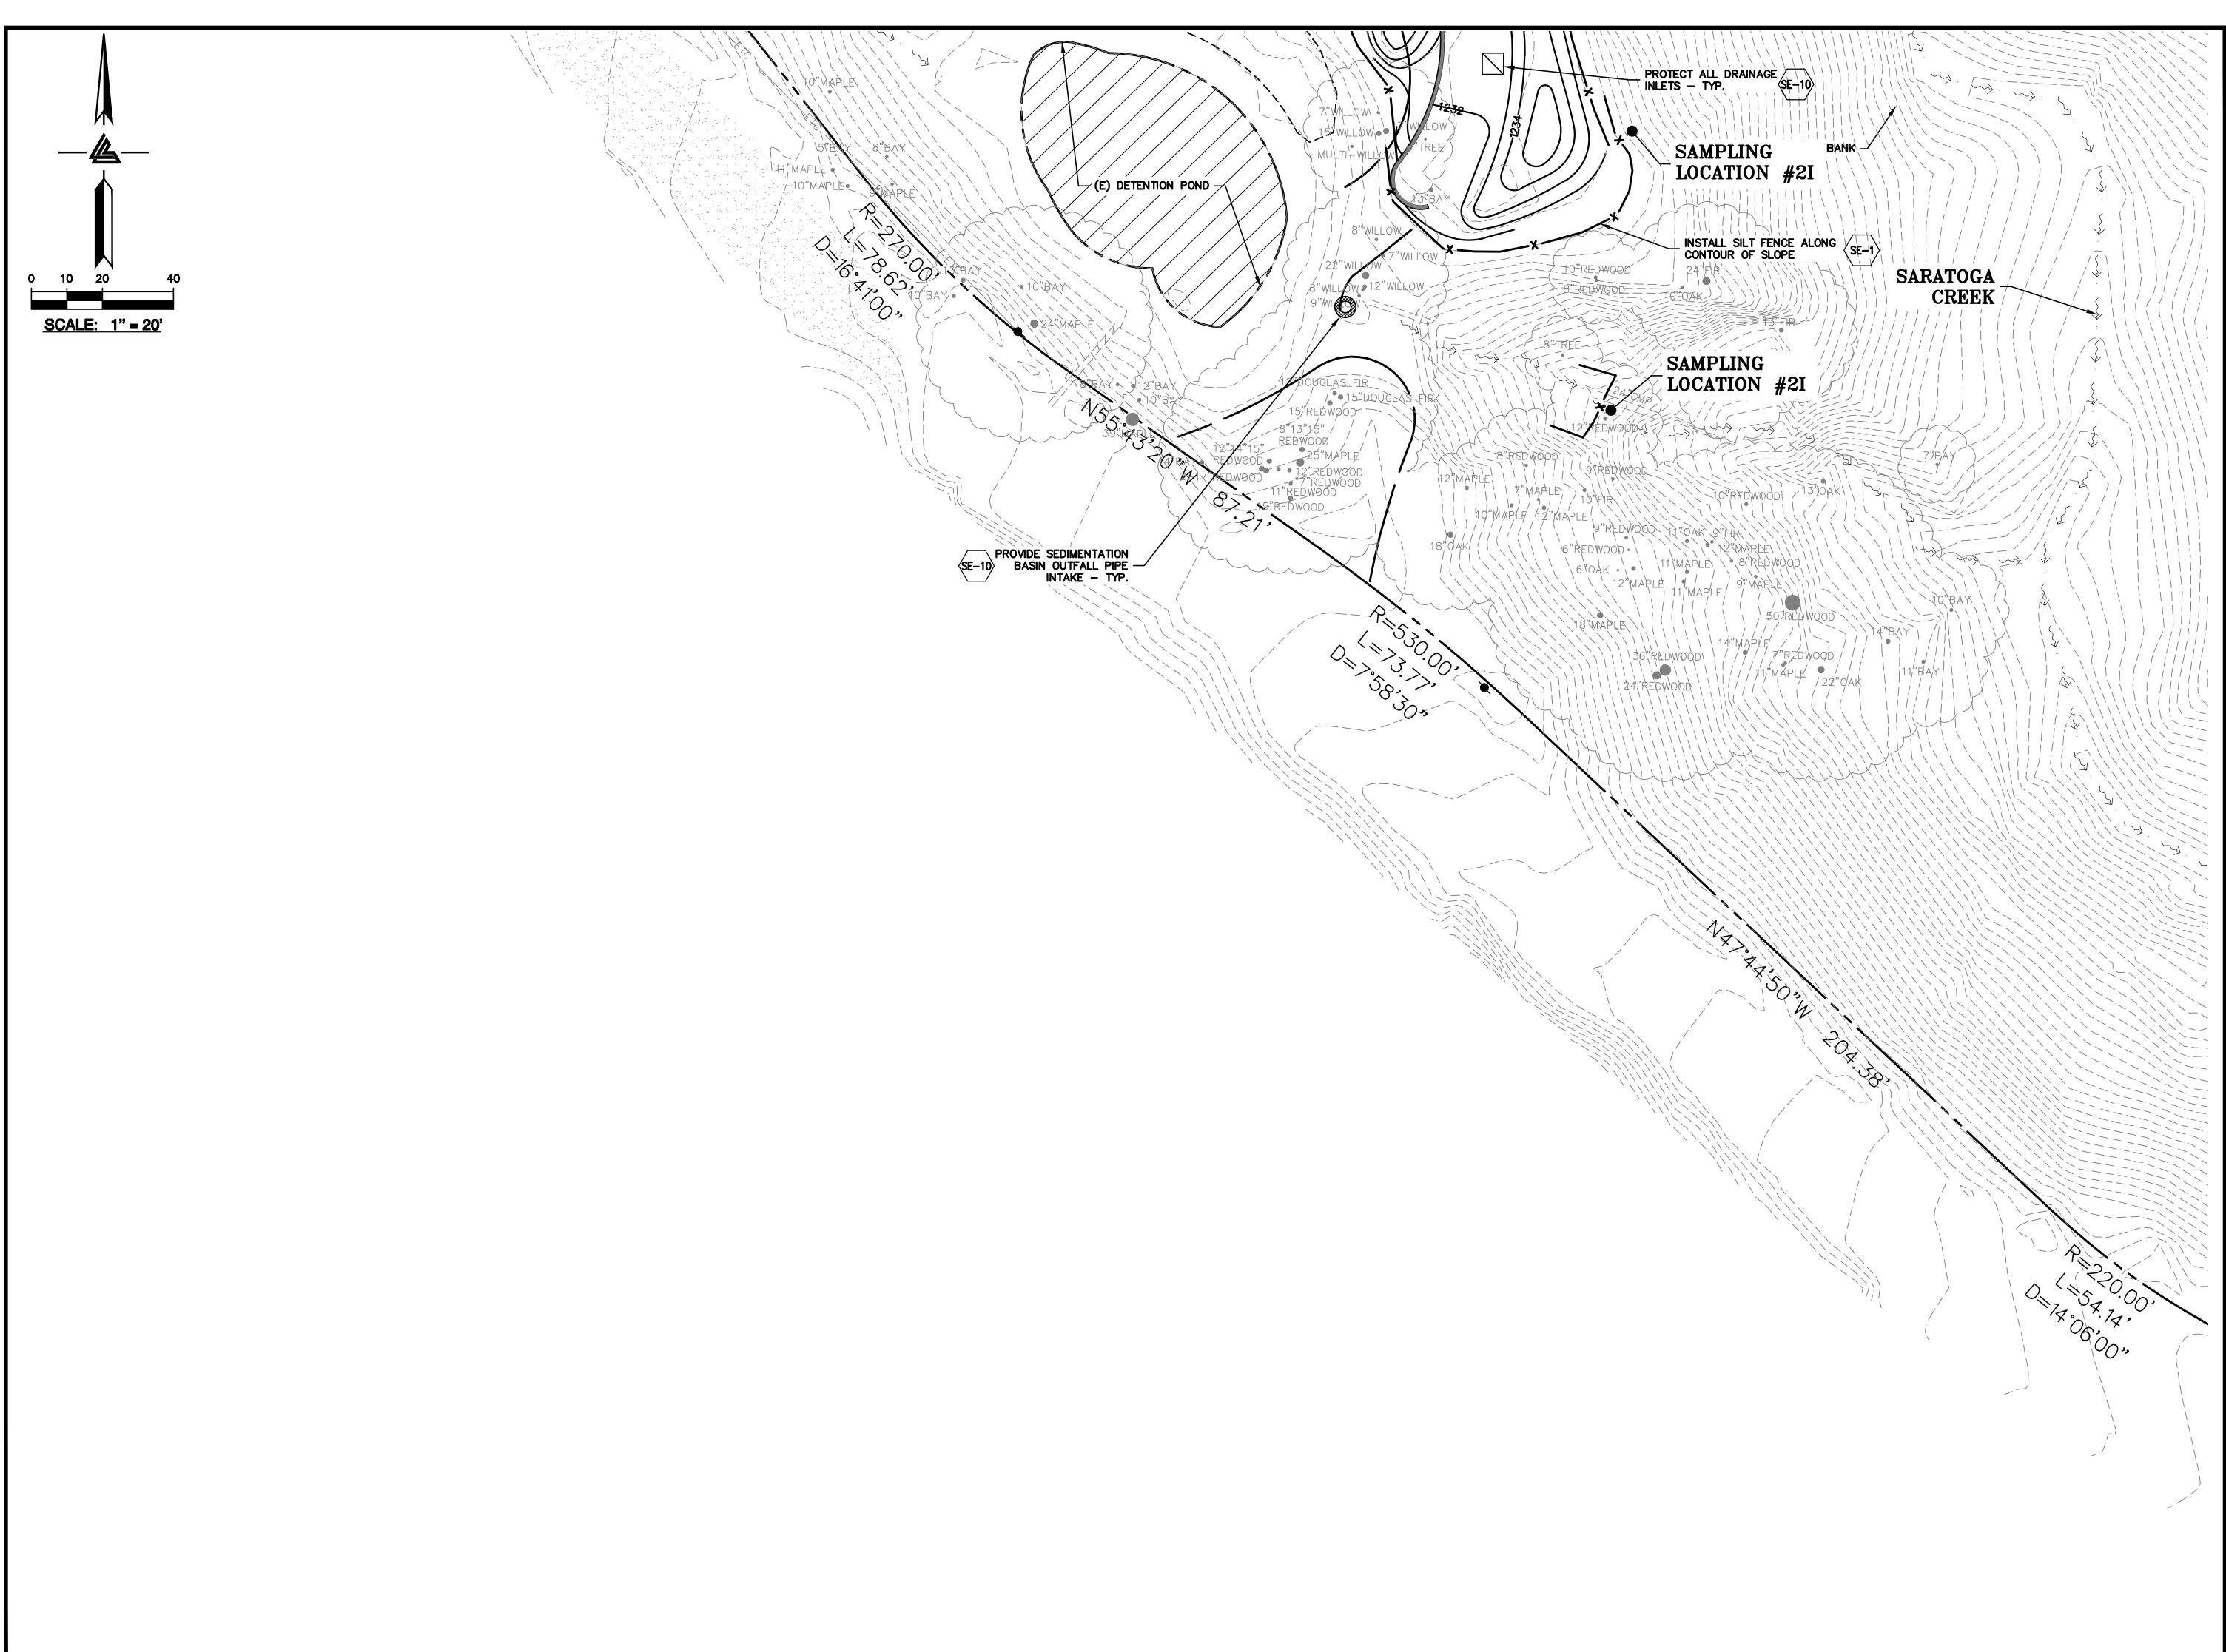

ELLISON CONSERVATION CENTER FOR WILDLIFE CARE





ARCHITECTS KORTH SUNSERI HAGEY



DATE DESCRIPTION

09-06-18 GRADING PERMIT PLAN CHECK 4

12-21-18 PERMIT RESUBMITTAL

03-26-19 PERMIT MODIFICATION

PLAN CHECK 1

04-11-19 ASA DELTA 2

04-22-19 BID SET

04-22-19 BID SET 05-10-19 BID SET ADDENDUM 1 05-22-19 UTILITY PLAN CHECK 1

05-22-19 UTILITY PLAN CHECK 08-06-19 PHASE 4 - PERMIT SUBMITTAL

09-20-19 CONSTRUCTION SET 1 01-28-20 PERMIT MODIFICATION 2 05-29-20 PLAN CHECK RESPONSE PERMIT MODIFICATION 2

07-22-20 UTILITY PLAN SUBMITTAL

SANTA CLARA COUNTY RECORD INFORMATION APPLICANT: PENINSULA HUMANE SOCIETY ROAD: CONGRESS SPRINGS

ROAD: CONGRESS SPRINGS LDE FILE: 6943-17-17G GRADING PERMIT: DEV19-1838 UTILITY PERMIT: DEV19-0220

> PROJECT NUMBER 16011.00

SHEET TITLE


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PHASE 2 BMP PLAN BUILDING & UTILITIES

SCALE 1" = 20'Designed By PC / CA
Checked By PC / JL
LB Job No. 2130712


SHEET NUMBER

C-9.21

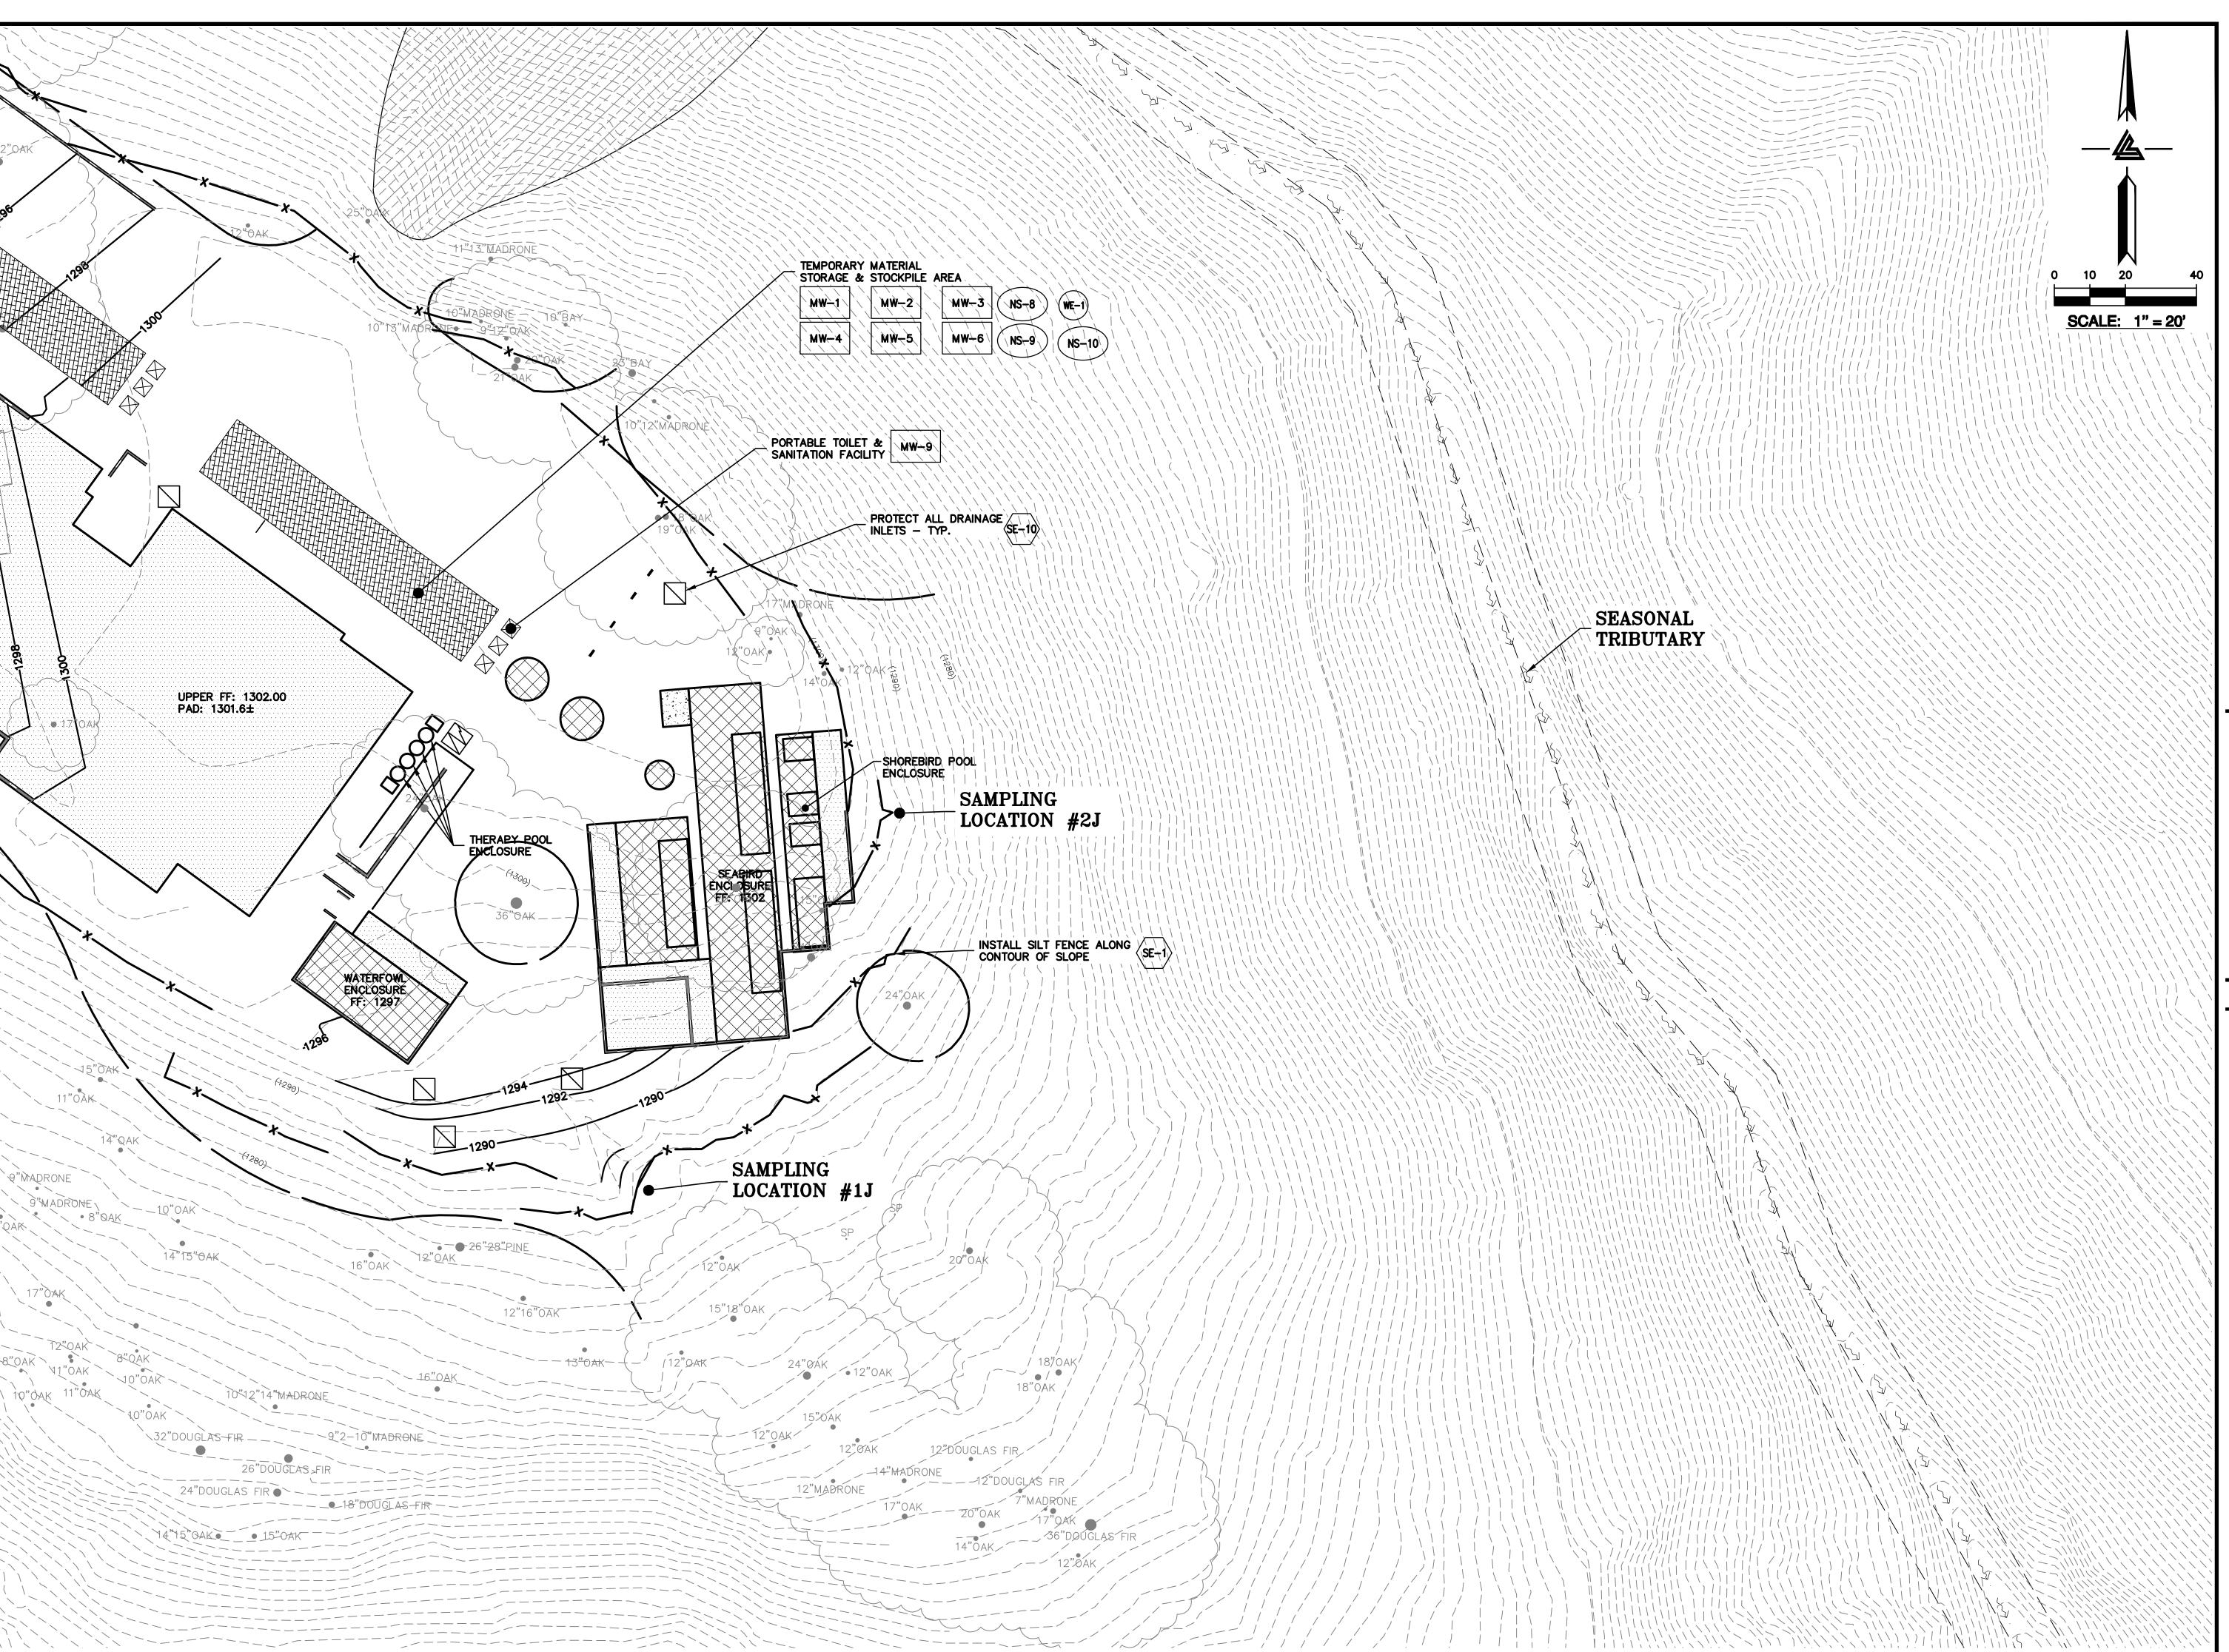

ELLISON CONSERVATION CENTER FOR WILDLIFE CARE



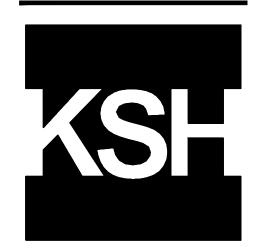

ARCHITECTS KORTH SUNSERI HAGEY

CIVIL ENGINEERS - LAND SURVEYORS
BAY AREA REGION
2495 INDUSTRIAL PKWY WEST
HAYWARD, CALIFORNIA 94545
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(P) (510) 887-3019
(F) (510) 887-3019
(F) (510) 887-3019
(F) (916)797-7363

ISSUES AND REVISIONS
ATE DESCRIPTION
GRADING PERM

09-06-18 GRADING PERMIT PLAN CHECK 4

12-21-18 PERMIT RESUBMITTAL PERMIT MODIFICATION PLAN CHECK 1

03-26-19 PLAN CHECK 1 04-11-19 ASA DELTA 2 04-22-19 BID SET 05-10-19 BID SET ADDENDUM 1

05-22-19 UTILITY PLAN CHECK 1 08-06-19 PHASE 4 - PERMIT SUBMITTAL

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01-28-20 PERMIT MODIFICATION 2
05-29-20 PLAN CHECK RESPONSE PERMIT MODIFICATION 2

07-22-20 UTILITY PLAN SUBMITTAL

SANTA CLARA COUNTY RECORD INFORMATION APPLICANT: PENINSULA HUMANE SOCIETY

ROAD: CONGRESS SPRINGS LDE FILE: 6943-17-17G GRADING PERMIT: DEV19-1838 UTILITY PERMIT: DEV19-0220

> PROJECT NUMBER 16011.00

PHASE 2 BMP PLAN BUILDING & UTILITIES


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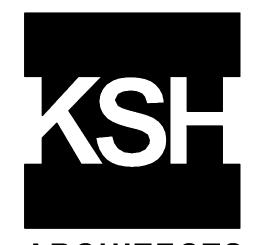
Designed By PC / CA
Checked By PC / JL
LB Job No. 2130712

SHEET NUMBER







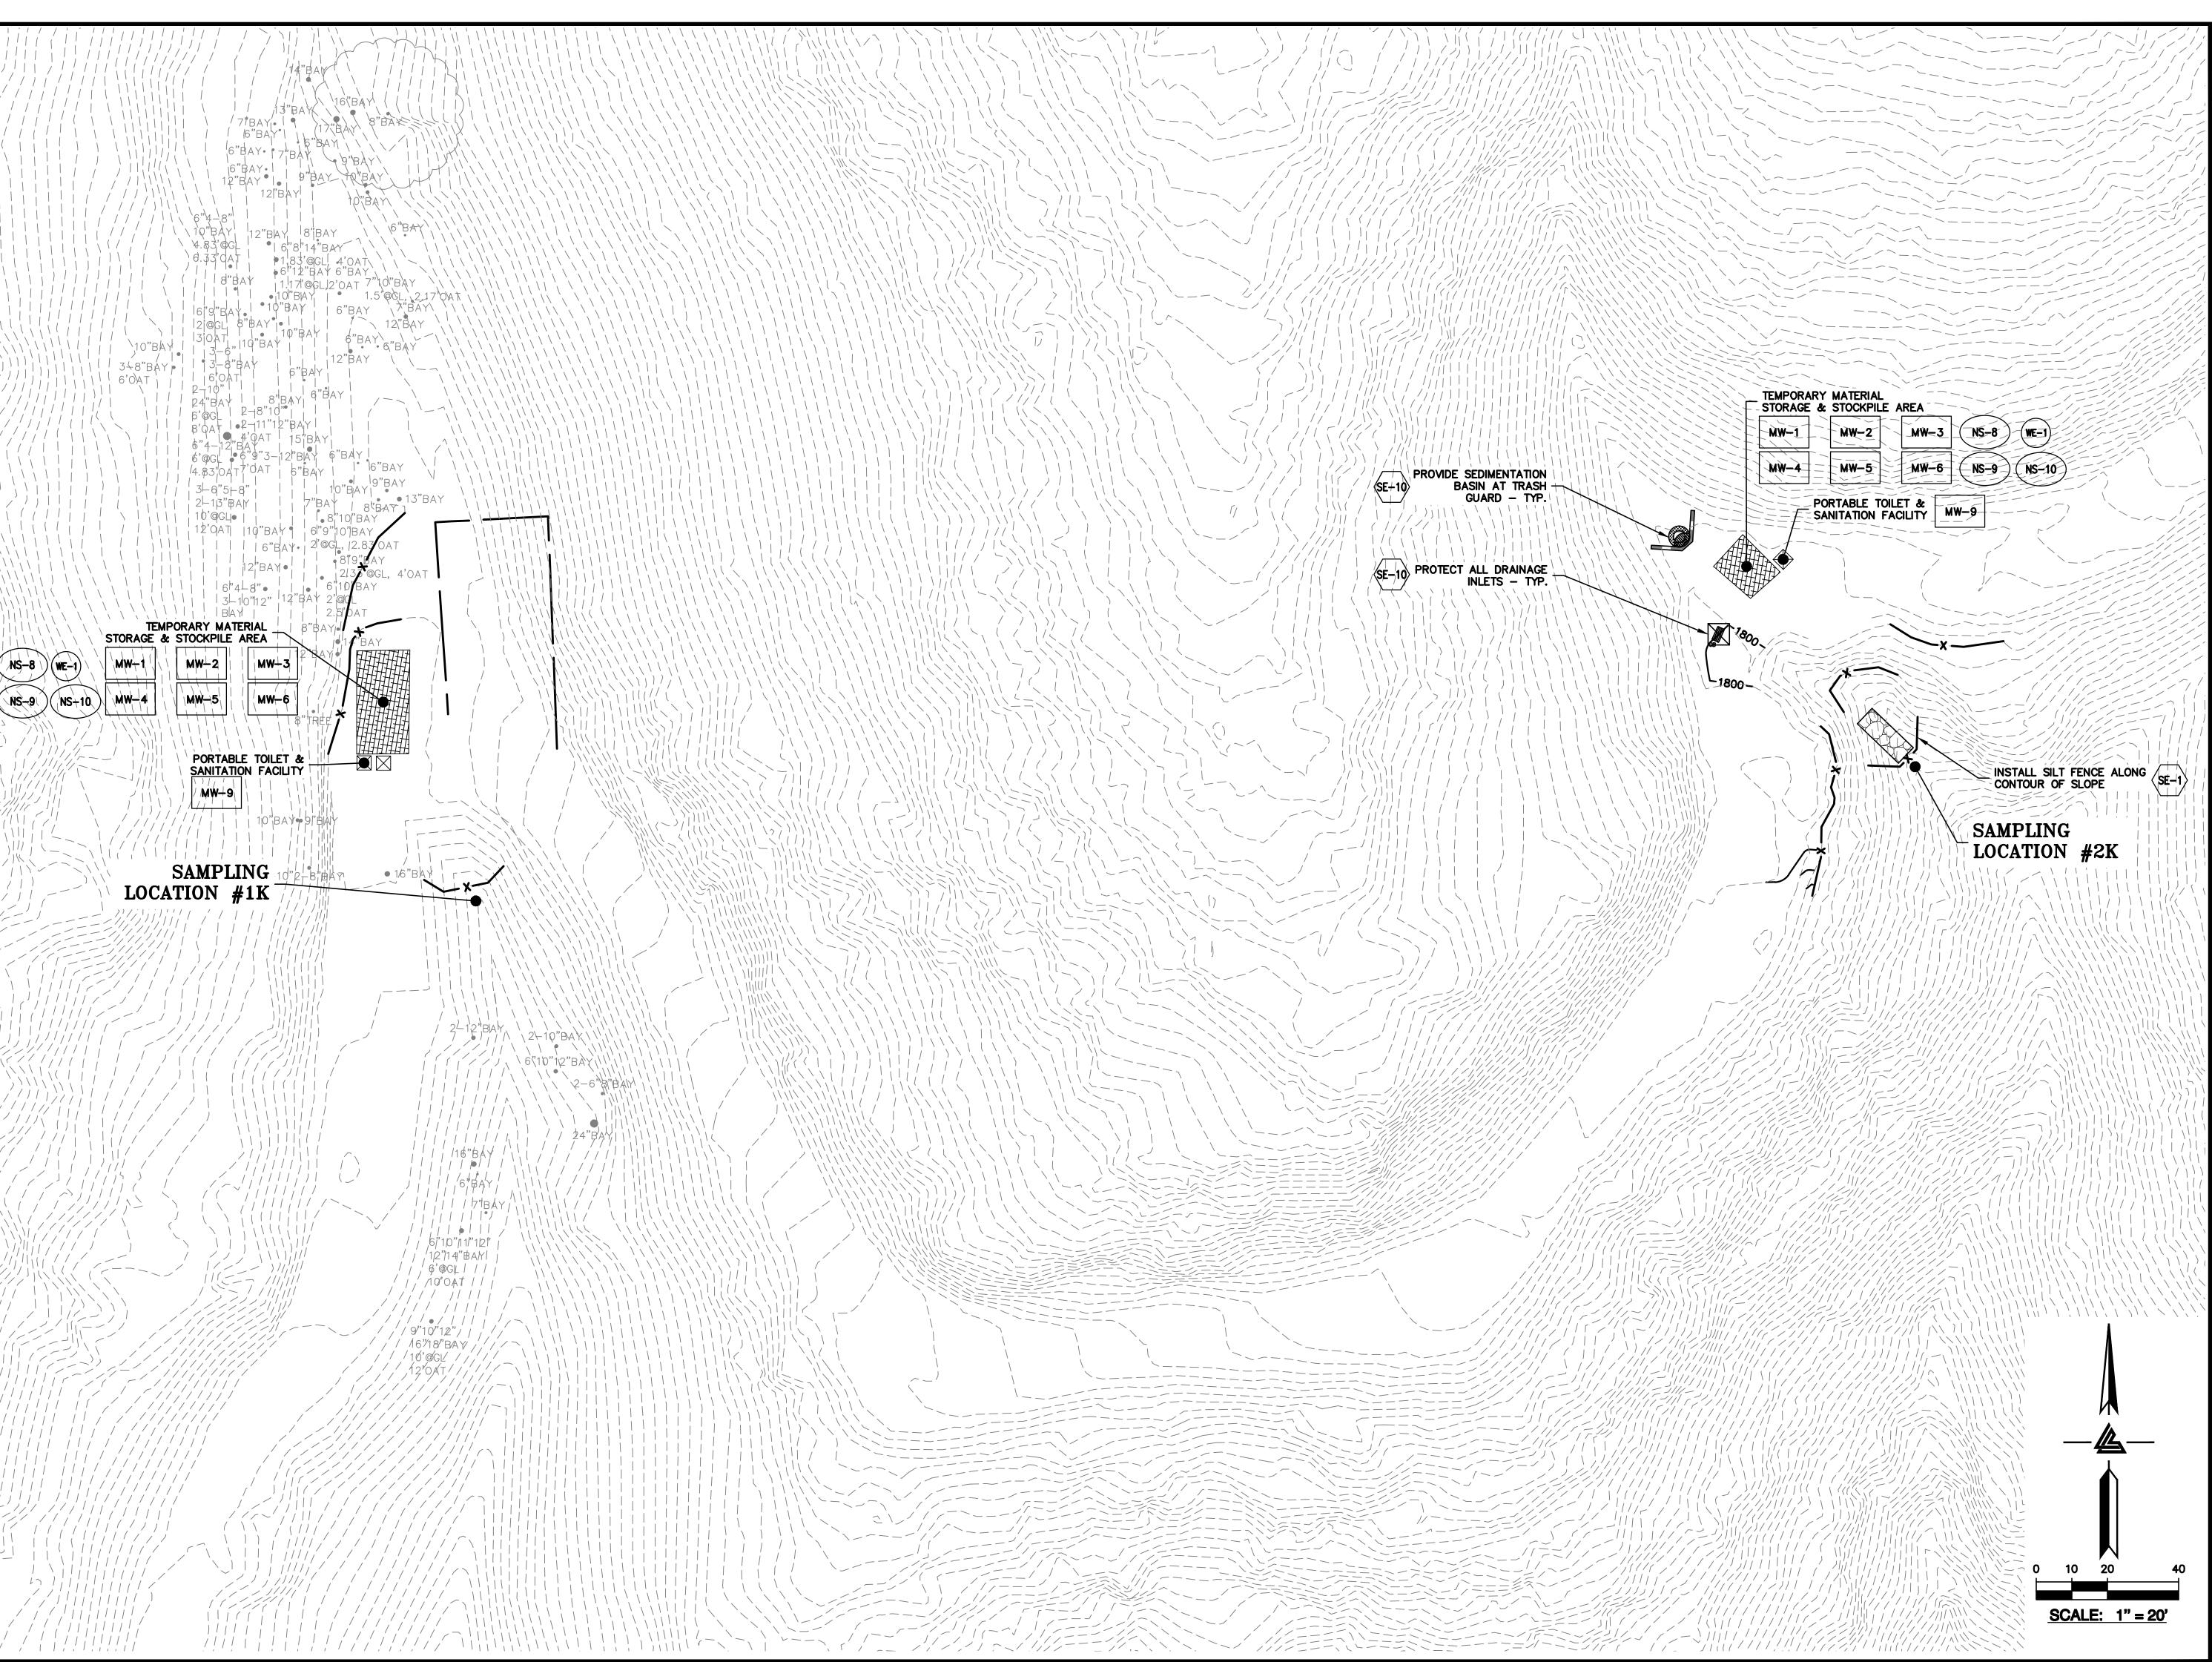

ARCHITECTS



ISSUES AND REVISIONS

09-06-18 GRADING PERMIT PLAN CHECK 4

12-21-18 PERMIT RESUBMITTAL 03-26-19 PERMIT MODIFICATION PLAN CHECK 1 04-11-19 ASA DELTA 2

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07-22-20 UTILITY PLAN SUBMITTAL

SANTA CLARA COUNTY **RECORD INFORMATION** APPLICANT: PENINSULA HUMANE SOCIETY

ROAD: CONGRESS SPRINGS LDE FILE: 6943-17-17G GRADING PERMIT: DEV19-1838

UTILITY PERMIT: DEV19-0220

PROJECT NUMBER

PHASE 2 BMP PLAN


BUILDING & UTILITIES

SCALE 1" = 20'PC / CA

PC / JL 2130712

SHEET NUMBER

C-9.23

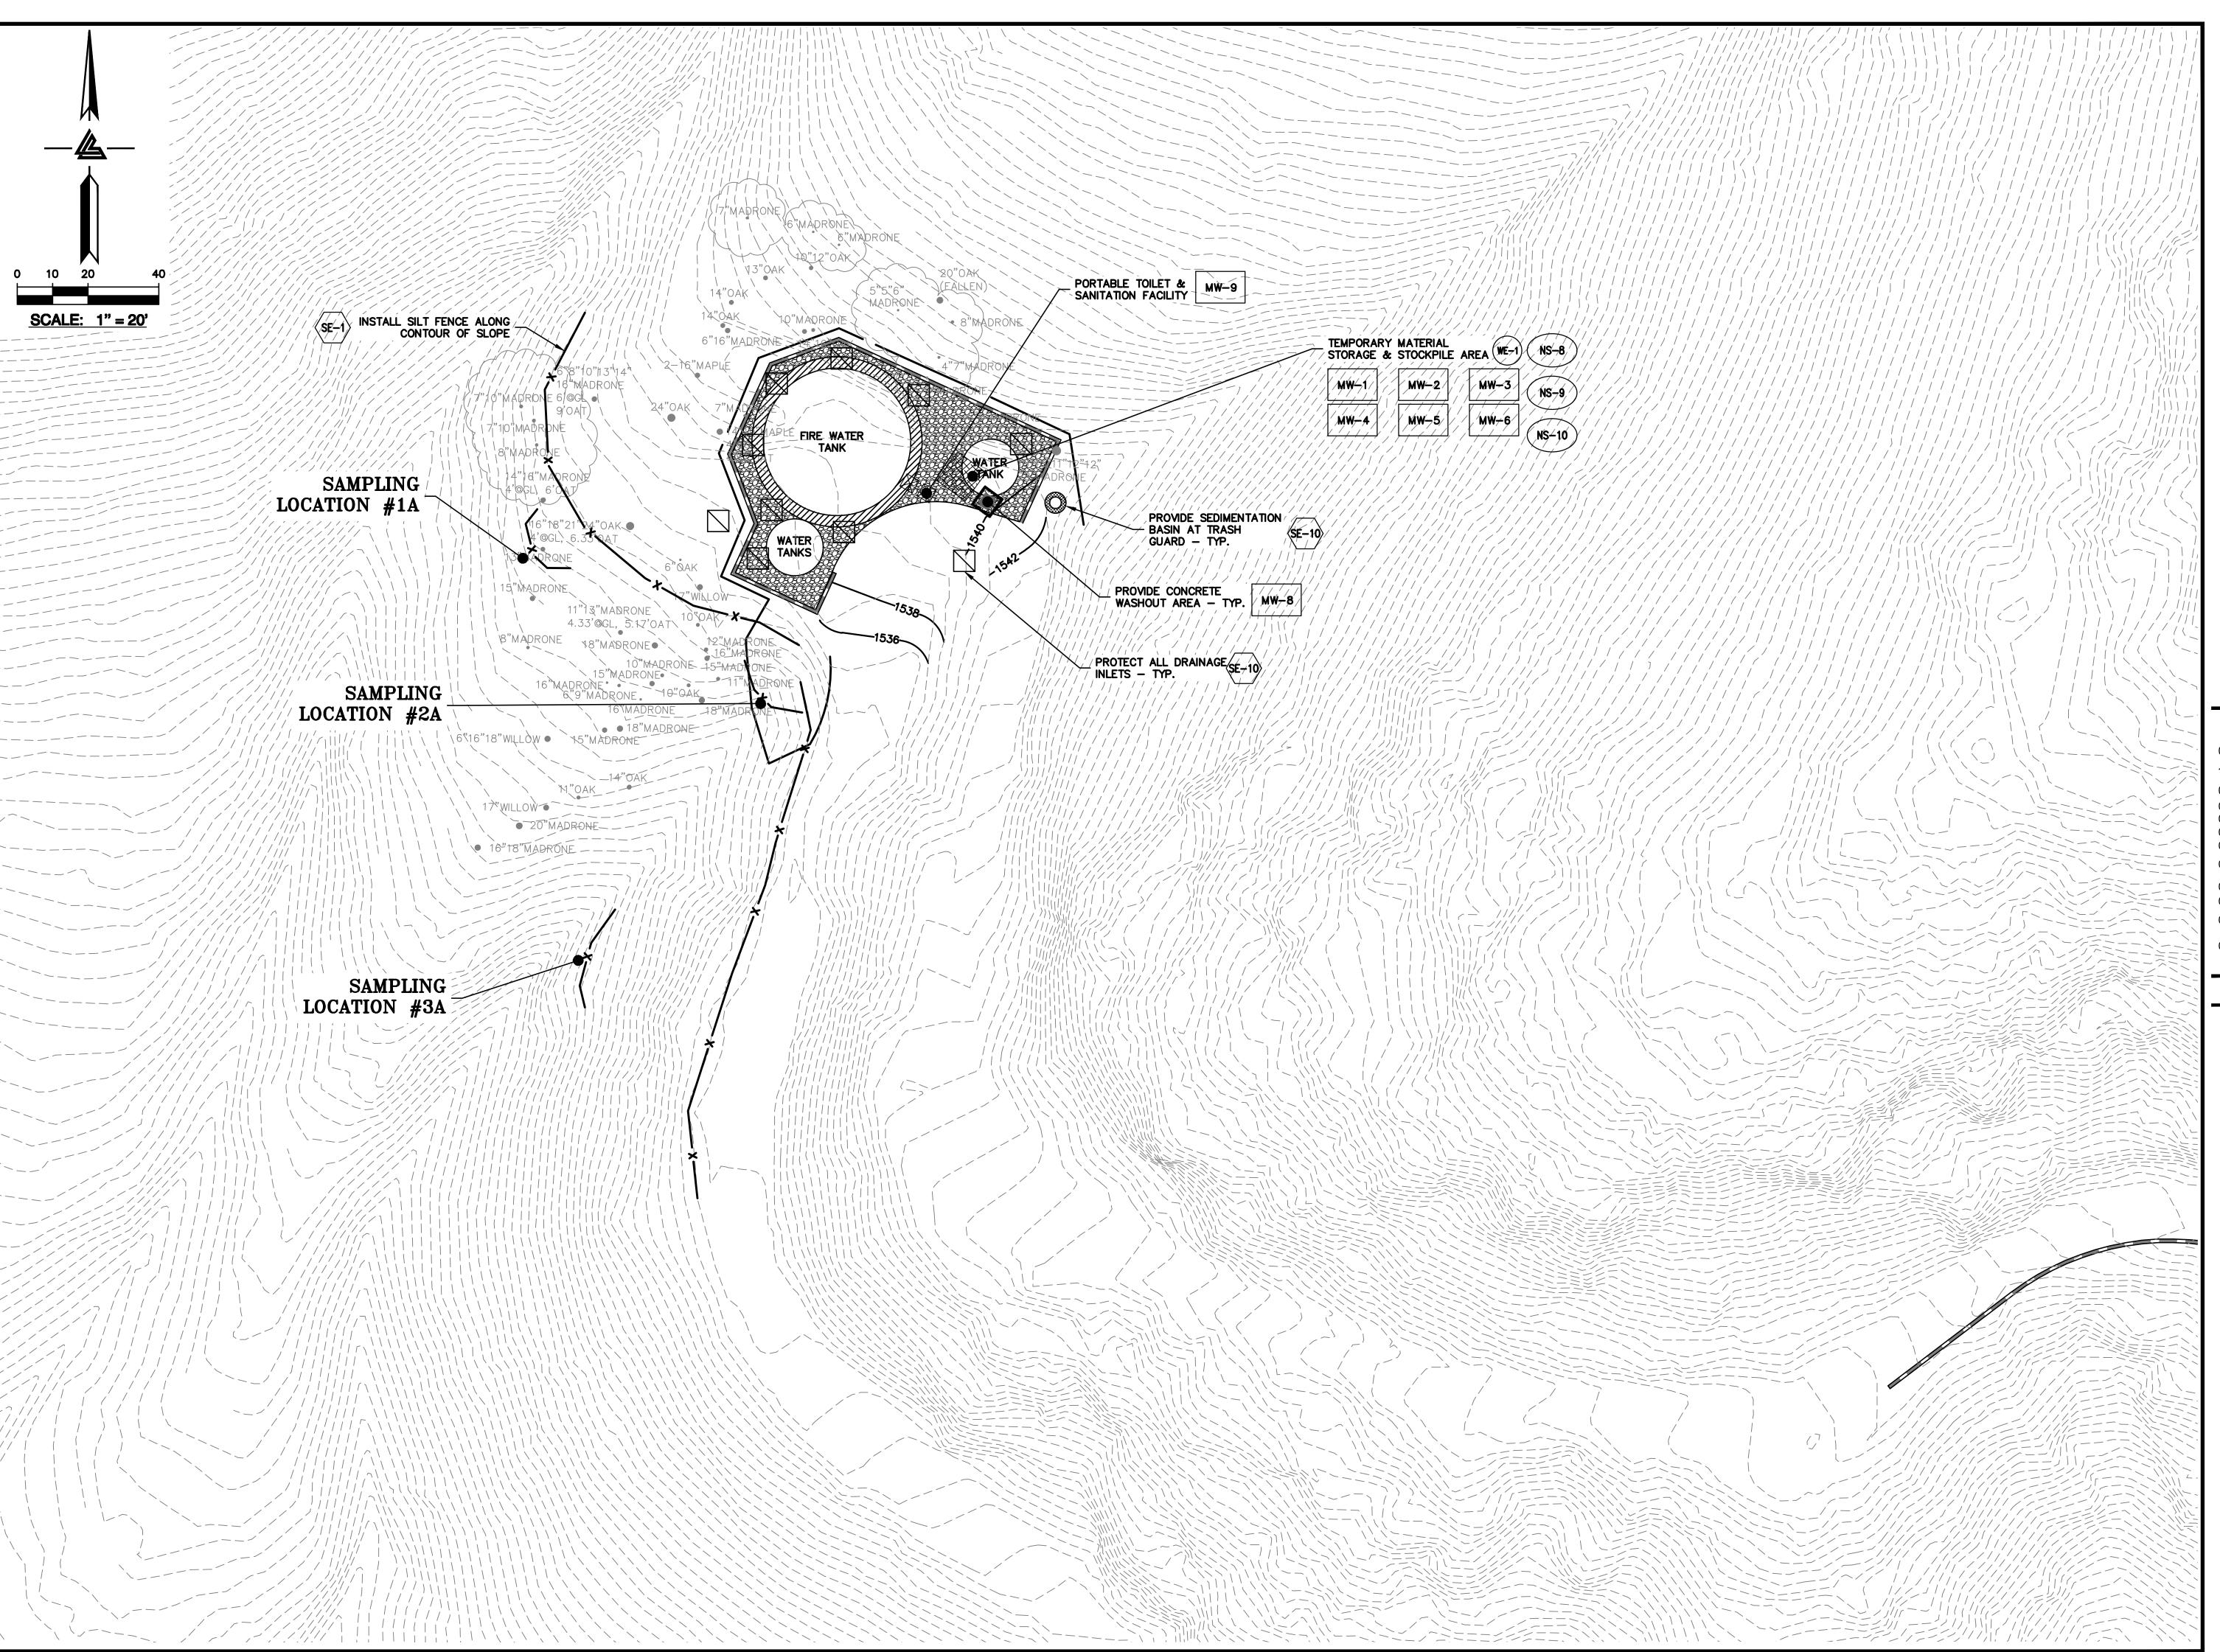

ELLISON CONSERVATION CENTER FOR WILDLIFE CARE SARATOGA, CA





ARCHITECTS KORTH SUNSERI HAGEY

ISSUES AND REVISIONS

12-21-18 PERMIT RESUBMITTAL

05-10-19 BID SET ADDENDUM 1 05-22-19 UTILITY PLAN CHECK 1 08-06-19 PHASE 4 - PERMIT SUBMITTAL

09-20-19 CONSTRUCTION SET 1 01-28-20 PERMIT MODIFICATION 2 05-29-20 PLAN CHECK RESPONSE PERMIT MODIFICATION 2

07-22-20 UTILITY PLAN SUBMITTAL

SANTA CLARA COUNTY RECORD INFORMATION APPLICANT: PENINSULA HUMANE SOCIETY

ROAD: CONGRESS SPRINGS LDE FILE: 6943-17-17G GRADING PERMIT: DEV19-1838 UTILITY PERMIT: DEV19-0220

PROJECT NUMBER


SHEET TITLE

PHASE 3 BMP PLAN PAVING & FINAL LANDSCAPE 1" = 20'

PC / CA PC / JL 2130712

SHEET NUMBER



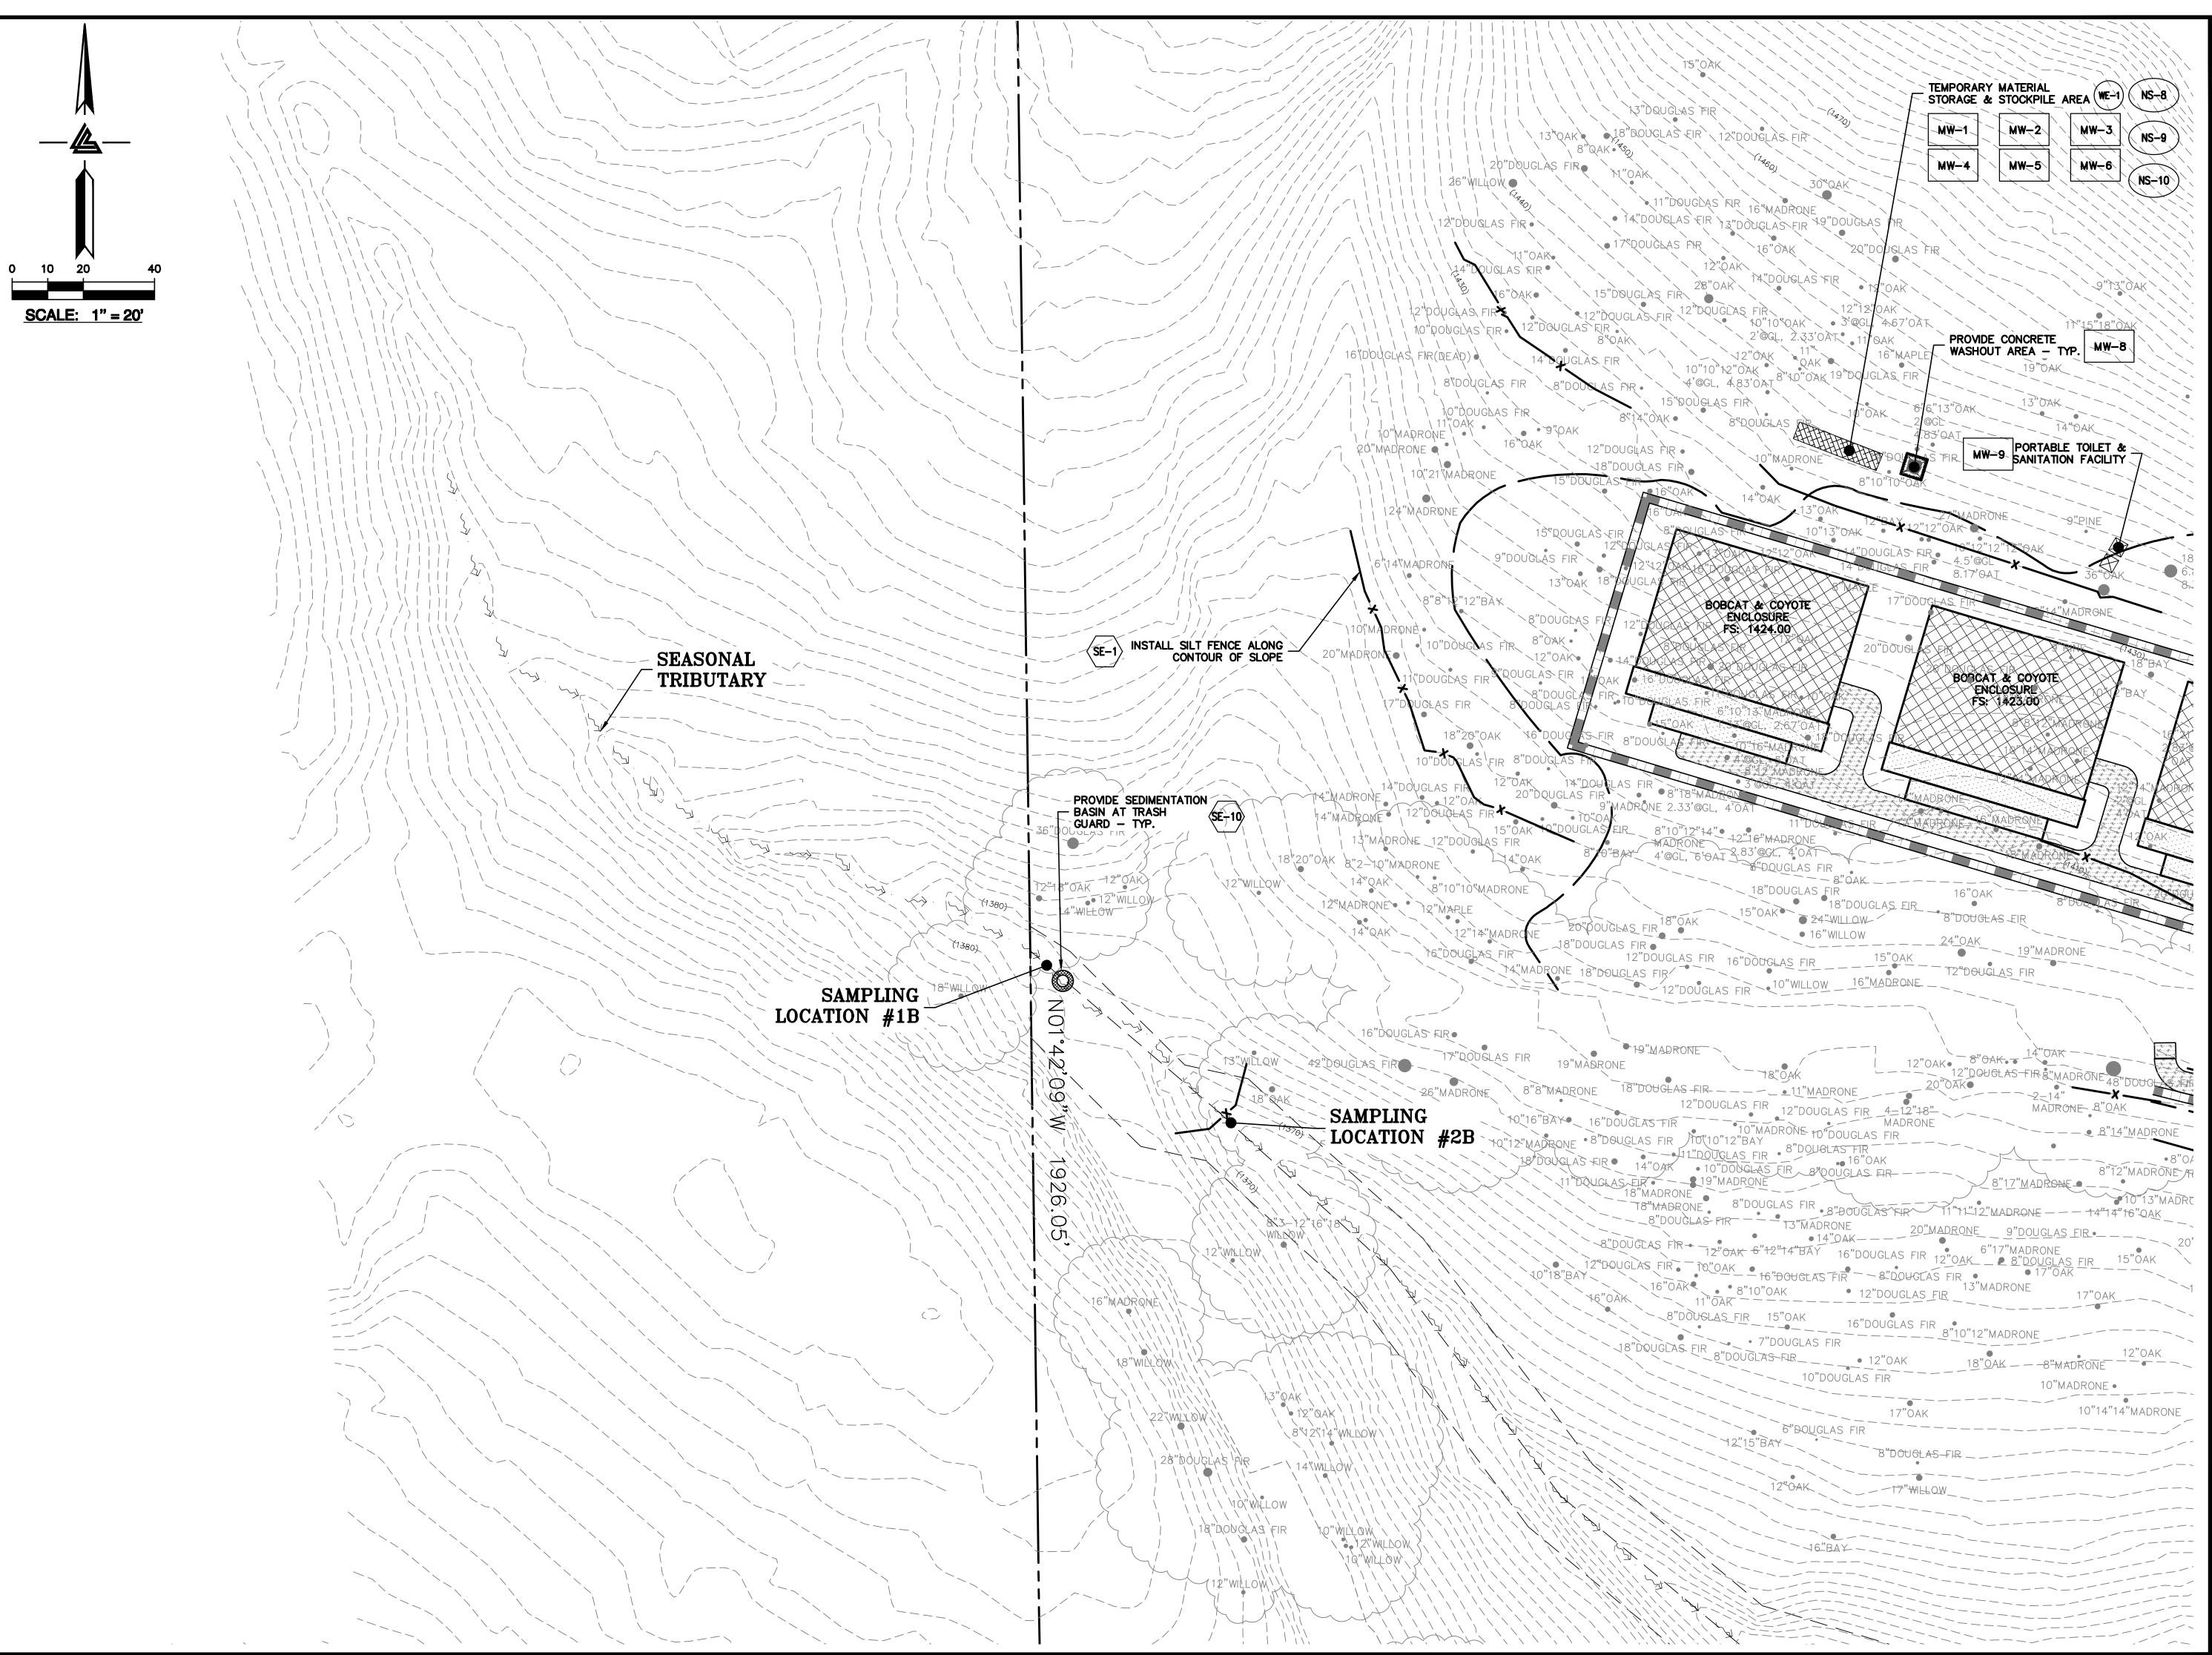

ELLISON CONSERVATION CENTER FOR WILDLIFE CARE





ARCHITECTS



ISSUES AND REVISIONS GRADING PERMIT 09-06-18 PLAN CHECK 4

12-21-18 PERMIT RESUBMITTAL PERMIT MODIFICATION 03-26-19 PLAN CHECK 1 04-11-19 ASA DELTA 2 04-22-19 BID SET

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09-20-19 CONSTRUCTION SET 1 01-28-20 PERMIT MODIFICATION 2 05-29-20 PLAN CHECK RESPONSE PERMIT MODIFICATION 2

07-22-20 UTILITY PLAN SUBMITTAL

GRADING PERMIT: DEV19-1838

UTILITY PERMIT: DEV19-0220

SANTA CLARA COUNTY **RECORD INFORMATION** APPLICANT: PENINSULA HUMANE SOCIETY ROAD: CONGRESS SPRINGS LDE FILE: 6943-17-17G

> PROJECT NUMBER 16011.00


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> SCALE 1" = 20'PC / CA PC / JL

> > 2130712

C-9.25

SHEET NUMBER



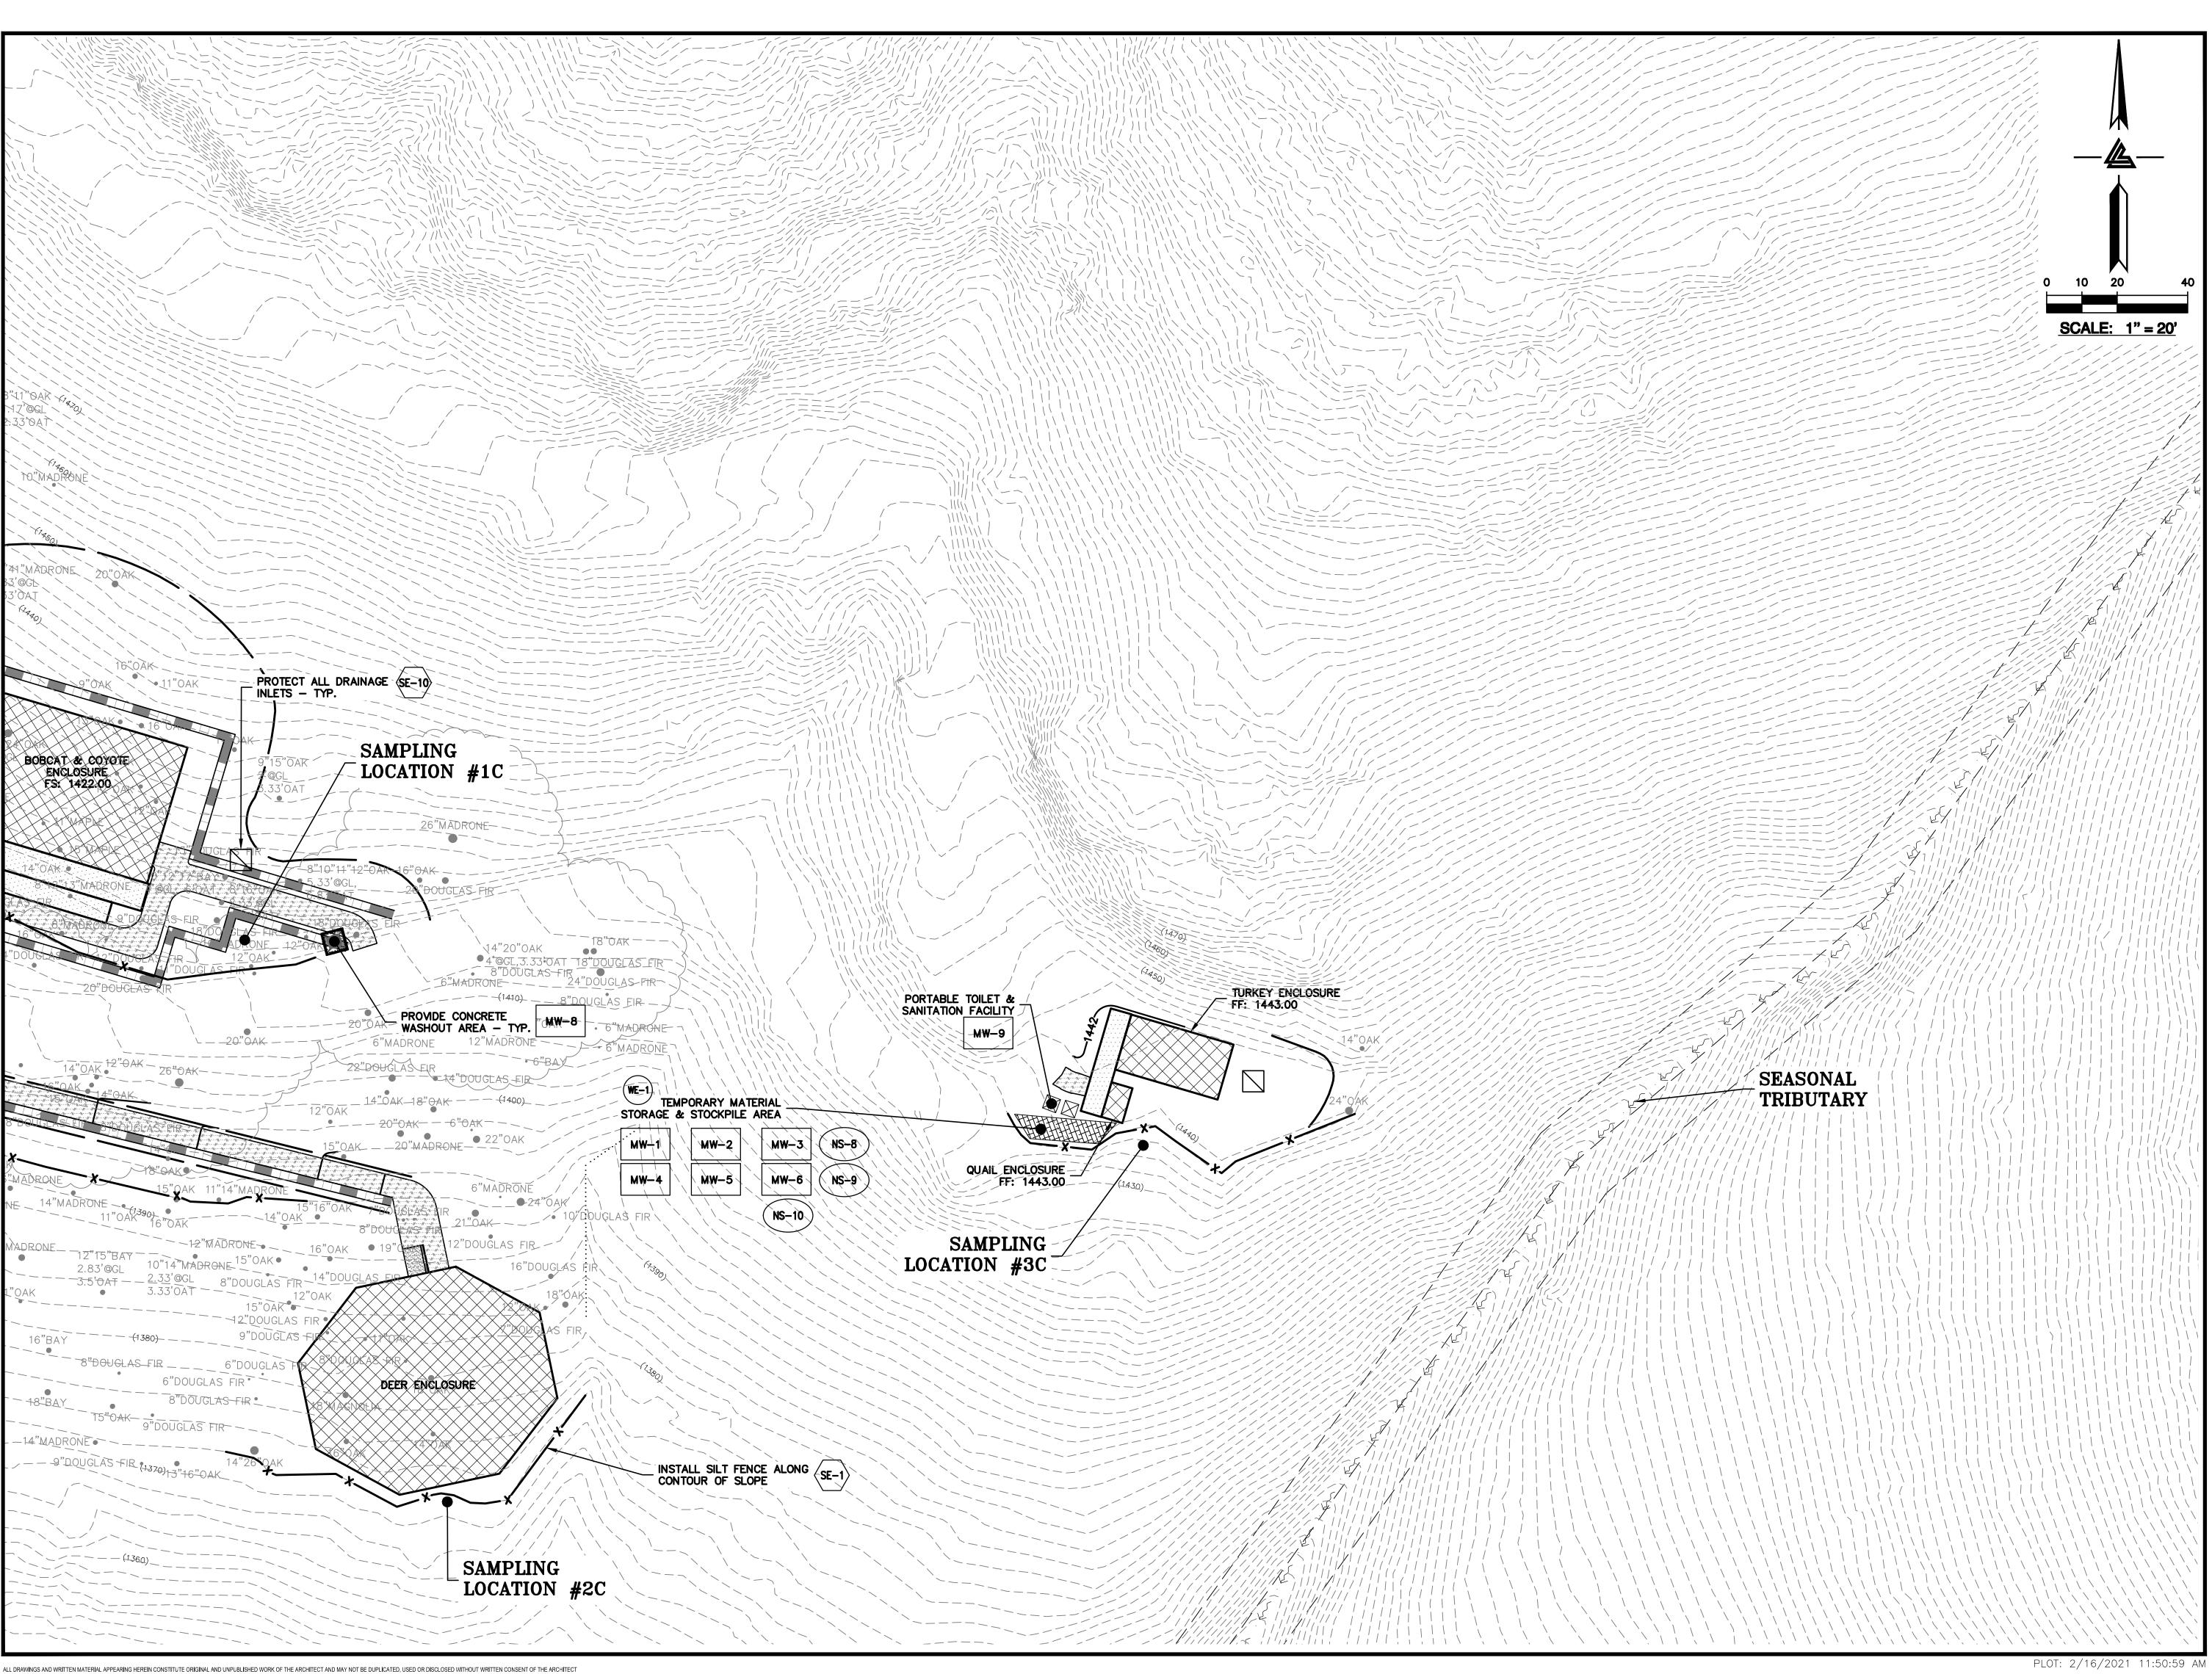



ARCHITECTS KORTH SUNSERI HAGEY

ISSUES AND REVISIONS

12-21-18 PERMIT RESUBMITTAL

05-22-19 UTILITY PLAN CHECK 1

08-06-19 PHASE 4 - PERMIT SUBMITTAL 09-20-19 CONSTRUCTION SET 1 01-28-20 PERMIT MODIFICATION 2 05-29-20 PLAN CHECK RESPONSE PERMIT MODIFICATION 2

07-22-20 UTILITY PLAN SUBMITTAL

UTILITY PERMIT: DEV19-0220

SANTA CLARA COUNTY RECORD INFORMATION APPLICANT: PENINSULA HUMANE SOCIETY ROAD: CONGRESS SPRINGS LDE FILE: 6943-17-17G GRADING PERMIT: DEV19-1838

> PROJECT NUMBER 16011.00


SHEET TITLE

PHASE 3 BMP PLAN PAVING & FINAL LANDSCAPE

SCALE 1" = 20'PC / CA PC / JL 2130712


SHEET NUMBER

C-9.26

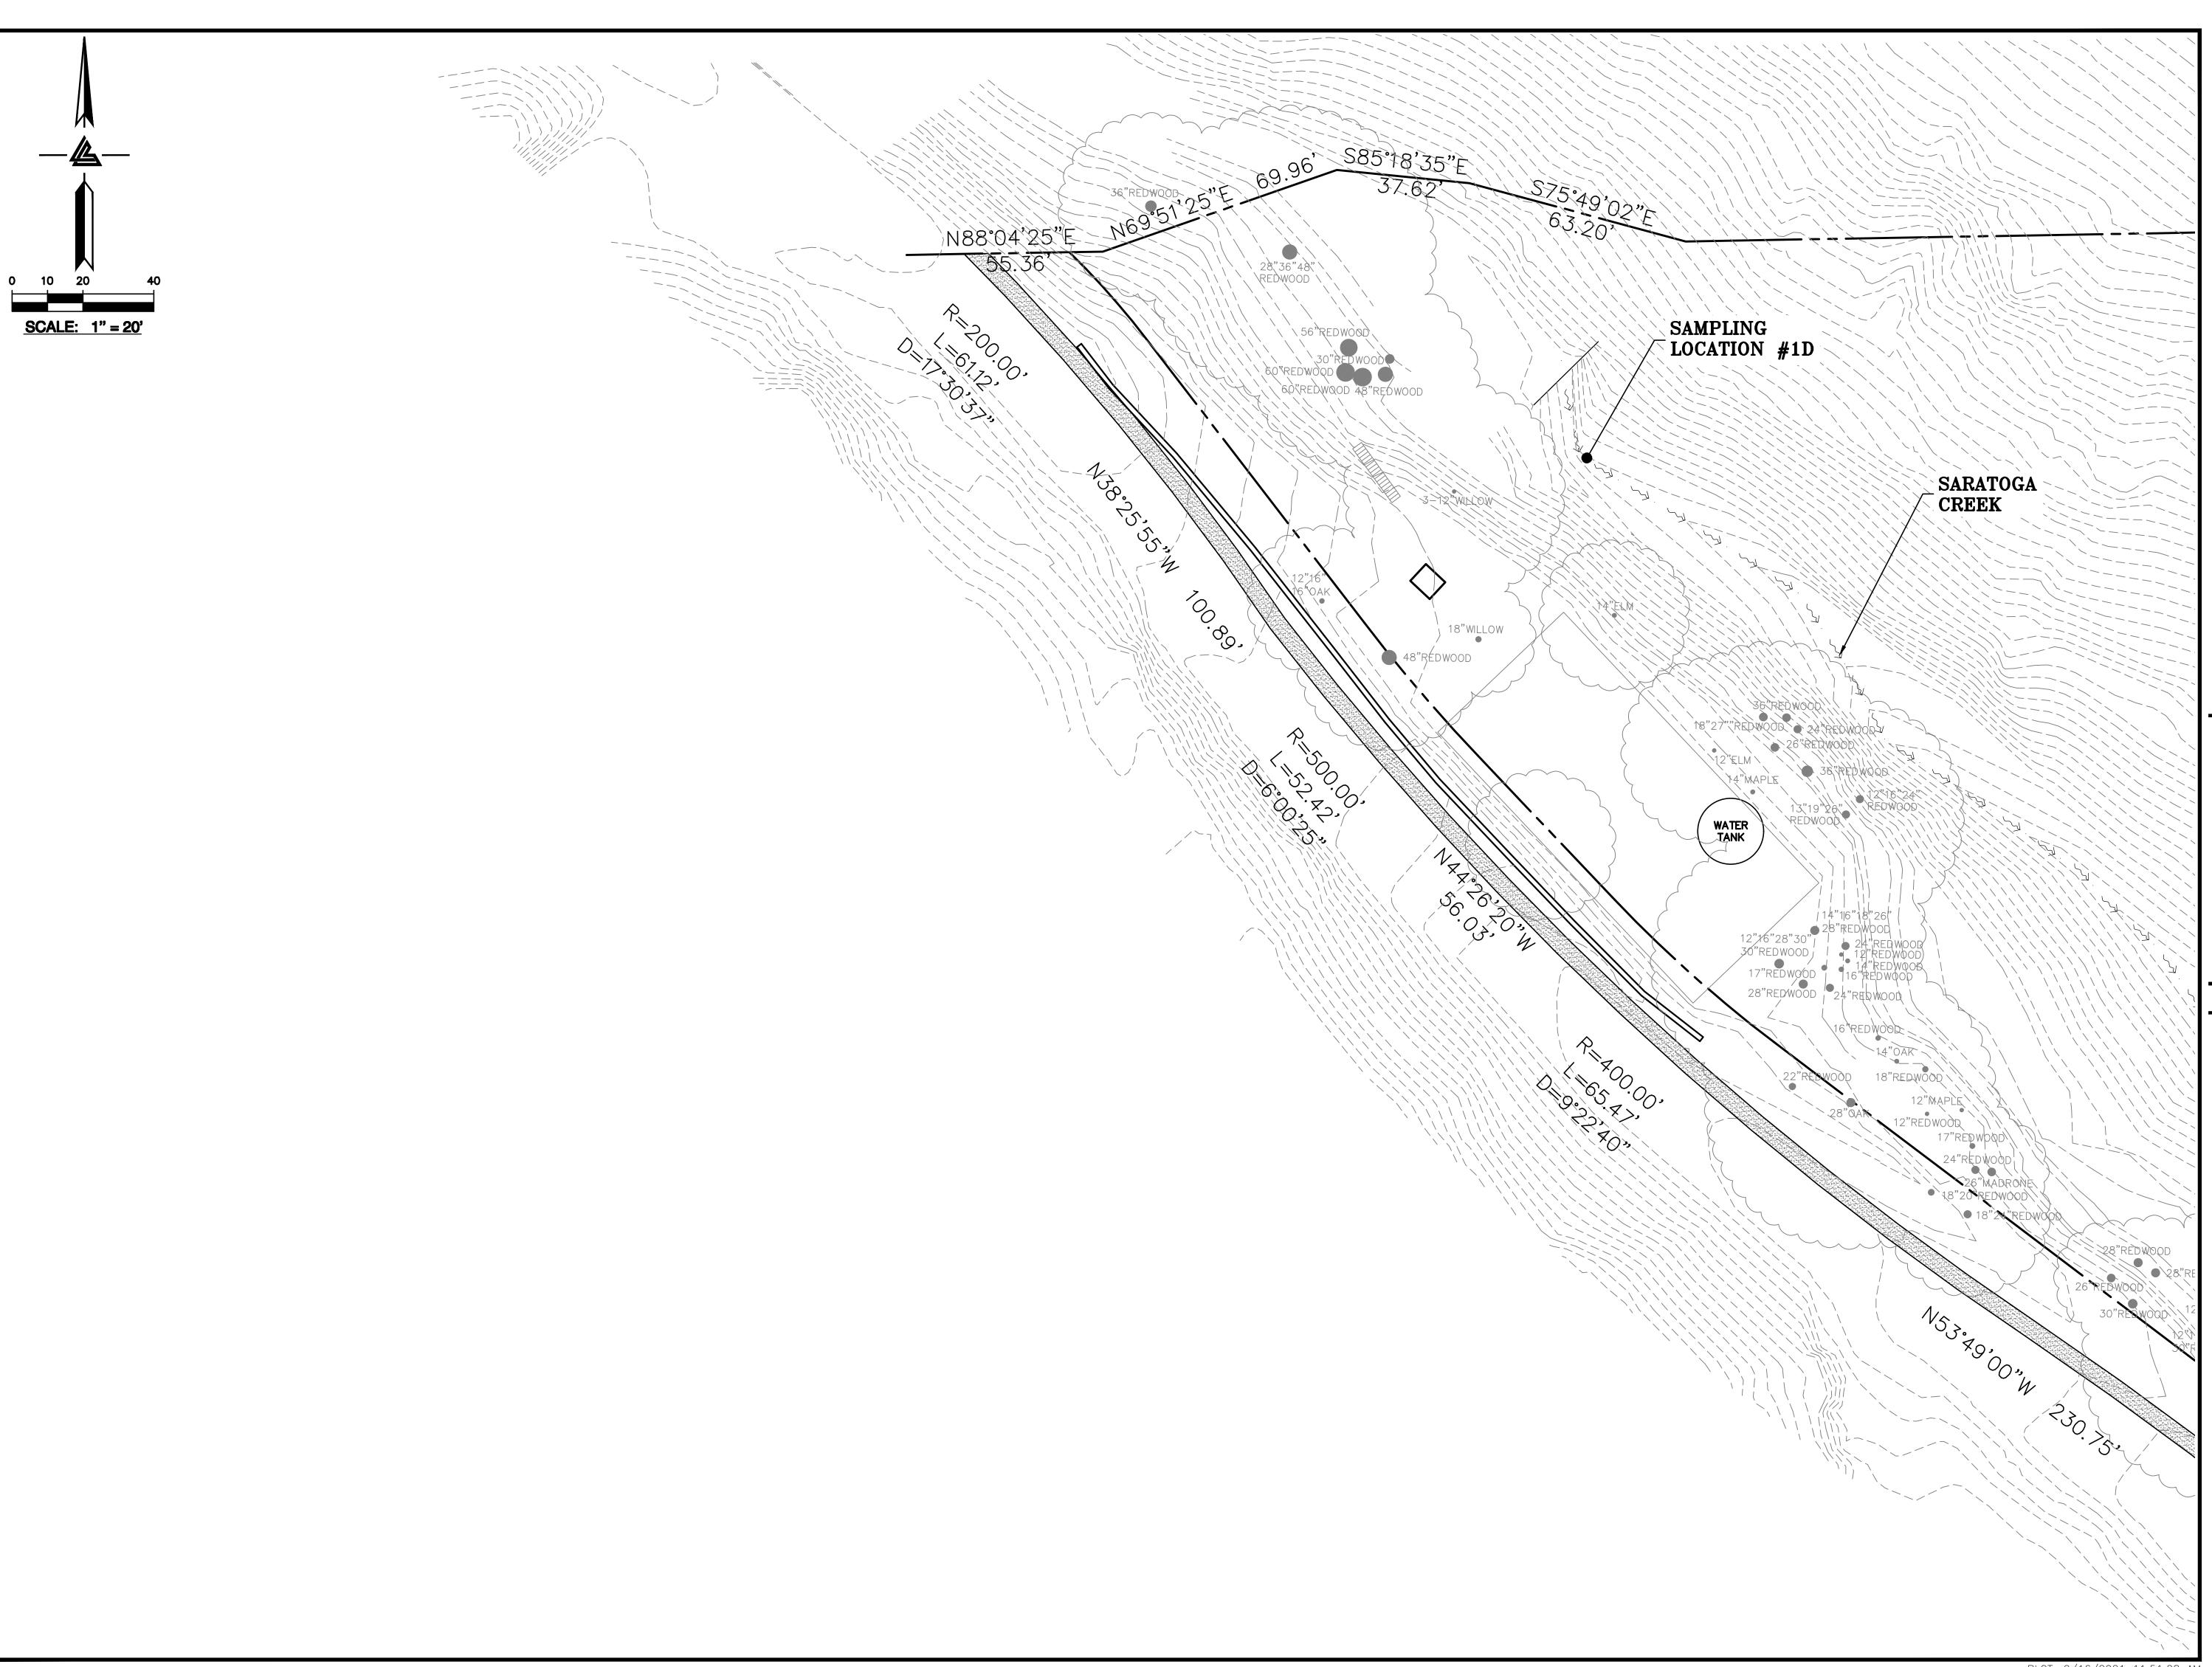

ELLISON CONSERVATION CENTER FOR WILDLIFE CARE SARATOGA, CA



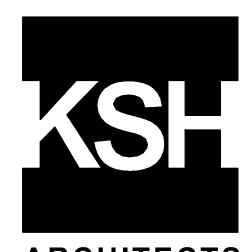

ARCHITECTS KORTH SUNSERI HAGEY



09-06-18 GRADING PERMIT PLAN CHECK 4 12-21-18 PERMIT RESUBMITTAL

03-26-19 PLAN CHECK 1

04-11-19 ASA DELTA 2

04-22-19 BID SET

05-10-19 BID SET ADDENDUM 1

05-22-19 UTILITY PLAN CHECK 1

08-06-19 PHASE 4 - PERMIT SUBMITTAL

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07-22-20 UTILITY PLAN SUBMITTAL

SANTA CLARA COUNTY RECORD INFORMATION

APPLICANT: PENINSULA HUMANE SOCIETY ROAD: CONGRESS SPRINGS LDE FILE: 6943-17-17G GRADING PERMIT: DEV19-1838

UTILITY PERMIT: DEV19-0220

PROJECT NUMBER 16011.00

SHEET TITLE


PHASE 3 BMP PLAN PAVING & FINAL LANDSCAPE

> SCALE 1" = 20'

PC / CA PC / JL 2130712

SHEET NUMBER

C-9.27

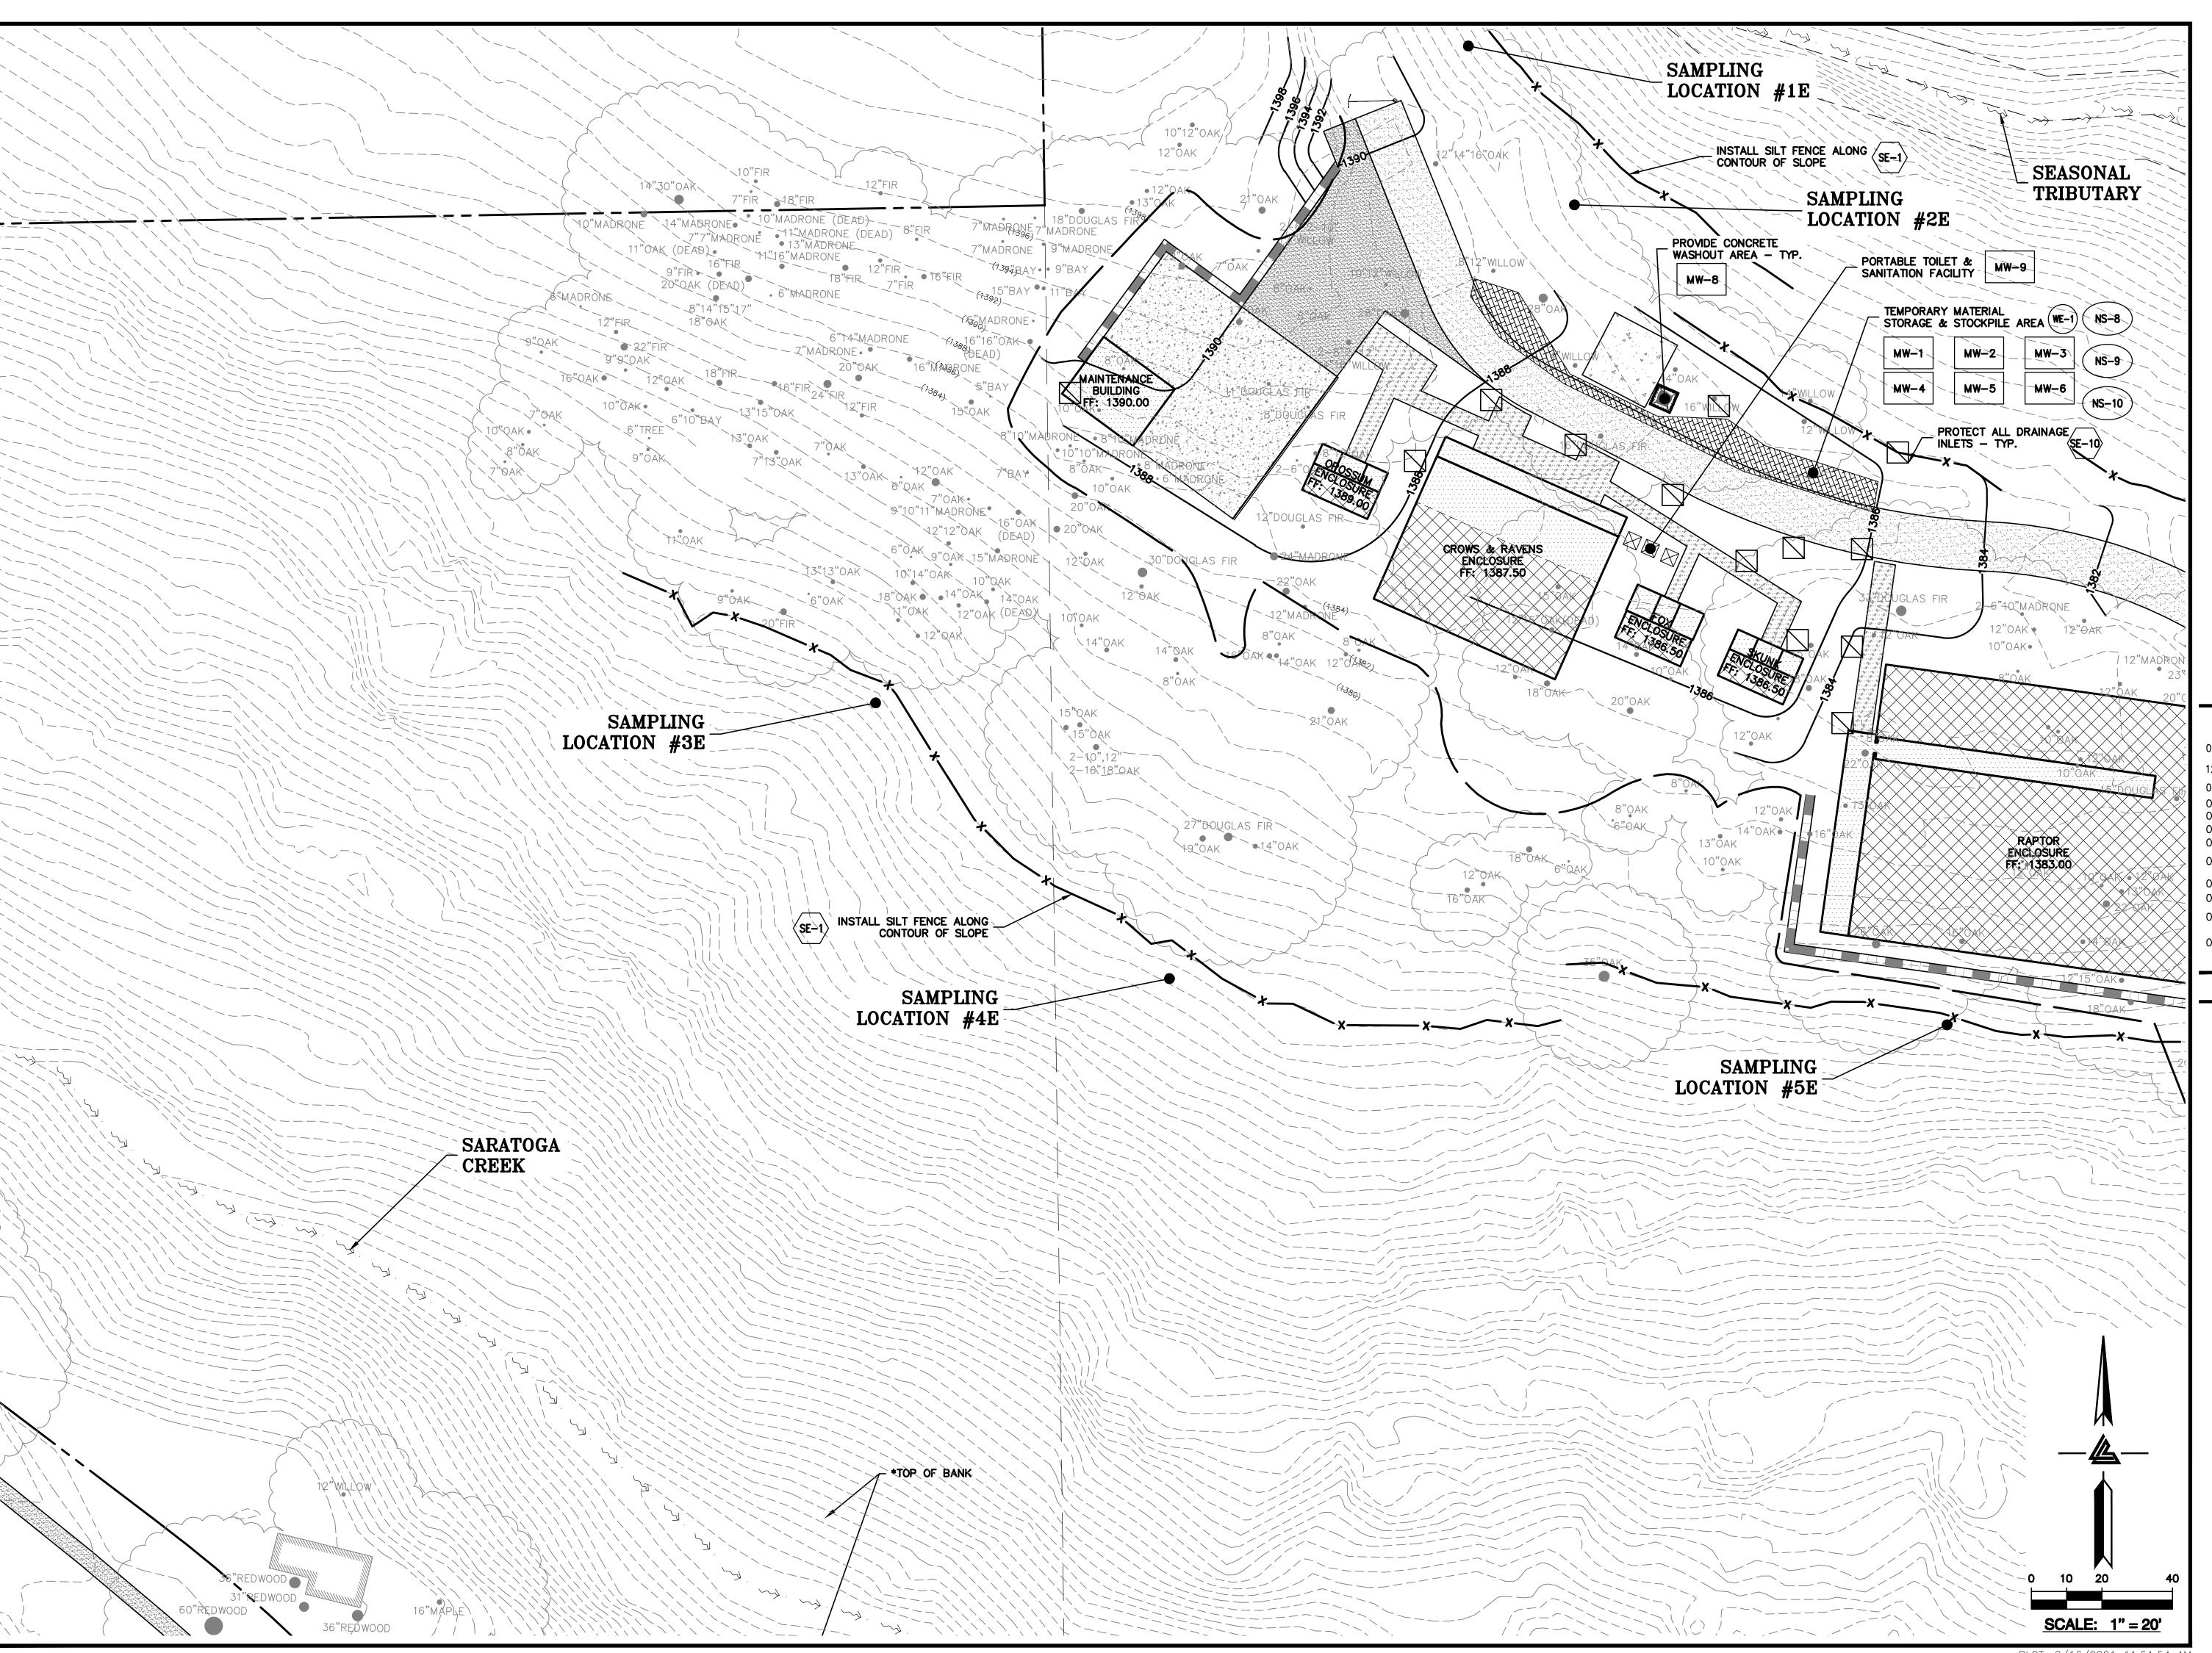

ELLISON CONSERVATION CENTER FOR WILDLIFE CARE





ARCHITECTS



ISSUES AND REVISIONS DESCRIPTION

09-06-18 GRADING PERMIT PLAN CHECK 4 12-21-18 PERMIT RESUBMITTAL 03-26-19 PERMIT MODIFICATION PLAN CHECK 1 04-11-19 ASA DELTA 2 04-22-19 BID SET

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07-22-20 UTILITY PLAN SUBMITTAL

SANTA CLARA COUNTY RECORD INFORMATION APPLICANT: PENINSULA HUMANE SOCIETY ROAD: CONGRESS SPRINGS

LDE FILE: 6943-17-17G GRADING PERMIT: DEV19-1838 UTILITY PERMIT: DEV19-0220

> PROJECT NUMBER 16011.00


SHEET TITLE PHASE 3 BMP PLAN PAVING & FINAL

LANDSCAPE 1" = 20'

PC / CA PC / JL 2130712

SHEET NUMBER

C-9.28

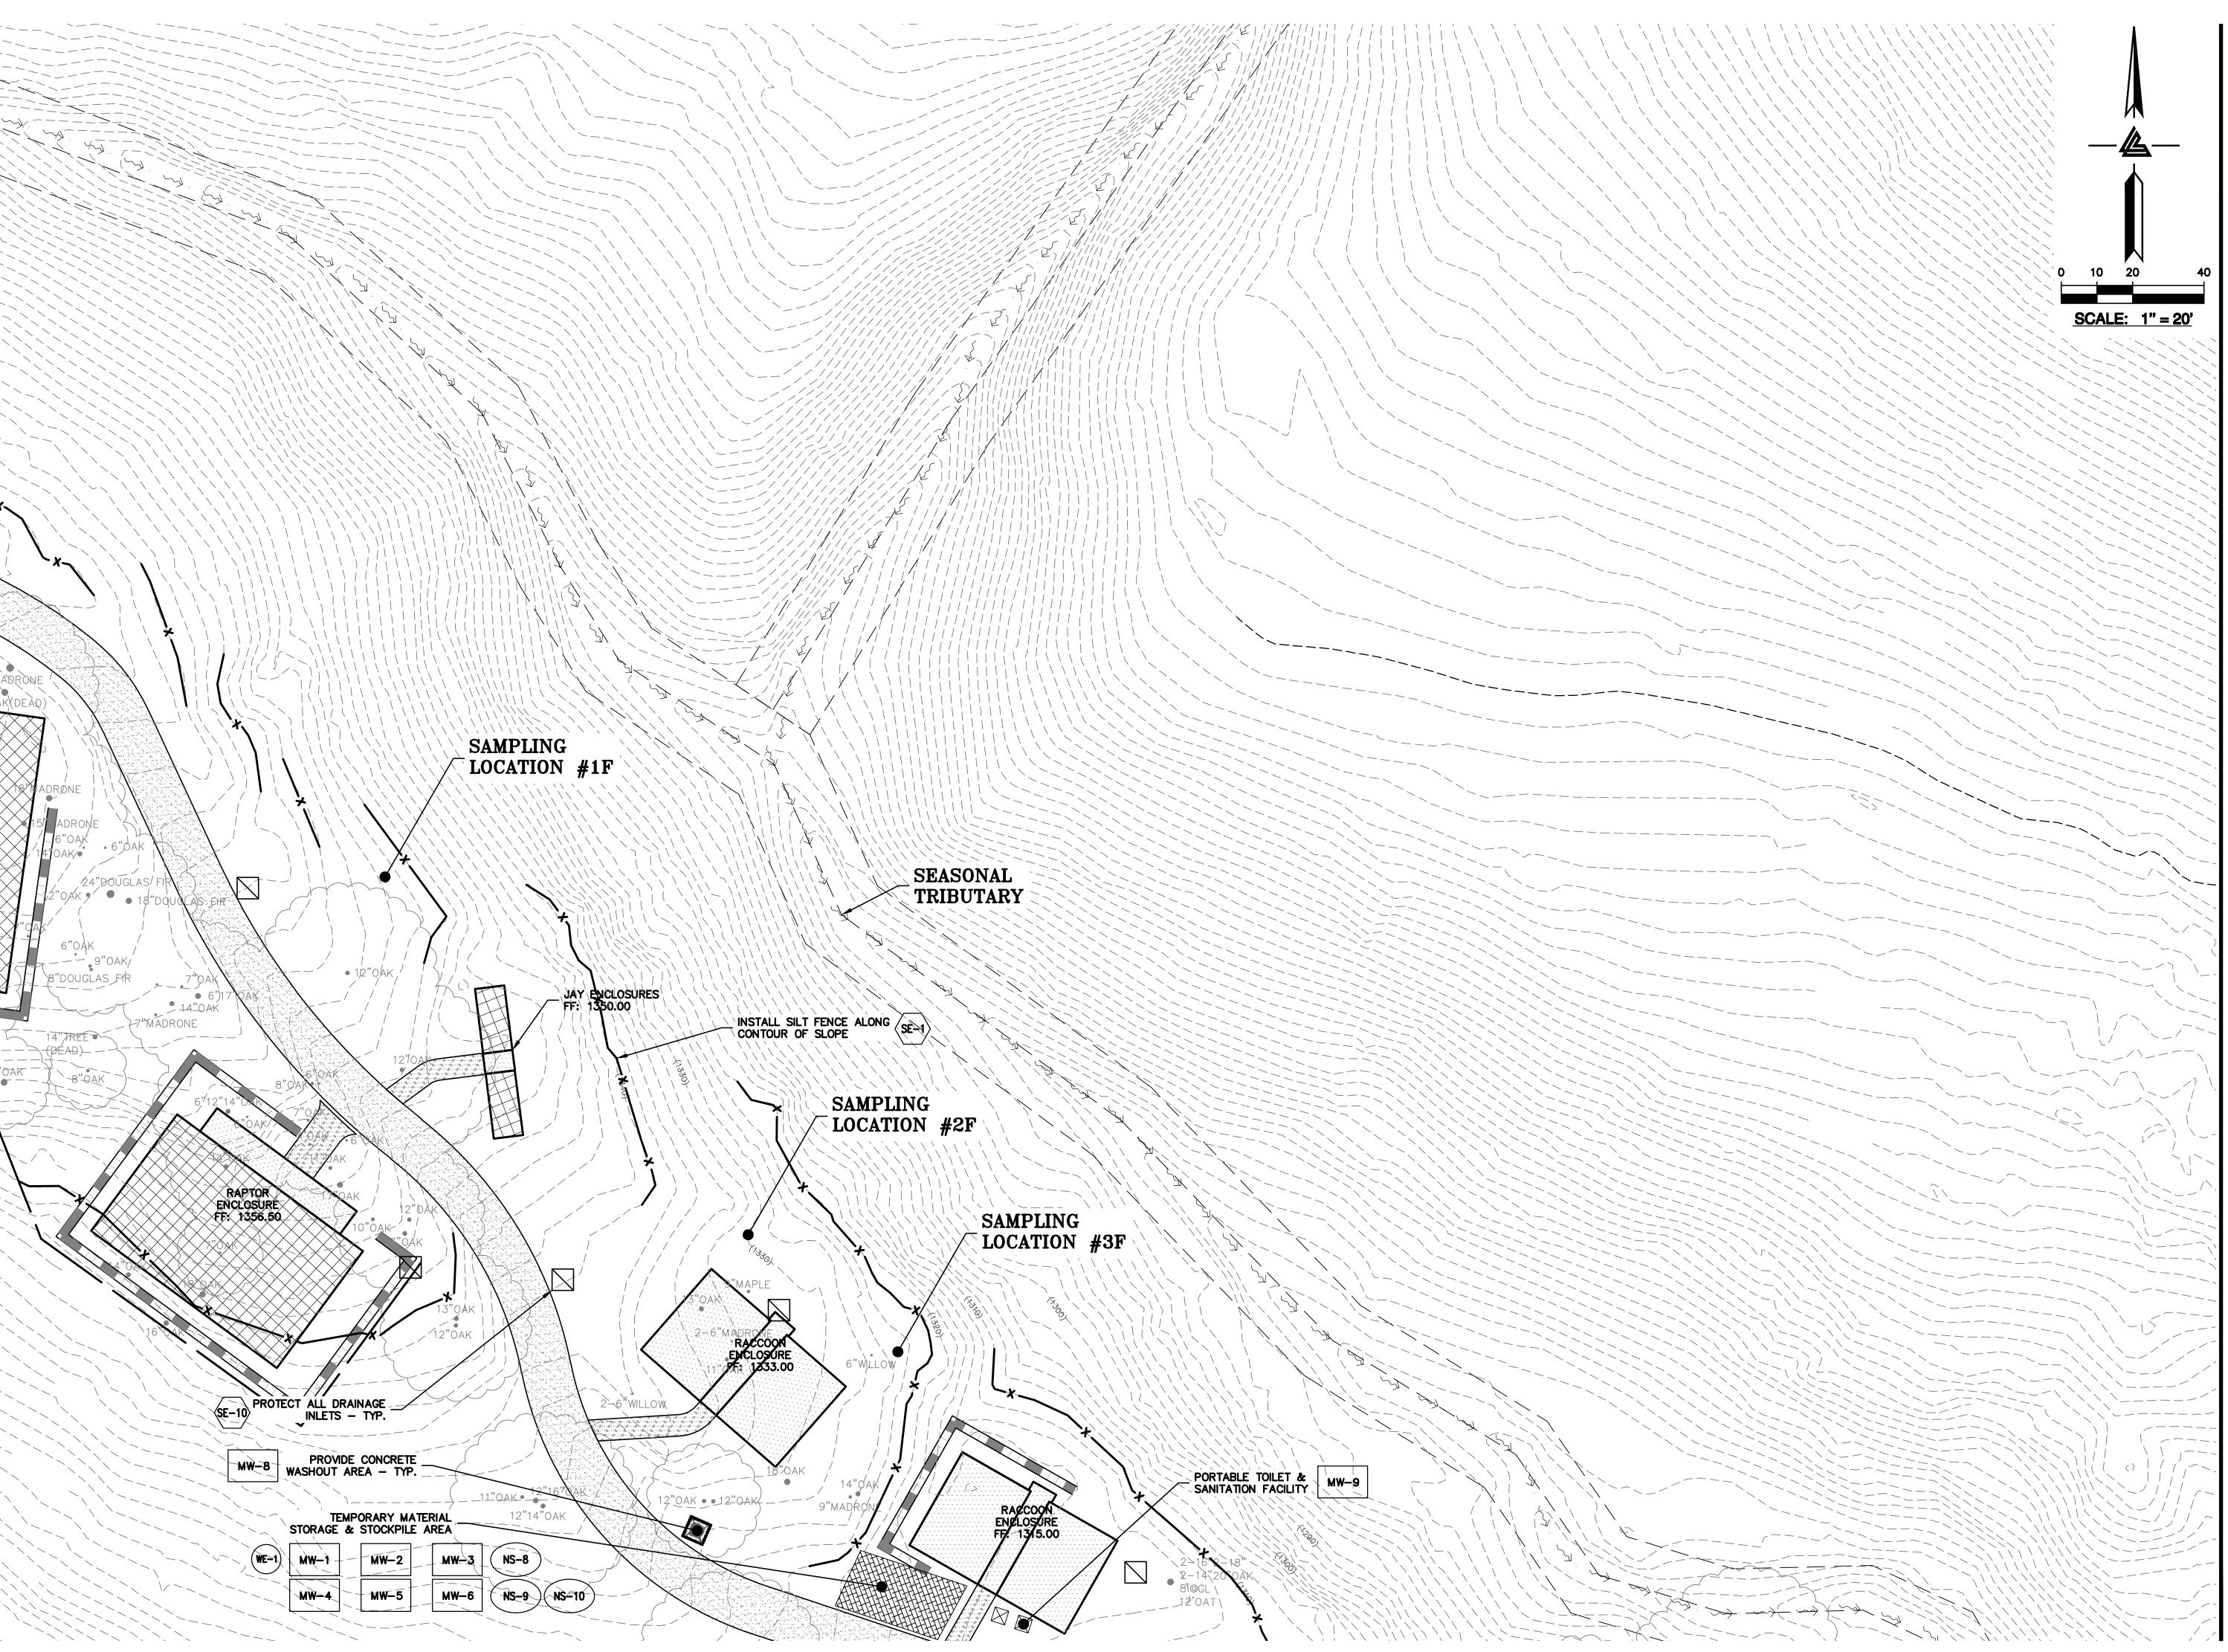

CENTER FOR WILDLIFE CARE SARATOGA, CA





ARCHITECTS KORTH SUNSERI HAGEY



08-06-19 PHASE 4 - PERMIT SUBMITTAL

09-20-19 CONSTRUCTION SET 1
01-28-20 PERMIT MODIFICATION 2
05-29-20 PLAN CHECK RESPONSE PERMIT MODIFICATION 2
07-22-20 UTILITY PLAN SUBMITTAL

SANTA CLARA COUNTY RECORD INFORMATION APPLICANT: PENINSULA HUMANE SOCIETY ROAD: CONGRESS SPRINGS

LDE FILE: 6943-17-17G GRADING PERMIT: DEV19-1838 UTILITY PERMIT: DEV19-0220

PROJECT NUMBER 16011.00

SHEET TITLE


PHASE 3 BMP PLAN PAVING & FINAL LANDSCAPE

SCALE

1" = 20' PC / CA PC / JL 2130712


SHEET NUMBER



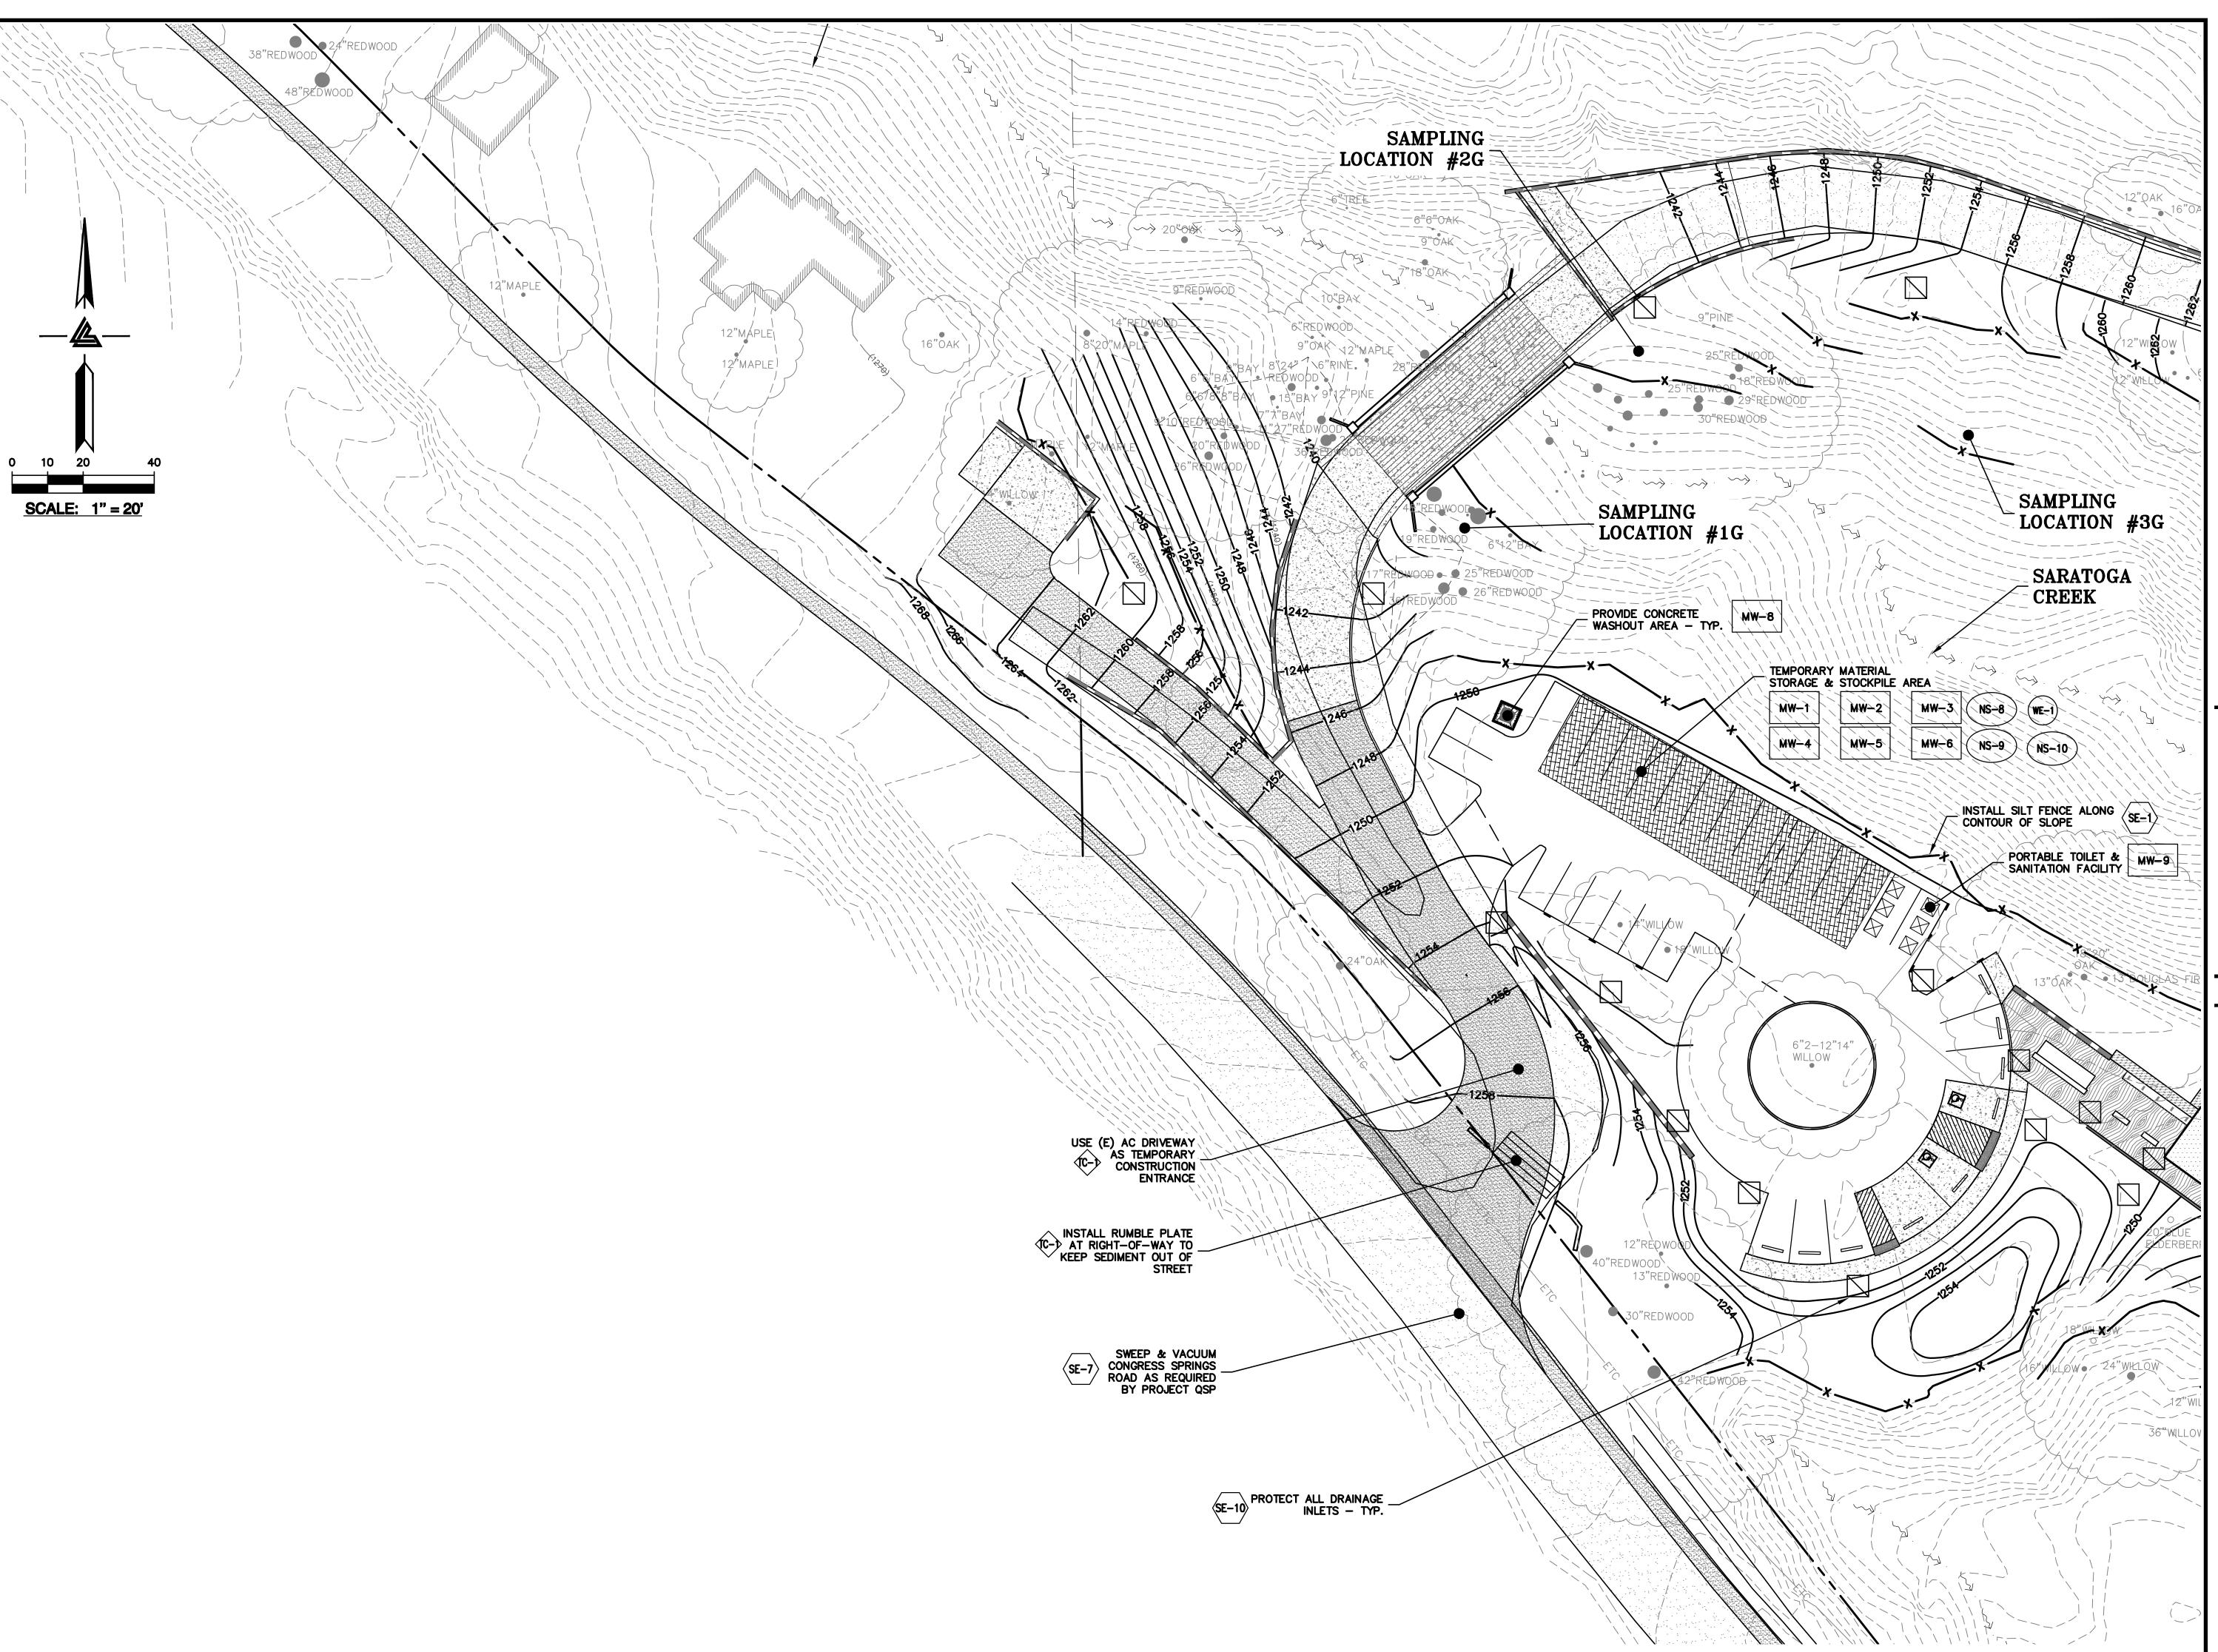

ELLISON CONSERVATION CENTER FOR WILDLIFE CARE SARATOGA, CA



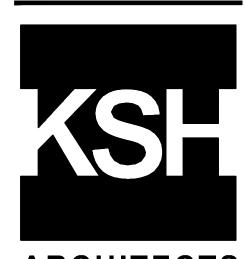

ARCHITECTS KORTH SUNSERI HAGEY



ISSUES AND REVISIONS

09-06-18 GRADING PERMIT PLAN CHECK 4 12-21-18 PERMIT RESUBMITTAL

03-26-19 PERMIT MODIFICATION PLAN CHECK 1 04-11-19 ASA DELTA 2 04-22-19 BID SET

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SANTA CLARA COUNTY RECORD INFORMATION APPLICANT: PENINSULA HUMANE SOCIETY ROAD: CONGRESS SPRINGS

LDE FILE: 6943-17-17G GRADING PERMIT: DEV19-1838 UTILITY PERMIT: DEV19-0220

> PROJECT NUMBER 16011.00

SHEET TITLE PHASE 3 BMP PLAN PAVING & FINAL

LANDSCAPE SCALE 1" = 20'


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SHEET NUMBER


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ASA/USE PERMIT MODIFICATION #3 PLN-17-6943

PLOT: 2/16/2021 11:52:50 AM





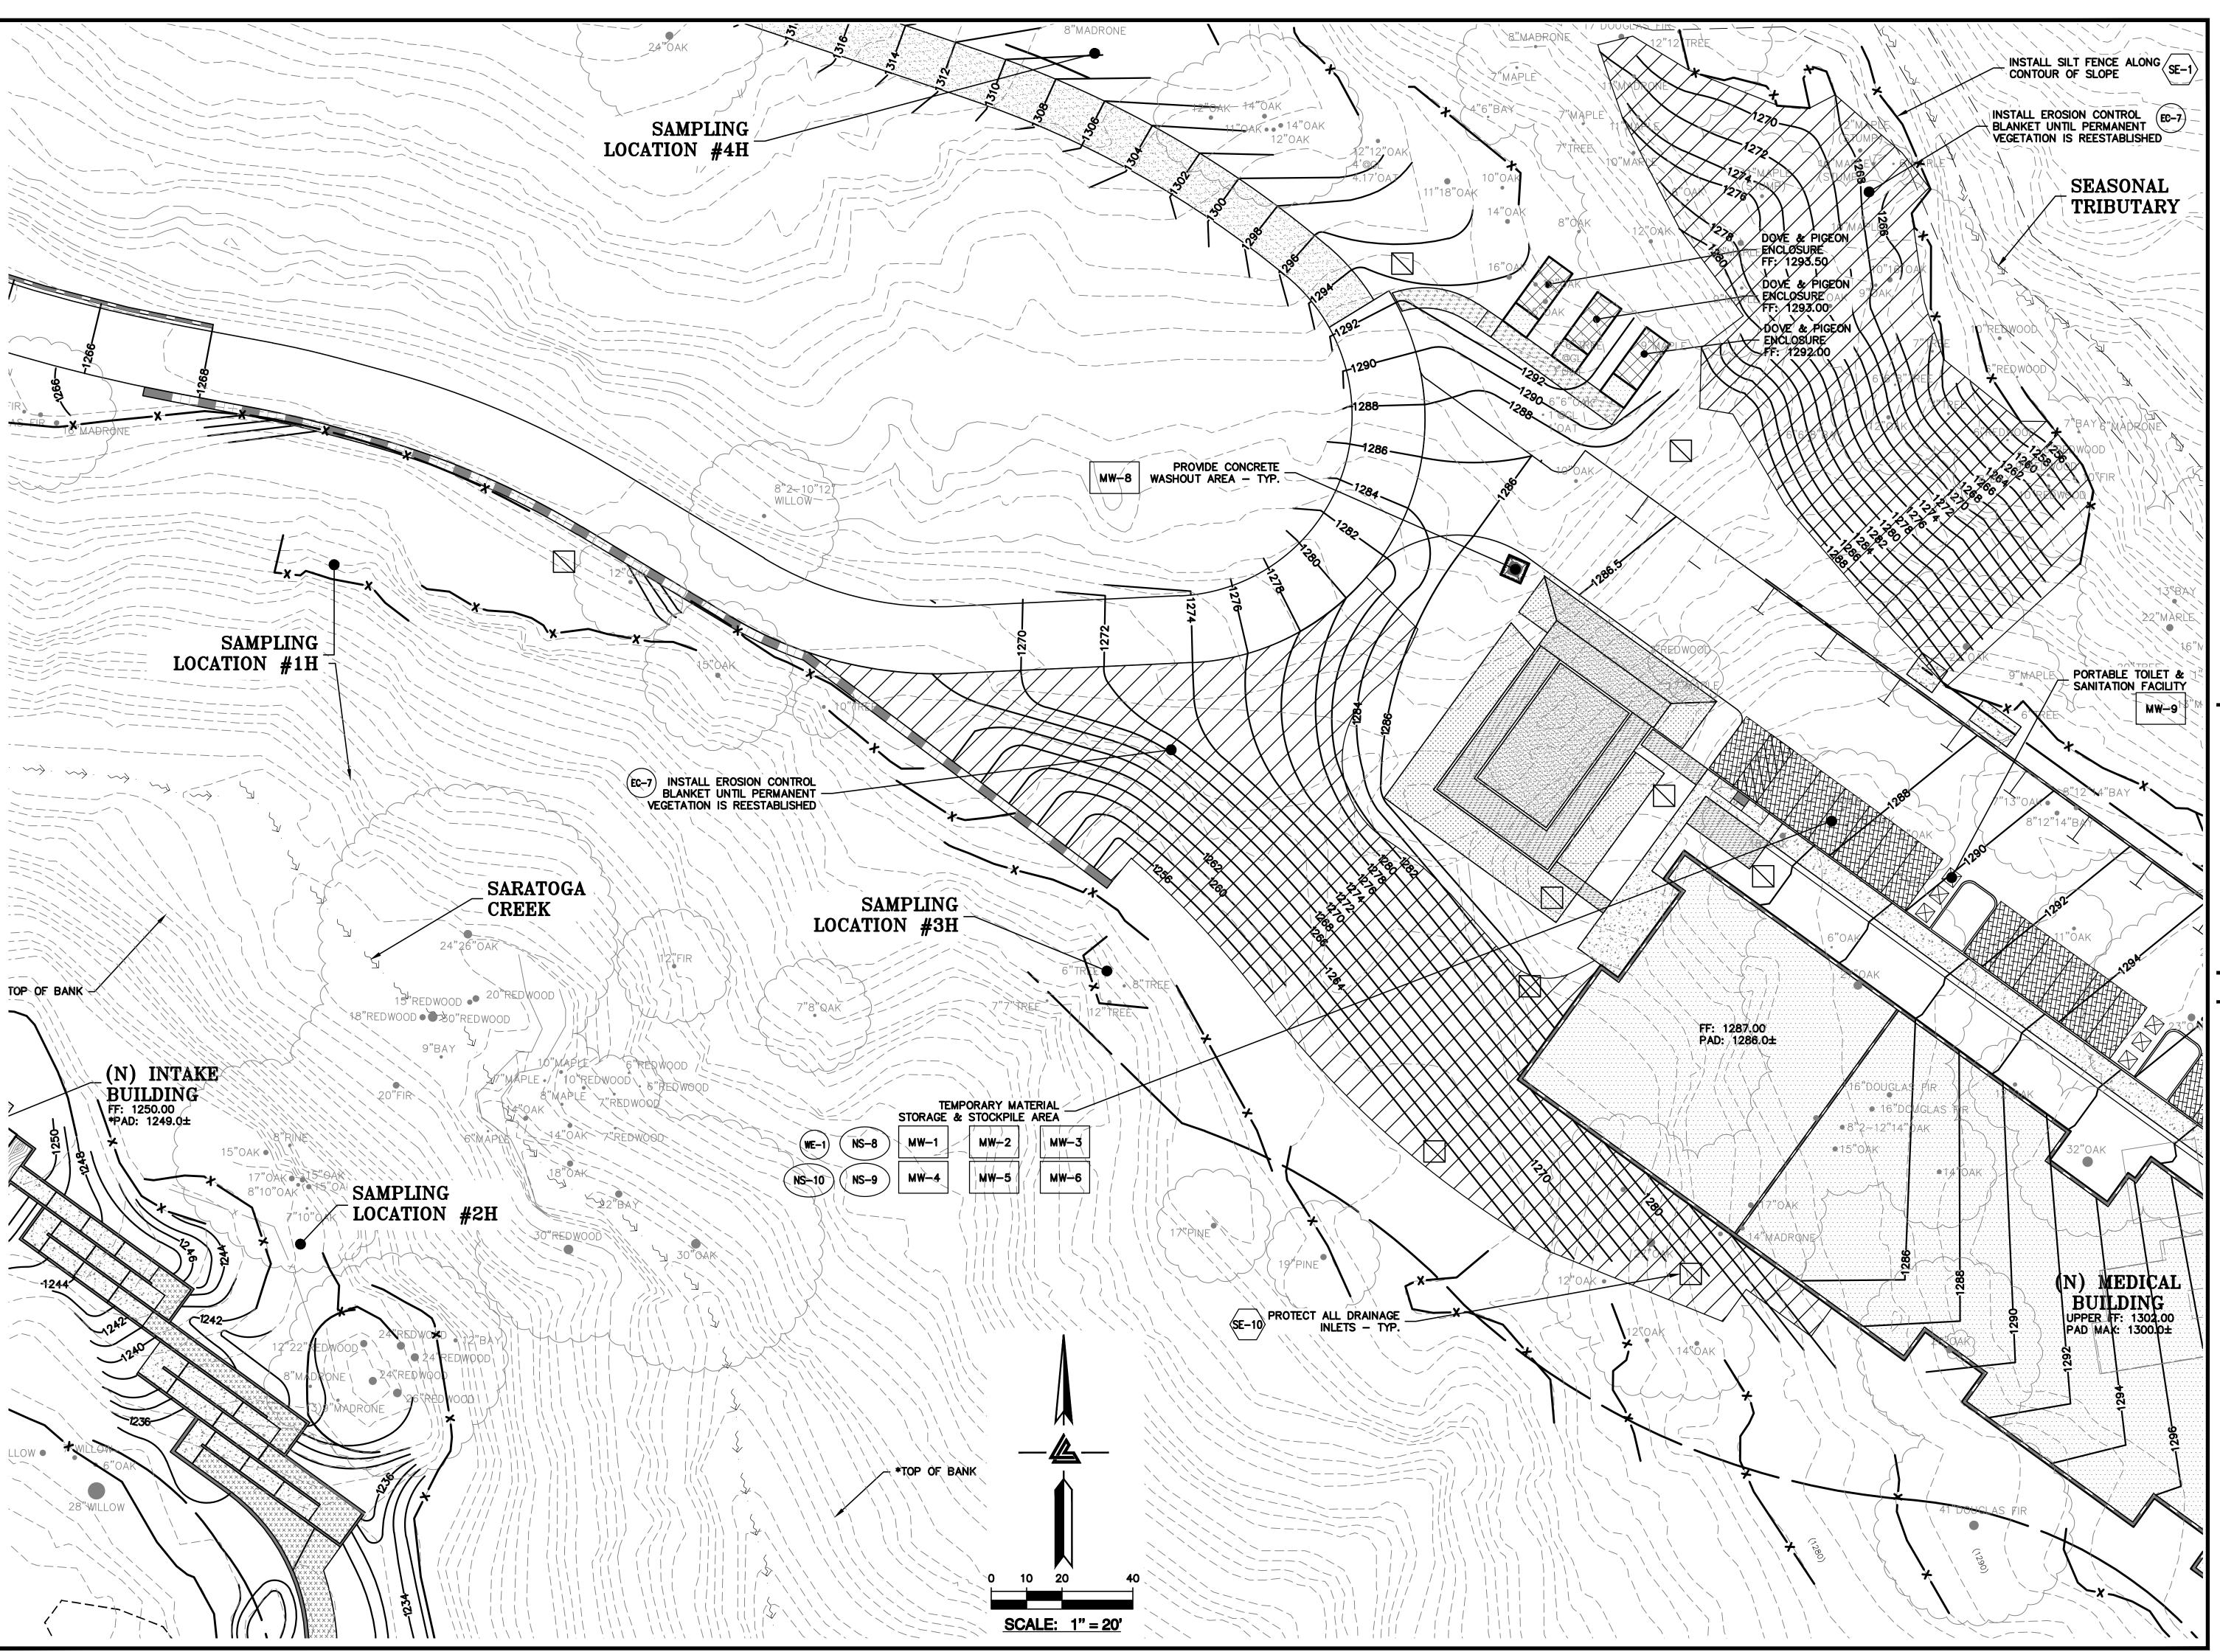

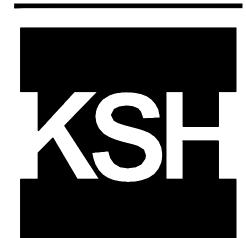ARCHITECTS



ISSUES AND REVISIONS

09-06-18 GRADING PERMIT PLAN CHECK 4

12-21-18 PERMIT RESUBMITTAL PERMIT MODIFICATION

03-26-19 PLAN CHECK 1 04-11-19 ASA DELTA 2 04-22-19 BID SET

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08-06-19 PHASE 4 - PERMIT SUBMITTAL

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05-29-20 PLAN CHECK RESPONSE PERMIT MODIFICATION 2

07-22-20 UTILITY PLAN SUBMITTAL

SANTA CLARA COUNTY RECORD INFORMATION APPLICANT: PENINSULA HUMANE SOCIETY

ROAD: CONGRESS SPRINGS LDE FILE: 6943-17-17G GRADING PERMIT: DEV19-1838

UTILITY PERMIT: DEV19-0220 PROJECT NUMBER

16011.00

SHEET TITLE

PHASE 3 BMP PLAN PAVING & FINAL LANDSCAPE

1" = 20'

PC / CA PC / JL 2130712


SHEET NUMBER

C-9.31



ELLISON CONSERVATION CENTER FOR WILDLIFE CARE



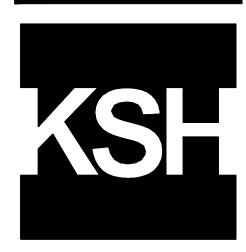

ARCHITECTS



09-06-18 GRADING PERMIT PLAN CHECK 4

12-21-18 PERMIT RESUBMITTAL 03-26-19 PERMIT MODIFICATION PLAN CHECK 1 04-11-19 ASA DELTA 2 04-22-19 BID SET

05-10-19 BID SET ADDENDUM 1 05-22-19 UTILITY PLAN CHECK 1 08-06-19 PHASE 4 - PERMIT SUBMITTAL

09-20-19 CONSTRUCTION SET 1 01-28-20 PERMIT MODIFICATION 2 05-29-20 PLAN CHECK RESPONSE PERMIT MODIFICATION 2

07-22-20 UTILITY PLAN SUBMITTAL

SANTA CLARA COUNTY RECORD INFORMATION APPLICANT: PENINSULA HUMANE SOCIETY ROAD: CONGRESS SPRINGS

LDE FILE: 6943-17-17G GRADING PERMIT: DEV19-1838 UTILITY PERMIT: DEV19-0220

> PROJECT NUMBER 16011.00


SHEET TITLE PHASE 3 BMP PLAN

PAVING & FINAL LANDSCAPE SCALE 1" = 20'

PC / CA PC / JL 2130712

SHEET NUMBER

C-9.32

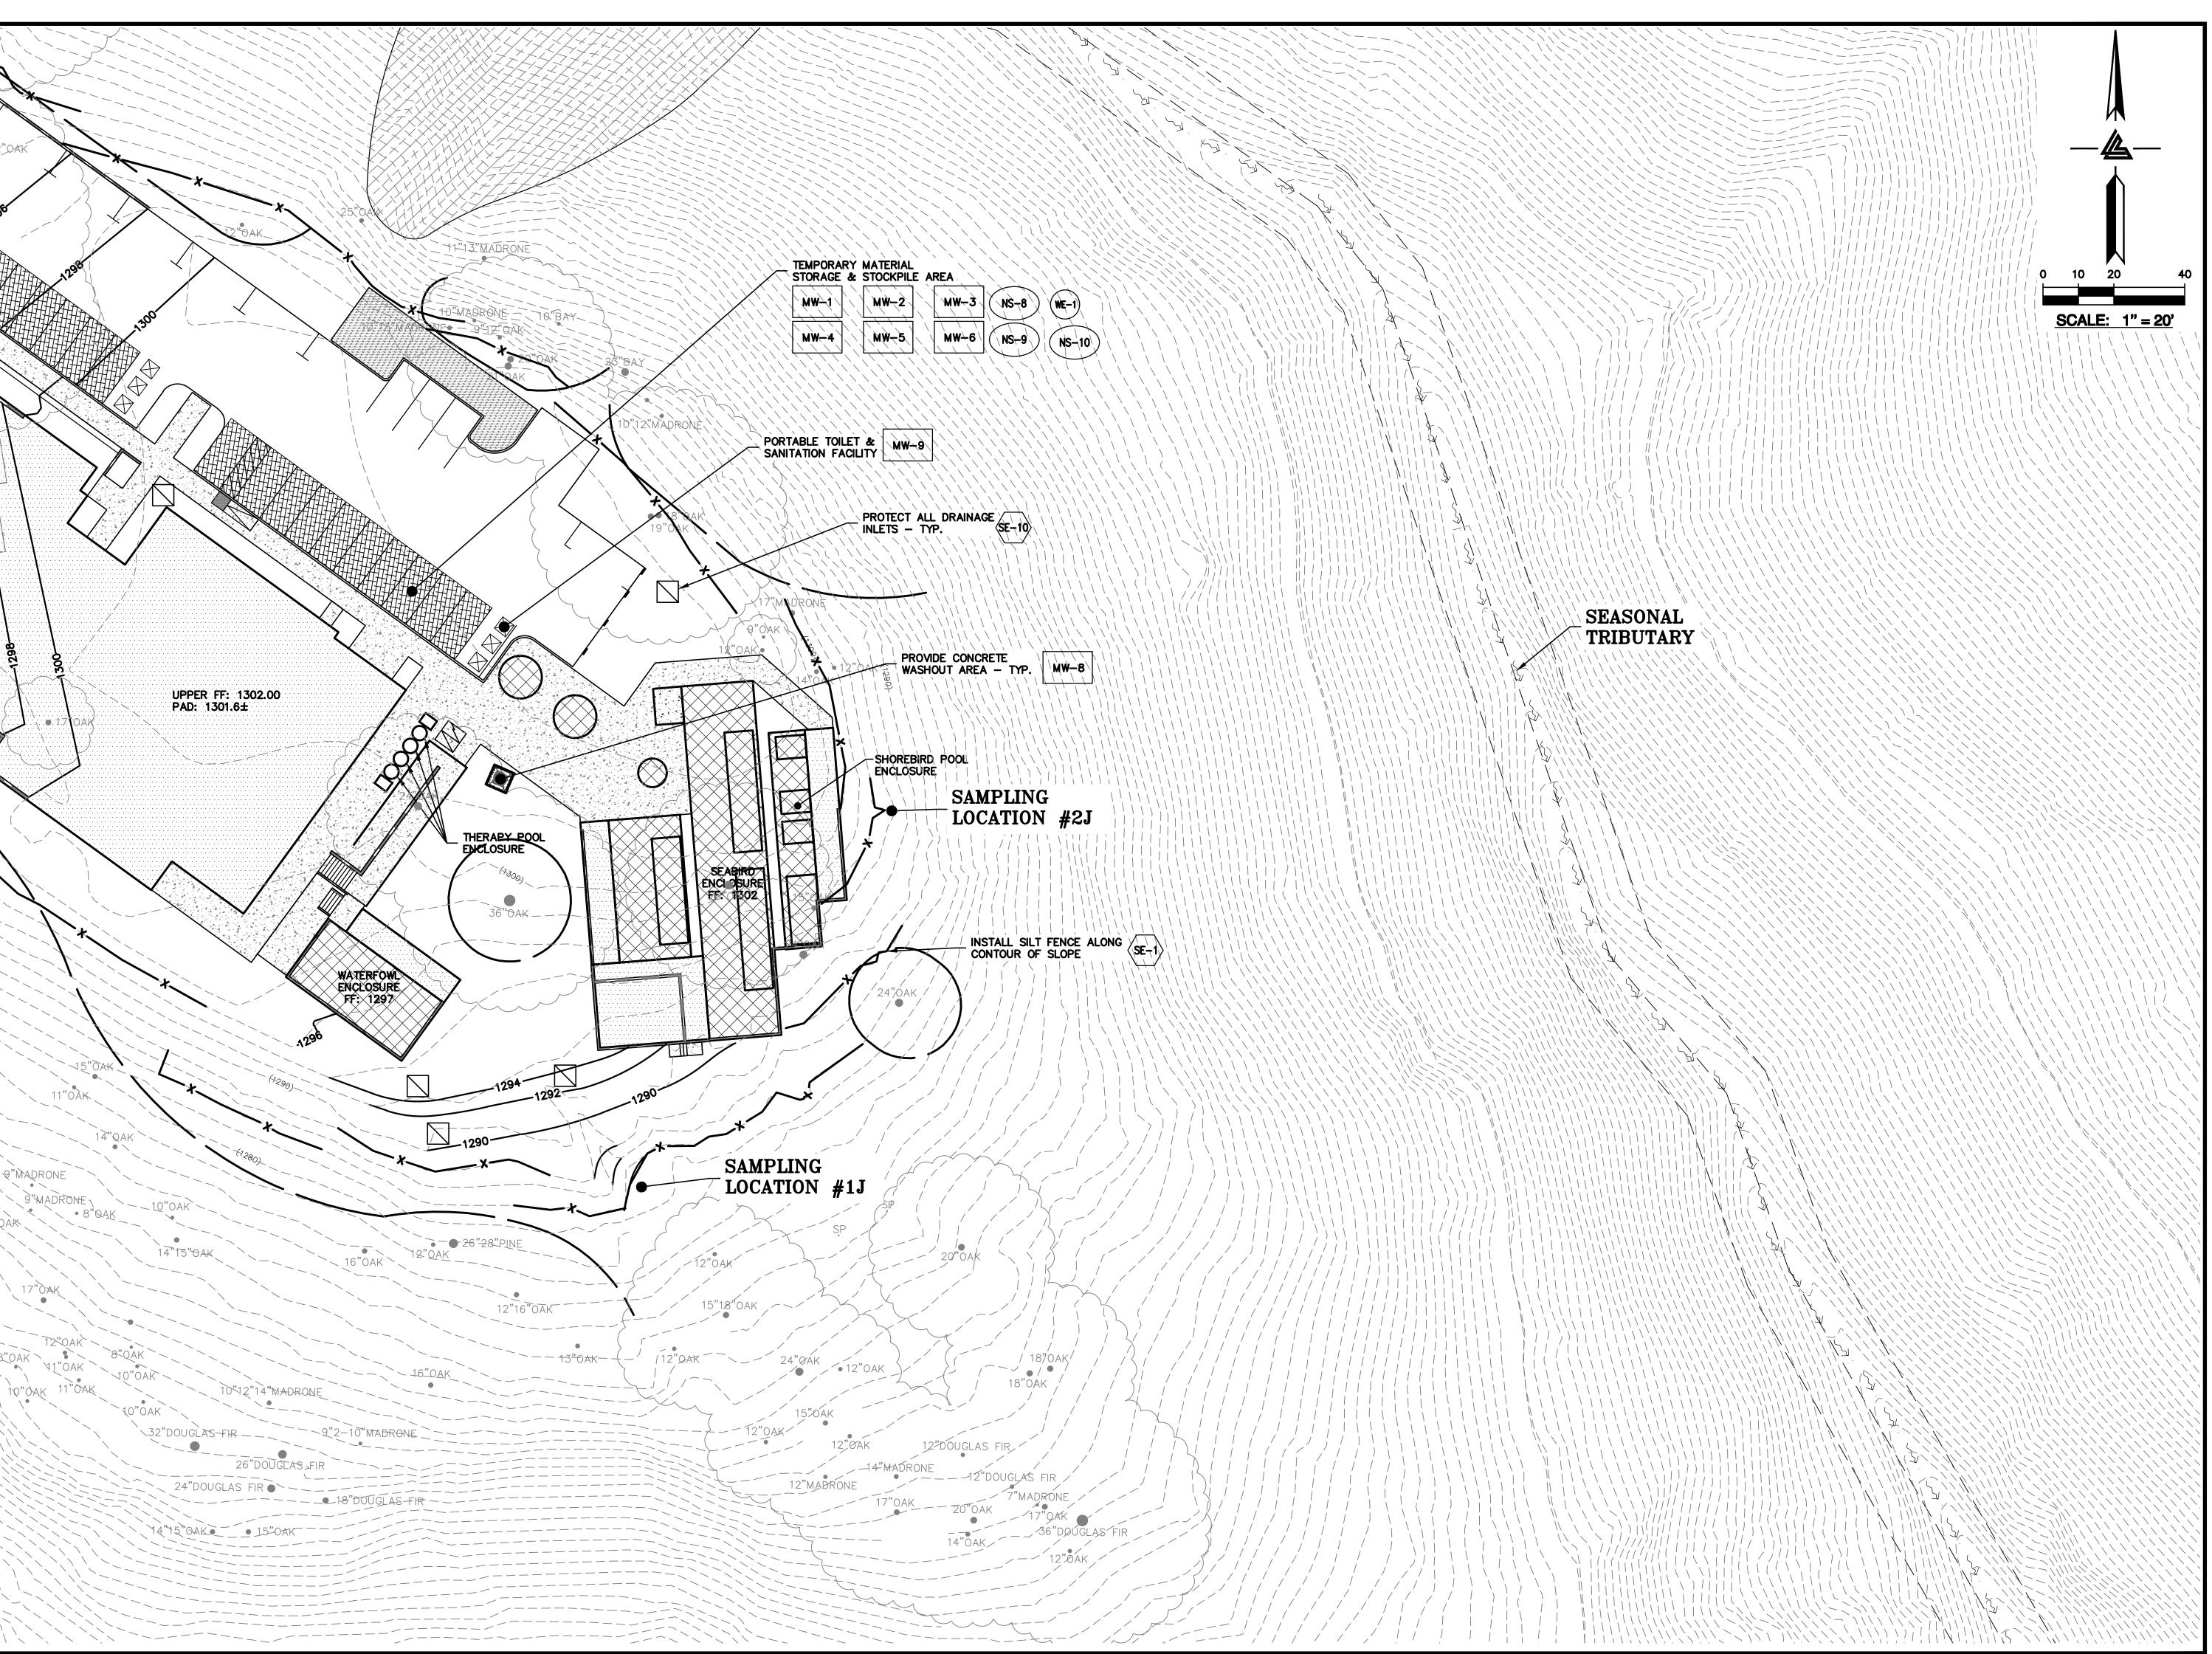





ARCHITECTS KORTH SUNSERI HAGEY

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(F) (510) 887-3019
(F) (510) 887-3019
(F) (916) 946-1338
(F) (916) 797-7363

DATE DESCRIPTION

CRADING DES

09-06-18 GRADING PERMIT PLAN CHECK 4

12-21-18 PERMIT RESUBMITTAL

03-26-19 PERMIT MODIFICATION PLAN CHECK 1 04-11-19 ASA DELTA 2 04-22-19 BID SET

05-10-19 BID SET ADDENDUM 1 05-22-19 UTILITY PLAN CHECK 1

08-06-19 PHASE 4 - PERMIT SUBMITTAL
09-20-19 CONSTRUCTION SET 1

01-28-20 PERMIT MODIFICATION 2 05-29-20 PLAN CHECK RESPONSE PERMIT MODIFICATION 2

07-22-20 UTILITY PLAN SUBMITTAL

SANTA CLARA COUNTY RECORD INFORMATION APPLICANT: PENINSULA HUMANE SOCIETY

ROAD: CONGRESS SPRINGS LDE FILE: 6943-17-17G GRADING PERMIT: DEV19-1838 UTILITY PERMIT: DEV19-0220

> PROJECT NUMBER 16011.00


PHASE 3 BMP PLAN

PAVING & FINAL LANDSCAPE

SCALE 1" = 20'signed By PC / CA
ecked By PC / JL
Job No. 2130712

SHEET NUMBER

C-9.33

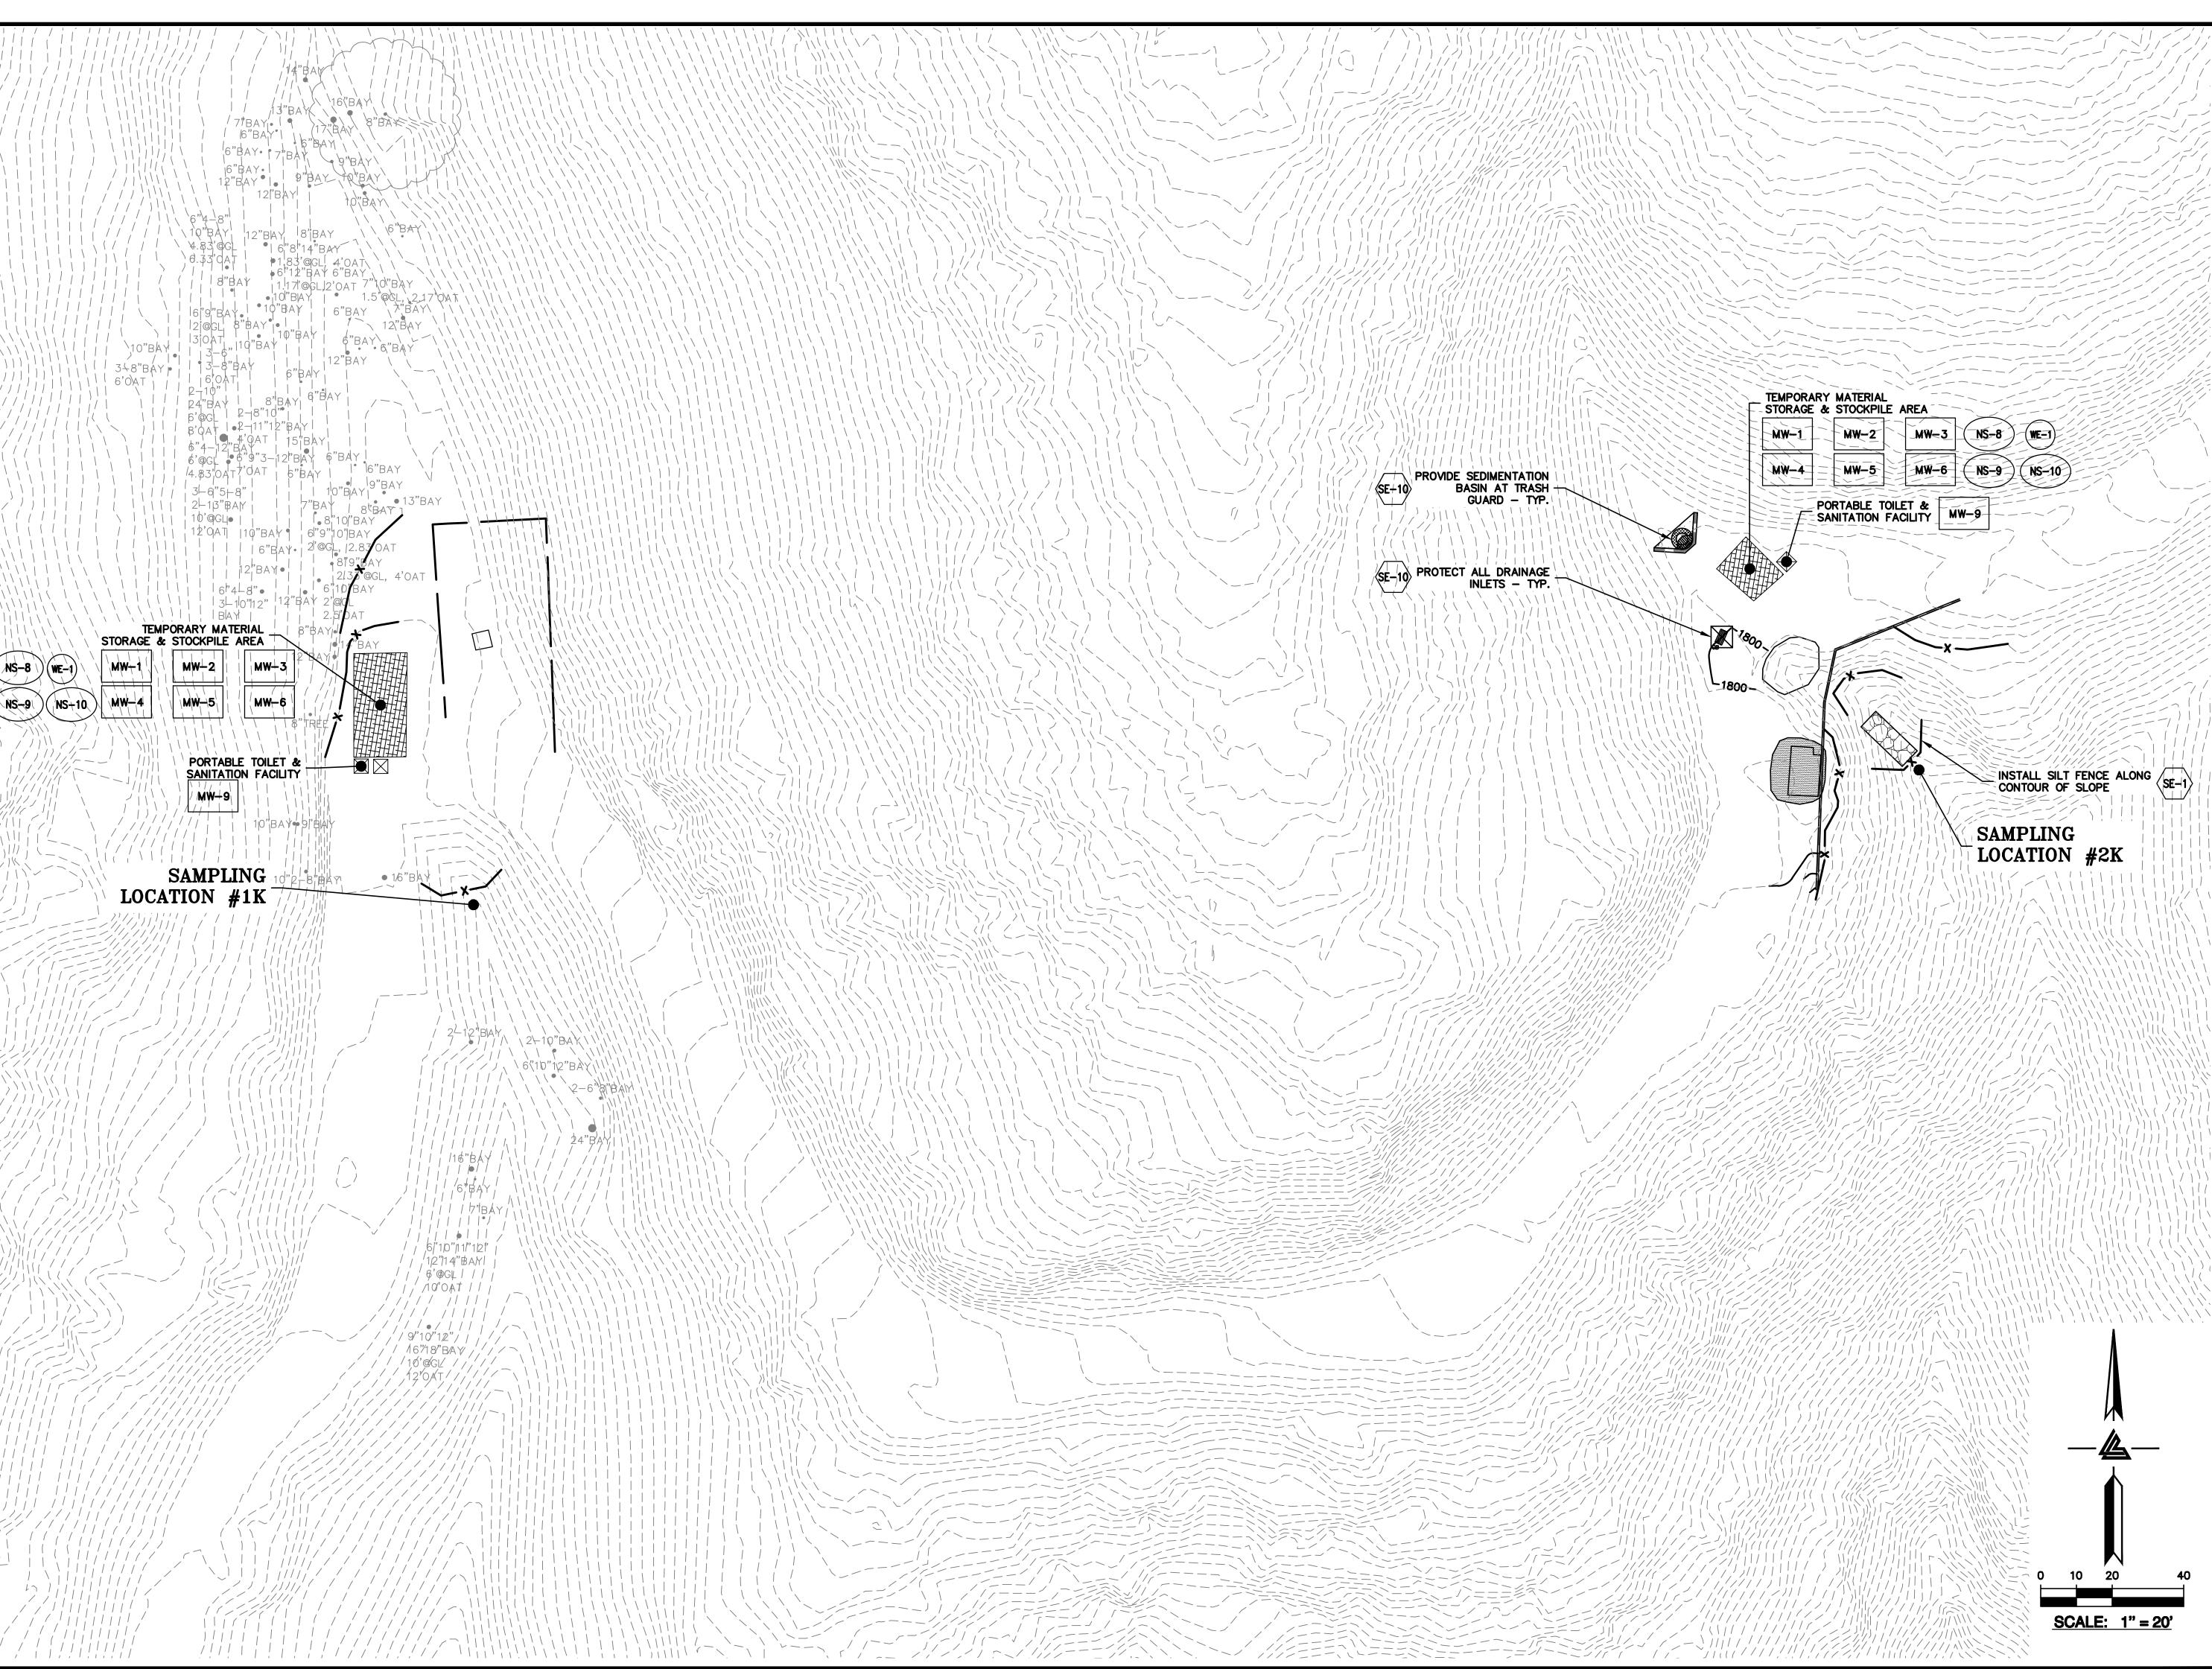





ARCHITECTS



ISSUES AND REVISIONS

09-06-18 GRADING PERMIT PLAN CHECK 4

12-21-18 PERMIT RESUBMITTAL 03-26-19 PERMIT MODIFICATION PLAN CHECK 1 04-11-19 ASA DELTA 2

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09-20-19 CONSTRUCTION SET 1 01-28-20 PERMIT MODIFICATION 2

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07-22-20 UTILITY PLAN SUBMITTAL

SANTA CLARA COUNTY **RECORD INFORMATION** APPLICANT: PENINSULA HUMANE SOCIETY ROAD: CONGRESS SPRINGS LDE FILE: 6943-17-17G

GRADING PERMIT: DEV19-1838 UTILITY PERMIT: DEV19-0220 PROJECT NUMBER


PHASE 3 BMP PLAN PAVING & FINAL LANDSCAPE

SCALE


1" = 20'PC / CA PC / JL 2130712


SHEET NUMBER


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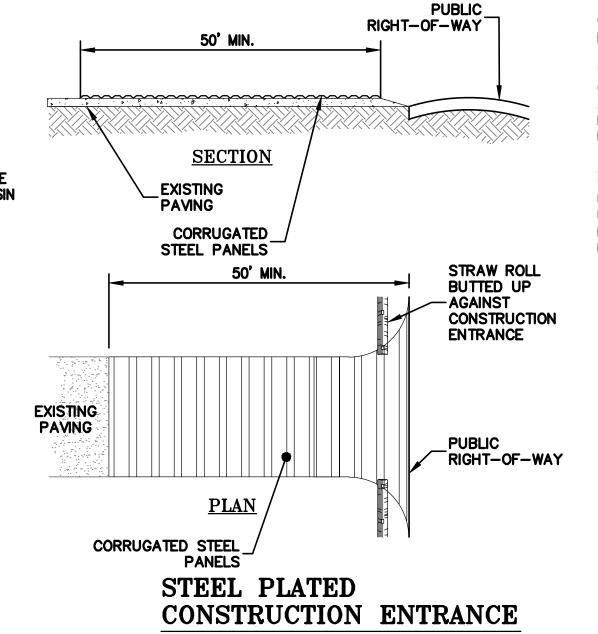


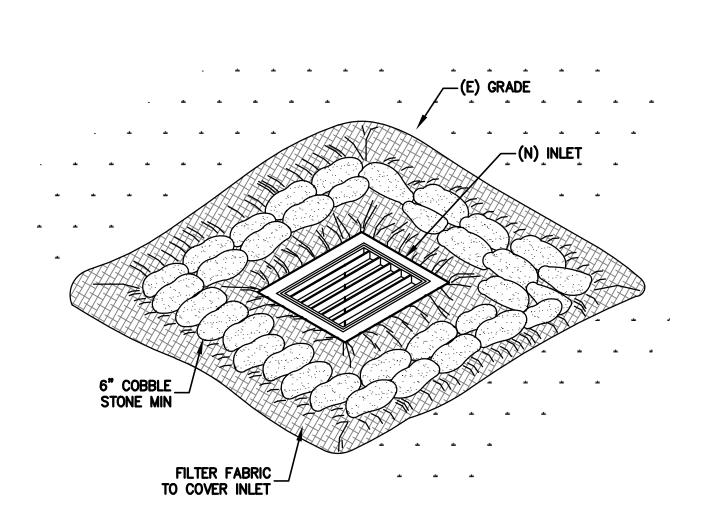
INLET PROTECTION NTS



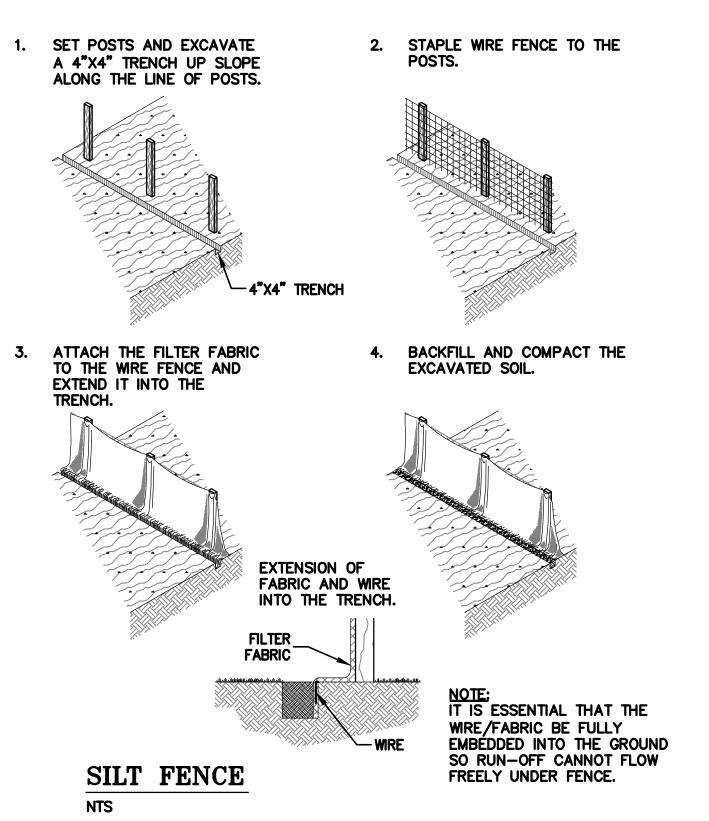

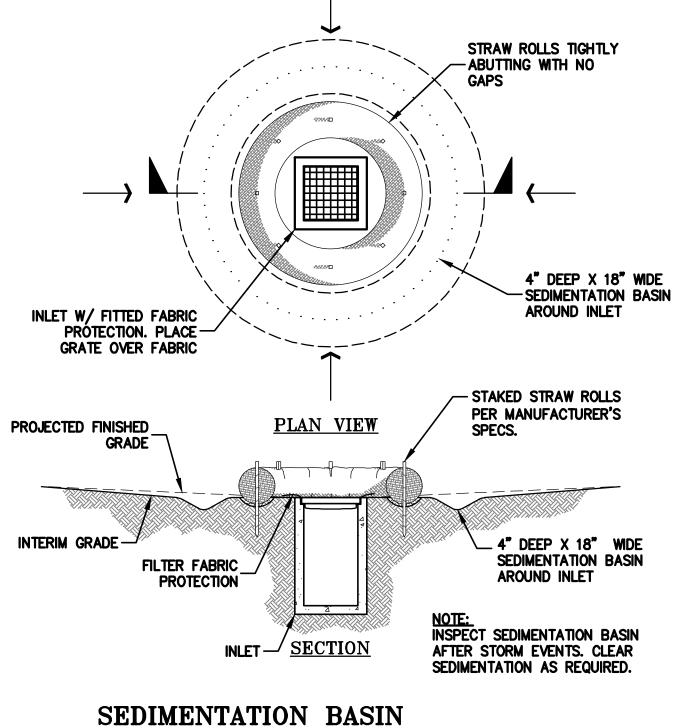

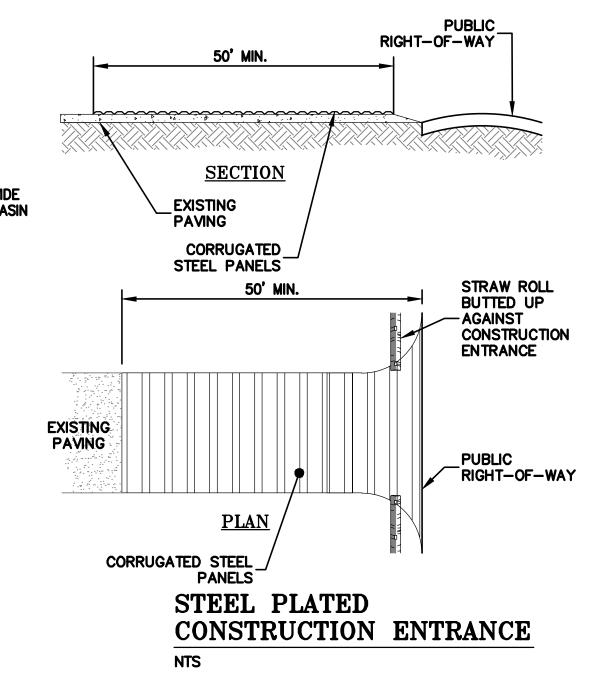

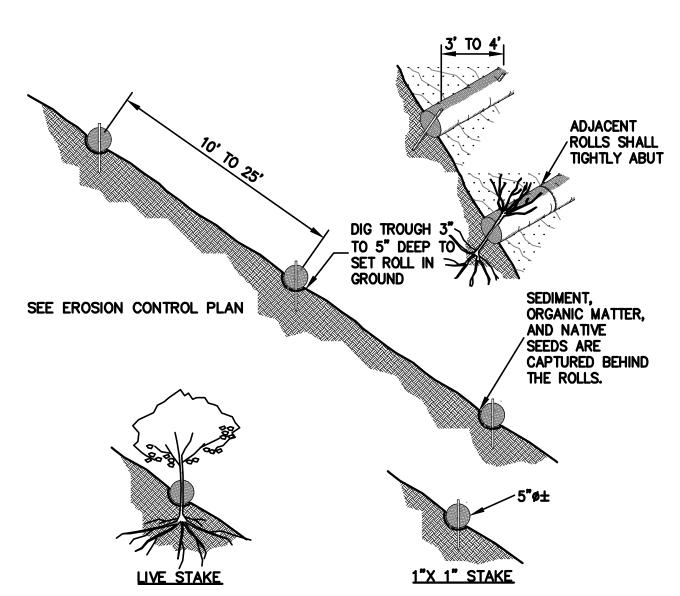


NOTE:

1. STRAW ROLL INSTALLATION REQUIRES THE PLACEMENT AND SECURE STAKING OF THE ROLL IN A TRENCH, 3" TO 5" DEEP, DUG ON CONTOUR. RUNOFF MUST NOT BE ALLOWED TO RUN UNDER OR AROUND ROLL.

2. CONTRACTOR IS RESPONSIBLE FOR REGULAR MAINTENANCE AND INSPECTION. THE SILT SHALL BE CLEANED OUT WHEN IT REACHES HALF THE HEIGHT OF THE ROLL.


STRAW ROLLS

NTS

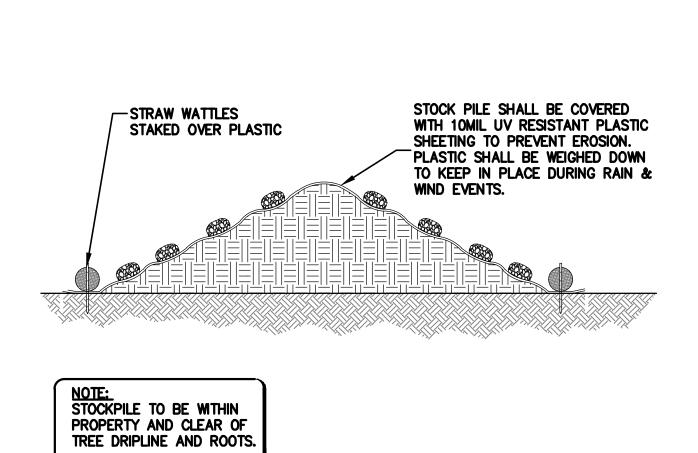


STOCK PILE COVERING

NTS

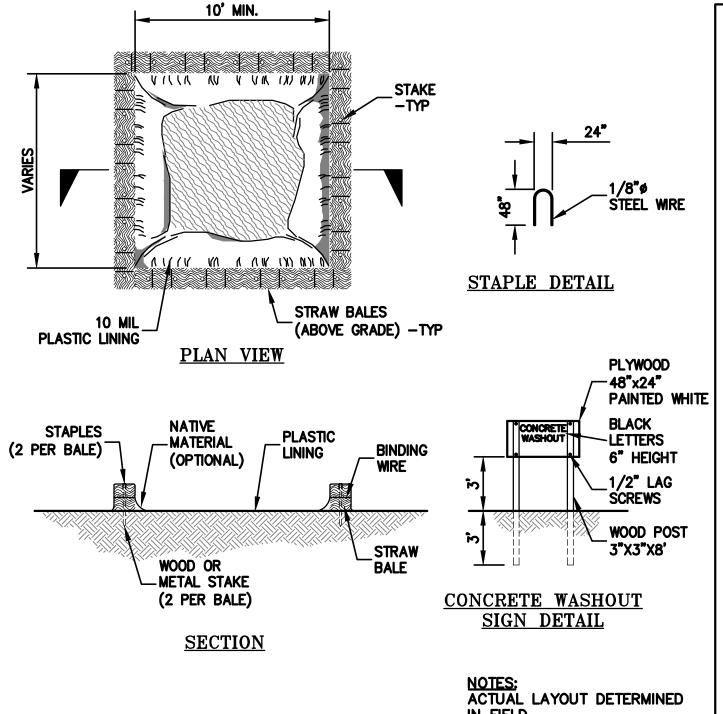

CONCRETE WASHOUT

THE CONCRETE WASHOUT SIGN SHALL BE INSTALLED WITHIN 10' OF THE TEMPORARY CONCRETE WASHOUT FACILITY.

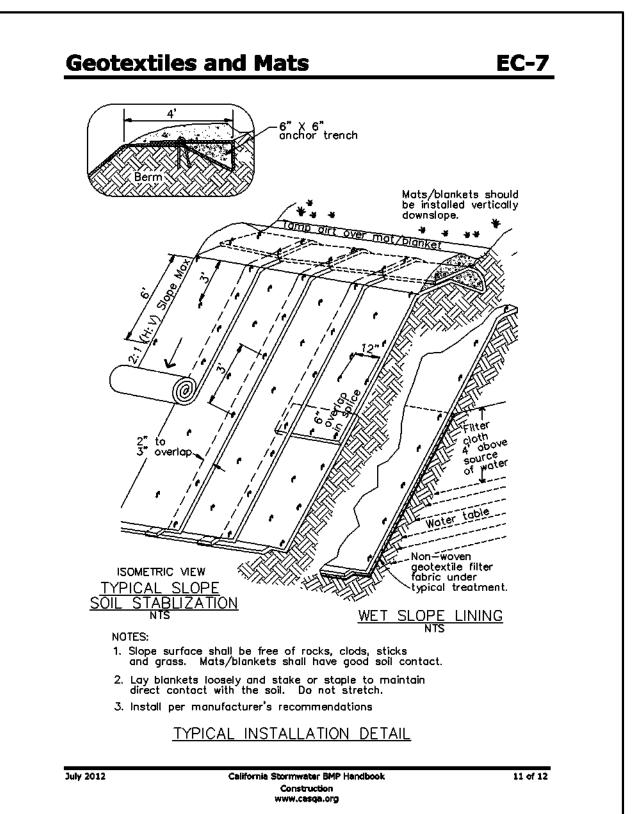

NOTES:

CORRUGATED STEEL PANELS SHAL BE A MINIMUM OF 50'.


WIDTH SHALL BE A MIN. OF 15' GREATER IF NECESSARY TO COVE ALL VEHICULAR INGRESS AND EGRESS. PROVIDE AMPLE TURNING RADII.

ACCESSES SHALL BE INSPECTED WEEKLY DURING PERIODS OF HEAV USAGE, MONTHLY DURING NORMAL USAGE, AND AFTER EACH RAINFALL, WITH MAINTENANCE PROVIDED AS NECESSARY.

ELLISON CONSERVATION CENTER FOR WILDLIFE CARE

SARATOGA, CA

ARCHITECTS KORTH SUNSERI HAGEY

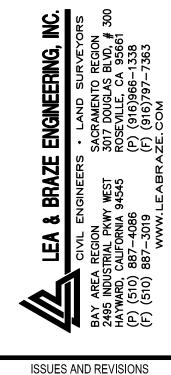

DESCRIPTION

GRADING PERMIT PLAN CHECK 4

12-21-18 PERMIT RESUBMITTAL PERMIT MODIFICATION

04-11-19 ASA DELTA 2 04-22-19 BID SET

05-10-19 BID SET ADDENDUM 05-22-19 UTILITY PLAN CHECK 1

08-06-19 PHASE 4 - PERMIT SUBMITTAL

09-20-19 CONSTRUCTION SET 1

01-28-20 PERMIT MODIFICATION 2

05-29-20 PLAN CHECK RESPONSE PERMIT MODIFICATION 2

07-22-20 UTILITY PLAN SUBMITTAL

SANTA CLARA COUNTY **RECORD INFORMATION**

APPLICANT: PENINSULA HUMANE SOCIETY ROAD: CONGRESS SPRINGS

LDE FILE: 6943-17-17G GRADING PERMIT: DEV19-1838 UTILITY PERMIT: DEV19-0220

> PROJECT NUMBER 16011.00


SHEET TITLE

EROSION CONTROL DETAILS

SCALE NTS PC / CA Checked By PC / JL 2130712 LB Job No.

SHEET NUMBER

C-9.35

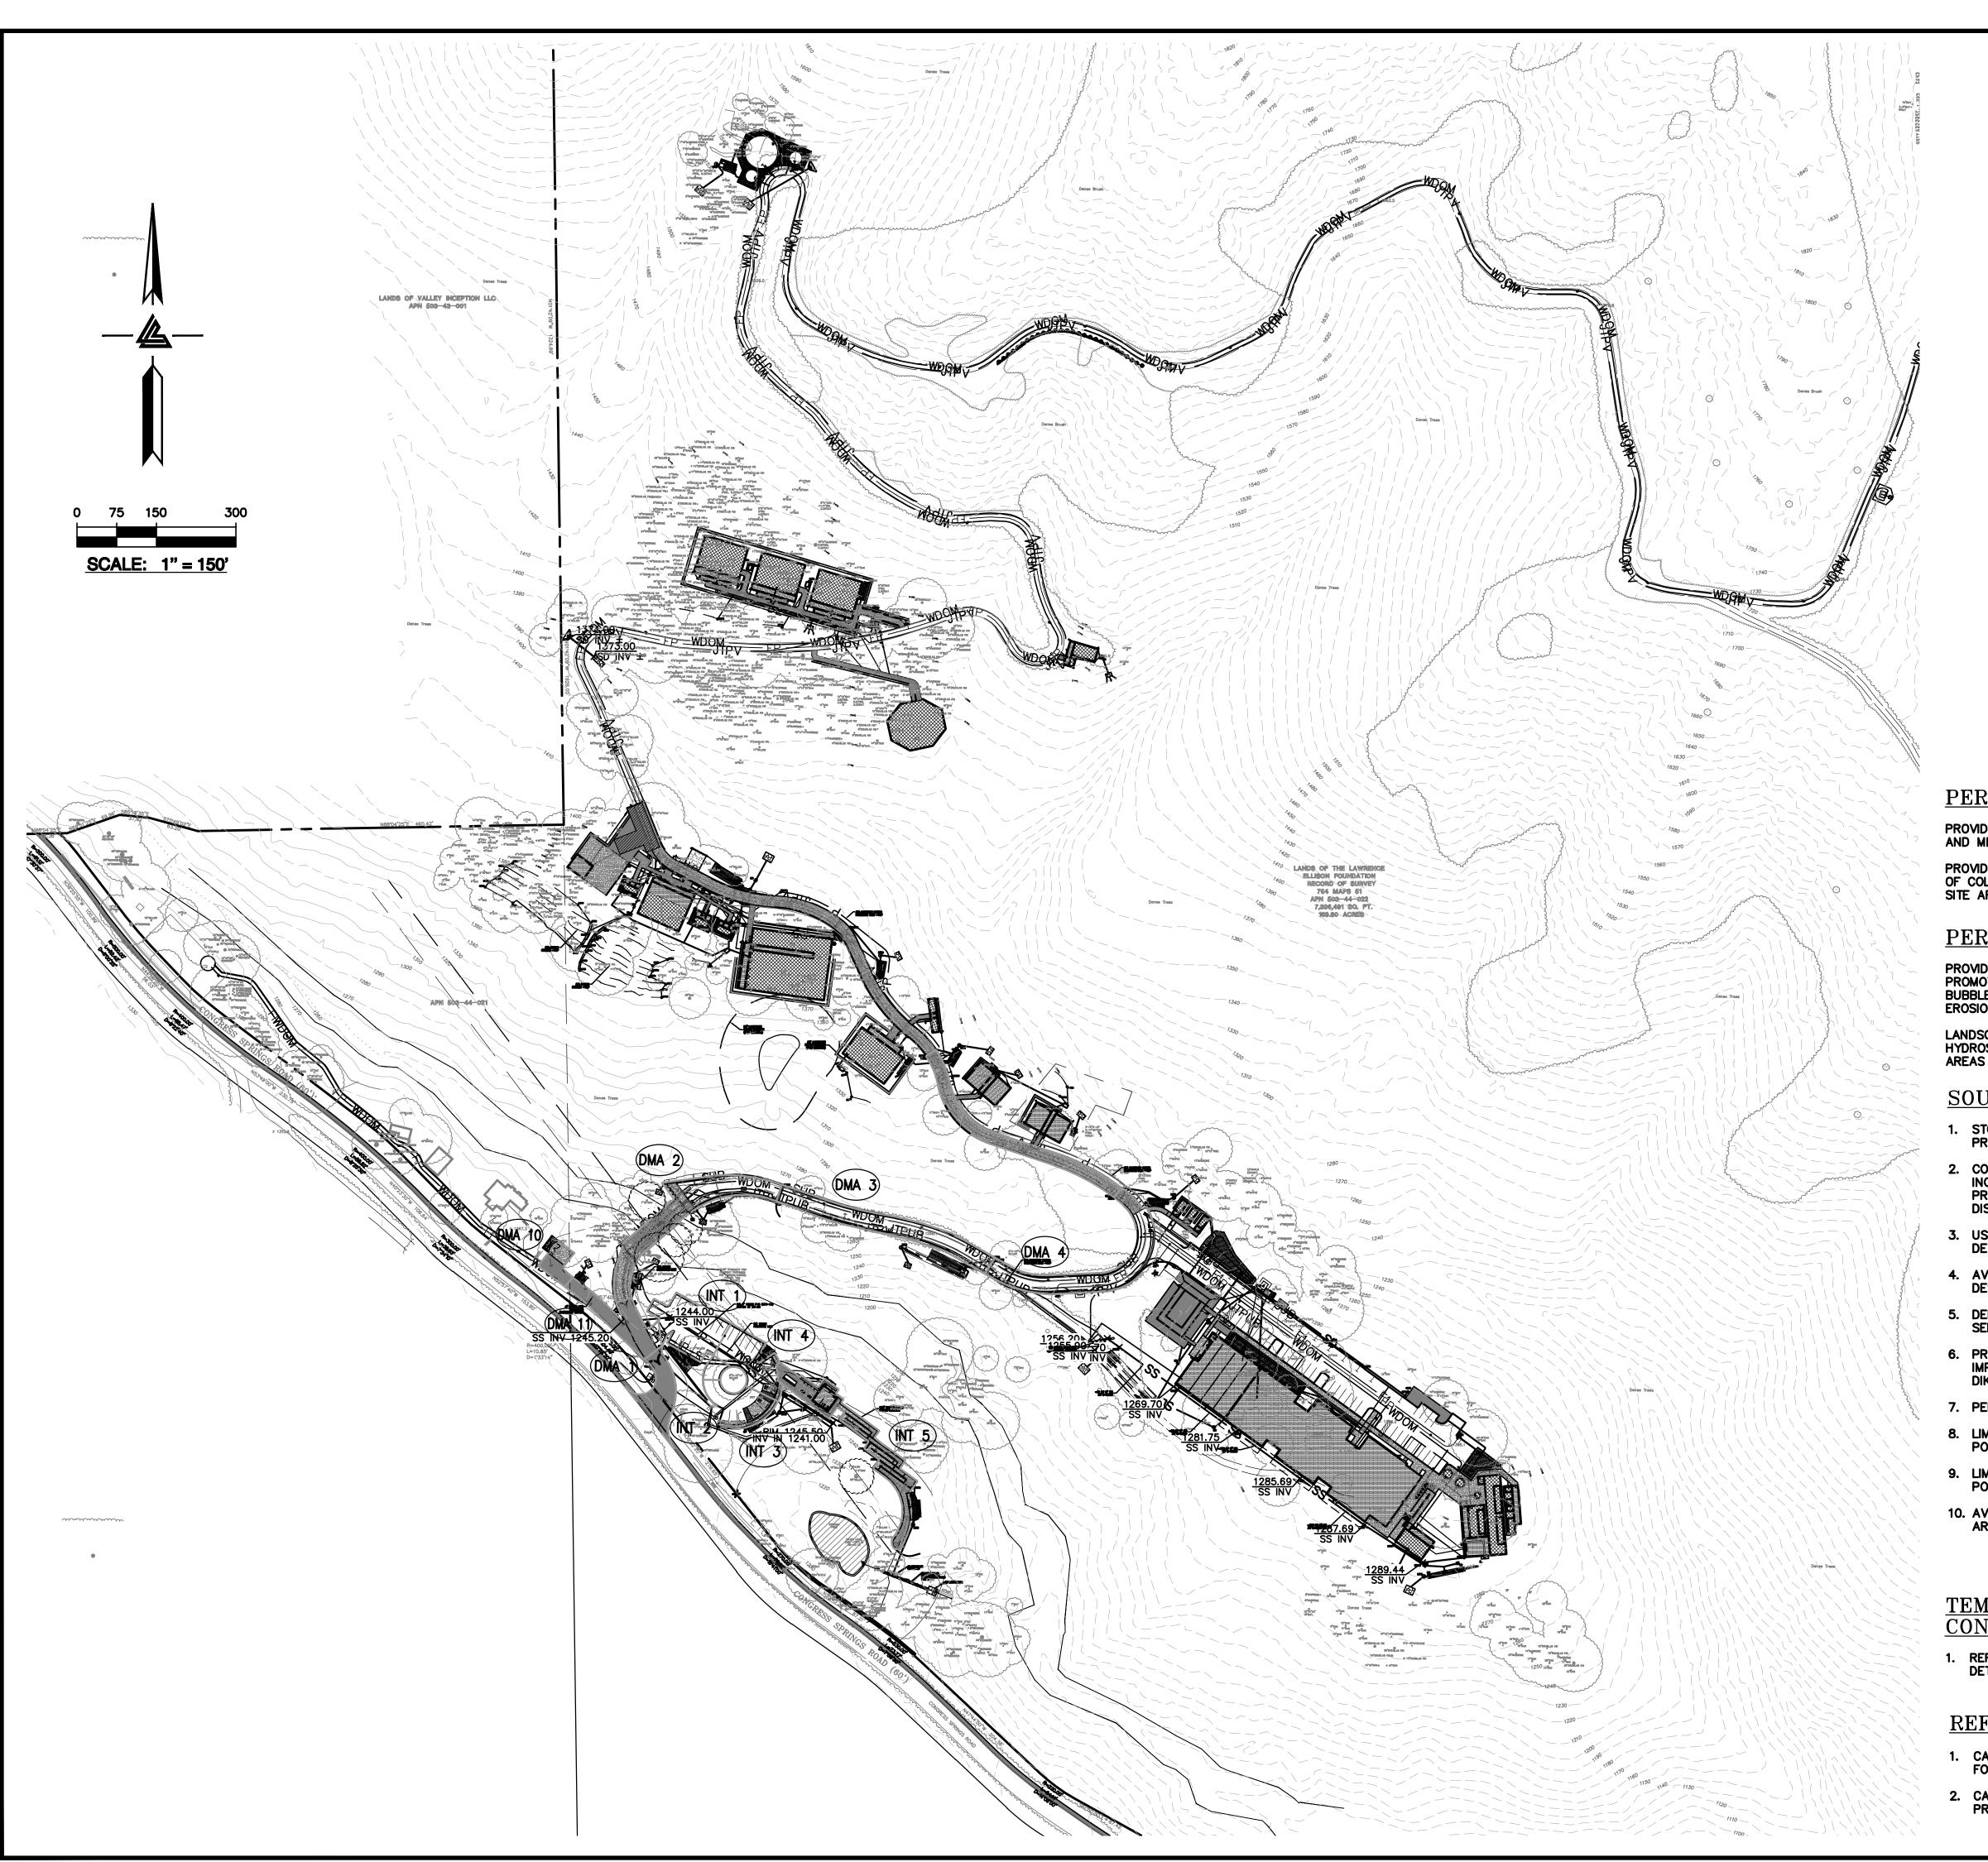

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LEGEND

BIO-RETENTION TREATMENT AREA HEADER BOARD (12" X 2") EDGE

BIO-RETENTION TREATMENT AREA 3:1 SLOPED EDGE BIO-RETENTION TREATMENT AREA LANDSCAPE WALL EDGE

RIP-RAP OUTFALL

DECOMPOSED GRANITE

(PERVIOUS AREA)

DECOMPOSED GRANITE (IMPERVIOUS AREA) REDWOOD HEADER BOARD - 12" X 2"

DIRECTION OF SURFACE DRAINAGE TRENCH DRAIN (TD)

DMA DESIGNAITON

PERMANENT STORMWATER CONTROL MEASURES

PROVIDE AREA DRAINS TO COLLECT LOCALIZED RUNOFF FOR STORM WATER RETENTION AND METERING.

PROVIDE A STORM WATER RETENTION SYSTEM TO RETAIN AND METER THE RELEASE OF COLLECTED STORM WATER TO PREVENT AN INCREASE IN RUNOFF LEAVING THE SITE AFTER CONSTRUCTION.

PERMANENT EROSION CONTROL MEASURES:

PROVIDE AN OPEN BOTTOM FOR THE RETENTION SYSTEM OUTLET BUBBLER TO PROMOTE INFILTRATION OF STORM WATER. PROVIDE ROCK PROTECTION AT THE BUBBLER RIM AND PLANT THE AREA WITH DENSE NATIVE GRASS TO PREVENT

LANDSCAPE ALL DISTURBED AREAS IMMEDIATELY AFTER CONSTRUCTION.
HYDROSEED, PLANT OR PROVIDE PROTECTIVE MULCH TO ALL NON-LANDSCAPED
AREAS TO PROVIDE PERMANENT EROSION CONTROL.

SOURCE CONTROL MEASURES:

- 1. STORE, HANDLE, AND DISPOSE OF CONSTRUCTION MATERIALS AND WASTES PROPERLY, SO AS TO PREVENT THEIR CONTACT WITH STORMWATER.
- CONTROL AND PREVENT THE DISCHARGE OF ALL POTENTIAL POLLUTANTS, INCLUDING PAVEMENT CUTTING WASTES, PAINTS, CONCRETE, PETROLEUM PRODUCTS, CHEMICALS, WASHWATER OF SEDIMENTS, AND NON-STORMWATER DISCHARGES TO STORM DRAINS AND WATERCOURSES.
- USE SEDIMENT CONTROLS OR FILTRATION TO REMOVE SEDIMENT WHEN DEWATERING SITE AND OBTAIN ALL NECESSARY PERMITS.
- 4. AVOID CLEANING, FUELING, OR MAINTAINING VEHICLES ON-SITE, EXCEPT IN A DESIGNATED AREA WHERE WASHWATER IS CONTAINED AND TREATED.
- 5. DELINEATE WITH FIELD MARKERS LIMITS ON CLEARING, EASEMENTS, SETBACKS, SENSITIVE OR CRITICAL AREAS, BUFFER ZONES, TREES AND DRAINAGE COURSES.
- 6. PROTECT ADJACENT PROPERTIES AND UNDISTURBED AREAS FROM CONSTRUCTION IMPACTS USING VEGETATIVE BUFFER STRIPS, SEDIMENT BARRIERS OR FILTERS, DIKES, MULCHING, OR OTHER MEASURES AS APPROPRIATE.
- 7. PERFORM CLEARING AND EARTH MOVING ACTIVITIES ONLY DURING DRY WEATHER.
- 8. LIMIT AND TIME APPLICATIONS OF PESTICIDES AND FERTILIZERS TO PREVENT POLLUTED RUNOFF.
- 9. LIMIT CONSTRUCTION ACCESS ROUTES AND STABILIZE DESIGNATED ACCESS
- 10. AVOID TRACKING DIRT OR OTHER MATERIALS OFF-SITE. CLEAN OFF-SITE PAVED AREAS AND SIDEWALKS USING DRY SWEEPING METHODS.

TEMPORARY STORM WATER & EROSION **CONTROL MEASURES:**

1. REFER TO THE CIVIL ENGINEERING PLANS, SHEETS C-9.0-9.35, FOR DETAILED CONSTRUCTION CONTROL MEASURES AND PRACTICES.

REFERENCES:

- CALIFORNIA REGIONAL WATER QUALITY CONTROL BOARD'S FIELD MANUAL FOR EROSION AND SEDIMENTATION CONTROL
- 2. CALIFORNIA STORM WATER QUALITY ASSOCIATION BEST MANAGEMENT PRACTICES HANDBOOK FOR CONSTRUCTION

ELLISON CONSERVATION CENTER FOR WILDLIFE CARE





ISSUES AND REVISIONS

GRADING PERMIT PLAN CHECK 4

12-21-18 PERMIT RESUBMITTAL PERMIT MODIFICATION

04-11-19 ASA DELTA 2 04-22-19 BID SET

05-22-19 UTILITY PLAN CHECK 1

08-06-19 PHASE 4 - PERMIT SUBMITTAL 09-20-19 CONSTRUCTION SET 1

01-28-20 PERMIT MODIFICATION 2 05-29-20 PLAN CHECK RESPONSE PERMIT MODIFICATION 2

07-22-20 UTILITY PLAN SUBMITTAL

SANTA CLARA COUNTY **RECORD INFORMATION** APPLICANT: PENINSULA HUMANE SOCIETY

ROAD: CONGRESS SPRINGS LDE FILE: 6943-17-17G GRADING PERMIT: DEV19-1838

UTILITY PERMIT: DEV19-0220

PROJECT NUMBER 16011.00

SHEET TITLE


STORMWATER TREATMENT PLAN

1" = 150' PC / CA

PC / JL 2130712

SHEET NUMBER



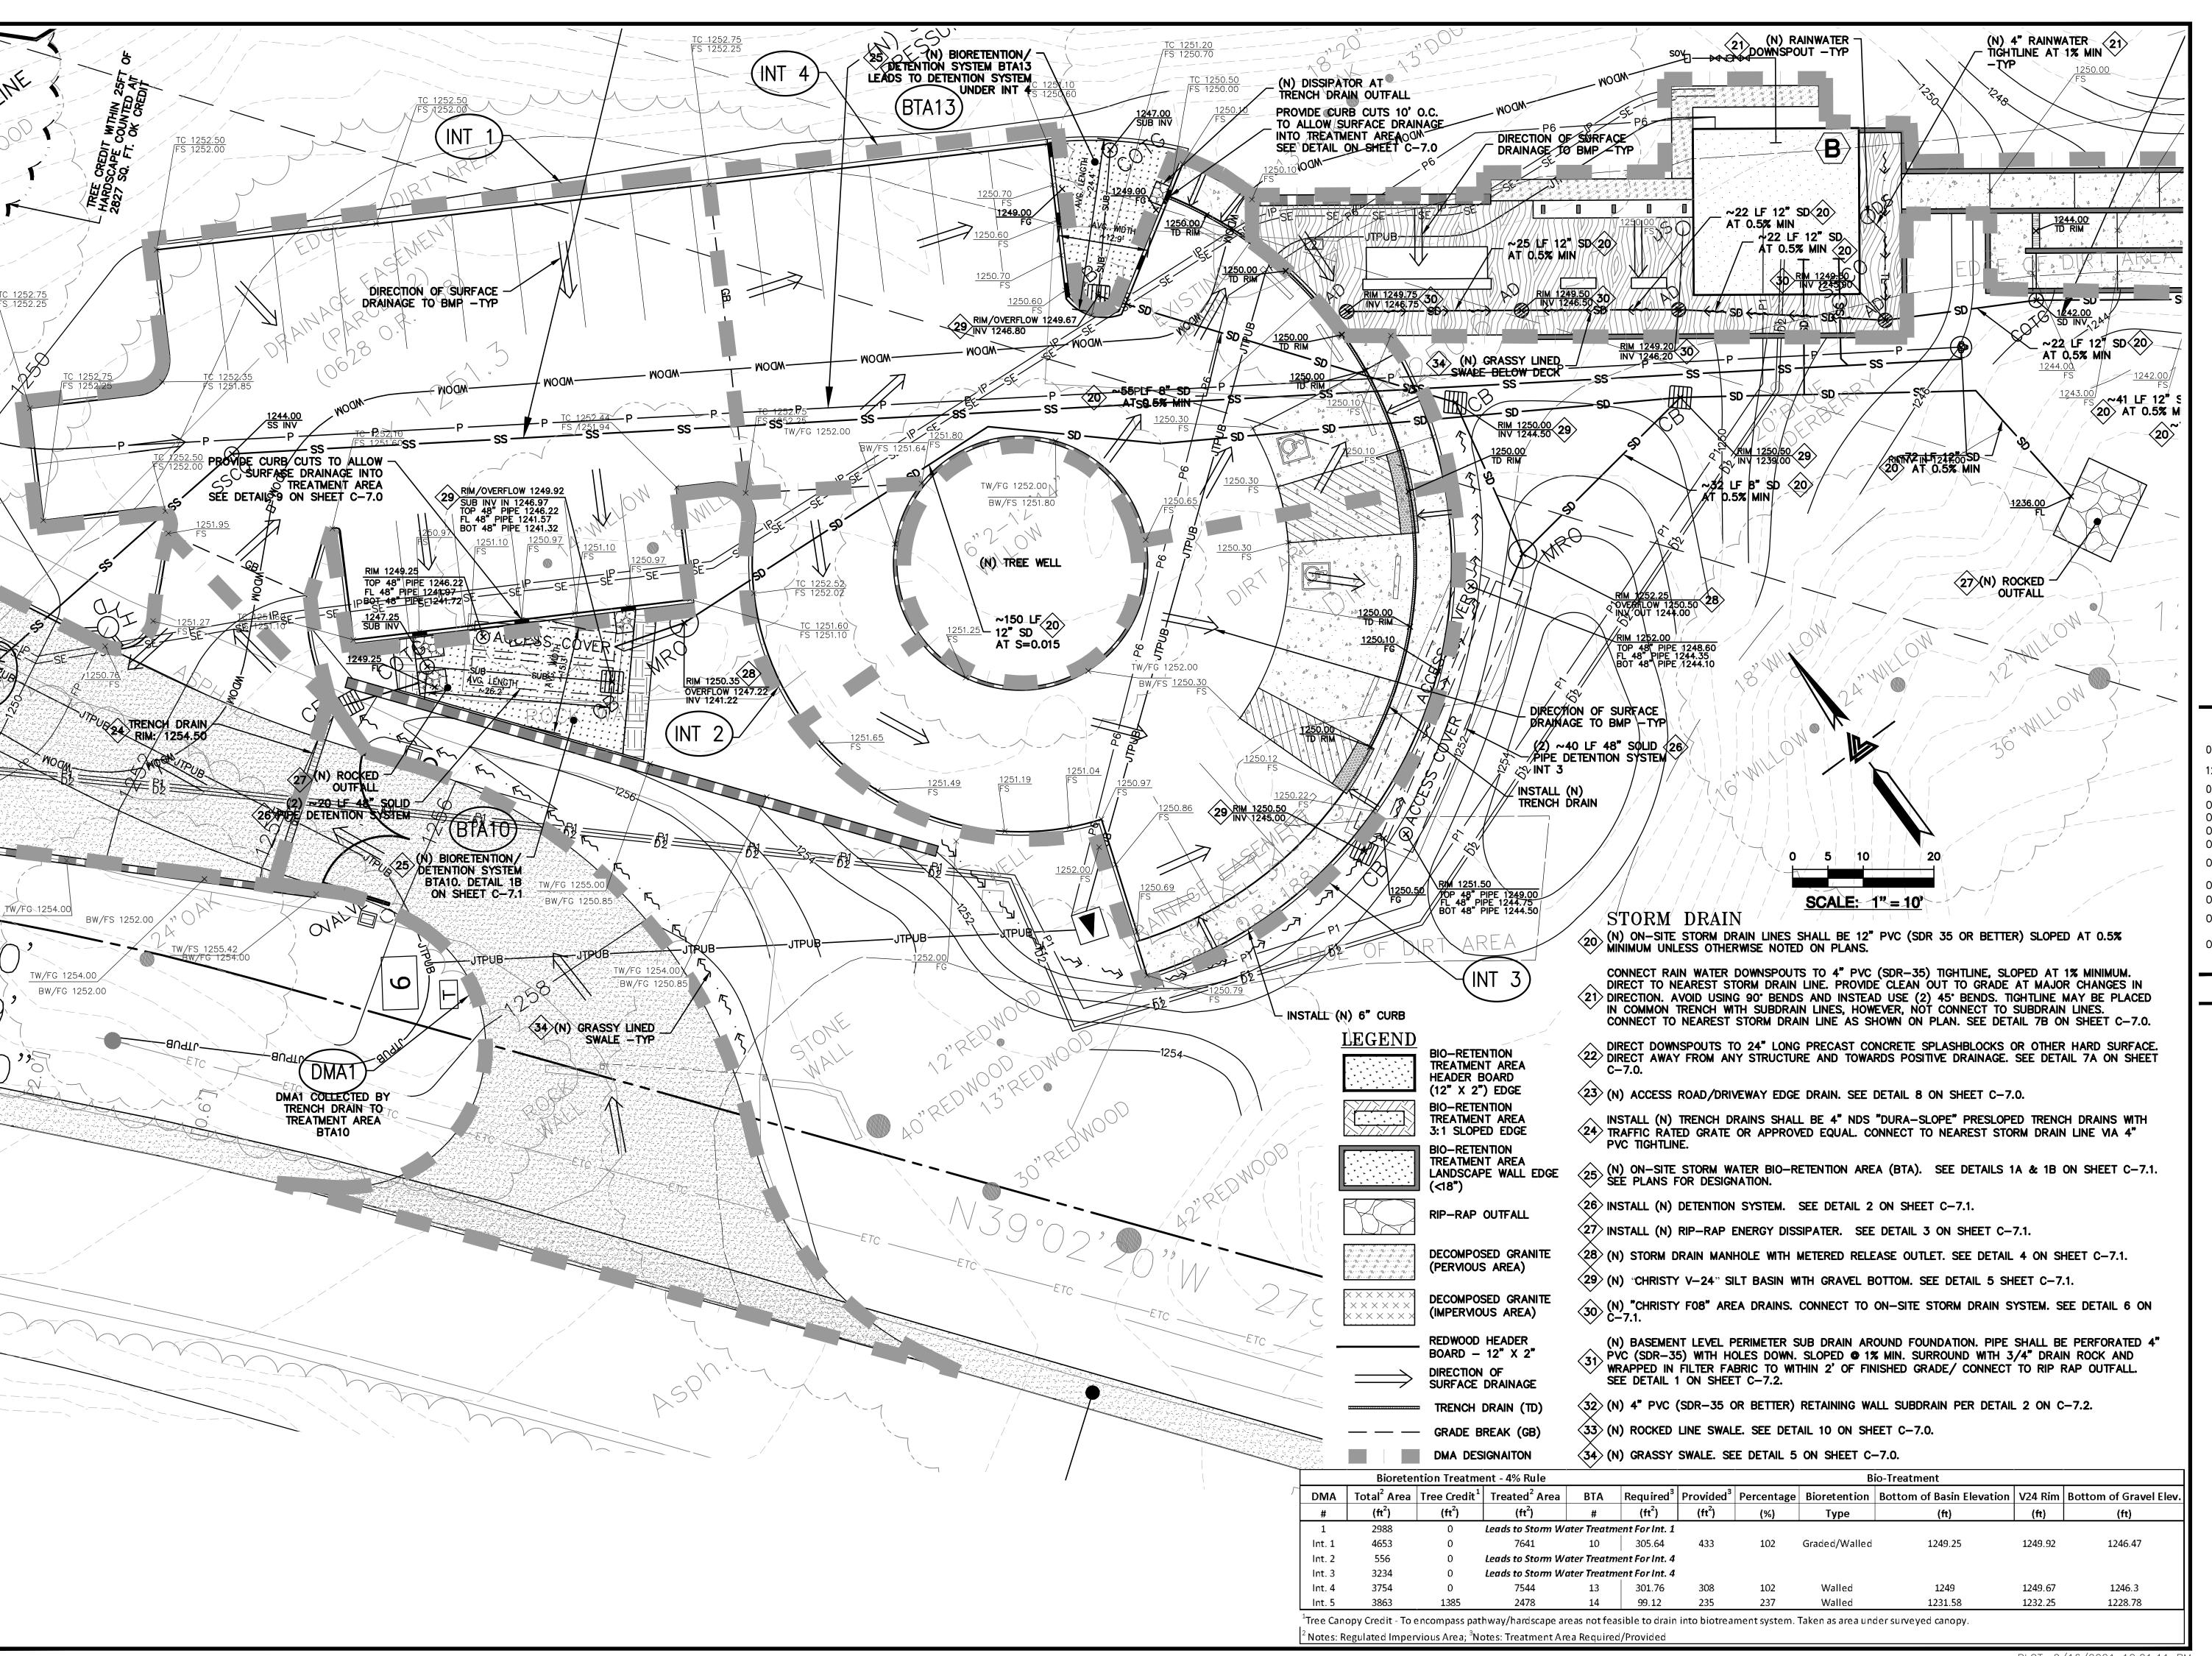

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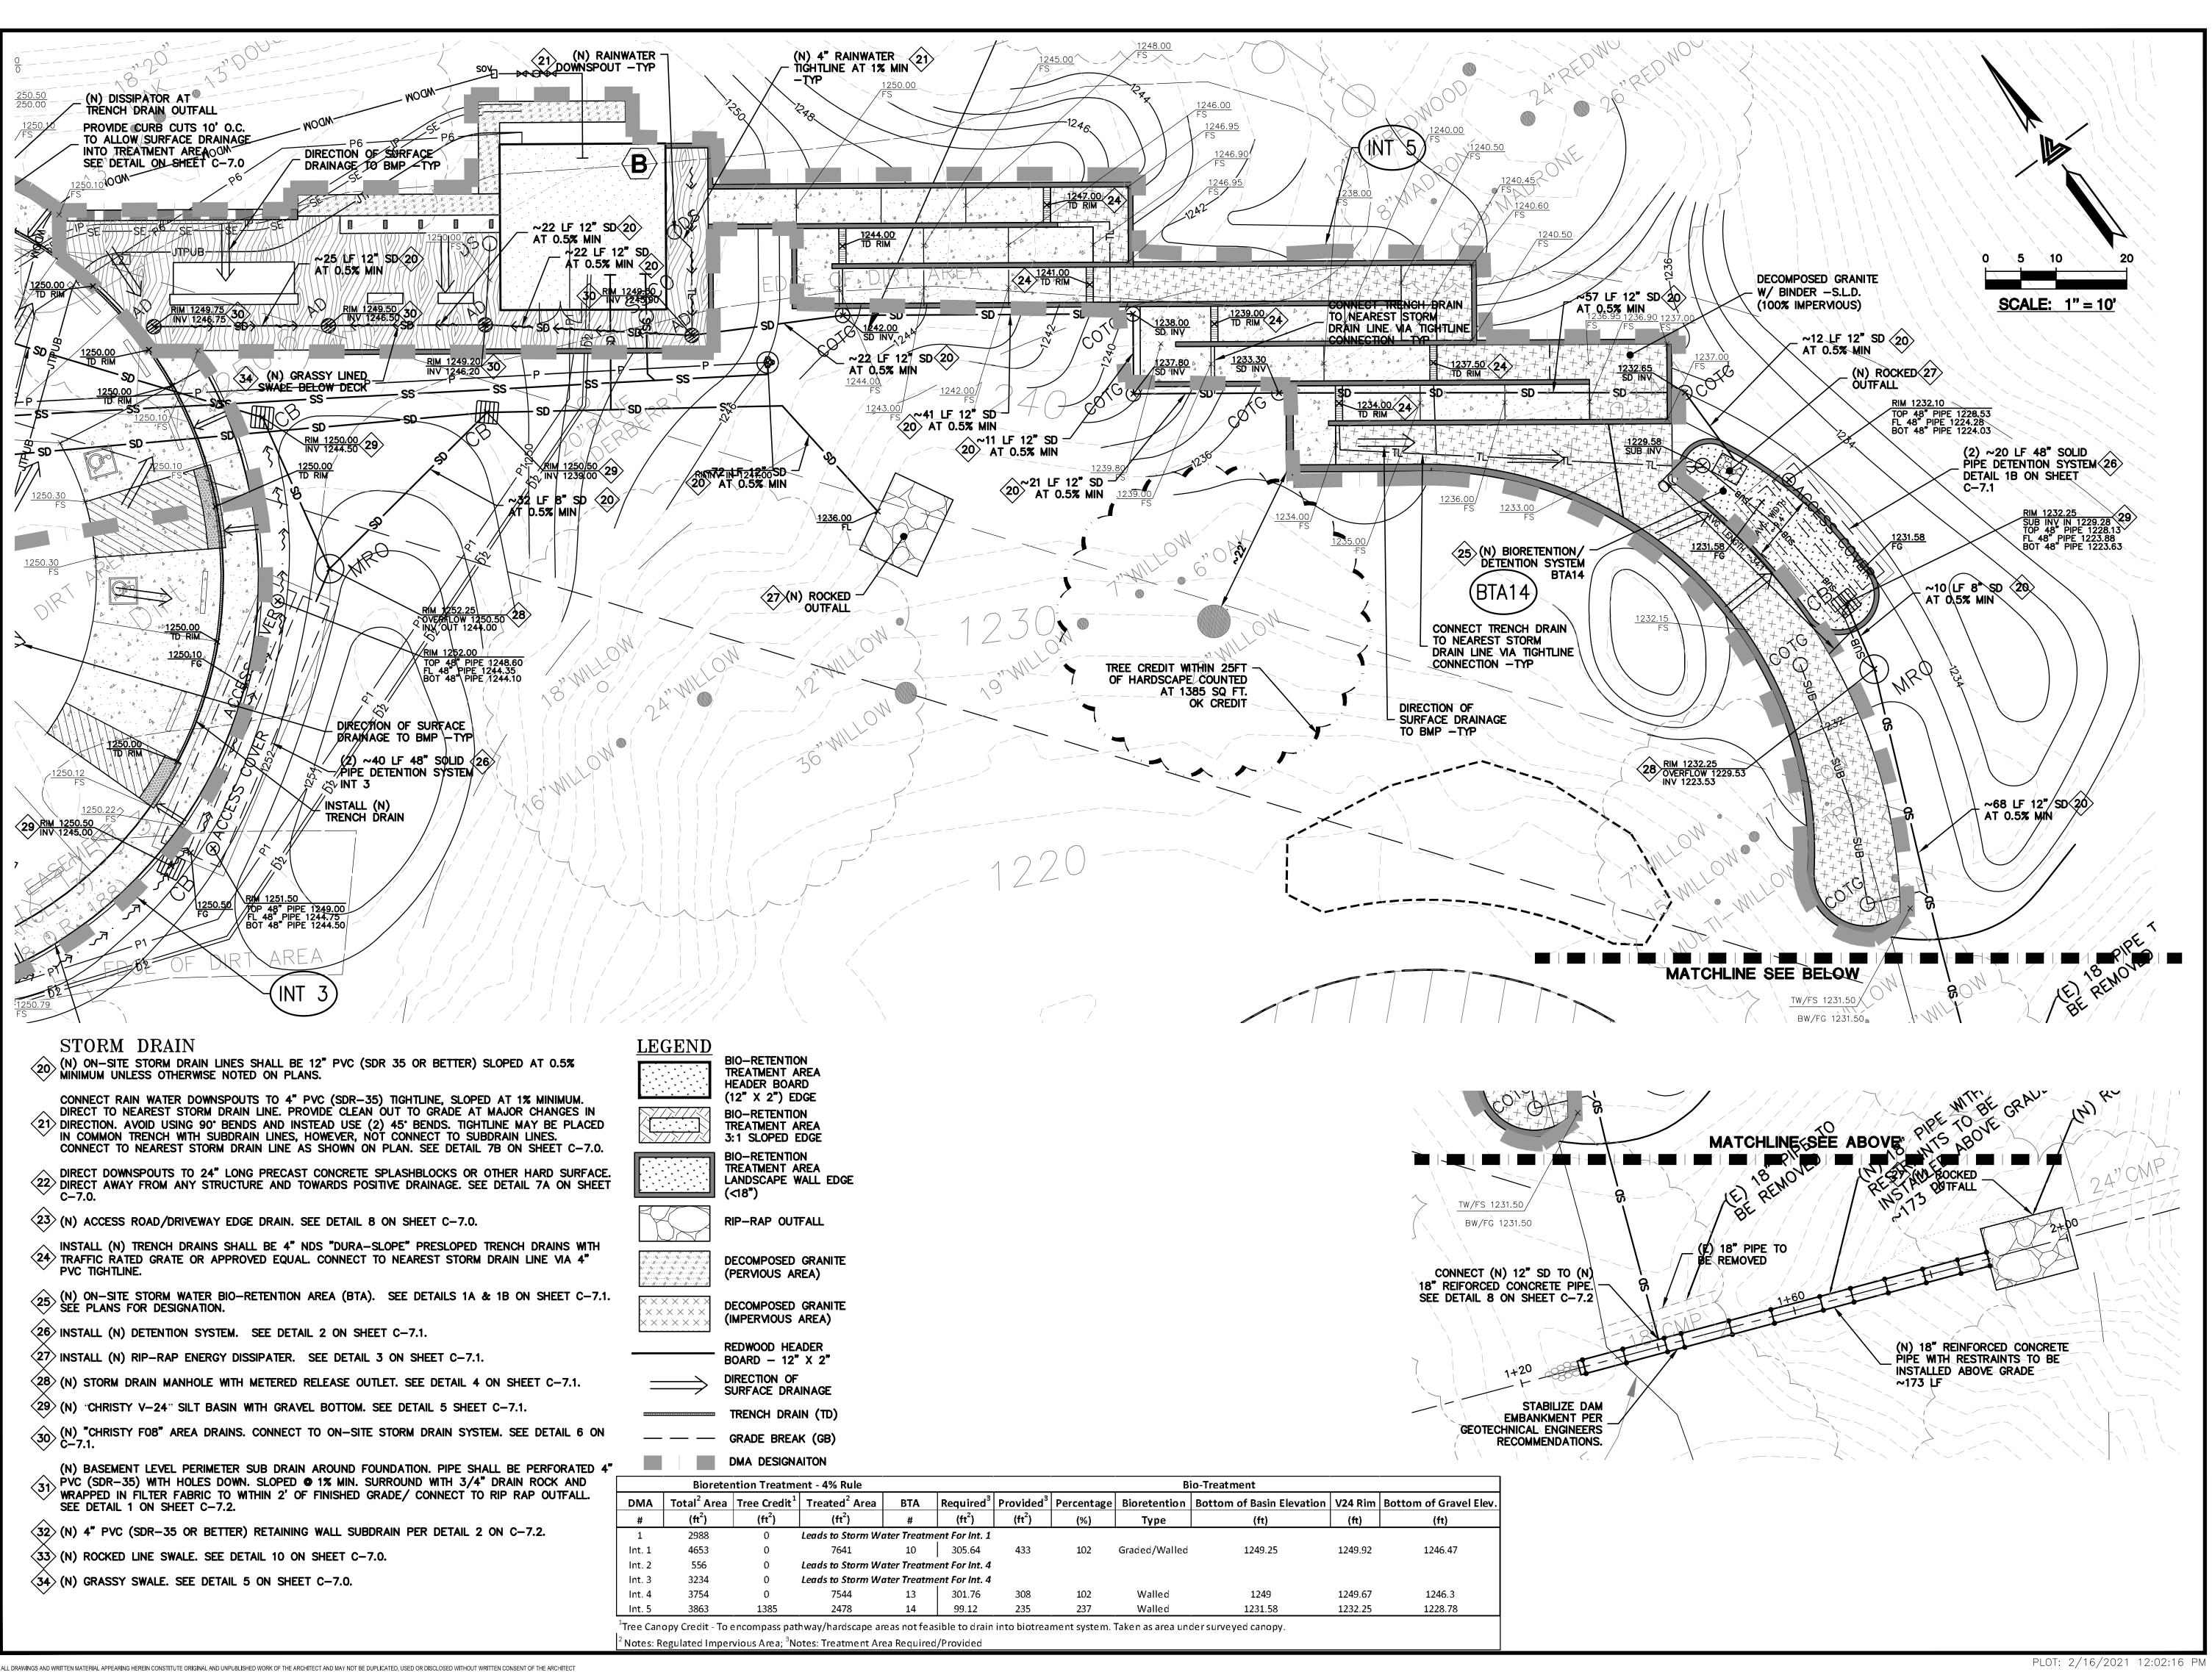
SHEET TITLE

STORMWATER TREATMENT PLAN

SCALE 1" = 10' PC / CA Checked By PC / JL 2130712

SHEET NUMBER

C-10.1







ARCHITECTS



GRADING PERMIT PLAN CHECK 4 12-21-18 PERMIT RESUBMITTAL PERMIT MODIFICATION

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SANTA CLARA COUNTY **RECORD INFORMATION** APPLICANT: PENINSULA HUMANE SOCIETY

ROAD: CONGRESS SPRINGS LDE FILE: 6943-17-17G GRADING PERMIT: DEV19-1838 UTILITY PERMIT: DEV19-0220

> PROJECT NUMBER 16011.00

> > SHEET TITLE

STORMWATER TREATMENT PLAN


SCALE 1" = 10' PC / CA Checked By PC / JL

2130712

SHEET NUMBER

ASA/USE PERMIT MODIFICATION #3

PLN-17-6943

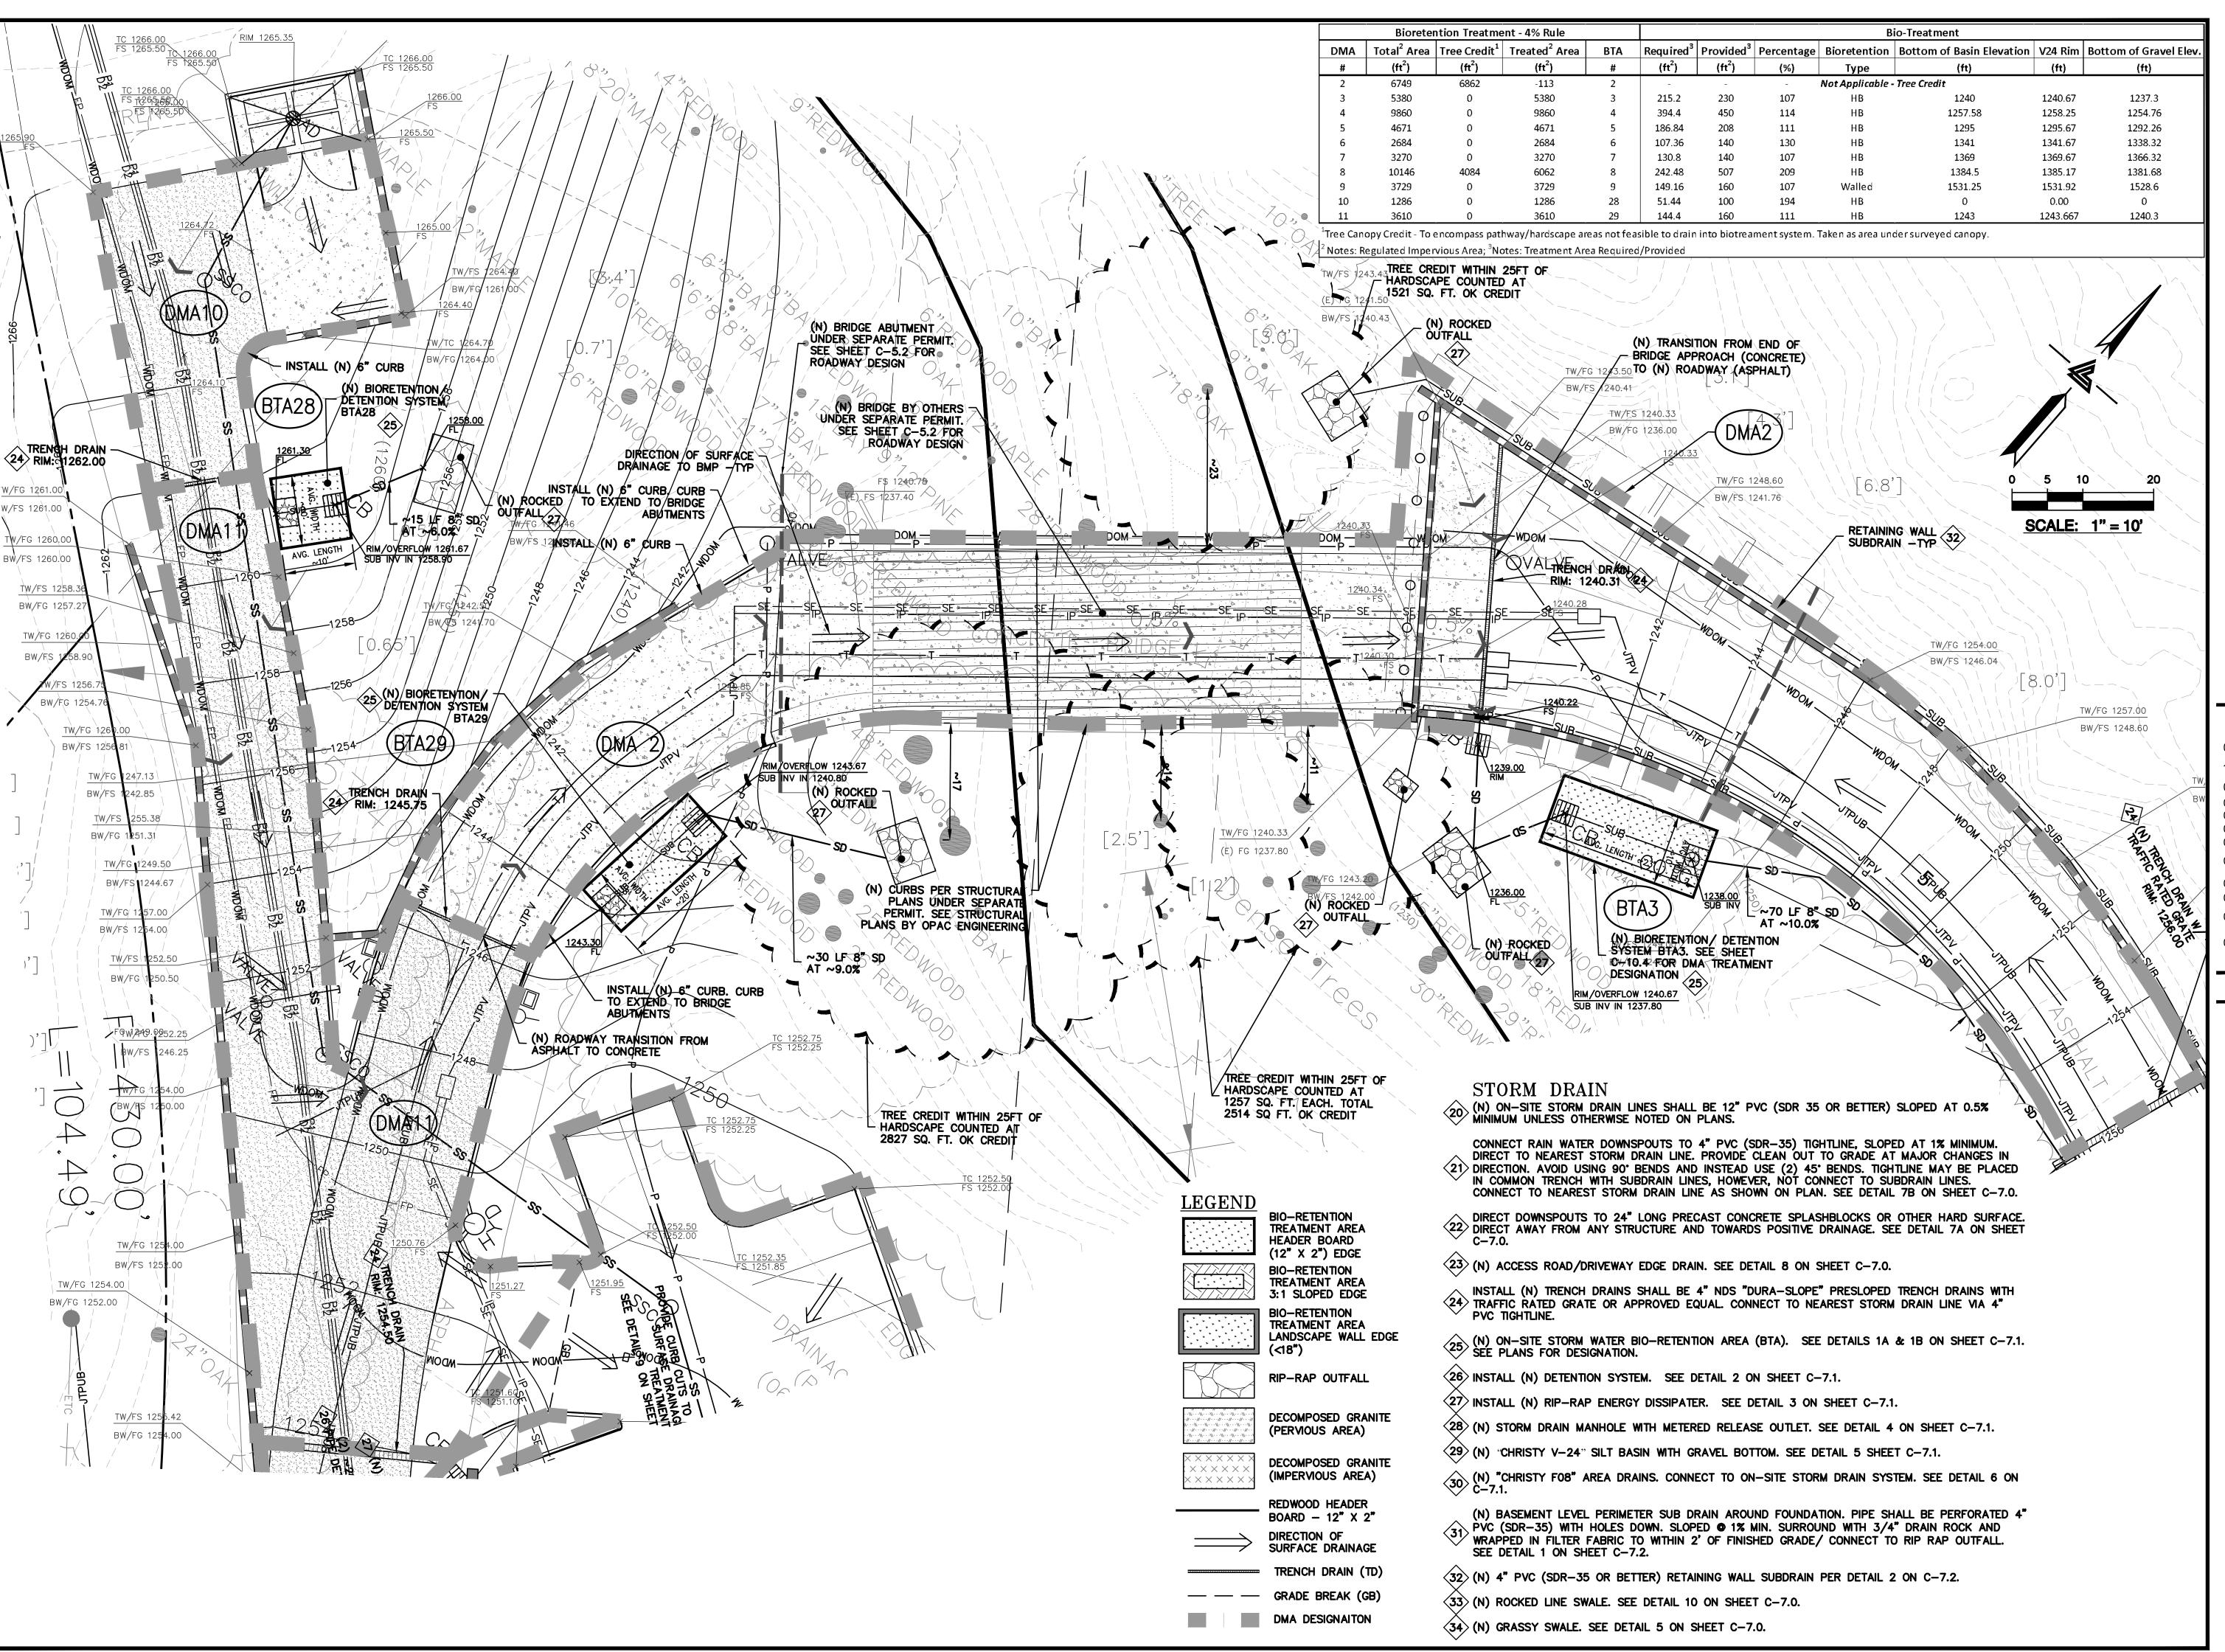





ISSUES AND REVISIONS GRADING PERMIT

PLAN CHECK 4 12-21-18 PERMIT RESUBMITTAL PERMIT MODIFICATION 04-11-19 ASA DELTA 2

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ROAD: CONGRESS SPRINGS LDE FILE: 6943-17-17G GRADING PERMIT: DEV19-1838 UTILITY PERMIT: DEV19-0220


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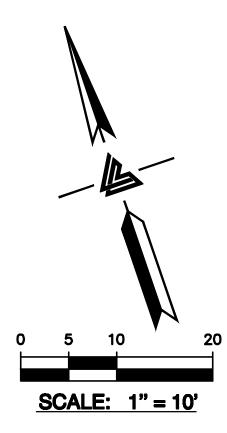
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SCALE 1" = 10' PC / CA PC / JL 2130712

SHEET NUMBER





STORM DRAIN

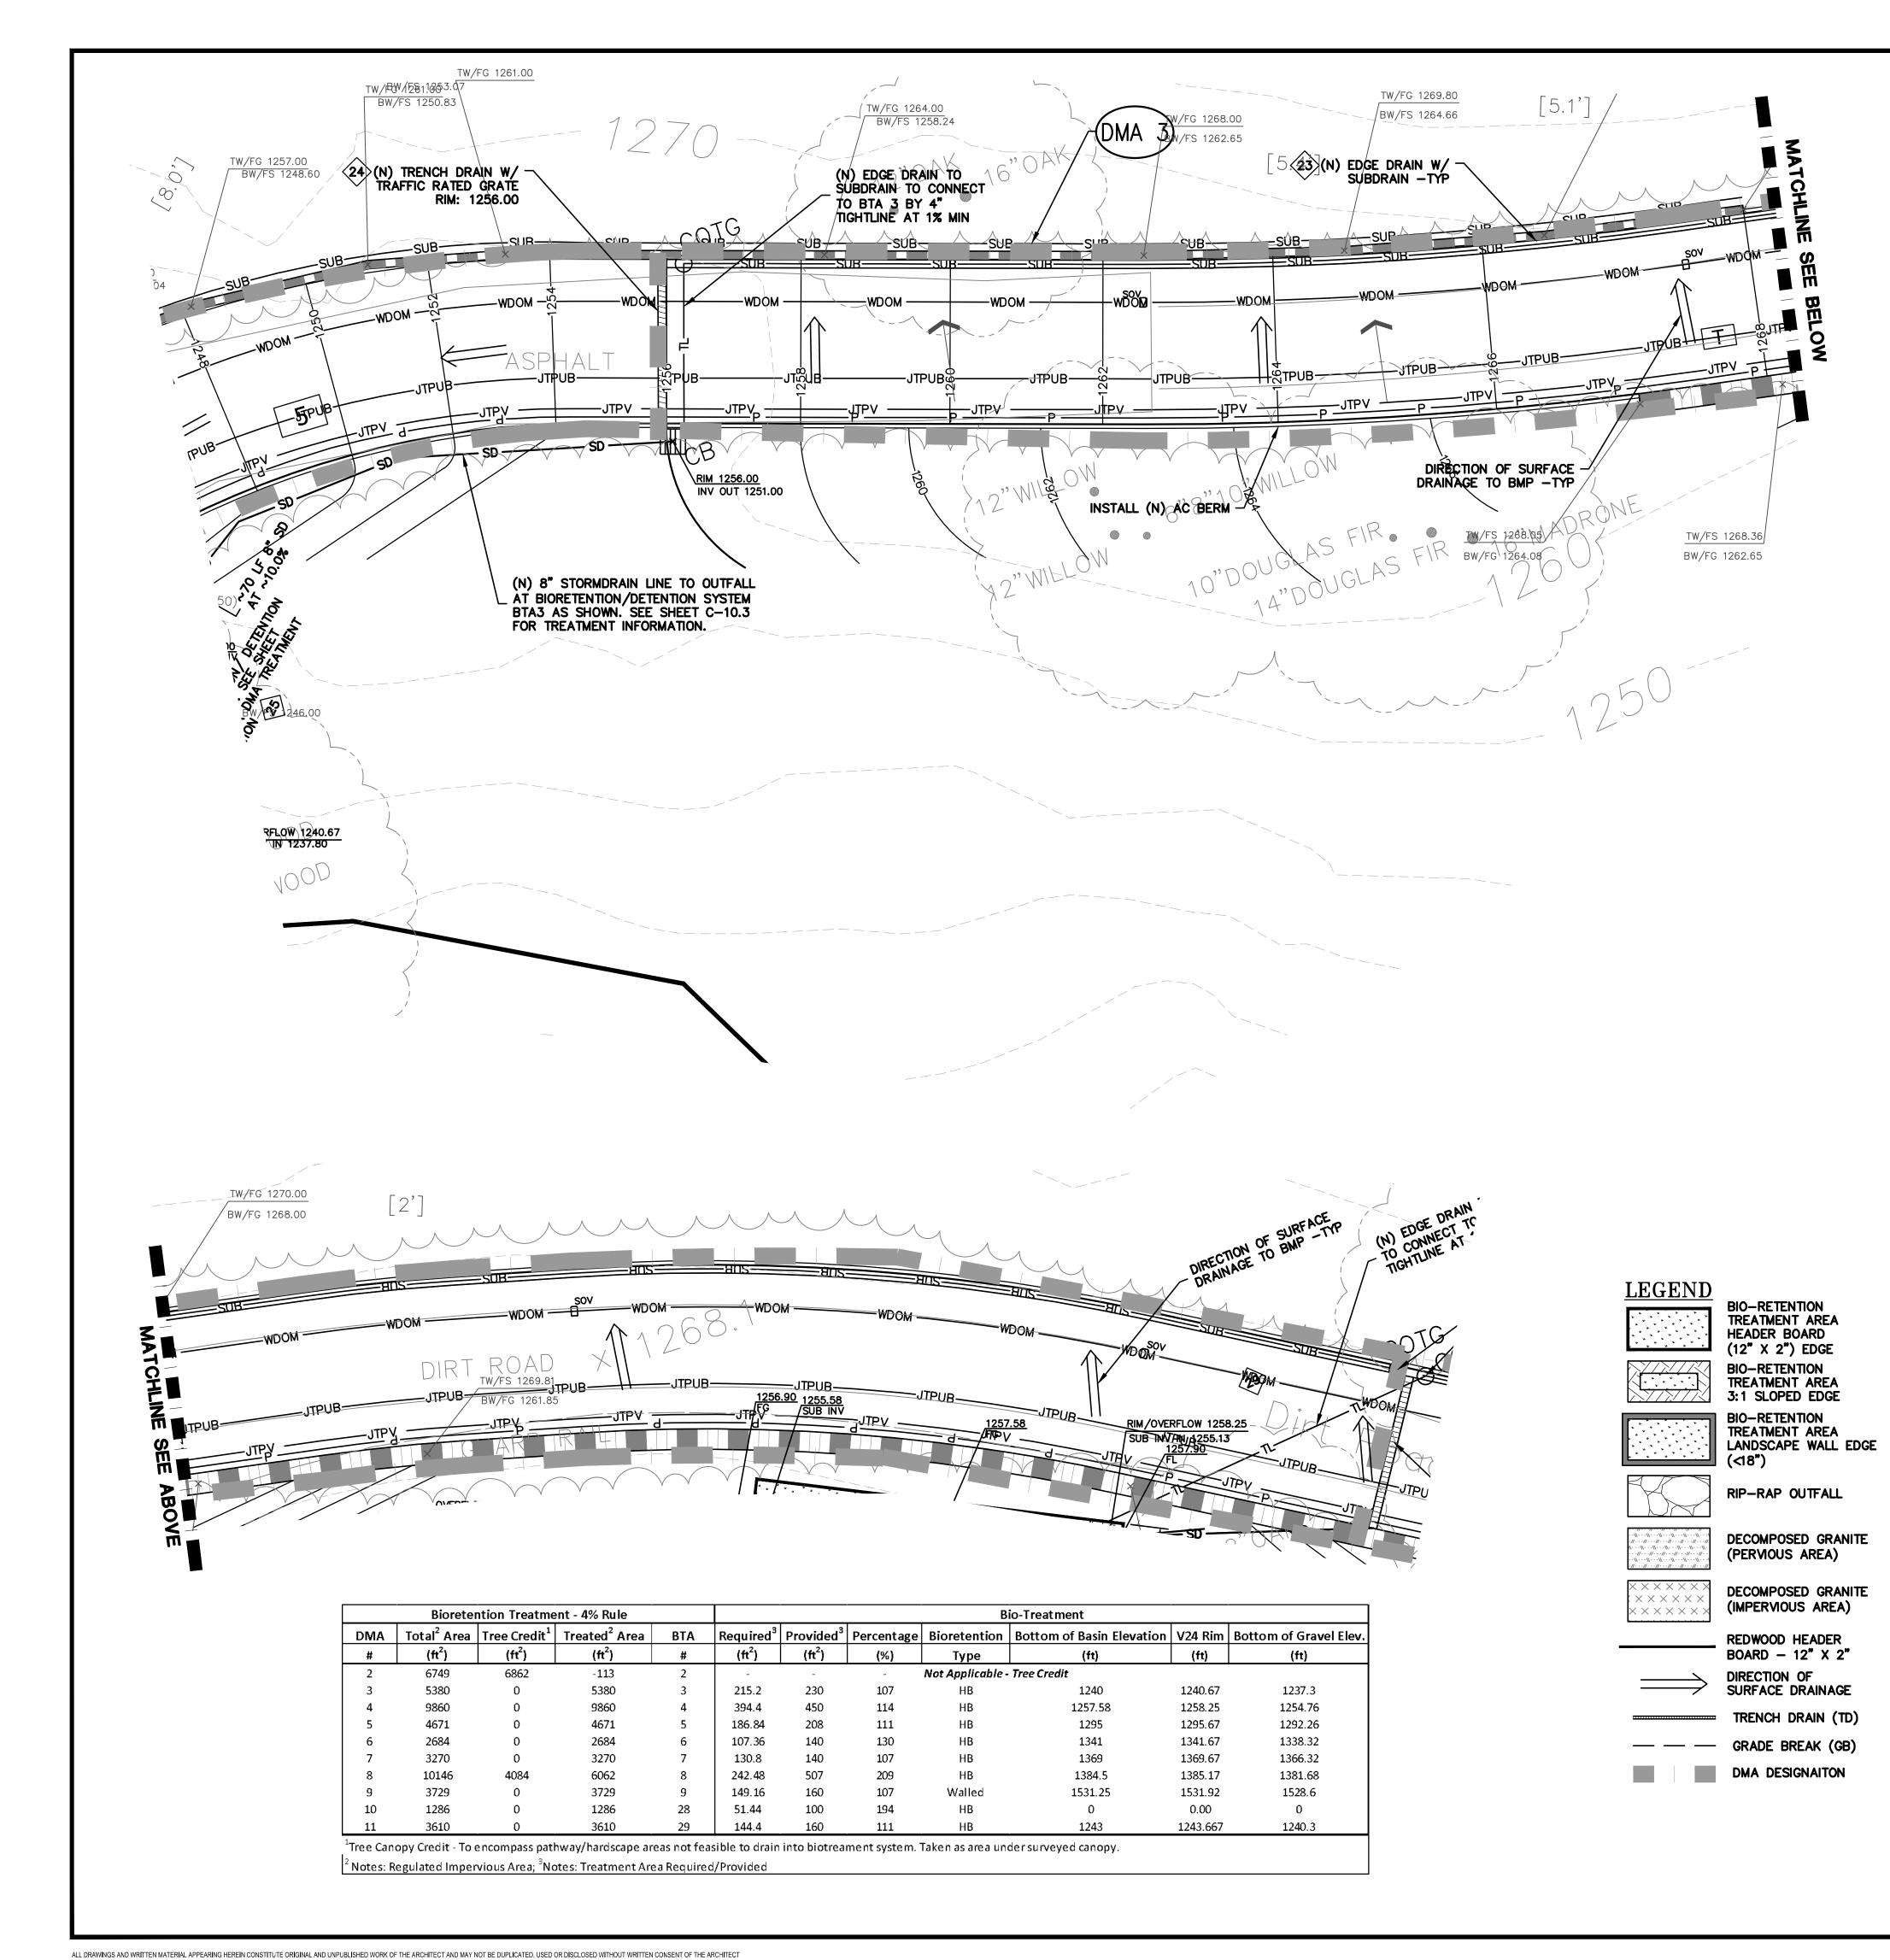(N) ON-SITE STORM DRAIN LINES SHALL BE 12" PVC (SDR 35 OR BETTER) SLOPED AT 0.5% MINIMUM UNLESS OTHERWISE NOTED ON PLANS.

CONNECT RAIN WATER DOWNSPOUTS TO 4" PVC (SDR-35) TIGHTLINE, SLOPED AT 1% MINIMUM. DIRECT TO NEAREST STORM DRAIN LINE. PROVIDE CLEAN OUT TO GRADE AT MAJOR CHANGES IN DIRECTION. AVOID USING 90° BENDS AND INSTEAD USE (2) 45° BENDS. TIGHTLINE MAY BE PLACED IN COMMON TRENCH WITH SUBDRAIN LINES, HOWEVER, NOT CONNECT TO SUBDRAIN LINES. CONNECT TO NEAREST STORM DRAIN LINE AS SHOWN ON PLAN. SEE DETAIL 7B ON SHEET C-7.0.

- DIRECT DOWNSPOUTS TO 24" LONG PRECAST CONCRETE SPLASHBLOCKS OR OTHER HARD SURFACE.
 DIRECT AWAY FROM ANY STRUCTURE AND TOWARDS POSITIVE DRAINAGE. SEE DETAIL 7A ON SHEET C-7.0.
- (N) ACCESS ROAD/DRIVEWAY EDGE DRAIN. SEE DETAIL 8 ON SHEET C-7.0.
- INSTALL (N) TRENCH DRAINS SHALL BE 4" NDS "DURA-SLOPE" PRESLOPED TRENCH DRAINS WITH TRAFFIC RATED GRATE OR APPROVED EQUAL. CONNECT TO NEAREST STORM DRAIN LINE VIA 4" PVC TIGHTLINE.
- (N) ON-SITE STORM WATER BIO-RETENTION AREA (BTA). SEE DETAILS 1A & 1B ON SHEET C-7.1. SEE PLANS FOR DESIGNATION.
- 26 INSTALL (N) DETENTION SYSTEM. SEE DETAIL 2 ON SHEET C-7.1.
- 27 INSTALL (N) RIP-RAP ENERGY DISSIPATER. SEE DETAIL 3 ON SHEET C-7.1.
- (N) STORM DRAIN MANHOLE WITH METERED RELEASE OUTLET. SEE DETAIL 4 ON SHEET C-7.1.
- (29) (N) "CHRISTY V-24" SILT BASIN WITH GRAVEL BOTTOM. SEE DETAIL 5 SHEET C-7.1.
- (N) "CHRISTY FO8" AREA DRAINS. CONNECT TO ON-SITE STORM DRAIN SYSTEM. SEE DETAIL 6 ON C-7.1.
- (N) BASEMENT LEVEL PERIMETER SUB DRAIN AROUND FOUNDATION. PIPE SHALL BE PERFORATED 4"
 PVC (SDR-35) WITH HOLES DOWN. SLOPED © 1% MIN. SURROUND WITH 3/4" DRAIN ROCK AND
 WRAPPED IN FILTER FABRIC TO WITHIN 2' OF FINISHED GRADE/ CONNECT TO RIP RAP OUTFALL.
 SEE DETAIL 1 ON SHEET C-7.2.
- (32) (N) 4" PVC (SDR-35 OR BETTER) RETAINING WALL SUBDRAIN PER DETAIL 2 ON C-7.2.
- (33) (N) ROCKED LINE SWALE. SEE DETAIL 10 ON SHEET C-7.0.
- (N) GRASSY SWALE. SEE DETAIL 5 ON SHEET C-7.0.

ELLISON CONSERVATION CENTER FOR WILDLIFE CARE





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(F) (510) 887-3019

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07-22-20 UTILITY PLAN
SUBMITTAL

GRADING PERMIT: DEV19-1838

SANTA CLARA COUNTY RECORD INFORMATION APPLICANT: PENINSULA HUMANE SOCIETY ROAD: CONGRESS SPRINGS LDE FILE: 6943-17-17G

UTILITY PERMIT: DEV19-0220
PROJECT NUMBER

PROJECT NUMBER 16011.00

SHEET TITLE

STORMWATER TREATMENT PLAN

SCALE 1" = 10'Designed By PC / CA
Checked By PC / JL
LB Job No. 2130712


SHEET NUMBER



Bioretention Treatment - 4% Rule	
5 4671 0 4671 5 186.84 208 111 HB 1295 1295.67 1292.26 6 2684 0 2684 6 107.36 140 130 HB 1341 1341.67 1338.32 7 3270 0 3270 7 130.8 140 107 HB 1369 1369.67 1366.32 8 10146 4084 6062 8 242.48 507 209 HB 1384.5 1385.17 1381.68 9 3729 0 3729 9 149.16 160 107 Walled 1531.25 1531.92 1528.6 10 1286 0 1286 28 51.44 100 194 HB 0 0.00 0	LOTG TO THE STATE OF THE STATE
11 3610 0 3610 29 144.4 160 111 HB 1243 1243.667 1240.3 Tree Canopy Credit - To encompass pathway/hardscape areas not feasible to drain into biotreament system. Taken as area under surveyed canopy. Notes: Regulated Impervious Area; Notes: Treatment Area Required/Provided	
STORM DRAIN (N) ON-SITE STORM DRAIN LINES SHALL BE 12" PVC (SDR 35 OR BETTER) SLOPED AT 0.5% MINIMUM UNLESS OTHERWISE NOTED ON PLANS. LEGEND BIO-RETENTION TREATMENT AREA	23 (N) EDGE DRAIN W/ SUBDRAIN -TYP 0 5 10 20
CONNECT RAIN WATER DOWNSPOUTS TO 4" PVC (SDR-35) TIGHTLINE, SLOPED AT 1% MINIMUM. DIRECT TO NEAREST STORM DRAIN LINE. PROVIDE CLEAN OUT TO GRADE AT MAJOR CHANGES IN DIRECTION. AVOID USING 90° BENDS AND INSTEAD USE (2) 45° BENDS. TIGHTLINE MAY BE PLACED IN COMMON TRENCH WITH SUBDRAIN LINES, HOWEVER, NOT CONNECT TO SUBDRAIN LINES. CONNECT TO NEAREST STORM DRAIN LINE AS SHOWN ON PLAN. SEE DETAIL 7B ON SHEET C-7.0.	DIRECTION OF SURFACE DRAINAGE TO BMP - TYP DRAINAGE TO BMP - TYP
DIRECT DOWNSPOUTS TO 24" LONG PRECAST CONCRETE SPLASHBLOCKS OR OTHER HARD SURFACE. DIRECT AWAY FROM ANY STRUCTURE AND TOWARDS POSITIVE DRAINAGE. SEE DETAIL 7A ON SHEET C-7.0. BIO-RETENTION TREATMENT AREA LANDSCAPE WALL EDGE (<18")	DRAINAGE TO BMF TIP
(N) ACCESS ROAD/DRIVEWAY EDGE DRAIN. SEE DETAIL 8 ON SHEET C-7.0.	
INSTALL (N) TRENCH DRAINS SHALL BE 4" NDS "DURA-SLOPE" PRESLOPED TRENCH DRAINS WITH TRAFFIC RATED GRATE OR APPROVED EQUAL. CONNECT TO NEAREST STORM DRAIN LINE VIA 4" PVC TIGHTLINE. (N) ON-SITE STORM WATER BIO-RETENTION AREA (BTA). SEE DETAILS 1A & 1B ON SHEET C-7.1.	
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27 INSTALL (N) RIP-RAP ENERGY DISSIPATER. SEE DETAIL 3 ON SHEET C-7.1. 28 (N) STORM DRAIN MANHOLE WITH METERED RELEASE OUTLET. SEE DETAIL 4 ON SHEET C-7.1. REDWOOD HEADER BOARD - 12" X 2" DIRECTION OF SURFACE DRAINAGE	Moon 77 1287.25
(N) "CHRISTY V-24" SILT BASIN WITH GRAVEL BOTTOM. SEE DETAIL 5 SHEET C-7.1. TRENCH DRAIN (TD) (N) "CHRISTY F08" AREA DRAINS. CONNECT TO ON-SITE STORM DRAIN SYSTEM. SEE DETAIL 6 ON ———————————————————————————————————	12 d
(N) BASEMENT LEVEL PERIMETER SUB DRAIN AROUND FOUNDATION. PIPE SHALL BE PERFORATED 4" PVC (SDR-35) WITH HOLES DOWN. SLOPED © 1% MIN. SURROUND WITH 3/4" DRAIN ROCK AND WRAPPED IN FILTER FABRIC TO WITHIN 2' OF FINISHED GRADE/ CONNECT TO RIP RAP OUTFALL. SEE DETAIL 1 ON SHEET C-7.2.	TC 1286.64 FL 1286.14 MA 7 CAN 1 TO 1286.89 FL 1286.14
32 (N) 4" PVC (SDR-35 OR BETTER) RETAINING WALL SUBDRAIN PER DETAIL 2 ON C-7.2. 33 (N) ROCKED LINE SWALE. SEE DETAIL 10 ON SHEET C-7.0.	TC 1286.79 FL 1286.29 Mo, S
(N) GRASSY SWALE. SEE DETAIL 5 ON SHEET C-7.0.	FL 1286.29 ON ON ON ON ON ON ON ON ON O
	Solve Moon COTO
SOV SOV	TC 1286.70 MOON F1 CQ
JTPUB TW/FG 1261.85 WDOM BW/FG 1261.85	TW/FG 1289.50 TW/FG 1286.70
JTPV BW/FG 1261.85 JTPUB JTPUB WDOW	78 <u>6.60</u> TC 1287/20 FL 1286.70
OVERFLOW 1255.50 INV 1249.60 MRO 1256.90 INV 1255.68	
TOP 48" PIPE 1254.20 FL 48" PIPE 1249.95 BOT 48" PIPE 1249.70 DIRECTION OF SURFACE DRAINAGE TO BMP - TYP	
ACCESS COVER TO CONNETTIGHTLINE	DRAIN TO SUBDRAIN AT 1% MIN
RIM/OVERFLOW 1258.25 (SUB INV IN 1255.13 (SUB IN 1255.13 (EDGE DRAIN SUBDRAINS SHALL NOT CONNECT. OUTFALL TO CORRESPONDING BTA AS DESIGNATED ON PLANS
AT ~14.5% 20 1250,80 TL TL TL TL TL TL TL TL TL T	(N) EDGE DRAIN W/23 SUBDRAIN -TYP
~80 LF 48" SOLID PIPE ACC ACC ACC ACC ACC ACC ACC A	SUBDRAIN -TYP
(N) ROCKED (N) BIORETENTION/ 1256.00 (N) TRENC	CH DRAIN W/A ATED GRATEO34
(N) ROCKED 27 DETENTION SYSTEM BTA4 BTA4 OUTFALL OUTFALL 25 (N) BIORE IENTION / FG FG TRAFFIC R RIM: 1268 AT 0.5% MIN TOR 48" PIPE 1255.00 FL 48" PIPE 1250.75 BOT 48" PIPE 1250.50	WOOM SUB CHIE CHIE CHIE
	WDOM WDOM WDOM WDOM WDOM SOV NOM WDOM SOV NO
BANK 7	JTPUB
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ELLISON CONSERVATION CENTER FOR WILDLIFE CARE SARATOGA, CA



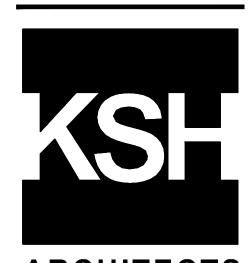

ARCHITECTS KORTH SUNSERI HAGEY

ISSUES AND REVISIONS
DATE DESCRIPTION

09-06-18 GRADING PERMIT PLAN CHECK 4

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05-29-20 PLAN CHECK RESPONSE PERMIT MODIFICATION 2

07-22-20 UTILITY PLAN SUBMITTAL

SANTA CLARA COUNTY RECORD INFORMATION APPLICANT: PENINSULA HUMANE SOCIETY

ROAD: CONGRESS SPRINGS LDE FILE: 6943-17-17G GRADING PERMIT: DEV19-1838 UTILITY PERMIT: DEV19-0220

> PROJECT NUMBER 16011.00

SHEET TITLE

STORMWATER TREATMENT PLAN

SCALE 1" = 10' PC / CA PC / JL 2130712

SHEET NUMBER

C-10.5

ASA/USE PERMIT MODIFICATION #3 PLN-17-6943


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PLOT: 2/16/2021 12:09:28 PM

Bioretention Treatment - 4% Rule DMA Total Area Tree Credit Treated Area BTA Required Provided Percentage Bioretention Bottom of Basin Elevation V24 Rim Bottom of Gravel Elev.		Bio-Treatment Provided Percentage Bioretention Bottom of Basin Elevation V24 Rim Bottom of Grant	rel Elev.
# (ft²) (ft²) # (ft²) (ft²) Type (ft) (ft) (ft) Enc. 1 1500 0 1500 20 60 66 110 Graded/HB 1313.75 1314.50 1311.15 Enc. 2 1500 0 1500 21 60 70 117 Graded/HB 1331.75 1332.50 1329.15	# (ft ²) (ft ²) (ft ²) # (ft ²) 2 6749 6862 -113 2 - 3 5380 0 5380 3 215.2	(ft²) (%) Type (ft) (ft) (ft) - - Not Applicable - Tree Credit 230 107 HB 1240 1240.67 1237.3	27 (N) ROCKED OUTFALL
Enc. 3 389 0 389 23 15.56 125 803 HB 1355.25 1355.92 1352.55 Enc. 4 705 0 2115 24 84.6 87 103 Walled 1420 1420.67 1417.4 Enc. 5 705 0 Leads to Storm Water Treatment For Enclosure 4	4 9860 0 9860 4 394.4 5 4671 0 4671 5 186.84 6 2684 0 2684 6 107.36	450 114 HB 1257.58 1258.25 1254.76 208 111 HB 1295 1295.67 1292.26 140 130 HB 1341 1341.67 1338.32	1286.00
Enc. 6 705 0 Leads to Storm Water Treatment For Enclosure 4 Enc. 7 397 0 397 27 15.88 25 157 Graded/HB 1439.75 1440.50 1437.14	7 3270 0 3270 7 130.8 8 10146 4084 6062 8 242.48	140 107 HB 1369 1369.67 1366.32 507 209 HB 1384.5 1385.17 1381.68	FL S
¹ Tree Canopy Credit - To encompass pathway/hardscape areas not feasible to drain into biotreament system. Taken as area under surveyed canopy. 2 Notes: Regulated Impervious Area; ³ Notes: Treatment Area Required/Provided	9 3729 0 3729 9 149.16 10 1286 0 1286 28 51.44 11 3610 0 3610 29 144.4	160 107 Walled 1531.25 1531.92 1528.6 100 194 HB 0 0.00 0 160 111 HB 1243 1243.667 1240.3	20 ~38 LF 8" SD — 8
$\begin{array}{c} {\rm STORM~DRAIN} \\ \hline \text{(n) on-site storm drain lines shall be 12" PVC (SDR 35 or Better) sloped at 0.5\%} \\ \text{Minimum unless otherwise noted on plans.} \end{array}$	¹ Tree Canopy Credit - To encompass pathway/hardscape areas not feasible to drain Notes: Regulated Impervious Area; ³ Notes: Treatment Area Required/Provided	into biotreament system. Taken as area under surveyed canopy.	22 ON
CONNECT RAIN WATER DOWNSPOUTS TO 4" PVC (SDR-35) TIGHTLINE, SLOPED AT 1% MINIMUM.		É	1293.80 FG FG
DIRECT TO NEAREST STORM DRAIN LINE. PROVIDE CLEAN OUT TO GRADE AT MAJOR CHANGES IN 21 DIRECTION. AVOID USING 90° BENDS AND INSTEAD USE (2) 45° BENDS. TIGHTLINE MAY BE PLACED IN COMMON TRENCH WITH SUBDRAIN LINES, HOWEVER, NOT CONNECT TO SUBDRAIN LINES. CONNECT TO NEAREST STORM DRAIN LINE AS SHOWN ON PLAN. SEE DETAIL 7B ON SHEET C-7.0.	BIO-RETENTION TREATMENT AREA HEADER BOARD	- WITARINE	28 RIM 1294.50 OVERFLOW 1293.01 INV 1287.15 20 P13 LF 8" SD AT 0.5% MIN
DIRECT DOWNSPOUTS TO 24" LONG PRECAST CONCRETE SPLASHBLOCKS OR OTHER HARD SURFACE. DIRECT AWAY FROM ANY STRUCTURE AND TOWARDS POSITIVE DRAINAGE. SEE DETAIL 7A ON SHEET	(12" X 2") EDGE BIO-RETENTION	SAURE	BTA5 25 (N) BIORETENTION / 1398 50 DETENTION SYSTEM BTA5
C-7.0. (N) ACCESS ROAD/DRIVEWAY EDGE DRAIN. SEE DETAIL 8 ON SHEET C-7.0.	TREATMENT AREA 3:1 SLOPED EDGE BIO-RETENTION	58 LF 12" SD 20 AT 0.5% MIN	26 (2) ~20 LF 48" SOLID PIPE DETENTION SYSTEM A R KORT
INSTALL (N) TRENCH DRAINS SHALL BE 4" NDS "DURA—SLOPE" PRESLOPED TRENCH DRAINS WITH TRAFFIC RATED GRATE OR APPROVED EQUAL. CONNECT TO NEAREST STORM DRAIN LINE VIA 4" PVC TIGHTLINE.	TREATMENT AREA LANDSCAPE WALL EDGE (<18")	(N) EDGE DRAIN SUBDRAIN (29)	RIM 1295.67 SUB INV IN 1292.76 TOP 48" PIPE 1392.01
(N) ON-SITE STORM WATER BIO-RETENTION AREA (BTA). SEE DETAILS 1A & 1B ON SHEET C-7.1. SEE PLANS FOR DESIGNATION.	RIP-RAP OUTFALL	(N) TRENCH —	FL 48" PIPE 1287.76 BOT 48" PIPE 1287.51 SUB RIM 1294.50
26 INSTALL (N) DETENTION SYSTEM. SEE DETAIL 2 ON SHEET C-7.1. 27 INSTALL (N) RIP-RAP ENERGY DISSIPATER. SEE DETAIL 3 ON SHEET C-7.1.	DECOMPOSED GRANITE (PERVIOUS AREA)	TRAFFIC ATED GRATE M: 1298.00	TOP 48" PIPE 1291.81 FL 48" PIPE 1287.56 BOT 948.0 PIPE 1287.31 FG 1293.35
28 (N) STORM DRAIN MANHOLE WITH METERED RELEASE OUTLET. SEE DETAIL 4 ON SHEET C-7.1.		A THE TOTAL PARTY OF THE TOTAL P	FS 1393.50 FS
(N) "CHRISTY V-24" SILT BASIN WITH GRAVEL BOTTOM. SEE DETAIL 5 SHEET C-7.1. (N) "CHRISTY F08" AREA DRAINS. CONNECT TO ON-SITE STORM DRAIN SYSTEM. SEE DETAIL 6 ON C-7.1.	REDWOOD HEADER BOARD - 12" X 2"	E COUM DO THE WORLD	$\begin{array}{c c} & & & & & & & & & & & & & & & & & & &$
(n) Basement Level Perimeter sub drain around foundation. Pipe shall be perforated 4" (31) PVC (SDR-35) with holes down. Sloped @ 1% min. Surround with 3/4" drain rock and	DIRECTION OF SURFACE DRAINAGE 0 5	10 20 SOUM WOOM SO	Wody of July
WRAPPED IN FILTER FABRIC TO WITHIN 2' OF FINISHED GRADE/ CONNECT TO RIP RAP OUTFALL. SEE DETAIL 1 ON SHEET C-7.2.	TRENCH DRAIN (TD) GRADE BREAK (GB) SCALE	: 1" = 10'	ISSI TO SERVICE THE PROPERTY OF THE PROPERTY O
(32) (N) 4" PVC (SDR-35 OR BETTER) RETAINING WALL SUBDRAIN PER DETAIL 2 ON C-7.2. (33) (N) ROCKED LINE SWALE. SEE DETAIL 10 ON SHEET C-7.0.	DMA DESIGNAITON	PRAIN SUBDRAINS SHALL CONNECT. OUTFALL TO ORRESPONDING BTA AS	DATE 09-06-18
SPOUT 34 (N) GRASSY SWALE. SEE DETAIL 5 ON SHEET C-7.0.			12-21-18 03-26-19
(N) 4" (N) ROCKED 27		27 (N) ROCKED OUTFALL	04-11-19 04-22-19 05-10-19
(N) 4" TIGHTLINE 21 AT 1% MIN -TYP (N) ROCKED 27 OUTFALL	27		DEVELOPMENT ENCLOSURES & 08-06-19 TED IMPROVEMENTS 05-22-19 08-06-19 09-20-19
(BTA21) (N) BIORETENTION	SS ~50 LF 4" TL AT 0.5% MIN &	1311.00 FL ~15 LF 8" SD 20 AT 0.5% MIN	09-20-19 01-28-20 05-29-20
28 RIM 1341.00 20 AT 0.5% MIN 1329.75 1332 SS FL SS FL SS SUB INV	S\$ 1315.25 FL	1314.25 FG	07-22-20
RIM 1340.50 TOP 48" PIPE 1337.87 RIM 1340.50 SUB INV-IN 1329 65 29		RIM 1314.50 SUB INV IN 1311.65 29 INV 1313.95 FG	SAURE
200 RIM 1341.00 FL 48" PIPE 1333.68 BOT 48" PIPE 13333.37	RIM 1315.10 INV 1314.50	1315.25 FG (N) BIORETENTION 25 DETENTION SYSTEM 25	58 LF 12" SD AT 0.5% MIN APPLICANT
DRAIN TO STATE ON SHEET C-7.1		BTA20 BTA20 BTA20	(N) EDGE DRAIN SUBDRAIN TO CONNECT TO BTA5 VIA GRADING FILE: 6
D BTA5 INE AT 1% MIN SD SD SD SD SYSTEM ST ST ST ST ST ST ST ST ST S		\\\\\\\\\\\\\\\\\\\\\\\\\\\\\\\\\\\\\\	(N) TRENCH — UTILITY PE
RIM 1341.67 SUB INVIN 1338.82 29	RIM 1315.25		RATED GRATE de RIM: 1298.00
FL 48" PIPE 1353.82 FL 48" PIPE 1353.82 DIVING THE 1353.82	AT 0.5% MIN	1314.00 FG	STOR
PSSO TO THE STATE OF THE STATE	1815.00 FF 7		TREA!
ENC 2 1332.00	1315:25 ENG 1	315.00 WO(2)	WO SW PRINS BINS BINS BINS BINS BINS BINS BINS B
No.	5	SOV WOOD THE	Designed I Checked E
~43 LF 12" SD 20 AT 0.5% MIN	de la	Modify	EDGE DRAIN SUBDRAINS SHALL — EB 500 NC NOT CONNECT. OUTFALL TO CORRESPONDING BTA AS
Solve and the second se	d 10 10 10 10 10 10 10 10 10 10 10 10 10	WOON	DESIGNATED ON PLANS
92 V 1353.00 29	Ad di woods	(N) EDGE DRAIN W/23 SUBDRAIN -TYP	
BIORETENTION/ IENTION SYSTEM BTA23 ADS TO RETENTION STEM UNDER BTA6 SEE DMA 5	Modula		
TAIL 1A ON SHEET C-7.1	DIRECTION OF SURI DRAINAGE TO BMP -	TACE	ASA/ MOD PLN-
(B1A23)			PLN-
$\frac{1}{2} \frac{1}{2} \frac{1}$			

ELLISON CONSERVATION CENTER FOR WILDLIFE CARE SARATOGA, CA



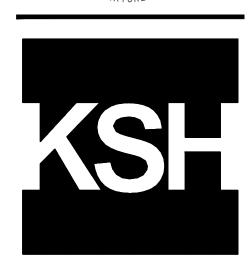

ARCHITECTS ORTH SUNSERI HAGEY



ISSUES AND REVISIONS DESCRIPTION -18 GRADING PERMIT PLAN CHECK 4

-18 PERMIT RESUBMITTAL PERMIT MODIFICATION
PLAN CHECK 1
1-19 ASA DELTA 2
22-19 BID SET

0-19 BID SET ADDENDUM 1 2-19 UTILITY PLAN CHECK 1 6-19 PHASE 4 - PERMIT SUBMITTAL

0-19 CONSTRUCTION SET 1 8-20 PERMIT MODIFICATION 2

9-20 PLAN CHECK RESPONSE PERMIT MODIFICATION 2

2-20 UTILITY PLAN SUBMITTAL

SANTA CLARA COUNTY RECORD INFORMATION ICANT: PENINSULA HUMANE SOCIETY : CONGRESS SPRINGS

FILE: 6943-17-17G DING PERMIT: DEV19-1838 ITY PERMIT: DEV19-0220


> PROJECT NUMBER 16011.00

SHEET TITLE CORMWATER REATMENT PLAN


SCALE 1" = 10' PC / CA PC / JL 2130712

SHEET NUMBER

C-10.6

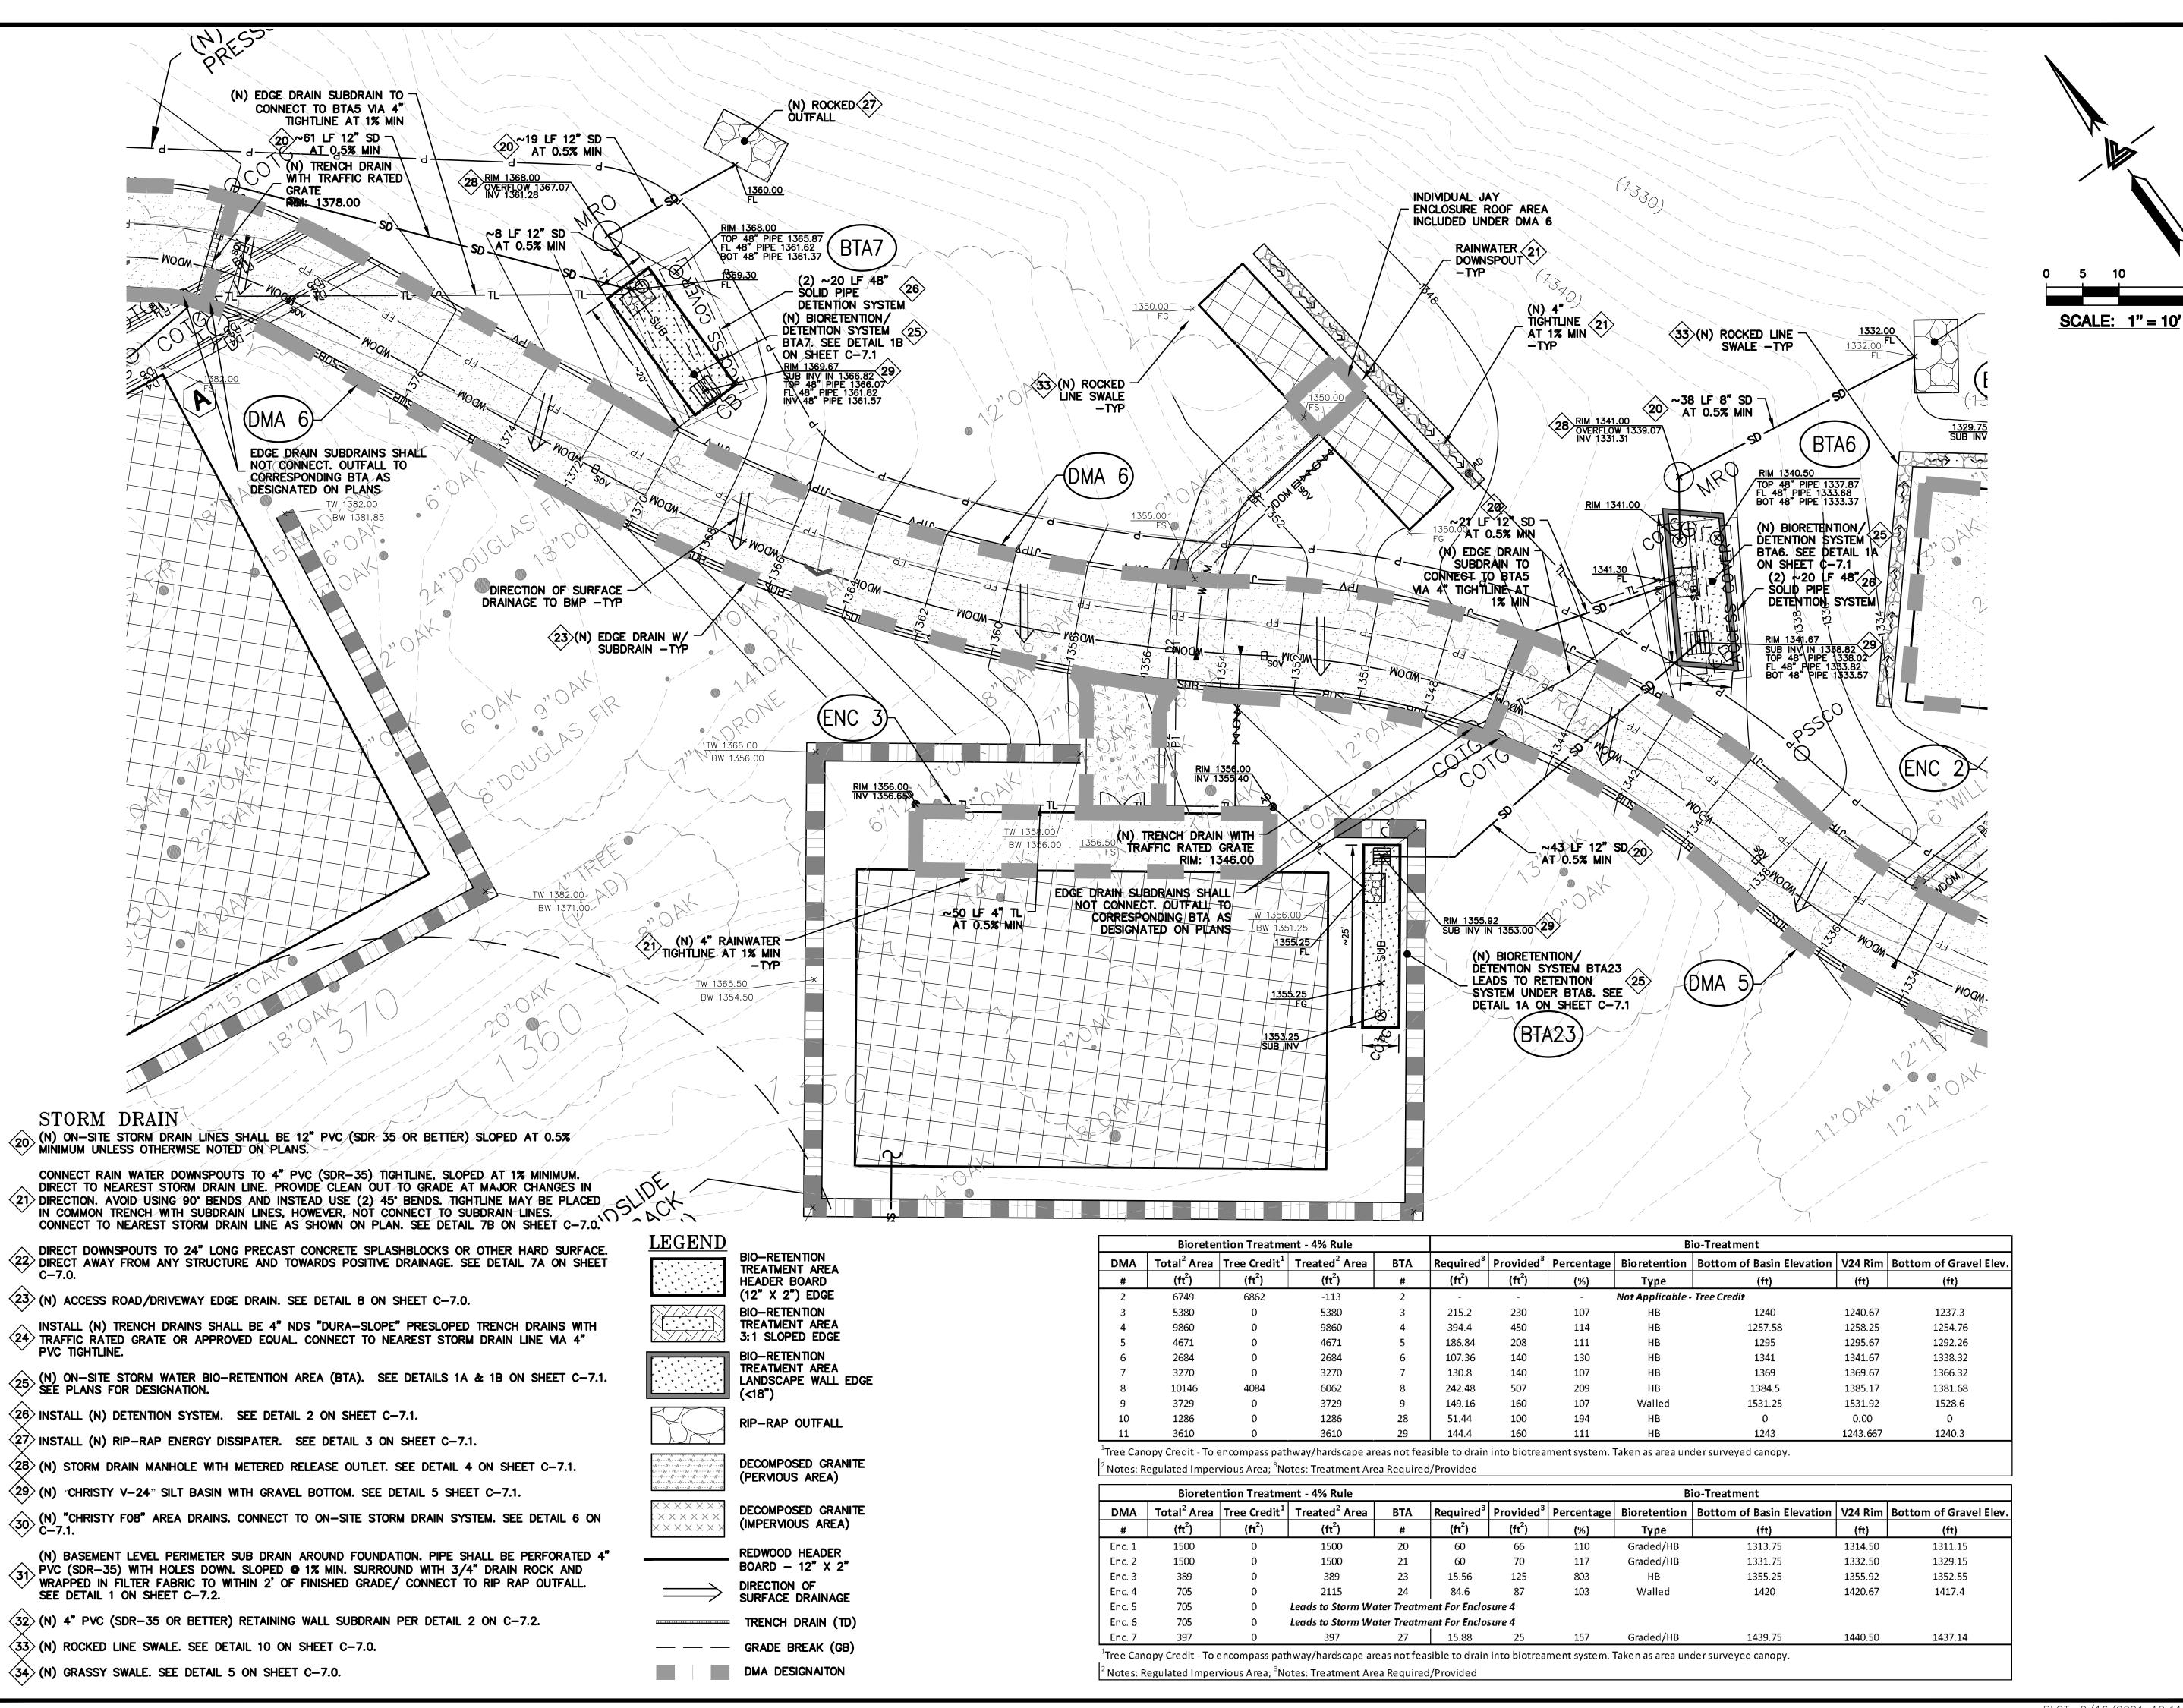



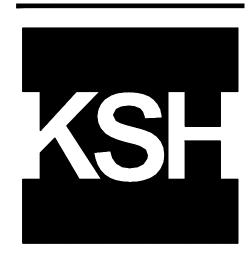

ARCHITECTS



GRADING PERMIT

PLAN CHECK 4 12-21-18 PERMIT RESUBMITTAL PERMIT MODIFICATION 04-11-19 ASA DELTA 2

04-22-19 BID SET 05-10-19 BID SET ADDENDUM 05-22-19 UTILITY PLAN CHECK

08-06-19 PHASE 4 - PERMIT SUBMITTAL

09-20-19 CONSTRUCTION SET 1 01-28-20 PERMIT MODIFICATION 2 05-29-20 PLAN CHECK RESPONSE PERMIT MODIFICATION 2

07-22-20 UTILITY PLAN SUBMITTAL

SANTA CLARA COUNTY RECORD INFORMATION

APPLICANT: PENINSULA HUMANE SOCIETY ROAD: CONGRESS SPRINGS LDE FILE: 6943-17-17G GRADING PERMIT: DEV19-1838


UTILITY PERMIT: DEV19-0220 PROJECT NUMBER

SHEET TITLE


STORMWATER TREATMENT PLAN

SCALE 1" = 10'PC / CA Checked By PC / JL 2130712

SHEET NUMBER

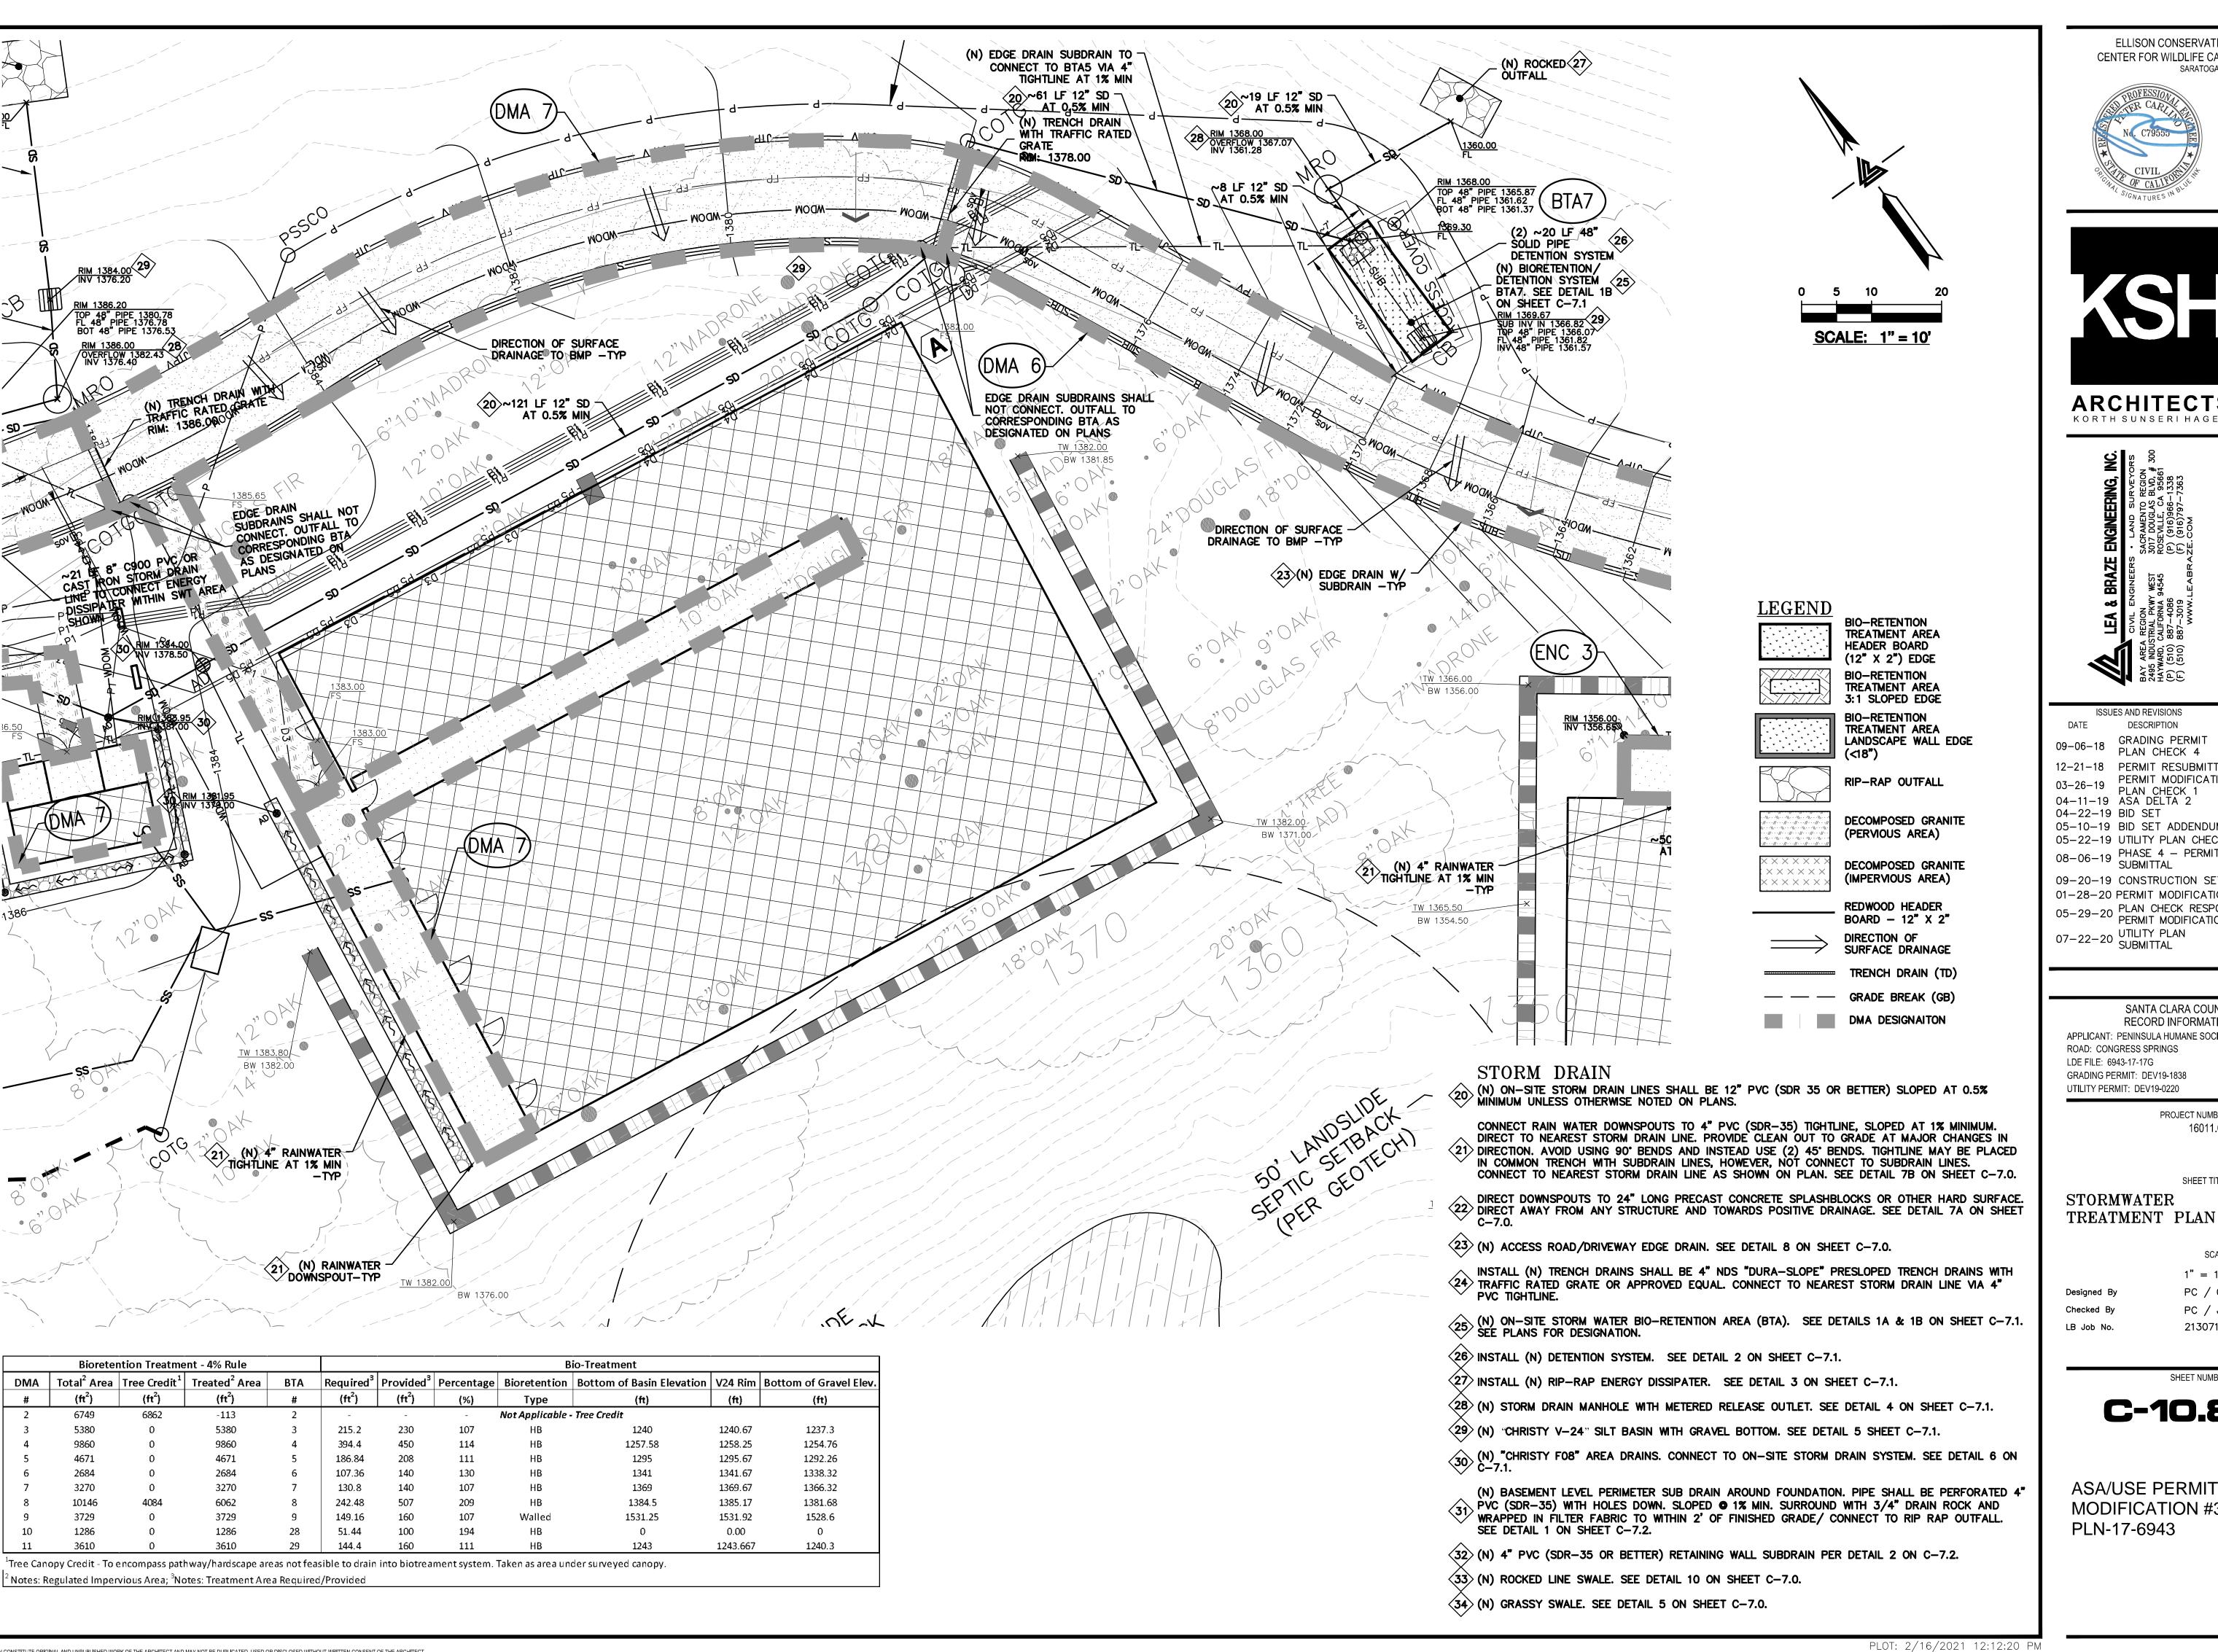



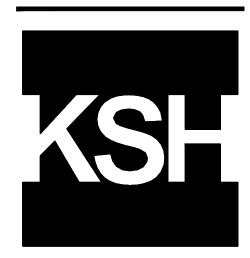

ARCHITECTS



ISSUES AND REVISIONS DESCRIPTION GRADING PERMIT

PLAN CHECK 4 12-21-18 PERMIT RESUBMITTAL PERMIT MODIFICATION 04-11-19 ASA DELTA 2 04-22-19 BID SET

05-10-19 BID SET ADDENDUM 05-22-19 UTILITY PLAN CHECK 08-06-19 PHASE 4 - PERMIT SUBMITTAL

09-20-19 CONSTRUCTION SET 1 01-28-20 PERMIT MODIFICATION 2 05-29-20 PLAN CHECK RESPONSE PERMIT MODIFICATION 2

07-22-20 UTILITY PLAN SUBMITTAL

SANTA CLARA COUNTY RECORD INFORMATION APPLICANT: PENINSULA HUMANE SOCIETY ROAD: CONGRESS SPRINGS

GRADING PERMIT: DEV19-1838 UTILITY PERMIT: DEV19-0220

PROJECT NUMBER 16011.00


SHEET TITLE STORMWATER

> SCALE 1" = 10'

PC / CA PC / JL 2130712

SHEET NUMBER

C-10.8

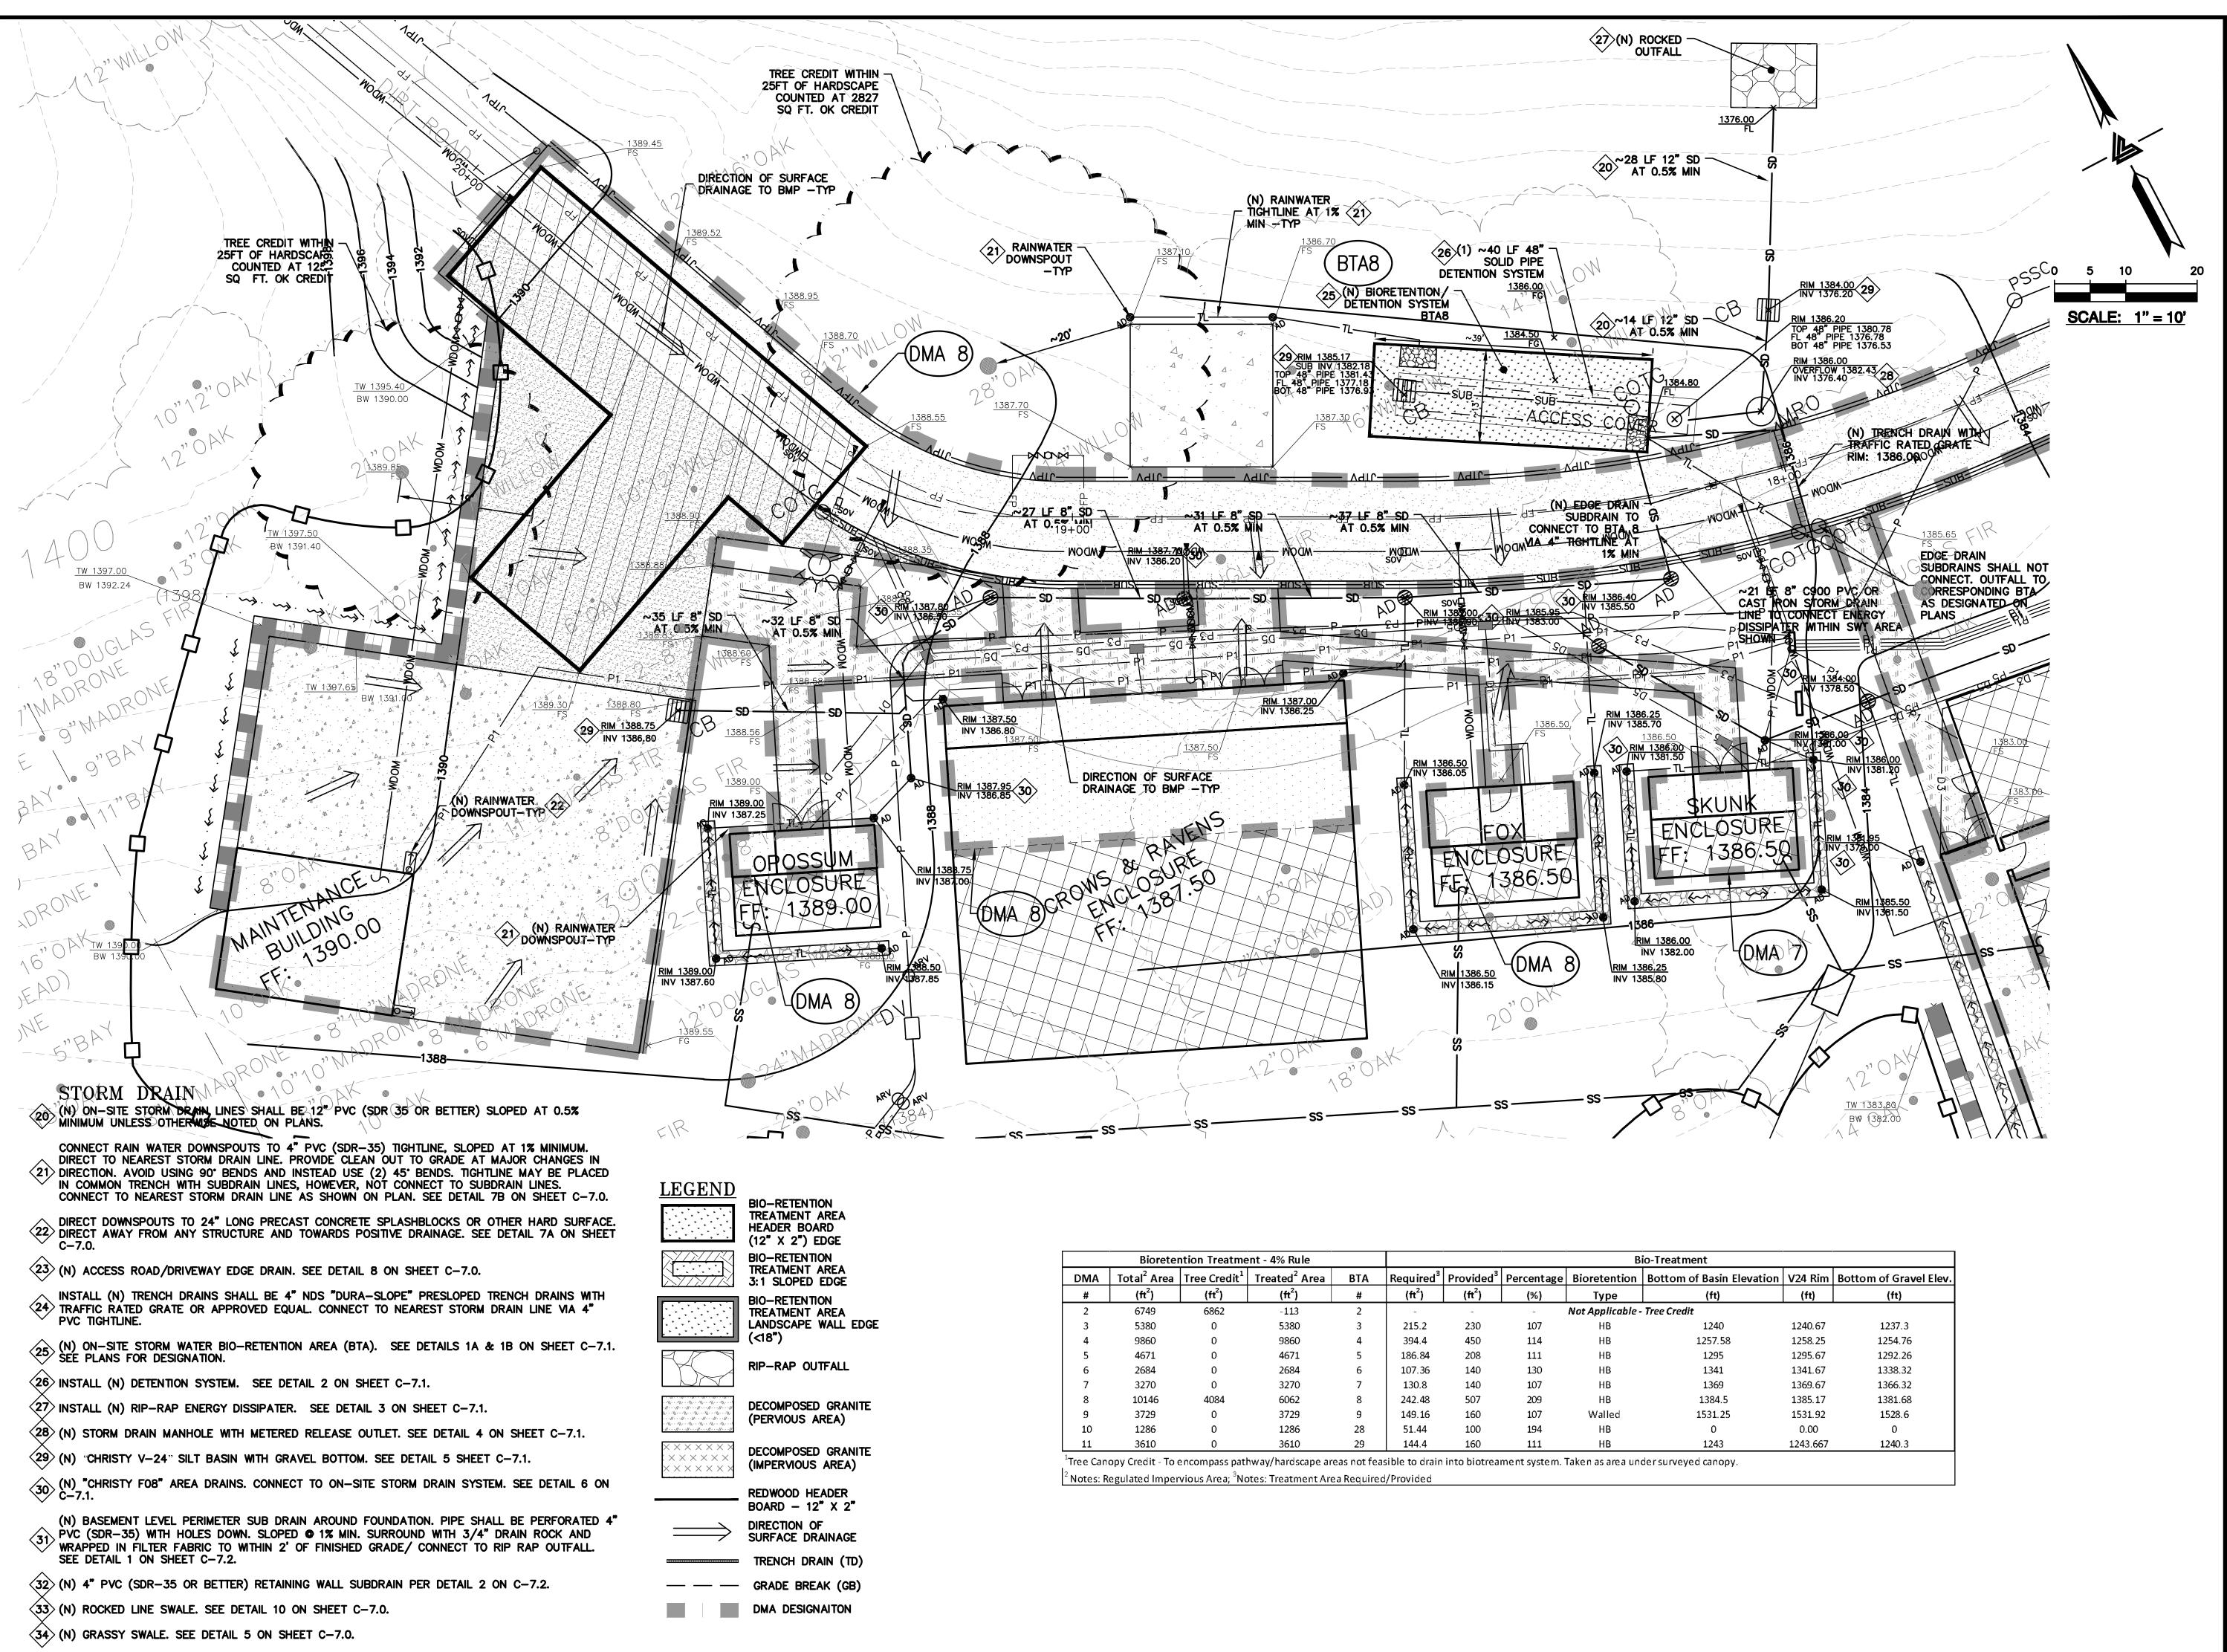





ARCHITECTS KORTH SUNSER! HAGEY



DATE DESCRIPTION

9-06-18 GRADING PERMIT

12-21-18 PERMIT RESUBMITTAL
03-26-19 PERMIT MODIFICATION
PLAN CHECK 1
04-11-19 ASA DELTA 2

04-22-19 BID SET 05-10-19 BID SET ADDENDUM 1 05-22-19 UTILITY PLAN CHECK 1

08-06-19 PHASE 4 - PERMIT SUBMITTAL

09-20-19 CONSTRUCTION SET 1

01-28-20 PERMIT MODIFICATION

01-28-20 PERMIT MODIFICATION 2 05-29-20 PLAN CHECK RESPONSE PERMIT MODIFICATION 2

07-22-20 UTILITY PLAN SUBMITTAL

SANTA CLARA COUNTY
RECORD INFORMATION
APPLICANT: PENINSULA HUMANE SOCIETY

ROAD: CONGRESS SPRINGS
LDE FILE: 6943-17-17G
GRADING PERMIT: DEV19-1838
UTILITY PERMIT: DEV19-0220

PROJECT NUMBER 16011.00

SHEET TITLE

STORMWATER TREATMENT PLAN

SCALE 1" = 10'Designed By PC / CA
Checked By PC / JL
LB Job No. 2130712

SHEET NUMBER

C-10.9

ASA/USE PERMIT MODIFICATION #3 PLN-17-6943

ALL DRAWINGS AND WRITTEN MATERIAL APPEARING HEREIN CONSTITUTE ORIGINAL AND UNPUBLISHED WORK OF THE ARCHITECT AND MAY NOT BE DUPLICATED, USED OR DISCLOSED WITHOUT WRITTEN CONSENT OF THE ARCHITECT

	Biorete	ntion Treatme	ent - 4% Rule					В	io-Treatment		
DMA	Total ² Area	Tree Credit ¹	Treated ² Area	вта	Required ³	Provided ³	Percentage	Bioretention	Bottom of Basin Elevation	V24 Rim	Bottom of Gravel Elev.
#	(ft ²)	(ft ²)	(ft ²)	#	(ft ²)	(ft ²)	(%)	Туре	(ft)	(ft)	(ft)
2	6749	6862	-113	2	-	-	-	Not Applicable -	Tree Credit		
3	5380	0	5380	3	215.2	230	107	НВ	1240	1240.67	1237.3
4	9860	0	9860	4	394.4	450	114	НВ	1257.58	1258.25	1254.76
5	4671	0	4671	5	186.84	208	111	НВ	1295	1295.67	1292.26
6	2684	0	2684	6	107.36	140	130	НВ	1341	1341.67	1338.32
7	3270	0	3270	7	130.8	140	107	НВ	1369	1369.67	1366.32
8	10146	4084	6062	8	242.48	507	209	НВ	1384.5	1385.17	1381.68
9	3729	0	3729	9	149.16	160	107	Walled	1531.25	1531.92	1528.6
10	1286	0	1286	28	51.44	100	194	НВ	0	0.00	0
11	3610	0	3610	29	144.4	160	111	НВ	1243	1243.667	1240.3

¹Tree Canopy Credit - To encompass pathway/hardscape areas not feasible to drain into biotreament system. Taken as area under surveyed canopy.

~ Notes: R	Regulated Imper	rvious Area;	otes: Treatment Ar	ea Required	d/Provided							
	Biorete	ntion Treatme	ent - 4% Rule			Bio-Treatment						
DMA	Total ² Area	Tree Credit ¹	Treated ² Area	вта	Required ³	Provided ³	Percentage	Bioretention	Bottom of Basin Elevation	V24 Rim	Bottom of Gravel Elev	
#	(ft²)	(ft ²)	(ft²)	#	(ft ²)	(ft ²)	(%)	Туре	(ft)	(ft)	(ft)	
Enc. 1	1500	0	1500	20	60	66	110	Graded/HB	1313.75	1314.50	1311.15	
Enc. 2	1500	0	1500	21	60	70	117	Graded/HB	1331.75	1332.50	1329.15	
Enc. 3	389	0	389	23	15.56	125	803	НВ	1355.25	1355.92	1352.55	
Enc. 4	705	0	2115	24	84.6	87	103	Walled	1420	1420.67	1417.4	
Enc. 5	705	0	Leads to Storm We	ater Treatm	ent For Enclo	sure 4						
Fnc 6	705	Λ	Leads to Storm We	ater Treatm	ent For Enclo	sure A						

1440.50

BIO-RETENTION TREATMENT AREA HEADER BOARD (12" X 2") EDGE

BIO-RETENTION

TREATMENT AREA

3:1 SLOPED EDGE

BIO-RETENTION

TREATMENT AREA

RIP-RAP OUTFALL

DECOMPOSED GRANITE (PERVIOUS AREA)

DECOMPOSED GRANITE (IMPERVIOUS AREA)

REDWOOD HEADER

BOARD - 12" X 2"

SURFACE DRAINAGE

TRENCH DRAIN (TD)

DIRECTION OF

LEGEND

1437.14

¹Tree Canopy Credit - To encompass pathway/hardscape areas not feasible to drain into biotreament system. Taken as area under surveyed canopy.

Enc. 7


STORM DRAIN


² Notes: Regulated Impervious Area; ³Notes: Treatment Area Required/Provided

(N) ON-SITE STORM DRAIN LINES SHALL BE 12" PVC (SDR 35 OR BETTER) SLOPED AT 0.5% MINIMUM UNLESS OTHERWISE NOTED ON PLANS.

CONNECT RAIN WATER DOWNSPOUTS TO 4" PVC (SDR-35) TIGHTLINE, SLOPED AT 1% MINIMUM. DIRECT TO NEAREST STORM DRAIN LINE. PROVIDE CLEAN OUT TO GRADE AT MAJOR CHANGES IN DIRECTION. AVOID USING 90° BENDS AND INSTEAD USE (2) 45° BENDS. TIGHTLINE MAY BE PLACED IN COMMON TRENCH WITH SURDRAIN LINES HOWEVER NOT CONNECT TO SURDRAIN LINES. IN COMMON TRENCH WITH SUBDRAIN LINES, HOWEVER, NOT CONNECT TO SUBDRAIN LINES. CONNECT TO NEAREST STORM DRAIN LINE AS SHOWN ON PLAN. SEE DETAIL 7B ON SHEET C-7.0.

- DIRECT DOWNSPOUTS TO 24" LONG PRECAST CONCRETE SPLASHBLOCKS OR OTHER HARD SURFACE. DIRECT AWAY FROM ANY STRUCTURE AND TOWARDS POSITIVE DRAINAGE. SEE DETAIL 7A ON SHEET C-7.0.
- (23) (N) ACCESS ROAD/DRIVEWAY EDGE DRAIN. SEE DETAIL 8 ON SHEET C-7.0.
- INSTALL (N) TRENCH DRAINS SHALL BE 4" NDS "DURA-SLOPE" PRESLOPED TRENCH DRAINS WITH TRAFFIC RATED GRATE OR APPROVED EQUAL. CONNECT TO NEAREST STORM DRAIN LINE VIA 4" PVC TIGHTLINE.
- (N) ON-SITE STORM WATER BIO-RETENTION AREA (BTA). SEE DETAILS 1A & 1B ON SHEET C-7.1. SEE PLANS FOR DESIGNATION.
- (26) INSTALL (N) DETENTION SYSTEM. SEE DETAIL 2 ON SHEET C-7.1.
- $\langle 27 \rangle$ install (n) rip-rap energy dissipater. See detail 3 on sheet C-7.1.
- $\langle 28 \rangle$ (n) storm drain manhole with metered release outlet. See detail 4 on sheet C-7.1.
- (29) (N) "CHRISTY V-24" SILT BASIN WITH GRAVEL BOTTOM. SEE DETAIL 5 SHEET C-7.1.
- (N) "CHRISTY FOB" AREA DRAINS. CONNECT TO ON-SITE STORM DRAIN SYSTEM. SEE DETAIL 6 ON

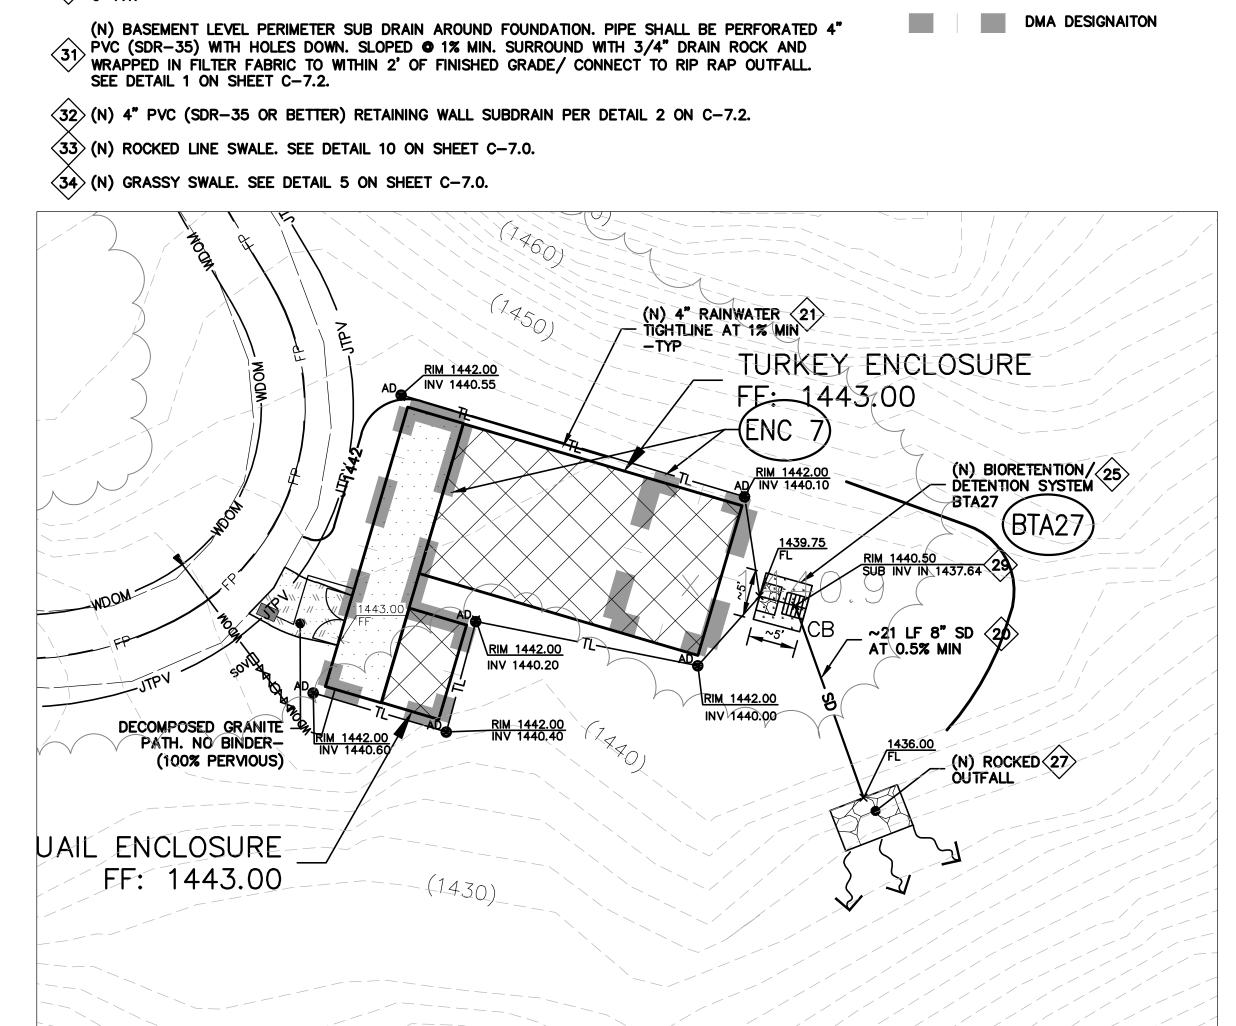

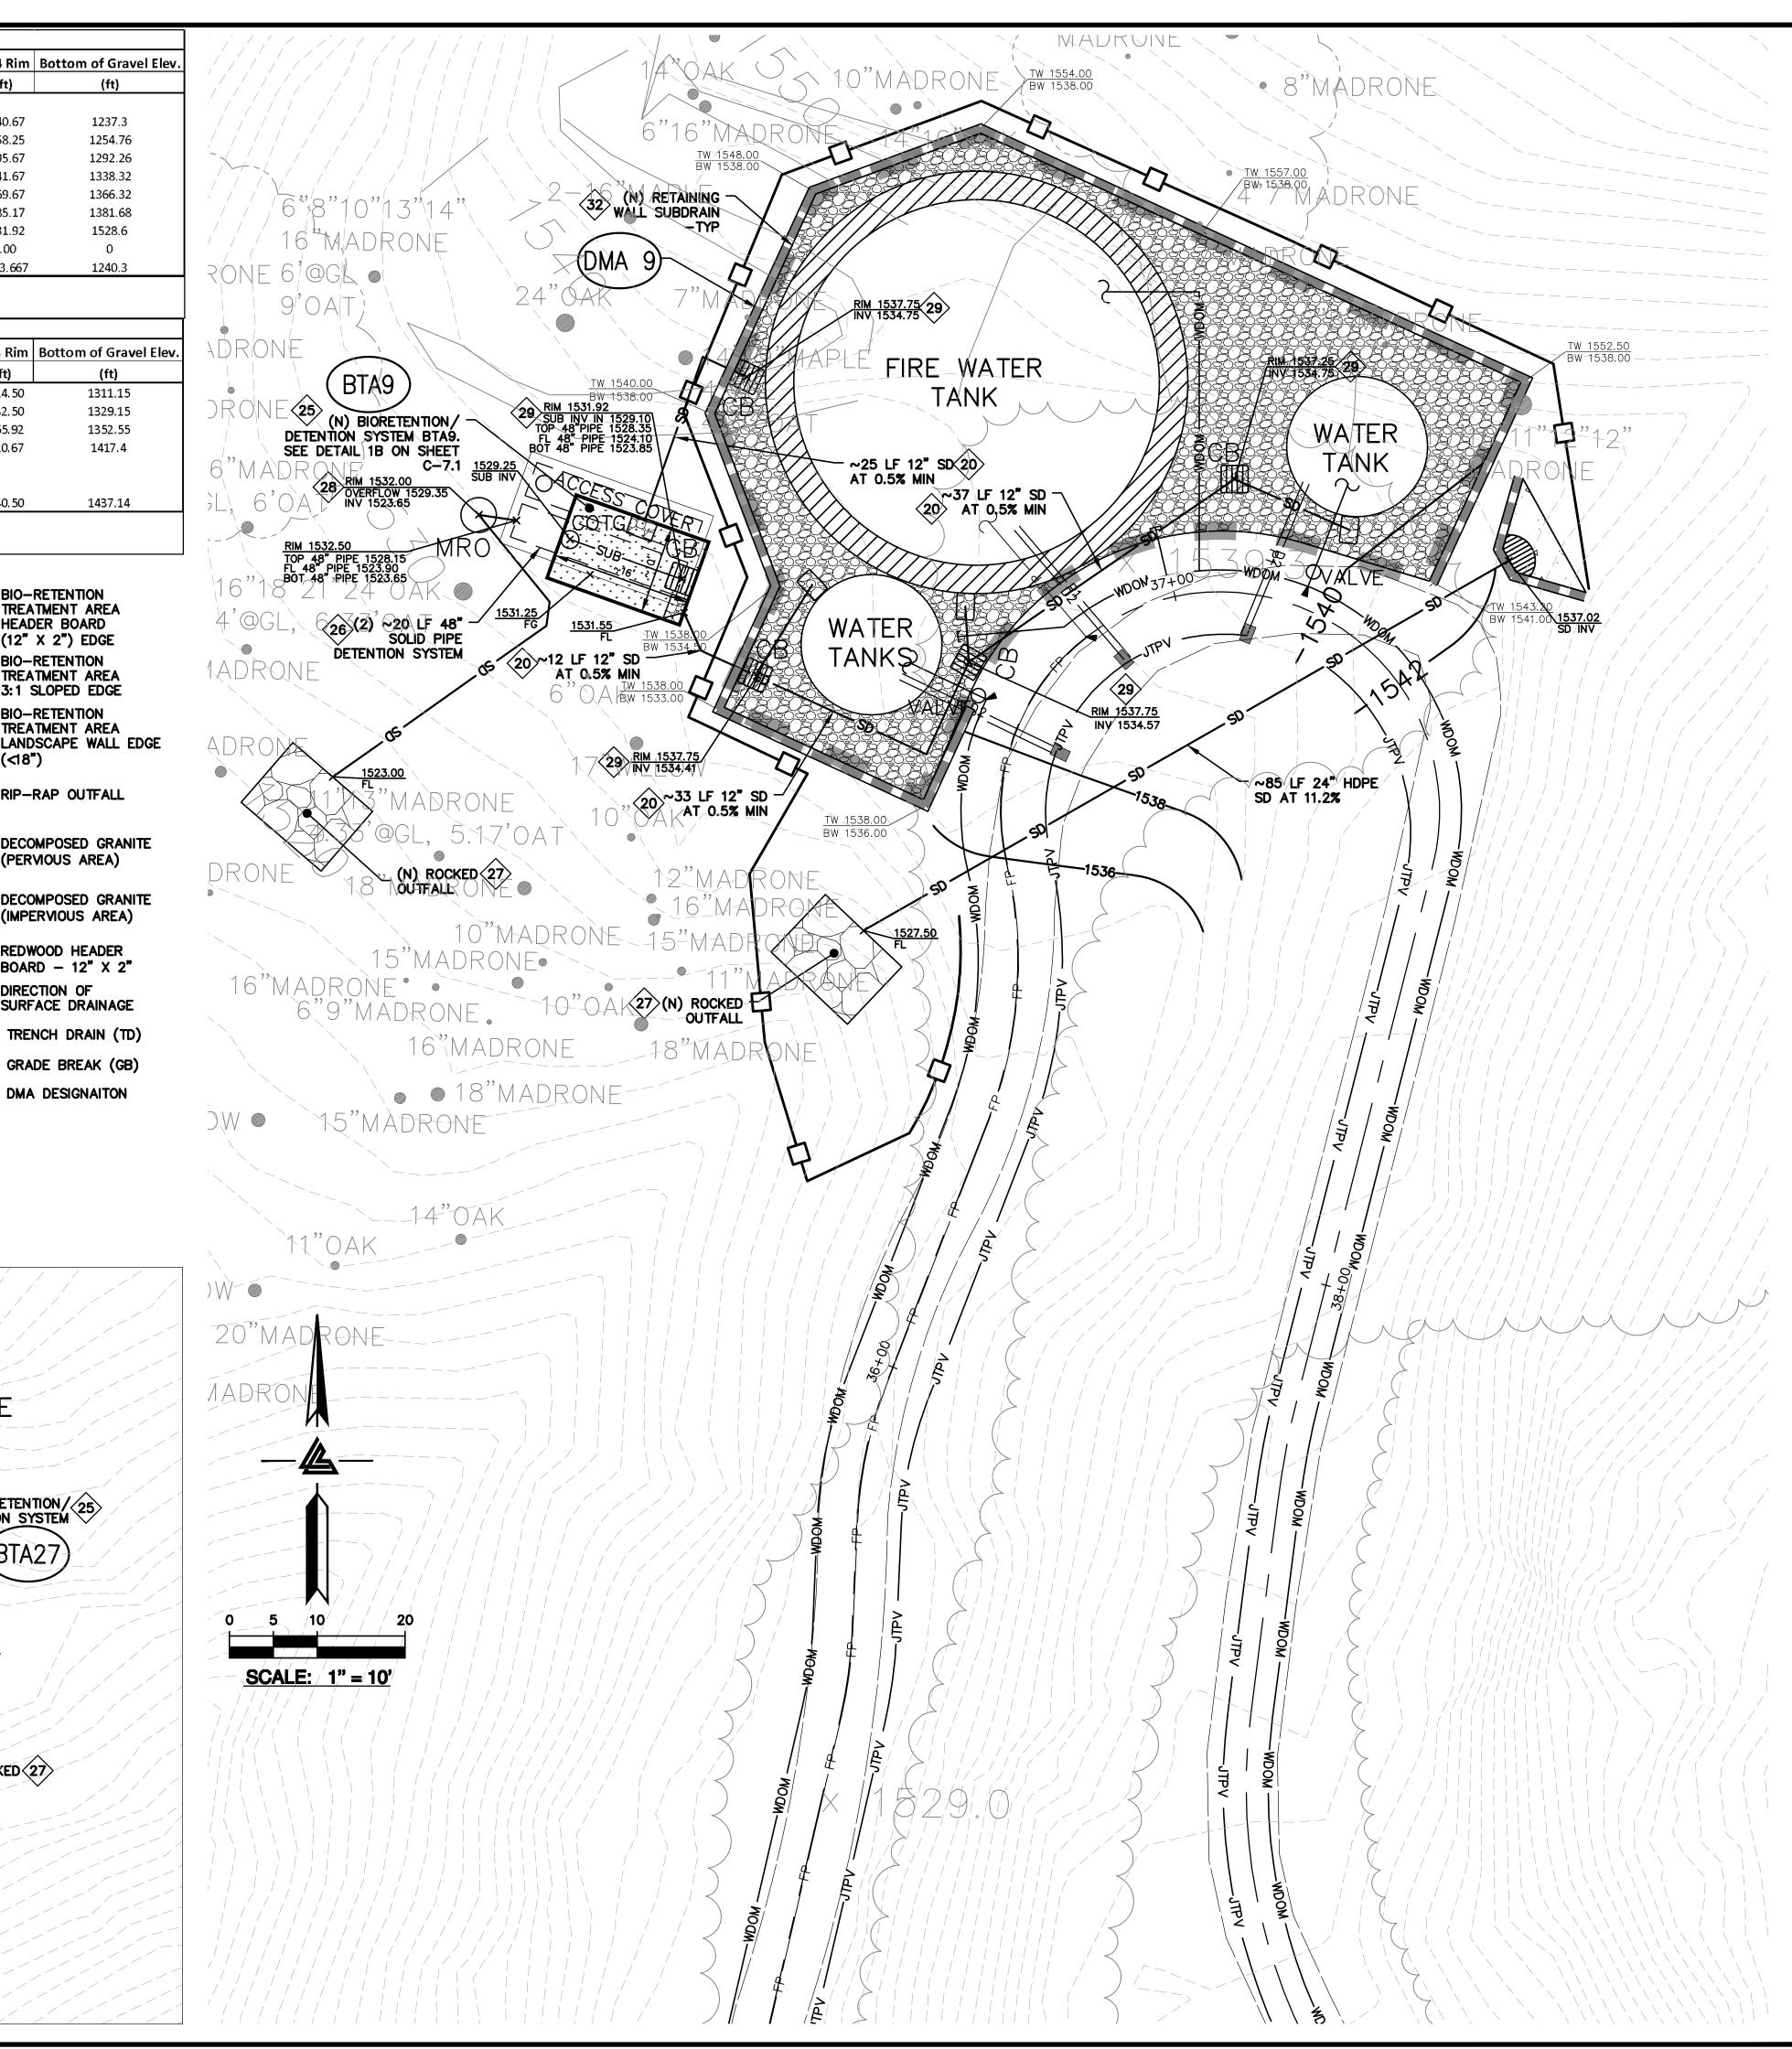

ELLISON CONSERVATION CENTER FOR WILDLIFE CARE





ARCHITECTS



ISSUES AND REVISIONS

GRADING PERMIT PLAN CHECK 4

12-21-18 PERMIT RESUBMITTAL PERMIT MODIFICATION

04-11-19 ASA DELTA 2 04-22-19 BID SET 05-10-19 BID SET ADDENDUM

05-22-19 UTILITY PLAN CHECK 1

08-06-19 PHASE 4 - PERMIT SUBMITTAL

09-20-19 CONSTRUCTION SET 1 01-28-20 PERMIT MODIFICATION 2

05-29-20 PLAN CHECK RESPONSE PERMIT MODIFICATION 2

07-22-20 UTILITY PLAN SUBMITTAL

SANTA CLARA COUNTY **RECORD INFORMATION** APPLICANT: PENINSULA HUMANE SOCIETY

ROAD: CONGRESS SPRINGS LDE FILE: 6943-17-17G GRADING PERMIT: DEV19-1838

UTILITY PERMIT: DEV19-0220

PROJECT NUMBER 16011.00


SHEET TITLE STORMWATER TREATMENT PLAN

1" = 10' PC / CA PC / JL

2130712

SHEET NUMBER

C-10.10

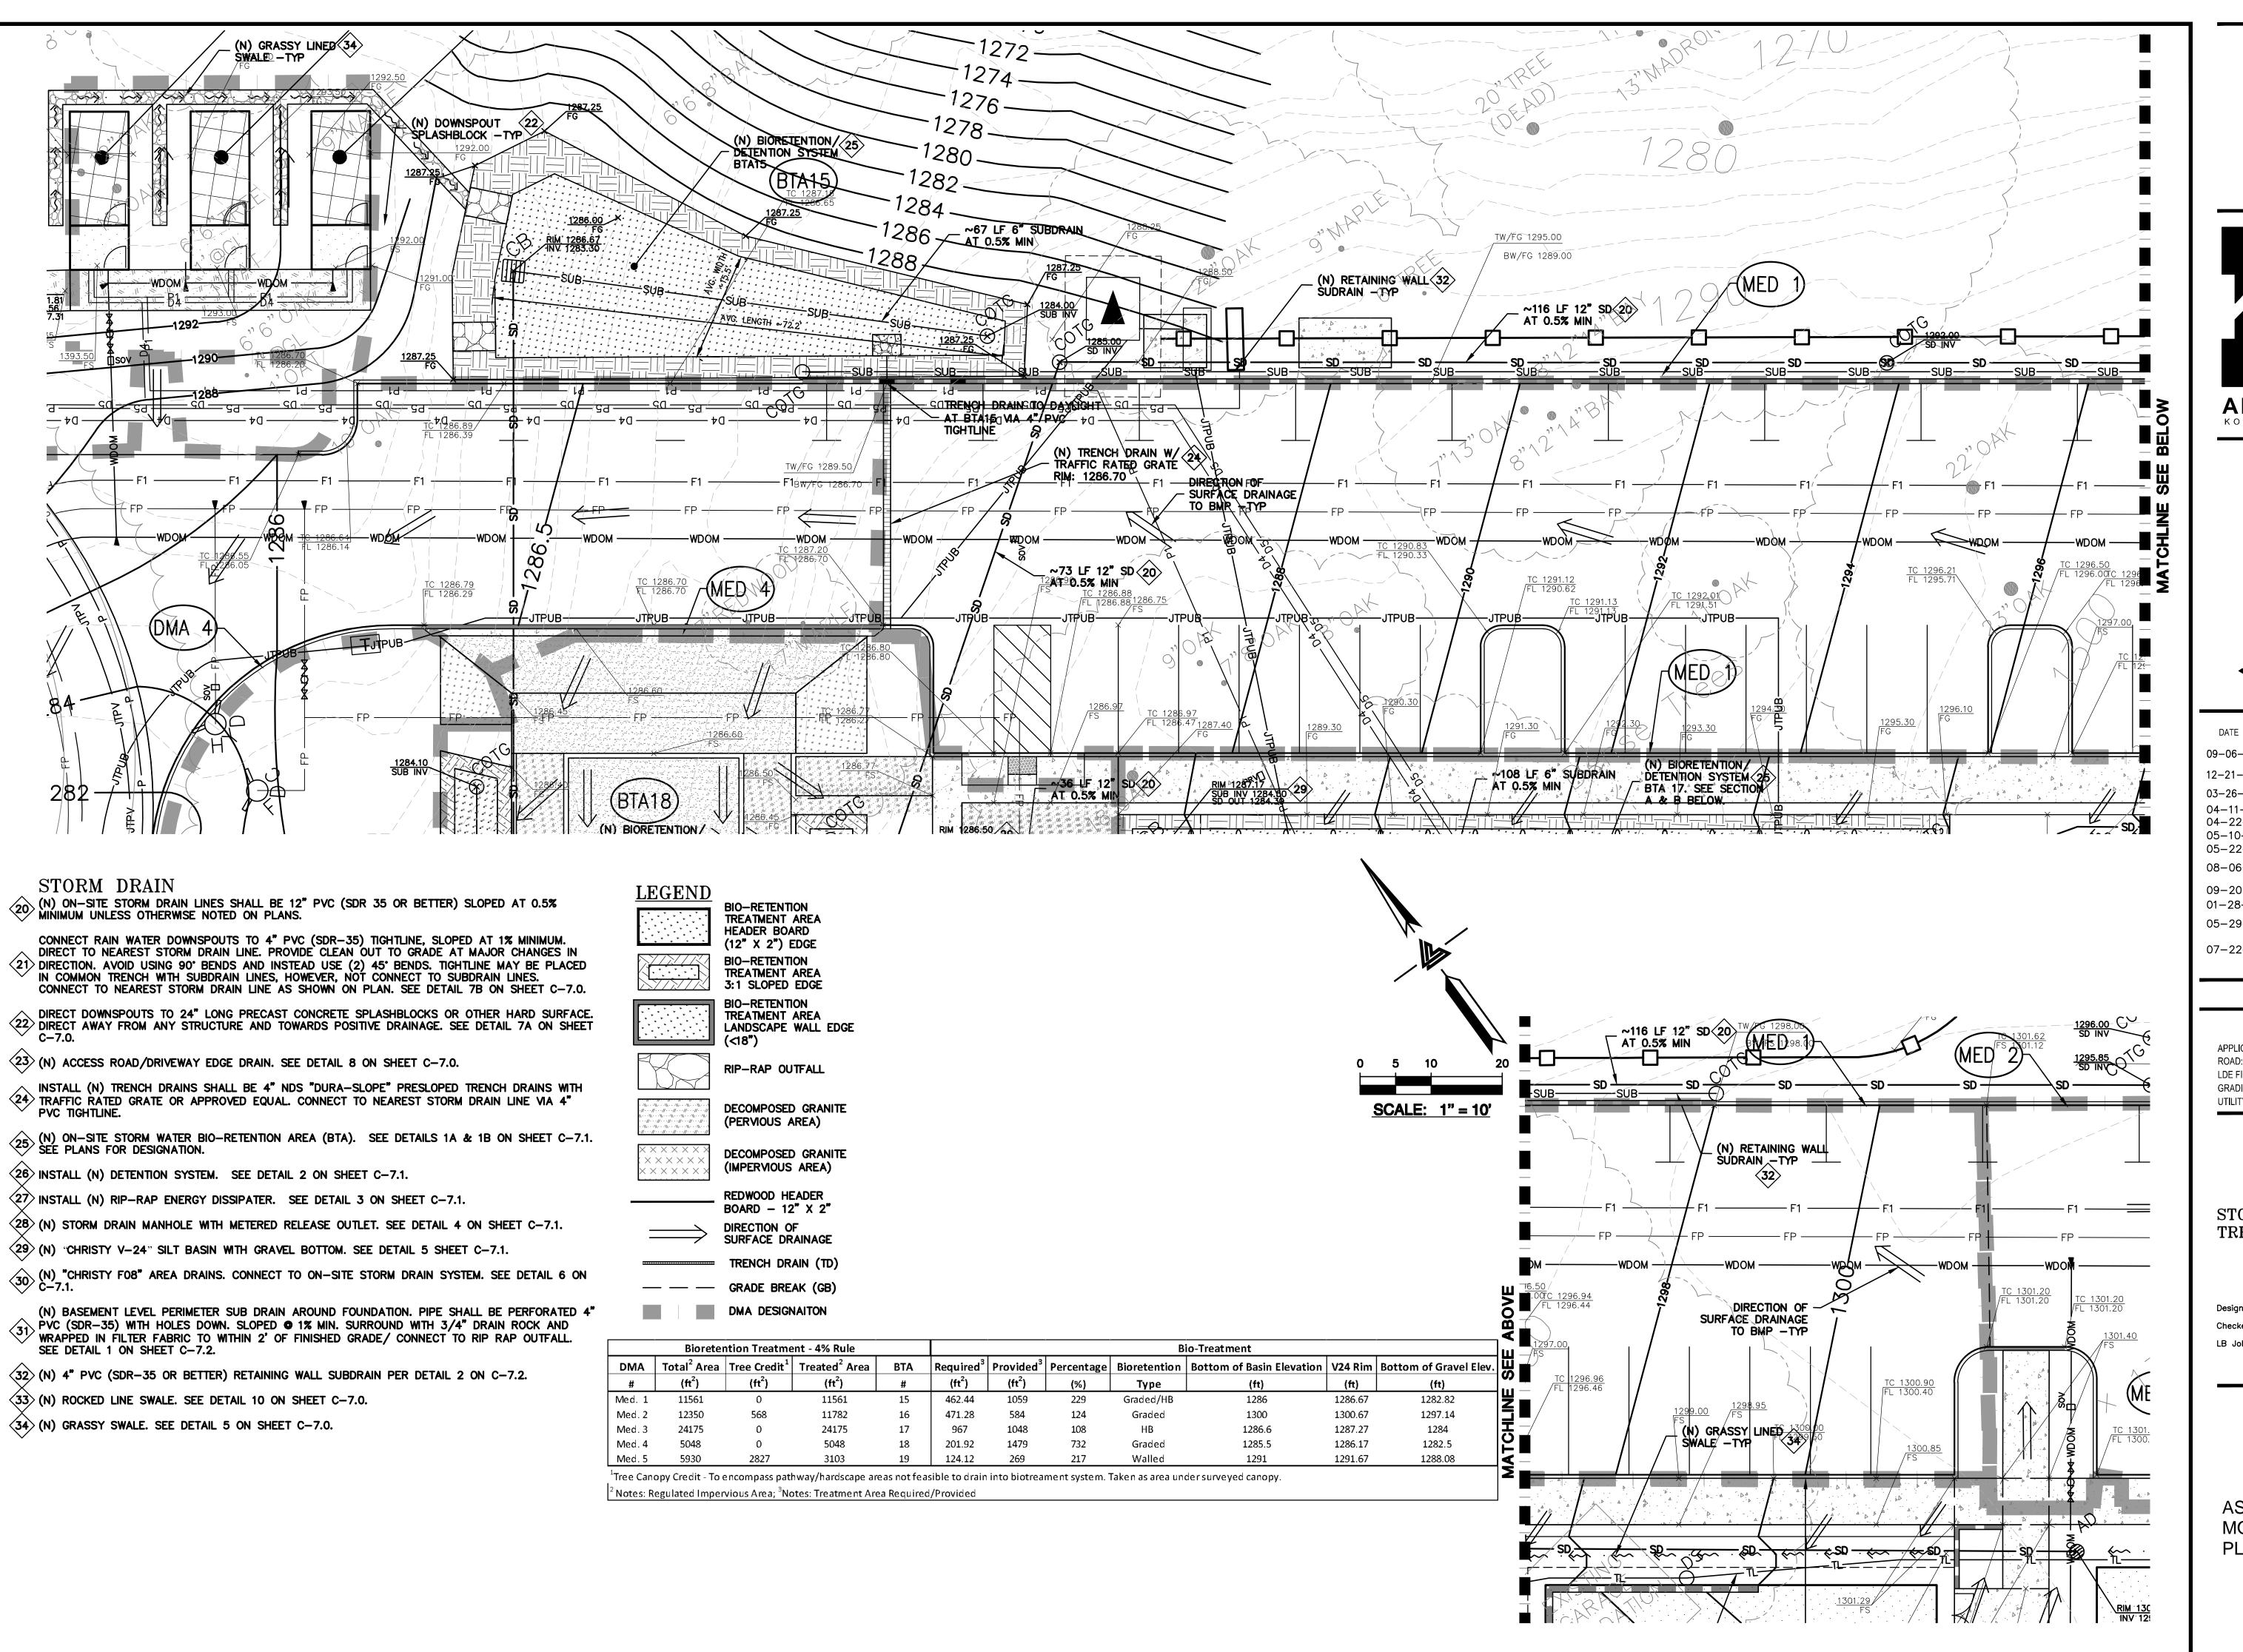





ISSUES AND REVISIONS 09-06-18 GRADING PERMIT PLAN CHECK 4

12-21-18 PERMIT RESUBMITTAL PERMIT MODIFICATION 04-11-19 ASA DELTA 2

04-22-19 BID SET 05-10-19 BID SET ADDENDUM

05-22-19 UTILITY PLAN CHECK 08-06-19 PHASE 4 - PERMIT SUBMITTAL

09-20-19 CONSTRUCTION SET 1 01-28-20 PERMIT MODIFICATION 2 05-29-20 PLAN CHECK RESPONSE PERMIT MODIFICATION 2

07-22-20 UTILITY PLAN SUBMITTAL

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ROAD: CONGRESS SPRINGS LDE FILE: 6943-17-17G GRADING PERMIT: DEV19-1838 UTILITY PERMIT: DEV19-0220

> PROJECT NUMBER 16011.00


SHEET TITLE STORMWATER TREATMENT PLAN

SCALE 1" = 10' PC / CA Checked By PC / JL


2130712

SHEET NUMBER

C-10.11

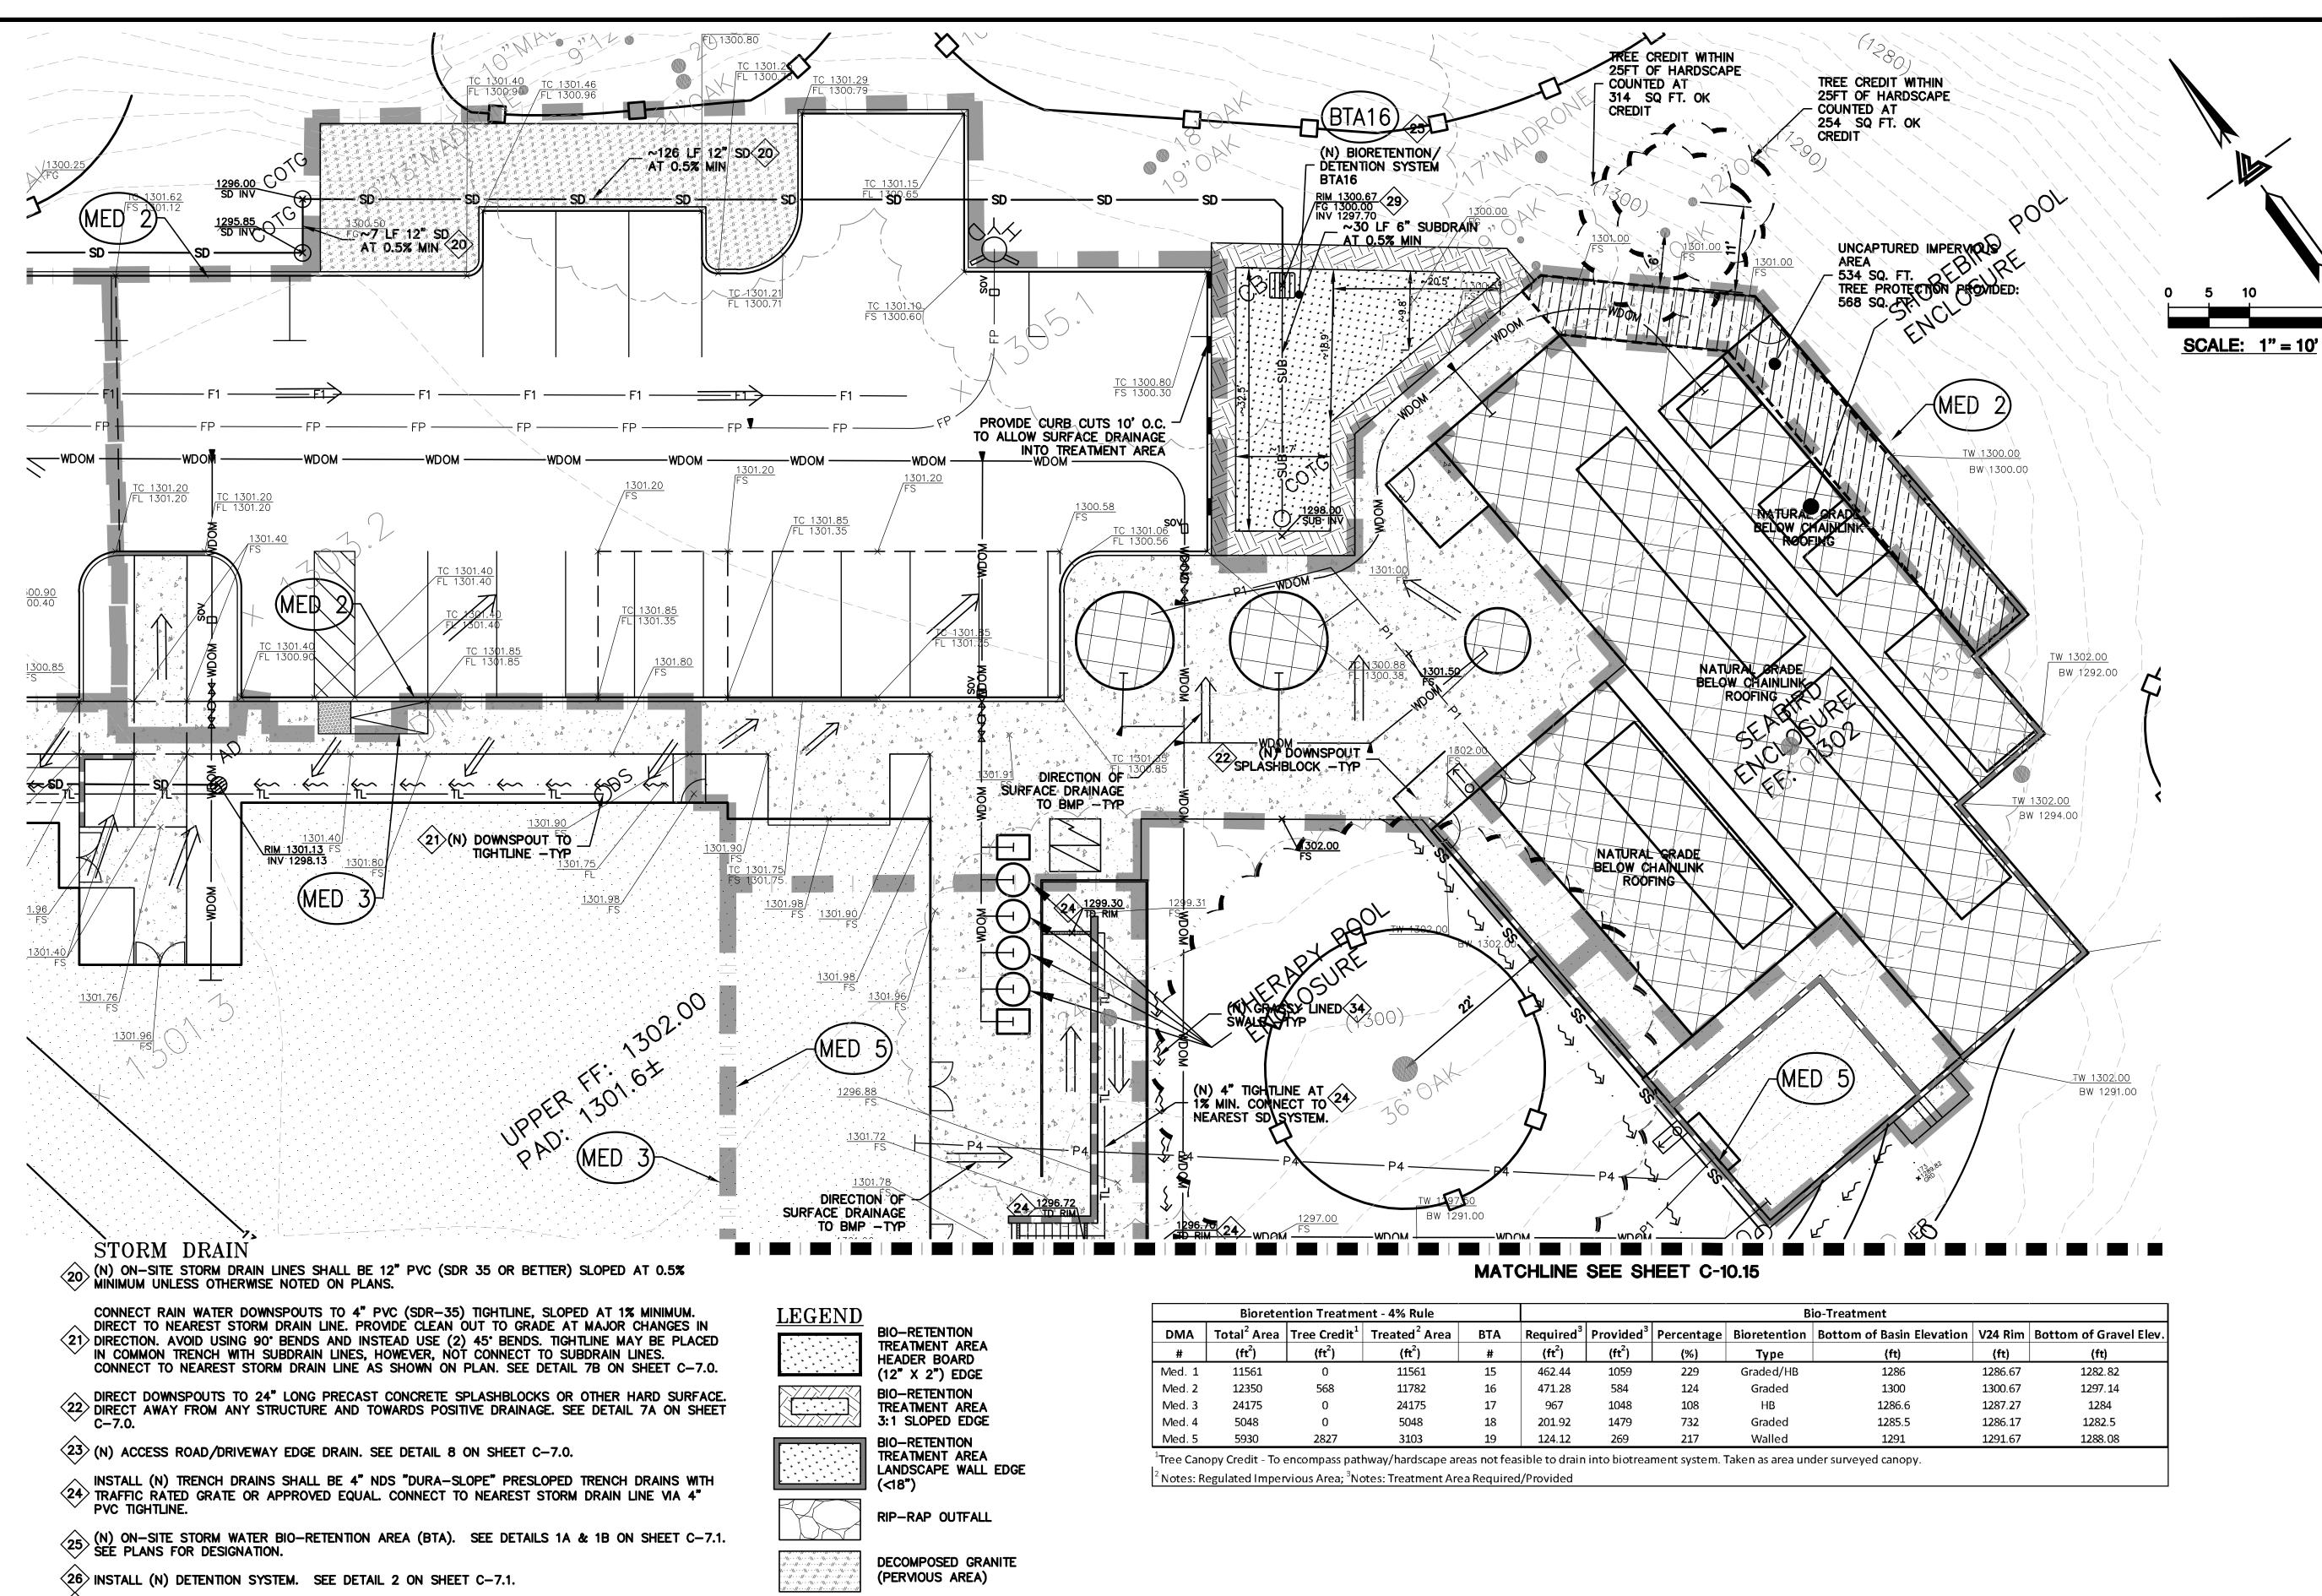



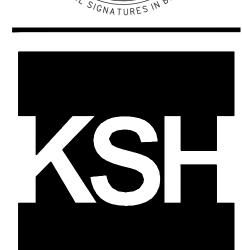

ARCHITECTS



GRADING PERMIT PLAN CHECK 4

12-21-18 PERMIT RESUBMITTAL PERMIT MODIFICATION 04-11-19 ASA DELTA 2

04-22-19 BID SET 05-10-19 BID SET ADDENDUM 05-22-19 UTILITY PLAN CHECK

08-06-19 PHASE 4 - PERMIT SUBMITTAL

09-20-19 CONSTRUCTION SET 1 01-28-20 PERMIT MODIFICATION 2 05-29-20 PLAN CHECK RESPONSE PERMIT MODIFICATION 2

07-22-20 UTILITY PLAN SUBMITTAL

SANTA CLARA COUNTY RECORD INFORMATION APPLICANT: PENINSULA HUMANE SOCIETY

ROAD: CONGRESS SPRINGS LDE FILE: 6943-17-17G GRADING PERMIT: DEV19-1838

UTILITY PERMIT: DEV19-0220 PROJECT NUMBER 16011.00

SHEET TITLE

STORMWATER TREATMENT PLAN

SCALE 1" = 10' PC / CA Designed By PC / JL Checked By 2130712

SHEET NUMBER

C-10.12

ASA/USE PERMIT MODIFICATION #3 PLN-17-6943

(32) (N) 4" PVC (SDR-35 OR BETTER) RETAINING WALL SUBDRAIN PER DETAIL 2 ON C-7.2.

 $\langle 28 \rangle$ (n) storm drain manhole with metered release outlet. See detail 4 on sheet C-7.1.

(N) "CHRISTY FO8" AREA DRAINS. CONNECT TO ON-SITE STORM DRAIN SYSTEM. SEE DETAIL 6 ON C-7.1.

(N) BASEMENT LEVEL PERIMETER SUB DRAIN AROUND FOUNDATION. PIPE SHALL BE PERFORATED 4"

PVC (SDR-35) WITH HOLES DOWN. SLOPED © 1% MIN. SURROUND WITH 3/4" DRAIN ROCK AND WRAPPED IN FILTER FABRIC TO WITHIN 2' OF FINISHED ORADE (CONTINUE TO THE PROPERTY OF THE PRO

WRAPPED IN FILTER FABRIC TO WITHIN 2' OF FINISHED GRADE/ CONNECT TO RIP RAP OUTFALL.

 $\langle 27 \rangle$ install (n) rip-rap energy dissipater. See detail 3 on sheet C-7.1.


 $\langle 29 \rangle$ (N) "CHRISTY V-24" SILT BASIN WITH GRAVEL BOTTOM. SEE DETAIL 5 SHEET C-7.1.


 $\langle 33 \rangle$ (N) ROCKED LINE SWALE. SEE DETAIL 10 ON SHEET C-7.0.

 $\langle 34 \rangle$ (N) GRASSY SWALE. SEE DETAIL 5 ON SHEET C-7.0.

SEE DETAIL 1 ON SHEET C-7.2.

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ARCHITECTS

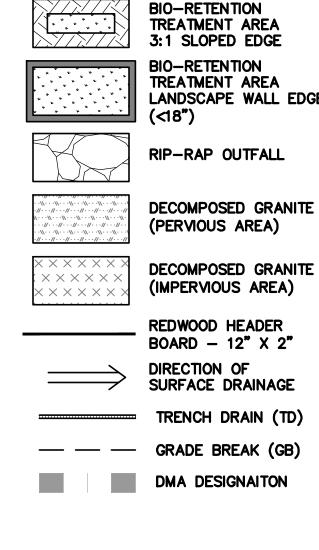

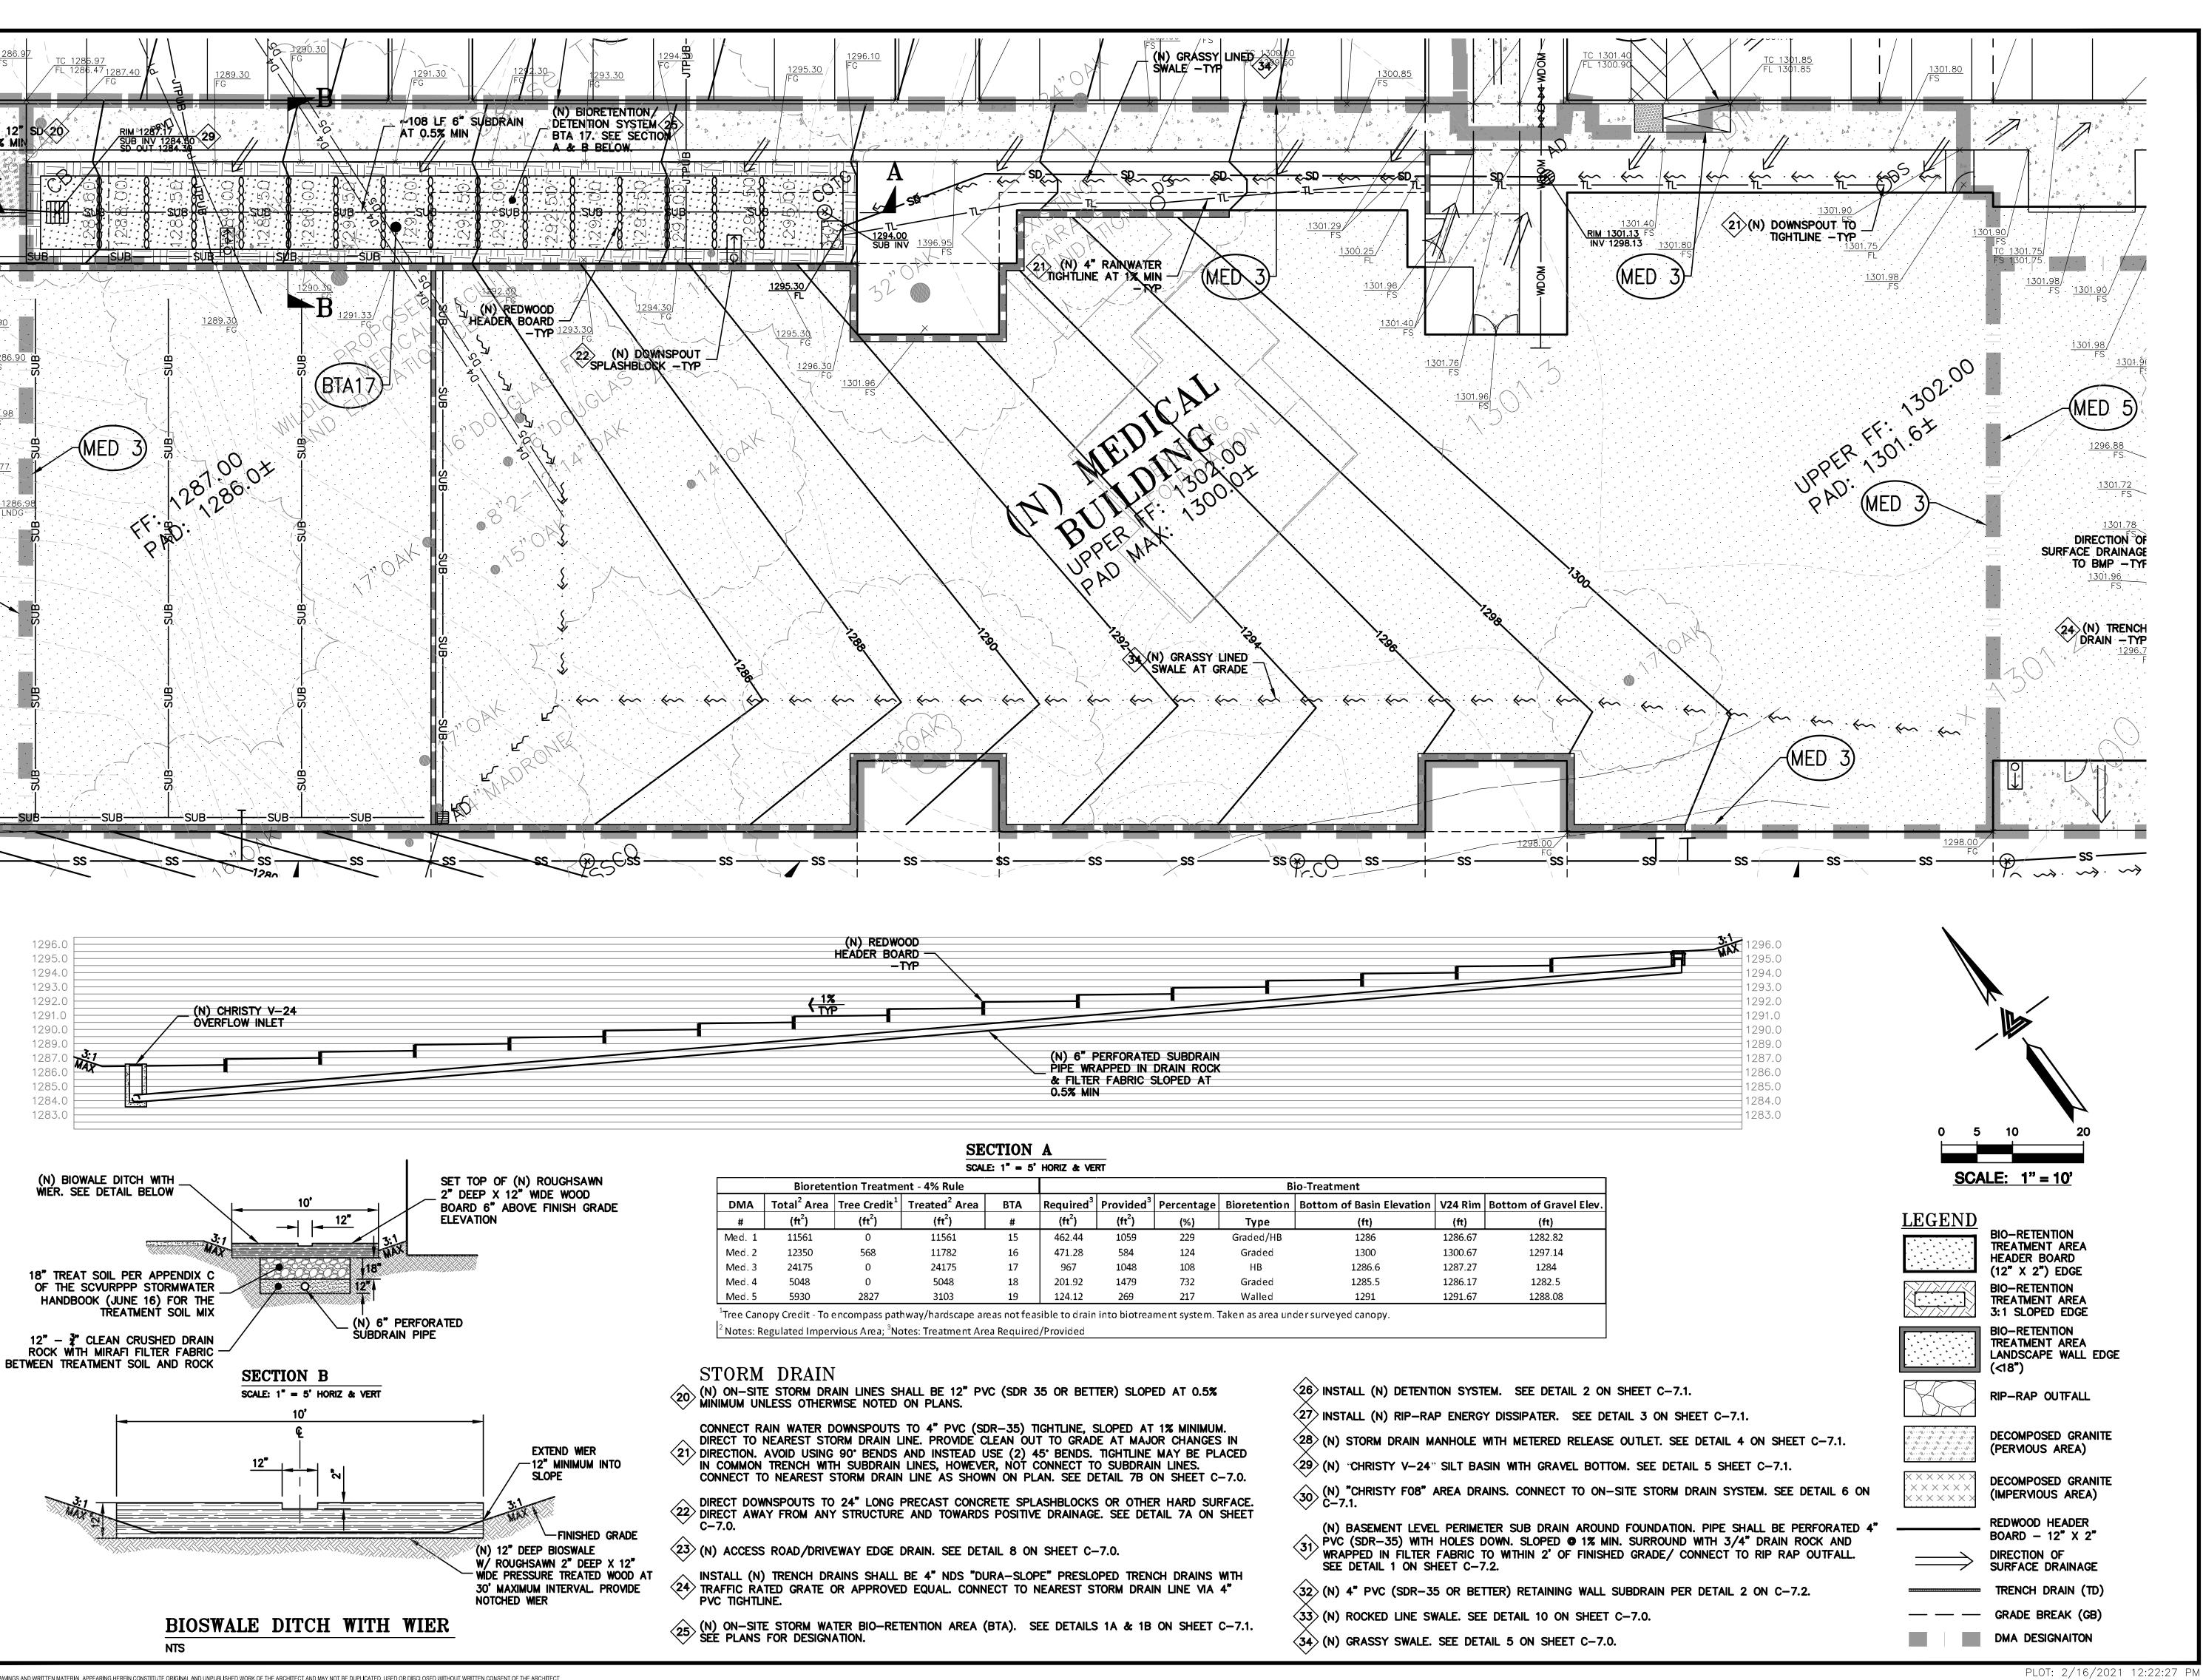ISSUES AND REVISIONS

GRADING PERMIT PLAN CHECK 4 12-21-18 PERMIT RESUBMITTAL

PERMIT MODIFICATION 03-26-19 PLAN CHECK 1 04-11-19 ASA DELTA 2 04-22-19 BID SET

05-10-19 BID SET ADDENDUM 05-22-19 UTILITY PLAN CHECK

08-06-19 PHASE 4 - PERMIT SUBMITTAL

09-20-19 CONSTRUCTION SET 1 01-28-20 PERMIT MODIFICATION 2

05-29-20 PLAN CHECK RESPONSE PERMIT MODIFICATION 2

07-22-20 UTILITY PLAN SUBMITTAL

SANTA CLARA COUNTY RECORD INFORMATION APPLICANT: PENINSULA HUMANE SOCIETY

ROAD: CONGRESS SPRINGS LDE FILE: 6943-17-17G GRADING PERMIT: DEV19-1838 UTILITY PERMIT: DEV19-0220

> PROJECT NUMBER 16011.00

> > SHEET TITLE

STORMWATER TREATMENT PLAN

SCALE 1" = 10' PC / CA


PC / JL Checked By 2130712

SHEET NUMBER

C-10.13

ASA/USE PERMIT MODIFICATION #3 PLN-17-6943

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ELLISON CONSERVATION CENTER FOR WILDLIFE CARE

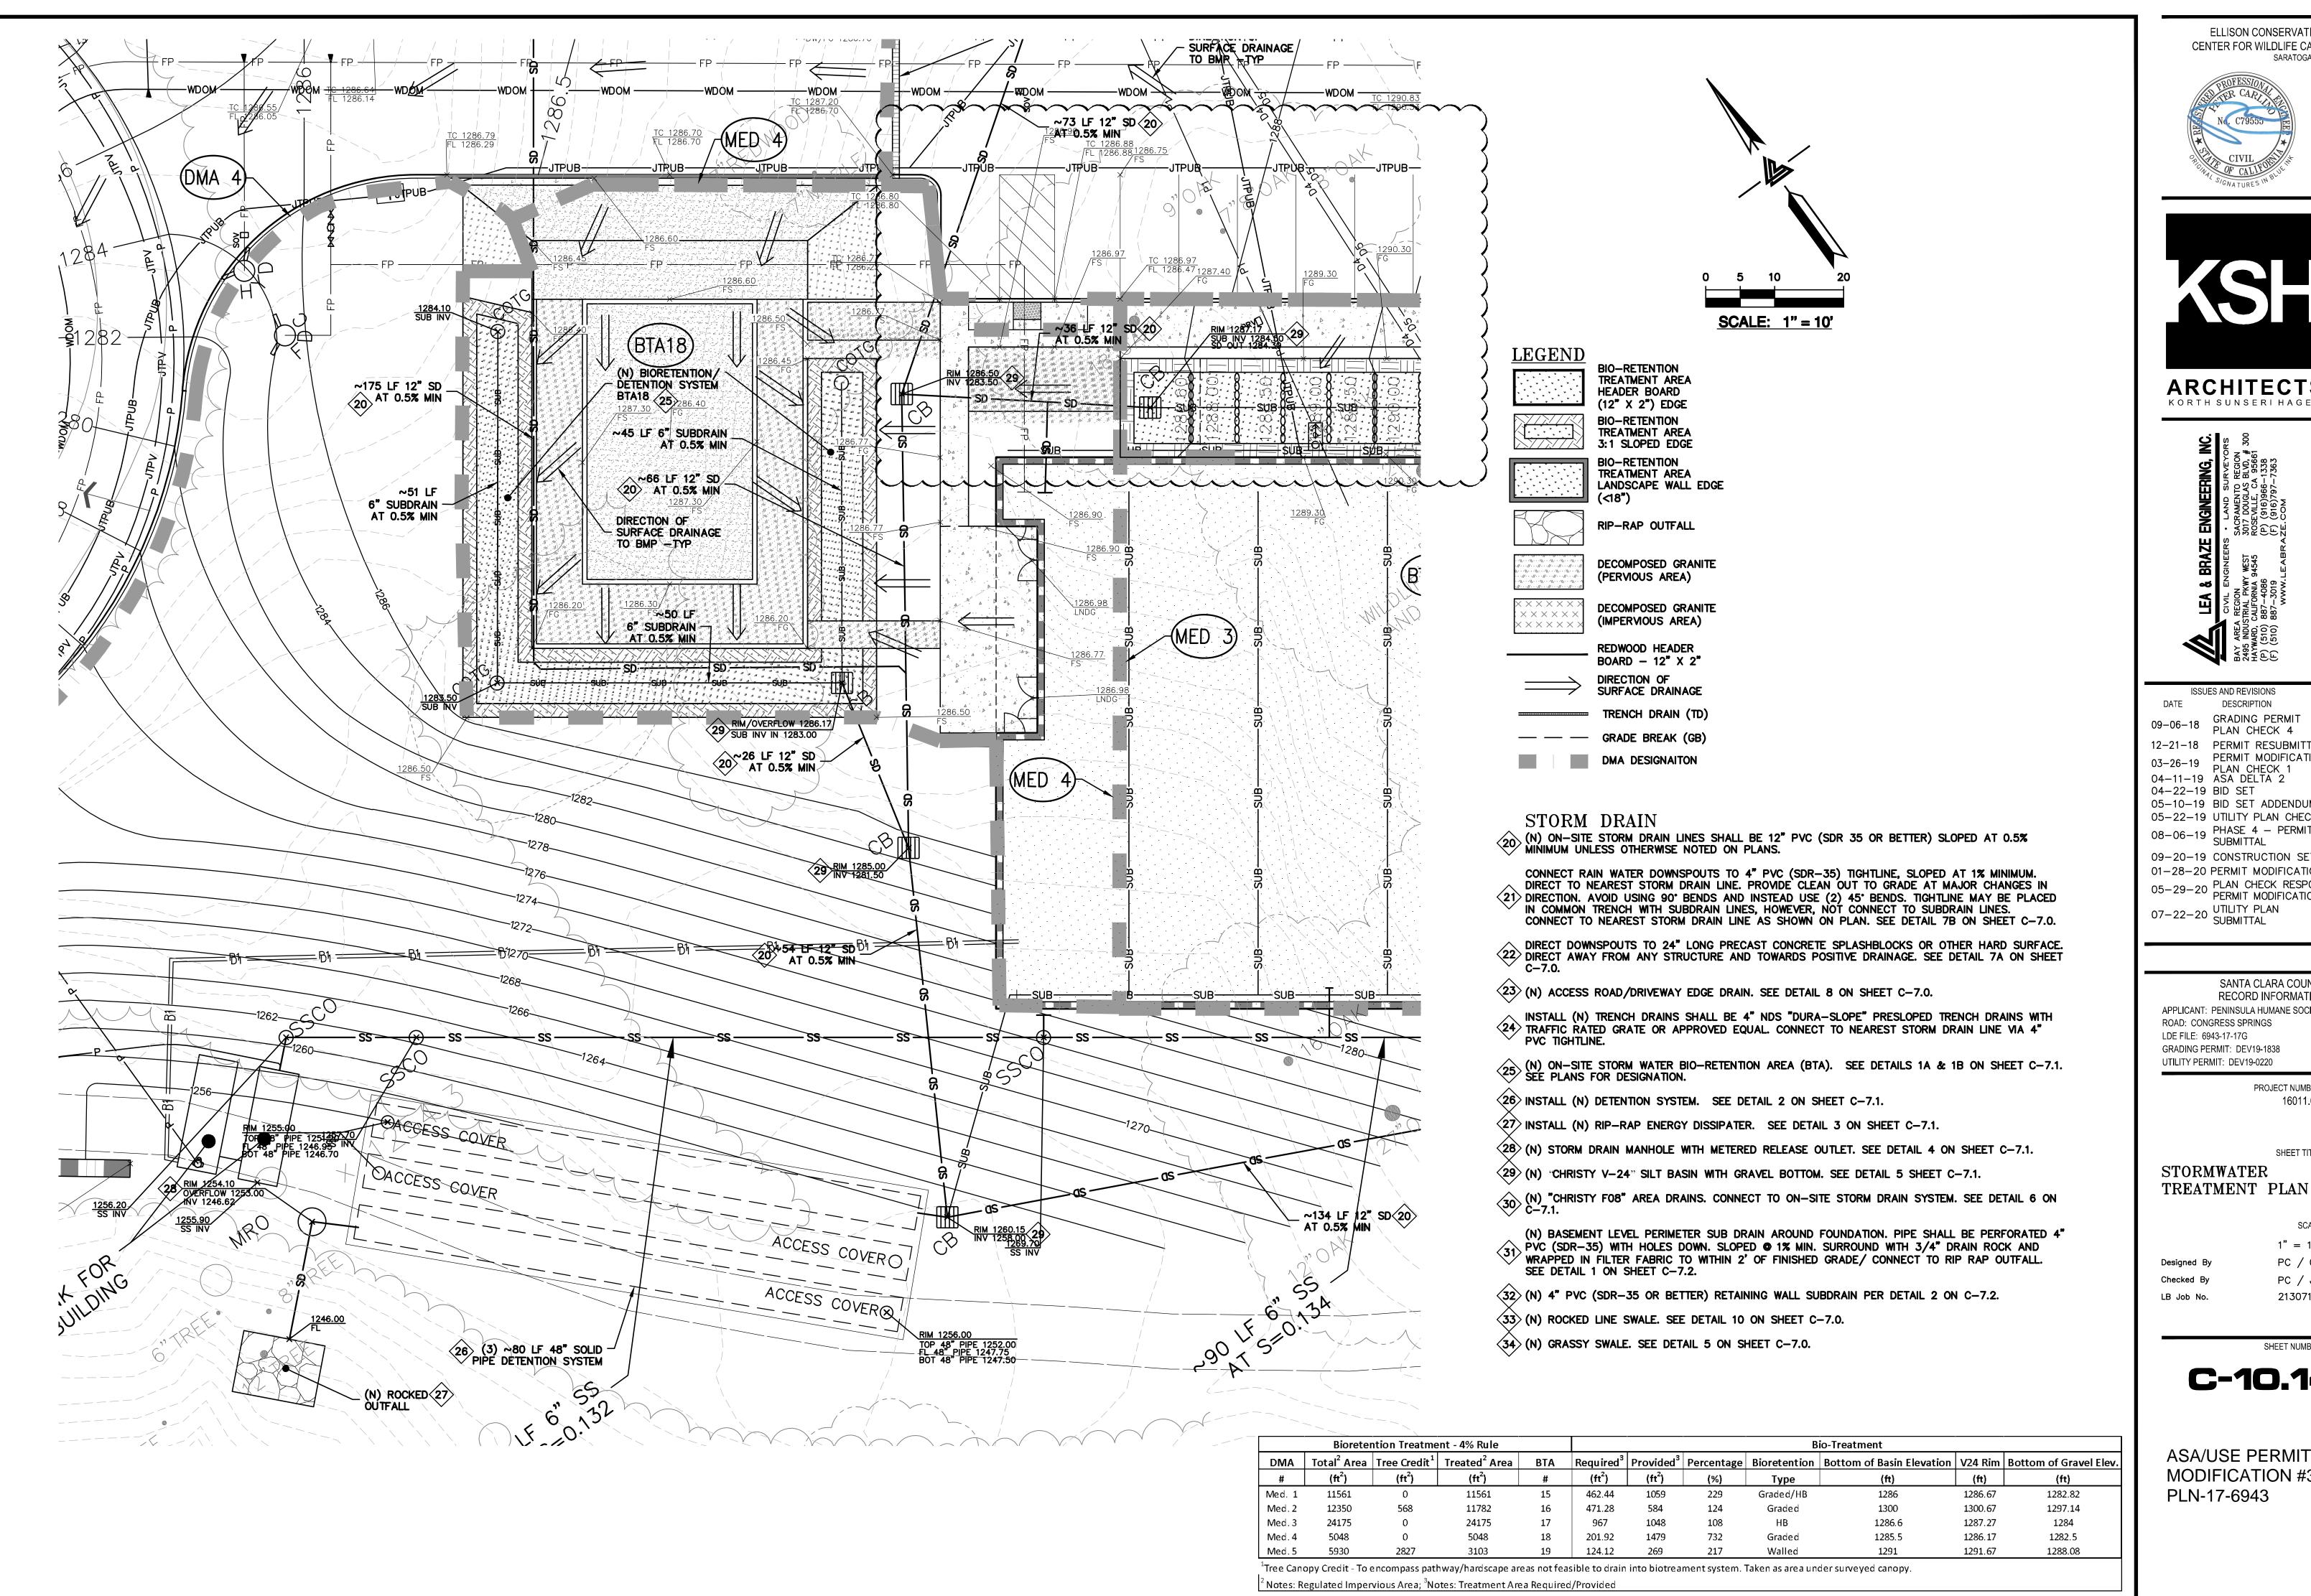



ARCHITECTS

ISSUES AND REVISIONS DESCRIPTION

GRADING PERMIT PLAN CHECK 4 12-21-18 PERMIT RESUBMITTAL PERMIT MODIFICATION 03-26-19 PLAN CHECK 1 04-11-19 ASA DELTA 2

04-22-19 BID SET 05-10-19 BID SET ADDENDUM

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09-20-19 CONSTRUCTION SET 1 01-28-20 PERMIT MODIFICATION 2

05-29-20 PLAN CHECK RESPONSE PERMIT MODIFICATION 2

07-22-20 UTILITY PLAN SUBMITTAL

SANTA CLARA COUNTY **RECORD INFORMATION** APPLICANT: PENINSULA HUMANE SOCIETY

ROAD: CONGRESS SPRINGS LDE FILE: 6943-17-17G GRADING PERMIT: DEV19-1838

UTILITY PERMIT: DEV19-0220 PROJECT NUMBER 16011.00


SHEET TITLE STORMWATER

SCALE 1" = 10' PC / CA

PC / JL Checked By 2130712

SHEET NUMBER

C-10.14

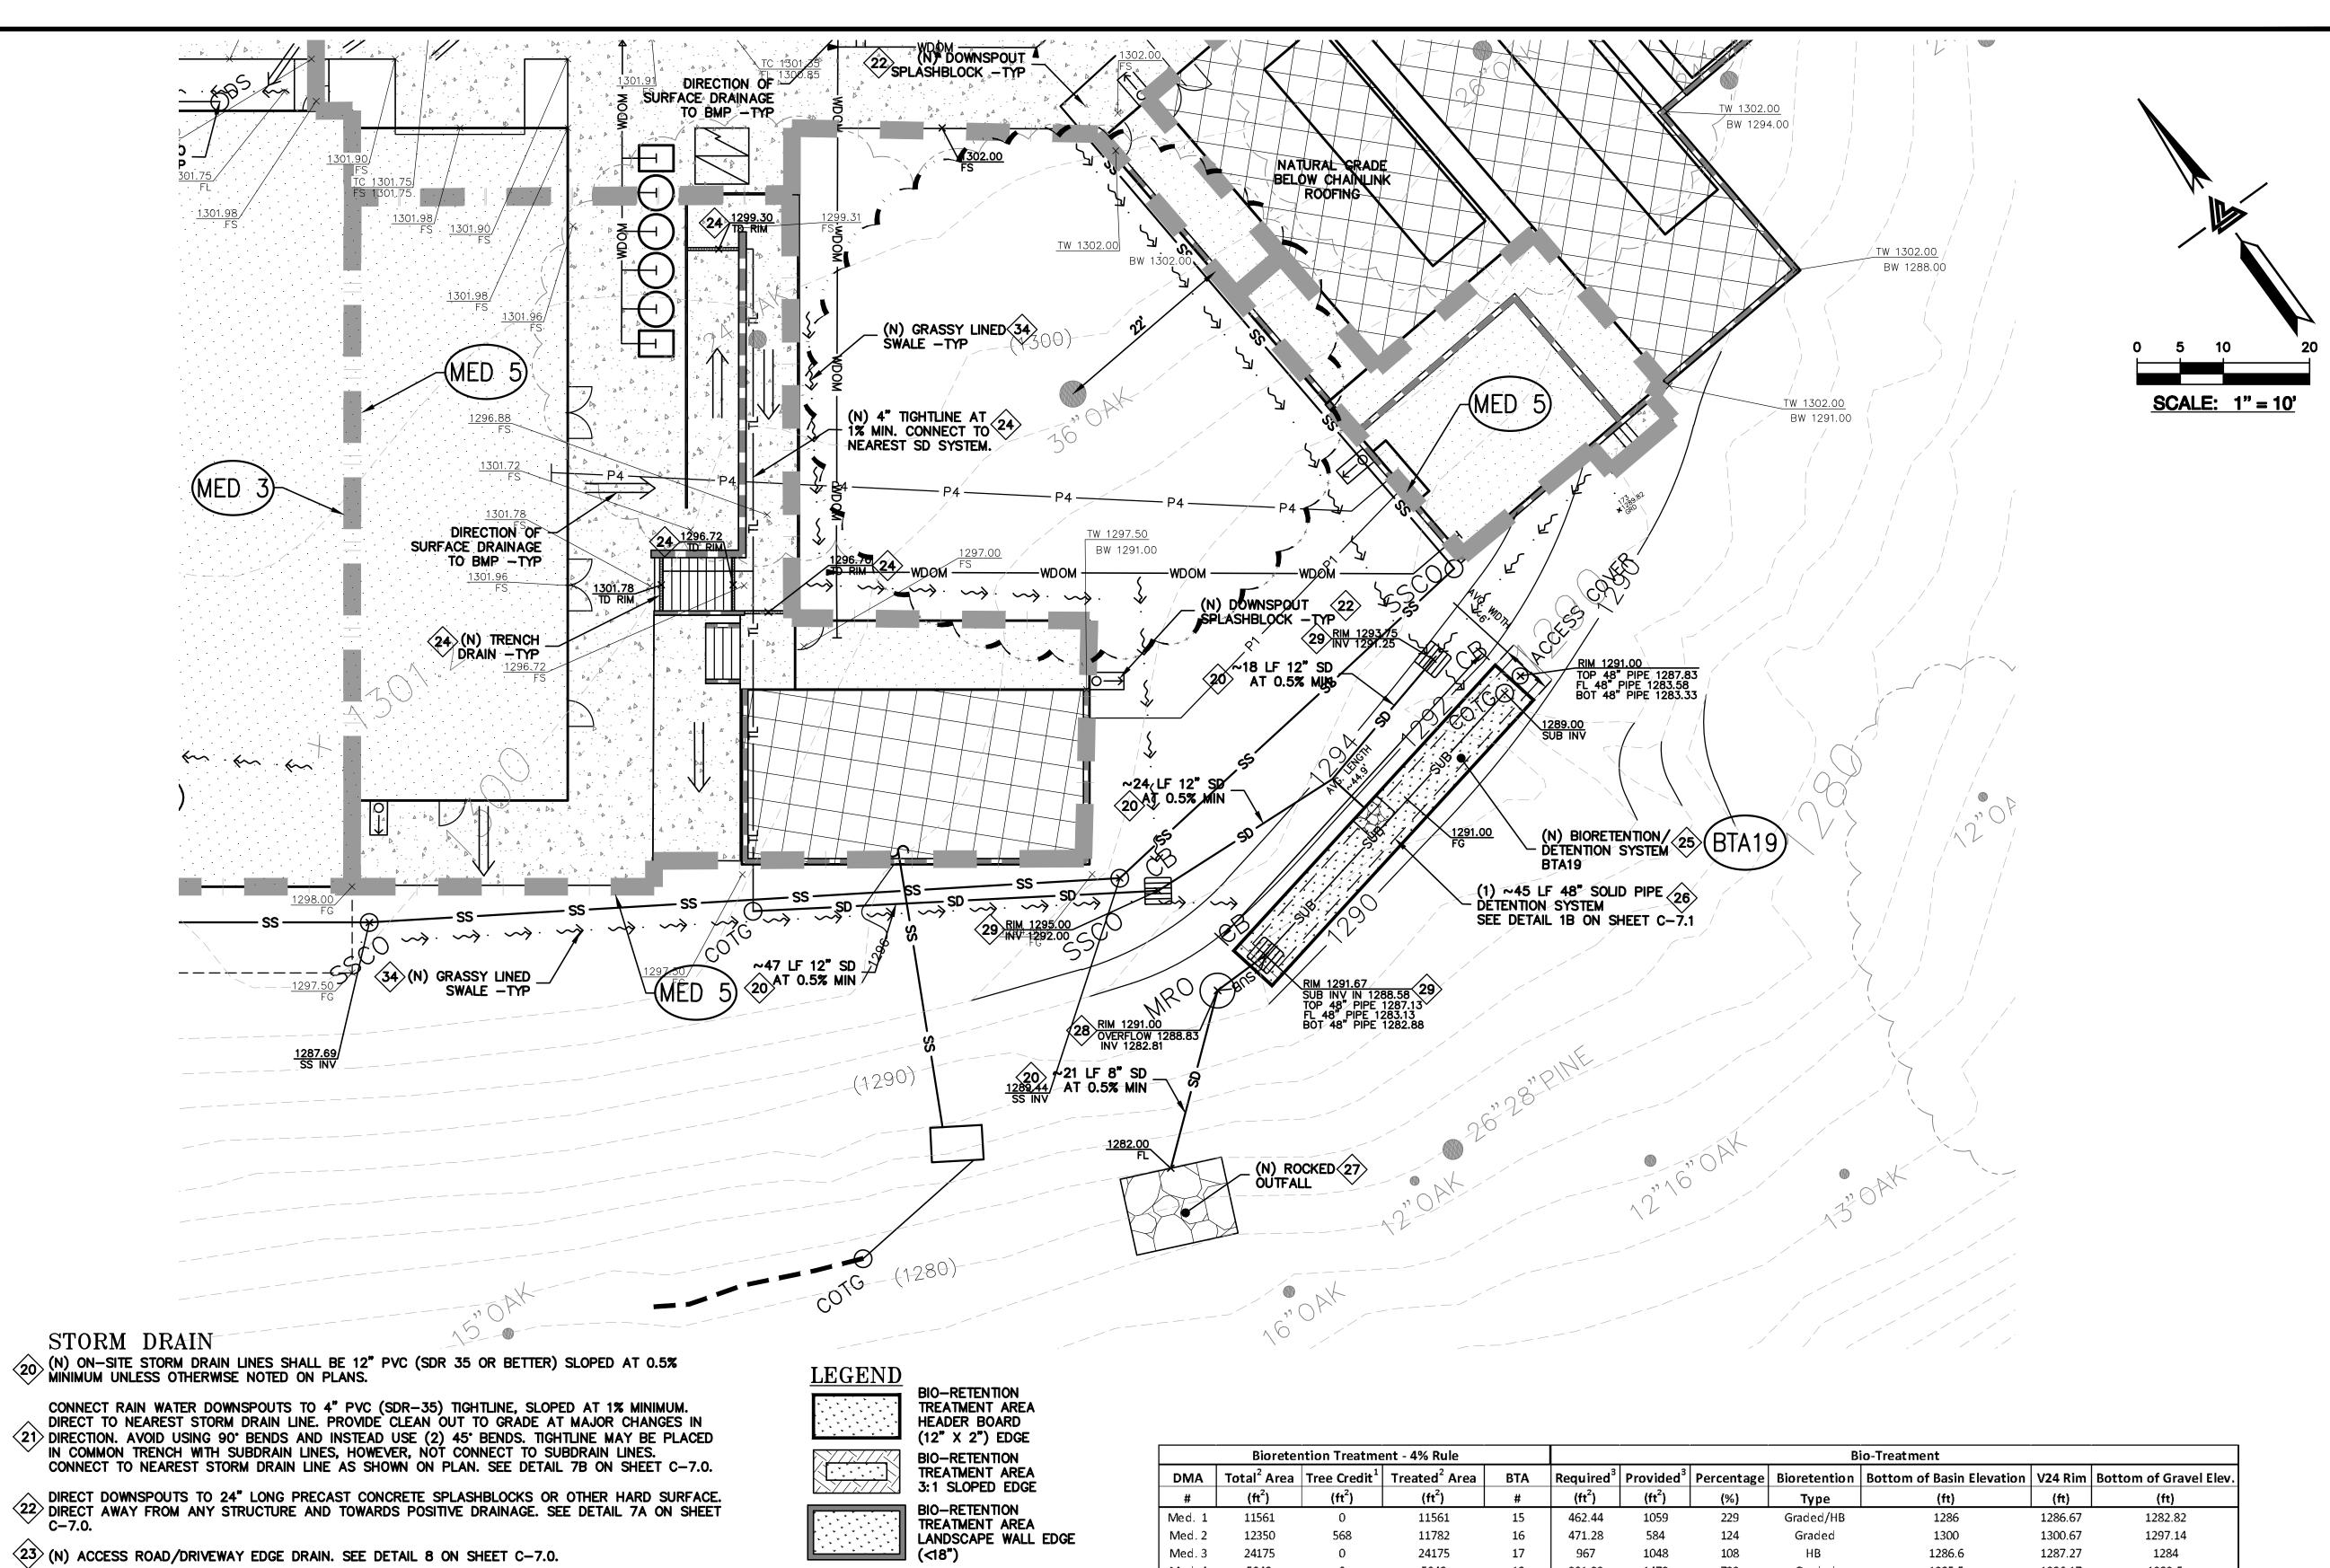

STORM DRAIN

CONNECT RAIN WATER DOWNSPOUTS TO 4" PVC (SDR-35) TIGHTLINE, SLOPED AT 1% MINIMUM. DIRECT TO NEAREST STORM DRAIN LINE. PROVIDE CLEAN OUT TO GRADE AT MAJOR CHANGES IN DIRECTION. AVOID USING 90' BENDS AND INSTEAD USE (2) 45' BENDS. TIGHTLINE MAY BE PLACED IN COMMON TRENCH WITH SUBDRAIN LINES, HOWEVER, NOT CONNECT TO SUBDRAIN LINES. CONNECT TO NEAREST STORM DRAIN LINE AS SHOWN ON PLAN. SEE DETAIL 7B ON SHEET C-7.0.

- (N) ACCESS ROAD/DRIVEWAY EDGE DRAIN. SEE DETAIL 8 ON SHEET C-7.0.
- INSTALL (N) TRENCH DRAINS SHALL BE 4" NDS "DURA-SLOPE" PRESLOPED TRENCH DRAINS WITH 24 TRAFFIC RATED GRATE OR APPROVED EQUAL. CONNECT TO NEAREST STORM DRAIN LINE VIA 4" PVC TIGHTLINE.
- (N) ON-SITE STORM WATER BIO-RETENTION AREA (BTA). SEE DETAILS 1A & 1B ON SHEET C-7.1. SEE PLANS FOR DESIGNATION.
- (26) INSTALL (N) DETENTION SYSTEM. SEE DETAIL 2 ON SHEET C-7.1.
- $\langle 27 \rangle$ install (n) rip-rap energy dissipater. See detail 3 on sheet C-7.1.
- $\langle 28 \rangle$ (n) storm drain manhole with metered release outlet. See detail 4 on sheet C-7.1.
- $\langle 29 \rangle$ (N) "CHRISTY V-24" SILT BASIN WITH GRAVEL BOTTOM. SEE DETAIL 5 SHEET C-7.1.
- (N) "CHRISTY FO8" AREA DRAINS. CONNECT TO ON-SITE STORM DRAIN SYSTEM. SEE DETAIL 6 ON C-7.1.
- PVC (SDR-35) WITH HOLES DOWN. SLOPED @ 1% MIN. SURROUND WITH 3/4" DRAIN ROCK AND WRAPPED IN FILTER FABRIC TO WITHIN 2" OF FINISHED ADARS (ACCUMENT TO THE PROCESS OF THE P (N) BASEMENT LEVEL PERIMETER SUB DRAIN AROUND FOUNDATION. PIPE SHALL BE PERFORATED 4" WRAPPED IN FILTER FABRIC TO WITHIN 2' OF FINISHED GRADE/ CONNECT TO RIP RAP OUTFALL. SEE DETAIL 1 ON SHEET C-7.2.
- (32) (N) 4" PVC (SDR-35 OR BETTER) RETAINING WALL SUBDRAIN PER DETAIL 2 ON C-7.2.
- (33) (N) ROCKED LINE SWALE. SEE DETAIL 10 ON SHEET C-7.0.
- (34) (N) GRASSY SWALE. SEE DETAIL 5 ON SHEET C-7.0.

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	BIO-RETENTION TREATMENT AREA LANDSCAPE WALL ED (<18")
	RIP-RAP OUTFALL
- - - - - - - -	DECOMPOSED GRANITI (PERVIOUS AREA)
× × × × × × × × × × × × × × × × × × ×	DECOMPOSED GRANITI (IMPERVIOUS AREA)
	REDWOOD HEADER BOARD - 12" X 2"
\Longrightarrow	DIRECTION OF SURFACE DRAINAGE
<u></u>	TRENCH DRAIN (TD)
	GRADE BREAK (GB)
	DMA DESIGNAITON


	Bioreter	ntion Treatme	ent - 4% Rule			Bio-Treatment							
DMA	Total ² Area	Tree Credit ¹	Treated ² Area	вта	Required ³	Provided ³	Percentage	Bioretention	Bottom of Basin Elevation	V24 Rim	Bottom of Gravel Elev.		
#	(ft²)	(ft ²)	(ft ²)	#	(ft ²)	(ft ²)	(%)	Туре	(ft)	(ft)	(ft)		
Med. 1	11561	0	11561	15	462.44	1059	229	Graded/HB	1286	1286.67	1282.82		
Med. 2	12350	568	11782	16	471.28	584	124	Graded	1300	1300.67	1297.14		
Med. 3	24175	0	24175	17	967	1048	108	НВ	1286.6	1287.27	1284		
Med. 4	5048	0	5048	18	201.92	1479	732	Graded	1285.5	1286.17	1282.5		
Med. 5	5930	2827	3103	19	124.12	269	217	Walled	1291	1291.67	1288.08		

¹Tree Canopy Credit - To encompass pathway/hardscape areas not feasible to drain into biotreament system. Taken as area under surveyed canopy.

² Notes: Regulated Impervious Area; ³Notes: Treatment Area Required/Provided

ELLISON CONSERVATION CENTER FOR WILDLIFE CARE



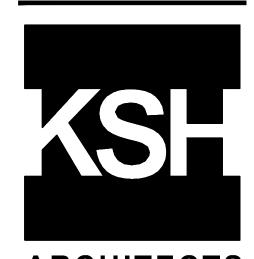

ARCHITECTS



09-06-18 GRADING PERMIT PLAN CHECK 4

12-21-18 PERMIT RESUBMITTAL PERMIT MODIFICATION 03-26-19 PLAN CHECK 1 04-11-19 ASA DELTA 2

04-22-19 BID SET 05-10-19 BID SET ADDENDUM

05-22-19 UTILITY PLAN CHECK 1 08-06-19 PHASE 4 - PERMIT SUBMITTAL

09-20-19 CONSTRUCTION SET 1 01-28-20 PERMIT MODIFICATION 2 05-29-20 PLAN CHECK RESPONSE PERMIT MODIFICATION 2

07-22-20 UTILITY PLAN SUBMITTAL

SANTA CLARA COUNTY **RECORD INFORMATION** APPLICANT: PENINSULA HUMANE SOCIETY

ROAD: CONGRESS SPRINGS LDE FILE: 6943-17-17G GRADING PERMIT: DEV19-1838 UTILITY PERMIT: DEV19-0220

> PROJECT NUMBER 16011.00


> > SHEET TITLE

STORMWATER TREATMENT PLAN

SCALE 1" = 10' PC / CA Checked By PC / JL 2130712

SHEET NUMBER

C-10.15

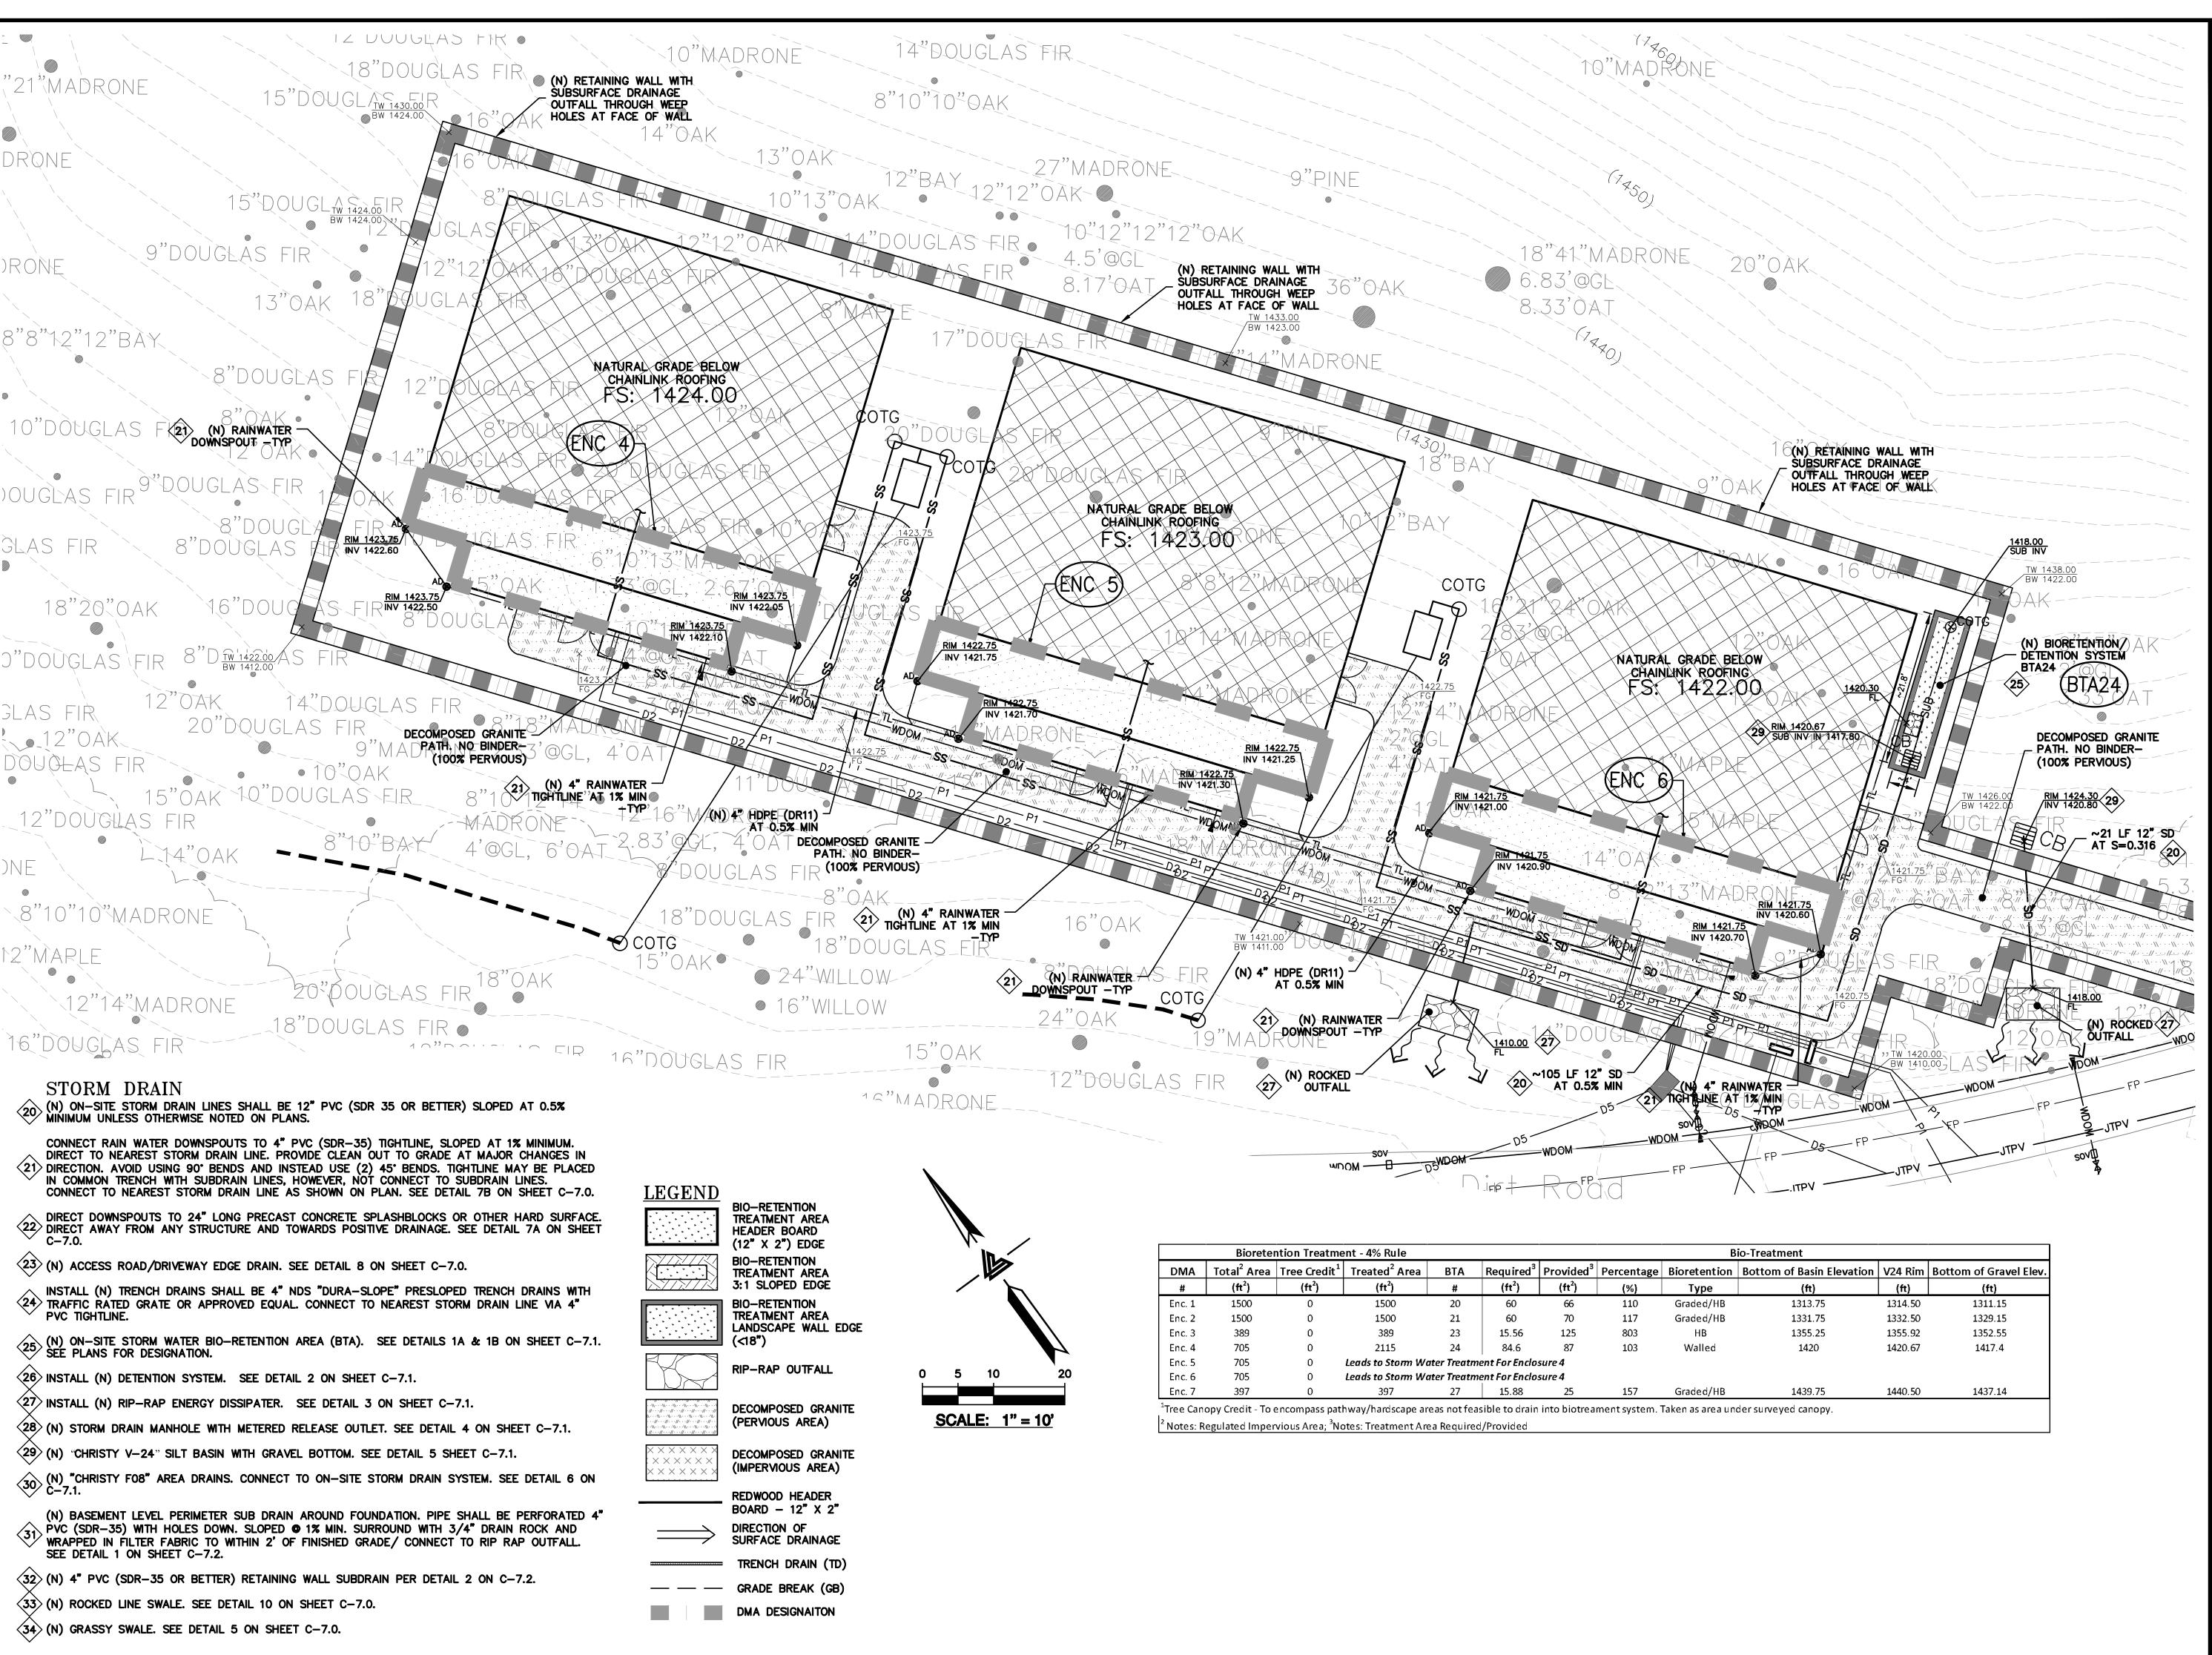







ISSUES AND REVISIONS GRADING PERMIT PLAN CHECK 4

12-21-18 PERMIT RESUBMITTAL PERMIT MODIFICATION 03-26-19 PLAN CHECK 1 04-11-19 ASA DELTA 2 04-22-19 BID SET

05-22-19 UTILITY PLAN CHECK 08-06-19 PHASE 4 - PERMIT SUBMITTAL

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UTILITY PERMIT: DEV19-0220 PROJECT NUMBER

16011.00

SHEET TITLE STORMWATER TREATMENT PLAN

SCALE 1" = 10' PC / CA PC / JL Checked By 2130712

SHEET NUMBER

C-10.16



Best Management Practices for the

Vehicle and equipment operators Site supervisors General contractors Home builders Developers

equipment ☐ If you must drain and replace motor oil use drip pans or drop cloths to catch

whenever possible. Do not use diesel oil to lubricate equip-

radiator coolant, or other fluids on site. drips and spills. Collect all spent fluids, store in separate containers, and recycle

possible.

What Can You Do?

Vehicle Maintenance -

parking,

refueling, and

routine.vehicle

and equipment

maintenance.

🔾 Maintain all

vehicles and

heavy equip-

ment. Inspect

frequently for

☐ Perform major

maintenance,

vehicle and

repair jobs, and

leaks.

Designate one area of the construction

site, well away from streams or storm

drain inlets, for auto and equipment

Site Planning and Preventive Clean up spills immediately when they happen.

Merer hose down "dirty" pavement or impermeable surfaces where fluids have spilled. Use dry cleanup metho

(absorbent Storm Drain Poliutions naterials, cat from Heavy Equipment on iller, and/or rags).whenever the Construction Site ossible. If you must use water,


Poorly maintained vehicles and heavy use just enough equipment leaking fuel, oil antifreeze or to keep the dust other fluids on the constr**uction site** are common sources of storm water pollution. Prevent spills and leaks by isolating equipment from runoff channels, and by watching for leaks and othermaintenance problems. Remove construction equipment from the site as soon as

Sweep up spilled dry materials nmediately. Never attempt "wash them away" with water or bury them.

Use as little water as possible for dust • Clean up spills on dirt areas by digging up and properly disposing of contami-

Report significant spills to the approprisie spill response agencies immediately

Roadwork and **Paving**

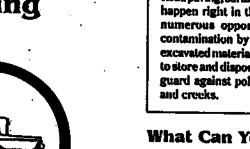

Best Management Practices for the Road crews

Driveway/sidewalk/parking lot construction crews Seal coat contractors Operators of grading equipment

Construction inspectors General contractors

dump trucks

Storm Drain Pollution from Roadwork

Road paving, surfacing, and pavement remove happen right in the street, where there are numerous opportunities for storm drain contamination by asphalt, saw-cut slurry, or excavated material. Extra planning is require to store and dispose of materials properly an guard against pollution of the storm drains

What Can You Do?

General Business Practices Develop and implement erosion/sedimen

control plans for embankments. Schedule excavation and grading work for

Check for and repair leaking equipment D Perform major equipment repairs in design nated areas at your yard, away from the onstruction site.

O When refueling or vehicle/equipment

maintenance must be done on site, designat a location away from storm drains and Do not use diesel oil to lubricate equipment

Recycle used oil, concrete, broken asphalt.

etc. whenever possible. **During Construction**

What Can You Do?

Chemical paint

ous waste.

Chips and dust

stripping residue is a hazard-

 Avoid paving and seal coating in wet. weather, or when rain is forecast before fresh pavement will have time to cure.

and

Use check dams, ditches, or berms to divert runoff around excavations. **Mortar Application**

Never wash excess material from expose aggregate concrete or similar treatments in a street or storm drain. Collect and recycle:

O Cover stockpiles (asphalt, sand, etc.) and other materials with plastic tarps. Protect from rainfall and prevent runoff with tennor rary roofs or plastic sheets and berms.

Cover and seal catch basins and manholes

when applying seal coat, slurry seal, fog seal,

Catch drips from paver with drip pans or absorbent material (cloth, rugs, etc.) placed under machine when not in use. ☐ Clear up all spills and leaks using "dry" methods (with absorbent materials and/o

rags), or dig up and remove contaminated Collect and recycle or appropriately dispose of excess abrasive gravel or sand.

Avoid over-application by water trucks for

dust control.

Asphalt/Concrete Removal

 Avoid creating excess dust when breaking asphalt or concrete.

After breaking old pavement, be sure to remove all chunks and pieces. Make sure broken pavement does not come

in contact with rainfall or runoff. Shovel or vacuum saw-cut sturry and remov from the site. Cover or barricade storm drain during saw-cutting if necessary.

Never hose down streets to clean up tracked

Fresh Concrete



Best Management Practices for the

Masons and bricklayers Sidewalk construction crew Patio construction workers Construction inspectors General contractors Home builders

Developers

What Can You Do?

General Business Practices

D Both at your yard and the construction site, always store both dry and wet materials under cover, protected from rainfall and runoff. Protect dry materials from wind.

☐ Secure bags of

cement after

wind-blown

cement powde

away from gut-

drains, rainfall

ters, storm

and runoff.

they are open.

Be sure to keep

Storm Drain Pollution

Fresh concrete and cement-related mortars that wash into lakes, streams, or estuaries are toxic to fish and the aquatic environment. Disposing of these materials to the storm drains or creeks causes serious problems — and is prohibited by

☐ Wash out concrete mixers only in designated wash-out areas in your yard, where the water will flow into containment ponds

or onto dirt. Whenever possible. recycle washout by pumping back into mixers for reuse. Never dispose of washout into the street, storm drains, drainage ditches, or

During Construction

O Don't mix up more fresh concrete or cement than you will use in a day.

O Set up and operate small mixers on tarps or heavy plastic drop cloths.

from Masonry and Paving

Place hay bales or other erosion controls down-slope to capture runoff carrying mortar or cement before it reaches the storm drain.

When cleaning

or sidewalk

construction,

wash fines onto

dirt areas, not

down the drive

way or into the

street or storm

up after driveway

When breaking up paving, be sure to pick up all the pieces and dispose prop-

Recycle large chunks of broken concrete

 Dispose of small amounts of excess dry concrete, grout, and mortar in the trash.

Never bury waste material.

Landscaping, Gardening. and



Landscapers Gardeners repair workers

Iome builders

Developers

Best Management Practices for the

Swimming pool/spa service and General contractors

dissipate for a few days, and then recycle/ reuse water by draining it gradually onto a

ity. You may be able to discharge to the

General Business Practices Protect stockpiles and landscaping material from wind and rain by storing them under tarns or secured plastic sheeting

What Can You Do?

Store pesticides, fertilizers, and other chem cals indoors or in a shed or storage cabinet,

 Schedule grading and excavation projects for dry weather. Use temporary check dams or ditches to divert runoff away

Protect storm drains with hay bales or other erosion controls.

from storm drains

Revegetation is an excellent form of erosion

Fountain/Spa

When emptying a pool or spa, let chloring

Do not use copper-based algaecides unles herbicide. Sewage treatment technology

dany landscaping activities expose soils and ncrease the likelihood that earth and garden themicals will run off into the storm drains during water containing chlorine and copper-based algaecides should never be discharged to storm drains. These chemicals are toxic to aquatic life.

Maintenance

Never discharge pool or spa water to a street

shouldely necessary. Control aligne with

Contact the local sewage treatment author-

smilary sewer by running a hose to a utility sink or sewer pipe cleanout junction.

chloring on other alternatives to copper based pool chemicals. Copper is a powerfu cannot remove all of the metals that enter a

La**ndscapi**ng/Garden Maintenance

Pool Maintenance

estment plant.

(See reverse.)

Storm Drain Pollution from Landscaping and Swimming

Collect lawn and garden clippings pruning waste,

Use up pesticide:

rinsewater as

product. Dispose

of rinsed contain-

hazardous waste.

Rinse containers

mings. Chip if necessary, and compost, recycling, leave clippings and pruning waste for pickup in approved bags or containers. Or, take to a landfill that composts yard

 Do not place yard waste in gutters. O Do not blow or rake leaves, etc. into the

Painting and Application of Solvents and

Best Management

Practices for the

Graphic artists

Dry wall crews

Floor covering installers

Adhesives

Keep all liquid paint products and wastes away from the gutter, street, and storm drains. Liquid residues from paints. thinners, solvents, glues, and cleaning fluids are hazardous wastes. When they are thoroughly dry, empty paint cans, spent

brushes, rags, and Storm drain pollution drop cloths may be from paints, solvents, disposed of as trash. and adhesives **Paint Removal**

All paints, solvents, and adhesives contain chemicals that are harmful to the wildlife in our creeks and Bay. Toxic chemicals may come from liquid or solid products or from cleaning residues or rags. It is especially important not to clean brushes in an area where paint residue can flow to a gutter, street, or storm drain.

from marine paints containing lead or tributyl tin are hazardous

wastes. Dry sweep and dispose of appro-Paint chips and dust from non-hazardou

swept up and disposed as trash

dry stripping and sand blasting may be

☐ When stripping or cleaning building exteriors with high-pressure water, block storm drains. Wash water onto dirt area and spade into soil. Or, check with the local wastewater treatment authority to find out if you can collect (mop or vacuum) building cleaning water and dispose to the sanitary sewer.

Dispose of empty aerosol paint cans as house-

Chemical paint stripping residue, including

laturated rags, is a hazardous waste and

should be taken to a household hazardou

Chips and dust from marine paints or paints

ous wastes. Sweep up and save for household

Reuse/recycle leftover paints

☐ Use up excess water-based paint or give it to a

collection programs recycle latex paint.

Q Use up leftover oil-based paint if possible. Paint

esidues are a hazardous waste and must be

General construction

Keep all construction debris away from the

 \mathbf{Q} Paint the inside of galvanized rain gutters to

street, gutter, and storm drain.

lid or tarp when not in use.

neighbor, or take to a household hazardous

waste event. Most household hazardous waste

whenever possible.

aken to collection events.

Paint removal

Painting Cleanup

Never clean brushes or rinse paint containers into a street, gutter, storm drain, or stream.

For water-based paints, paint out brushes to the extent possible, and rinse to the sanitary sewer.

For oil-based paints, paint out brushes to the extent possible. filter and reuse thinners and solvents. Dispos of excess liquids and residue as

Recycle excess water-based paint, or use up. Dispose of excess liquid, including sludges, as hazardous waste.

Recycle/reuse Jeftover paints enever possible.

Reuse leftover oil-based paint. Dispose of excess liquid, including sludges, as

Los Altos Municipal Code Requirements

Los Altos Municipal Code Section 5-5.639 Storm Drains; threatened discharges

a) Unlawful Discharges. It shall be unlawful to discharge any domestic waste or industrial waste into storm drains, gutters, creeks, or San Francisco Bay. Unlawful discharges to storm drains shall include, but not be limited to, discharges from toilets; sinks; industrial processes; cooling systems; boilers; fabric cleaning; equipment cleaning; vehicle cleaning; construction activities, including, but not limited to, painting, paving, concrete placement, sawcutting and grading; swimming pools; spar; and fountains, unless specifically permitted by a discharge permit or unless exempted pursuant to guidelines published

b) Threatened Discharges. It shall be unlawful to cause hazardous materials, domestic waste, or industrial waste to be deposited in such a manner or location as to constitute a threatened discharge into storm drains, gutters, creeks or San Francisco Bay. A "threatened discharge" is a condition creating a substantial probability of harm, when the probability and potential extent of harm make it reasonably necessary to take immediate action to prevent, reduce or mitigate damages to persons, property or natural resources. Domestic or industrial wastes that are no longer contained in a pipe, tank or other container are considered to be threatened discharges unless they are actively being cleaned up. Los Altos Municipal Code Section 5-5.643 Requirements for construction operations.

a) A spill response plan for hazardous waste, hazardous materials and uncontained construction materials shall be prepared and available at the construction sites for all projects where the proposed construction site is equal to or greater than five acres of disturbed soil and for any other projects for which the city engineer determines is necessary to protect surface waters. Preparation of the plan shall be in accordance with guidelines published by the b) A storm water pollution prevention plan shall be prepared and available at the construction sites for all projects greater than five acres of disturbed

soil and for any other projects for which the city engineer determines that a storm water management plan is necessary to protect surface waters. Preparation of the plan shall be in accordance with guidelines published by the city engineer. c) Prior approval shall be obtained form the city engineer or designee to discharge water pumped form construction sites to the storm drain. The discharge. Contaminated ground water or water that exceeds state or federal requirements for discharge to navigable waters may not be discharged to the storm drain. Such water may be discharged to the sewer, provided that the requirements of Section 5-5.624 are met and the approval of the superintendent

is obtained prior to discharge. d) No cleanup of construction debris from the streets shall result in the discharge of water to the storm drain system; nor shall any construction debris be deposited or allowed to be deposited in the storm drain system.

Los Altes Municipal Code Section 5-5.645 Enforcement; criminal penalties As provided in Chapter 1-2 of this code, violations of the provisions of this title shall be subject to criminal penalties, the following designated amployee positions may enforce the provisions of this title by the issuance of citations: Persons employed in such positions are authorized to exercise the authority provided in Penal Code Section 836.5 and are authorized to issue citations for violations of this chapter. The designated employee positions are: Peace officers, community service officers, Chief Building Official, Director of Public Works, associate engineer, industrial waste inspector, industrial waste investigator, environmental control programs, supervisor, industrial waste; and manager, environmental compliance division.

Las Altos Municipal Code Section 5-5,646 Enforcement; judicial civil penalties. Any person who intentionally or negligently violates any provision of this title or any provision of any permit issued pursuant to this title shall be cicilly liable to the City in a sum of not to exceed twenty-five thousand dollars (\$25,000) per day for each day in which such violation occurs. The City may petition the Superior Court pursuant to Government Code Scetion 54740 to impose, assess, and recover such sums. the remedy provided in this section is cumlative and not exclusive, and shall be in addition to the penalty provisions of Chapter 5-5.647 of this code and all other remedies available to the City

Storm Drain Pollution Prevention: It's Up to Us

In the Santa Clara Valley, storm drains flow directly to local creeks and San Francisco Bay, with no treatment. Storm water pollution is a serious problem for wildlife dependent on our waterways and for the people who live near polluted streams or baylands. Some common sources of this pollution include spilled oil, fuel, and fluids from vehicles and heavy equipment; construction debris; landscaping runoff containing pesticides or weed killers; and materials such as used motor oil, antifreeze, and paint products that people pour or spill into a street or storm drain.

Thirteen valley cities have joined together with Santa Clara County and the Santa Clara Valley Water District to educate local residents and businesses and fight storm drain pollution. We hope you will join us, by using the practices described in this sheet.

Spill Response Agencies

1. DIAL 911

2. Santa Clara Valley Water District **Environmental Compliance Division** (408) 927-0710.

3. Governor's Office of Emergency **Services Warning Center** (800) 852-7550 (24 hours).

Local Pollution Control Agencies

Santa Clara County Office of Toxics and Solid Waste Management (408) 441-1195

Santa Clara Valley Water District (408) 927-0710 Palo Alto Regional Water Quality

Control Plant (450) 329-2598 Serving East Palo Alto, Los Altos, Los Altos Hills, Mountain View, Palo Alto,


City of Los Altos

Building Department (650) 948-0226

and Stanford

General

Construction Site Supervision

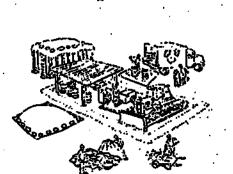

Advance Planning to Prevent Pollution

C Schedule excavation and grading activities for dry weather periods.

your site (especially during excavation!) h

using berms or drainage ditches to divert

Control the amount of runoff crossing

Train your employees and subcontrac tors. Make this sheet available to everyone who works on the site. Inform subcontractors about the new storm water requirements and their own responsibilities Refer to Blueprint for a Clean Bay, a construction best management practices guide available from the Santa Clara Valley Nonpoint Source Pollution Control Program.

 Designate one area of the site for auto parking, vehicle refueling, and routine equipment maintenance. The designated area should be well away from streams or storm drain inlets, and bermed

Make major repairs off site Keep materials out of the rain — prevent runoff at the source piles of soil or

construction abcontractors or employees. materials with plastic sheeting or temporary roofs. Before it rains, sweep and remove materials from surfaces that drain to storm drains, creeks, or channels .

Place trash cans and recycling receptacles around the site to minimize litter. Clean up leaks, drips and other spills immediately so they do not contaminate soil or groundwater or leave residue on

Never hose down "dirty" pavement or surfaces where materials have spilled.

Use dry cleanup methods whenever

mough to keep the dust down."

possible. If you must use water, use just

Good housekeeping Practices

ontractor, site supervisor, owner or operator of

environmental damage caused by your

 Keep pollutants off exposed surfaces. C) Use recyclable materials whenever pos-

> Dispose of all wastes properly, Many broken asplialt and concrete, wood, and deared vegetation can be recycled. (See the reference list of recyclers at the back of **Ineprint for a Clean Bay**) Materials that cannot be recycled must be taken to an

Cover and maintain dumpsters. Check irequently for leaks. Place dumbaters under roofs or cover with tarps or plastic sheeting secured around the outside of the dumpste

> Storm Drain Pollution: rom Construction Activities Construction sites are communicated of storm water pollution. Materials and wastes that blow er wash into a storm drain, guller, or street have direct impact on local creeks and the Bay. As a

Check frequently site, you may be responsible for any Materials/ Waste/

> Handling Practice Source Reduction - minimize waste when you order materials. Order only the amount you need to finish the job.

construction materials and wastes, including solvents, water-based paints, vehicle fluids, appropriate landfill or disposed of as hazardous waste. Never bury waste materials or leave them in the street or near a creek

Never clean out a dumputer by

working order

All paints, solvents, and adhesives contain chemicals that are harmful to aquatic animals and other wildlife in our creeks and Bay, Toxic chemicals may come from liquid or solid produc or from cleaning residues on rags. It is especially important not to clean brushes or painting quipment (buckets, pans, hoses,etc.) in an area

hosing it down gutter, street, or storm drain. on the constru Painting cleanup Make sure portable tollets For water-based paints, paint out brushes on are in good

through your local household hazardous waste

General construction Landscaping/foundation work Painting and paint cleanup

Masonry and tile work

Painting and paint cleanup

where paint or paint cleanup water can flow to a Never clean brushes or rinse paint container into a street, gutter, storm drain, or stream,

to the sanitary sewer.

extent possible, filter and reuse thinners and solvents. Dispose of excess paint and thinner

scrap material to the extent possible, and rinse

For oil-based paints, paint out brushes to the

When they are thoroughly dry, empty paint cama, spent brushes, rags, and drop cloths may be disposed of as trash. Leave the lids off pair rans so the refuse collector can see that they

Remodeling Landscaping/ foundation work

Intensive gardening, landscaping, and all excavation projects such as foundation repair or pool containing lead or tributy! tin are also hazardonstruction expose soils and increase the likelihood that garden chemicals and earth will wash into the storm drains. Be careful to contro rosion and minimize runoff to all driveways.

gutters, and storm drains,

dry weather. Cover excavated material and stockpiles (asphalt, sand, etc. with plastic tarps during the Replant as soon as possible, with temporary regetation such as annual grass seed if neces-

sary. Revegetation provides excellent erosion

up leftover supply. Rinse empty containers, and

use rinse-water as you would use the product.

Take care not to over-apply pesticides, and use

Do not blow or rake leaves, etc. into the street

or place yard waste in gutters or on dirt

Schedule grading and excavation projects for

 Dispose of unused pesticides as hazardous O During cleanup, check the street and gutters for refuse or debris. Look around the corner of Collect lawn and garden clippings, pruning waste, and tree trimmings. Many cities and ownstream for material that may have already raveled away from your property. landfills have yard waste composting programs. Check with your local recycling If you or your contractor keep a dumpster at your site, be sure it is securely covered with a

Home Repair Santa Clara Valley

O In unincorporated areas and communities with curbside yard waste recycling, leave clippings

> Concrete, masonry, and tile work

blown cement powder away from gutters, Horm drains, rainfall, and runoff, Wash down exposed aggregate concrete only when wash water can flow onto a dirt area, or be collected, pumped, and disposed of proprly. Make sure runoff does not reach gutters

Don't mix up more fresh concrete or cemen

than you will use in a day.

 Dispose of small amounts of excess dry concrete, grout, and mortar in the trash. Call your local refuse hauler for weight and size

Collect and reuse excess gravel and sand.

Never hose down driveways, sidewalk, or

Nonpoint Source Pollution Control Program

and pruning waste for pickup in approved bags

Cover and protect bags of cement and plaste. after they are open. Be sure to keep wind-


☐ Never wash excess material from bricklaying or patio or driveway construction into a streor storm drain. Empty mixing container onto a lirt area, or allow material to dry and put in

caused by your subcontractors or employees.

Best Management Practices for the **Construction Industry**



Santa Clara Valley **Urban Runoff Pollution Prevention Program**

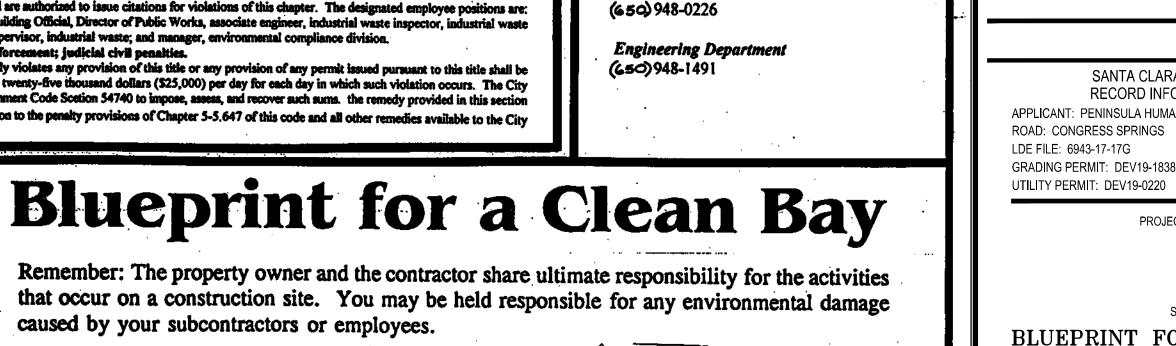

BLUEPRINT FOR A CLEAN BAY

Checked By

SHEET NUMBER

ASA/USE PERMIT MODIFICATION #3 PLN-17-6943

LOYANCED REPRO. SUPPLY 120843

ELLISON CONSERVATION CENTER FOR WILDLIFE CARE



ARCHITECTS

KORTH SUNSERI HAGE`

GRADING PERMIT PLAN CHECK 4 PERMIT RESUBMITTAL PERMIT MODIFICATION 04-11-19 ASA DELTA 04-22-19 BID SET 05-10-19 BID SET ADDENDUM 05-22-19 UTILITY PLAN CHECK 08-06-19 PHASE 4 - PERMIT SUBMITTAL 09-20-19 CONSTRUCTION SET

07-22-20 UTILITY PLAN SUBMITTAL

ISSUES AND REVISIONS

DESCRIPTION

SANTA CLARA COUNTY RECORD INFORMATION APPLICANT: PENINSULA HUMANE SOCIET **ROAD: CONGRESS SPRINGS** LDE FILE: 6943-17-17G

01-28-20 PERMIT MODIFICATION 2

05-29-20 PLAN CHECK RESPONSE PERMIT MODIFICATION 2

PROJECT NUMBER

SHEET TITLE

PC / JL

2130712

1" = 10' PC / CA

C-10.17

PLOT: 2/16/2021 12:29:38 PM

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