
GEORGE P. SHULTZ BUILDING: ASA APPLICATION

STANFORD PROJECT # 5413 BLDG ID 03-140 PARCEL # 142-07-085 580 SERRA MALL, STANFORD, CA 93405

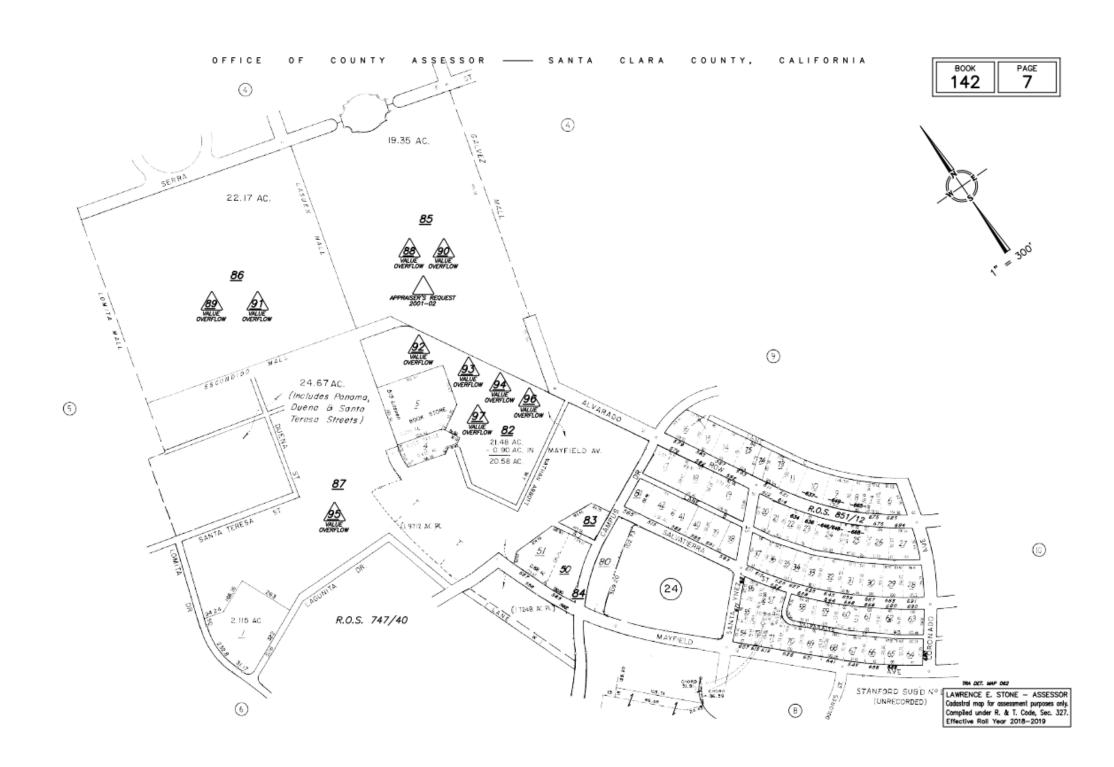

ASSESSOR'S PARCEL MAP: NTS



SITE AREA PLAN: NTS

SHEET INDEX - ASA

OENEDAL	
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A0.00B	GUP ANALYSIS - SHULTZ
CIVIL	GOL ANALTOIO GITOLIZ
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C2.00	SITE UTILITY DEMOLITION PLAN
C3.00	SITE UTILITY PLAN
C3.10	STORMWATER MANAGEMENT PLAN
C4.00	SITE GRADING PLAN
C5.00	SECTIONS
C5.10	SECTIONS
C5.20	SECTIONS
C5.30	SECTIONS
C6.00	EROSION CONTROL PLAN
C7.00	FIRE TRUCK TURNING EXHIBIT
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A1.01	FIRST FLOOR PLAN
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A1.04	FOURTH FLOOR PLAN
A1.05	ROOF PLAN
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A2.09	BUILDING SECTIONS
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A2.13	SITE ALIGNMENT
A2.14	HEIGHT COMPARISONS

CODE INTERPRETATIONS

ALL FLOORS EXCEPT FIRST

EXTERIOR ELEVATIONS - EAST & WEST

EXTERIOR ELEVATIONS - SOUTH EXTERIOR ELEVATIONS - NORTH

OCCUPANCY TYPE:

S-2	BASEMENT
TYPE OF CONSTRUCTION	ON: IIB
STRUCTURE RATING:	1 HR FROM 2ND FLOOR SLAB, 1ST FLOOR SLAB & STRUCTURE SUPPORTING LEVELS 1 AND 2.
FIRE SPRINKLER:	YES
BUILDING HEIGHT:	69'-4"
ALLOWABLE HEIGHT:	75'
BUILDING AREAS: BASEMENT FIRST FLOOR: SECOND FLOOR: THIRD FLOOR: FOURTH FLOOR: TOTAL:	11,449 10,872 11,132 11,132 10,887 55,472

PROJECT DESCRIPTION

DEMOLITION OF EXISTING LOU HENRY HOOVER BUILDING EXCEPT FOR SOUTHEAST CORNER WHERE IT CONNECTS WITH HOOVER TOWER. REPLACEMENT WITH A NEW GEORGE P. SHULTZ BUILDING, WITH 4 STORIES ABOVE GRADE AND 1 BASEMENT LEVEL.

SEPARATED OCCUPANCIES

NEW BUILDING CONNECTS WITH BASEMENT AND SITE RAMPS OF EXISTING HERBERT HOOVER MEMORIAL BUILDING. THE NEW BUILDING PROGRAM INCLUDES GATHERING SPACE ON THE FIRST FLOOR AND OFFICE SPACE FOR FLOORS 2 TO 4. BASEMENT WILL INCLUDE A DIGITIZATION STUDIO, STORAGE ROOM AND MECHANICAL SPACES

NEW BUILDING WILL BE FULLY SPRINKLERED.

SITE DATA INFORMATION

GENERAL SITE INFORMATION:

APN:	142-07-085
PARCEL SIZE (WITHIN LIMITS OF WORK)	19.35 ACRES
DEVELOPMENT DISTRICT A1	A1
LAND USE DESIGNATION ACADEMIC	ACADEMIC
BUILDING FOOTPRINT	10,872 SF
SITE AREA	0.89 ACRES
DEMOLITION AREA	0.89 ACRES

GUP SQUAREFOOTAGE ANALYSIS

METHOD 2 (GUP) (EXISTING BUILDING TO BE DEMOLISH
13,955 SF
1,665 SF
12,290 SF
14,323 SF
147 SF
14,176 SF
11,304 SF
183 SF
11,121 SF
11,263 SF
rs 207 SF
11,056 SF
AGE 48,643 SF

GEORGE P. SHULTZ BUILDING (NEW	BUILDING)
BASEMENT B2 GROSS AREA:	11,449 S
BASEMENT B2 ADJUSTMENTS	2,964 S
ADJUSTED SQUARE FOOTAGE	8,485 S
FIRST FLOOR GROSS AREA:	10,872 S
FIRST FLOOR ADJUSTMENTS	520 S
ADJUSTED SQUARE FOOTAGE	10,352 S
SECOND FLOOR GROSS AREA:	11,132 S
SECOND FLOOR ADJUSTMENTS	402 S
ADJUSTED SQUARE FOOTAGE	10,730 S
THIRD FLOOR GROSS AREA:	11,132 S
THIRD FLOOR ADJUSTMENTS	605 S
ADJUSTED SQUARE FOOTAGE	10,527 S
FOURTH FLOOR GROSS AREA:	10,887 S
FOURTH FLOOR ADJUSTMENTS	2,338 S
ADJUSTED SQUARE FOOTAGE	8,549 S
TOTAL ADJUSTED GUP SQUAREFOOTAGE	48,643 S

PROJECT DIRECTORY

Client/Owner

Stanford University	Helena Cipres-Palacin	Project Manager	helenacp@stanford.edu
3160 Porter Drive, Suite 200 Palo Alto, CA 94304 Phone: 650.723.9071			
<u>Architect</u>			
CAW Architects, Inc.			
455 Lambert Avenue Palo Alto, CA 94306 Phone: 650.328.1818 Fax: 650.328.1888	Chris Wasney Mousam Adcock Pui San Ng Thomas Koyama Kimberly Castillo Alex Siegel	Principal Project Manager Project Architect Designer Designer Designer	csw@cawarchitects.com mousam@cawarchitects.com psng@cawarchitects.com tkoyama@cawarchitects.com kcastillo@cawarchitects.com asiegel@cawarchitects.com
William Rawn Associates, Archited	cts, Inc.		
10 Post Office Square, Suite 1010 Boston, MA 02109 Phone: 617.423.3470	Doug Johnston Erik Tellander Sasha Spriggs Paul Governor	Principal Senior Associate Designer Designer	djohnston@rawnarch.com etellander@rawnarch.com sspriggs@rawnarch.com pgovernor@rawnarch.com
Landscape Engineer			
SWA			
2200 Bridgeway Boulevard PO Box 5904 Sausalito, CA 94966 Phone: 415.332.5100	John Wong Bill Hynes Carson Lindley	Principal Project Manager Designer	jwong@swagroup.com whynes@swagroup.com clindley@swagroup.com
Civil Engineer			
BKF Engineers			
4670 Willow Road, Suite 250 Pleasanton, CA 94588 Phone: 925.396.7700	John Lamon Steven Reynolds Chelsea Mudgett	Associate Project Manager Project Engineer	jlamon@bkf.com sreynolds@bkf.com cmudgett@bkf.com



455 LAMBERT AVENUE PALO ALTO, CA 94306



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<u> </u>	DATE
C ASA SUBMISSION	07/31/201

GEORGE P. SHULTZ BUILDING

HOOVER INSTITUTION

580 SERRA MALL


STANFORD, CA 93405

SHEET TITLE

ASA SUBMITTAL SET **COVER SHEET**

PROJECT NO. 14029 DRAWN BY TK, KC, AS CHECKED BY PN, MA, CSW

A0.00

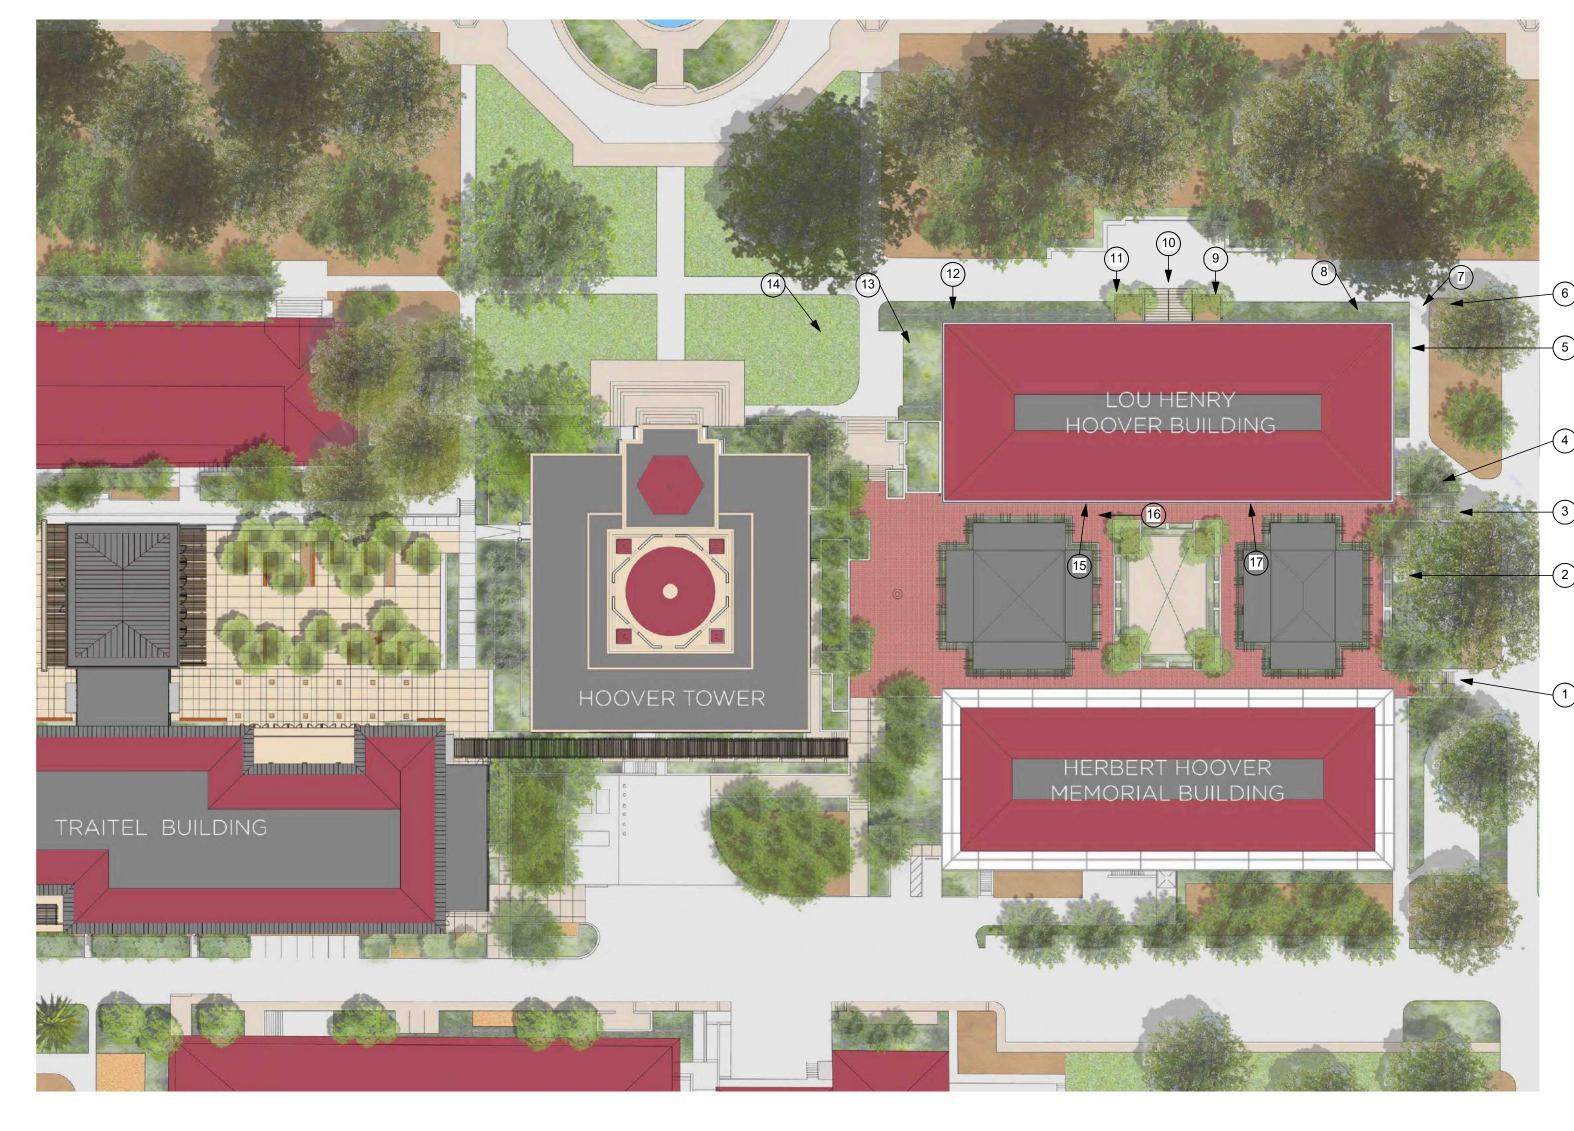












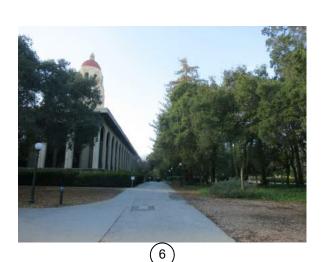









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MILESTONE DATE C ASA SUBMISSION 07/31/2019

PROJECT NAME

SHEET TITLE

GEORGE P. SHULTZ BUILDING


HOOVER INSTITUTION


580 SERRA MALL

STANFORD, CA 93405

EXISTING CONDITIONS

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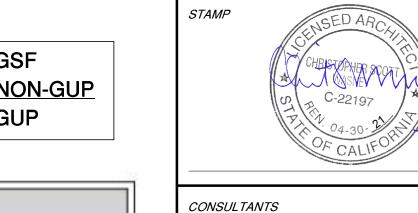


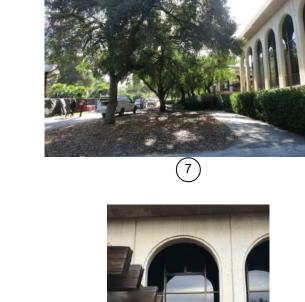

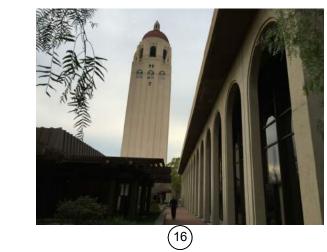	GROSS		GROSS		GROSS	
ECOND FLOOR:	11,263 SF	-	0 SF	=	11,263 SF	
IRST FLOOR:	11,304 SF	-	0 SF	=	11,304 SF	
ASEMENT 1:	15,697 SF	-	1,374 SF	=	14,323 SF	
ASEMENT 2:	16,072 SF	-	2,117 SF	=	<u>13,955 SF</u>	
OTAL	54,336 SF	-	3,491 SF	=	50,845 SF	

		₩
	GUP	GROSS
SECOND FLOOR:	11,056 SF	11,263 SF
FIRST FLOOR:	11,121 SF	11,304 SF
BASEMENT 1:	14,176 SF	14,323 SF
BASEMENT 2:	12,290 SF	13,955 SF
TOTAL	48,643 SF	50,845 SF

14,323 GSF - 147 NON-GUP 14,176 GUP



	MILESTONE	DATE
С	ASA SUBMISSION	07/31/2019

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13,955 GSF - 1,665 NON-GUP

PROJECT NAME

GEORGE P. SHULTZ BUILDING

HOOVER INSTITUTION 580 SERRA MALL

STANFORD, CA 93405

SHEET TITLE

GUP ANALYSIS - LHHB

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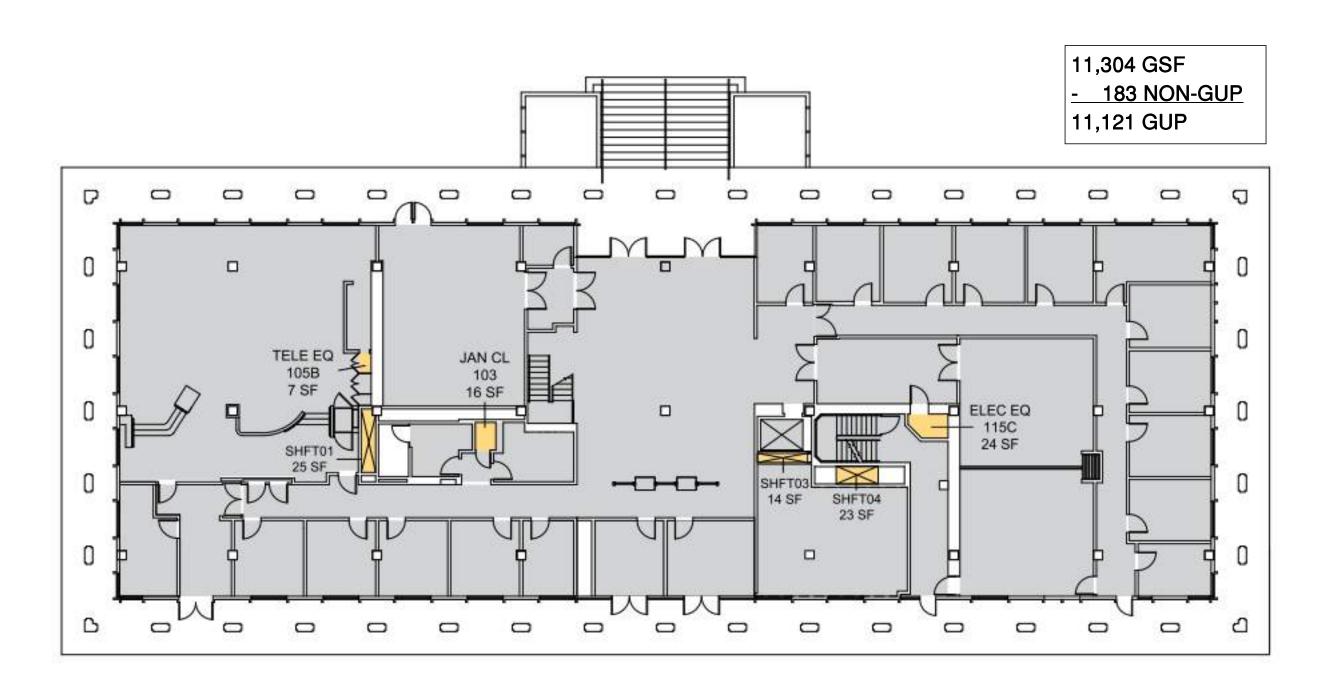
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11,263 GSF


11,056 GUP


- 207 NON-GUP

SECOND FLOOR PLAN



FIRST FLOOR PLAN
1/16" = 1'-0"

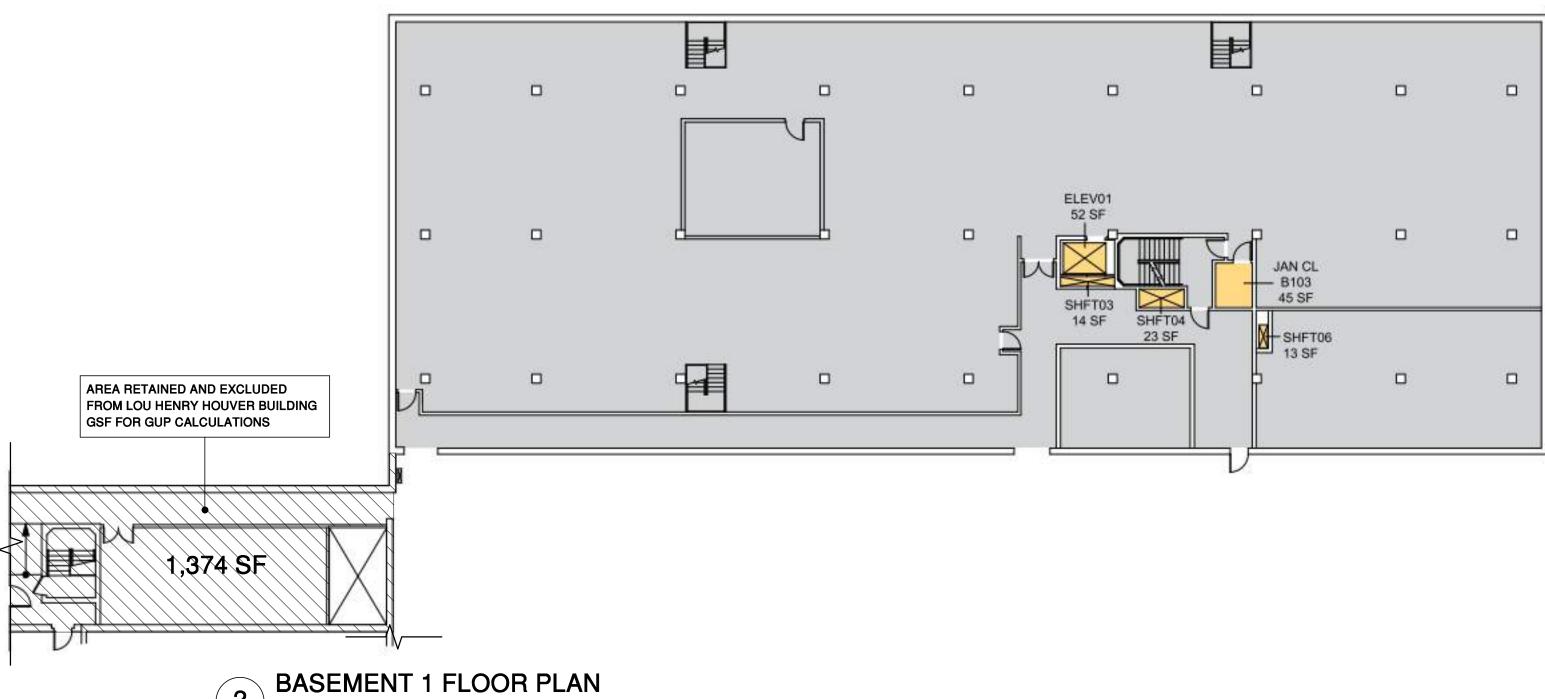


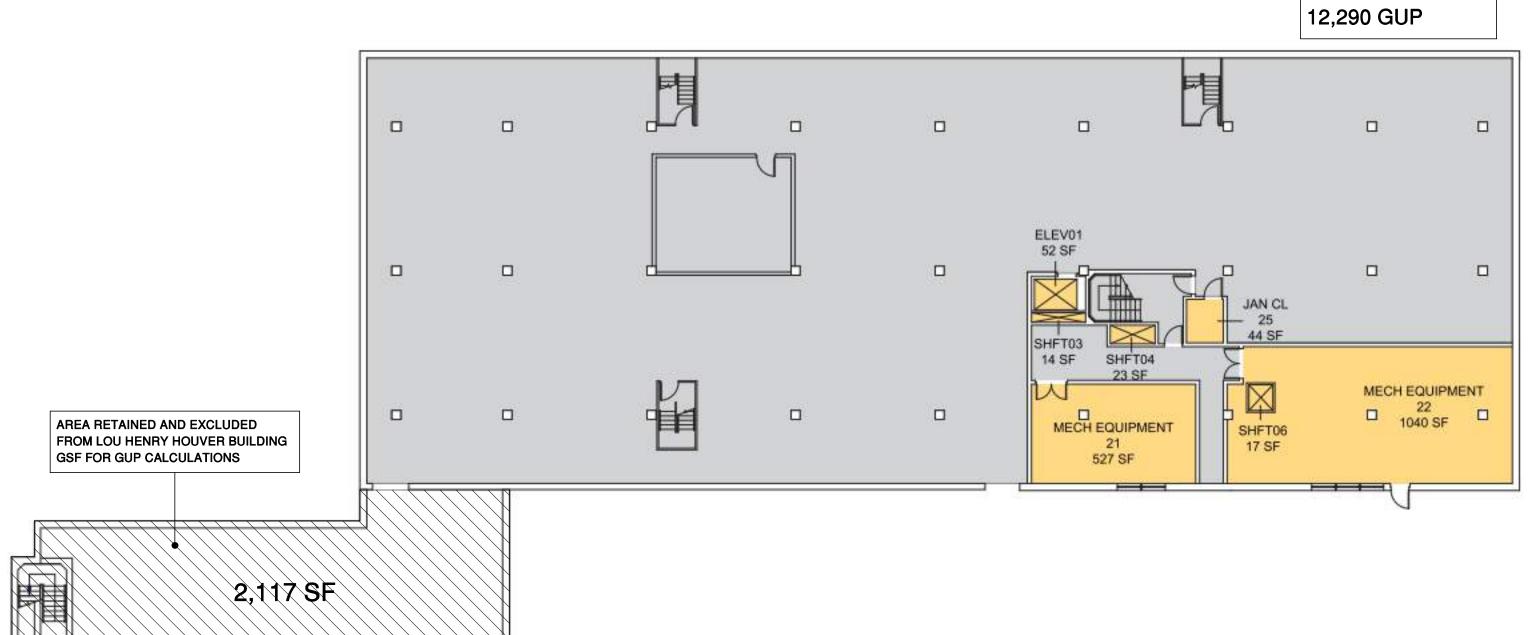

1 BASEMENT 2 FLOOR PLAN

1/16" = 1'-0"



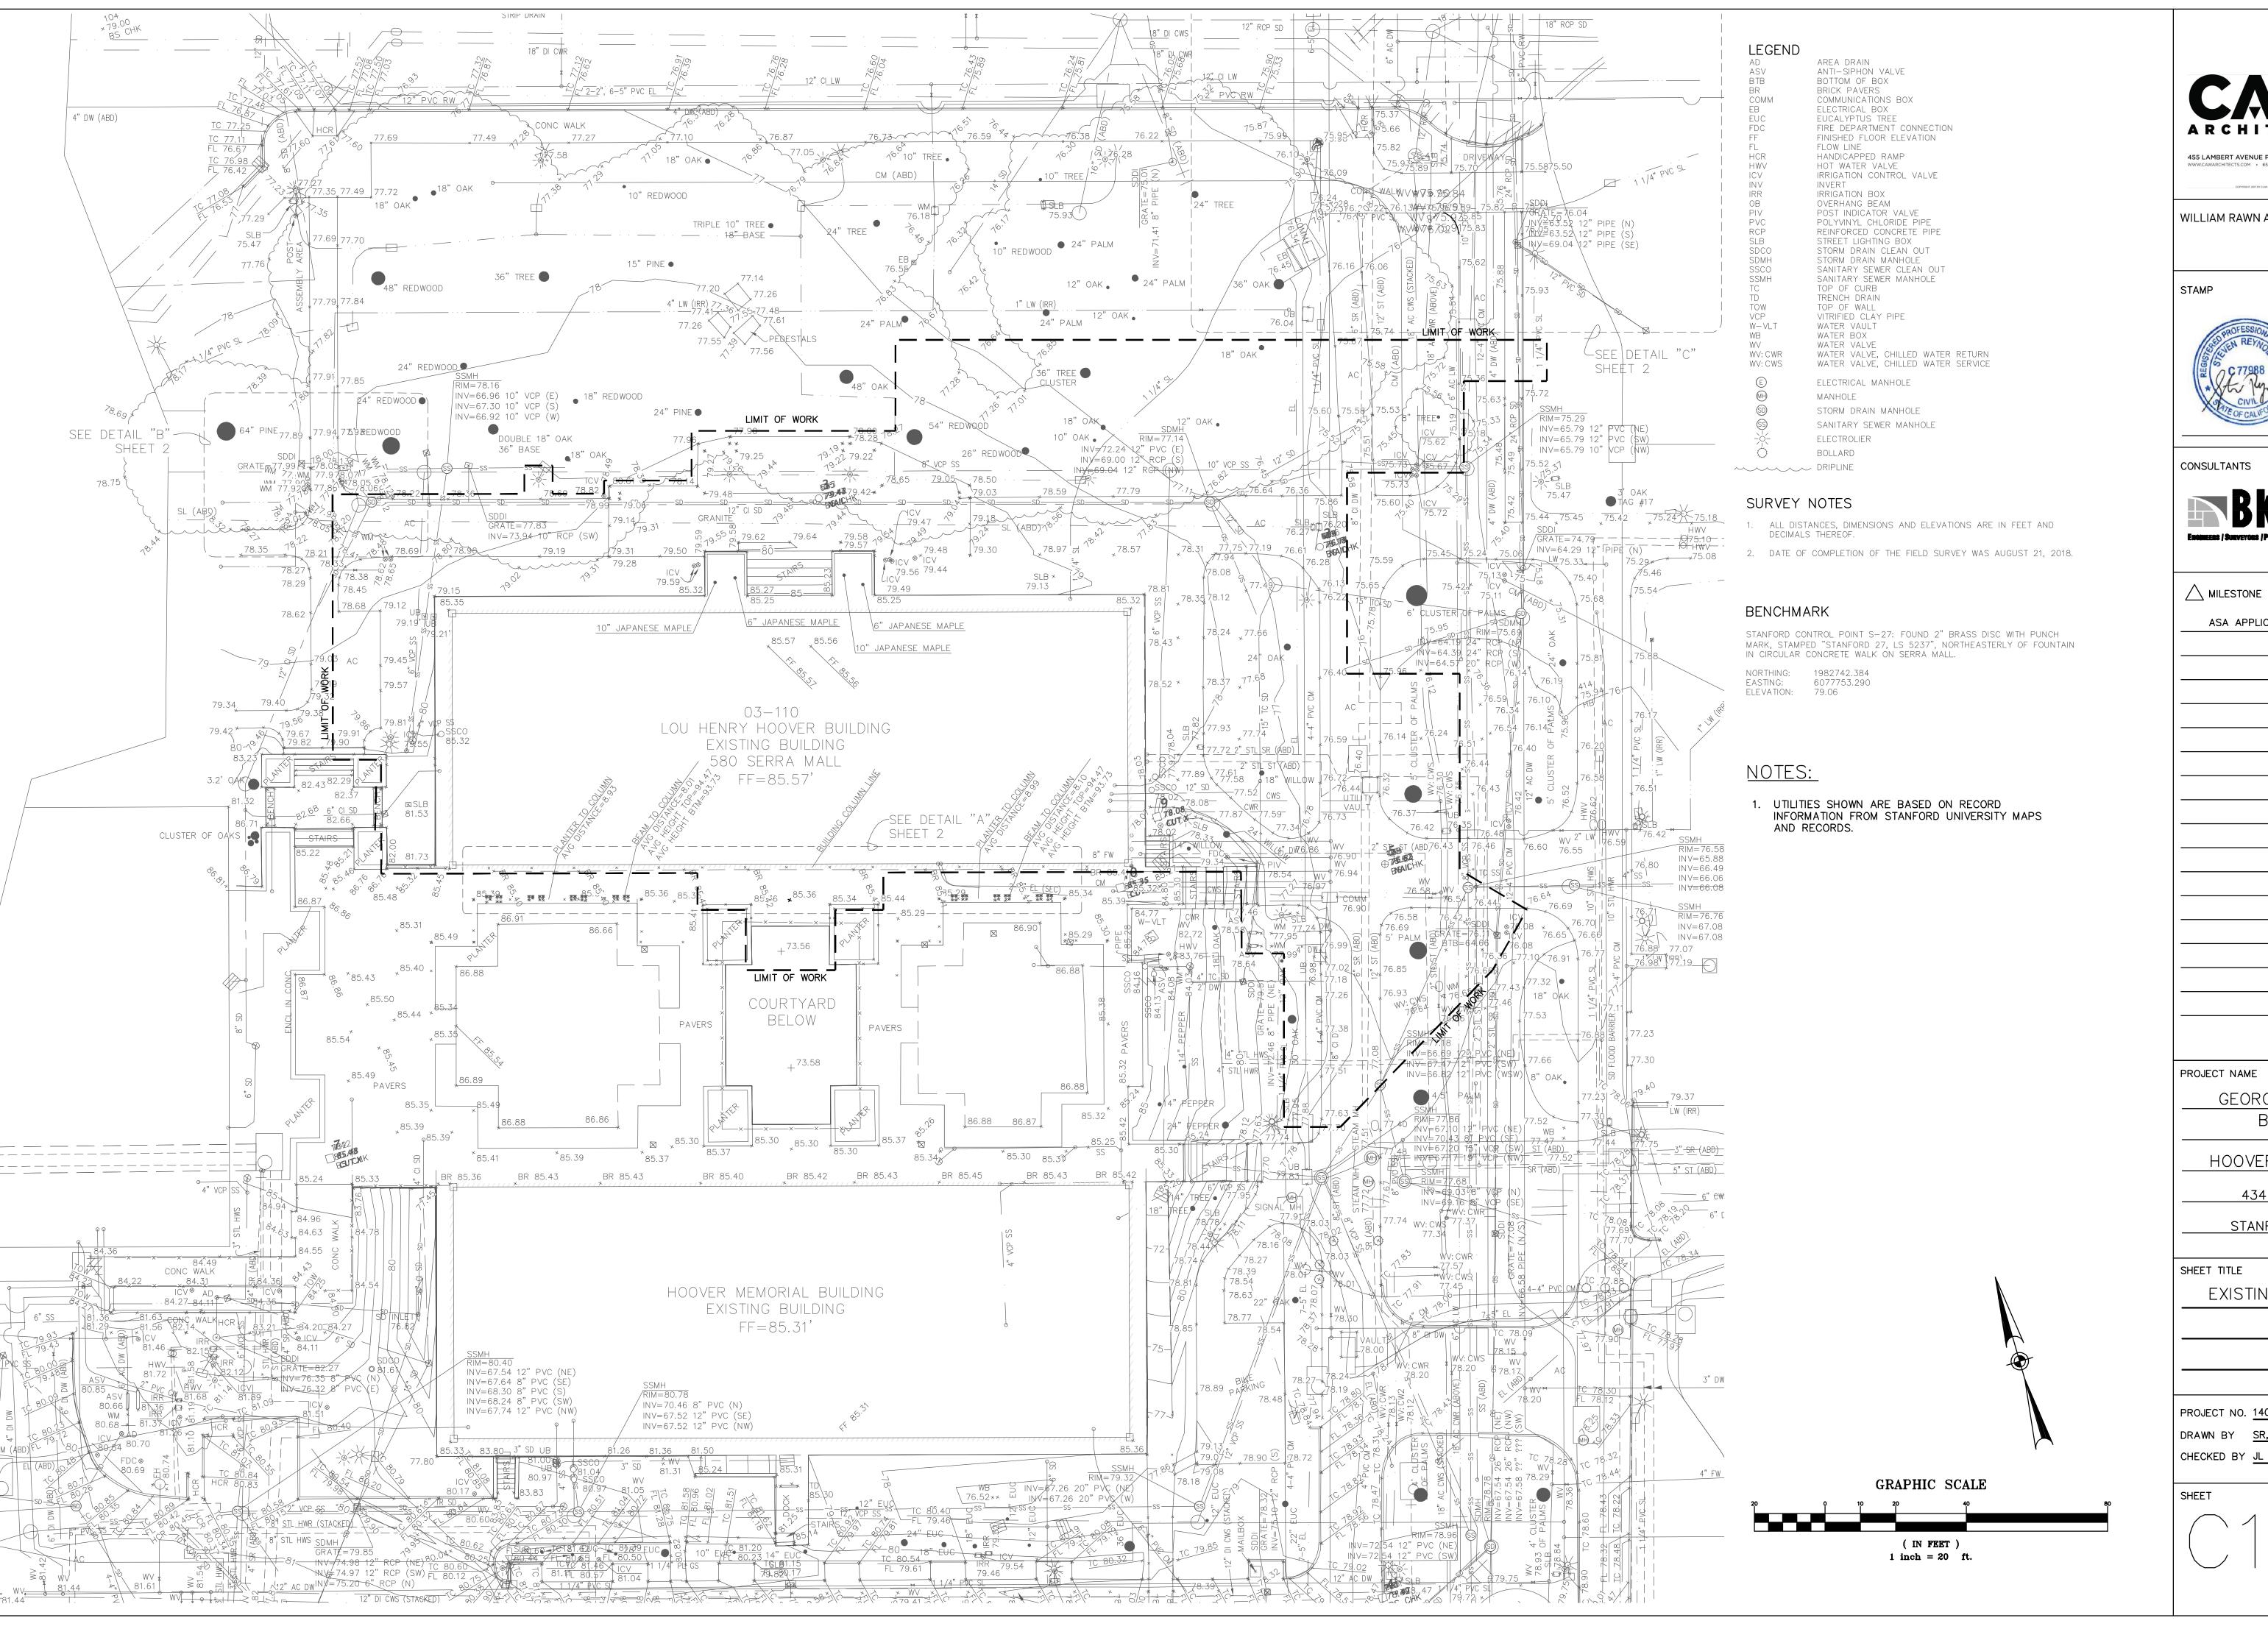



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PROJECT NAME

GEORGE P. SHULTZ BUILDING


HOOVER INSTITUTION 434 GALVEZ MALL

STANFORD, CA 93405

SHEET TITLE

EXISTING CONDITIONS

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△ MILE	STONE	DATE
ASA	APPLICATION	7/31/2019

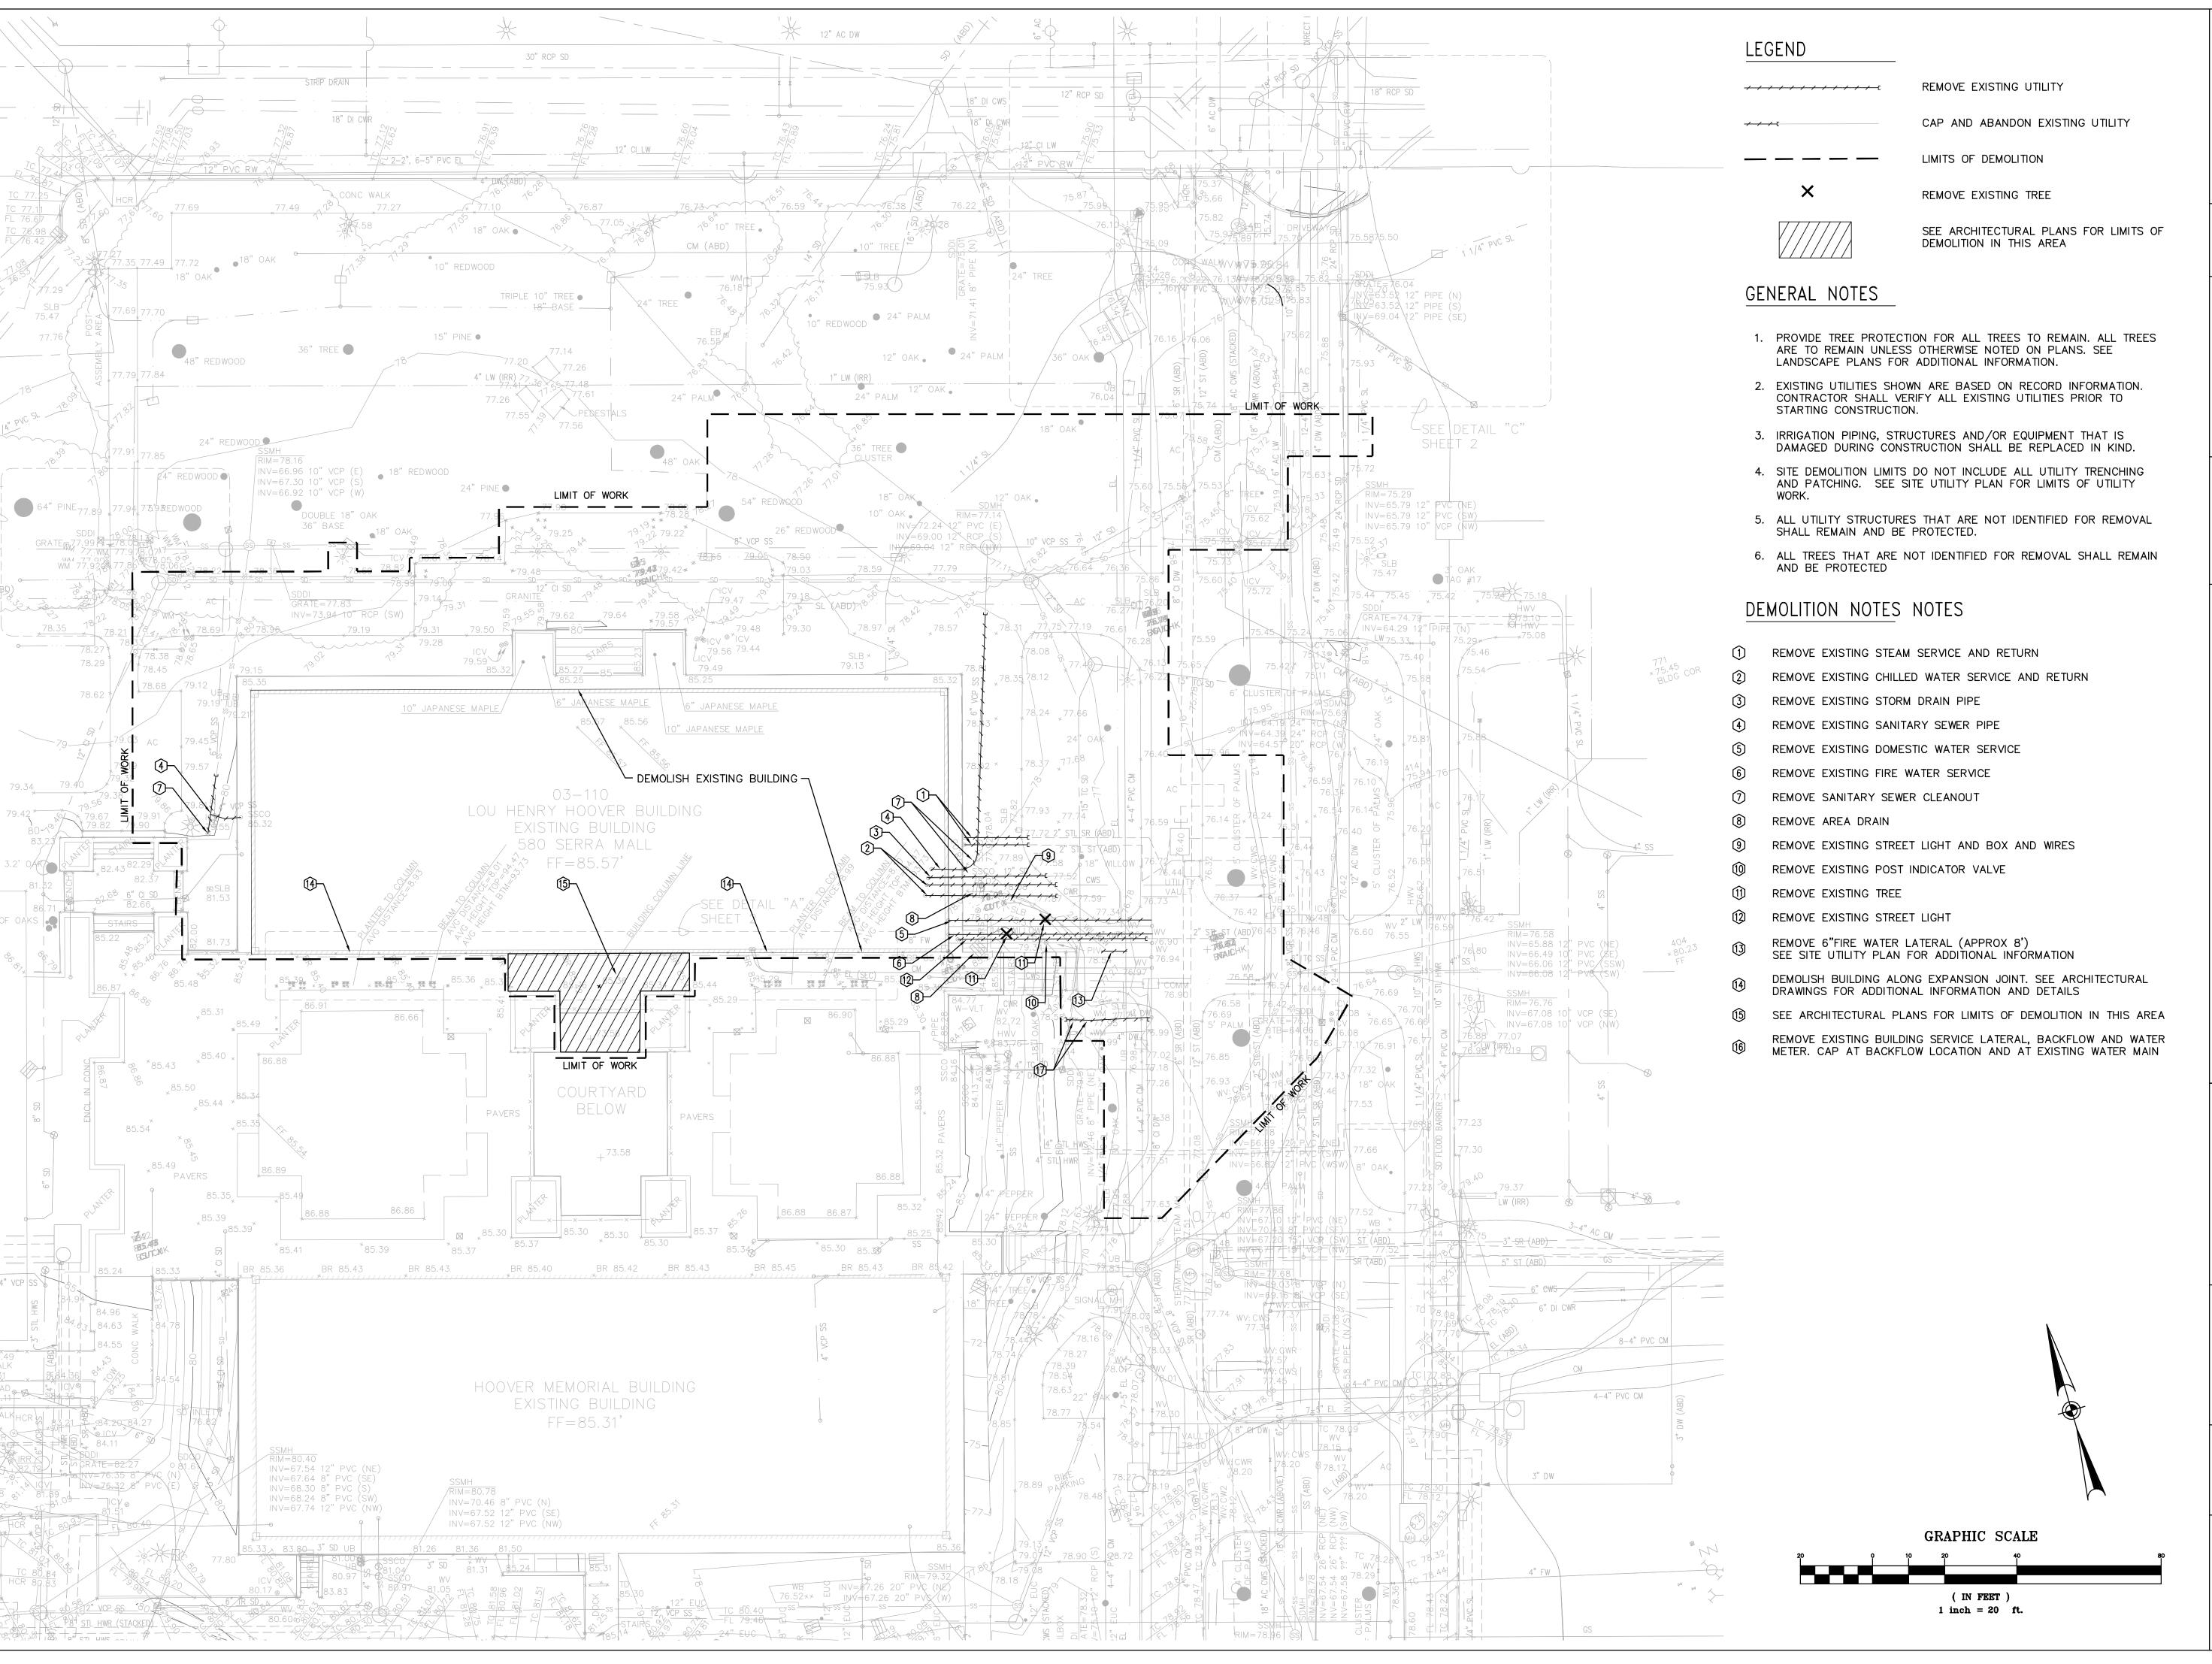PROJECT NAME

GEORGE P. SHULTZ
BUILDING
HOOVER INSTITUTION

434 GALVEZ MALL

STANFORD, CA 93405

SHEET TITLE

SITE/UTILITY

DEMOLITION PLAN


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5/2/19 5:39:03





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PROJECT NAME

GEORGE P. SHULTZ BUILDING

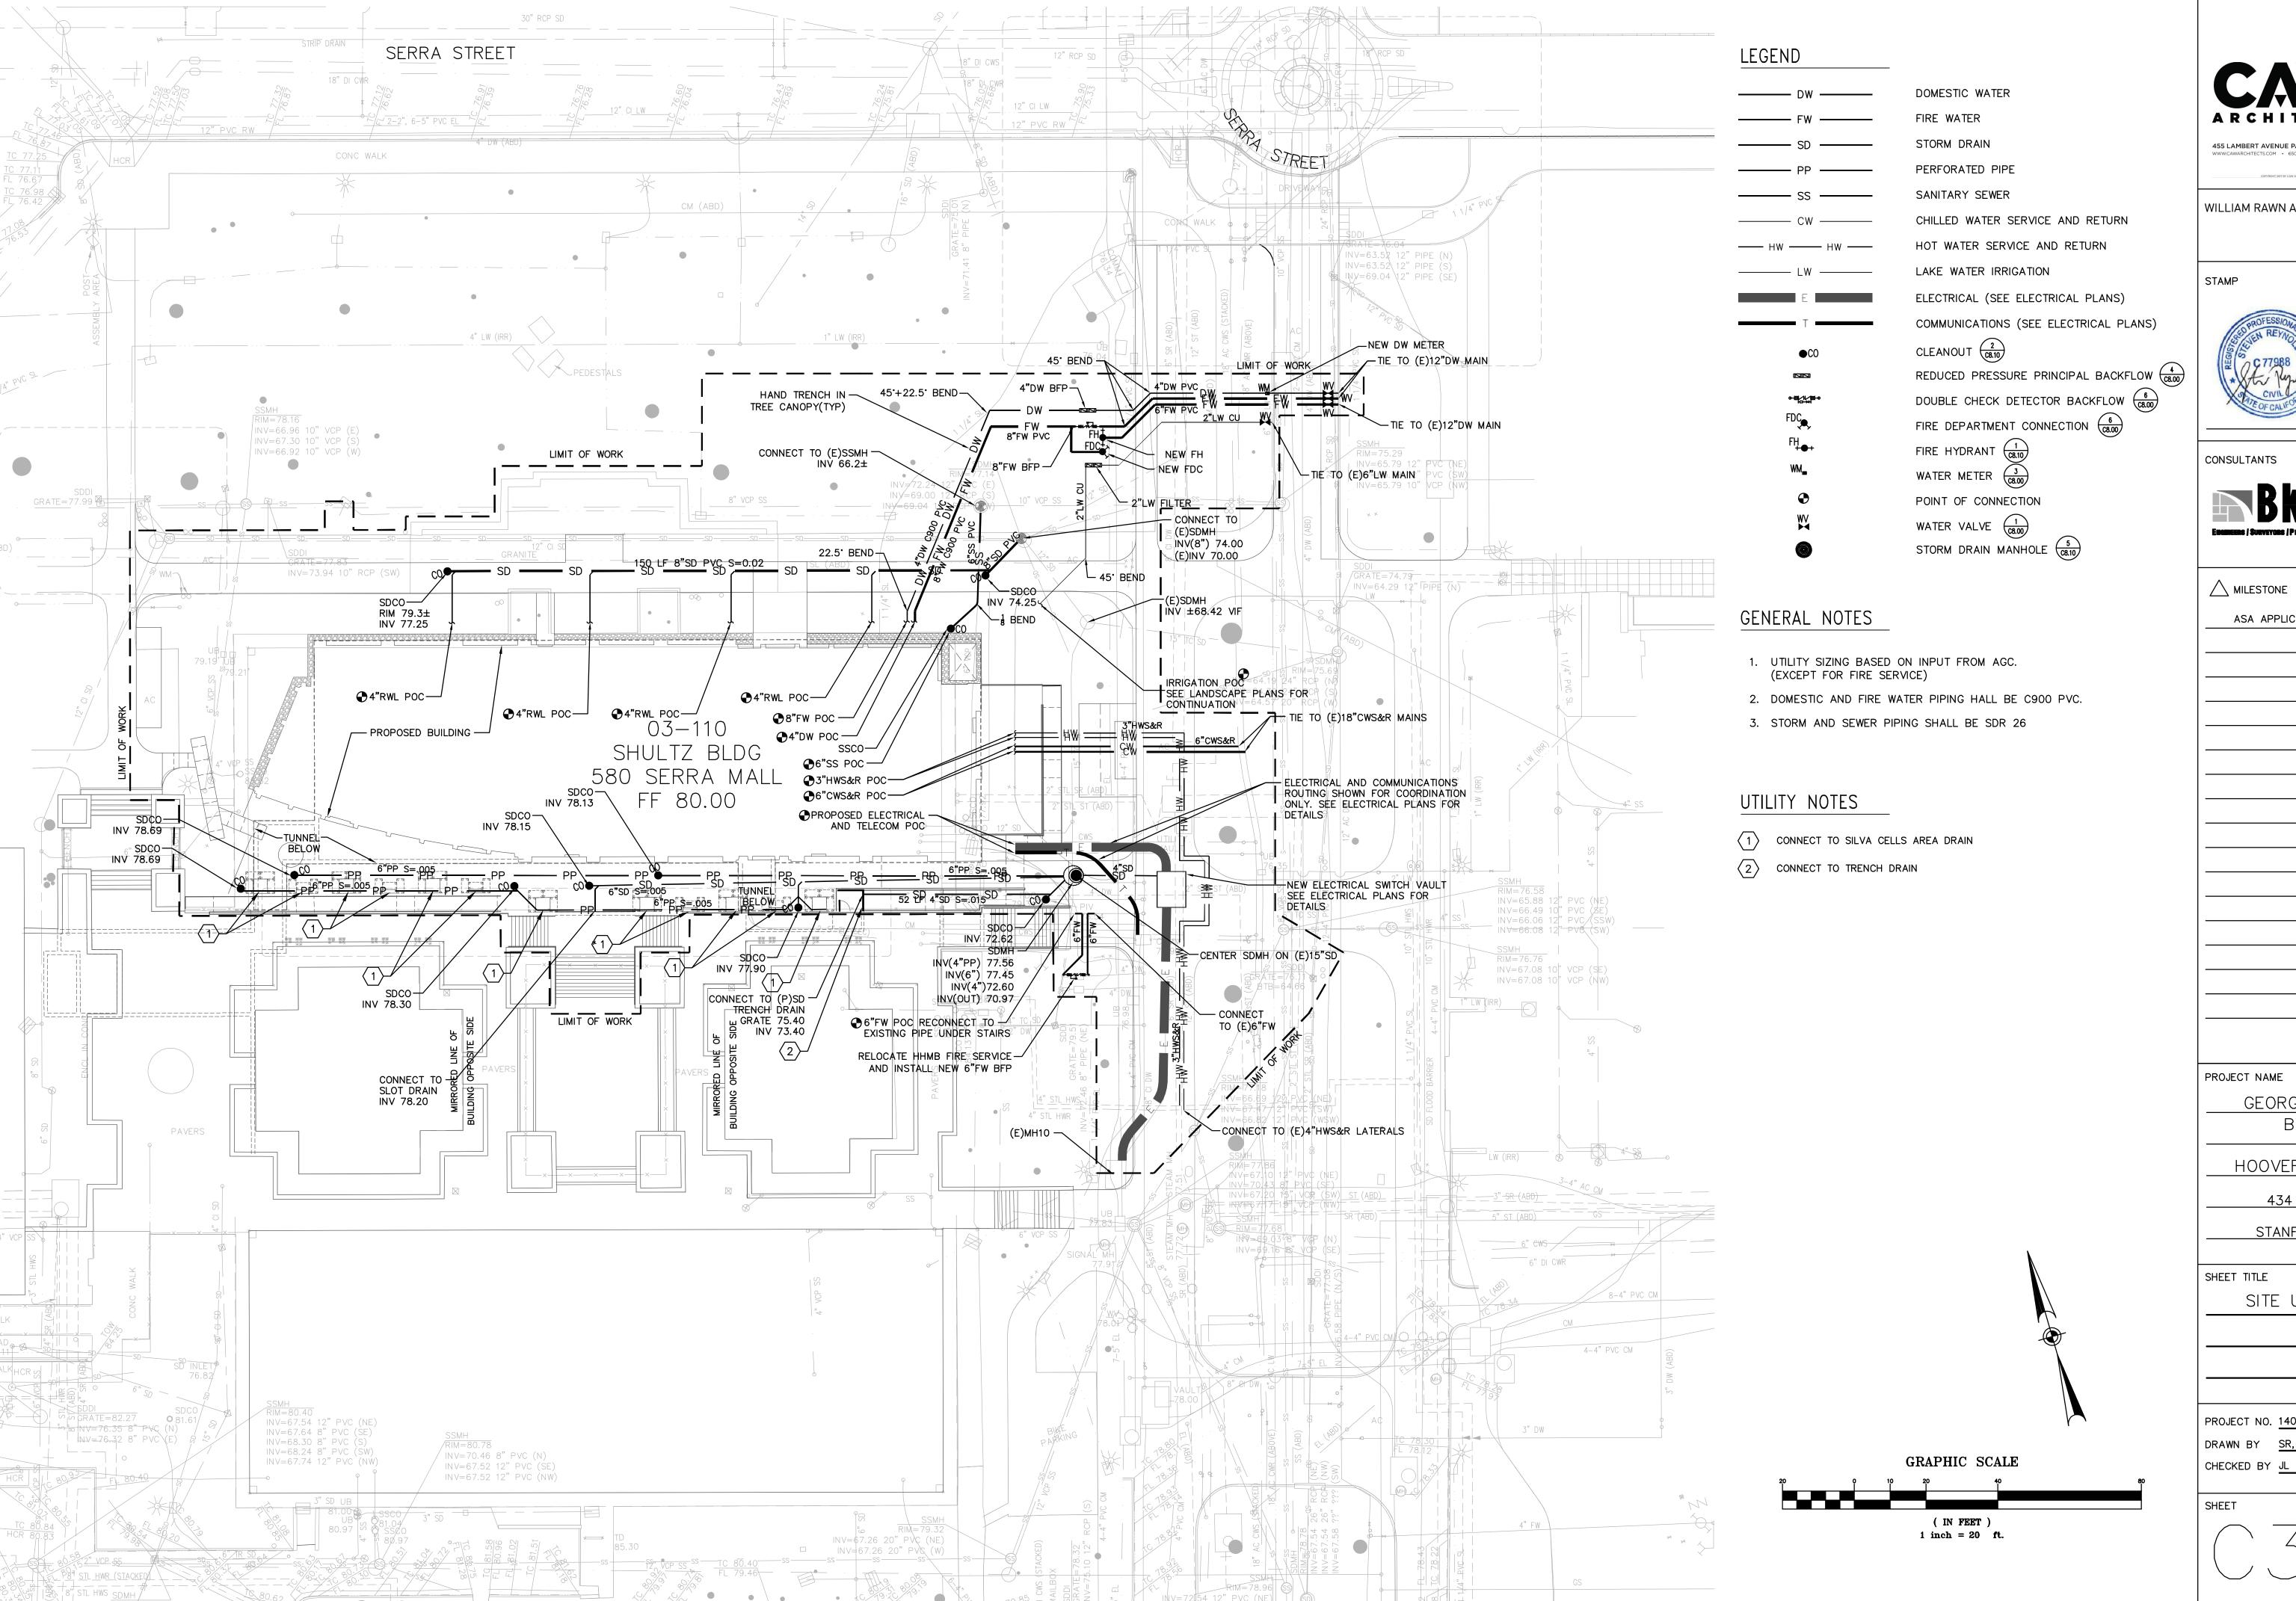HOOVER INSTITUTION 434 GALVEZ MALL


STANFORD, CA 93405

SHEET TITLE

SITE UTILITY PLAN

PROJECT NO. 14029 DRAWN BY SR, CM

SHEET

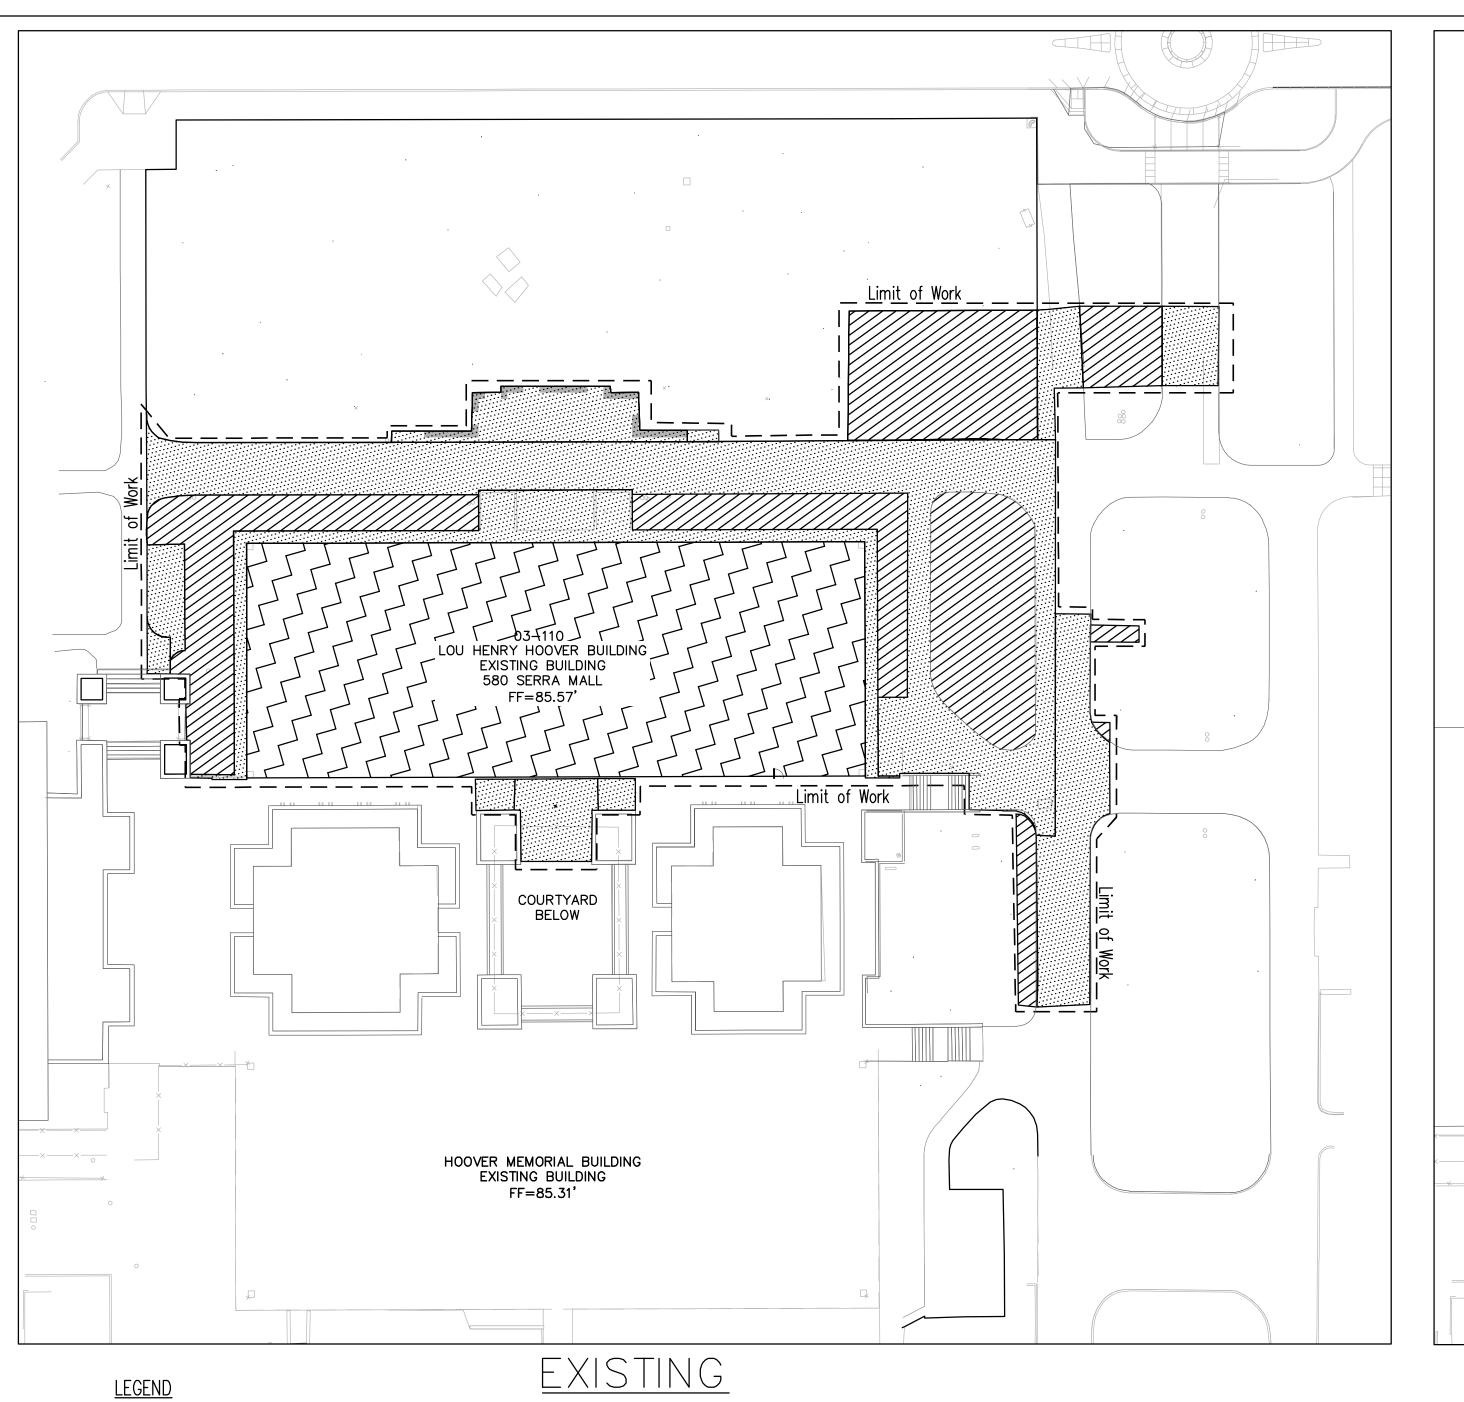


TOTAL SITE AREA: 37,702 SQ FT

IMPERVIOUS 13,904 SQ FT

PERVIOUS LANDSCAPE 9,659 SQ FT

R00F 14,139 SQ FT

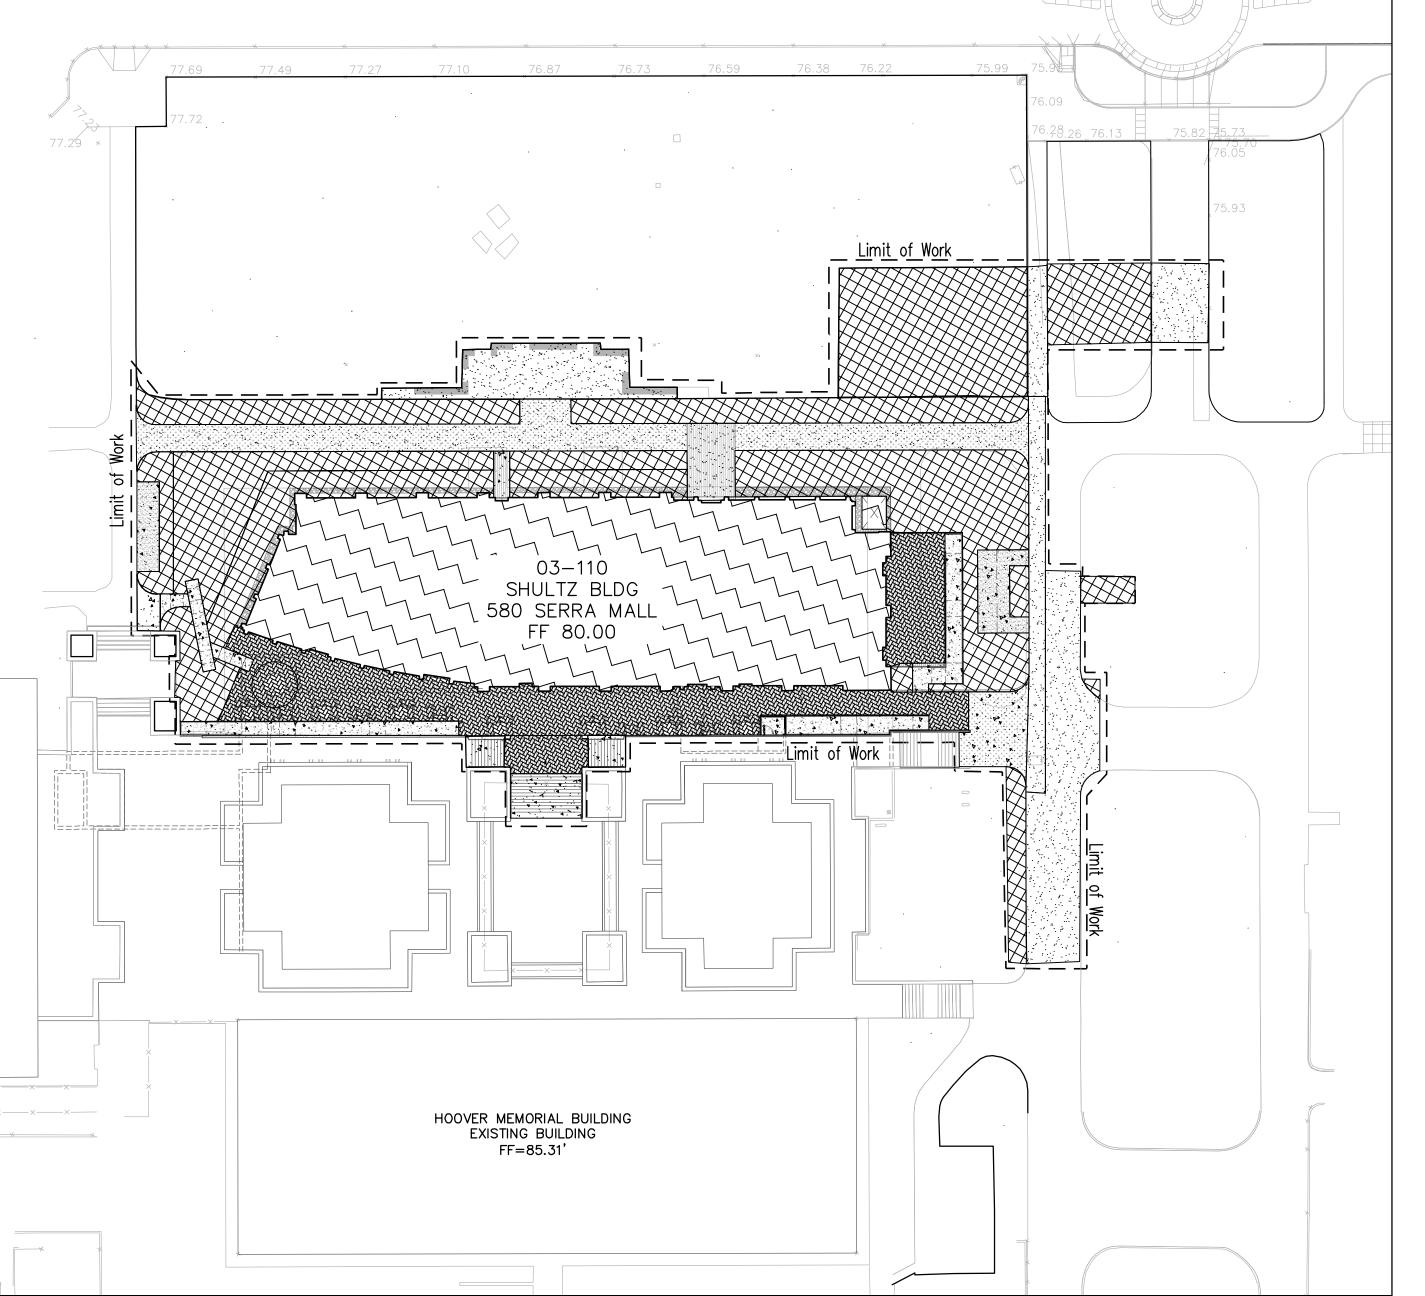

PROPOSED

<u>LEGEND</u> TOTAL SITE AREA: 37,702 SQ FT

IMPERVIOUS 9,889 SQ FT

R00F 10,945 SQ FT

PERVIOUS LANDSCAPE 12,422 SQ FT

IMPERVOIUS PAVERS 4,446 SQ FT

VEHICULAR NON-VEHICULAR MIN. VEHICULAR TREATMENT IMP AREA (SF) IMP AREA (SF) AREA REQD. (SF) TOTAL MIN. TREATMENT AREA REQUIRED (SF)

TOTAL MIN. TREATMENT AREA PROVIDED (SF) MIN. NON-VEHICULAR TREATMENT AREA REQD. (SF) DMA SITE AREA (SF) TREATMENT METHOD 37,702 2,906 22,374 1,012 1,012 117 IN-LIEU 895

1.) TREATMENT IS 4% OF IMPERVIOUS AREA
2.) IN-LIEU TREATMENT IS FROM THE EAST CAMPUS WATER CAPTURE FACILITY COUNTY FILE NUMBER _______.

GRAPHIC SCALE (IN FEET) 1 inch = 30 ft.



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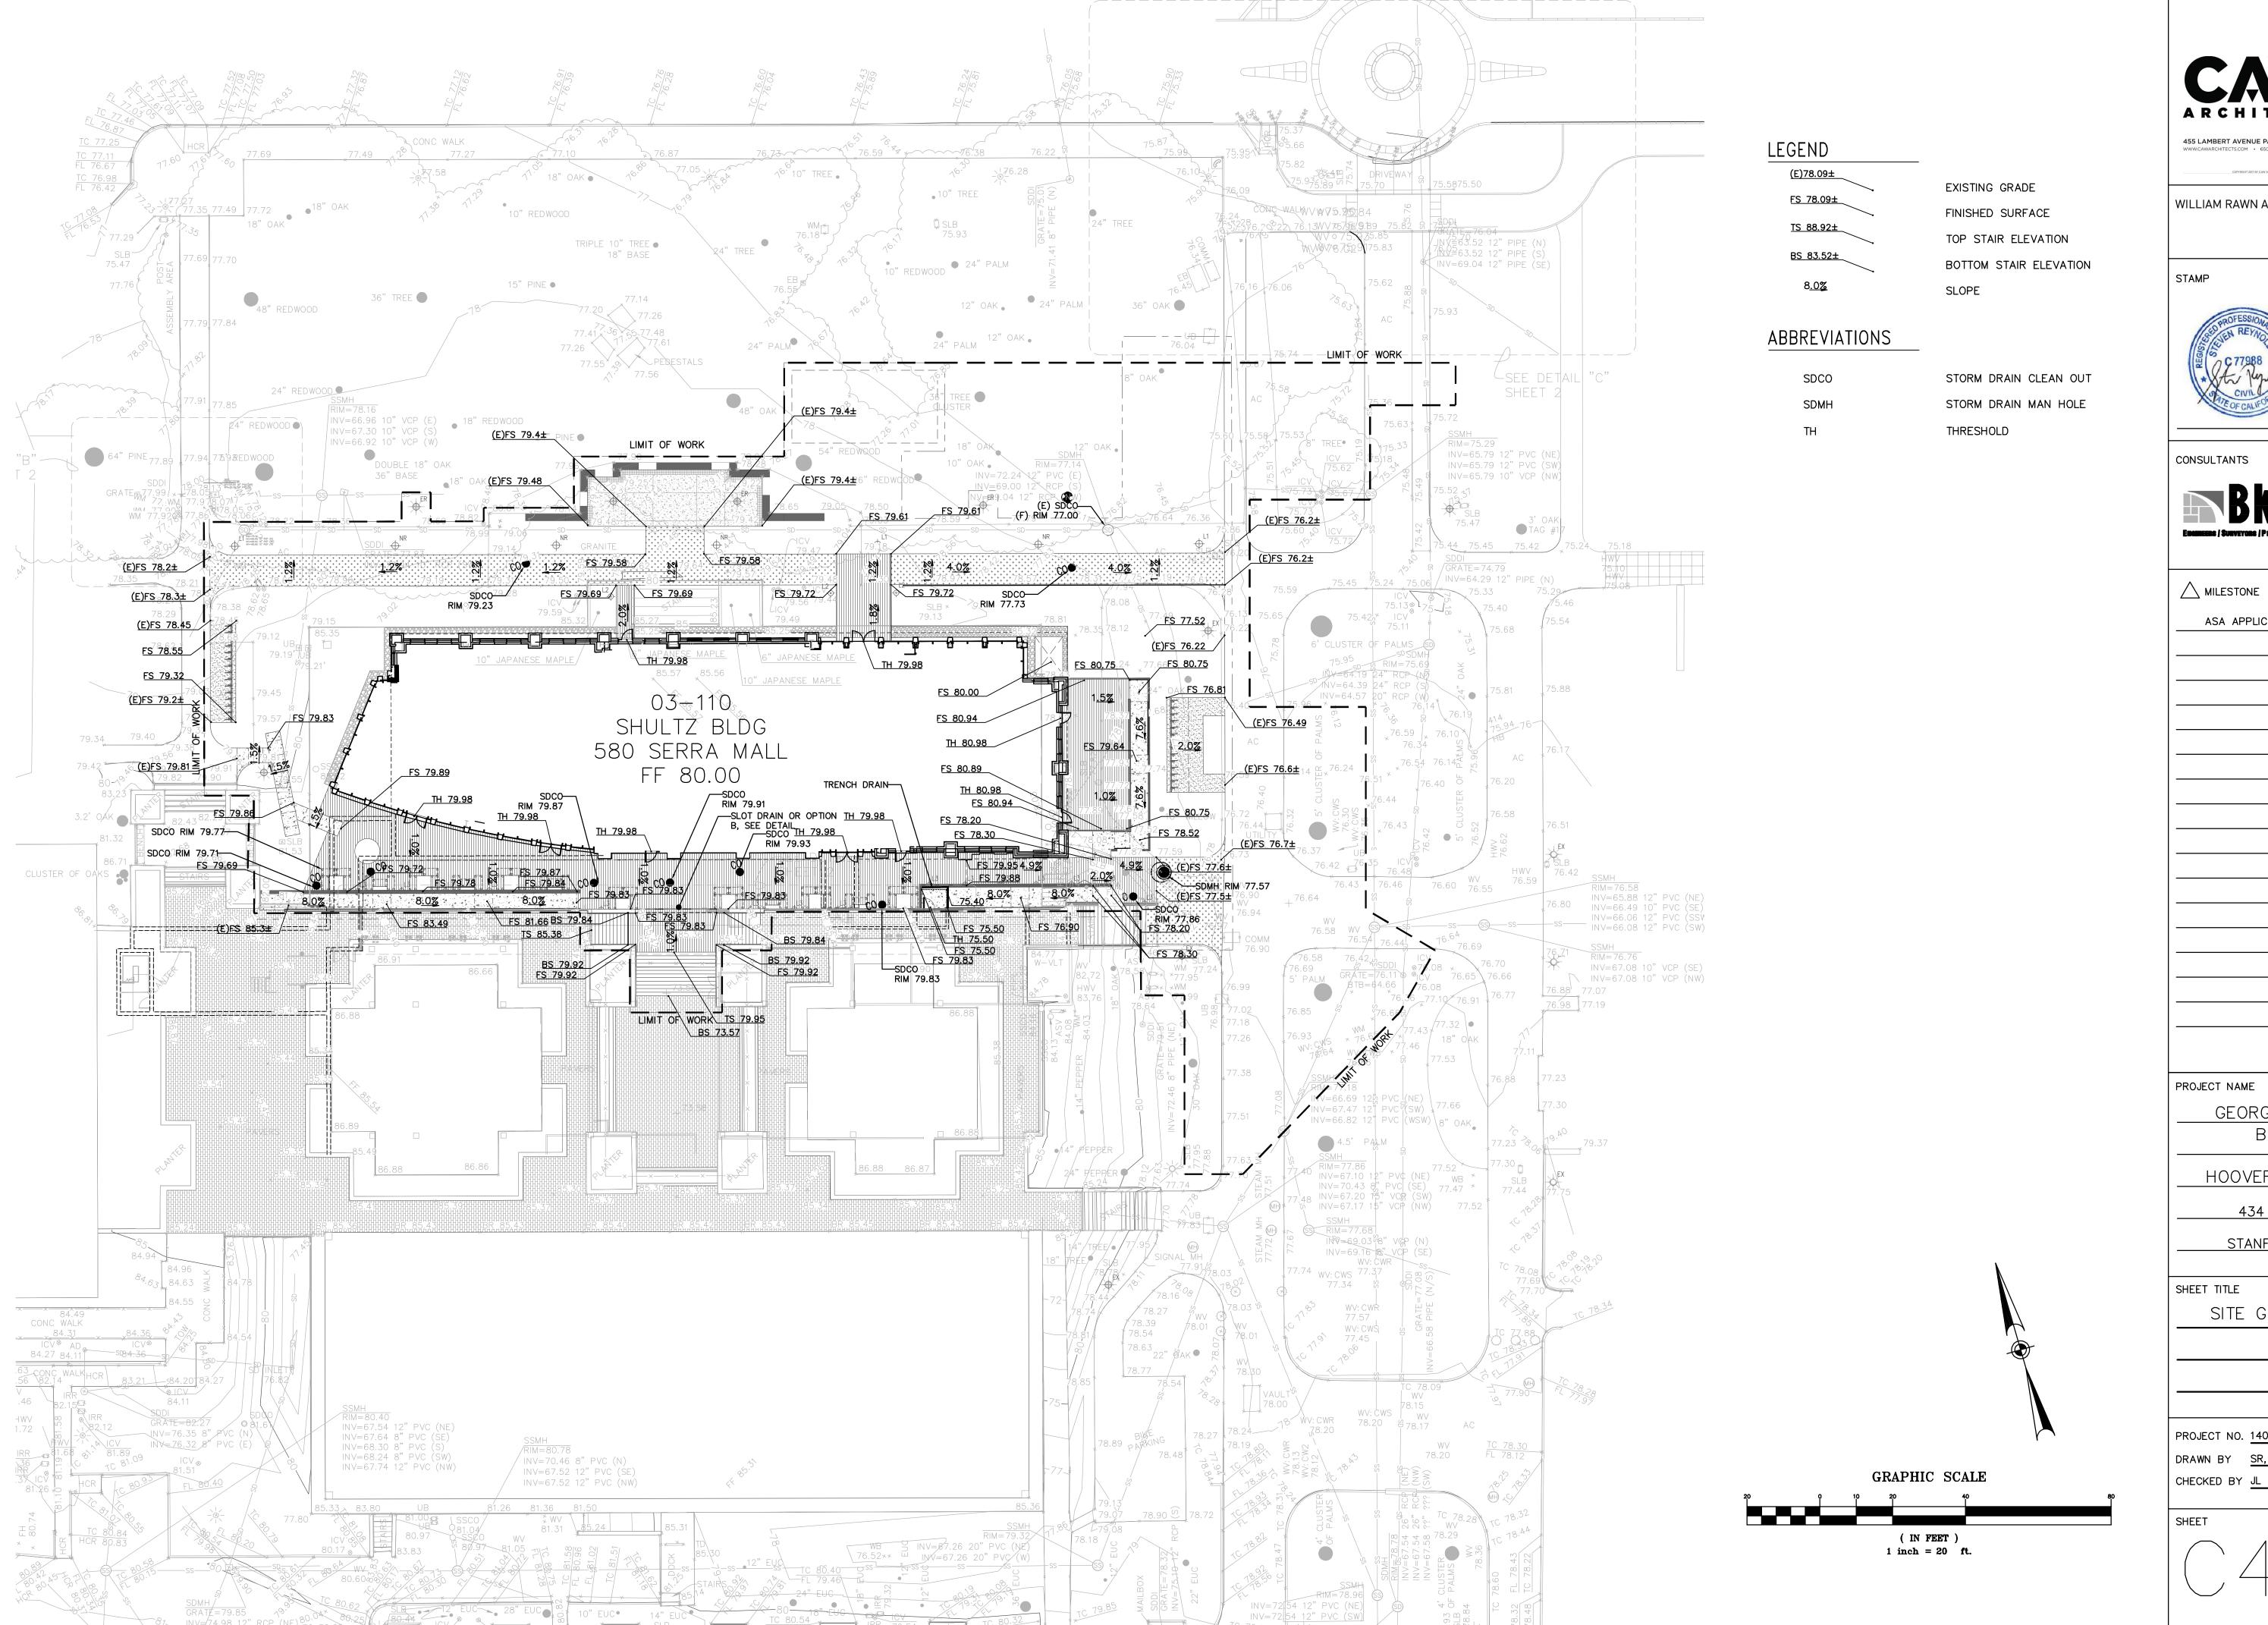
GEORGE P. SHULTZ BUILDING

HOOVER INSTITUTION 434 GALVEZ MALL

STANFORD, CA 93405

SHEET TITLE STORMWATER MANAGEMENT PLAN

PROJECT NO. <u>14029</u> DRAWN BY SR, CM CHECKED BY JL





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✓ MILESTONE DATE ASA APPLICATION 7/31/2019

PROJECT NAME

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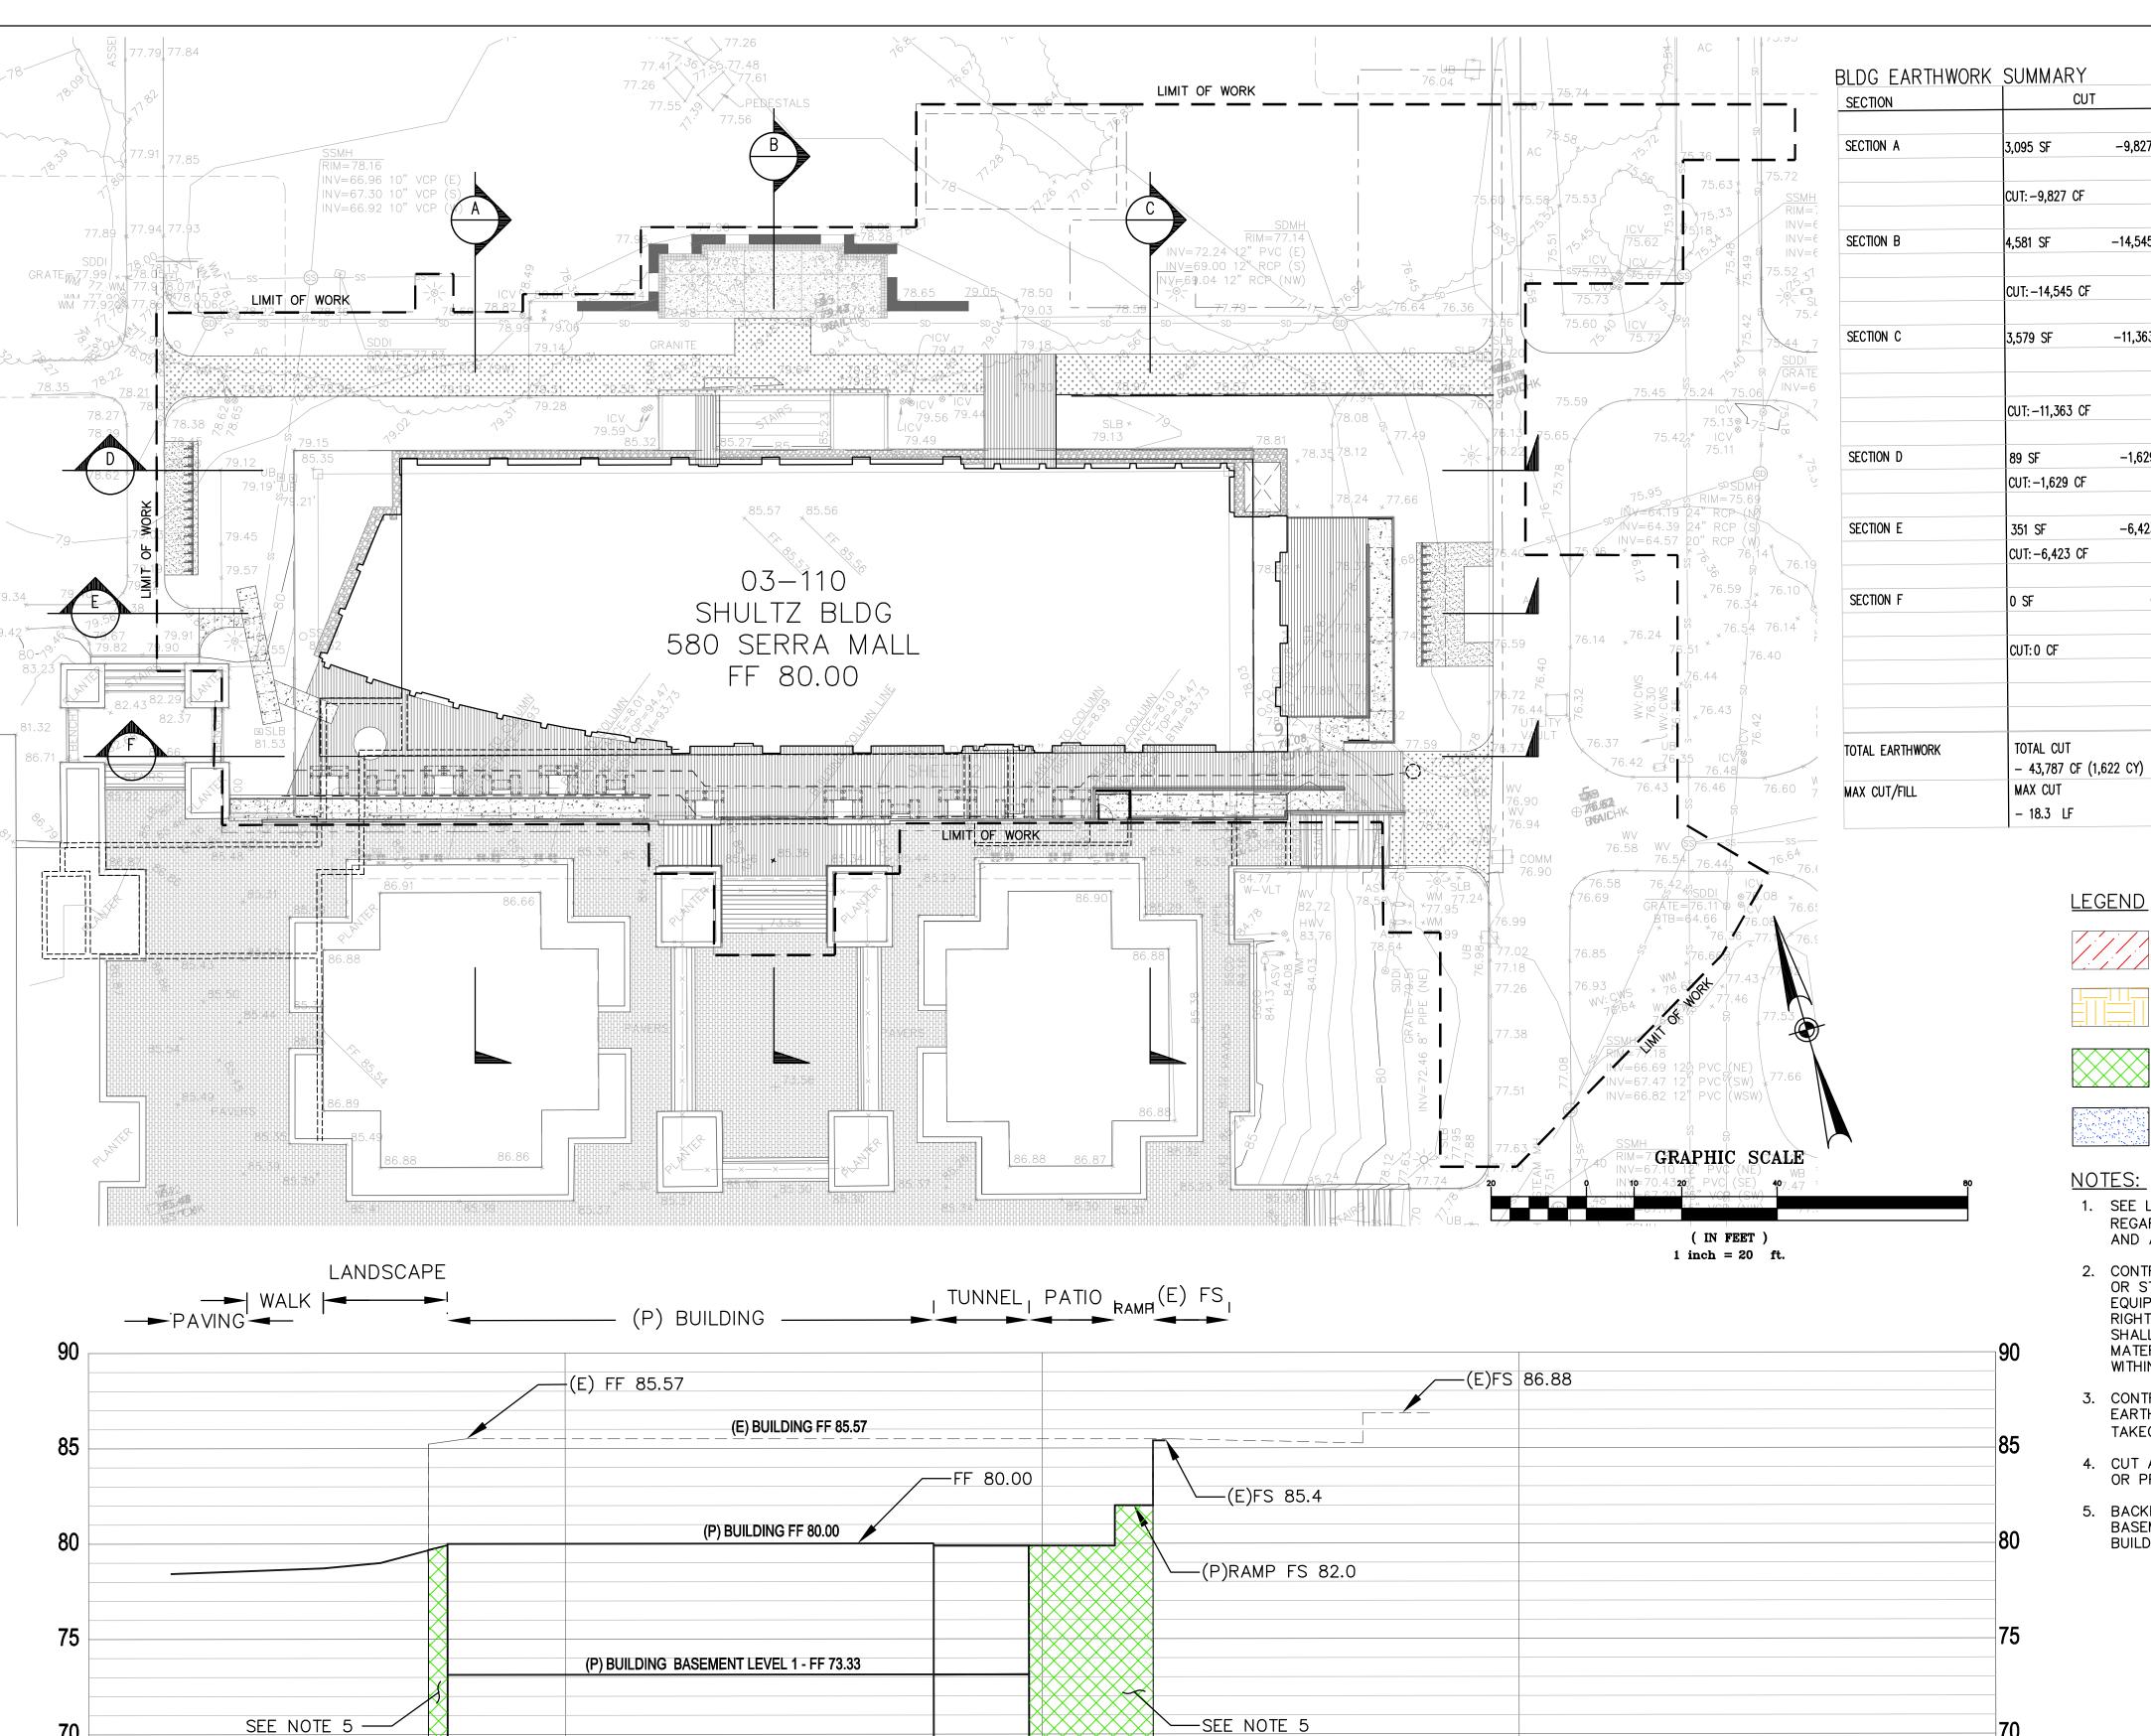
STANFORD, CA 93405


SHEET TITLE

SITE GRADING PLAN


PROJECT NO. 14029 DRAWN BY SR, CM

SHEET



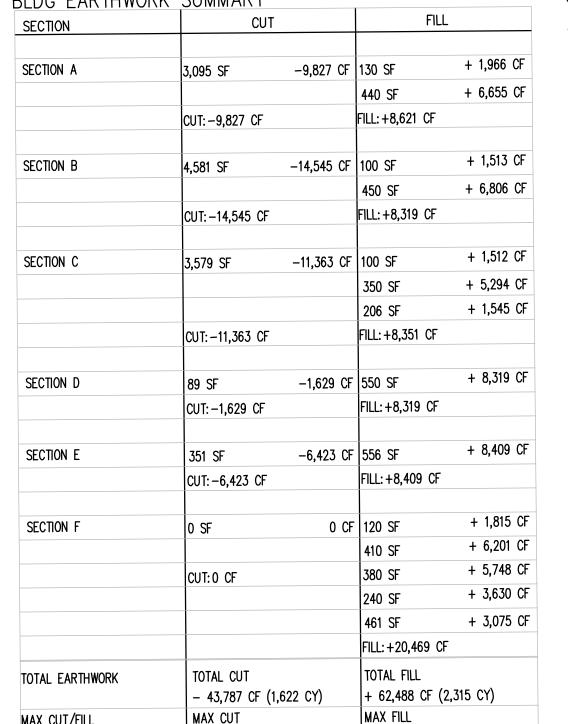

SECTION	CUT		FIL	L
SECTION A	CUT: 0 CF		FILL: +0 CF	
SECTION B	305 SF	-1,525 CF	FILL: +0 CF	
	304 SF	-760 CF		
	CUT: -2,285 CF			
SECTION C	CUT: 0 CF		+524 SF	+393 CF
			FILL: +393 CF	
SECTION D	204 SF	-153 CF	+390 SF	+293 CF
	CUT: -153 CF		FILL: +293 CF	
SECTION E	206 SF	-155 CF	+714 SF	+2,142 CF
	CUT: -155 CF		+352 SF	+704 CF
			+130 SF	+98 CF
			FILL: +2,943 CF	
SECTION F	386 SF	-386 CF	FILL: +0 CF	
	CUT: -386 CF			
TOTAL EARTHWORK	TOTAL CUT -2,979 CF (110	CY)	TOTAL FILL + 3,629 CF (134 CY)
MAX CUT/FILL	MAX CUT		MAX FILL	•

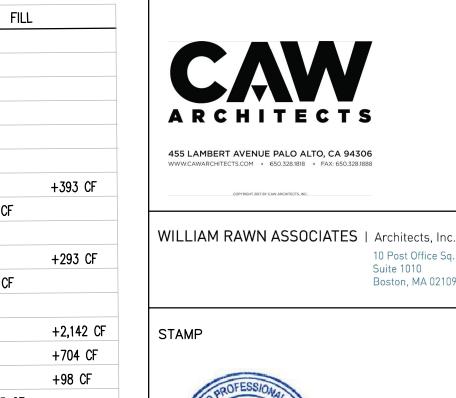



CONSULTANTS

✓ MILESTONE



ASA APPLICATION

SUITE 250
PLEASANTON, CA 94588
925-396-7700 925-396-7799 (FAX)

DATE

7/31/2019

10 Post Office Sq.

Suite 1010 Boston, MA 02109

BUILDING EARTHWORK SUMMARY

+ 3 LF

CUT	1,622 CY
FILL	2,315 CY
NET FILL	693 CY

SITE EARTHWORK SUMMARY

- 5 LF

CUT	110 CY
FILL	134 CY
NET FILL	24 CY

TOTAL EARTHWORK SUMMARY

CUT	1,732 CY
FILL	2,449 CY
NET FILL	717 CY

*FILL DOES NOT INCLUDE SHRINKAGE OR COMPACTION

1. SEE LANDSCAPE PLANS FOR DETAILS

	REGARDING TREE/LANDSCAPING PLANTING, AND ALL OTHER SITE FEATURES.
2.	CONTRACTOR SHALL NOT STAGE, STORE, OR STOCKPILE ANY MATERIAL OR EQUIPMENT WITHIN THE PUBLIC ROAD RIGHT-OF-WAY. CONSTRUCTION PHASING SHALL BE COORDINATED TO KEEP MATERIALS AND EQUIPMENT ONSITE OR

PROPOSED BUILDING AREA TO

PROPOSED SITE AREA TO BE

PROPOSED BUILDING AREA TO

PROPOSED SITE AREA TO BE FILLED

+ 15.13 LF

3. CONTRACTOR SHALL PERFORM THEIR OWN EARTHWORK QUANTITY TAKEOFF/CALCULATIONS.

WITHIN PRIVATE PROPERTY.

- 4. CUT AND FILL DOES NOT INCLUDE EXISTING OR PROPOSED FOOTING FOR BUILDING.
- 5. BACKFILL OF EXISTING BUILDING AND BASEMENT TO BE COVERED UNDER BUILDING AND DEMO PERMIT.

PROJECT NAME

GEORGE P. SHULTZ BUILDING

HOOVER INSTITUTION 434 GALVEZ MALL

STANFORD, CA 93405

SHEET TITLE

SECTIONS

PROJECT NO. 14029 DRAWN BY SR, CM CHECKED BY JL


SHEET

SECTION A SCALE: H- 1"=10'


V- 1"=20'


(E) BUILDING BASEMENT LEVEL 2 - FF 65.17

(P) BUILDING BASEMENT LEVEL 2 FF 62.26

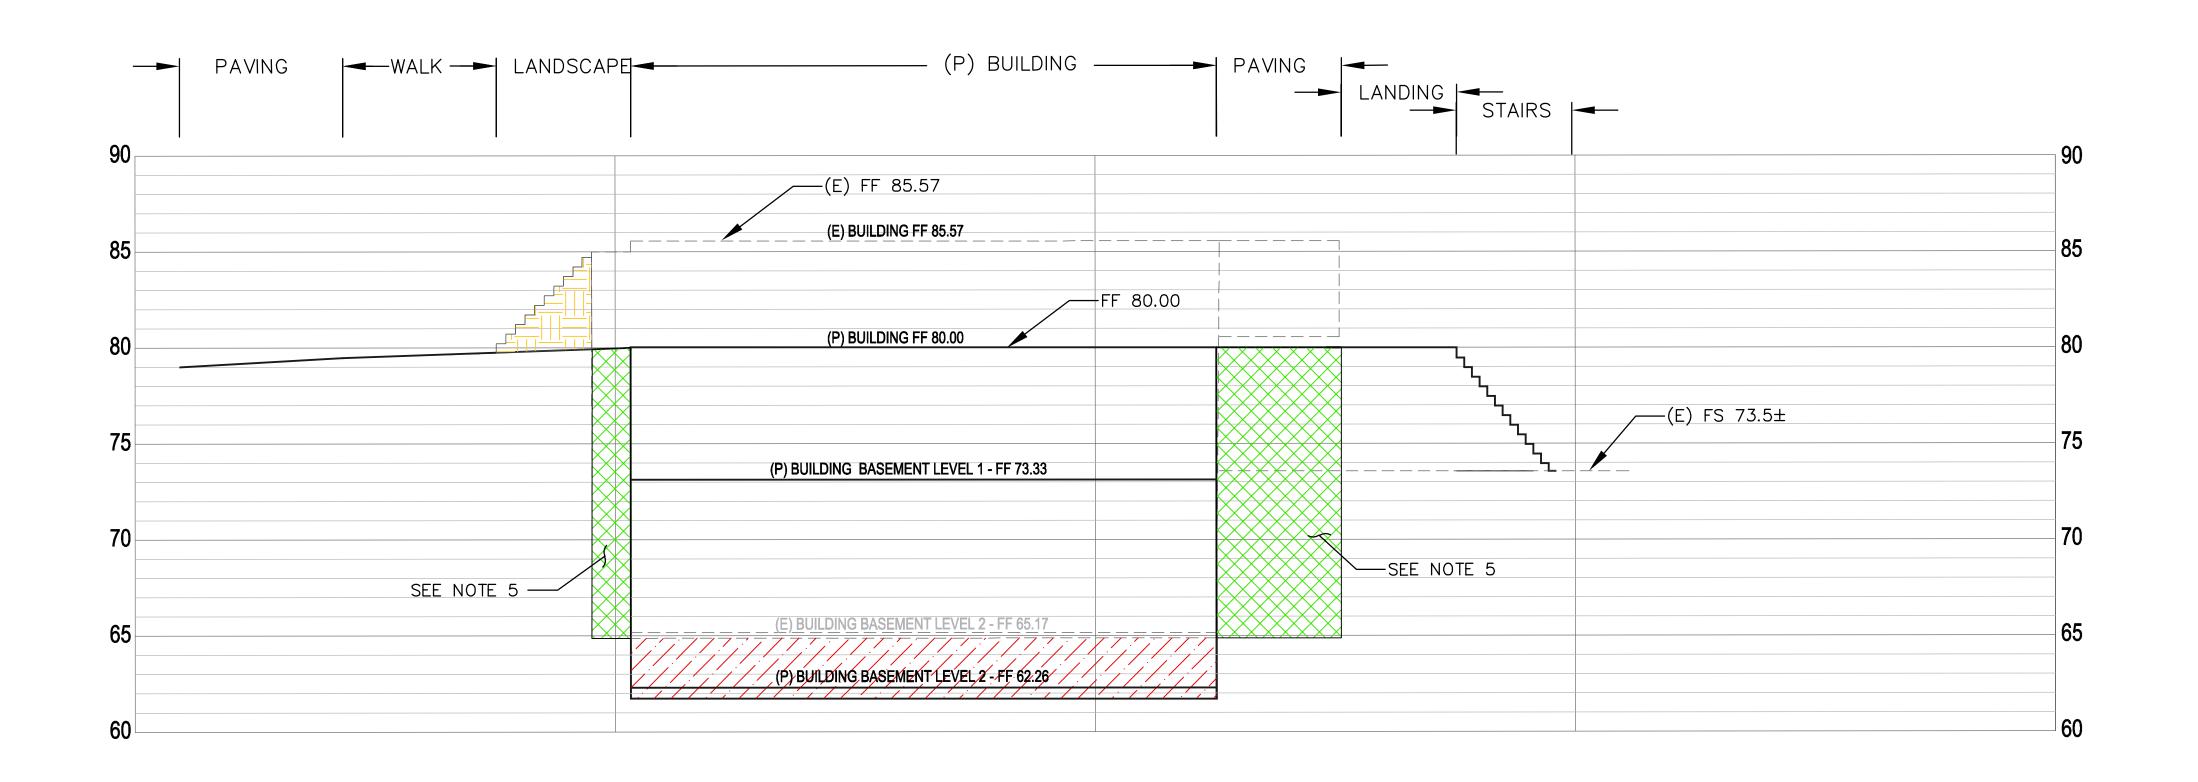

SECTION B SCALE: H- 1"=10' V- 1"=20'

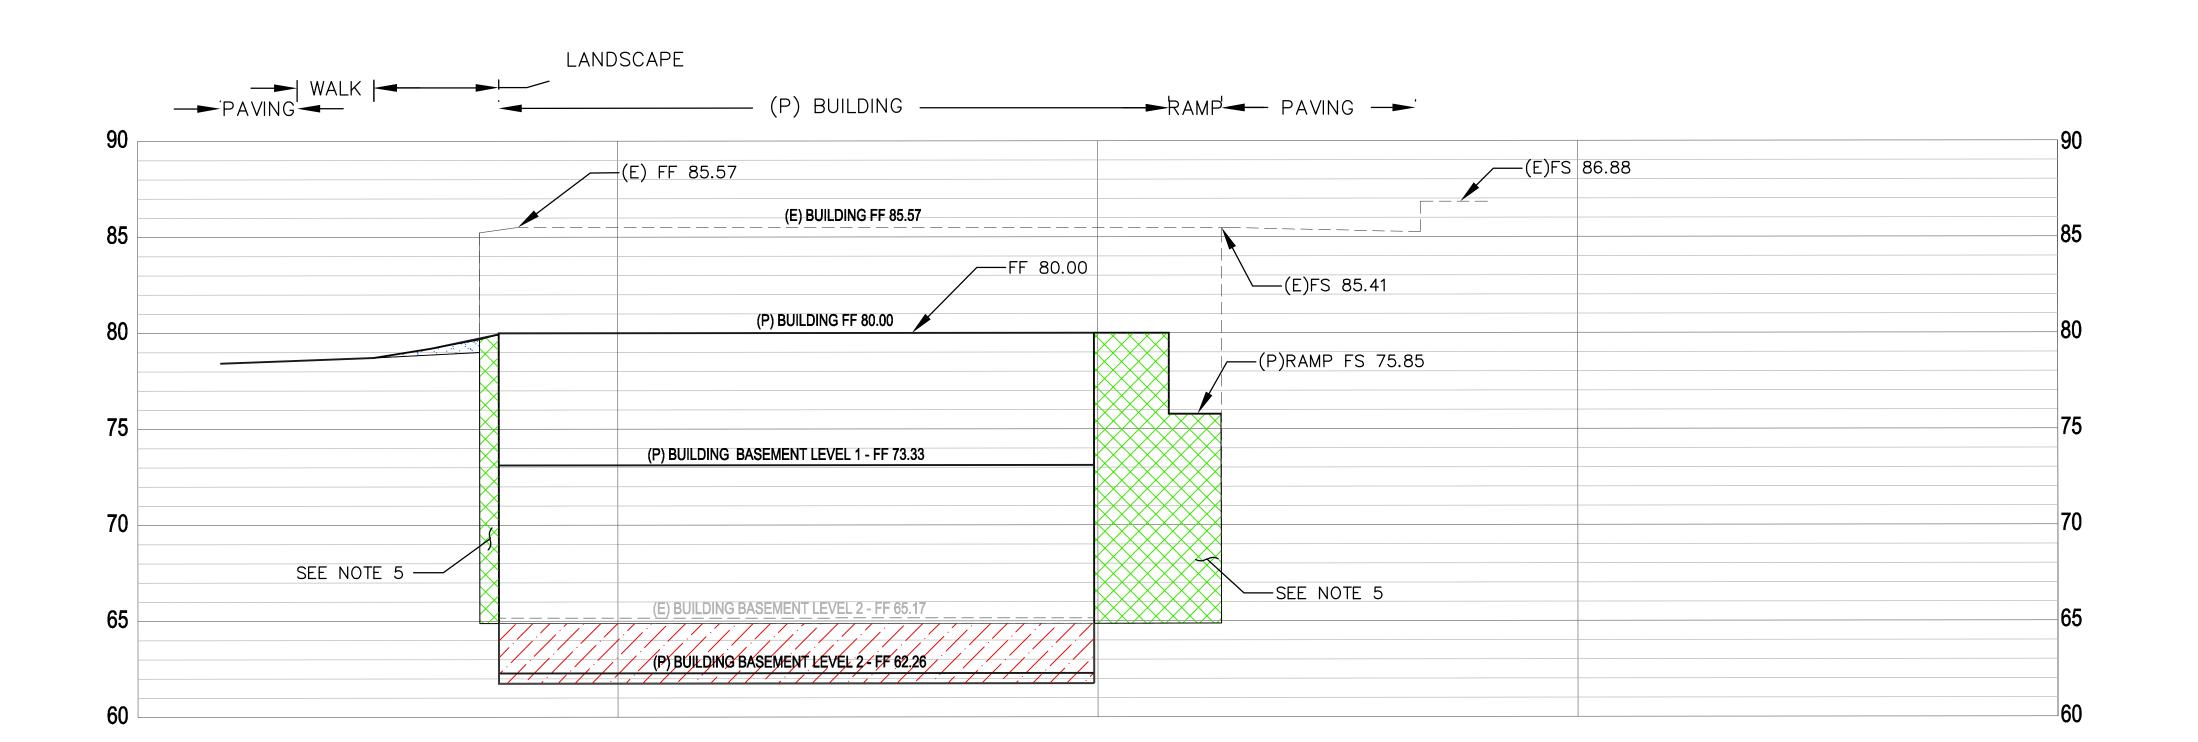

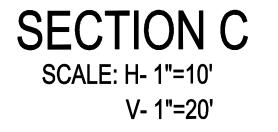



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GEORGE P. SHULTZ BUILDING

HOOVER INSTITUTION

434 GALVEZ MALL

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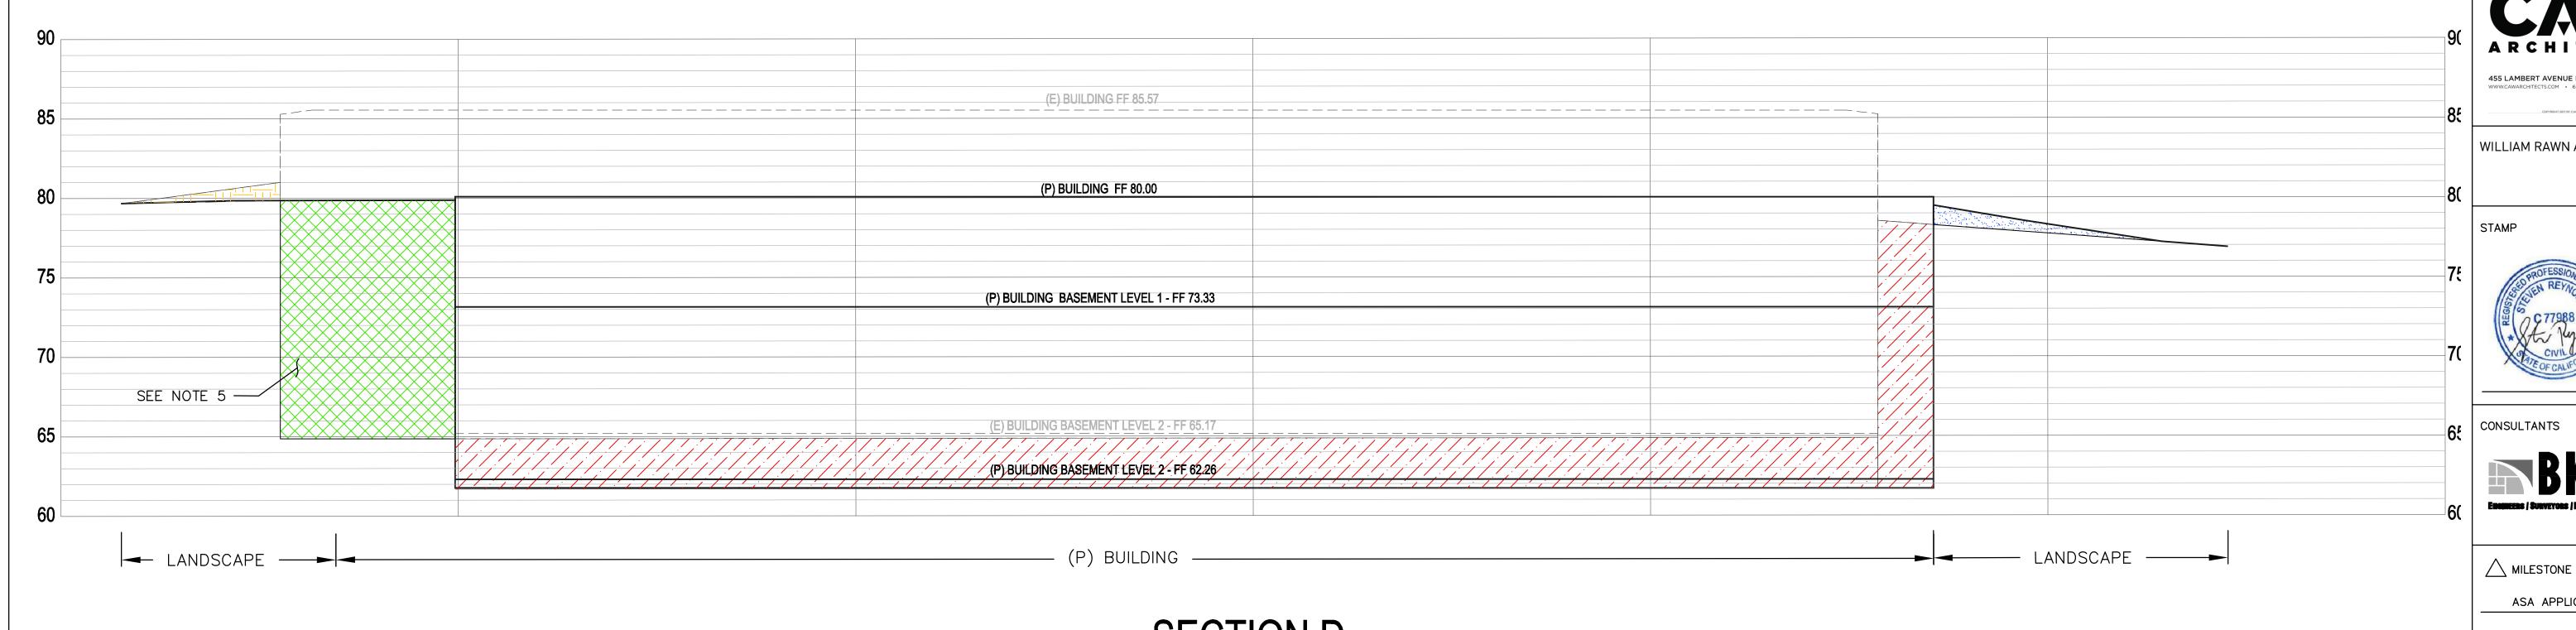
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SECTIONS

PROJECT NO. <u>14029</u>


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SHEE



SECTION D

SCALE: H- 1"=10' V- 1"=20'

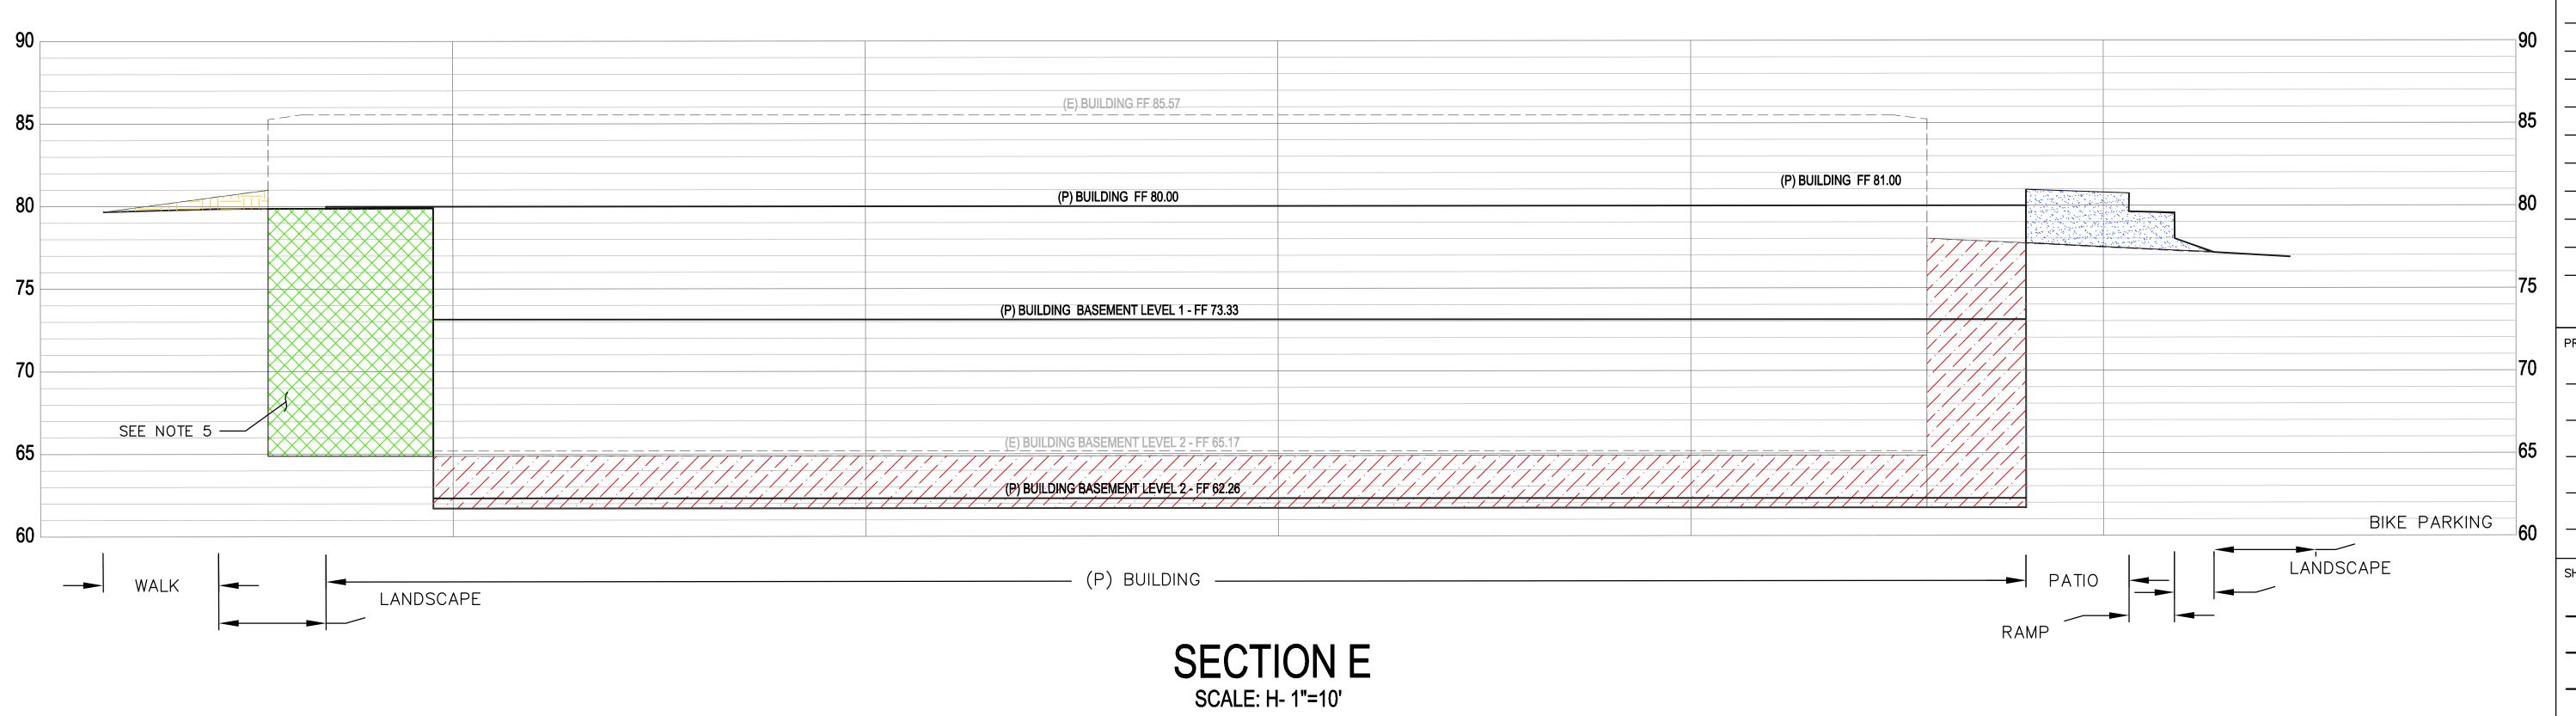

V- 1"=20'

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DATE

7/31/2019 ASA APPLICATION PROJECT NAME GEORGE P. SHULTZ BUILDING


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SHEET TITLE

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MILESTONE DATE 7/31/2019 ASA APPLICATION PROJECT NAME GEORGE P. SHULTZ BUILDING

HOOVER INSTITUTION


434 GALVEZ MALL STANFORD, CA 93405

SHEET TITLE

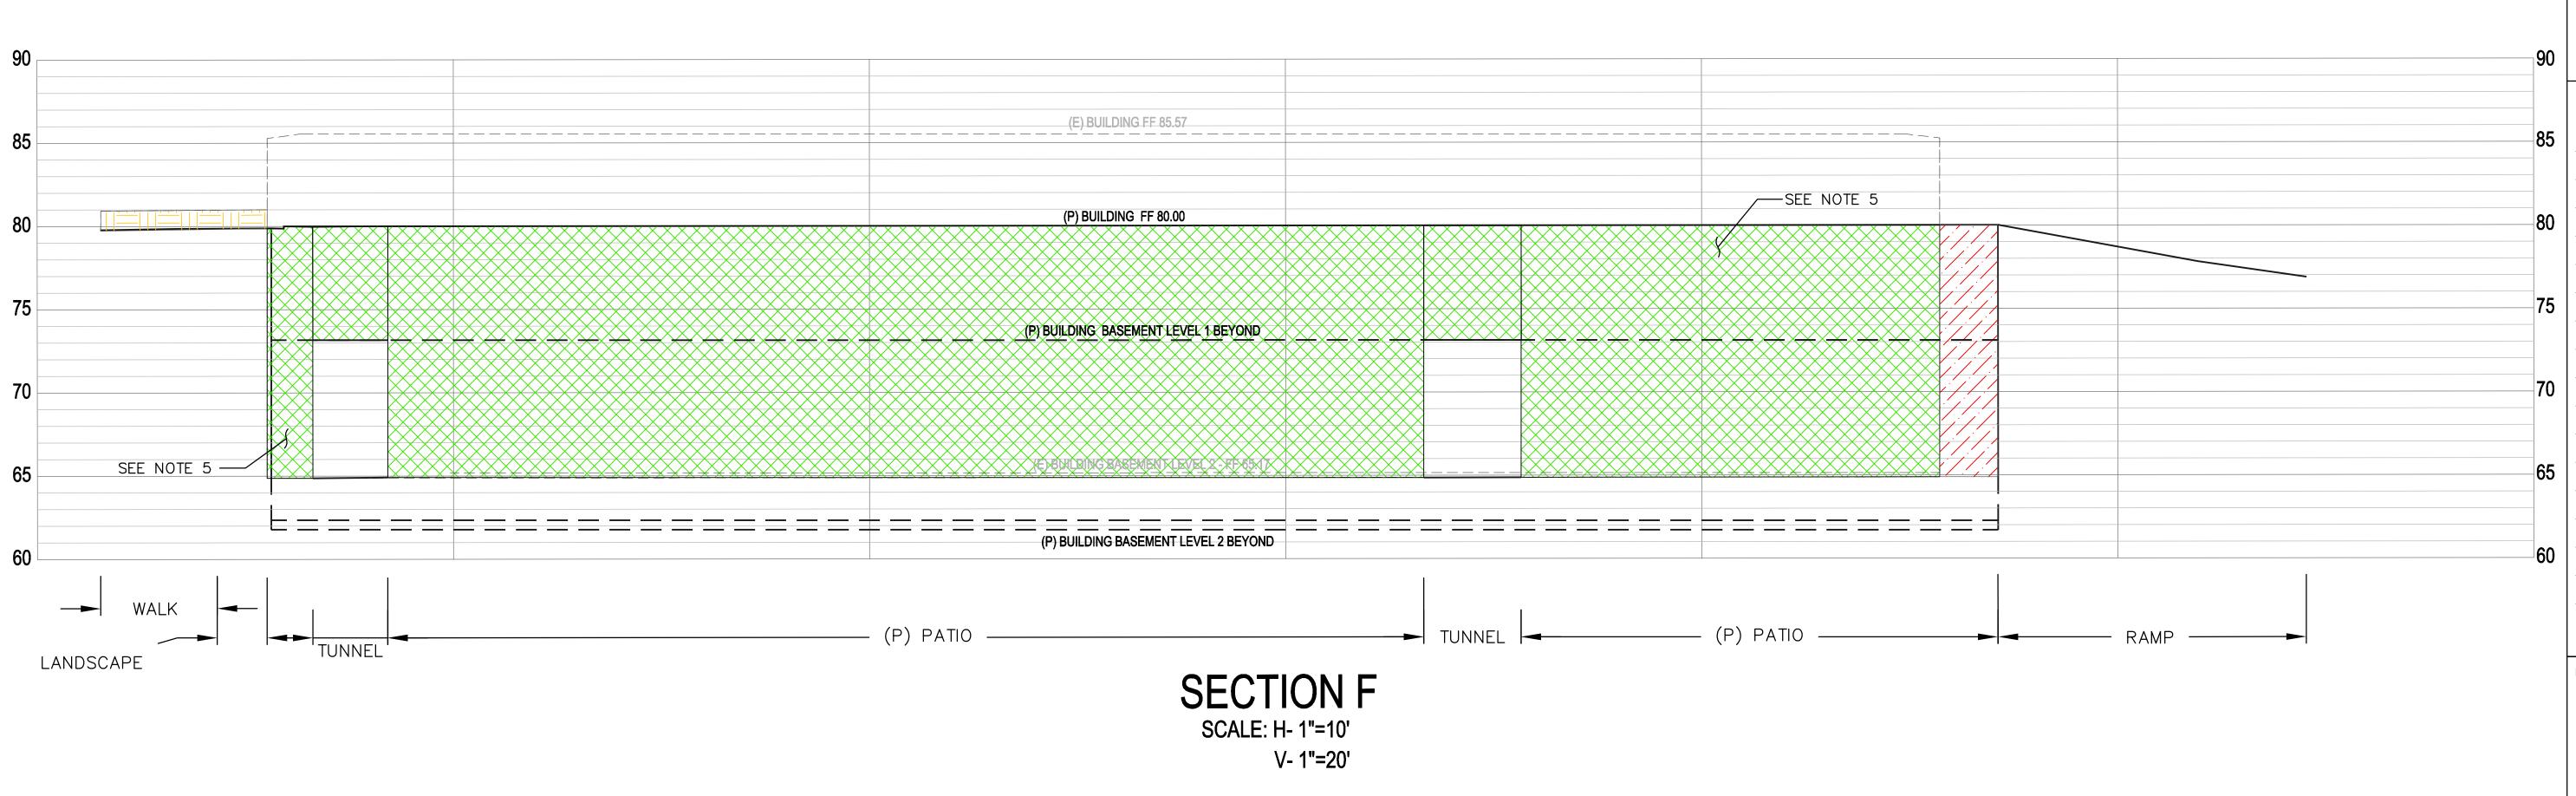SECTIONS

PROJECT NO. <u>14029</u> DRAWN BY SR, CM

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580 SERRA MALL

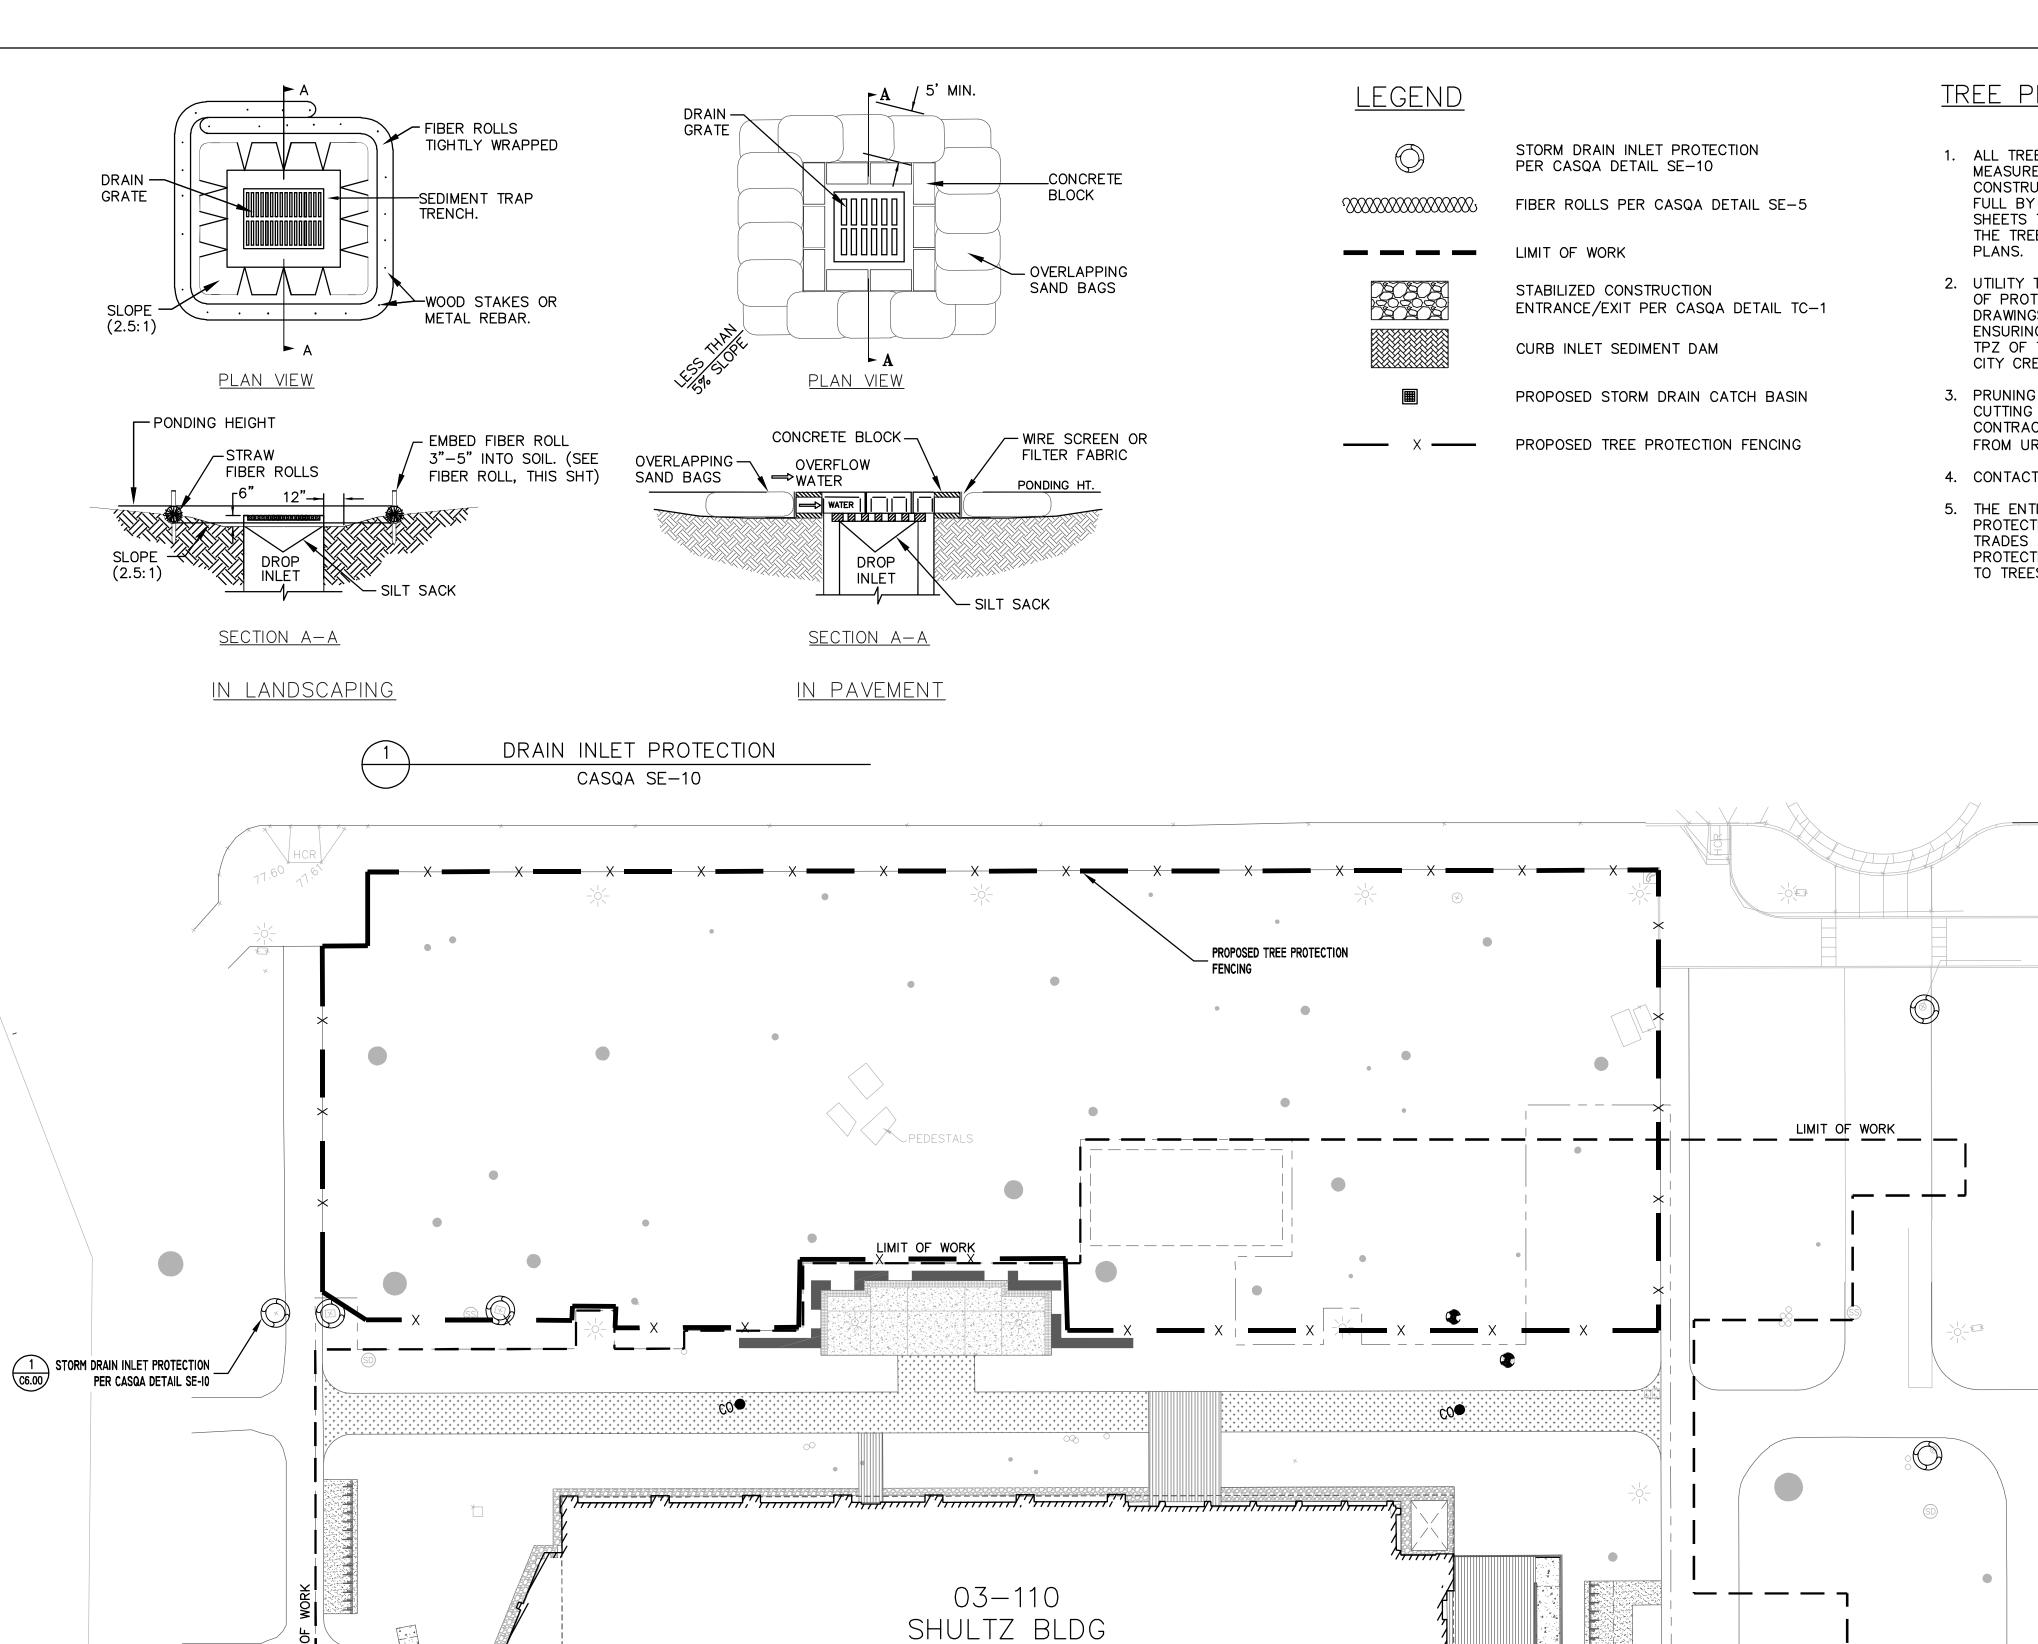FF 80.00

LIMIT OF WORK

TREE PROTECTION NOTES:

- 1. ALL TREE PROTECTION AND INSPECTION SCHEDULE MEASURES, DESIGN RECOMMENDATIONS, WATERING AND CONSTRUCTION SCHEDULING SHALL BE EXECUTED IN FULL BY OWNER AND CONTRACTOR, AS STATED ON SHEETS T-1, T-2, T-3, T-7A, L0.01 AND L0.02, IN THE TREE PROTECTION REPORT, AND THE APPROVED
- 2. UTILITY TRENCHING SHALL NOT OCCUR WITHIN THE TPZ OF PROTECTED TREES, BEYOND THAT INDICATED ON DRAWINGS. CONTRACTOR SHALL BE RESPONSIBLE FOR ENSURING THAT NO TRENCHING OCCURS WITHIN THE TPZ OF THE PROTECTED TREES BY CONTRACTORS, CITY CREWS, OR FINAL LANDSCAPE WORKERS.
- 3. PRUNING RESTRICTIONS NO PRUNING OR CLEARANCE CUTTING OF BRANCHES IS PERMITTED ON CITY TREES. CONTRACTOR SHALL OBTAIN A PUBLIC TREE PERMIT FROM URBAN FORESTRY (650-496-5953).
- 4. CONTACT PROJECT ARBORIST BEFORE WORK IN TPZ.
- 5. THE ENTIRE CONSTRUCTION SITE IS A TREE PROTECTION AWARENESS ZONE. REFERENCE T-7A. ALL TRADES ARE RESPONSIBLE FOR PARTICIPATING IN PROTECTION OF EXISTING TREES AND DOING NO HARM TO TREES OR THEIR ROOT SYSTEMS.

EROSION CONTROL NOTES

- 1. SEE COUNTY OF SANTA CLARA EROSION CONTROL TEMPLATES EC1 AND EC2 FOR BEST MANAGEMENT PRACTICES AND EROSION CONTROL DETAILS.
- 2. FIBER ROLLS SHALL BE INSTALLED AROUND THE PERIMETER ALONG THE CONSTRUCTION FENCE.
- 3. THIS SHEET IS INTENDED FOR EROSION CONTROL ONLY
- 4. IT IS THE CONTRACTOR'S RESPONSIBILITY TO IMPLEMENT ALL REQUIREMENTS SET FORTH IN THE STATE WATER RESOURCES CONTROL BOARD (SWRCB) ORDER NO. XX-XXXX-XXXX-DWQ, NPDES GENERAL PERMIT NO. WDID: XXXXXXXXX, STORM WATER DISCHARGES ASSOCIATED WITH CONSTRUCTION AND LAND DISTURBANCE ACTIVITIES, ALSO KNOWN AS THE CONSTRUCTION GENERAL PERMIT (CGP) AND THE PROJECT STORM WATER POLLUTION PREVENTION PLAN (SWPPP).
- 5. IT IS THE CONTRACTOR'S RESPONSIBILITY TO RETAIN A QUALIFIED STORM WATER POLLUTION PREVENTION PLAN PRACTITIONER (QSP) THAT WILL MONITOR THE SITE, IN ACCORDANCE WITH THE CGP.
- 6. THIS PLAN MAY NOT COVER ALL THE SITUATIONS THAT ARISE DURING CONSTRUCTION DUE TO UNANTICIPATED FIELD CONDITIONS. IN GENERAL, THE CONTRACTOR IS RESPONSIBLE FOR KEEPING ANY SEDIMENT FROM LEAVING THE SITE. FIBER ROLLS. SAND BAGS AND ADDITIONAL SILT FENCES SHALL BE USED BY THE CONTRACTOR ON AN AS NEEDED BASIS TO INHIBIT SILT FROM LEAVING THE SITE AND ENTERING THE STORM DRAIN SYSTEM. ALL EXISTING, TEMPORARY OR PERMANENT CATCH BASINS SHALL USE THE SEDIMENT BARRIERS SHOWN ON THIS PLAN
- 7. STORM DRAIN PIPING IS SHOWN FOR REFERENCE ONLY. SEE SHEET C4.00 FOR UTILITY RELATED WORK.

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ASA APPLICATION

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DATE

7/31/2019

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ABBREVIATIONS

AB	AGGREGATE BASE	PVC	POLYVINYL CHLORIDE
AC	ASPHALT CONCRETE	PVI	POINT OF VERTICAL INTERSECT
AD	AREA DRAIN	PWR	POWER
ALT	ALTERNATE	RW	RECYCLED WATER
BC	BOTTOM OF CURB	RCP	REINFORCED CONCRETE PIPE
BFP	BACK FLOW PREVENTER	S	STATION
BW	BEGINNING OF WALL	SD	STORM DRAIN
CO	CLEANOUT	SDFM	STORM DRAIN FORCE MAIN
CONC	CONCRETE	SEQ	SCIENCE & ENGINEERING QUAD
CU	COPPER PIPE	SIG	SIGNAL
CW	CHILLED WATER	SS	SANITARY SEWER
CWR	CHILLED WATER RETURN	SSR	SOUTH SERVICE ROAD
CWS	CHILLED WATER SERVICE	SW	SEARSVILLE WATER
DI	DRAIN INLET	TC	TOP OF CURB. TELECOM
DIP	DUCTILE IRON PIPE	TEL	TELEPHONE
DW	DOMESTIC WATER	TYP	TYPICAL
E	ELEVATION	TW	TOP OF WALL
ECR	END CURB RETURN	VC	VERTICAL CURVE
EG	EXISTING GRADE	W	WATER
ELEC	ELECTRICAL	WM	WATER METER
EP	EDGE OF PAVEMENT	WV	WATER VALVE
EW	END OF WALL		
EX	EXISTING		
FDC	FIRE DEPARTMENT CONNECT	ION	
FG	FINISHED GRADE		
FH	FIRE HYDRANT		
FS	FIRE SERVICE		
FW	FIRE WATER		
GES	GREEN EARTH SCIENCE		
HWR	HOT WATER RETURN		
HWS	HOT WATER SERVICE		
INV	INVERT		
IRR	IRRIGATION		
ΚV	KILO - VOLT		\
LG	LIP OF GUTTER		
LW	LAKE WATER		
MH	MANHOLE		\
MIN	MINIMUM		
OC	ON CENTER		
PC	POINT ON CURVE		*
PIV	POST INDICATOR VALVE		\
POC	POINT OF CONNECTION		
PP	PERFORATED PIPE		\ \
			\

GRAPHIC SCALE


(IN FEET) 1 inch = 20 ft.

TERSECTION	
PIPE	
MAIN IG QUAD	
IG QUAD	
М	
	PROJECT NAME
	GEORGE P. SHUI
	BUILDING
	HOOVER INSTITUT
	434 GALVEZ MAL
	STANFORD, CA 93
	SHEET TITLE
	EROSION CONTROL

PROJECT NO. 14029

DRAWN BY SR, CM

CHECKED BY JL

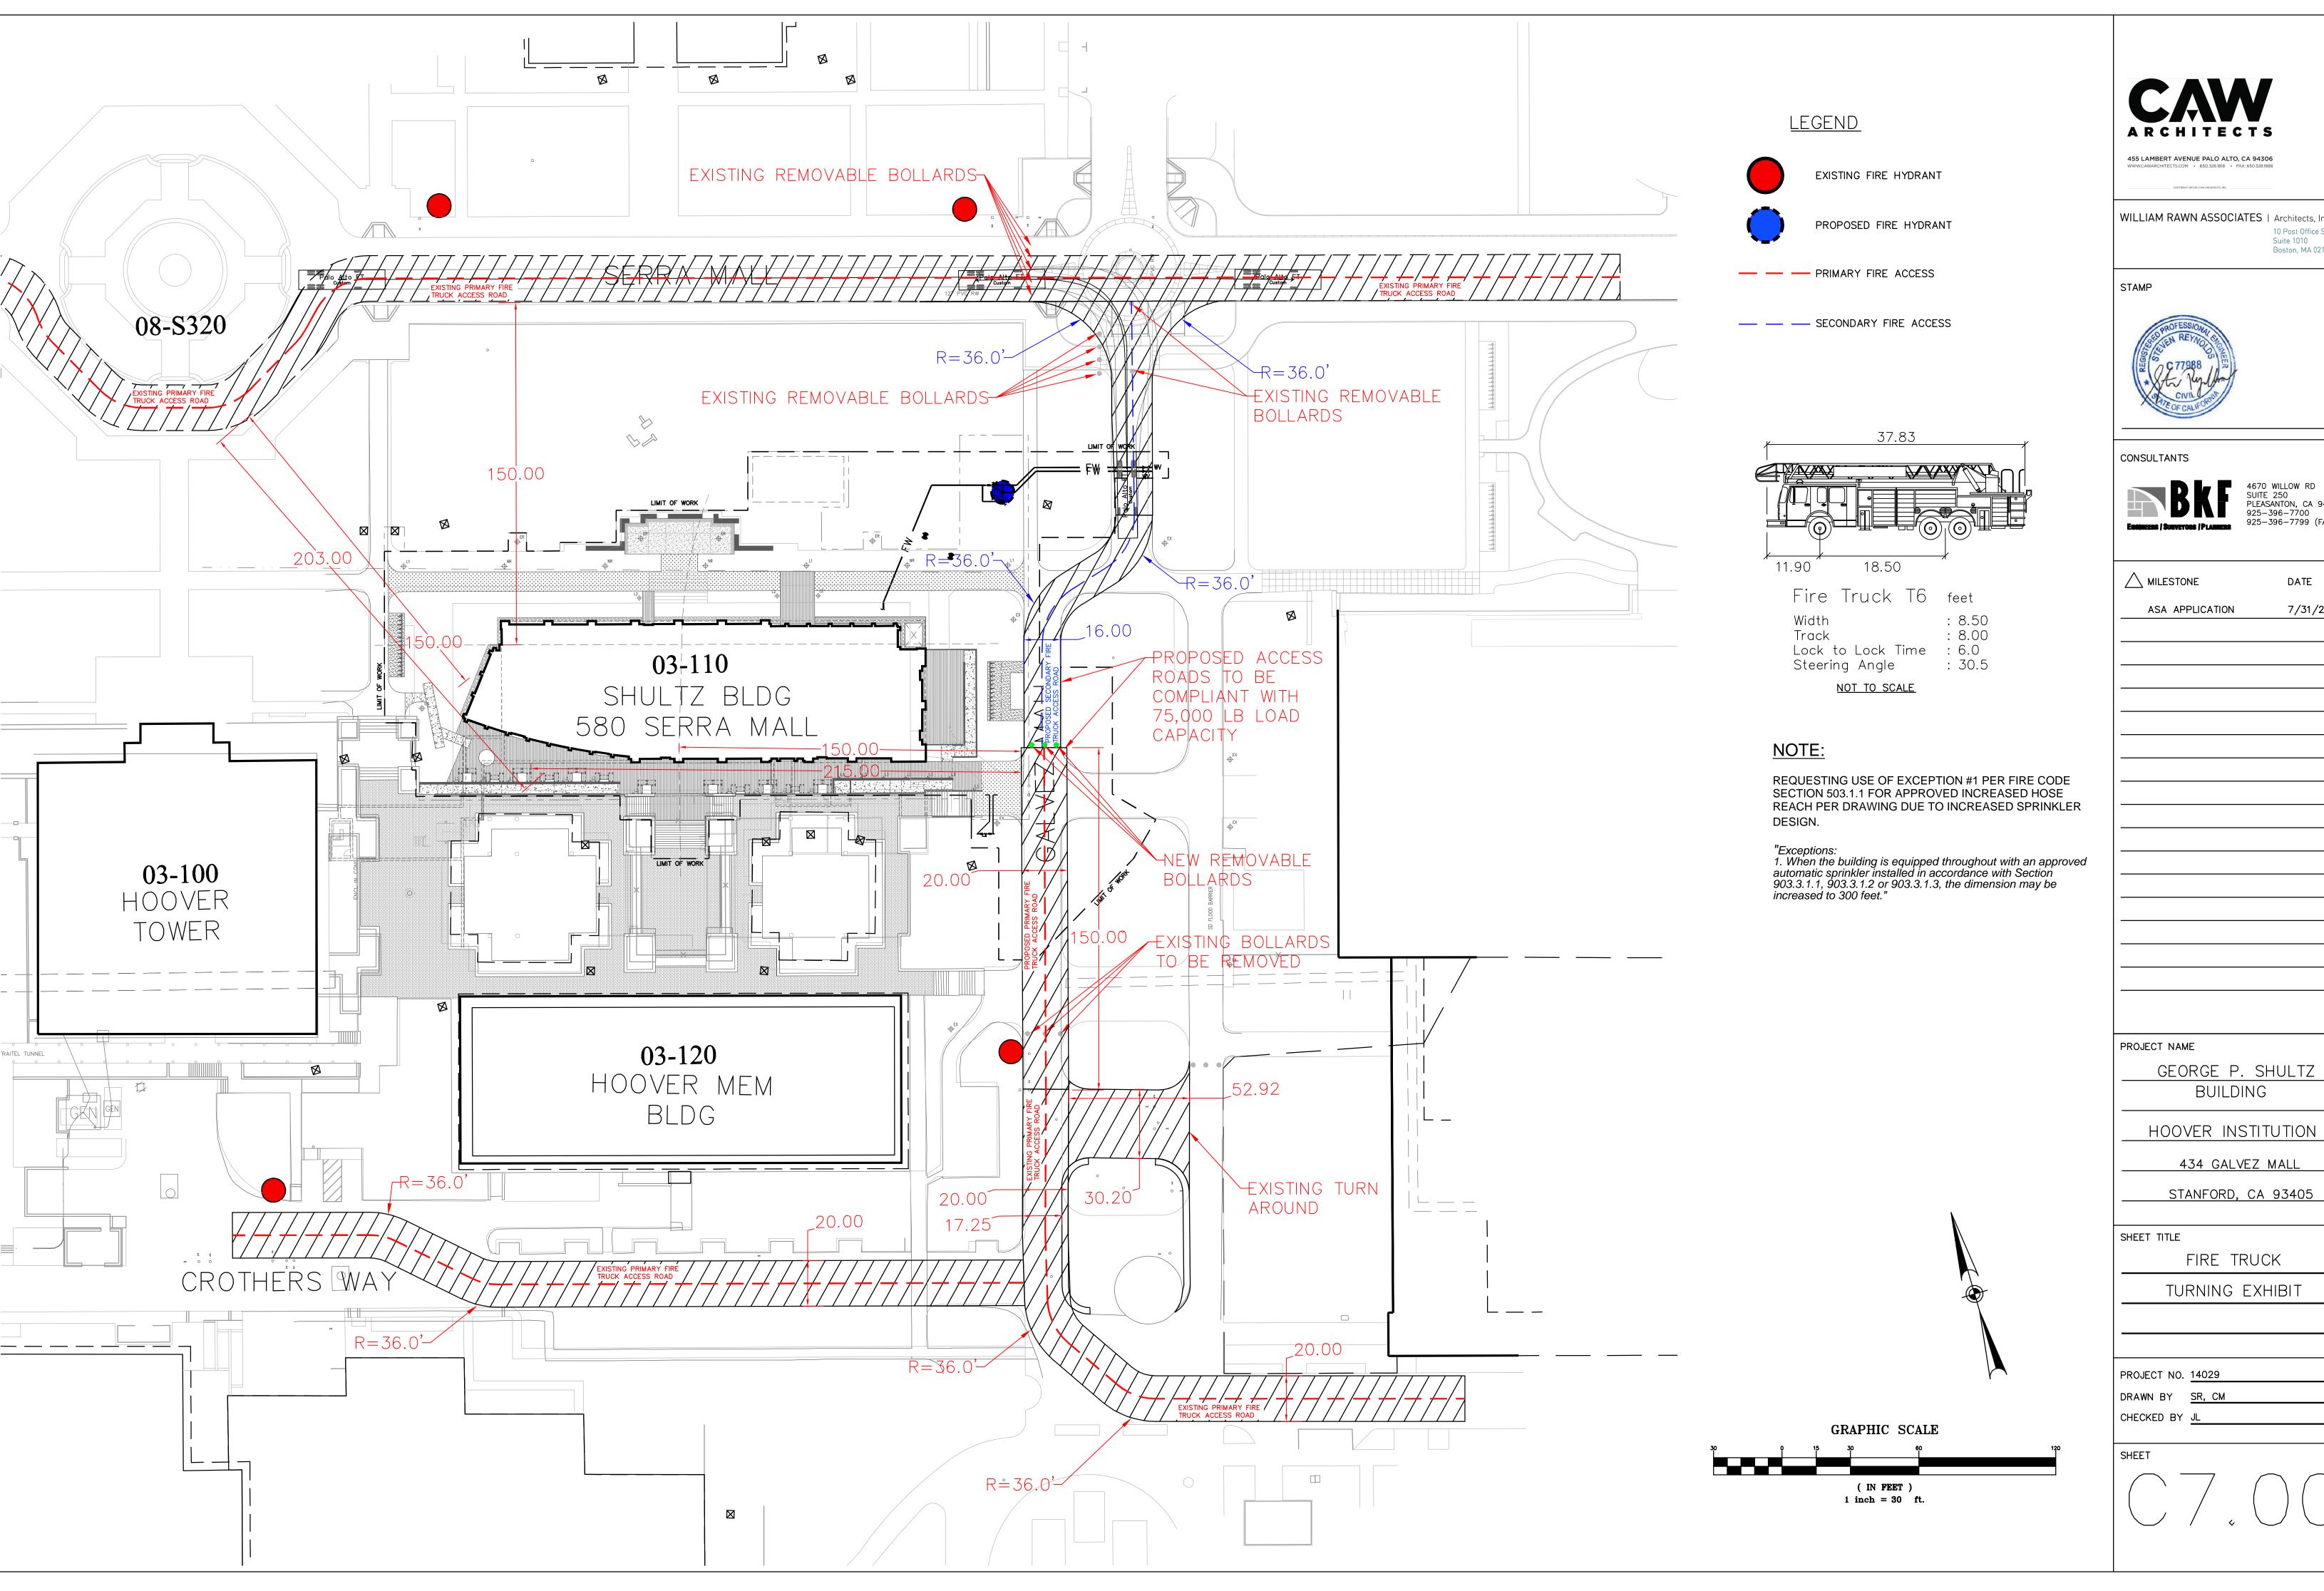

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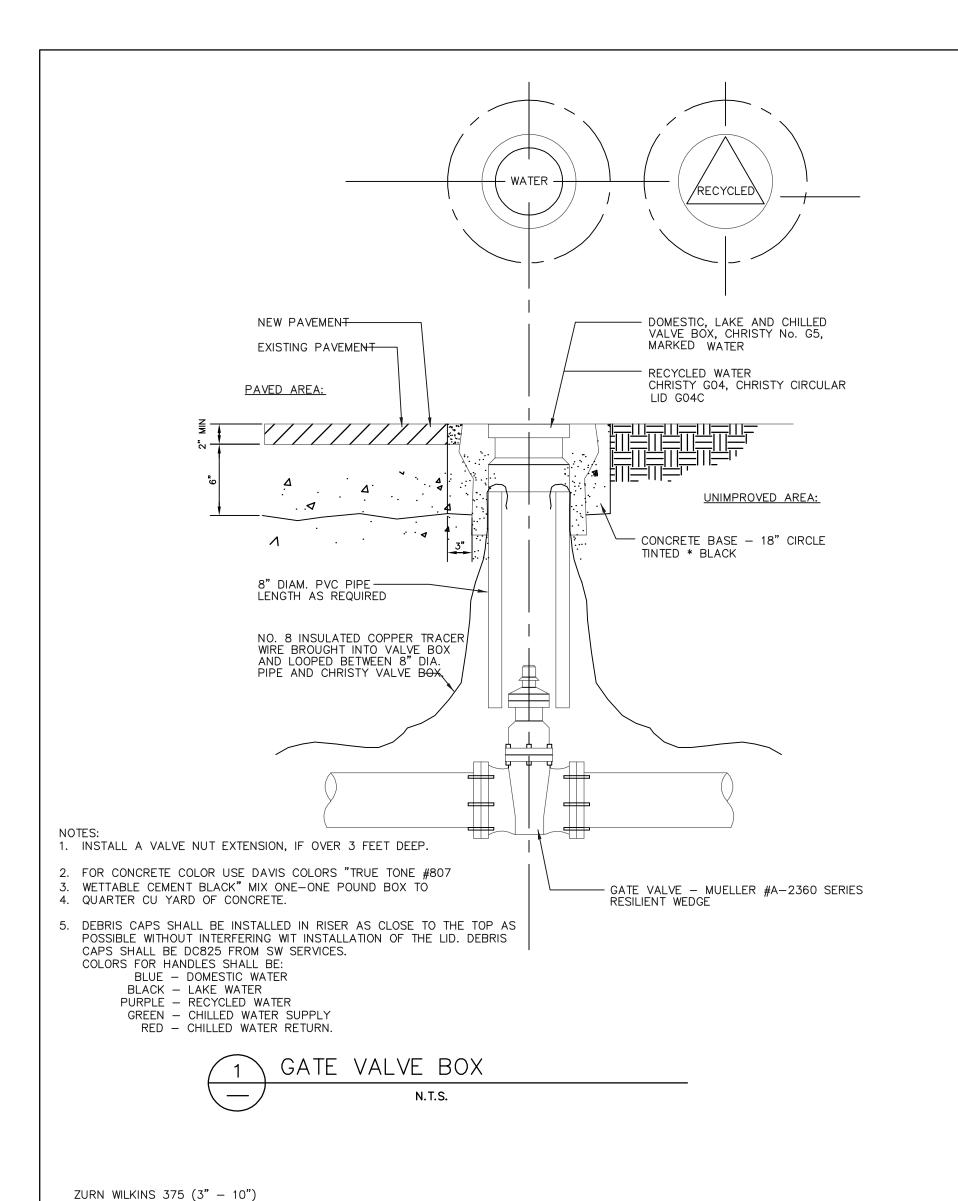
GEORGE P. SHULTZ BUILDING


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TURNING EXHIBIT


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- 1. INLET AND OUTLET PIPES MAY VARY IN ELEVATION BASED ON BUILDING ENTRANCE LOCATIONS
- AND ELEVATIONS. CONSTRUCT THRUST BLOCKS AS REQUIRED. 2. PAINT BACKFLOW CARBON BLACK: KELLY MOORE 1245-407
- 3. ADD CATHODIC PROTECTION WHEN SHOWN ON DRAWINGS.
- 4. RESTRAIN ALL MECHANICAL JOINT FITTINGS WITH MEGA-LUG RESTRAINTS 6. LOCATION TO BE SUBMITTED FOR APPROVAL TO UNIVERSITY ARCHITECT/CAMPUS PLANNING






TEE CONNECTION WITH MAIN LINE AND BRANCH VALVES

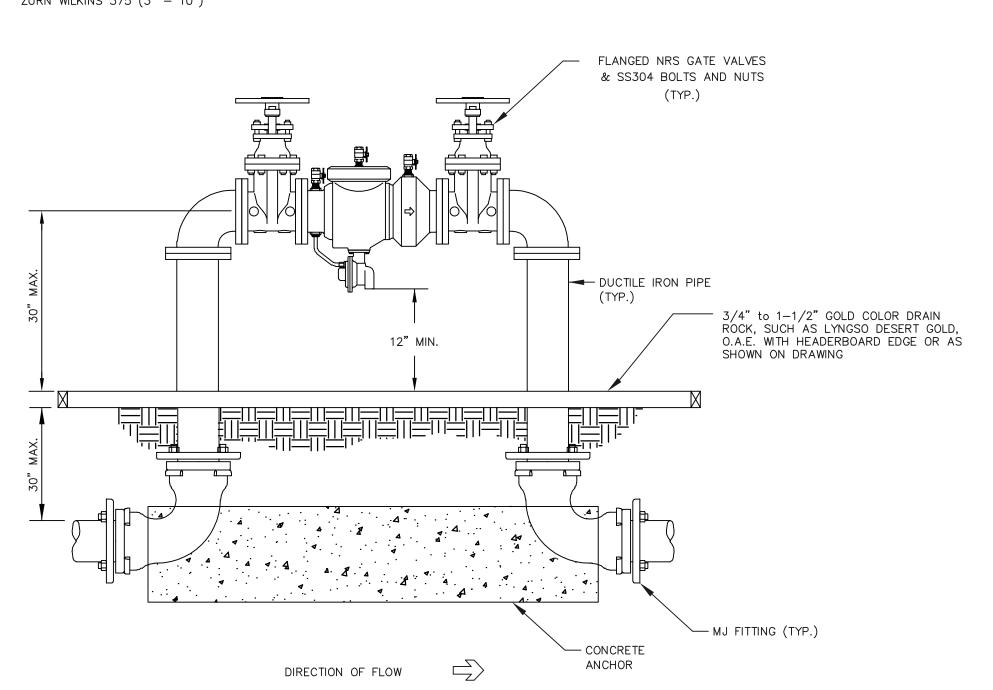1. TAPPING SLEEVE CONNECTION SHALL BE REVIEWED AND APPROVED BY STANFORD UTILITIES

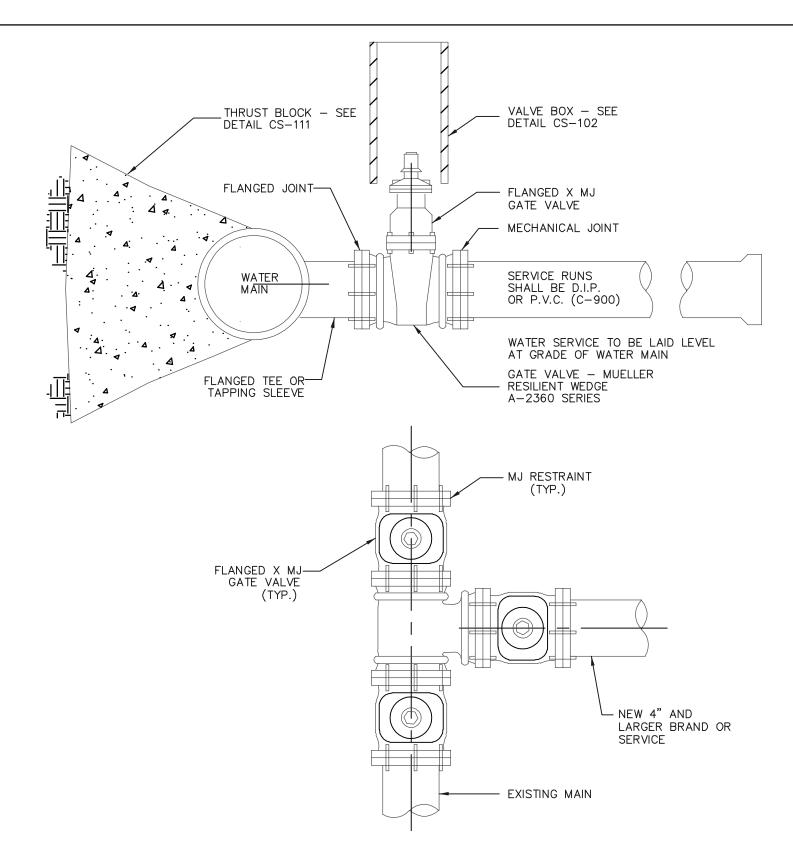2. ADD CATHODIC PROTECTION WHEN SHOWN ON DRAWINGS



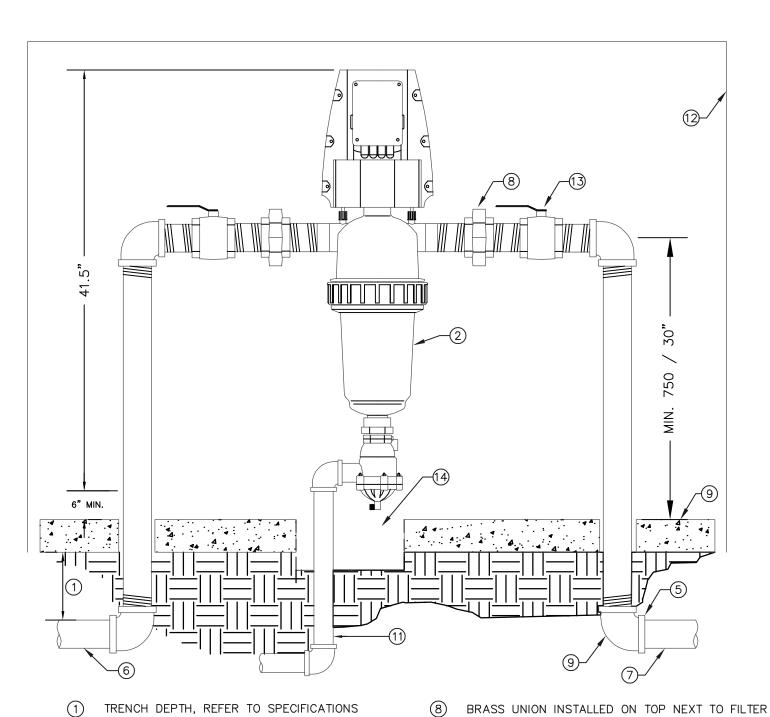

- THREADED BRASS PIPING AND FITTINGS EXTENDED
- 6" BEYOND CONCRETE PAD. (4) 6" THICK CONCRETE PAD FOR ENCLOSURE
- (5) PVC SCHEDULE 80 COUPLER SXT (TWO REQUIRED)
- 6 MINIMUM 2" WATER SOURCE, AS REQUIRED

- 2" PVC PRESSURE SUPPLY LINE THROUGHOUT
- AMIAD 2" TAF-750 FILTER WITH CARTRIDGE DISC. 9 BRASS 90 DEGREE ELL (4 REQUIRED) PURGE VALVE AS PART OF VALVE ASSEMBLY —
 - 1/2" DIAMETER PVC PIPE TO AND THROUGH THE NEAREST CUBE, CORE AND EXTEND TO DRAIN. PROVIDE ALL REQUIRED FITTINGS TO MAKE PROPER CONNECTION TO THE PURGE VALVE.
 - (12) LE MEUR ENCLOSURE SEE FDG IR-04
 - (13) BRASS ISOLATION BALL VALVE

6" MINIMUM BOTTOM CLEARANCE


- CENTER 10" ROUND VALVE BOX AT CONCRETE PAD
- HEIGHT FOR REMOVAL OF FILTER CARTRIDGE SERVICE

NOTE: PROVIDE A 110 VAC POWER SOURCE FOR THE AMIAD TAF-750 LAKE WATER FILTER CONTROLLER. 110 VAC POWER PROVIDED BY OTHERS. THE LANDSCAPE CONTRACTOR SHALL COORDINATE THE POWER WIRES FROM THE SOURCE TO THE FILTER CONTROLLER AND MAKE THE FINAL HOOK-UP. ALL 100 VAC POWER WIRING SHALL BE INSTALLED PER CODE BY A LICENSED ELECTRICAL CONTRACTOR. EACH SITE HAS ITS OWN POC AND FILTER




LAKE WATER FILTER INSTALLATION

N.T.S.

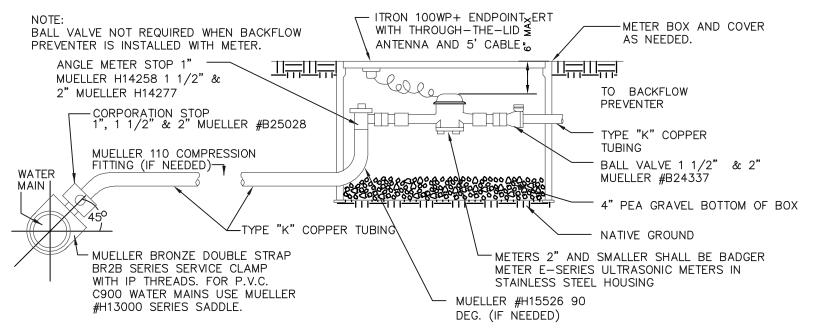

2" AND SMALLER WATER METER INSTALLATION CHRISTY METER BOX, WITH EXTENSIONS AS REQUIRED.

CHRISTY #B9 WITH FL9D LID "WATER" 1" METER CHRISTY #B12 WITH B12G LID "WATER 1 1/2" OR 2" METER CHRISTY #B36 WITH 61G70 LID "WATER"

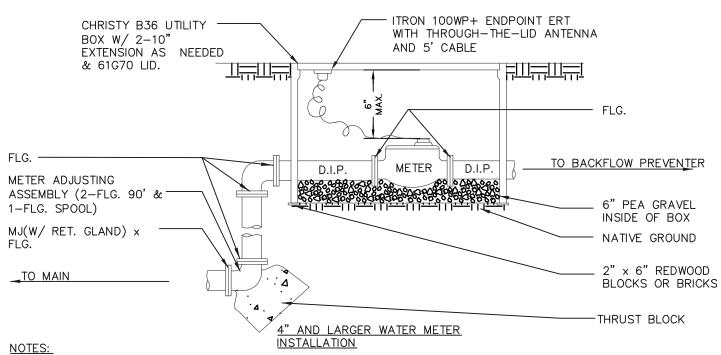


1. CHRISTY B36 METER BOX WITH EXTENSIONS AS REQUIRED. STEEL

CHECKER PLATE LID WITH METER READING LID (61G70).

- 2. BADGER METER TURBO SERIES WITH RTR REGISTER AND ITRON PIT ERT STRAIGHT READING CF REGISTER
- 3. 6" PEA GRAVEL IN BOTTOM OF BOX.
- 4. IF REDUCERS ARE REQUIRED, INSTALL OUTSIDE OF BOX.
- 5. INSTALL FIBERGLASS ROD INSIDE OF BOX TO HOLD UP THE SMART METER COMPONENTS. FIBERGLASS ROD SHALL BE 1/2" DIAMETER AND



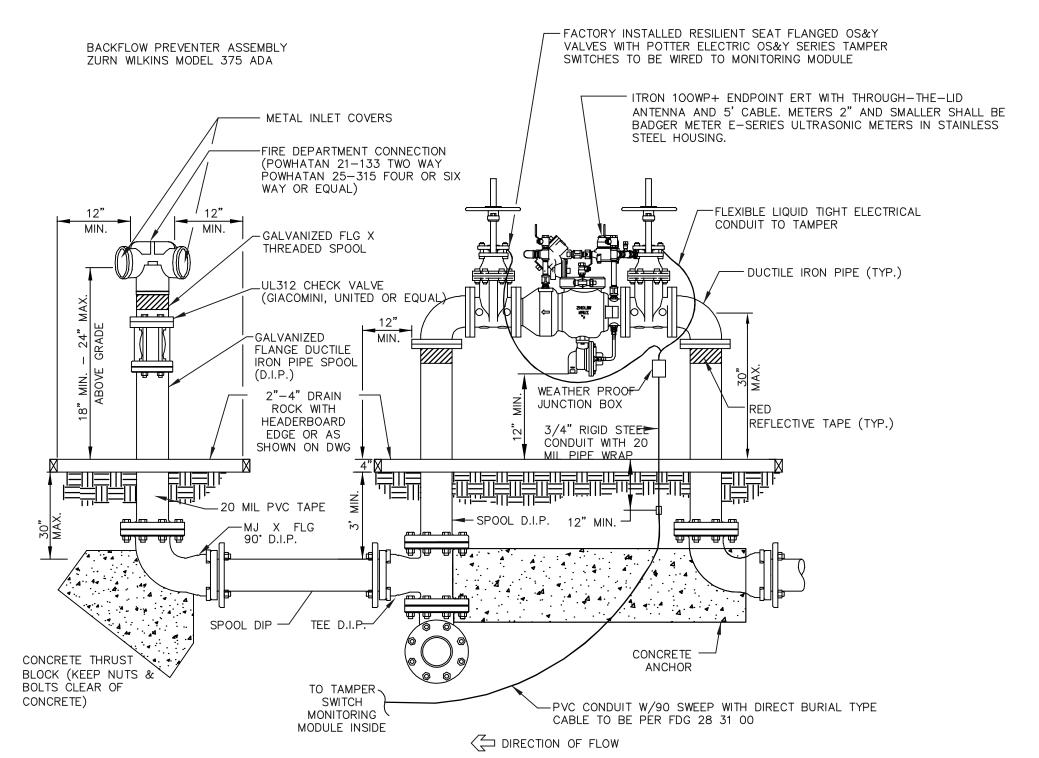

1. SEE STANFORD FACILITIES DESIGN GUIDELINESS, SECTION 33 10 01. FOR ADDITIONAL INFORMATION AND REQUIREMENTS FOR REDUCED PRESSURE ZONE BACKFLOW PREVENTER ASSEMBLIES.

- 2. INLET AND OUTLET PIPES MAY VARY IN ELEVATION BASED ON BUILDING ENTRANCE LOCATIONS AND ELEVATIONS. CONSTRUCT THRUST BLOCKS AS REQUIRED.
- 3. FDC SHALL BE ACCESSIBLE TO FIRE DEPARTMENT IN ACCORDANCE WITH FIRE MARSHAL.
- 4. BACKFLOW PREVENTER ASSEMBLY SHALL BE PAINTED WITH KELLY-MOORE/DTM 5725 WROUGHT IRON BLACK.
- 5. ADD CATHODIC PROTECTION WHEN SHOWN ON DRAWINGS.
- 6. LOCATION TO BE SUBMITTED FOR APPROVAL TO UNIVERSITY ARCHITECT/CAMPUS PLANNING AND TO SUFMO. 7. PROVIDE CODE REQUIRED SIGNAGE PER STANFORD FDG 21 13 00.
 - BACKFLOW PREVENTER ASSY. & FIRE DEPARTMENT CONNECTION N.T.S.



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PROJECT NAME GEORGE P. SHULTZ BUILDING

> HOOVER INSTITUTION 434 GALVEZ MALL

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SHEET TITLE


CIVIL DETAILS

PROJECT NO. 14029 DRAWN BY CHECKED BY JL

SHEET


- 1. FLANGE BOLTS & NUTS SHALL BE KEPT CLEAR OF CONCRETE.
- 2. SEE PLAN FOR HYDRANT LOCATION.
- 3. STEEL TIE RODS & CLAMPS ARE NOT ACCEPTABLE.
- 4. PAINT HYDRANT WHITE.
- 5. SEE DETAIL CS-172 FOR GUARD POST

- 8. ADD CATHODIC PROTECTION WHEN SHOWN

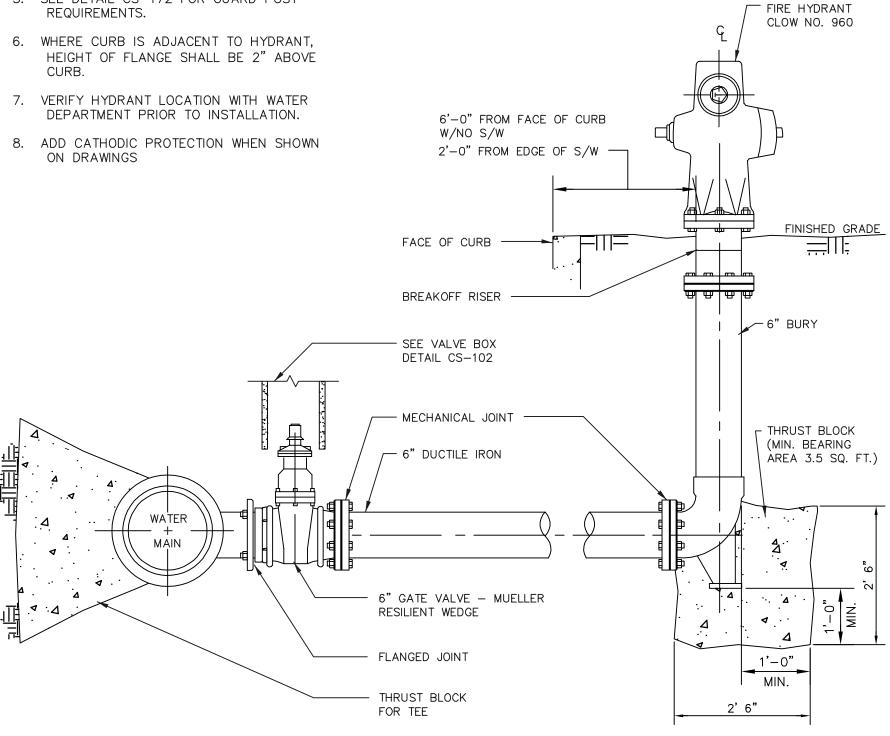


FIRE HYDRANT

N.T.S.

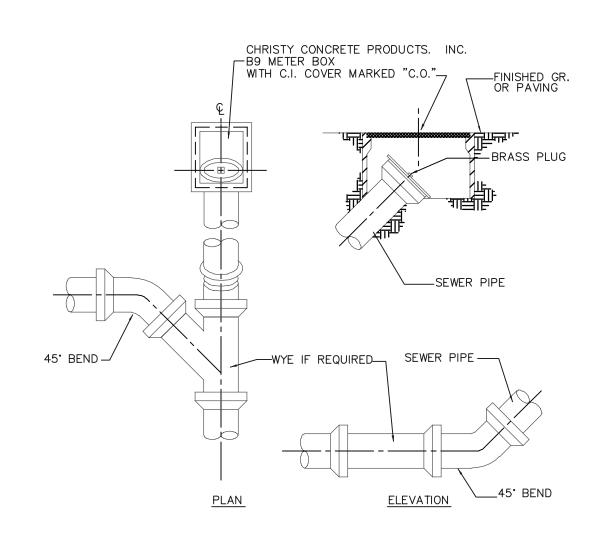

1. CLEANOUT PIPE TO BE SAME SIZE AND MATERIAL AS SEWER MAIN UP TO 8"




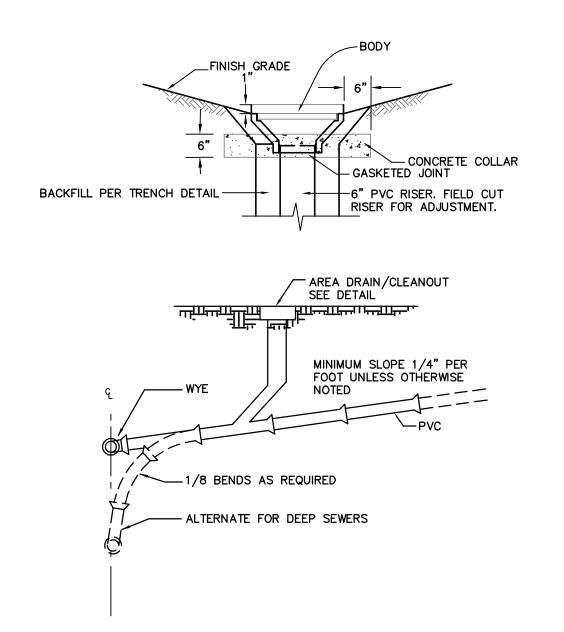


NDS #6 AREA DRAIN & WYE

CONNECTION

N.T.S.

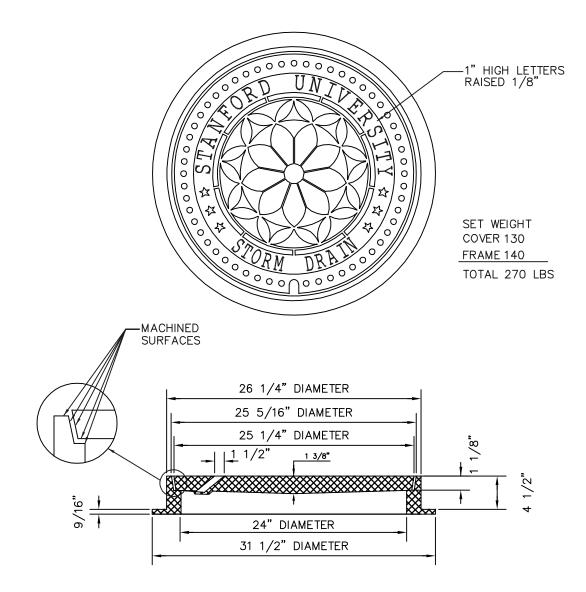




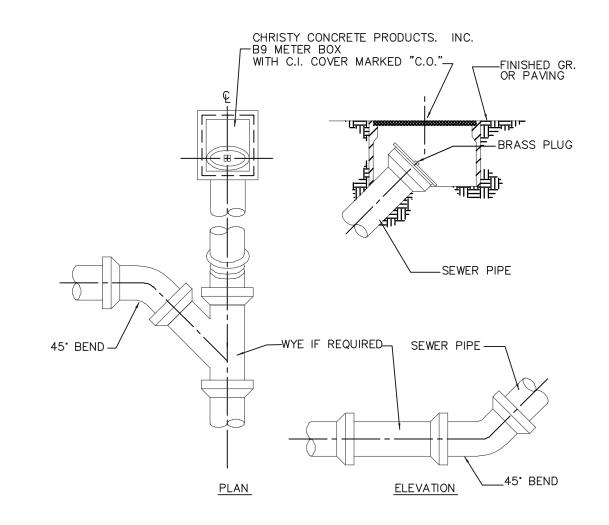

1. CLEANOUT PIPE TO BE SAME SIZE AND MATERIAL AS SEWER MAIN UP TO 8"

3	SANITARY SEWER CLEANOUT	
	N.T.S.	

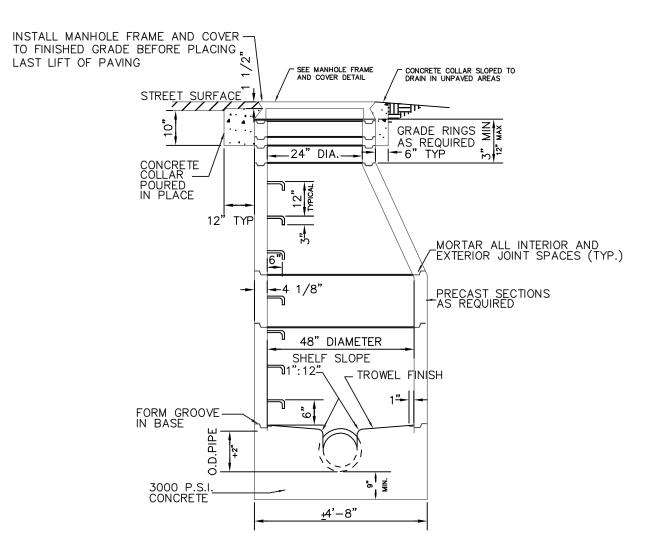

<u>SPECIFICATIONS</u>

- PRECAST M.H. SECTIONS SHALL CONFORM TO APPLICABLE PROVISIONS OF ASTM C76-59T.
- MANHOLE SECTIONS SHALL BE AS SPECIFIED IN TABLE II, WALL A, FOR 48" REINFORCED CONCRETE PIPE. REINFORCING SHALL BE CIRCULAR AS SPECIFIED FOR SINGLE CURTAIN.
- 3. STEPS SHALL BE 14" WIDE
- 4. FOR MANHOLE BASES SEE CS-203.





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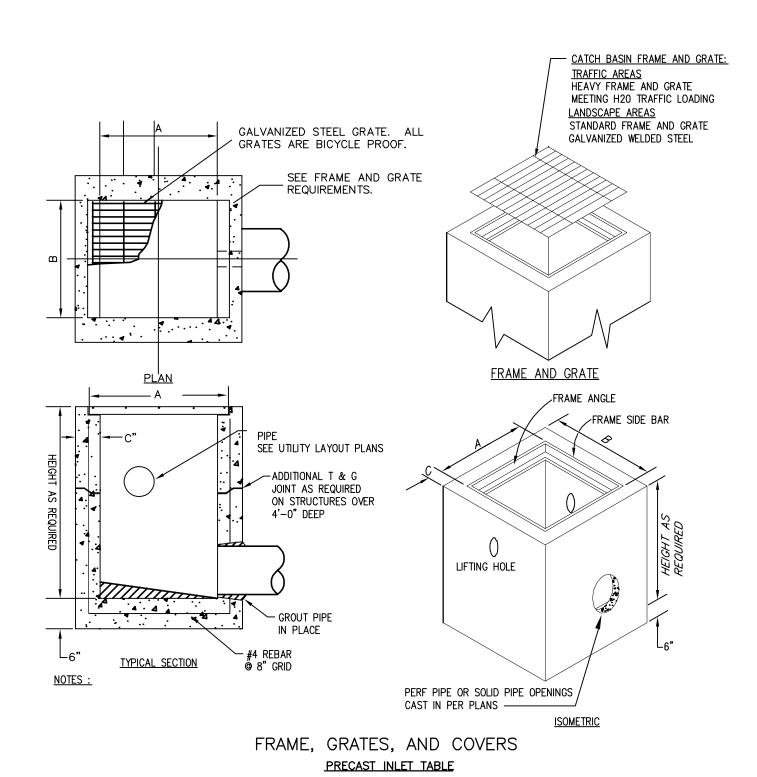
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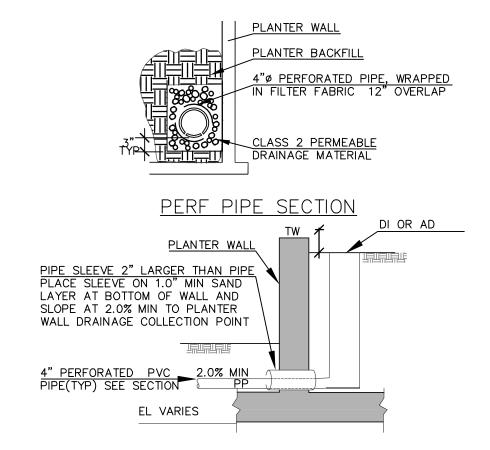
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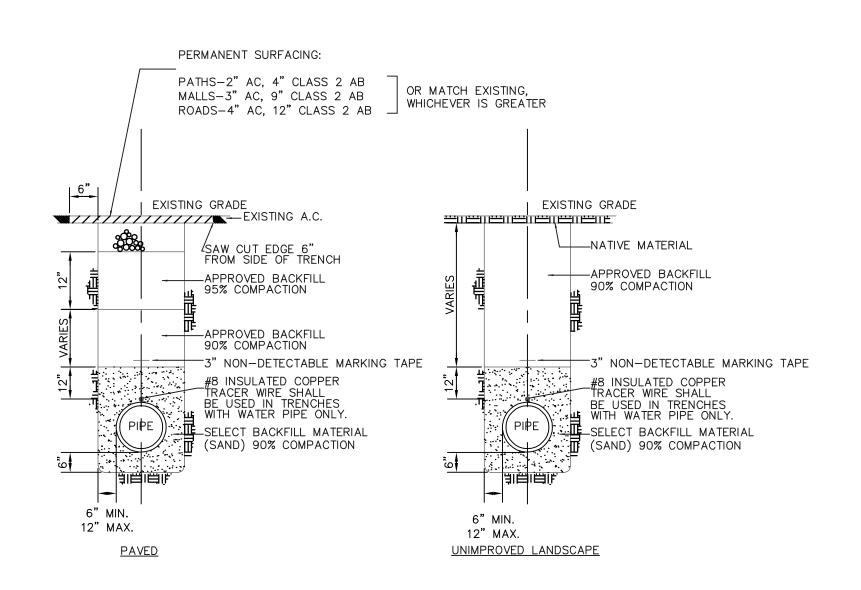


INLET TYPE	MODEL	Α	В	U	FRAME, GRATE AND COVER TYPE
12" CATCH BASIN	1K	12"	12"	4"	HEAVY FRAME AND GRATE IN TRAFFIC AREAS, STANDARD IN LANDSCAPE AREAS
24" CATCH BASIN	2K	24"	24"	5"	HEAVY FRAME AND GRATE IN TRAFFIC AREAS, STANDARD IN LANDSCAPE AREAS
JUNCTION BOX	3K	24"	24"	5"	REINFORCED CHECKERED SOLID PLATE COVER WITH HEAVY FRAME AND GRATE









NOTES:

1. SHORING TO BE PER CAL/OSHA CONSTRUCTION SAFETY ORDERS.

2. RESTORE ALL PAVEMENT MARKINGS IN-KIND WHERE REMOVED AS PART OF TRENCHING OPERATIONS

2	TRENCH BACKFILL AND SURFACE						
	RESTORATION						
	N.T.S.						



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STANFORD UNIVERSITY

434 GALVEZ MALL, STANFORD, CA 93405

ASA APPLICATION
JULY 31, 2019

Landscape Architect


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Consultants

Irrigation Consultant

Russell D. Mitchell Associates, Inc. 2760 Camino Diablo Walnut Creek, CA 94597 (925) 939-3985



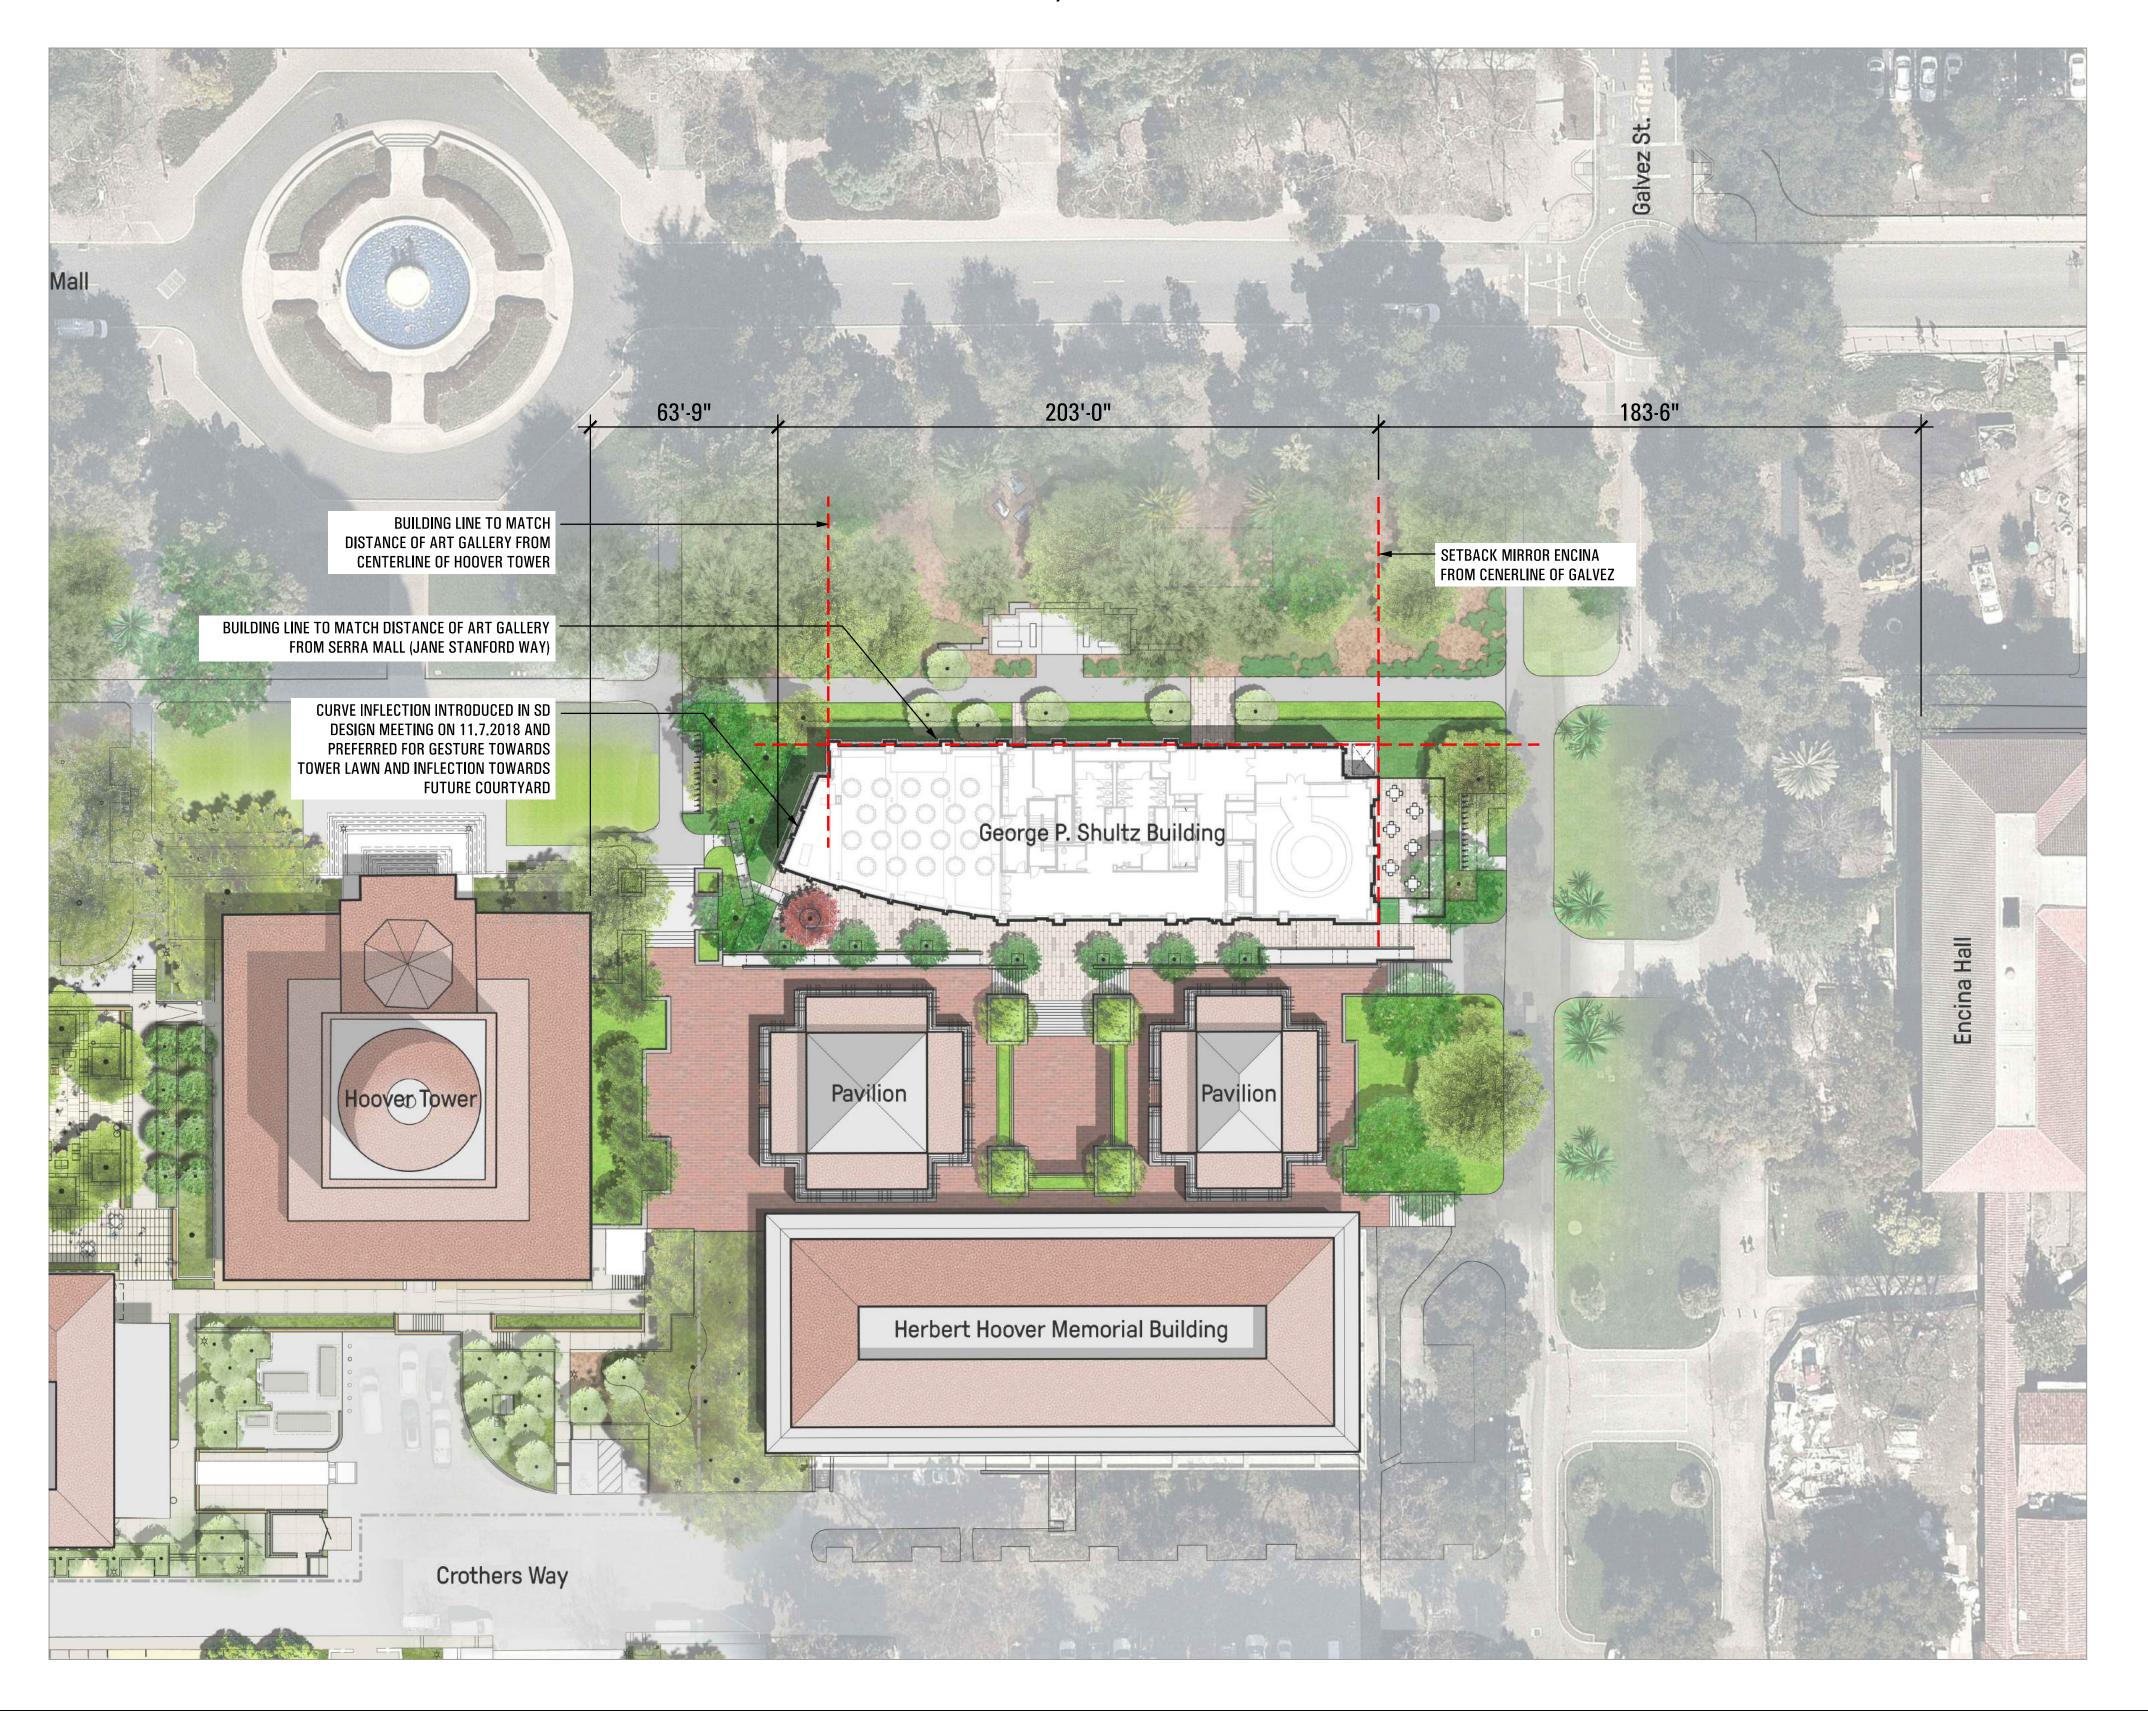

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7/31/2019

ASA APPLICATION

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KEY PLAN

PROJECT NO. STFS802

DRAWN BY C. LINDLEY

CHECKED BY W. HYNES

SHEET

L0.0

STANFORD UNIVERSITY TREE AND SHRUB PROTECTION GUIDELINES 1. WE HAVE STRICT REQUIREMENTS WHICH INCLUDE THE POINTS LISTED BELOW AND ADDITIONAL PROCEDURES AS DETAILED IN THE FDG SPECIFICATIONS GUIDELINE 01 56 39 TREE AND SHRUB PROTECTION. WITHIN ANY TREES ROOT ZONES. 4. ALL TREES TO REMAIN ON A PROJECT SHALL HAVE PROTECTIVE FENCING INSTALLED PER THE TREE

- 2. THE ROOT ZONE OF ALL TREES MUST BE PROTECTED ON ALL CONSTRUCTION PROJECTS, AS DESCRIBED BELOW. A TREE'S ROOT ZONE IS DEFINED AS THE AREA FROM THE TRUNK OUT TO 10' BEYOND THE
- 3. A STANFORD GROUNDS SERVICES CERTIFIED ARBORIST SHALL BE CONTACTED TO EVALUATE ALL WORK
- PROTECTION DRAWING INCLUDED IN THE PLAN SET.
- 5. PROTECTIVE FENCING SHALL BE CHAIN LINK ON SECURE FOOTINGS, OR IMBEDDED AS REQUIRED BY THE CAMPUS PLANNING AND DESIGN OFFICE OR STANFORD GROUNDS SERVICES CERTIFIED ARBORIST. THAT WILL NOT FALL OVER ONTO TREES.
- 6. PROTECTIVE FENCING SHALL BE PLACED AT THE OUTER EDGE OF THE ROOT ZONE, 10' BEYOND THE TREE DRIPLINE WHEREVER POSSIBLE AS SHOWN ON TREE PROTECTION DRAWING. IF PROJECT CONSTRAINTS DO NOT ALLOW FOR FENCING AT THE OUTER EDGE OF THE ROOT ZONE, FENCING MUST BE PLACED AS CLOSE TO THIS AS POSSIBLE AND APPROVED AFTER IT IS IN PLACE BY A STANFORD UNIVERSITY GROUNDS SERVICES CERTIFIED ARBORIST.
- 7. LAYDOWN, STAGING AND PARKING AREAS SHALL BE APPROVED BY THE STANFORD UNIVERSITY ARCHITECT/CAMPUS PLANNING DEPARTMENT AND SHALL BE SHOWN ON THE PLANS IF WITHIN THE PROJECT LIMIT AREA, OR ON THE CONSTRUCTION LOGISTICS PLAN IF OUTSIDE THE PROJECT LIMIT AREA. ALL TREE PROTECTION GUIDELINES APPLY TO TREES IN LAYDOWN, STAGING AND PARKING AREAS AS WELL AS TO TREES WITHIN THE PROJECT LIMITS.
- CONSTRUCTION MATERIALS/EQUIPMENT/PERSONAL VEHICLES SHALL NOT BE STORED, PARKED OR TEMPORARILY PLACED IN THE ROOT ZONE OF ANY TREES. NOTHING SHALL BE STORED OR PLACED TEMPORARILY WITHIN PROTECTIVE FENCING, TO AVOID SOIL COMPACTION AND SOIL CONTAMINATION UNDER TREES. ROOT ZONES OF TREES SHALL NOT BE DRIVEN OVER. PROVIDE ALTERNATIVE ROUTES FOR CONSTRUCTION TRAFFIC OF ANY KIND INCLUDING CARS, PEOPLE, TRACTORS, EQUIPMENT, CRANES, OR ANY OTHER TRAFFIC AND ALL STAGING OR STORAGE AREAS.
- 9. PROTECT OVERHANGING TREE CANOPIES FROM CONSTRUCTION DAMAGE. IF DRIVE AISLES ARE ANTICIPATED UNDER LOW CANOPIES CALL FOR AN EVALUATION BY A STANFORD GROUNDS SERVICES CERTIFIED ARBORIST TO DETERMINE APPROPRIATE MEASURES.
- 10. THERE SHALL BE NO GRADE CHANGE WITHIN A MINIMUM OF TEN FEET OF THE TRUNK OF EXISTING TREES, AND PREFERABLY NONE WITHIN THE ENTIRE ROOT ZONE. NATIVE OAKS ARE PARTICULARLY SENSITIVE TO GRADE CHANGES.
- 11. NO RINSING, CLEANING EQUIPMENT OR DUMPING CONSTRUCTION LIQUID MATERIALS SHALL BE ALLOWED IN THE TREE ROOT ZONE. CARE SHALL BE TAKEN IN CLEANING UP EQUIPMENT. THERE SHALL BE NO STORAGE OF DUMPSTERS OR ACCUMULATED DEBRIS FROM DEMOLITION ON OR AROUND THE ROOT ZONES OF EXISTING TREES AND SHRUBS.
- 12. EXISTING TREES SHALL BE MONITORED WEEKLY AND IRRIGATED AS NEEDED DURING THE COURSE OF CONSTRUCTION.
- 13. NO LIME OR OTHER SOIL TREATMENT SHALL BE APPLIED WITHOUT THE CONSENT OF A STANFORD GROUNDS SERVICES CERTIFIED ARBORIST.
- 14. ALL TRENCHING SHALL CONFORM TO THE FOLLOWING GUIDELINES.
- A. A STANFORD GROUNDS SERVICES CERTIFIED ARBORIST IS REQUIRED TO BE PRESENT TO SUPERVISE ANY TRENCHING, DIGGING OR EXCAVATION OF ANY KIND WITHIN A TREES' ROOT ZONE.
- B. ROOTS LARGER THAN 2 INCHES IN DIAMETER SHALL NOT BE SEVERED WITHOUT CALLING A STANFORD GROUNDS SERVICES CERTIFIED ARBORIST FOR CUTTING OR REVIEW.
- C. TUNNELING OR BORING UNDER ROOTS RATHER THAN PRUNING IS PREFERRED.
- D. DIGGING WITHIN A TREE'S ROOT ZONE SHALL BE AVOIDED. IF IT IS NECESSARY, HAND DIGGING SHALL BE USED FOR ANY TRENCHING WITHIN THE TREE'S ROOT ZONE UNLESS OTHERWISE APPROVED BY A SGSCA.
- E. ALL ROOTS THAT NEED TO BE CUT SHALL BE PRUNED CLEANLY, NOT TORN.

THE PRECEDING GUIDELINES SHALL BE CONSIDERED MINIMUM REQUIREMENTS. THE GREATER THE DISTANCE OF TREE PROTECTION PROVIDED THE GREATER THE INSTANCE OF TREE SUCCESS IN CONSTRUCTION AREAS.

TREE NOTES

- 1. CONTRACTOR SHALL TAG ALL TREES TO BE REMOVED, RELOCATED AND PROTECTED. CONTRACTOR SHALL REVIEW ALL TREES WITH THE OWNER AND THE LANDSCAPE ARCHITECT PRIOR TO REMOVAL & RELOCATION.
- 2. PLEASE CONTACT A STANFORD ARBORIST TO BE PRESENT FOR NECESSARY ROOT EXCAVATION, DURING THE REMOVAL OF EXISTING PARKING LOT. CURB-PERIMETERS. SIDEWALKS AND OR AGGREGATE PATHWAYS, WHERE ANY TRENCHING MAY SEVER TREE ROOTS. THERE ARE MANY ESTABLISHED TREES IN NARROW PLANTING AREAS AND THESE TREE ROOTS HAVE GROWN NEXT TO OR UNDER SUCH CONCRETE. AGGREGATE WALK WAYS, AND PAST CURBS AND INTO THE PARKING LOT PERIMETERS. STANFORD ARBORIST'S ARE REQUIRED TO OVERSEE CONSTRUCTION WORK THAT IS DONE UNDER TREES, INCLUDING ROOT PRUNING.
- 3. THIS IS A LIST OF STANFORD UNIVERSITY ARBORISTS:
 - MICHAEL BURDZINSKI (650) 444-6589 BURDZINS@STANFORD.EDU (650) 313-9436 MICHAEL GLADDEN MGLADDEN@STANFORD.EDU
- 4. ALL EXISTING LANDSCAPED AREA AND IRRIGATION ARE TO BE RESTORED AND OPERATIONAL WITH PRIOR APPROVAL OF THE STANFORD UNIVERSITY ARCHITECT AND PLANNING OFFICE AND STANFORD GROUNDS
- 5. ONLY HAND EXCAVATION IS TO BE DONE FOR GRUBBING UNDERNEATH THE CANOPIES OR WITHIN ANY PROTECTED EXISTING TREES' ROOTZONE. FOLLOW ALL STANFORD UNIVERSITY TREE AND SHRUB PROTECTION GUIDELINES (AS SHOWN ABOVE) AND REFER TO THE FDG DOCUMENTATION.
- 6. COORDINATE WITH STANFORD ARBORIST PRIOR TO BEGINNING CONSTRUCTION IF PRUNING TO EXISTING TREES WILL BE NECESSARY IN ORDER TO COMPLETE THE REQUIRED WORK.



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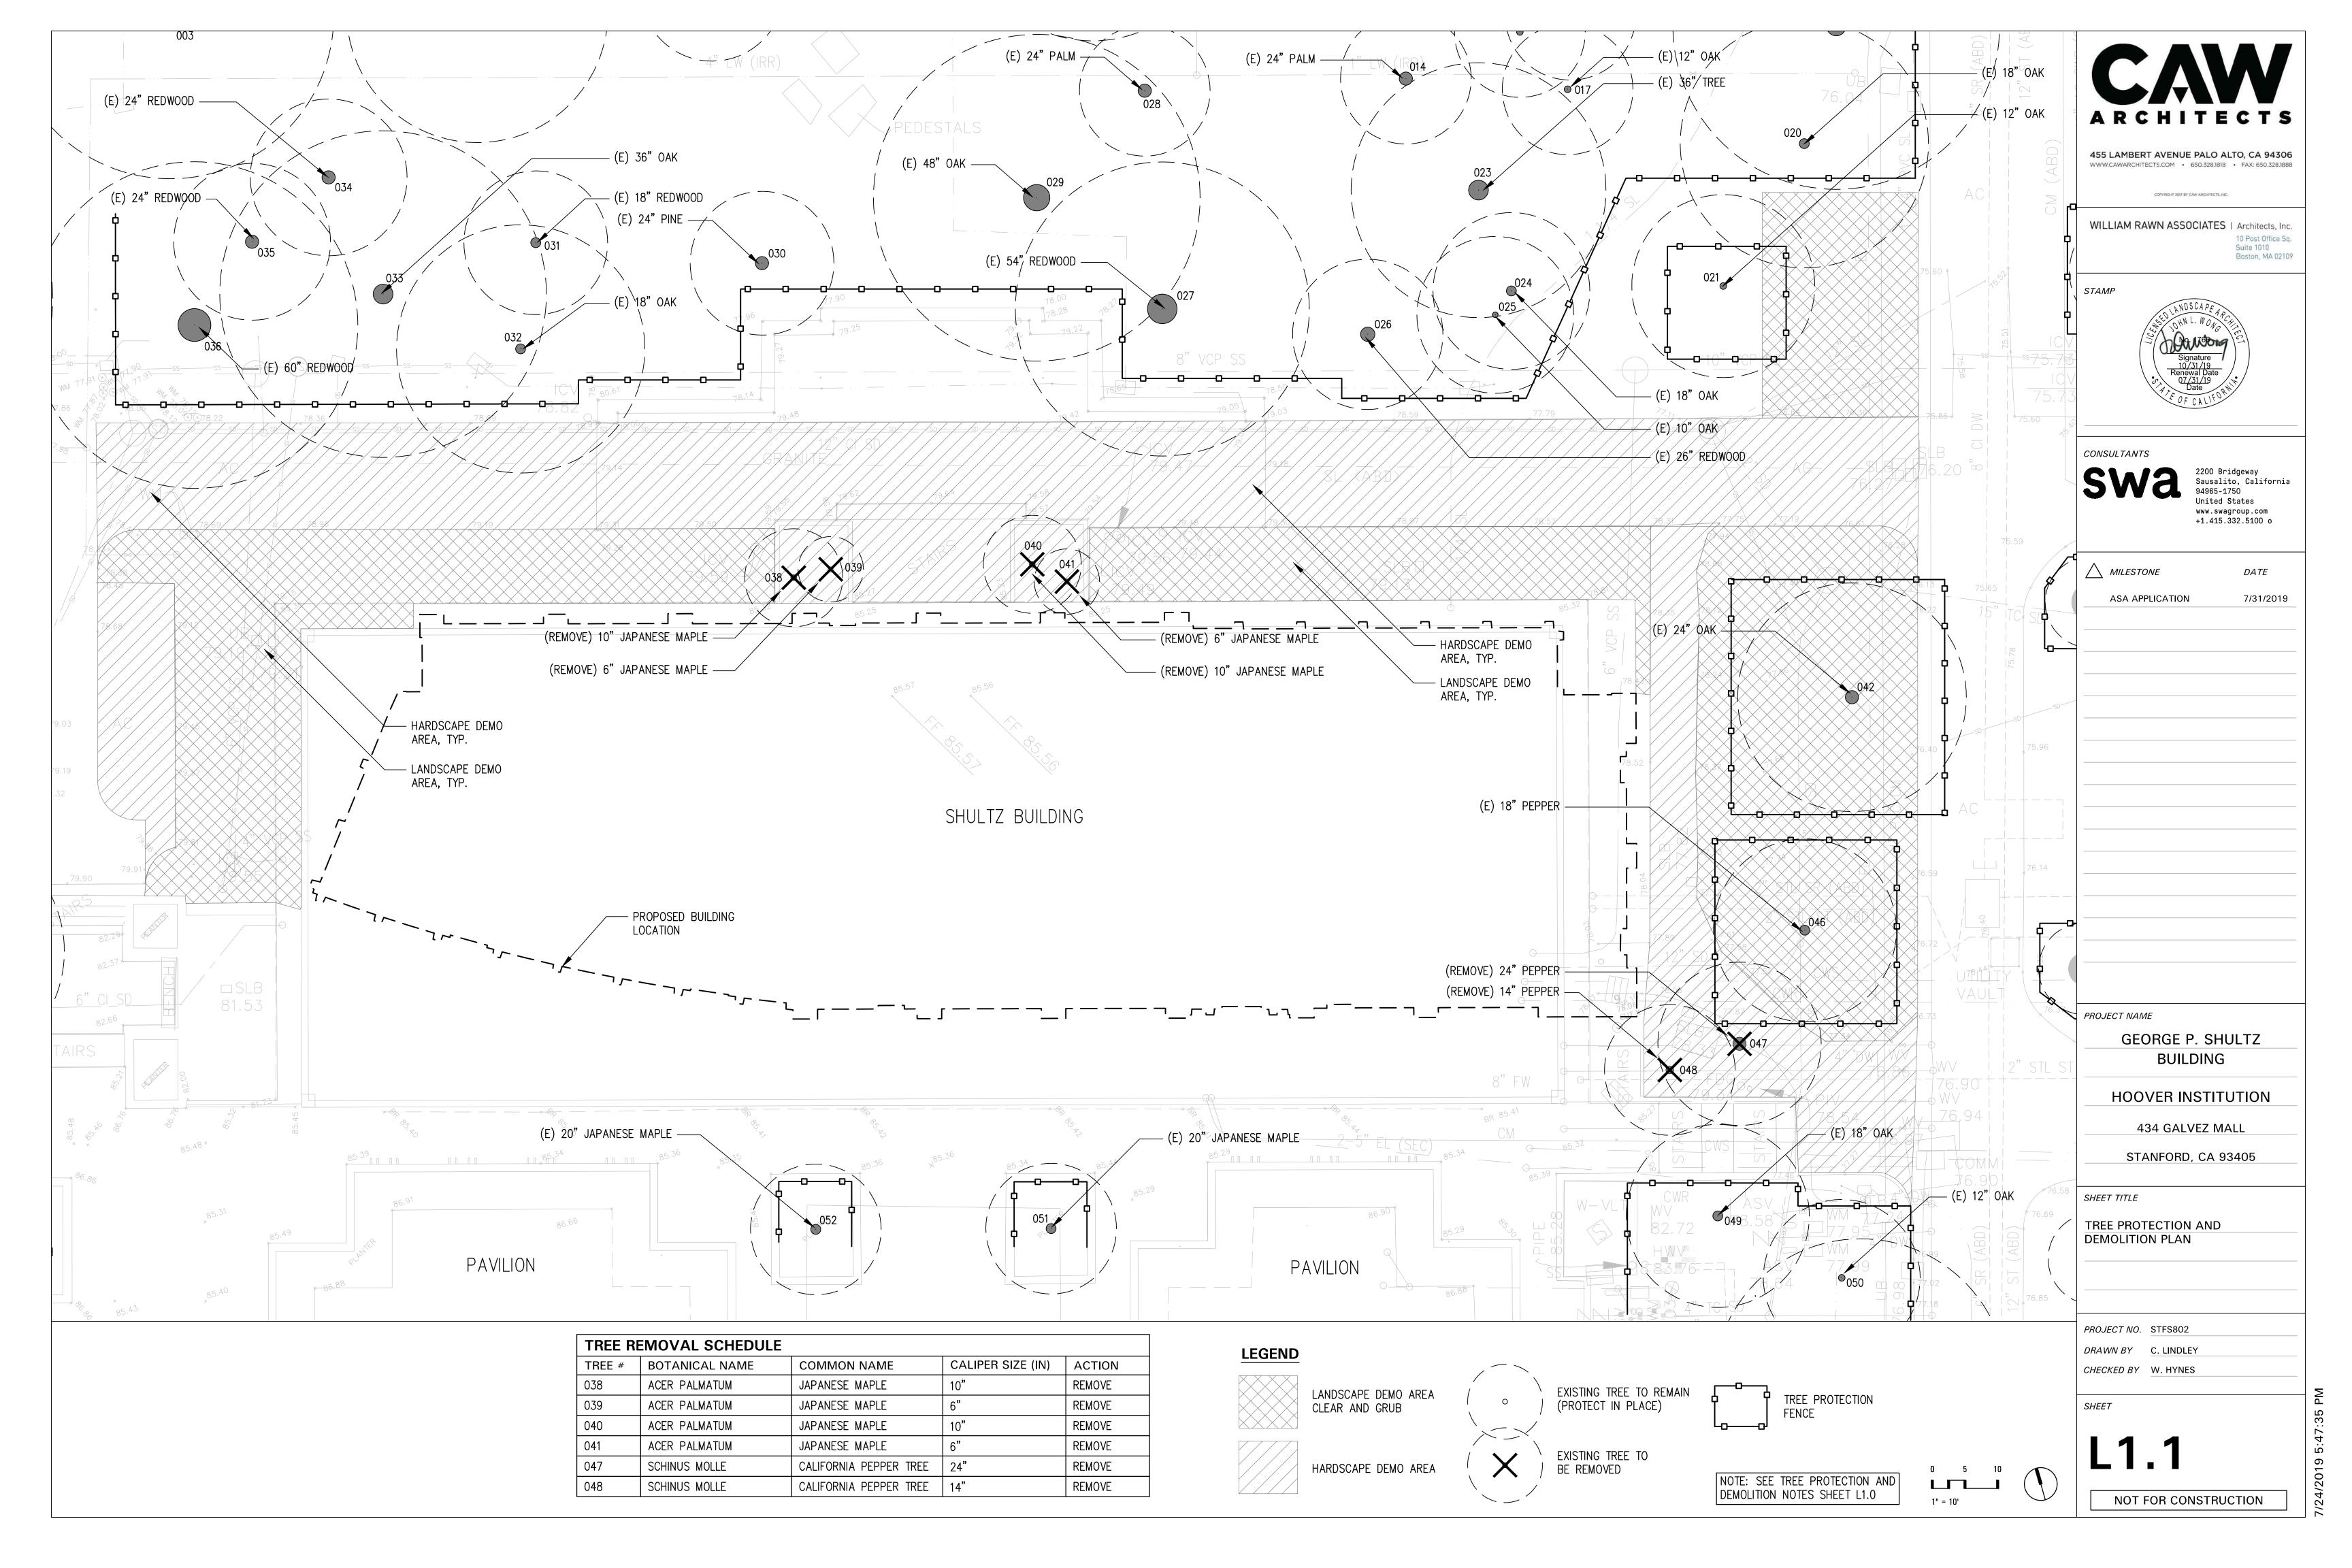
SHEET TITLE

TREE PROTECTION AND DEMOLITION NOTES

PROJECT NO. STFS802 DRAWN BY C. LINDLEY

CHECKED BY W. HYNES

SHEET



ABBREVIATIONS

SYM	DESCRIPTION
BLDG	BUILDING
BS	BOTTOM OF STAIR
CL	CENTER LINE
(E)	EXISTING ELEMENT
EJ	EXPANSION JOINT
EQ	EQUAL
(ER)	ORIGINAL LOCATION OF ELEMENT TO BE RELOCATED
FFE	FINISH FLOOR ELEVATION
FG	FINISH GRADE (PLANTING)
FS	FINISH SURFACE (HARDSCAPE)
(N)	NEW
N/A	NOT APPLICABLE
(NR)	LOCATION OF RELOCATED ELEMENT
O.C.	ON CENTER
P.A.	PLANTING AREA

SYM	DESCRIPTION			
P.O.B.	POINT OF BEGINNING			
S.A.D.	SEE ARCHITECTURAL DRAWINGS			
S.C.D.	SEE CIVIL DRAWINGS			
S.L.D.	SEE LIGHTING CONSULTANT'S DRAWINGS			
S.S.	STAINLESS STEEL			
S.S.D.	SEE STRUCTURAL DRAWINGS			
S.U.	STANFORD UNIVERSITY			
TBD	TO BE DETERMINED			
TS	TOP OF STAIR			
TW	TOP OF WALL			
TYP.	TYPICAL			
U.O.N.	UNLESS OTHERWISE NOTED			

SITE PLAN NOTES

- LOCATION OF ALL ABOVE GROUND ELEMENTS TO BE REVIEWED AND APPROVED BY LANDSCAPE ARCHITECT OR STANFORD REPRESENTATIVE.
- 2. PROPOSED ELEMENTS, INCLUDING UTILITIES, LOCATED AMONG EXISTING TREES SHALL BE REVIEWED IN FIELD WITH LANDSCAPE ARCHITECT AND STANFORD ARBORIST PRIOR TO EXCAVATING.
- 3. PROVIDE 4'X4' SQUARE MOCKUPS FOR ALL CONCRETE
- FLATWORK FOR REVIEW AND APPROVAL

 4. PROVIDE 6'X6' SQUARE MOCKUPS FOR PRECAST
- PAVING FOR REVIEW AND APPROVAL.

 5. PROVIDE MOCKUP OF 4' LONG SECTION OF STEPS
- WITH CONTRASTING STRIPE FOR REVIEW AND APPROVAL.

 6. TRASH AND RECYCLE BINS TO BE DETERMINED AND
- WILL BE LOCATED BY LANDSCAPE ARCHITECT OR STANFORD REPRESENTATIVE PRIOR TO ORDERING OR INSTALLATION.
- 7. ALL EXISTING AND PROPOSED ASPHALT, MULCH AND AGGREGATE PATHS TO HAVE METAL HEADERS.
- 8. TAKE ALL DIMENSIONS PERPENDICULAR TO ANY REFERENCE LINE, WORK LINE, FACE OF BUILDING, FACE OF WALL, OR CENTERLINE, AS INFERRED ON DRAWINGS.

- 9. ALL WORK PERFORMED WITHIN THE DRIP LINE OF TREES DESIGNATED "EXISTING TREES TO REMAIN" SHALL BE DONE BY HAND LABOR.
- 10. ALL ANGLES TO BE 90 DEGREES UNLESS OTHERWISE NOTED. MAINTAIN HORIZONTAL ALIGNMENT OF ADJACENT ELEMENTS AS NOTED ON DRAWINGS.
- 11. HOLD TOPS OF WALLS AND FENCES LEVEL UNLESS
 OTHERWISE NOTED
- 12. REFERENCE TO NORTH REFERS TO TRUE NORTH, REFERENCE TO SCALE IS FOR FULL-SIZED DRAWINGS ONLY. DO NOT SCALE FROM REDUCED DRAWINGS.
- 13. DIMENSIONS TAKE PRECEDENCE OVERS SCALES SHOWN ON DRAWINGS.
- 14. NOTES AND DETAILS ON SPECIFIC DRAWINGS TAKE PRECEDENCE OVER GENERAL NOTES AND TYPICAL DETAILS
- 15. DO NOT INSTALL ANY WORK ON STRUCTURE PRIOR TO REVIEW OF WATERPROOFING BY ARCHITECT.
- 16. ALL CONCRETE SLABS, RAMPS, OR STEP FOOTINGS SHALL BE DOWELED INTO ABUTTING WALLS, FOUNDATIONS AND FOOTINGS USING BARS OF THE SAME SIZE AND SPACING UNLESS OTHERWISE NOTED.

CAV

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swa

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DATE

ASA APPLICATION 7/31/2019

PROJECT NAME

GEORGE P. SHULTZ BUILDING

HOOVER INSTITUTION

434 GALVEZ MALL

STANFORD, CA 93405

SHEET TITLE

MATERIAL SCHEDULE AND NOTES

PROJECT NO. STFS802

DRAWN BY C. LINDLEY

CHECKED BY W. HYNES

OUEET

L2.0


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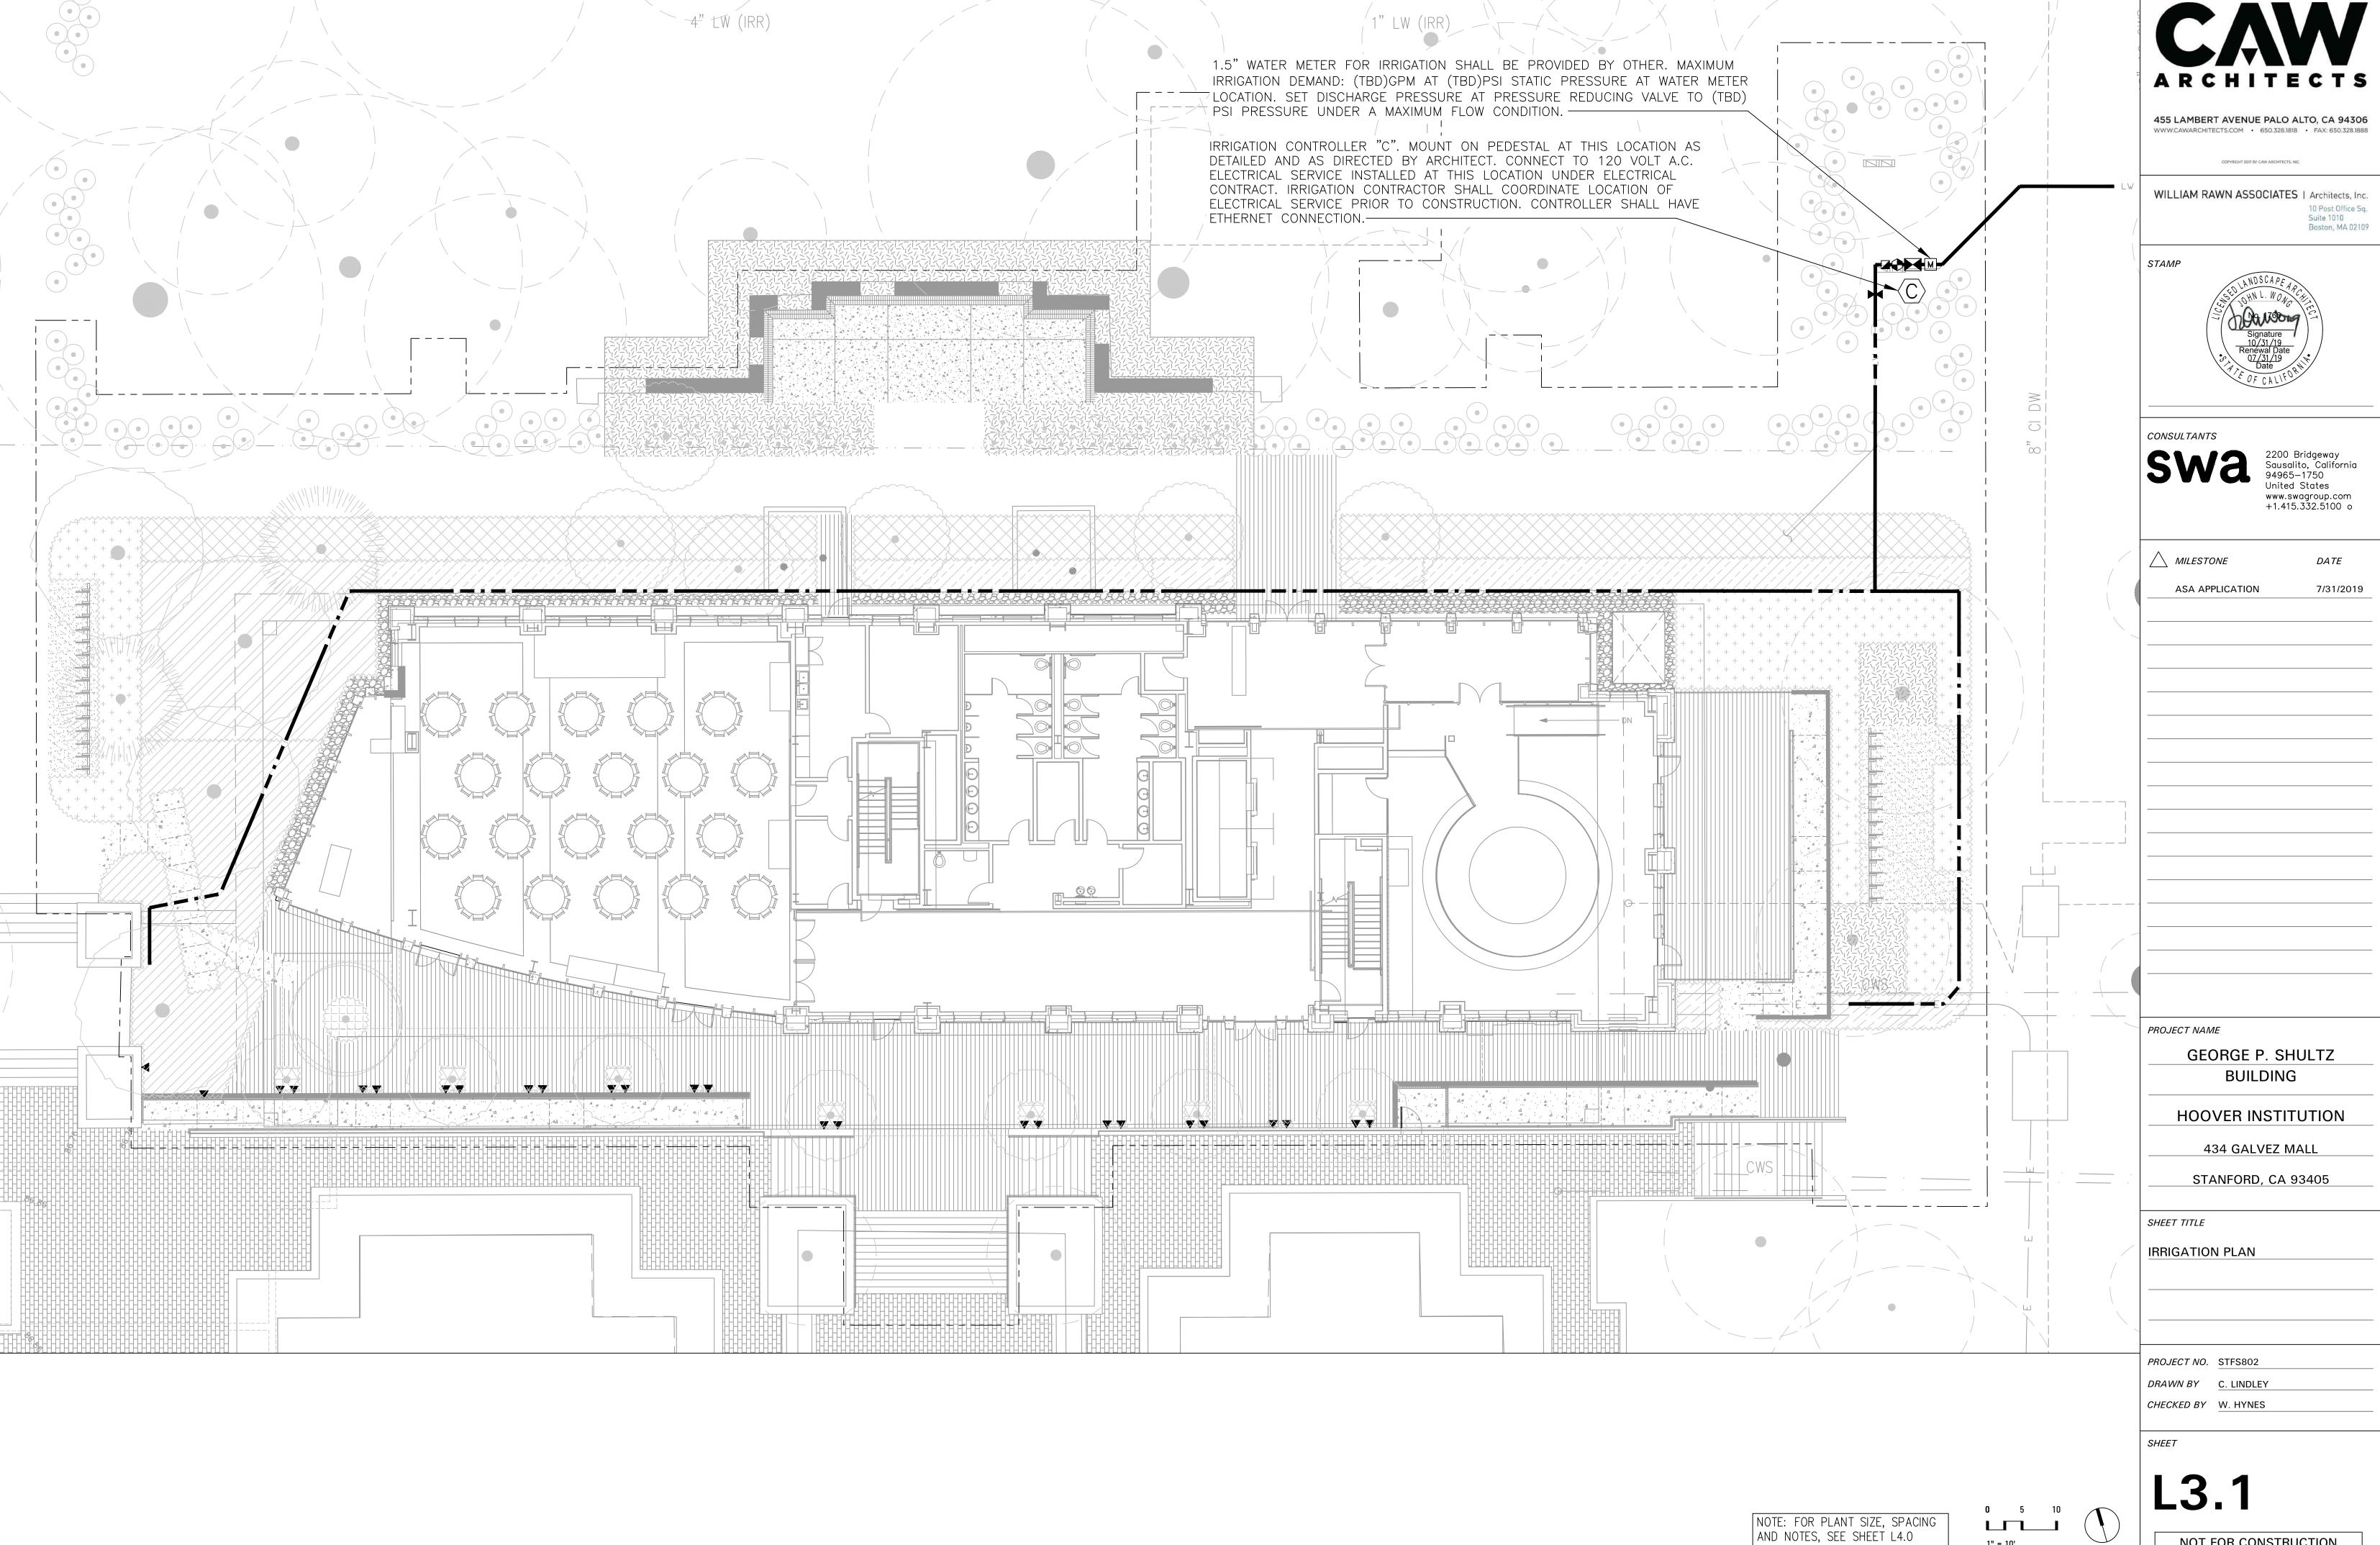
MATERIAL SCHEDULE

PAVING SCHEDULE (P)								
CODE	DESCRIPTION	MATERIAL	SUPPLIER	SIZE	COLOR	FINISH	JOINT	REMARK
P01	PRECAST PAVERS (PERVIOUS)	PRECAST CONCRETE	STEPSTONE - CALARC	12" X 24" X 2"	TBD	SANDBLAST	1/4"	_
P02	PRECAST PAVERS (NON-PERVIOUS)	PRECAST CONCRETE	STEPSTONE - CALARC	12" X 24" X 2"	TBD	SANDBLAST	1/16"	_
P03	DECOMPOSED GRANITE	CRUSHED AGGREGATE	TMT ENTERPRISES, INC.	1/4"	FELTON GOLD	_	_	STABILIZED USE BINDER PER SPECIFICATIONS
P04	ASPHALT PAVING	ASPHALT	T-	PER PLAN	_	_	_	_
P05	LANDSCAPE MULCH	BARK MULCH	BFI ORGANICS	2" SCREENED	DARK BROWN	_	_	_
P06	GRAVEL	GRANITE	TMT ENTERPRISES, INC.	3/4"	FELTON GOLD	ANGULAR	_	_
P07	CONCRETE FLATWORK	INTEGRAL COLOR CONCRETE	DAVIS COLOR	PER PLAN	PALOMINO - 5447	BROOM	SAWCUT - SEE DETAIL	_

LIGHTING SCHEDULE (L)							
CODE	DESCRIPTION	MATERIAL	SUPPLIER	SIZE	COLOR	FINISH	REMARK
L01	NEW GLOBE LIGHT	POLE: STEEL/CAST IRON GLOBE: ACRYLIC	ANTIQUE STREET LAMPS	POLE: 10' HEIGHT GLOBE: 16" DIAMETER	POLE: BLACK GLOBE: OPAL WHITE	POLE: POWDER COAT	S.L.D.
L02	BOLLARD LIGHT	ALUMINUM	BEGA	2'-7 1/2" HEIGHT	BLACK (BLK)	POWDER COAT	S.L.D.; PRODUCT 99852/99620
L03	WALL MOUNTED DOWNLIGHT	ALUMINUM	BEGA	12 1/2" X 2 3/4"	BLACK (BLK)	POWDER COAT	S.L.D.; PRODUCT 24065
L04	LIGHTED HANDRAIL	EXTRUDED ALUMINUM	COLE LIGHTING	1.66" DIAMETER	BLACK	POWDER COAT	S.L.D.
EX	EXISTING GLOBE LIGHT — REMAIN	N/A	N/A	N/A	N/A	N/A	
ER	EX. RELOCATED GLOBE LIGHT	N/A	N/A	N/A	N/A	N/A	
NR	NEW RELOCATED GLOBE LIGHT	N/A	N/A	N/A	N/A	N/A	RE-LAMP (E) WITH LED SOURCE

AMEN	AMENITY SCHEDULE (A)									
CODE	DESCRIPTION	MATERIAL	SUPPLIER	PRODUCT	SIZE	COLOR	FINISH	REMARKS		
A01	BIKE RACK	STEEL	SCH ENTERPRISES, LLC.	LR-P SERIES	VARIES, PER PLAN	BLACK	PFS THERMOPLASTIC	-		
A02	PATIO SEATING	ALUMINUM	LANDSCAPE FORMS	CHIPMAN 27" DINING	27" X 29"H	TBD	POWDER COAT	(4) CHIPMAN CHAIRS		
A03	METAL HEADER	STEEL	J.D. RUSSELL COMPANY	HEAVY DUTY DURAEDGE	1/4" X 5"	BLACK	POWDER COATED	USE 3/16" X 16" STAKES		



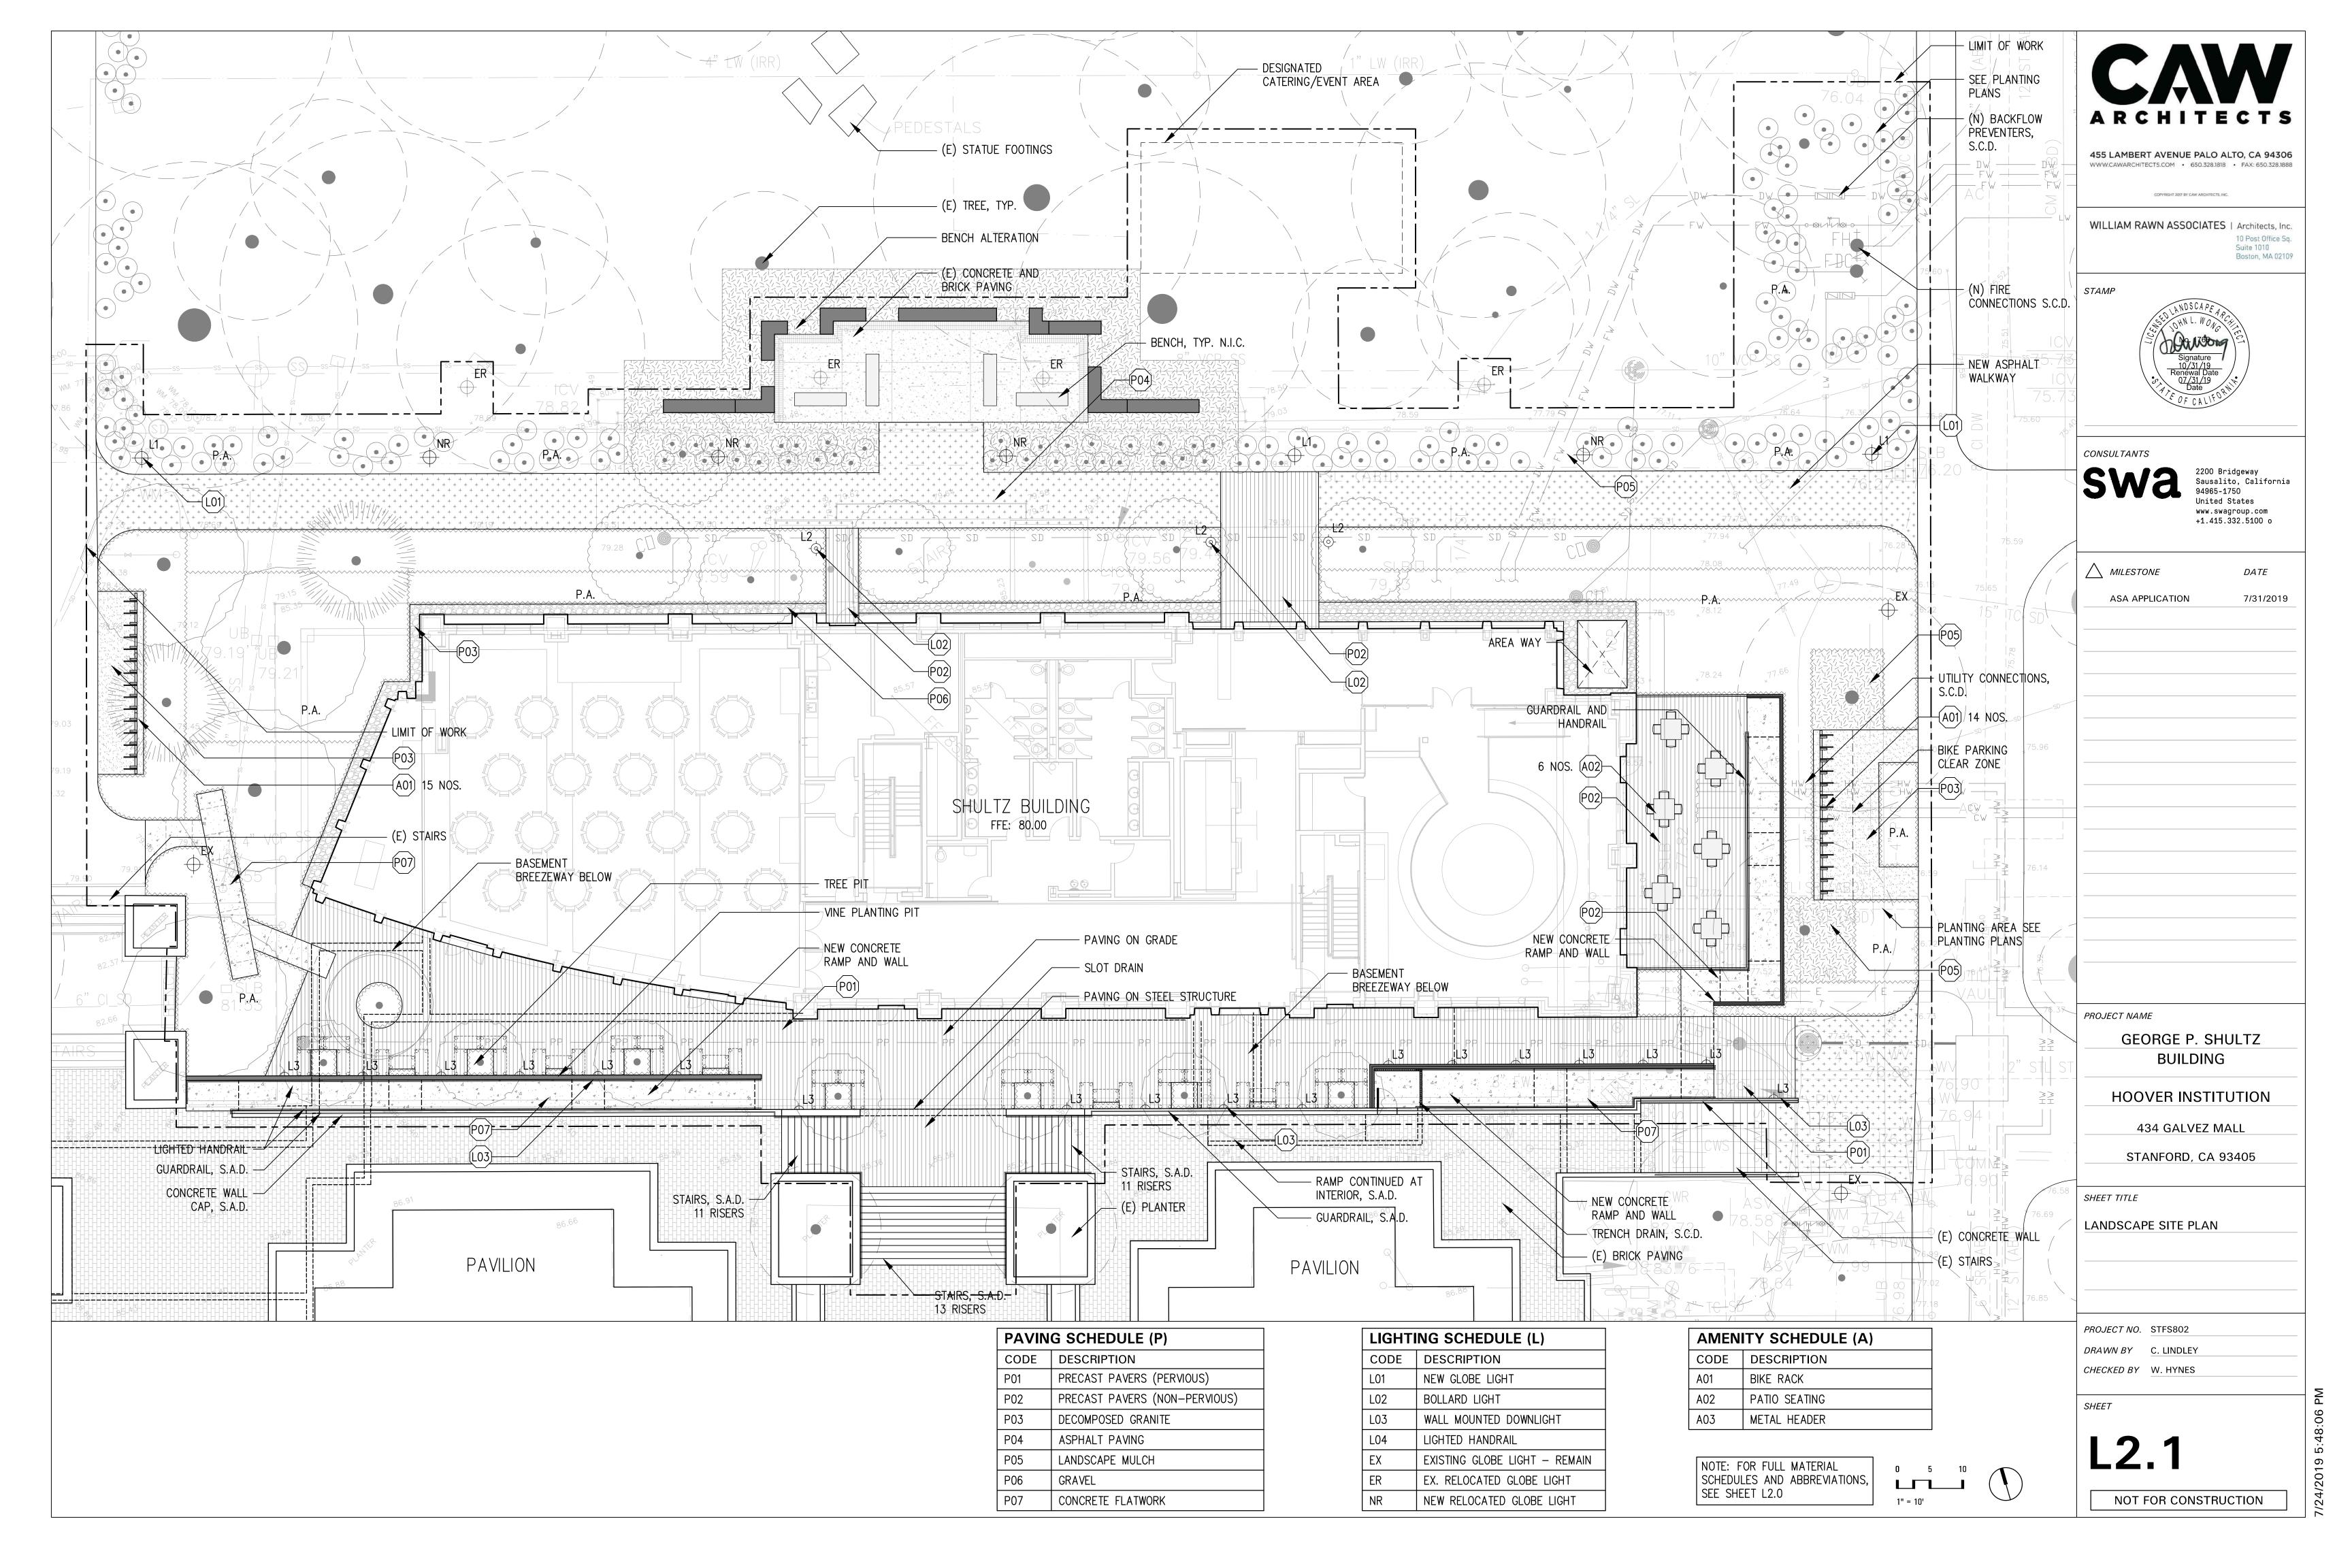

IRRIGATION NOTES

- THESE IRRIGATION DRAWINGS ARE DIAGRAMMATIC AND INDICATIVE OF THE WORK TO BE INSTALLED. ALL PIPING, VALVES, AND OTHER IRRIGATION COMPONENTS MAY BE SHOWN WITHIN PAVED AREAS FOR GRAPHIC CLARITY ONLY AND ARE TO BE INSTALLED WITHIN PLANTING AREAS. DUE TO THE SCALE OF THE DRAWINGS, IT IS NOT POSSIBLE TO INDICATE ALL OFFSETS, FITTINGS, SLEEVES, CONDUIT, AND OTHER ITEMS WHICH MAY BE REQUIRED. INVESTIGATE THE STRUCTURAL AND FINISHED CONDITION AFFECTING THE CONTRACT WORK INCLUDING OBSTRUCTIONS, GRADE DIFFERENCES OR AREA DIMENSIONAL DIFFERENCES. IN THE EVENT OF FIELD DISCREPANCY WITH CONTRACT DOCUMENTS, PLAN THE INSTALLATION WORK ACCORDINGLY BY NOTIFICATION AND APPROVAL OF THE OWNER'S AUTHORIZED REPRESENTATIVE AND ACCORDING TO THE CONTRACT SPECIFICATIONS. NOTIFY AND COORDINATE IRRIGATION CONTRACT WORK WITH APPLICABLE CONTRACTORS FOR THE LOCATION AND INSTALLATION OF PIPE, CONDUIT OR SLEEVES THROUGH OR UNDER WALLS, ROADWAYS, PAVING AND STRUCTURES BEFORE CONSTRUCTION. IN THE EVENT THESE NOTIFICATIONS ARE NOT PERFORMED, THE CONTRACTOR ASSUMES FULL RESPONSIBILITY FOR REQUIRED REVISIONS.
- THE CONTRACTOR SHALL COMPLY WITH ALL APPLICABLE CODES, STANDARDS, AND REGULATIONS. ALL WORK AND MATERIALS SHALL BE IN FULL ACCORDANCE WITH THE LATEST RULES AND REGULATIONS OF THE NATIONAL ELECTRIC CODE; THE UNIFORM PLUMBING CODE, PUBLISHED BY THE WESTERN PLUMBING OFFICIALS ASSOCIATION; AND OTHER STATE OR LOCAL LAWS OR REGULATIONS. NOTHING IN THESE DRAWINGS IS TO BE CONSTRUED TO PERMIT WORK NOT CONFORMING TO THESE CODES OR REGULATIONS. THE CONTRACTOR SHALL FURNISH WITHOUT ANY EXTRA CHARGE, ANY ADDITIONAL MATERIAL AND LABOR WHEN REQUIRED BY THE COMPLIANCE WITH THESE CODES AND REGULATIONS.
- THE CONTRACTOR SHALL COORDINATE INSTALLATION OF IRRIGATION SYSTEM WITH LAYOUT AND INSTALLATION OF THE PLANT MATERIALS TO INSURE THAT THERE WILL BE COMPLETE AND UNIFORM IRRIGATION COVERAGE OF PLANTING IN ACCORDANCE WITH THESE DRAWINGS, AND CONTRACT DOCUMENTS. THE IRRIGATION LAYOUT SHALL BE CHECKED BY THE CONTRACTOR AND OWNER'S AUTHORIZED REPRESENTATIVE PRIOR TO CONSTRUCTION TO DETERMINE IF ANY CHANGES, DELETIONS, OR ADDITIONS ARE REQUIRED. IRRIGATION SYSTEM SHALL BE INSTALLED AND TESTED PRIOR TO INSTALLATION OF PLANT MATERIAL.
- 4. THE INTENT OF THIS IRRIGATION SYSTEM IS TO PROVIDE THE MINIMUM AMOUNT OF WATER REQUIRED TO SUSTAIN GOOD PLANT HEALTH.
- 5. IT IS THE RESPONSIBILITY OF THE MAINTENANCE CONTRACTOR AND/OR OWNER TO PROGRAM THE IRRIGATION CONTROLLER(S) TO PROVIDE THE MINIMUM AMOUNT OF WATER NEEDED TO SUSTAIN GOOD PLANT HEALTH. THIS INCLUDES MAKING ADJUSTMENTS TO THE PROGRAM FOR SEASONAL WEATHER CHANGES, PLANT MATERIAL, WATER REQUIREMENTS, MOUNDS, SLOPES, SUN, SHADE AND WIND EXPOSURE.
- 6. IT IS THE RESPONSIBILITY OF A LICENSED ELECTRICAL CONTRACTOR TO PROVIDE 120 VOLT A.C. (2.5 AMP DEMAND PER CONTROLLER) ELECTRICAL SERVICE TO THE CONTROLLER LOCATION(S). IT IS THE RESPONSIBILITY OF THE IRRIGATION CONTRACTOR TO COORDINATE THE ELECTRICAL SERVICE STUB—OUT TO THE CONTROLLER(S). PROVIDE PROPER GROUNDING PER CONTROLLER MANUFACTURER'S INSTRUCTIONS AND IN ACCORDANCE WITH LOCAL CODES.
- 7. PROVIDE EACH CONTROLLER WITH ITS OWN GROUND ROD. SEPARATE THE GROUND RODS BY A MINIMUM OF EIGHT FEET. THE GROUND ROD SHALL BE AN EIGHT FOOT LONG BY 5/8" DIAMETER U.L. APPROVED COPPER CLAD ROD. INSTALL NO MORE THAN 6" OF THE GROUND ROD ABOVE FINISH GRADE. CONNECT #6 GAUGE WIRE WITH A U.L. APPROVED GROUND ROD CLAMP TO ROD AND BACK TO GROUND SCREW AT BASE OF CONTROLLER WITH APPROPRIATE CONNECTOR. MAKE THIS WIRE AS SHORT AS POSSIBLE, AVOIDING KINKS OR BENDING.
- 8. SCHEDULE A MEETING WHICH INCLUDES
 REPRESENTATIVES OF THE IRRIGATION CONTROLLER
 MANUFACTURER, THE MAINTENANCE CONTRACTOR, THE
 OWNER AND THE IRRIGATION CONTRACTOR AT THE
 SITE FOR INSTRUCTION ON THE PROPER
 PROGRAMMING AND OPERATION OF THE IRRIGATION
 CONTROLLER.
- 9. INSTALL 3" DETECTABLE TAPE ABOVE ALL PRESSURIZED MAIN LINES AS DETAILED. USE CHRISTY MODEL #TA-DT-3-BIRR FOR POTABLE IRRIGATION

- SYSTEMS OR #TA-DT-3-PRW FOR RECYCLED IRRIGATION WATER SYSTEMS.
- 10. PROVIDE EACH IRRIGATION CONTROLLER WITH ITS OWN INDEPENDENT LOW VOLTAGE COMMON GROUND WIRE.
- 11. IRRIGATION CONTROL WIRES: SOLID COPPER WITH U.L. APPROVAL FOR DIRECT BURIAL IN GROUND. COMMON GROUND WIRE: SIZE #12-1 WIRE WITH A WHITE INSULATING JACKET. CONTROL WIRE SERVICING REMOTE CONTROL VALVES: SIZE #14-1 WIRE WITH INSULATING JACKET OF COLOR OTHER THAN WHITE. TRACING WIRE SHALL HAVE A YELLOW INSULATING JACKET. SPLICES SHALL BE MADE WITH 3M-DBY SEAL PACKS OR APPROVED EQUAL.
- 12. INSTALL TWO SPARE CONTROL WIRES OF A DIFFERENT COLOR ALONG THE ENTIRE MAIN LINE. LOOP 36" EXCESS WIRE INTO EACH SINGLE VALVE BOX AND INTO ONE VALVE BOX IN EACH GROUP OF VALVES.
- 13. SPLICING OF LOW VOLTAGE WIRES IS PERMITTED IN VALVE BOXES ONLY. LEAVE A 36" LONG, 1" DIAMETER COIL OF EXCESS WIRE AT EACH SPLICE AND A 36" LONG EXPANSION LOOP EVERY 100 FEET ALONG WIRE RUN. TAPE WIRES TOGETHER EVERY TEN FEET. DO NOT TAPE WIRES TOGETHER WHERE CONTAINED WITHIN SLEEVING OR CONDUIT.
- 14. INSTALL GREEN (LAWN), BLACK (SHRUB/GC/MULCD)
 PLASTIC VALVE BOXES WITH BOLT DOWN, NON HINGED
 COVER MARKED "IRRIGATION". BOX BODY SHALL HAVE
 KNOCK OUTS. ACCEPTABLE VALVE BOX
 MANUFACTURER'S INCLUDE NDS, CARSON OR
 APPROVED EQUAL.
- 15. INSTALL REMOTE CONTROL VALVE BOXES 12" FROM WALK, CURB, BUILDING OR LANDSCAPE FEATURE. AT MULTIPLE VALVE BOX GROUPS, INSTALL EACH BOX AN EQUAL DISTANCE FROM THE WALK, CURB, BUILDING OR LANDSCAPE FEATURE AND PROVIDE 12" BETWEEN BOX TOPS. ALIGN THE SHORT SIDE OF RECTANGULAR VALVE BOXES PARALLEL TO WALK, CURB, BUILDING OR LANDSCAPE FEATURE.
- 16. VALVE LOCATIONS SHOWN ARE DIAGRAMMATIC. INSTALL IN GROUND COVER/SHRUB AREAS (AVOID LAWN AREAS WHERE POSSIBLE).
- 17. THE REMOTE CONTROL VALVES SPECIFIED ON THE DRAWINGS IS A PRESSURE REDUCING TYPE. SET THE DISCHARGE PRESSURE AS FOLLOWS:
- A. SPRAY HEADS=40 PSI
- B. ROTARY HEADS=60 PSI
- C. DRIP EMITTERS=35 PSI
 D. BUBBLERS= 30 PSI
- 18. INSTALL A GATE VALVE TO ISOLATE EACH REMOTE CONTROL VALVE OR GROUP OF RCV'S LOCATED TOGETHER. GATE VALVE SIZE SHALL BE SAME AS THE LARGEST REMOTE CONTROL VALVE IN MANIFOLD.
- 19. FLUSH AND ADJUST IRRIGATION OUTLETS AND NOZZLES FOR OPTIMUM PERFORMANCE AND TO PREVENT OVER SPRAY ONTO WALKS, ROADWAYS, AND/OR BUILDINGS. SELECT THE BEST DEGREE OF THE ARC AND RADIUS TO FIT THE EXISTING SITE CONDITIONS AND THROTTLE THE FLOW CONTROL AT EACH VALVE TO OBTAIN THE OPTIMUM OPERATING PRESSURE FOR EACH CONTROL ZONE.
- 20. SET SPRINKLER HEADS PERPENDICULAR TO FINISH GRADE.
- 21. LOCATE EMITTER OUTLETS ON UPHILL SIDE OF PLANT OR TREE.
- 22. LOCATE BUBBLERS ON UPHILL SIDE OF PLANT OR TREE.
- 23. INSTALL A HUNTER HCV SERIES, KBI CV SERIES, OR APPROVED EQUAL SPRING LOADED CHECK VALVE IN SPRINKLER RISER ASSEMBLIES WHERE LOW OUTLET DRAINAGE WILL CAUSE EROSION AND/OR EXCESS WATER.
- 24. WHERE IT IS NECESSARY TO EXCAVATE ADJACENT TO EXISTING TREES, USE CAUTION TO AVOID INJURY TO TREES AND TREE ROOTS. EXCAVATE BY HAND IN AREAS WHERE TWO (2) INCH AND LARGER ROOTS OCCUR. BACK FILL TRENCHES ADJACENT TO TREE WITHIN TWENTY—FOUR (24) HOURS. WHERE THIS IS NOT POSSIBLE, SHADE THE SIDE OF THE TRENCH ADJACENT TO THE TREE WITH WET BURLAP OR CANVAS.
- 25. NOTIFY LOCAL JURISDICTIONS FOR INSPECTION AND TESTING OF INSTALLED BACKFLOW PREVENTION DEVICE.

- 26. THE IRRIGATION SYSTEM DESIGN IS BASED ON THE MINIMUM OPERATING PRESSURE SHOWN ON THE IRRIGATION DRAWINGS. VERIFY WATER PRESSURE PRIOR TO CONSTRUCTION. REPORT ANY DIFFERENCE BETWEEN THE WATER PRESSURE INDICATED ON THE DRAWINGS AND THE ACTUAL PRESSURE READING AT THE IRRIGATION POINT OF CONNECTION TO THE OWNER'S AUTHORIZED REPRESENTATIVE.
- 27. IRRIGATION DEMAND: REFER TO PLANS.
- 28. THE EXISTING MAIN LINE SHOWN ON THE DRAWINGS IS DIAGRAMMATIC. VERIFY AND LOCATE EXISTING MAIN LINE IN FIELD. REPORT TO ARCHITECT IN WRITING ANY DEVIATION OF EXISTING MAIN LINE LOCATION FROM THAT SHOWN ON THE DRAWINGS.
- 29. PIPE SIZING SHOWN ON THE DRAWINGS IS TYPICAL.
 AS CHANGES IN LAYOUT OCCUR DURING STAKING AND
 CONSTRUCTION THE SIZE MAY NEED TO BE ADJUSTED
 ACCORDINGLY.
- 30. PIPE THREAD SEALANT COMPOUND SHALL BE RECTOR SEAL #5.
- 31. THE LANDSCAPE CONTRACTOR SHALL BE RESPONSIBLE FOR MINOR CHANGES IN THE IRRIGATION LAYOUT DUE TO OBSTRUCTIONS NOT SHOWN ON THE IRRIGATION DRAWINGS SUCH AS LIGHTS, FIRE HYDRANTS, SIGNS, ELECTRICAL ENCLOSURES, ETC.
- 32. THE LANDSCAPE CONTRACTOR SHALL BE RESPONSIBLE FOR CHANGES IN THE IRRIGATION LAYOUT AND VALVE ZONING DUE TO VARIATIONS IN THE EXISTING SITE CONDITIONS SUCH AS EXPOSURE FROM BUILDINGS, TRELLISES, TREES, ETC., AS WELL AS SLOPE AND SOIL CONDITIONS. THE CONTRACTOR SHALL NOTIFY THE LANDSCAPE ARCHITECT AND IRRIGATION CONSULTANT OF THE PROPOSED CHANGES PRIOR TO INSTALLATION FOR APPROVAL.
- 33. THE LANDSCAPE CONTRACTOR IS RESPONSIBLE FOR ADJUSTING THE IRRIGATION SYSTEM DESIGN IF THE PLANTING DESIGN CHANGES FROM THE ORIGINAL PLAN AND NEEDS TO ADAPT TO THE NEW PLANTING DESIGN. THE LANDSCAPE CONTRACTOR NEEDS TO NOTIFY THE LANDSCAPE ARCHITECT AND IRRIGATION CONSULTANT OF PROPOSED CHANGES PRIOR TO INSTALLATION FOR APPROVAL.
- 34. WHEN WORK OF THIS SECTION HAS BEEN COMPLETED AND SUCH OTHER TIMES AS MAY BE DIRECTED, REMOVE ALL TRASH, DEBRIS, SURPLUS MATERIALS AND EQUIPMENT FROM SITE.
- 35. CONTRACTOR SHALL BE RESPONSIBLE FOR SUPPLEMENTAL HAND WATERING OF ALL PLANT MATERIAL WITHIN DRIPLINE AREAS UNTIL THE PLANTS ARE SUFFICIENTLY ESTABLISHED.

NOTE

INSTALL IRRIGATION SYSTEM PER STANFORD UNIVERSITY FACILITIES DESIGN GUIDELINES AND SPECIFICATIONS;

HTTP://MAPS.STANFORD.EDU/FDG_AVAILABLE

1. TREE AND SHRUB PROTECTION (#01532)

2. TRENCHING, BACKFILLING & COMPACTING

(#02321)
3. LANDSCAPE IRRIGATION (#02810)

WELO CALCULATIONS (FUTURE SUBMITTAL)

WATER TYPE	POTABLE											
SITE ETO=	43.4											
	7/5/2019											
REGULAR LANDSCAPE	AREAS											
HYDROZONE #	HYDROZONE NAME	PLANT WATER USE TYPE	PLANT FACTOR (PF)		IRRIGATION EFFICIENCY	ETAF (PF/IE)	AREA (SQ. FT) (HA)	ETAF X AREA (HA)	ETWU (GAL/YR)	ACRE FEET/ YEAR	HCF/ YEAR	PERCENTAGE O LANDSCAPE
1	SHRUBS	LOW	0.2	DRIP	0.81	0.247	3,616	893	24,025	0.07	32.12	40%
2	TREES	LOW	0.2	BUBBLER	0.81	0.247	550	136	3,654	0.01	4.89	6%
3	SHRUBS	MOD	0.5	DRIP	0.81	0.617	4,256	2,627	70,692	0.22	94.51	47%
4	TREES	MOD	0.5	BUBBLER	0.81	0.617	350	216	5,813	0.02	7.77	4%
5	TREES	HIGH	0.8	BUBBLER	0.81	0.988	100	99	2,658	0.01	3.55	1%
6	VINES	MOD	0.5	BUBBLER	0.81	0.617	130	80	2,159	0.01	2.89	1%
			N			TOTALS	9,002	4,051	109,001	0.33	145.72	100%

WATER USE ESTIMATION - STANFORD, HOOVER INSTITUTION, SCHULTZ BUILDING

SPECIAL LANDSCAPE	AREAS	22							190
HYDROZONE #	HYDROZONE NAME								
				1	2		·		0%
				TOTALS					0%
			000000000000000000000000000000000000000						
	GALLONS/Y	75.75	109,002						
MAWA	ACRE FEET/	YR	0.33		MAWA FORMUL			ETWU FORMUL	
	HCF/YR		145.72	MAXIMUI	M APPLIED WATER ALLO GALLONS PER YEA		ESTIMATE	ED TOTAL WATER USE (ET YEAR	WU) GALLONS PER
				MAWA =	E(ETo)(0.62)[(LA x 0.45)) + (0.55 x SLA)]		ETWU= ((ETO)(.62)(ET	AF x LA))
	GALLONS/Y	'R	109,001	ETo = REFERENCE EVAPOTRANSPIRATION		ETo = REFERENCE EVAPOTRANSPIRATION		PIRATION	
ETWU	ACRE FEET/YR		0.33	0.55= ET ADJUSTMENT FACTOR			PF = PLANT FACTOR FOR HYDROZONES		
	HCF/YR		145.72	LA=LANDSCAPED AREA (SQUARE FEET)		HA = HYDROZONE AREA (SQ.FT)			
				0.62 = CON	NVERSION FACTOR (G	ALLONS/SQ.FT/YR)	0.62 = CON	IVERSION FACTOR (GA	LLONS/SQ.FT/YR)
SITE IRRIGATION EFFICIENCY	SITE PLANT FACTOR	MAWA COMPLIANT					IE = IRRIGA	TION EFFICIENCY (0.81)-BUBBLER/DRIP
81.0%	0.36	YES					IE = IRRIGA	TION EFFICIENCY (0.75)-ROTORS/SPRAY
ETAF (Calculations								
REGULAR LANDSC	APE AREAS								
TOTAL ETAF x AREA	4,051								
TOTAL AREA	9,002								
AVG. ETAF	45.00%								



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△ MILESTONE	DATE
ASA APPLICATION	7/31/2019

PROJECT NAME

GEORGE P. SHULTZ
BUILDING

HOOVER INSTITUTION

434 GALVEZ MALL

STANFORD, CA 93405

SHEET TITLE

IRRIGATION NOTES AND WATER CALCULATIONS


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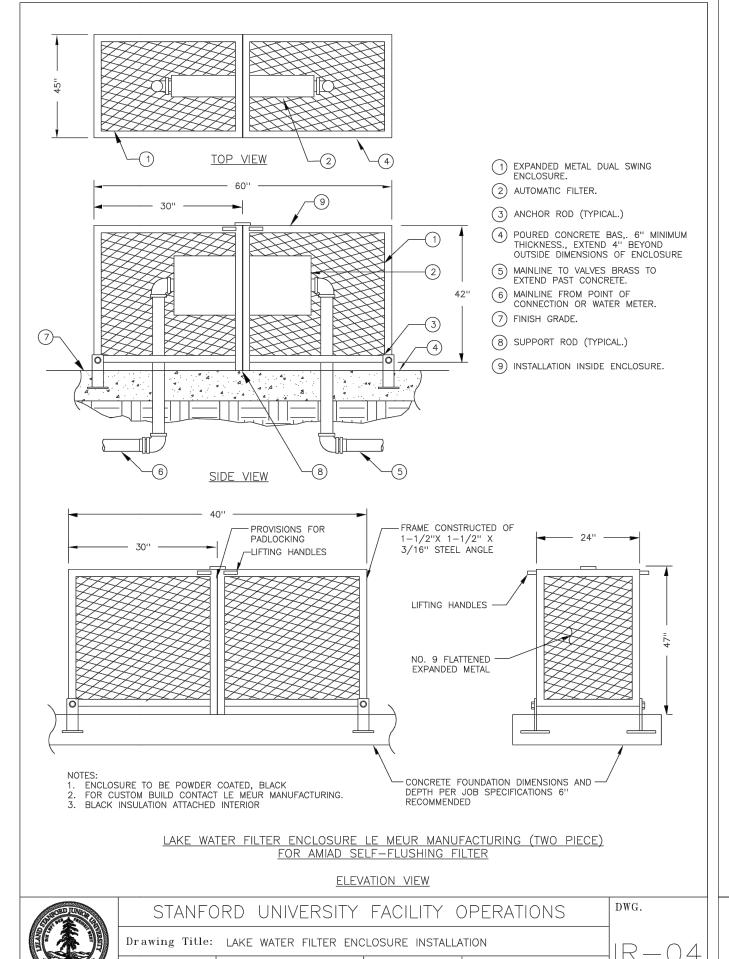
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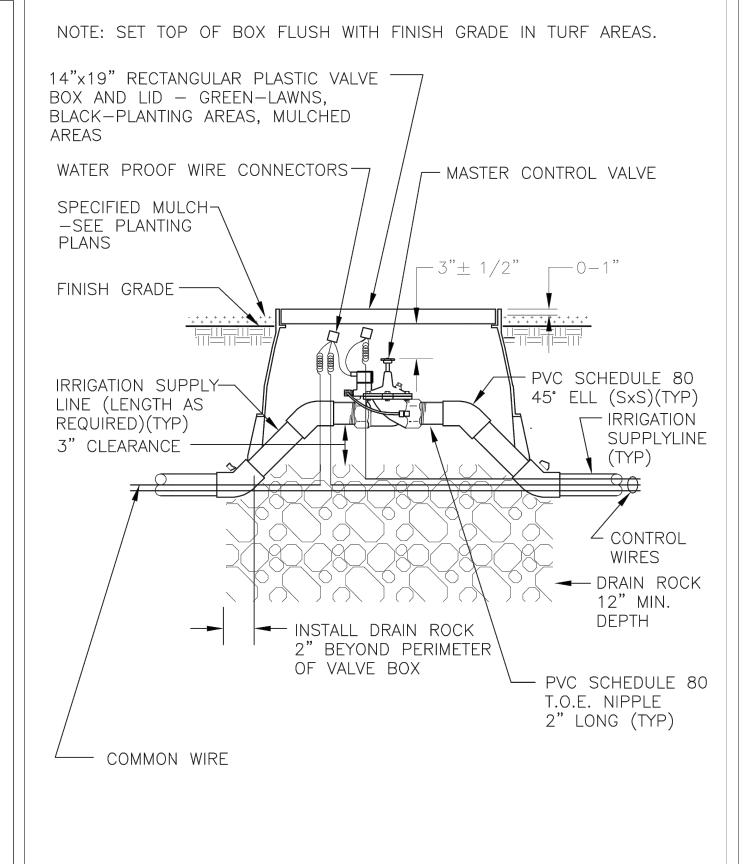
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CHECKED BY W. HYNES








STANFORD UNIVERSITY FACILITY OPERATIONS

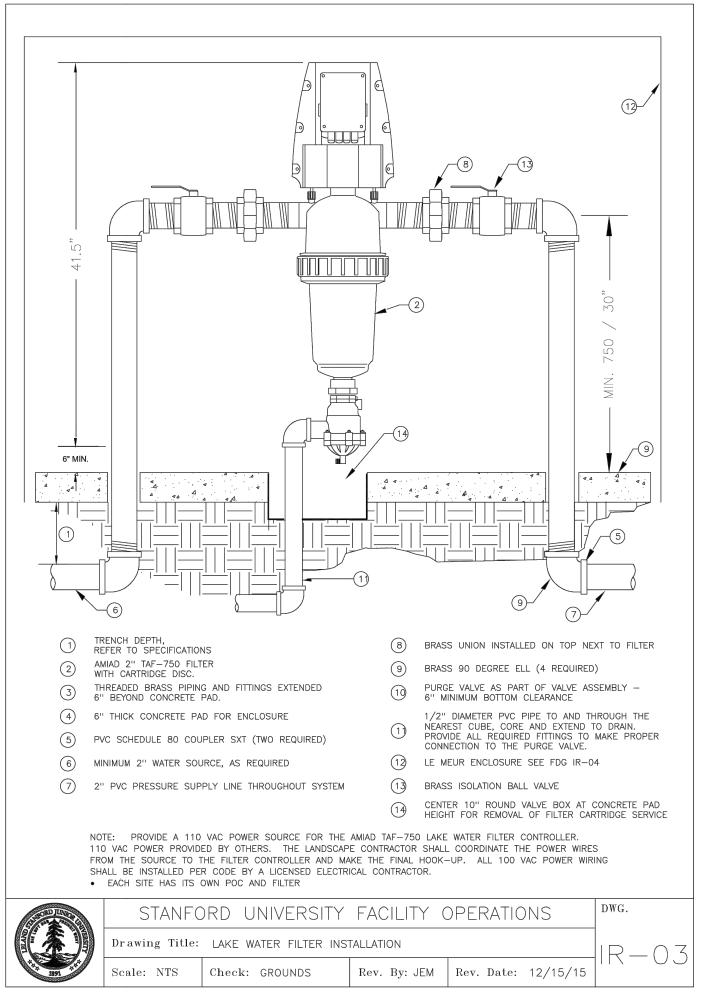NOTE: SET TOP OF BOX FLUSH WITH FINISH GRADE IN TURF AREAS.


Rev. By: 0.G | Rev. Date: 01/08/09

Drawing Title: MASTER CONTROL VALVE INSTALLATION

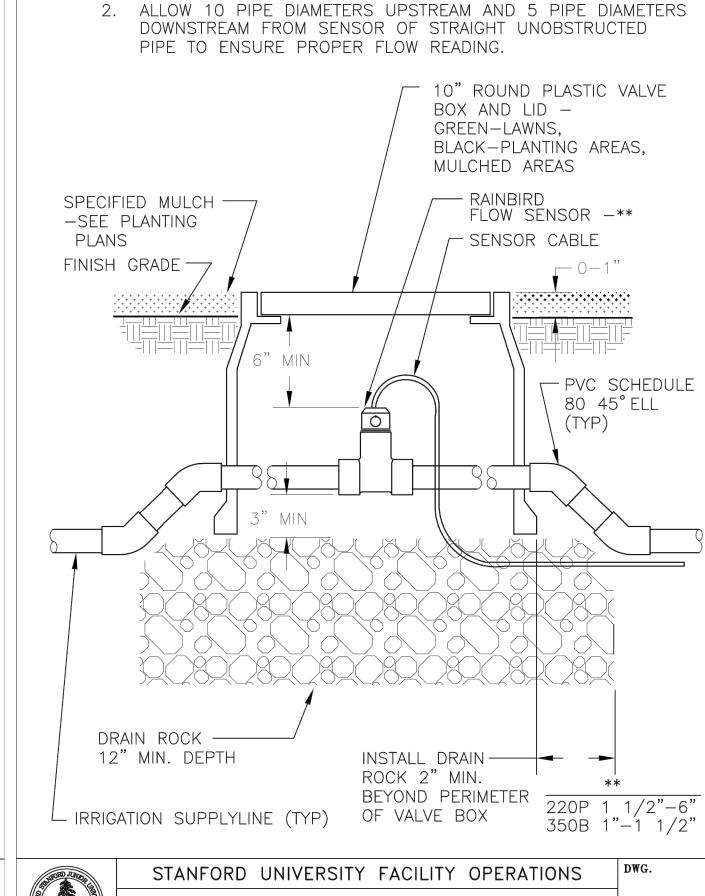



Drawing Title: FLOW SENSOR INSTALLATION


NOTE: 1. SET TOP OF BOX EVEN WITH FINISH GRADE IN TURF AREAS.

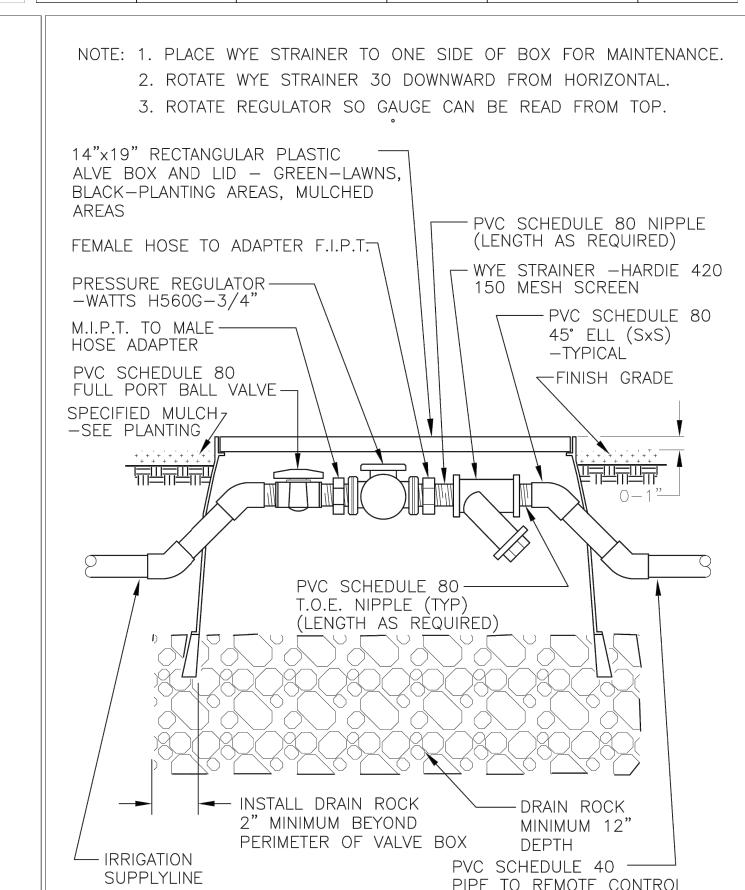

Rev. By: O.G. | Rev. Date: 01/08/09

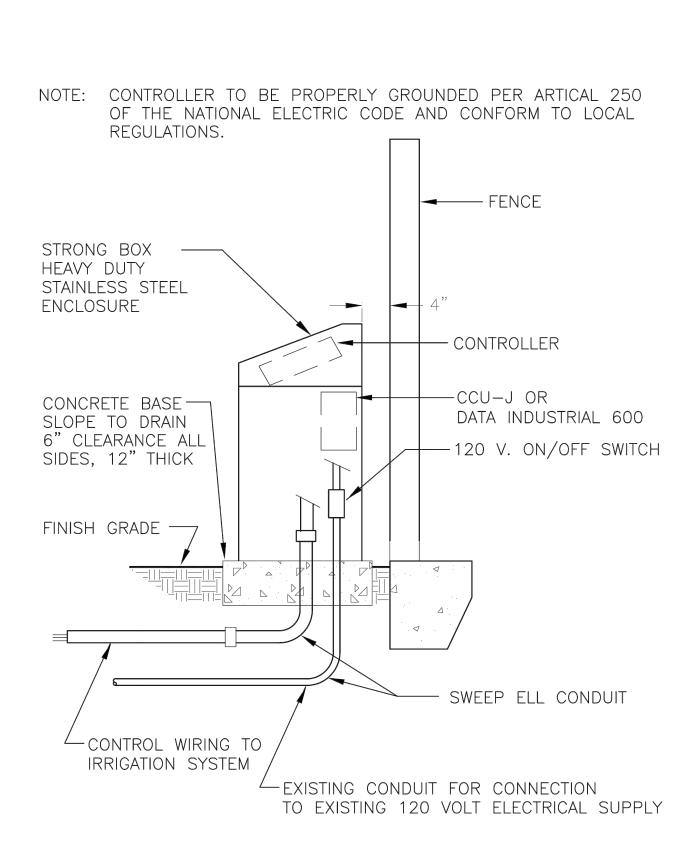

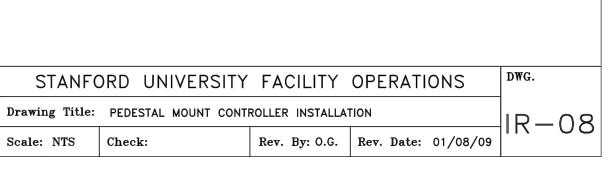

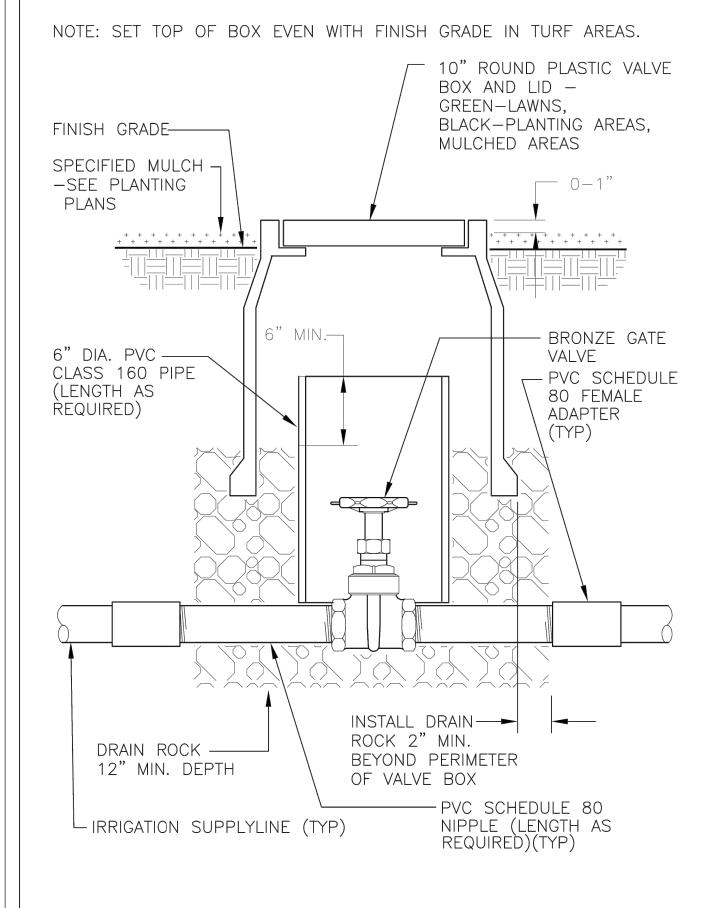


STANFORD UNIVERSITY FACILITY OPERATIONS

Rev. By: O.G. Rev. Date: 01/08/09

Drawing Title: 2 1/2" AND SMALLER GATE VALVE INSTALLATION

Scale: NTS | Check:


Rev. By: OG | Rev. Date: 12/14/15

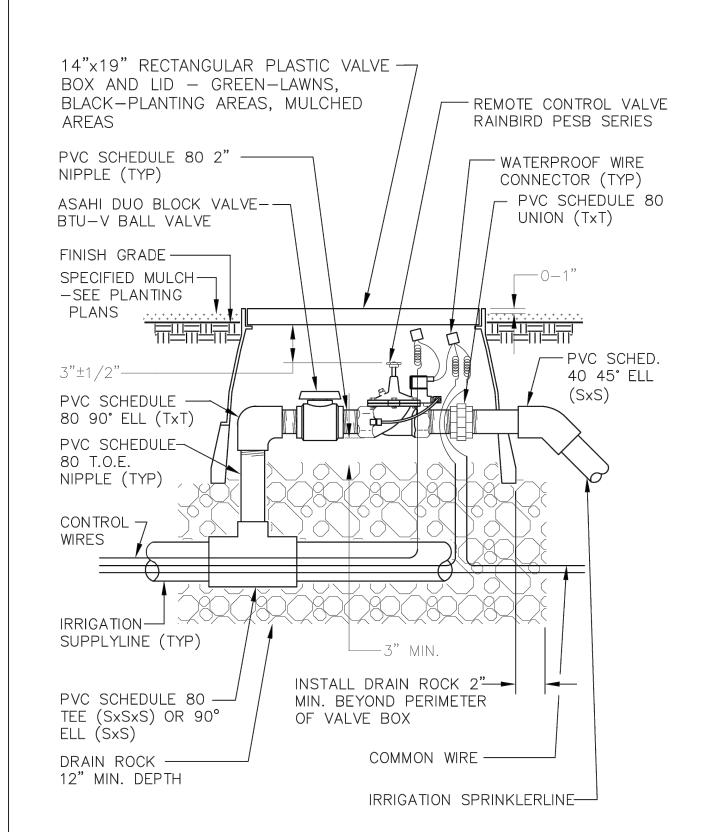


STANFORD UNIVERSITY FACILITY OPERATIONS

Rev. By: O.G. | Rev. Date: 01/07/09

Drawing Title: REMOTE CONTROL VALVE INSTALLATION

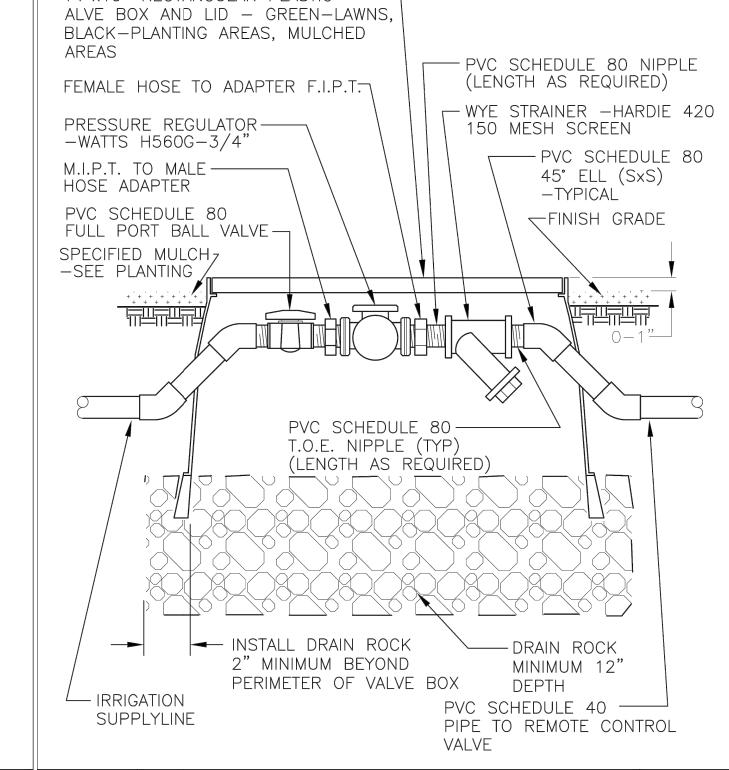

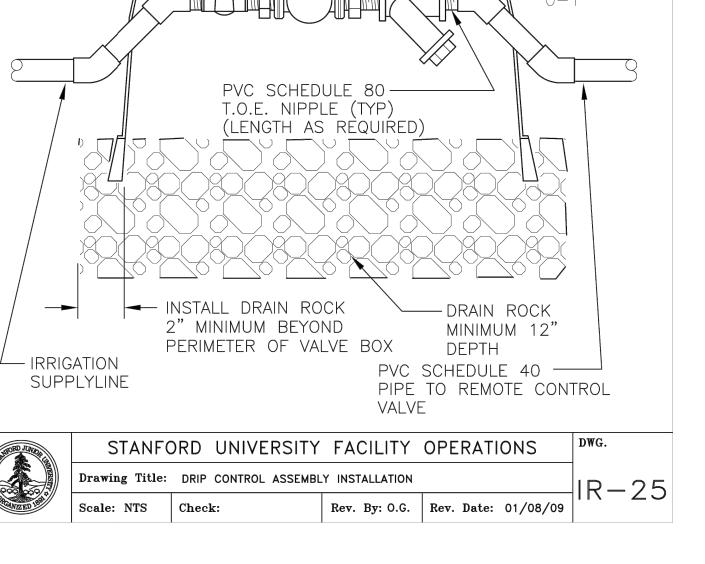



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\triangle	MILESTONE	DATE
	ASA APPLICATION	7/31/2019

+1.415.332.5100 o

PROJECT NAME

GEORGE P. SHULTZ BUILDING

HOOVER INSTITUTION

434 GALVEZ MALL

STANFORD, CA 93405


SHEET TITLE


IRRIGATION DETAILS

PROJECT NO. STFS802 DRAWN BY C. LINDLEY

SHEET

CHECKED BY W. HYNES

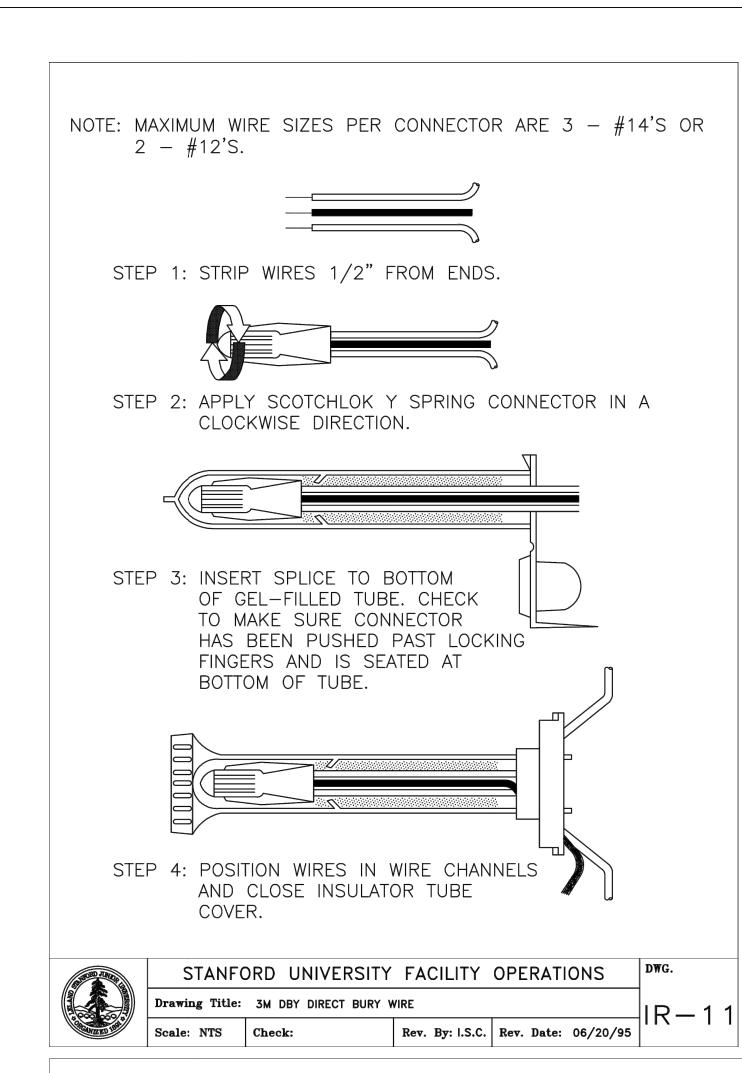

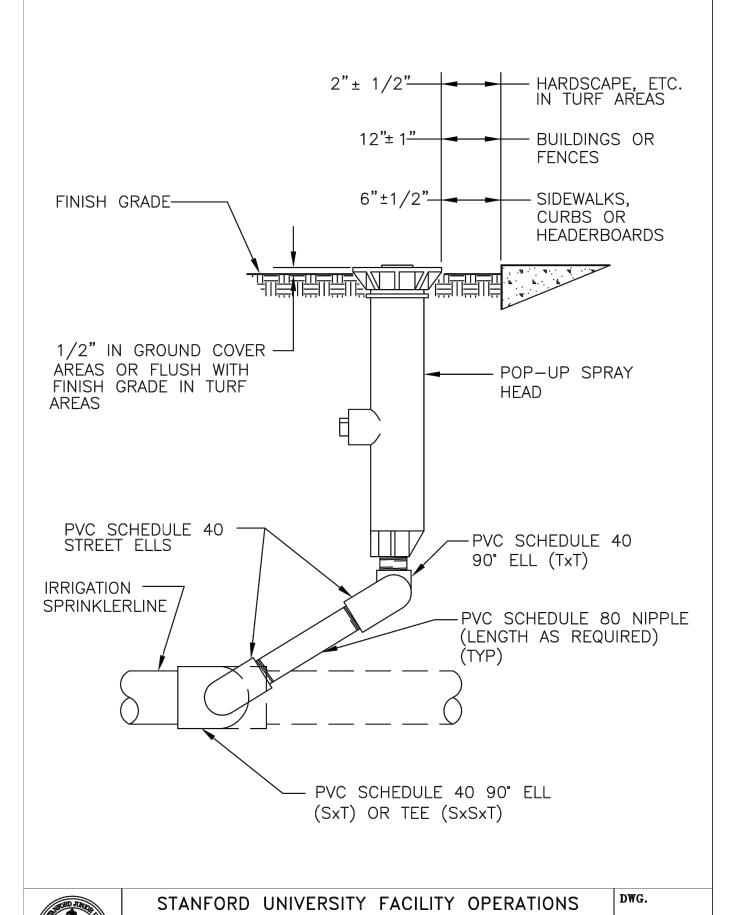

Drawing Title: POP-UP SPRAY HEAD RISER ASSEMBLY

2. SET BOXES IN GROUND COVER/SHRUB AREA WHERE POSSIBLE.


3. SET BOXES PARALLEL TO EACH OTHER, LEVEL AND PERPENDICULAR


Scale: NTS Check:


1. CENTER BOXES OVER VALVES.


IR-18

Rev. By: I.S.C. Rev. Date: 06/20/95

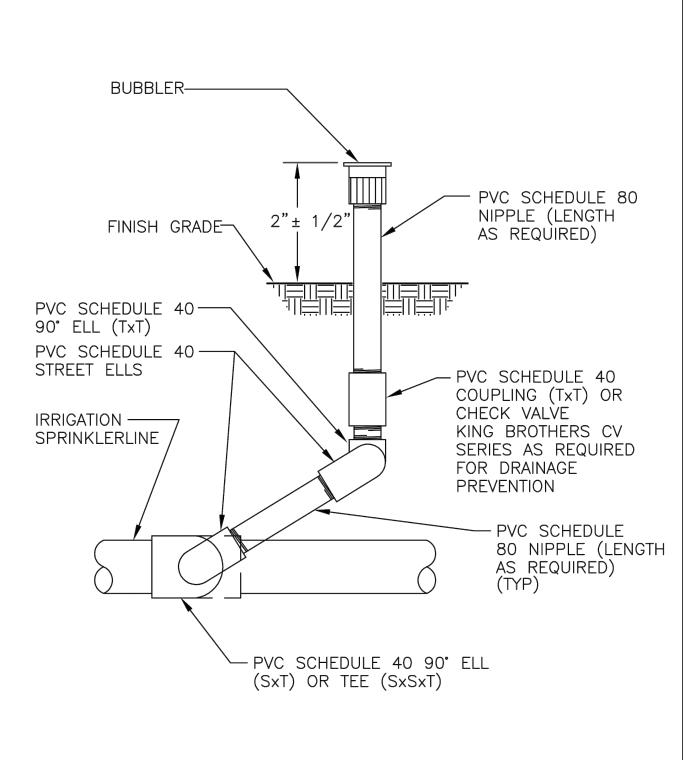

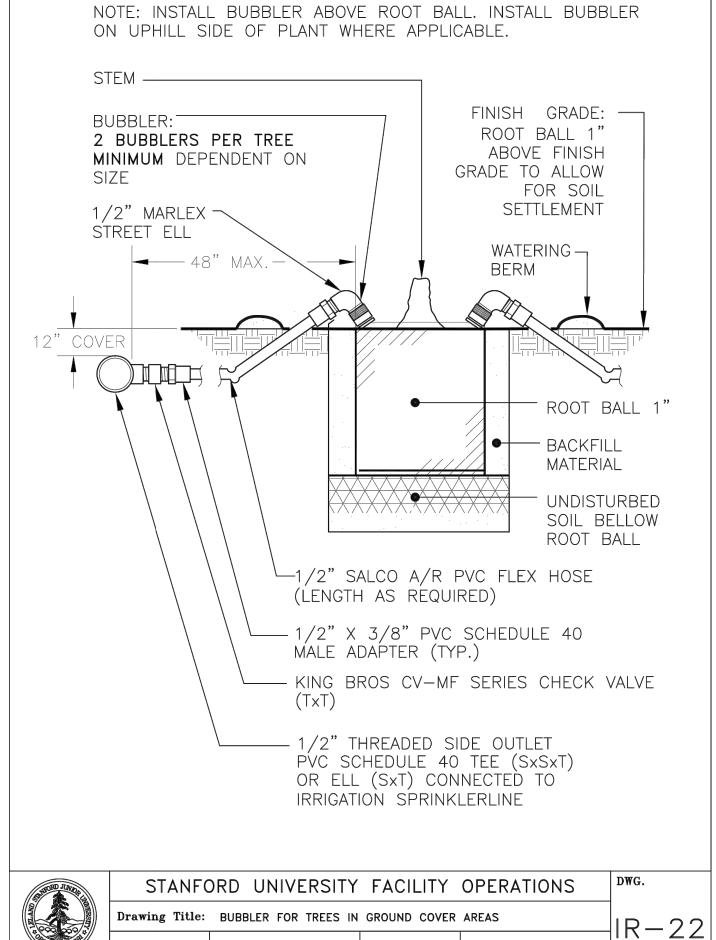

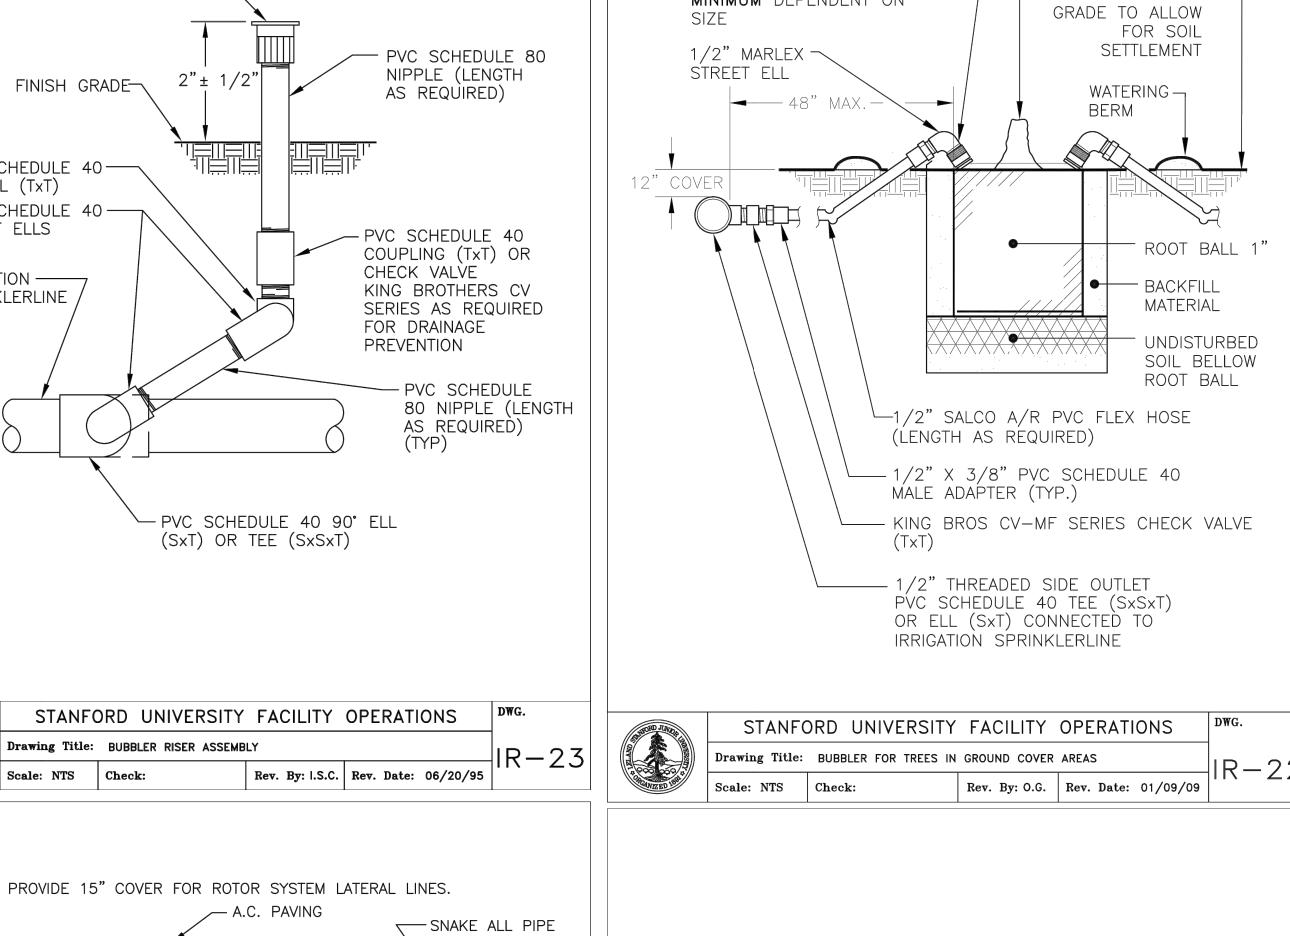

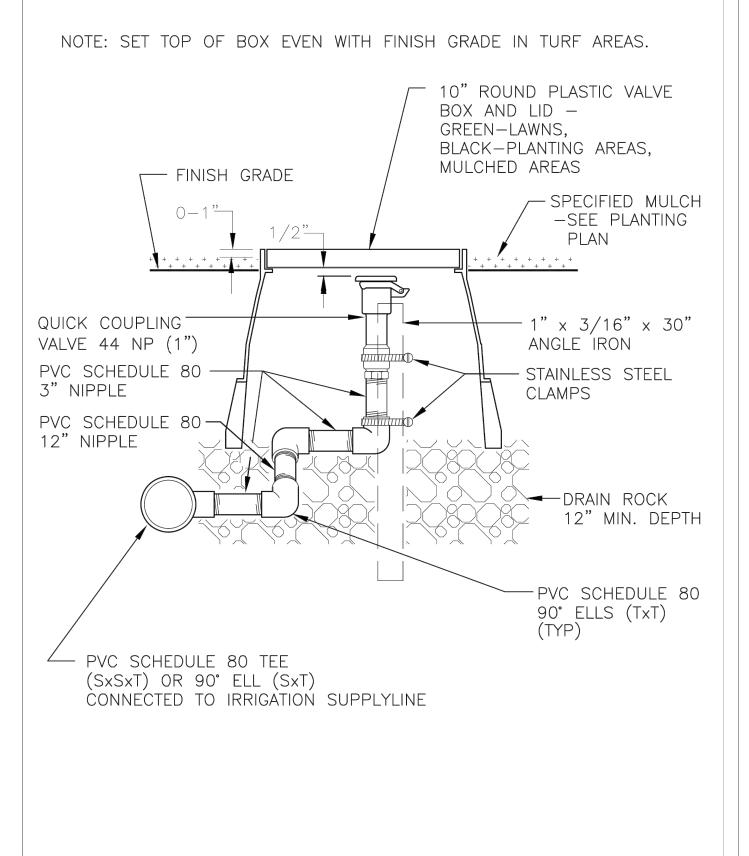



STANFORD UNIVERSITY FACILITY OPERATIONS

Rev. By: O.G. | Rev. Date: 01/08/09

Drawing Title: QUICK COUPLING VALVE INSTALLATION

Scale: NTS | Check:

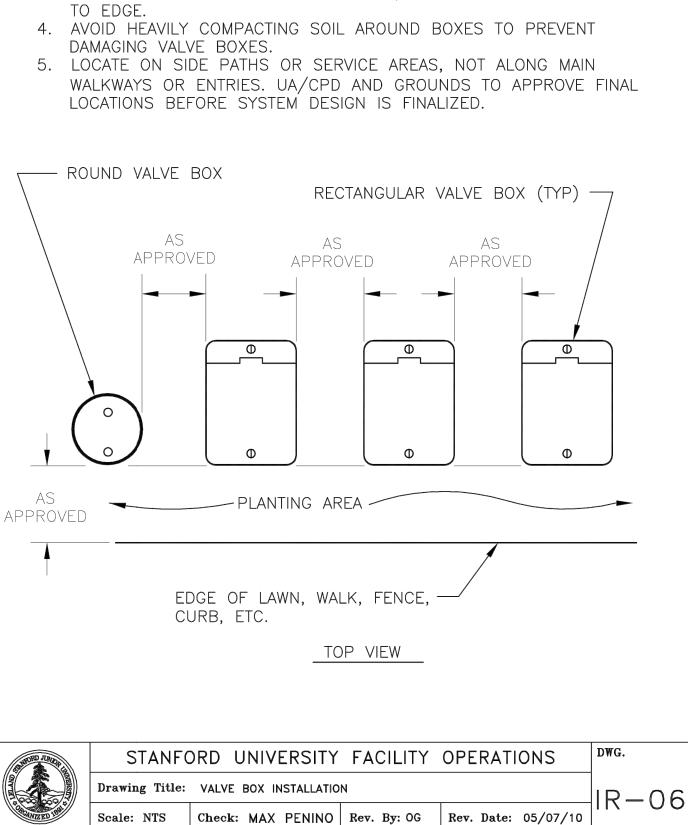

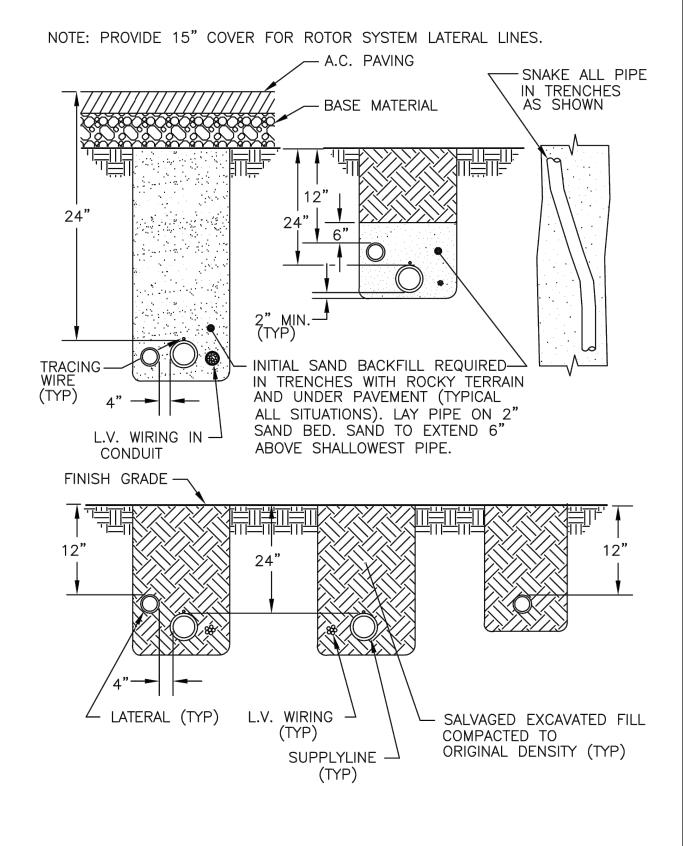


STANFORD UNIVERSITY FACILITY OPERATIONS

Rev. By: I.S.C. Rev. Date: 06/20/95

Drawing Title: TRENCHING


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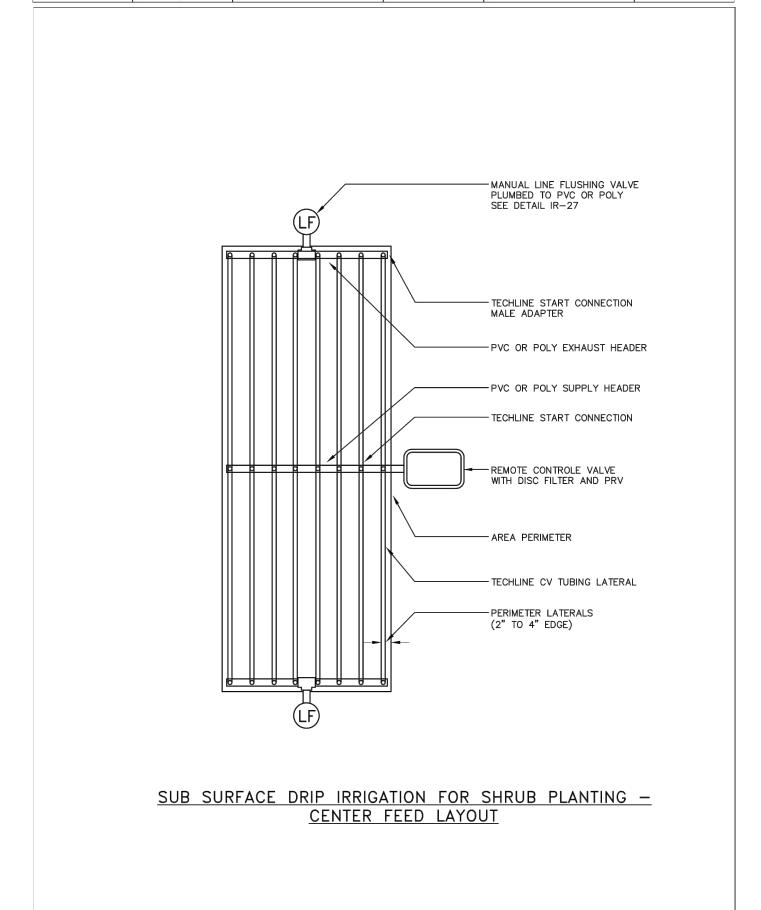
Rev. By: OG | Rev. Date: 01/06/09

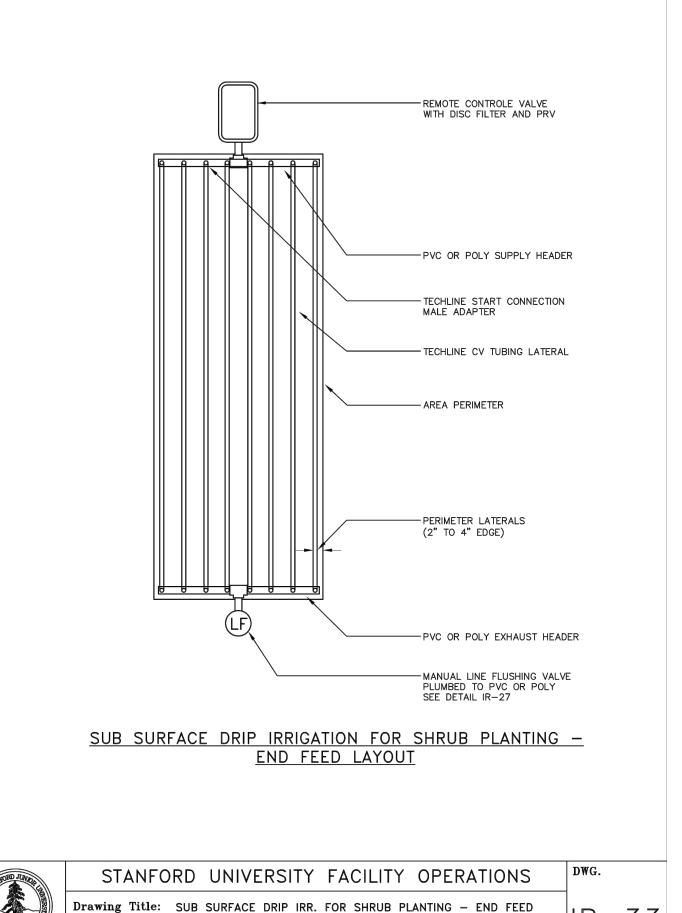Scale: NTS | Check:





25	STANFO	ORD UN	IVERSITY	FACILITY	OPERATI	ONS	DWG.	
S. THOMPSONT .	Drawing Title:	FLUSH VAI	LVE INSTALLAT	ION			IR—	2
1881	Scale: NTS	Check:		Rev. By: O.G.	Rev. Date:	01/08/09	111	_

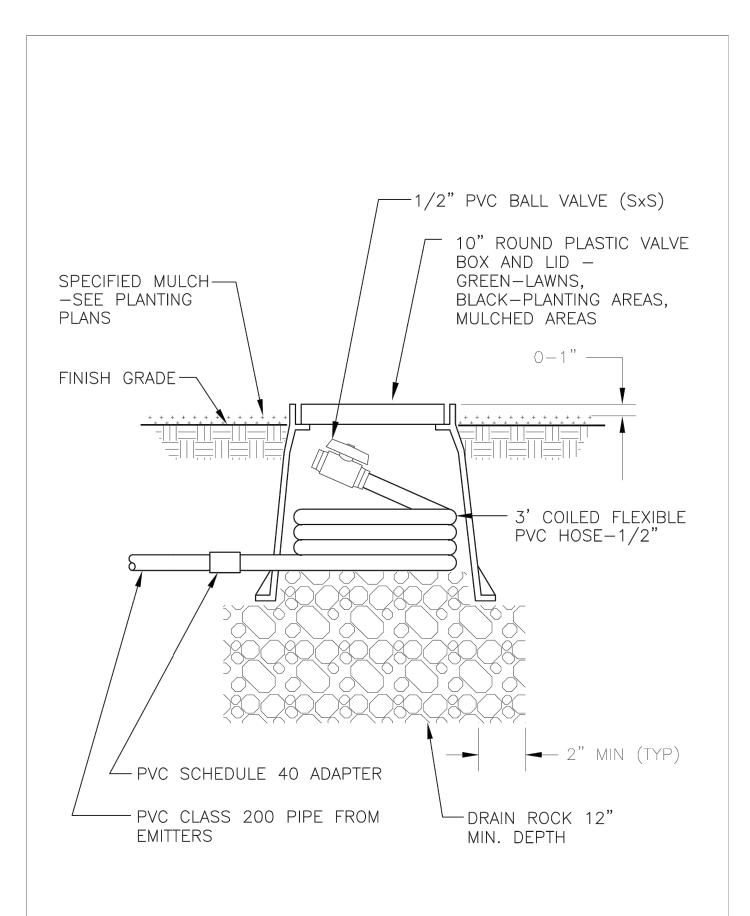

STANFORD UNIVERSITY FACILITY OPERATIONS

Drawing Title: SUB SURFACE DRIP IRR. FOR SHRUB PLANTING - CENTER FEED

Rev. By: OG Rev. Date: 01/06/09

Scale: NTS Check:

IRRIGATION LEGEND

		.					
SYMBOL	MODEL NUMBER	DESCRIPTION	NOZZLE GPM	OPERATING PSI	OPERATING RADIUS (FEET)		
•	1401 SERIES	RAIN BIRD BUBBLER, 2 MIN PER TREE	0.5	30	TRICKLE		
∞	1401 SERIES	RAIN BIRD BUBBLER, 1 PER SHRUB	0.25	30	TRICKLE		
••	65ARIA075	NETAFIM DRIPLINE AIR/V	acuum relie	EF VENT			
•+	EBV-0500-T	NDS DRIPLINE FLUSH VA	LVE, 1/2" S	SCH. 40 PVC	BALL VALVE		
O	1806-SAM/MPR-5Q	RAIN BIRD POP-UP SPR CLOSED 5' NOZZLE TO					
•	PEB SERIES	RAIN BIRD REMOTE CON-	TROL VALVE				
5	100-PEB-PRS-D/ RBY100MPTX	RAIN BIRD REMOTE CONTROL VALVE WITH A PRESSURE REGULATOR (SET TO 45 PSI) AND A 1" FILTER (0.20-1					
•	33 DNP	RAIN BIRD QUICK COUPL	ING VALVE				
H	LGT-XX-SS	LEEMCO STAINLESS STEEL GATE VALVE (LINE SIZE)-2.5" AND SMALLER					
•	2160K	GRISWOLD MASTER VALVE	VALVE, 1.5" (NORMALLY OPEN)				
	FS-150B	RAIN BIRD FLOW SENSOR	7				
	SXL-1.5"	WILKENS WYE STRAINER					
	500HLR-1.5"	WILKENS WYE PRESSURE	REGULATING	G VALVE			
	_	AMIAD 2" TAF-750 LAKE	WATER FILT	ΓER			
C	MAXI-PEDS-1-P5-NA -LK450-EL24-ANT07 -FM-SPP-NL-RBSC -SATVRF-LINKSURVEY	RAIN BIRD ESP—SAT SER CONTROL UNIT (CCU) IN RADIO COMMUNICATION. PEDESTAL MOUNTED ENCORPORE CONTROLLER IS SURVEY VISIT TO ENSUR	D FLOW MON NGLE STAINLE NTACT RAIN O COORDINAT	ITORING WITH SS STEEL BIRD SERVICES E A LINK			

NOTE:
ALL COPIES OF IRRIGATION INVOICES FOR ANY RAIN BIRD PRODUCTS
USED ON THIS PROJECT TO BE RETAINED AND SUBMITTED TO STANFORD
GROUNDS SERVICES. CONTACT DENNIS NICE (650) 804-2476

T)	SYMBOL	DESCRI	PTION
		CONTROLLER FLOW (GPM)	AND STATION NUMBER
			TROL VALVE SIZE (IN INCHES) REMOTE CONTROL VALVE
		CONTROLLER	AND STATION NUMBER
		AREA (SQ. F FLOW (GPM)	T.)
			TROL VALVE SIZE (IN INCHES) REMOTE CONTROL VALVE
		MAIN LINE:	2 1/2" AND SMALLER: 1120-SCHEDULE 40 PVC PLASTIC PIPE WITH SCHEDULE 40 PVC SOLVENT WELD FITTINGS. 18" COVER.
		LATERAL LINE:	3/4" AND LARGER: 1120—SCHEDULE 40 PVC PLASTIC PIPE WITH SCHEDULE 40 PVC SOLVENT WELD FITTINGS. 12" COVER.
		SLEEVING:	SCHEDULE 40 PVC PLASTIC PIPE. COVER TO BE AS INDICATED IN SPECIFICATIONS OR AS INDICATED ABOVE FOR PIPE DEPTH OF COVER.
R S			3/4" AND LARGER: 1120-SCHEDULE 40 PVC PLASTIC PIPE WITH SCHEDULE 40 PVC SOLVENT WELD FITTINGS. 12" COVER.
	PVC LATERAL——	DRIPLINE RE	MOTE CONTROL VALVE
	PVC PVC EXHAUST HEADER ——	DRIP ZONE:	NETAFIM TECHLINE HCVXR (CHECK VALVE & COPPER) SERIES DRIPLINE, PART # TLHCVXR5-18. TUBING TO BE INSTALLED 4" BELOW GRADE IN A 18" O.C. GRID ACCORDING TO DETAILS. SIZE EXHAUST HEADERS AS FOLLOWS: 1": 0-10 GPM, 1.25": 11-20 GPM. ALL EXHAUST HEADERS SHALL BE 1" SCH 40 PVC OR 1" SCH 40 FLEXIBLE PVC. USE SCH. 40 PVC SOLVENT WELD FITTINGS. EXTEND PVC HEADERS TO THE ENDS OF ALL DRIP ZONES TO BALANCE FLOW IF REQUIRED. SEE DETAILS FOR FURTHER INFORMATION.
	PVC LATERAL	DRIPLINE RE	MOTE CONTROL VALVE
	PVC PVC EXHAUST HEADER ————————————————————————————————————	DRIP ZONE:	NETAFIM TECHLINE HCVXR (CHECK VALVE & COPPER) SERIES DRIPLINE, PART # TLHCVXR5-12. TUBING TO BE INSTALLED 4" BELOW GRADE IN A 12" O.C. GRID ACCORDING TO DETAILS. SIZE EXHAUST HEADERS AS FOLLOWS: 1": 0-10 GPM, 1.25": 11-20 GPM. ALL EXHAUST HEADERS SHALL BE 1" SCH 40 PVC OR 1" SCH 40 FLEXIBLE PVC. USE SCH. 40 PVC SOLVENT WELD FITTINGS. EXTEND PVC HEADERS TO THE ENDS OF ALL DRIP ZONES TO BALANCE FLOW IF REQUIRED. SEE DETAILS FOR FURTHER INFORMATION.
	PVC LATERAL	DRIPLINE RE	MOTE CONTROL VALVE
		AND PVC SU	E CONNECTION POINT BETWEEN DRIPLINE TUBING JPPLY WHEN DRIP ZONE IS LESS THAN 3 GPM AND PPLY/EXHUST HEADERS ARE NEEDED. REFER TO BING CONNECTION DETAIL FOR MORE INFORMATION.



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\triangle	MILESTONE	DATE
	ASA APPLICATION	7/31/2019

PROJECT NAME

GEORGE P. SHULTZ BUILDING

HOOVER INSTITUTION

434 GALVEZ MALL

STANFORD, CA 93405

SHEET TITLE

IRRIGATION DETAILS AND LEGEND

PROJECT NO. STFS802

CHECKED BY W. HYNES

SHEET

L3.5

PLANT LIST

TREE SCHEDULE						
SYMBOL	CODE	BOTANICAL NAME	COMMON NAME	CONTAINER	TRUNK	REMARKS
	CBE	CARPINUS BETULUS 'FASTIGIATA'	EUROPEAN HORNBEAM	24" BOX	SINGLE	
	OEU	OLEA EUROPAEA 'MAJESTIC BEAUTY"	MAJESTIC BEAUTY FRUITLESS OLIVE	24" BOX	MULTI	
	PCH	PISTACIA CHINENSIS 'KEITH DAVEY'	FRUITLESS CHINESE PISTACHE	48" BOX	SINGLE	
	QAG	QUERCUS AGRIFOLIA	COAST LIVE OAK	36" BOX	SINGLE	
	SSE	SEQUOIA SEMPERVIRENS 'APTOS BLUE'	COAST REDWOOD	36" BOX	SINGLE	

SHRUB SCHEDULE						
SYMBOL	CODE	BOTANICAL NAME	COMMON NAME	SPACING	CONTAINER	REMARKS
	AAA	HETEROMELES ARBUTIFOLIA	TOYON	60" O.C.	5 GAL	_
	AAA	MAHONIA REPENS	CREEPING MAHONIA	36" O.C.	5 GAL	_
	AAA	RHAMNUS CALIFORNICA	COFFEEBERRY	48" O.C.	5 GAL	_
	ADE	ARCTOSTAPHYLOS DENSIFLORA 'HOWARD MCMINN'	HOWARD MCMINN MANZANITA	36" O.C.	5 GAL	_
	CKI	COPROSMA KIRKII	CREEPING MIRROR PLANT	48" O.C.	5 GAL	_
	SH0	SARCOCOCCA HOOKERIANA VAR. HUMILIS	SWEET BOX	48" O.C.	5 GAL	_
	PT0	PITTOSPORUM TOBIRA	JAPANESE PITTOSPORUM	48" O.C.	5 GAL	_
+ + + + + + + + + + + + + + + + + + + +	LJA +	LIGUSTRUM JAPONICUM 'TEXANUM'	WAXLEAF PRIVET	36" O.C.	5 GAL	_
	FGA	FUCHSIA 'GARTENMEISTER BONSTEDT'	GARTENMEISTER FUCHSIA	36" O.C.	5 GAL	_
	BBB	RHODODENDRON	RHODODENDRON, AZALEA	36" O.C.	5 GAL	_
	BBB	AUCUBA JAPONICA	SPOTTED LAUREL	36" O.C.	5 GAL	_
	BBB	FATSIA JAPONICA	JAPANESE ARALEA	48" O.C.	5 GAL	_
	ccc	CAMELLIA SASANQUA 'YULETIDE'	YULETIDE CAMELLIA	48" O.C.	5 GAL	_
	ccc	HYDRANGEA QUERCIFOLIA	OAK LEAF HYDRANGEA	48" O.C.	5 GAL	_
	DGR	DIETES GRANDIFLORA	FORTNIGHT LILY	18" O.C.	5 GAL	_
V	FRE	FICUS REPENS	CLIMBING FIG	PER PLAN	5 GAL	_

PLANTING AND IRRIGATION NOTES

- 1. ALL EXISTING LANDSCAPED AREAS AND IRRIGATION IN THE AREA THAT MAY HAVE BEEN IMPACTED ARE TO BE RESTORED AND OPERATIONAL WITH PRIOR APPROVAL OF THE STANFORD UNIVERSITY ARCHITECT AND PLANNING OFFICE AND STANFORD GROUNDS SERVICES.
- 2. EXISTING WIRING, CONTROLLER AND POINT OF CONNECTION TO BE REUSED FOR THIS PROJECT. NEW OR REPLACED EQUIPMENT SHOULD BE REPLACED IN ACCORDANCE WITH FDG GUIDELINES.
- 3. CONTRACTOR TO PROVIDE A SUBMITTAL TO STANFORD GROUNDS SERVICES FOR REVIEW FOR ALL PROPOSED EQUIPMENT USED TO RESTORE EXISTING SYSTEM. PROPOSED EQUIPMENT, DOCUMENTATION AND DETAIL DRAWINGS CAN BE FOUND AT THE STANFORD FDG GUIDELINES. HTTP: //MAPS.STANFORD.EDU/SITES/ALL/LBRE-SHARED/FILES/DOCS_PUBLIC/LANDSCAPING_DESIGN_GUIDELINES.PDF
- AND HTTP: //MAPS.STANFORD.EDU/FDG_VIEW_DRAWINGS 4. SPECIFY THAT ONLY RAIN BIRD IRRIGATION PARTS ARE UTILIZED. INCLUDE ADDITIONAL NOTE: ALL COPIES OF IRRIGATION INVOICES FOR ANY RAIN BIRD PRODUCTS USED IN THIS PROJECT TO BE RETAINED AND SUBMITTED TO GROUNDS SERVICES. STANFORD GROUNDS IRRIGATION (650) 650-725-8687.
- 5. PROVIDE 3" OF MULCH FOR ALL PLANTING AREAS AND 10' BEYOND THE LIMITS OF WORK.
- 6. EACH TREE LOCATION TO BE APPROVED BY LANDSCAPE ARCHITECT PRIOR TO INSTALLATION
- 7. AMEND TOPSOIL PER SPECIFICATIONS IN ALL PLANTING AREAS. PROVIDE AND INSTALL IMPORTED TOPSOIL AS MAY BE NECESSARY TO COMPLETE THE WORK AND MEET GRADES AS REQUIRED BY THE CIVIL DRAWINGS.
- 8. ALL SHRUBS PLACED ADJACENT TO A VERTICAL STRUCTURE (WALL, FOOTINGS, ETC.) SHALL HAVE MINIMUM OF 24" DEPTH OF SOIL.



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	MILESTONE	DATE
A	ASA APPLICATION	7/31/2019

PROJECT NAME

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HOOVER INSTITUTION

434 GALVEZ MALL

STANFORD, CA 93405


SHEET TITLE

PLANT LIST AND NOTES


PROJECT NO. STFS802 DRAWN BY C. LINDLEY

CHECKED BY W. HYNES

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WILLIAM RAWN ASSOCIATES | Architects, Inc

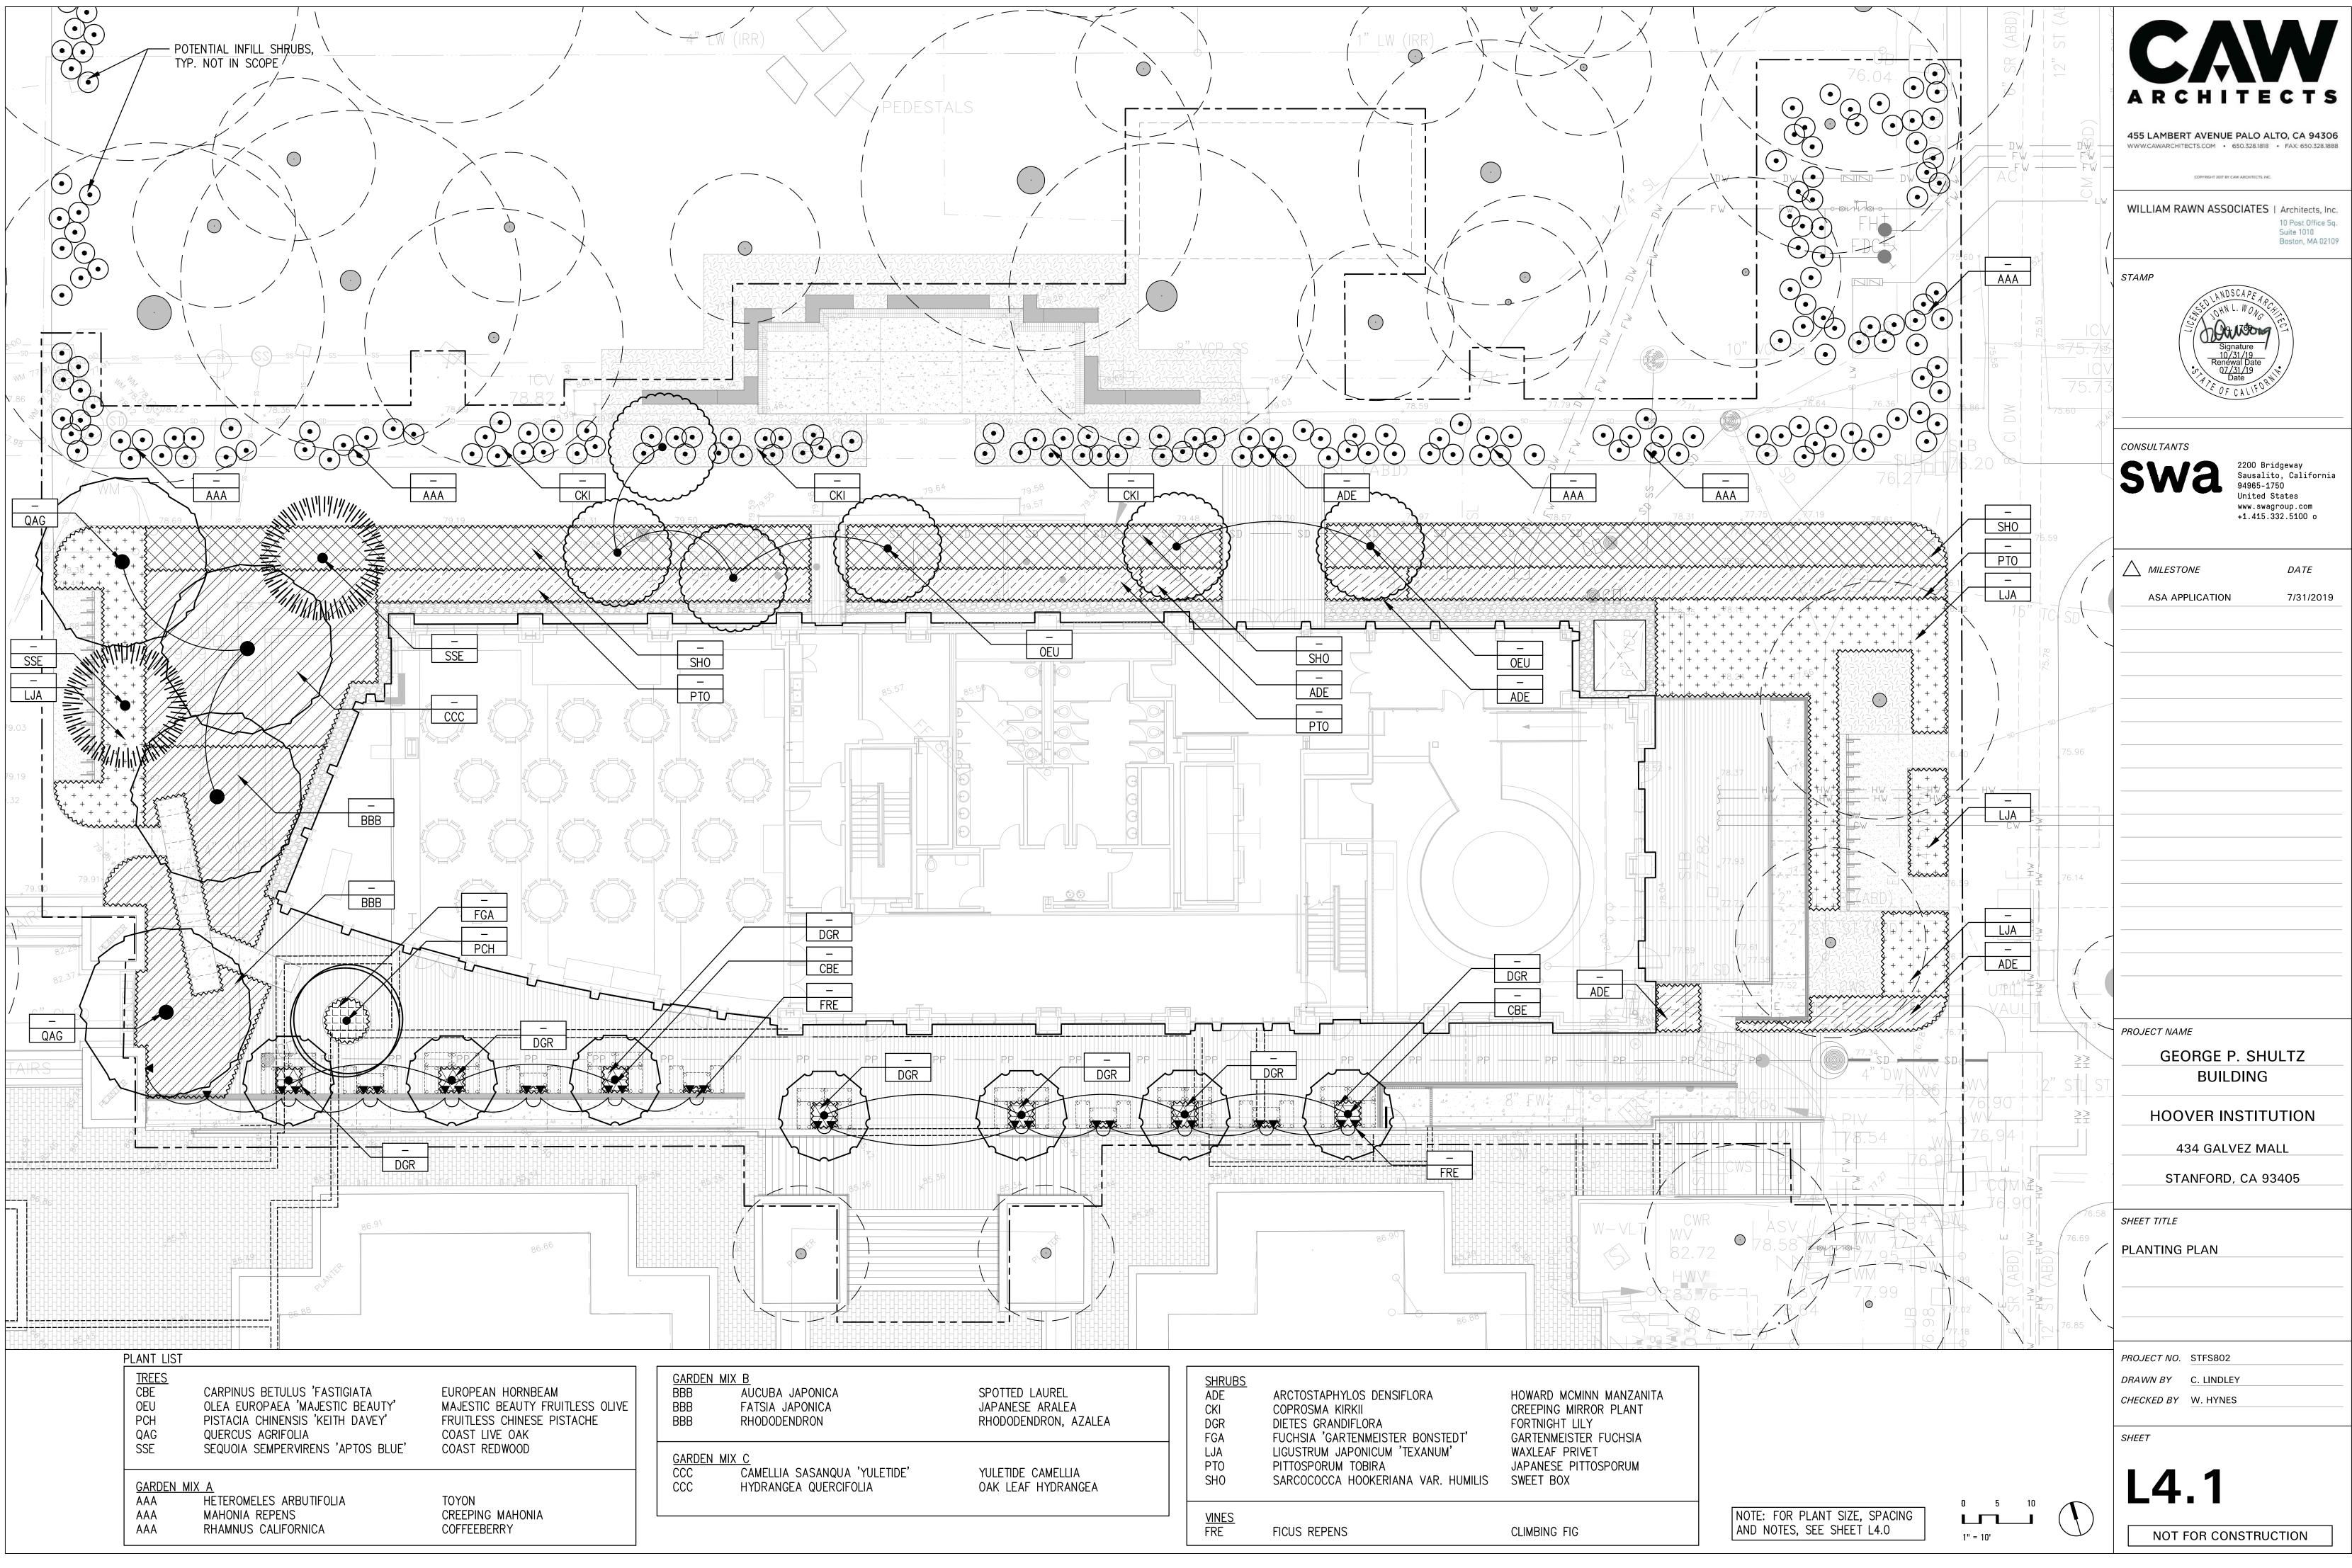- 1. ALL COLUMNS TO BE ENCLOSED IN FURRED WALLS F3, U.N.O.
- 2. COLUMNS AND BEAMS AROUND STAIR, ELEVATOR, AND DUCT SHAFTS TO BE 1-HR RATED WITH SPRAY APPLIED OR GYP BOARD FIRE PROOFING.
- 3. SEE STRUCTURAL DRAWINGS FOR ALL SLAB OPENINGS AT SHAFTS.

FLOOR PLAN LEGEND

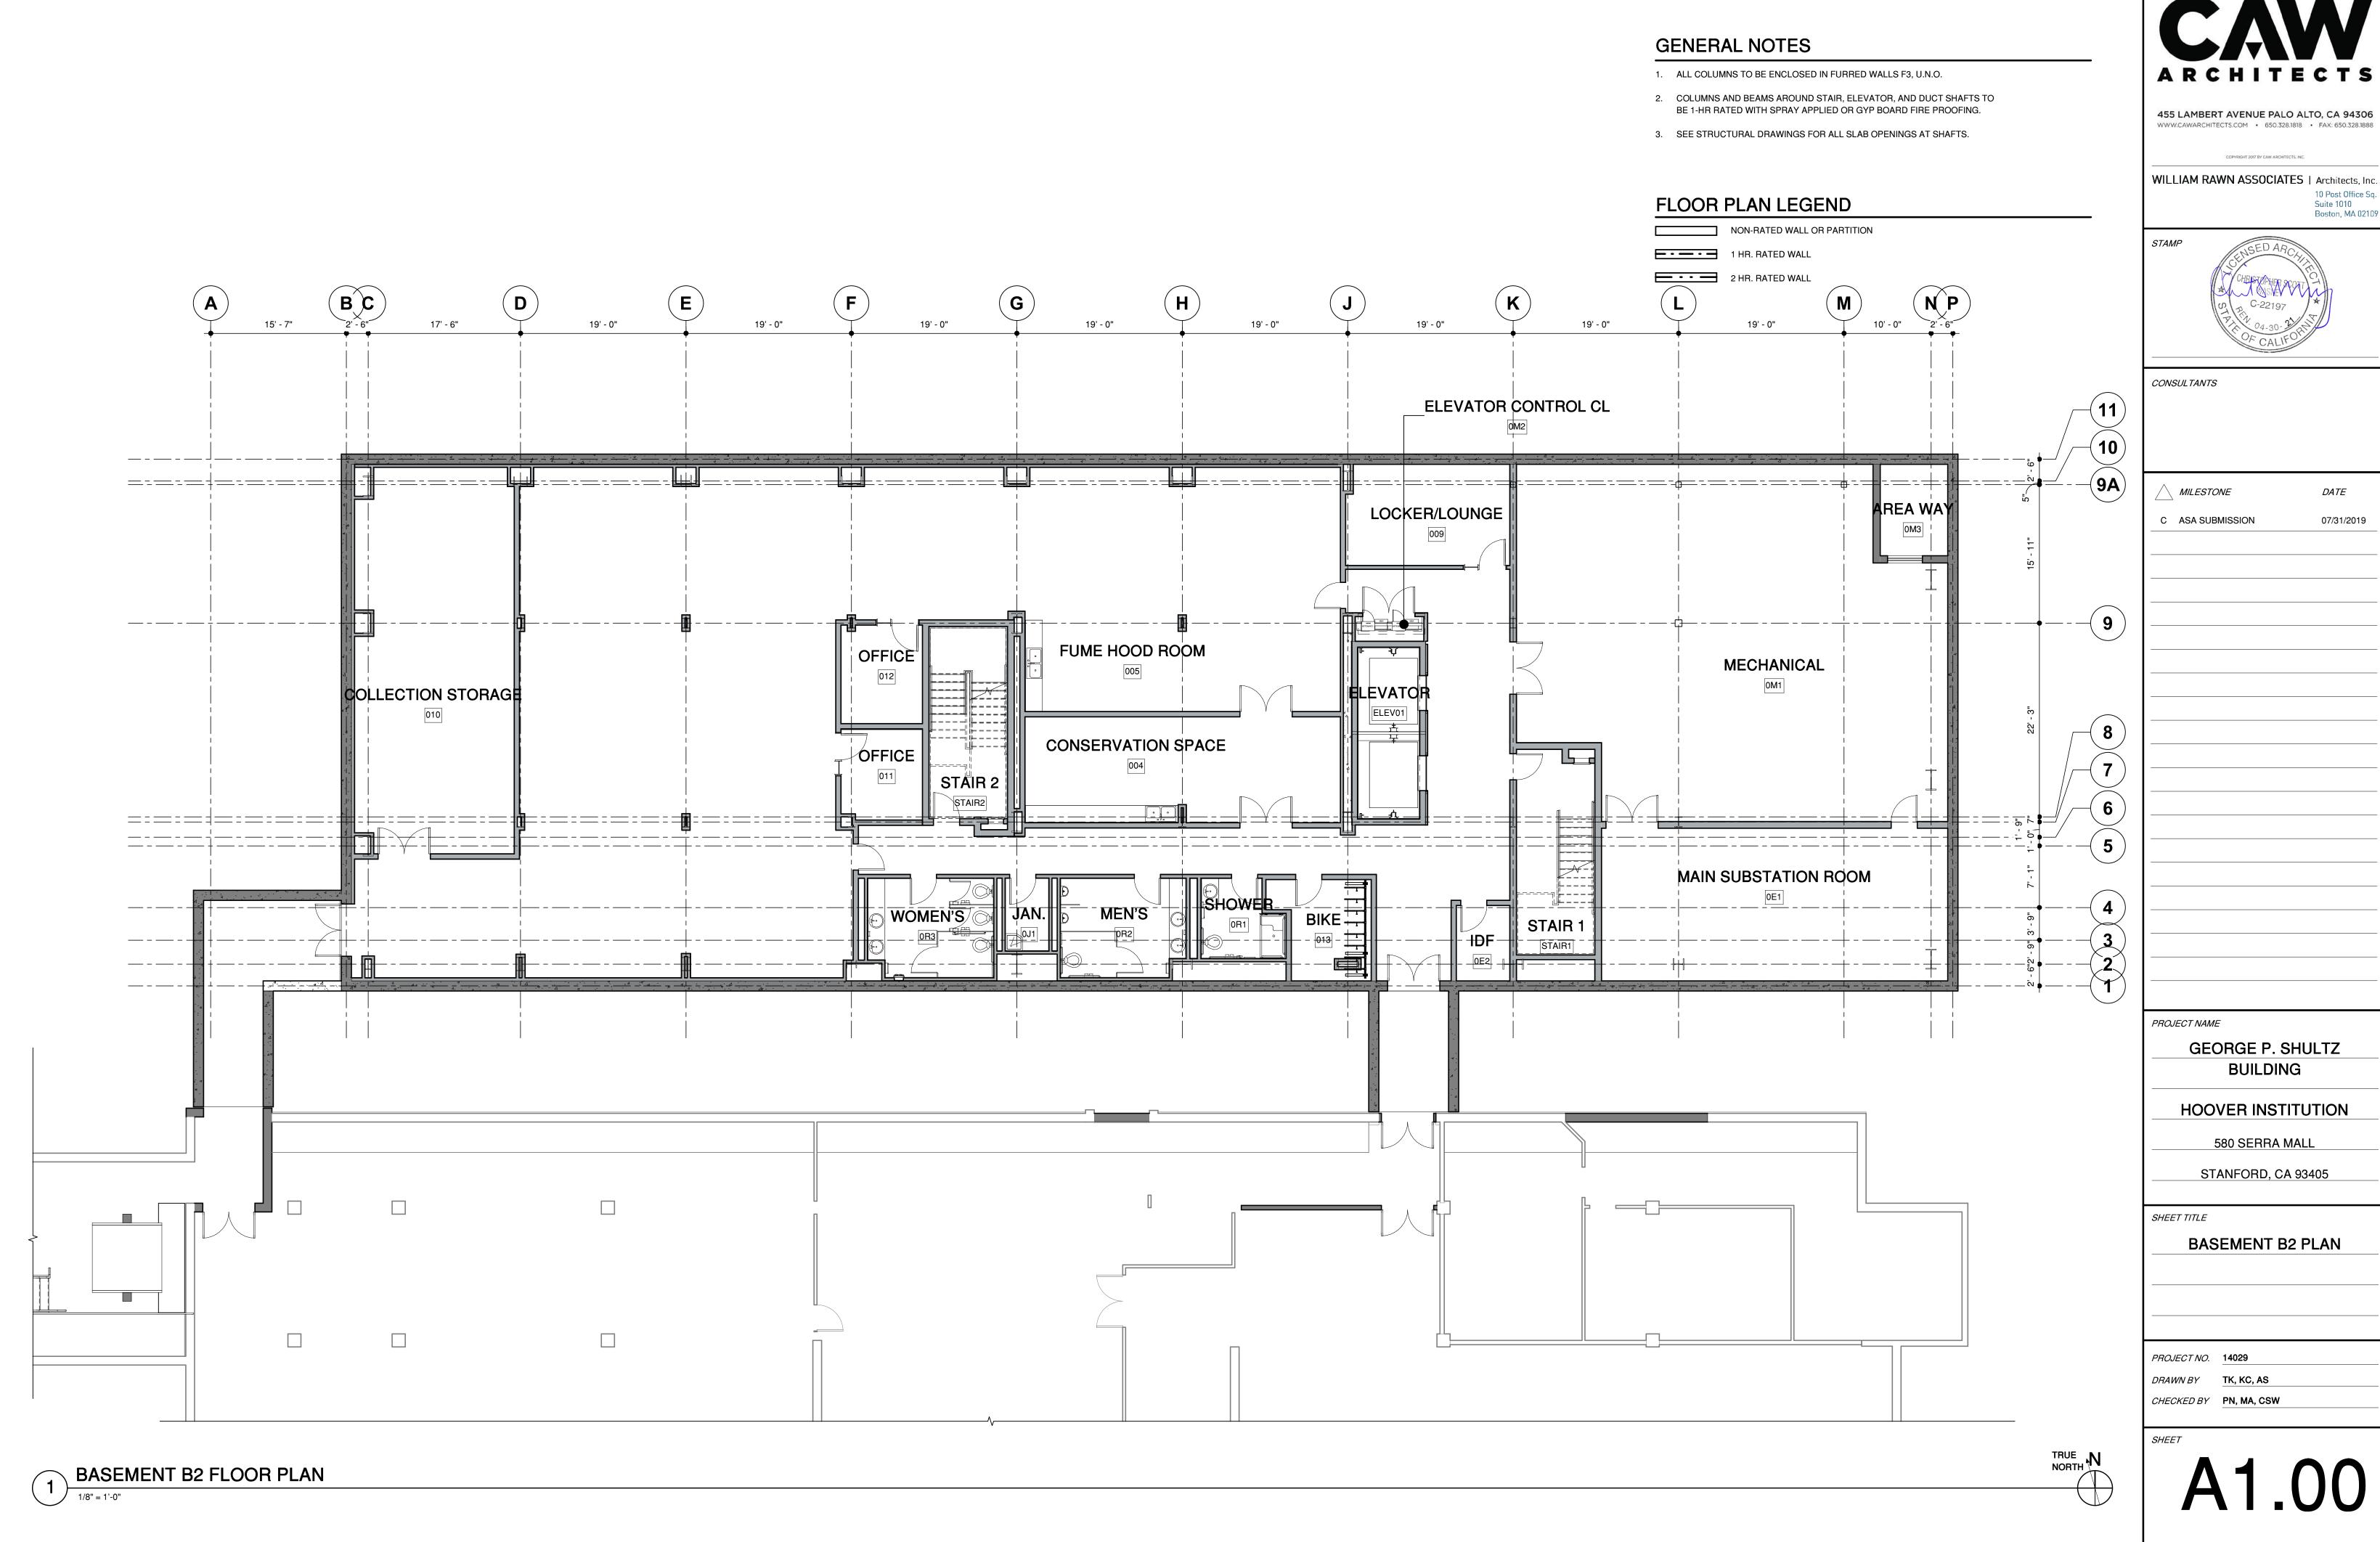NON-RATED WALL OR PARTITION

1 HR. RATED WALL

2 HR. RATED WALL

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MILESTONE DATE

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GEORGE P. SHULTZ BUILDING


HOOVER INSTITUTION 580 SERRA MALL

STANFORD, CA 93405

FIRST FLOOR PLAN

DRAWN BY TK, KC, AS

CHECKED BY PN, MA, CSW

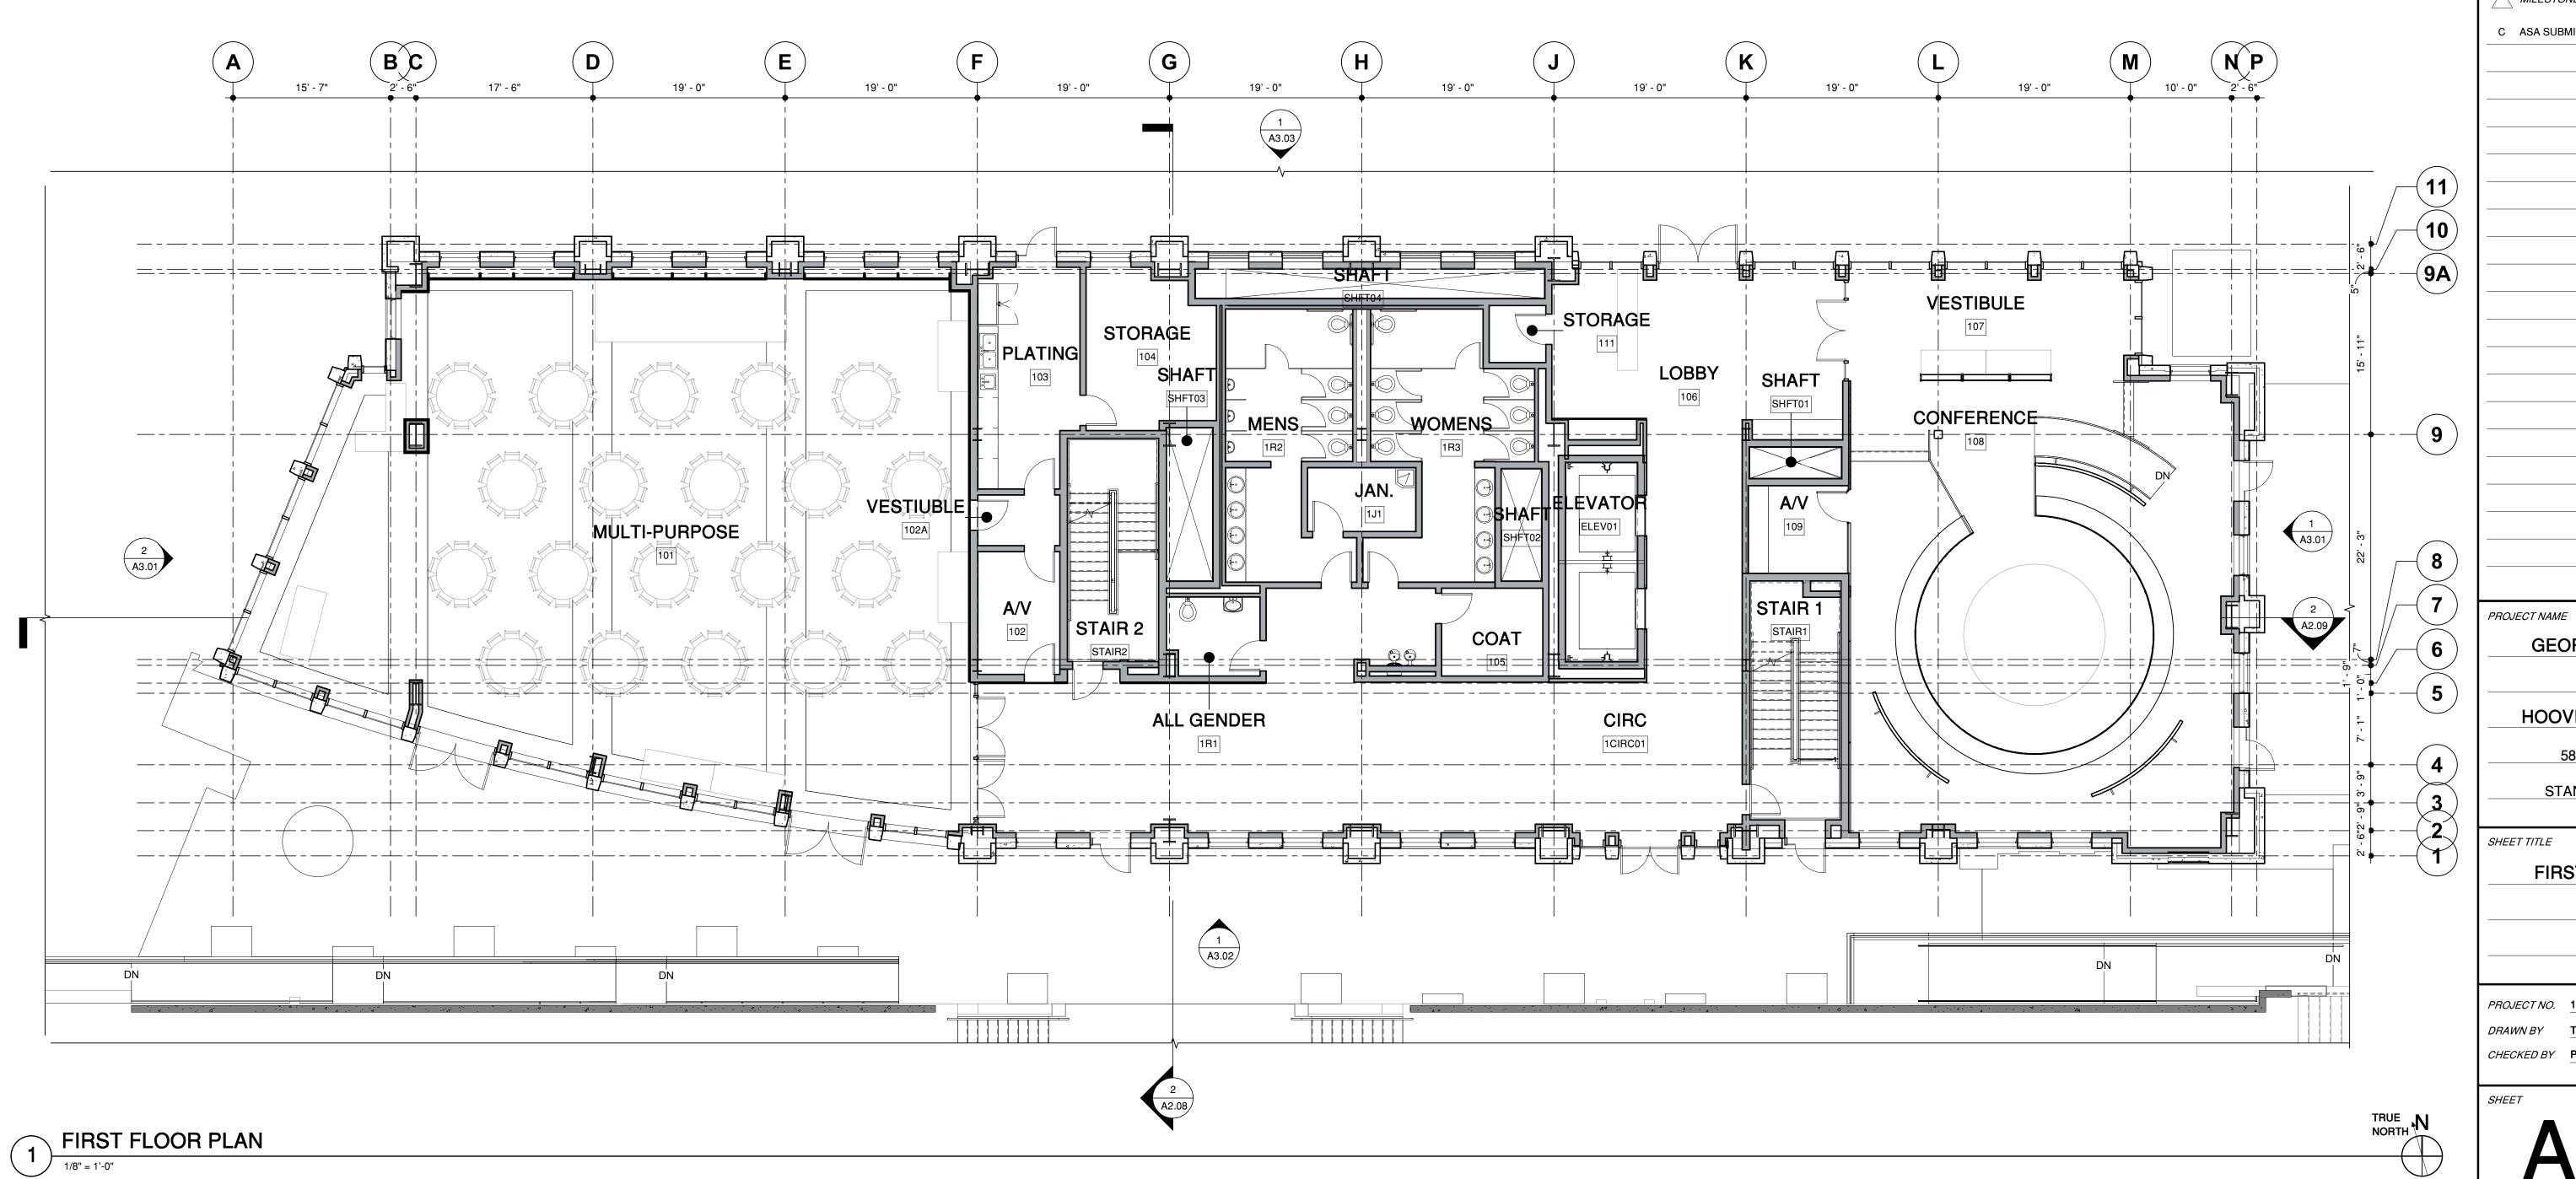

- 1. ALL COLUMNS TO BE ENCLOSED IN FURRED WALLS F3, U.N.O.
- 2. COLUMNS AND BEAMS AROUND STAIR, ELEVATOR, AND DUCT SHAFTS TO BE 1-HR RATED WITH SPRAY APPLIED OR GYP BOARD FIRE PROOFING.
- 3. SEE STRUCTURAL DRAWINGS FOR ALL SLAB OPENINGS AT SHAFTS.

FLOOR PLAN LEGEND

NON-RATED WALL OR PARTITION

1 HR. RATED WALL
2 HR. RATED WALL

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MILESTONE DATE

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GEORGE P. SHULTZ
BUILDING

HOOVER INSTITUTION
580 SERRA MALL

STANFORD, CA 93405


SHEET TITLE

SECOND FLOOR PLAN

PROJECT NO. 14029

DRAWN BY
TK, KC, AS
CHECKED BY
PN, MA, CSW

1.02

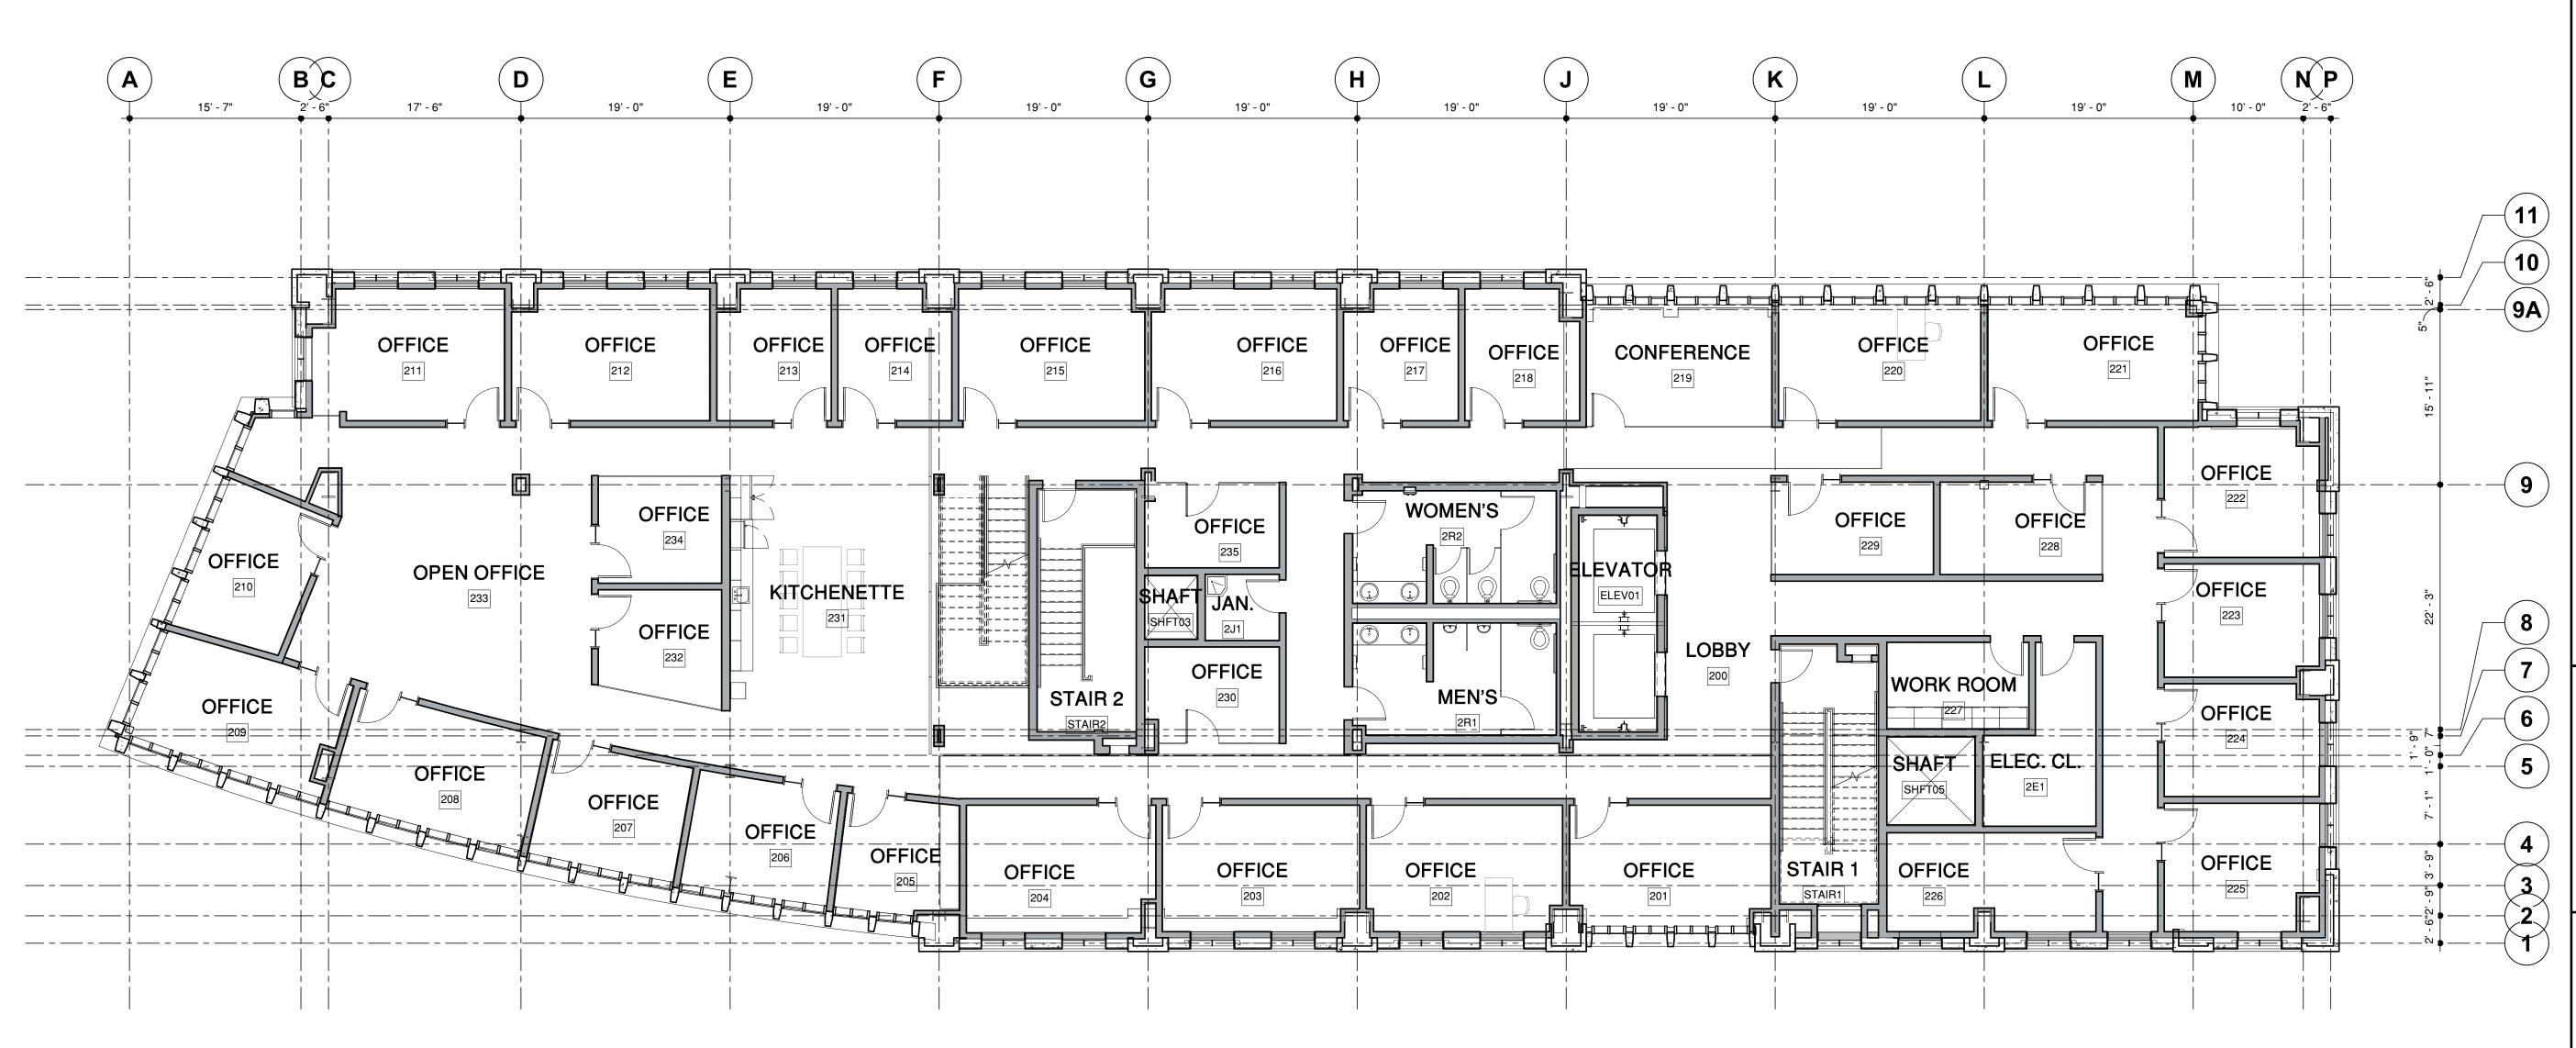

- 1. ALL COLUMNS TO BE ENCLOSED IN FURRED WALLS F3, U.N.O.
- 2. COLUMNS AND BEAMS AROUND STAIR, ELEVATOR, AND DUCT SHAFTS TO BE 1-HR RATED WITH SPRAY APPLIED OR GYP BOARD FIRE PROOFING.
- 3. SEE STRUCTURAL DRAWINGS FOR ALL SLAB OPENINGS AT SHAFTS.

FLOOR PLAN LEGEND

NON-RATED WALL OR PARTITION

1 HR. RATED WALL 2 HR. RATED WALL

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PROJECT NAME

GEORGE P. SHULTZ **BUILDING**

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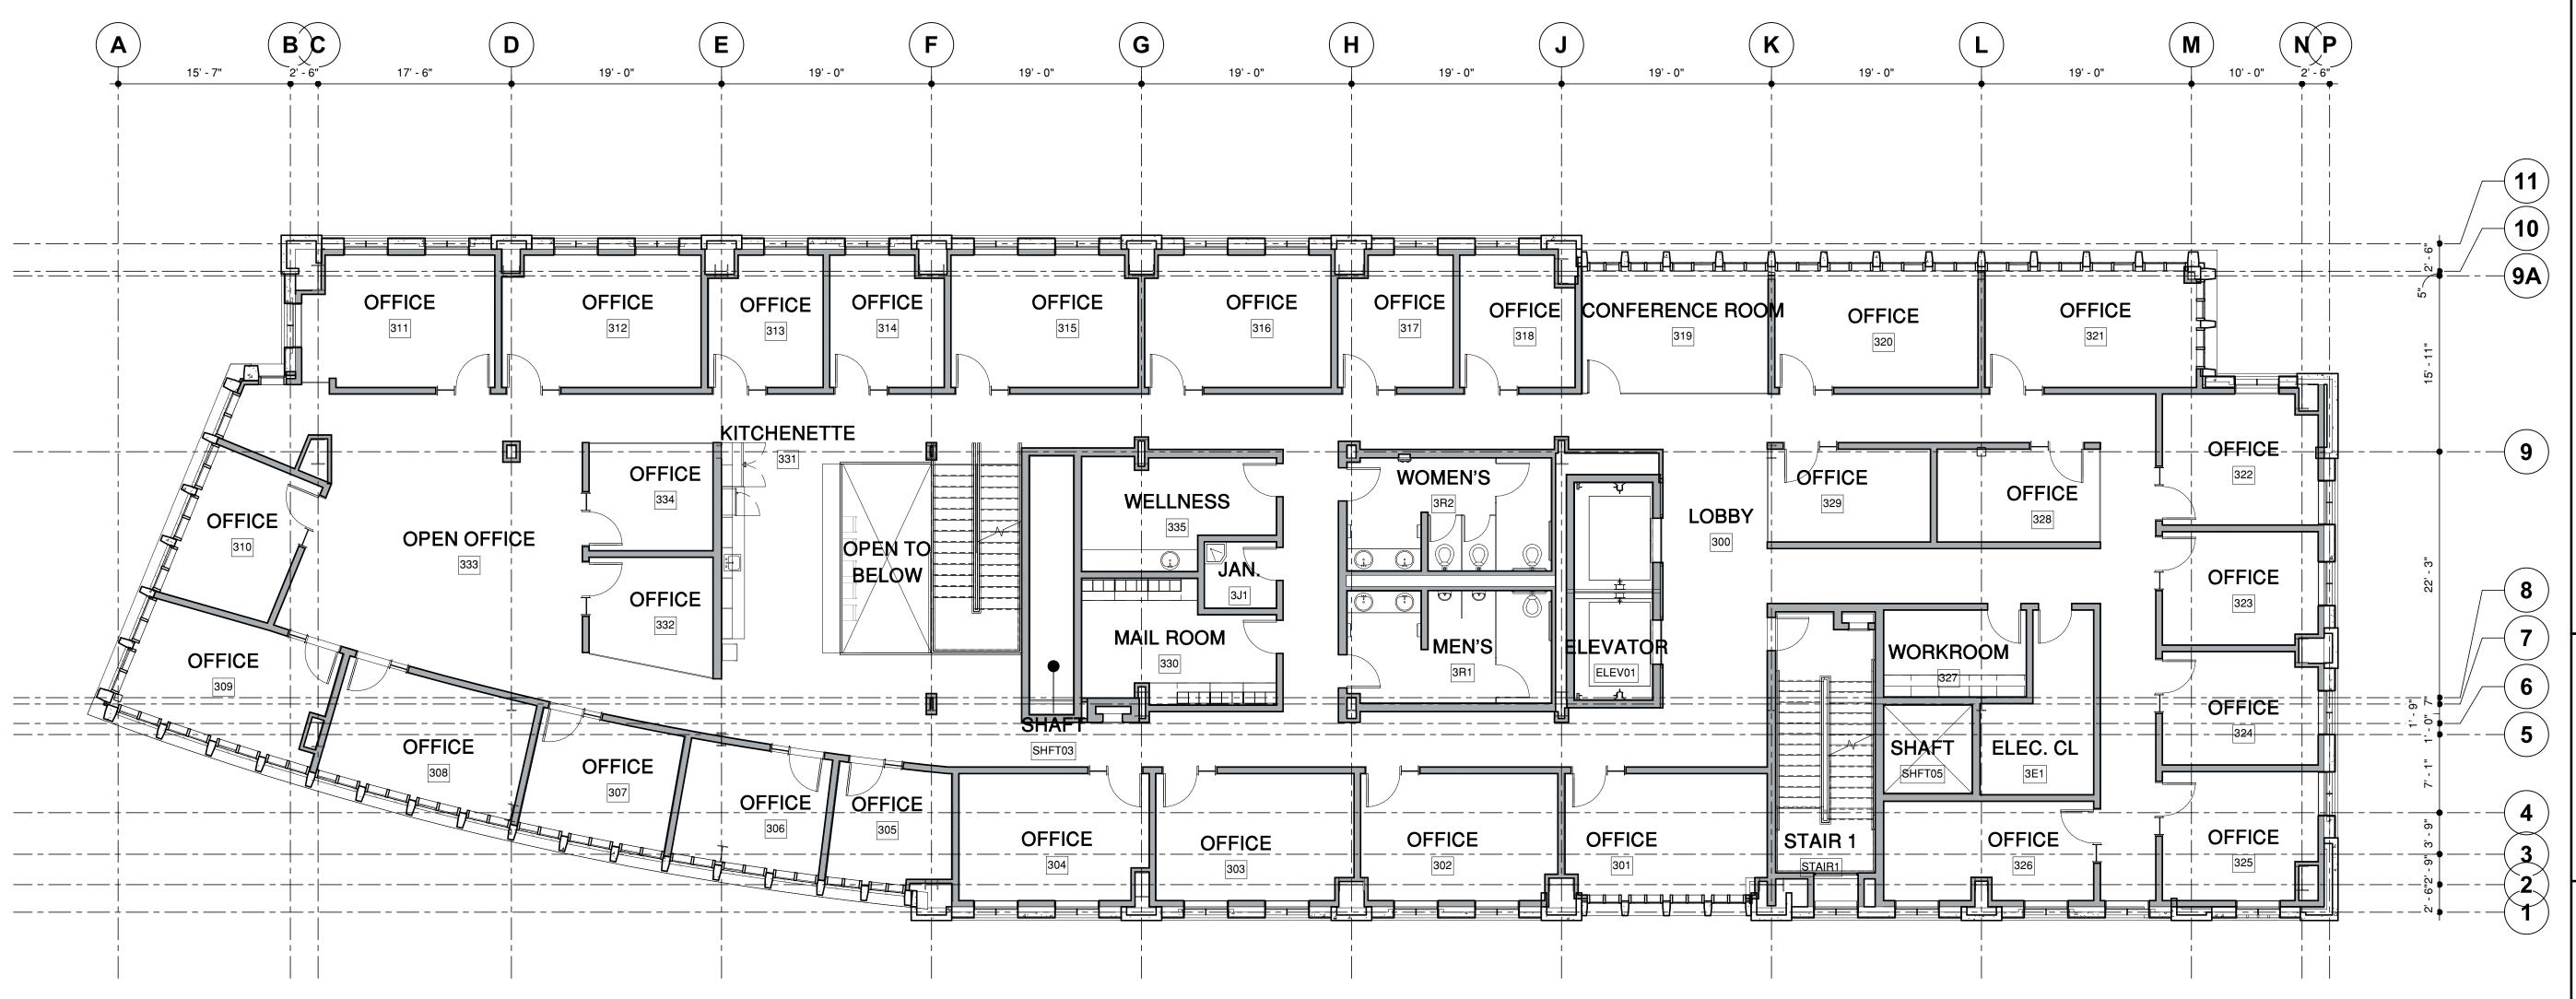
STANFORD, CA 93405

SHEET TITLE

THIRD FLOOR PLAN

DRAWN BY TK, KC, AS

CHECKED BY PN, MA, CSW



- 1. ALL COLUMNS TO BE ENCLOSED IN FURRED WALLS F3, U.N.O.
- 2. COLUMNS AND BEAMS AROUND STAIR, ELEVATOR, AND DUCT SHAFTS TO BE 1-HR RATED WITH SPRAY APPLIED OR GYP BOARD FIRE PROOFING.
- 3. SEE STRUCTURAL DRAWINGS FOR ALL SLAB OPENINGS AT SHAFTS.

FLOOR PLAN LEGEND

NON-RATED WALL OR PARTITION

1 HR. RATED WALL
2 HR. RATED WALL


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MILESTONE DATE

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PROJECT NAME

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HOOVER INSTITUTION
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SHEET TITLE


FOURTH FLOOR PLAN

PROJECT NO. 14029

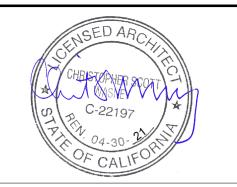DRAWN BY
TK, KC, AS
CHECKED BY
PN, MA, CSW

-

41.04

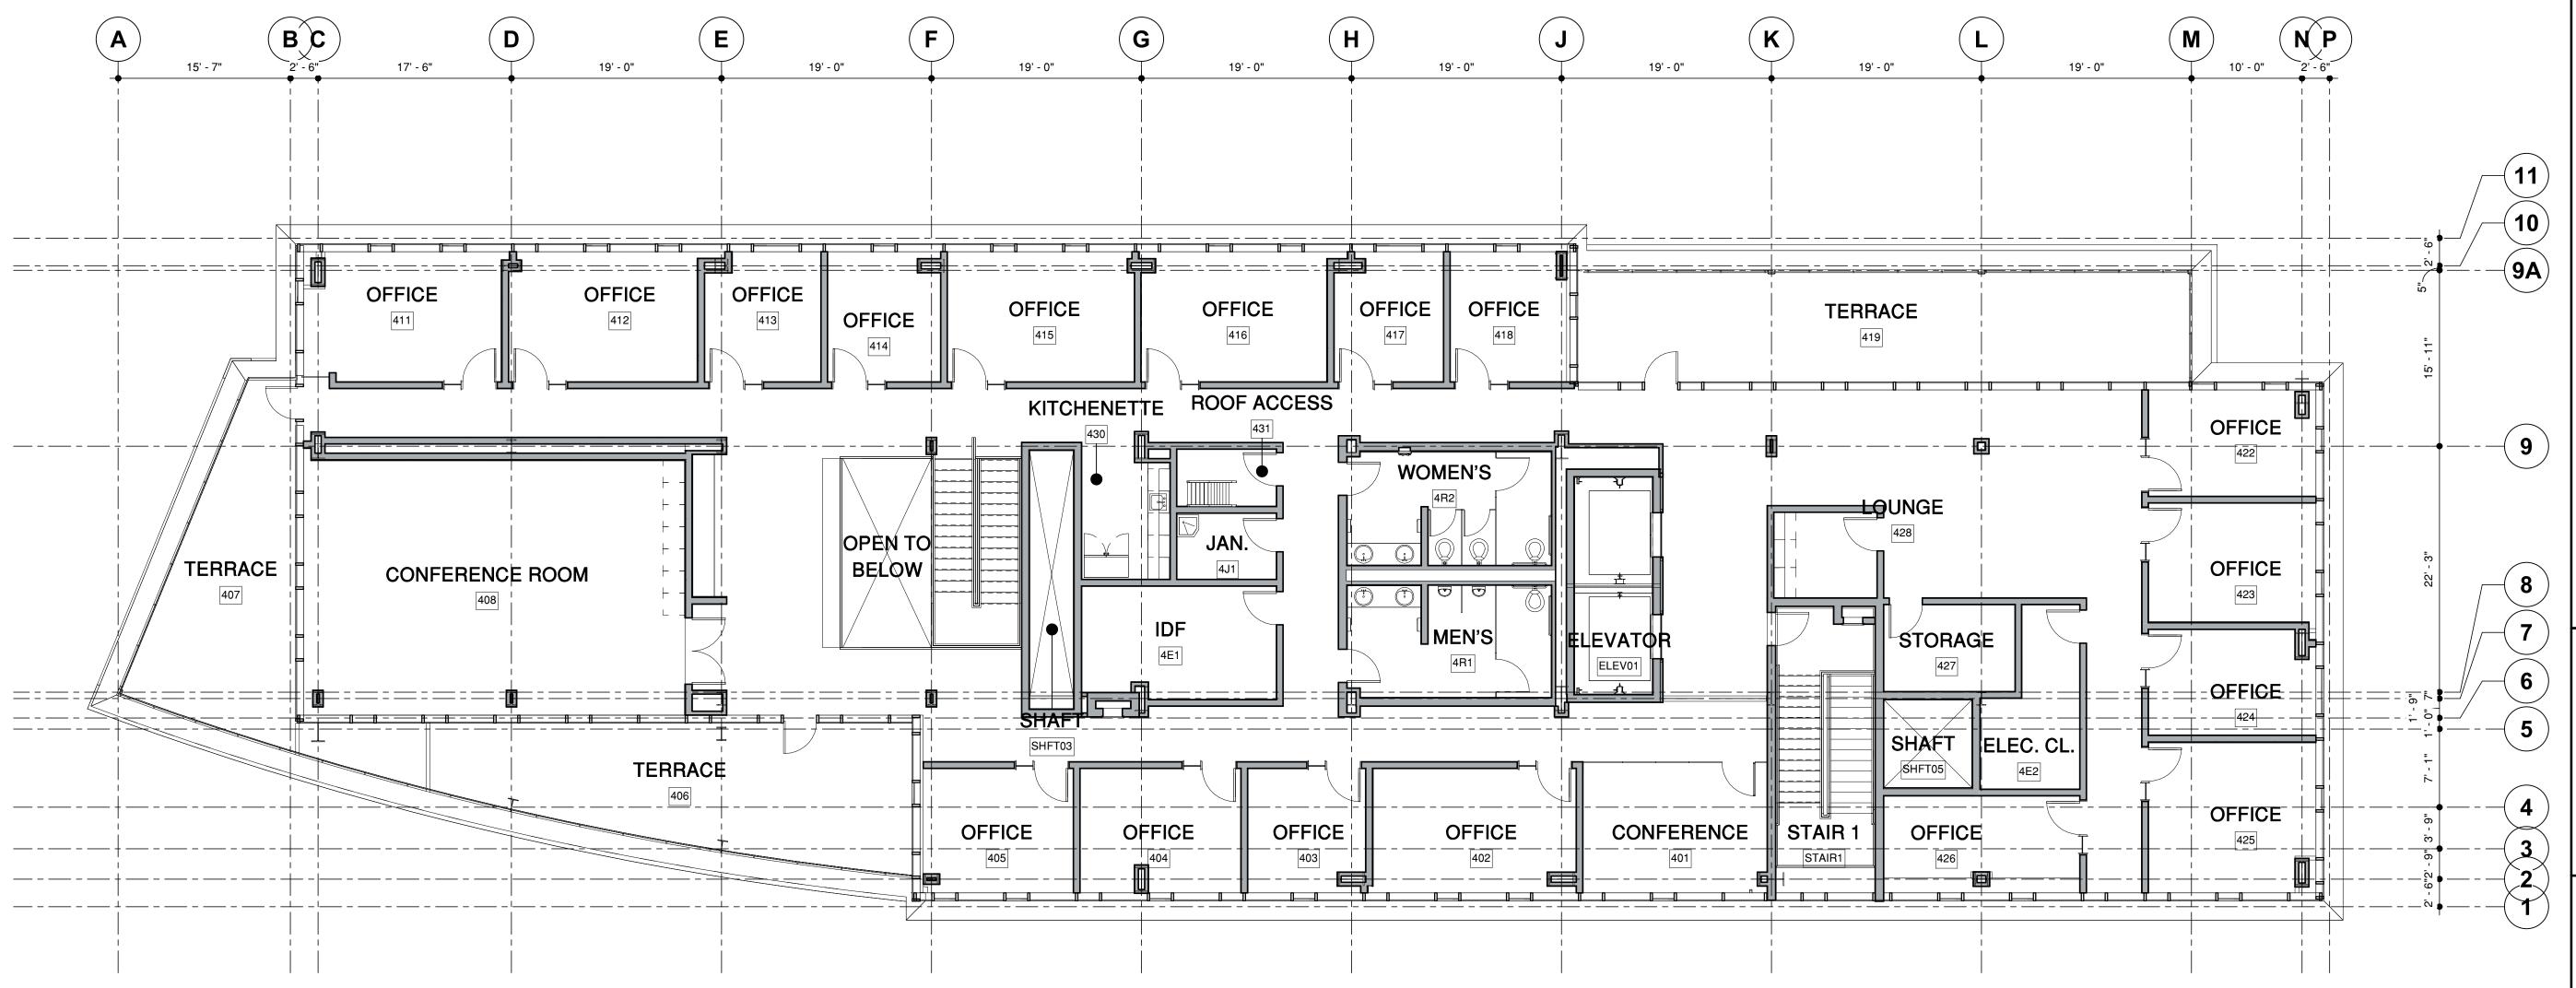

- 1. ALL COLUMNS TO BE ENCLOSED IN FURRED WALLS F3, U.N.O.
- 2. COLUMNS AND BEAMS AROUND STAIR, ELEVATOR, AND DUCT SHAFTS TO BE 1-HR RATED WITH SPRAY APPLIED OR GYP BOARD FIRE PROOFING.
- 3. SEE STRUCTURAL DRAWINGS FOR ALL SLAB OPENINGS AT SHAFTS.

FLOOR PLAN LEGEND

NON-RATED WALL OR PARTITION

1 HR. RATED WALL
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PROJECT NAME

GEORGE P. SHULTZ

HOOVER INSTITUTION

BUILDING

580 SERRA MALL STANFORD, CA 93405

SHEET TITLE


ROOF PLAN


 WN BY
 TK, KC, AS

CHECKED BY PN, MA, CSW

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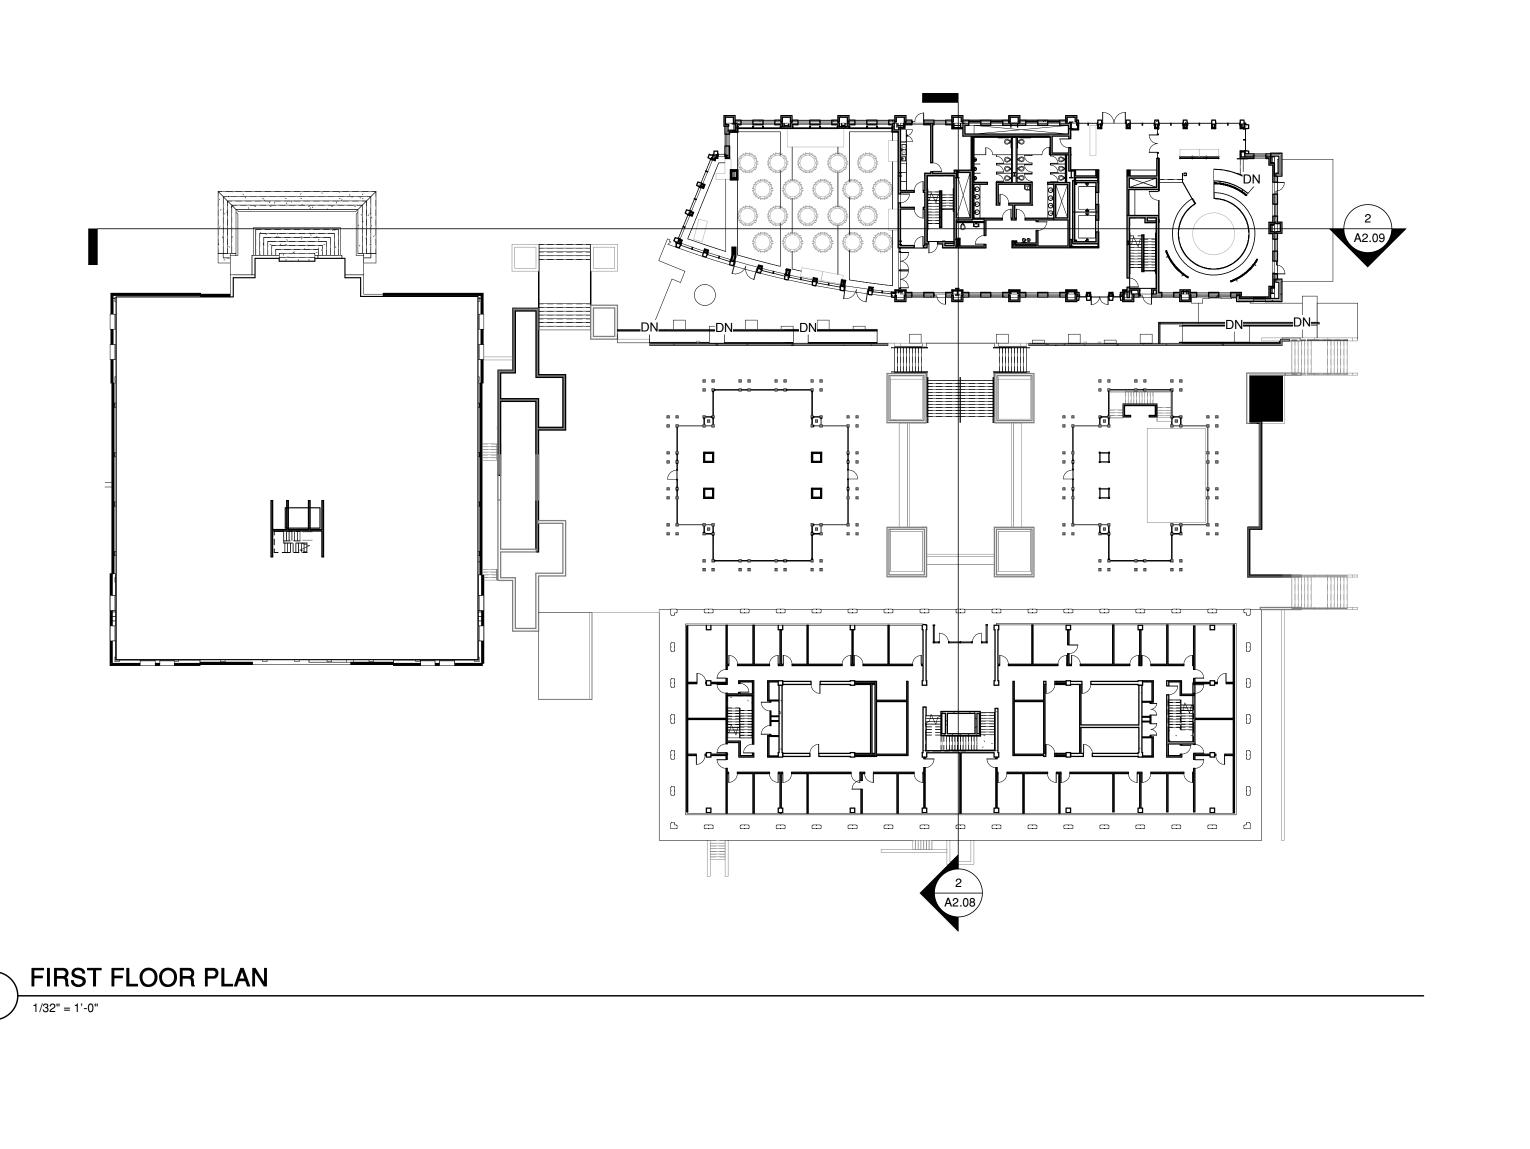
GEORGE P. SHULTZ BUILDING


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BUILDING SECTIONS

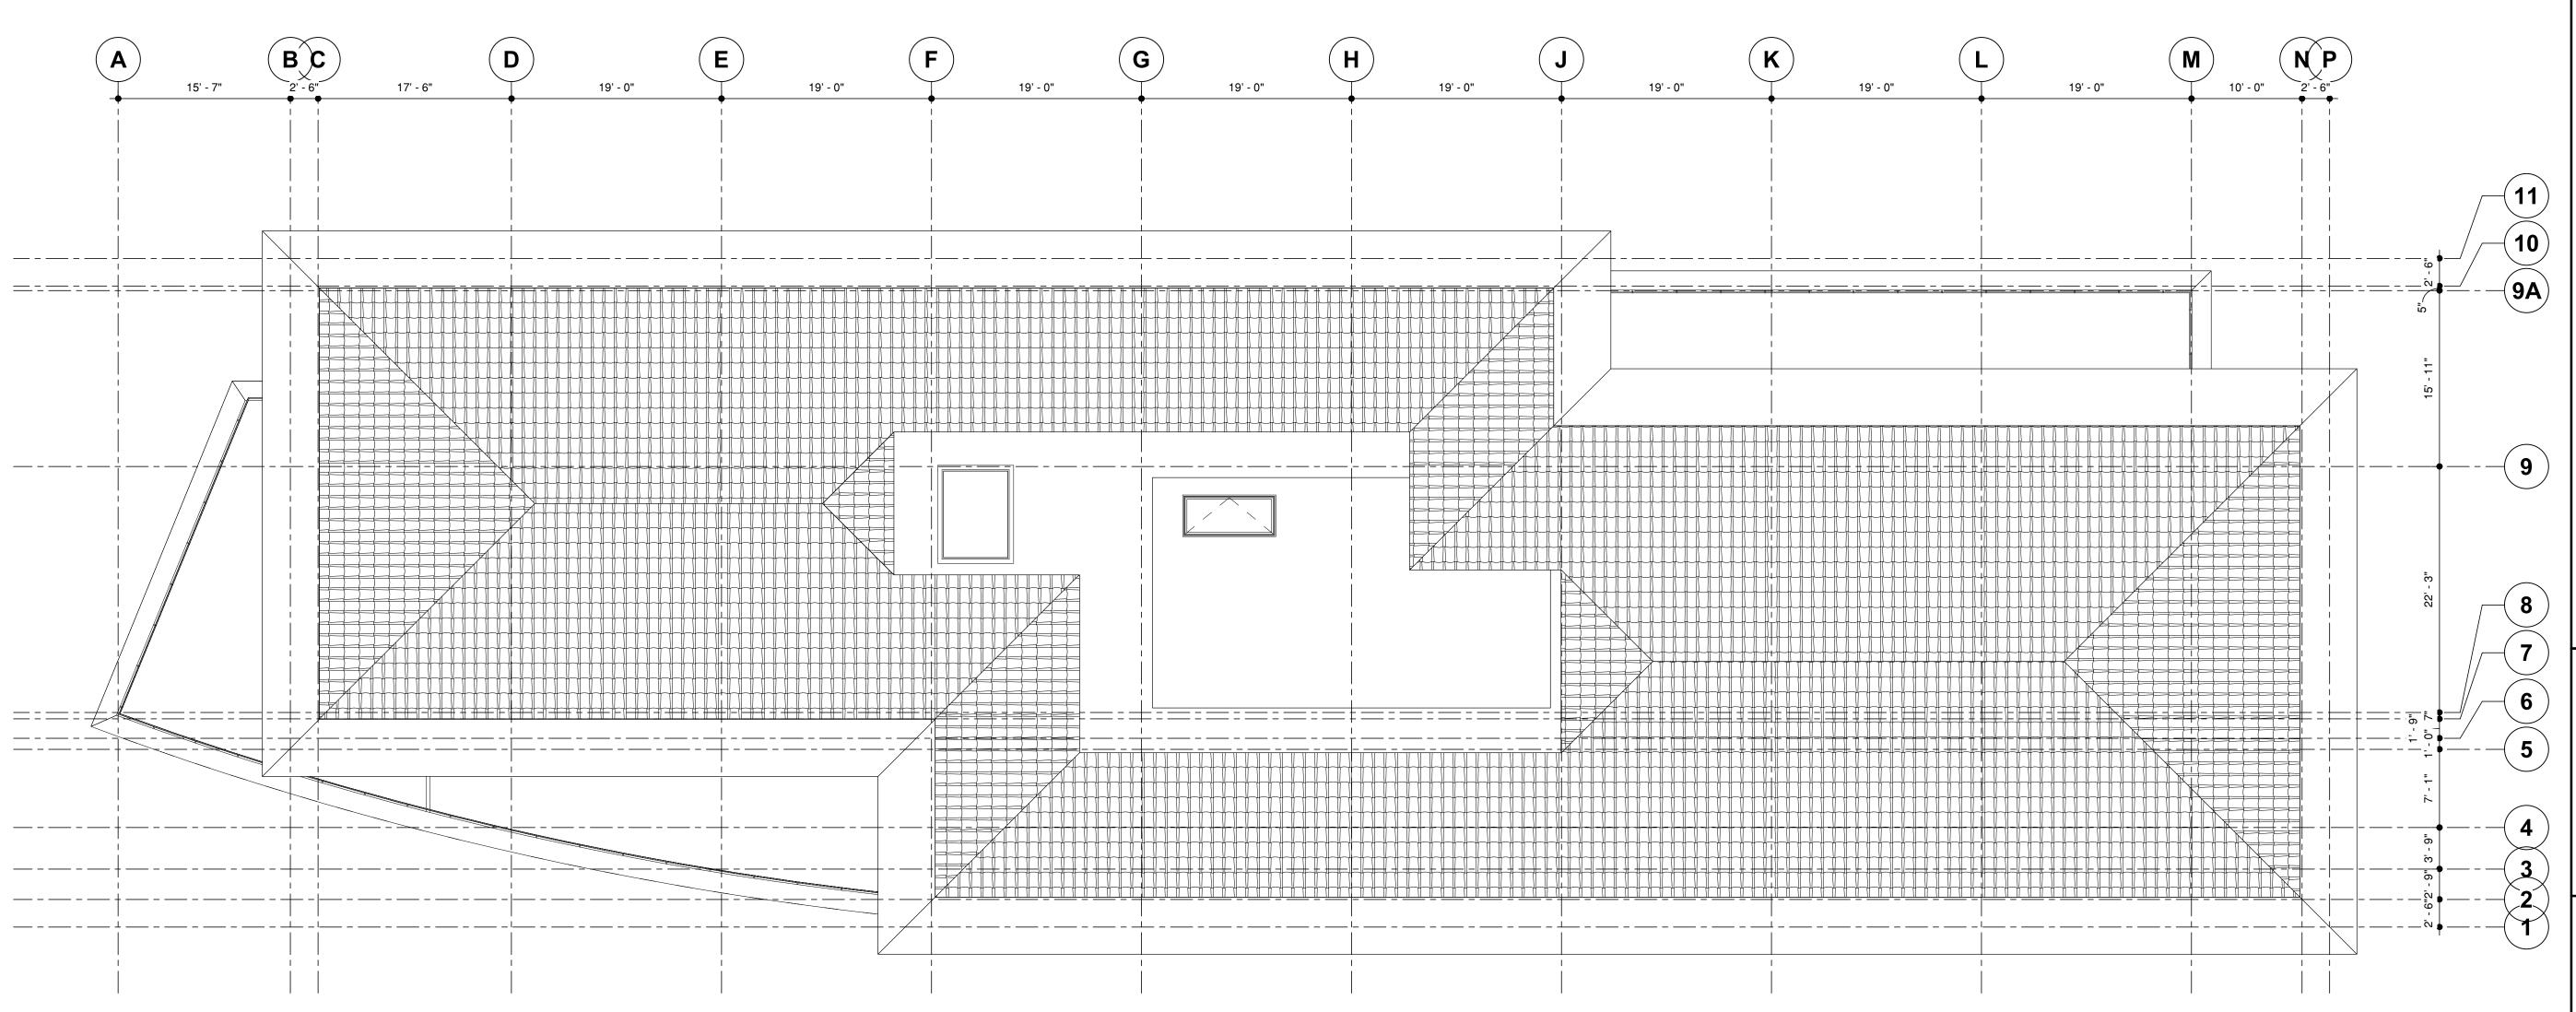DRAWN BY TK, KC, AS

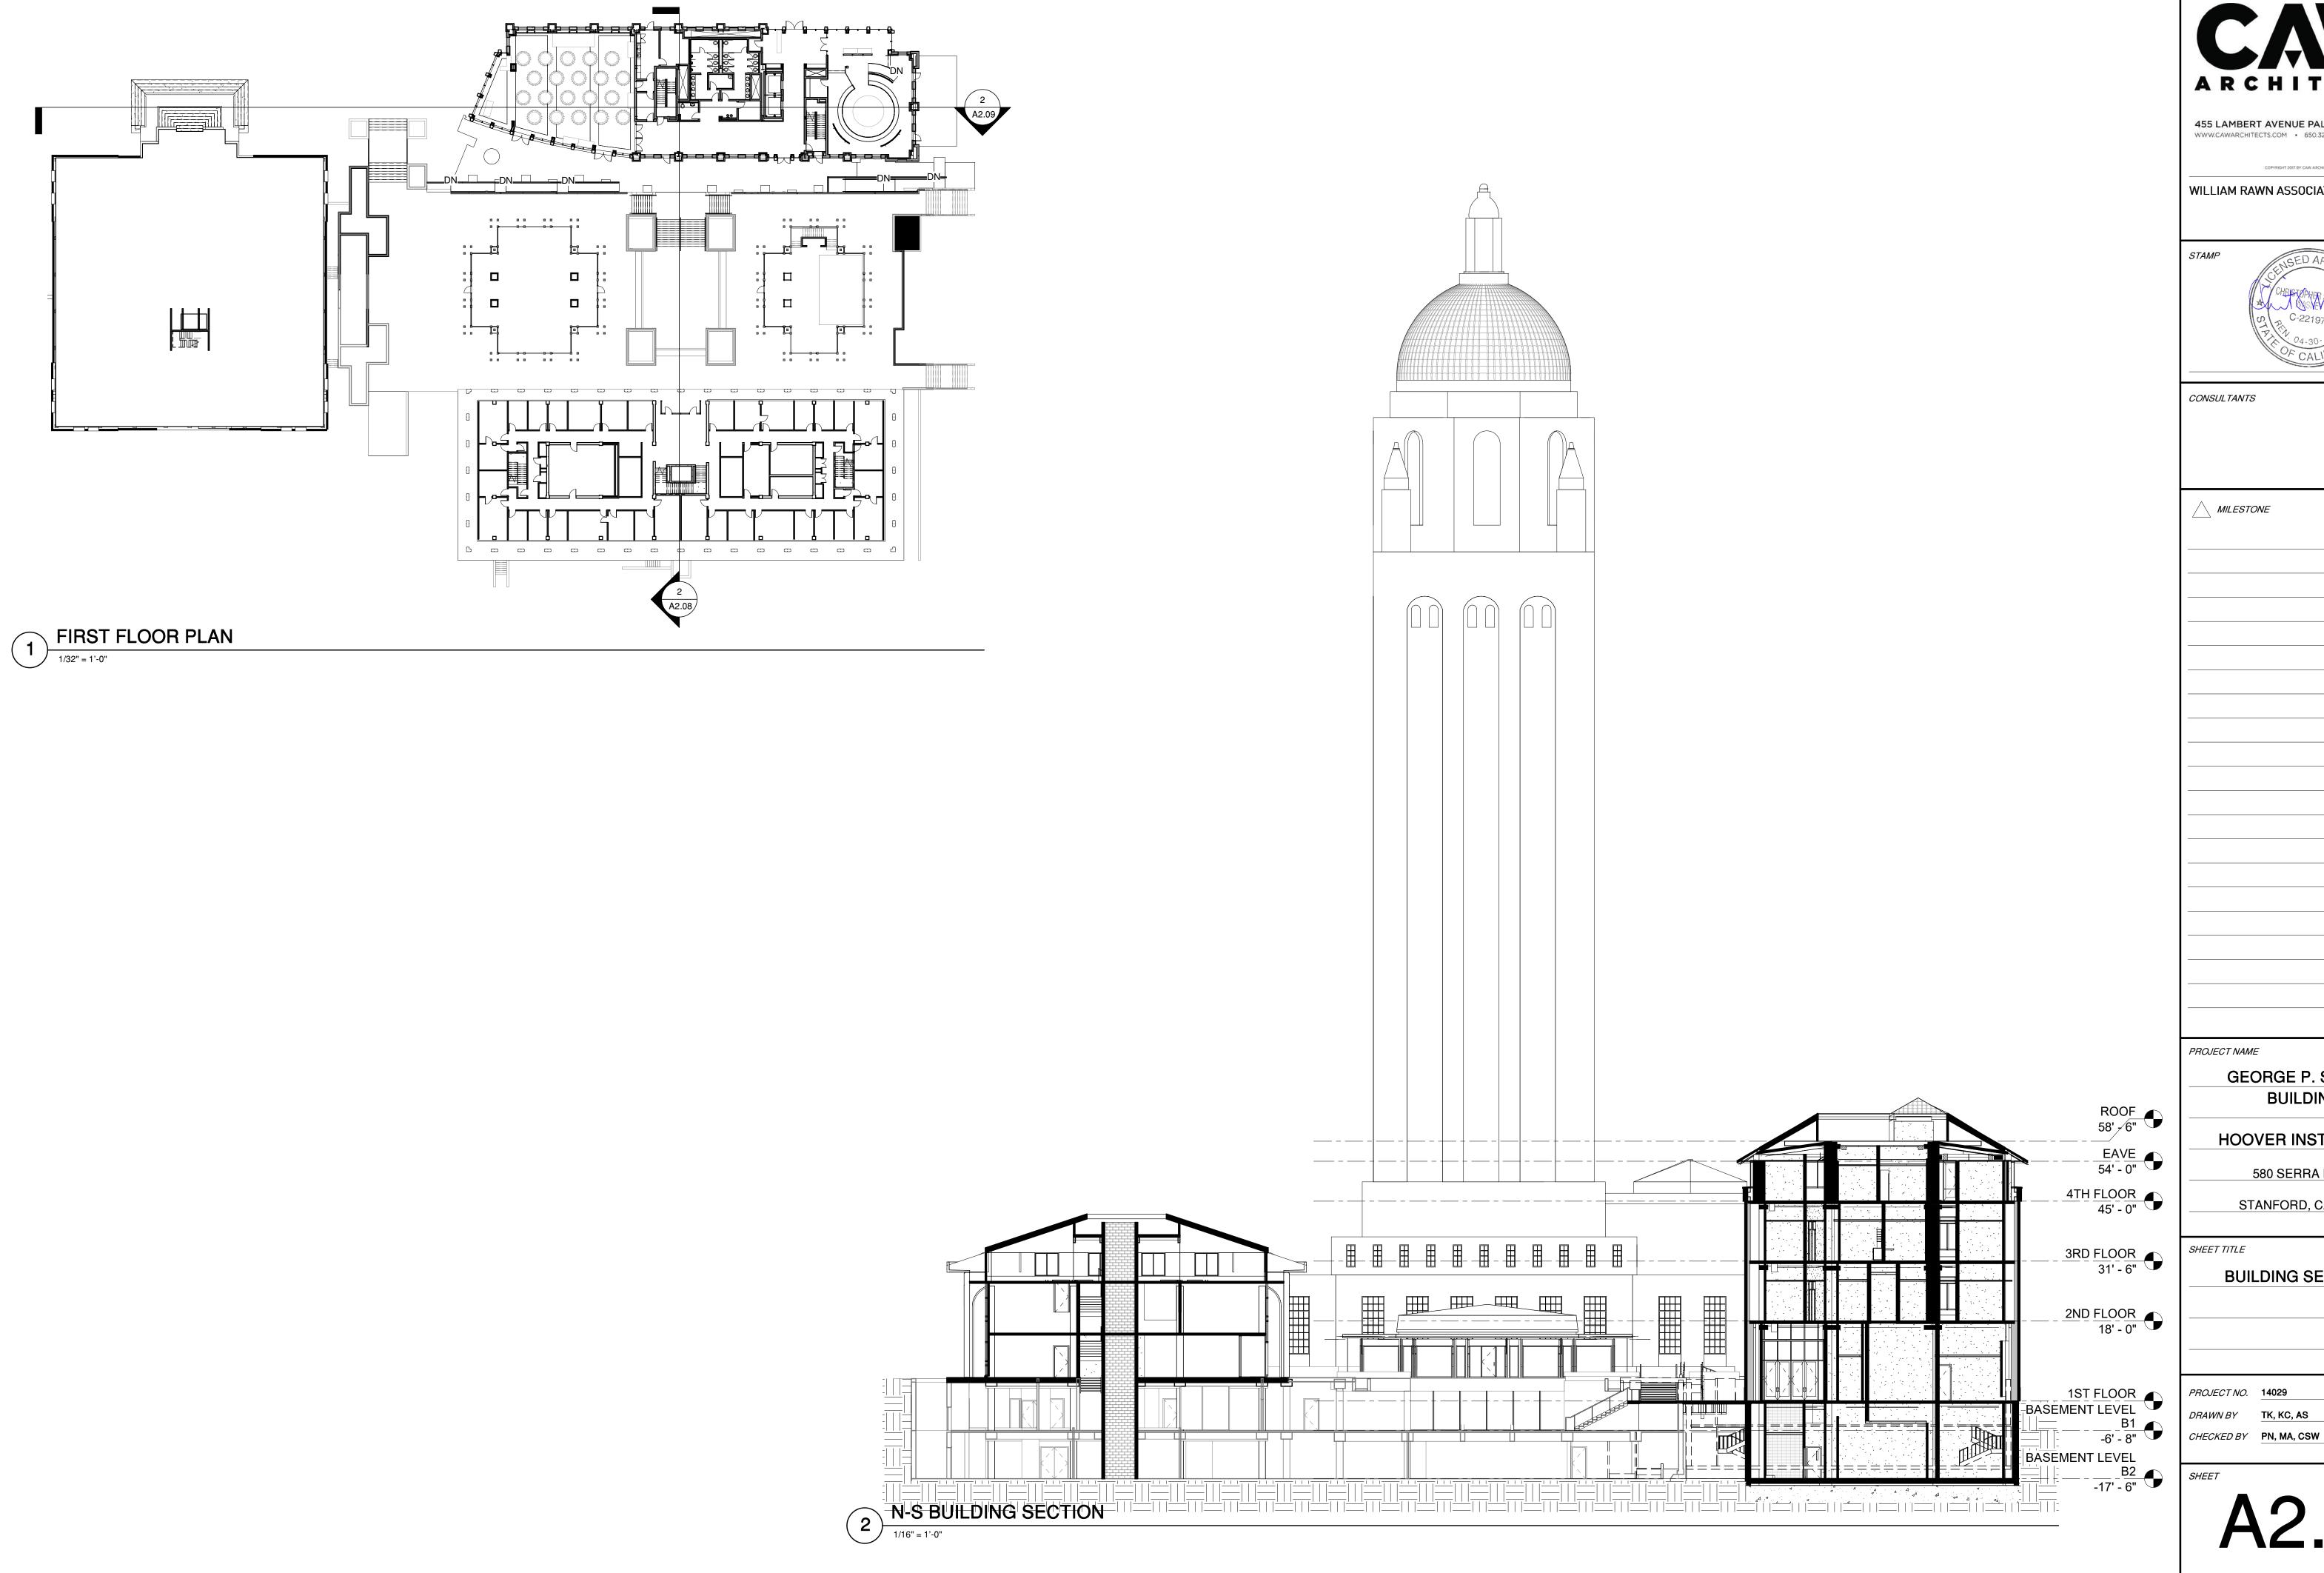



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HOOVER INSTITUTION

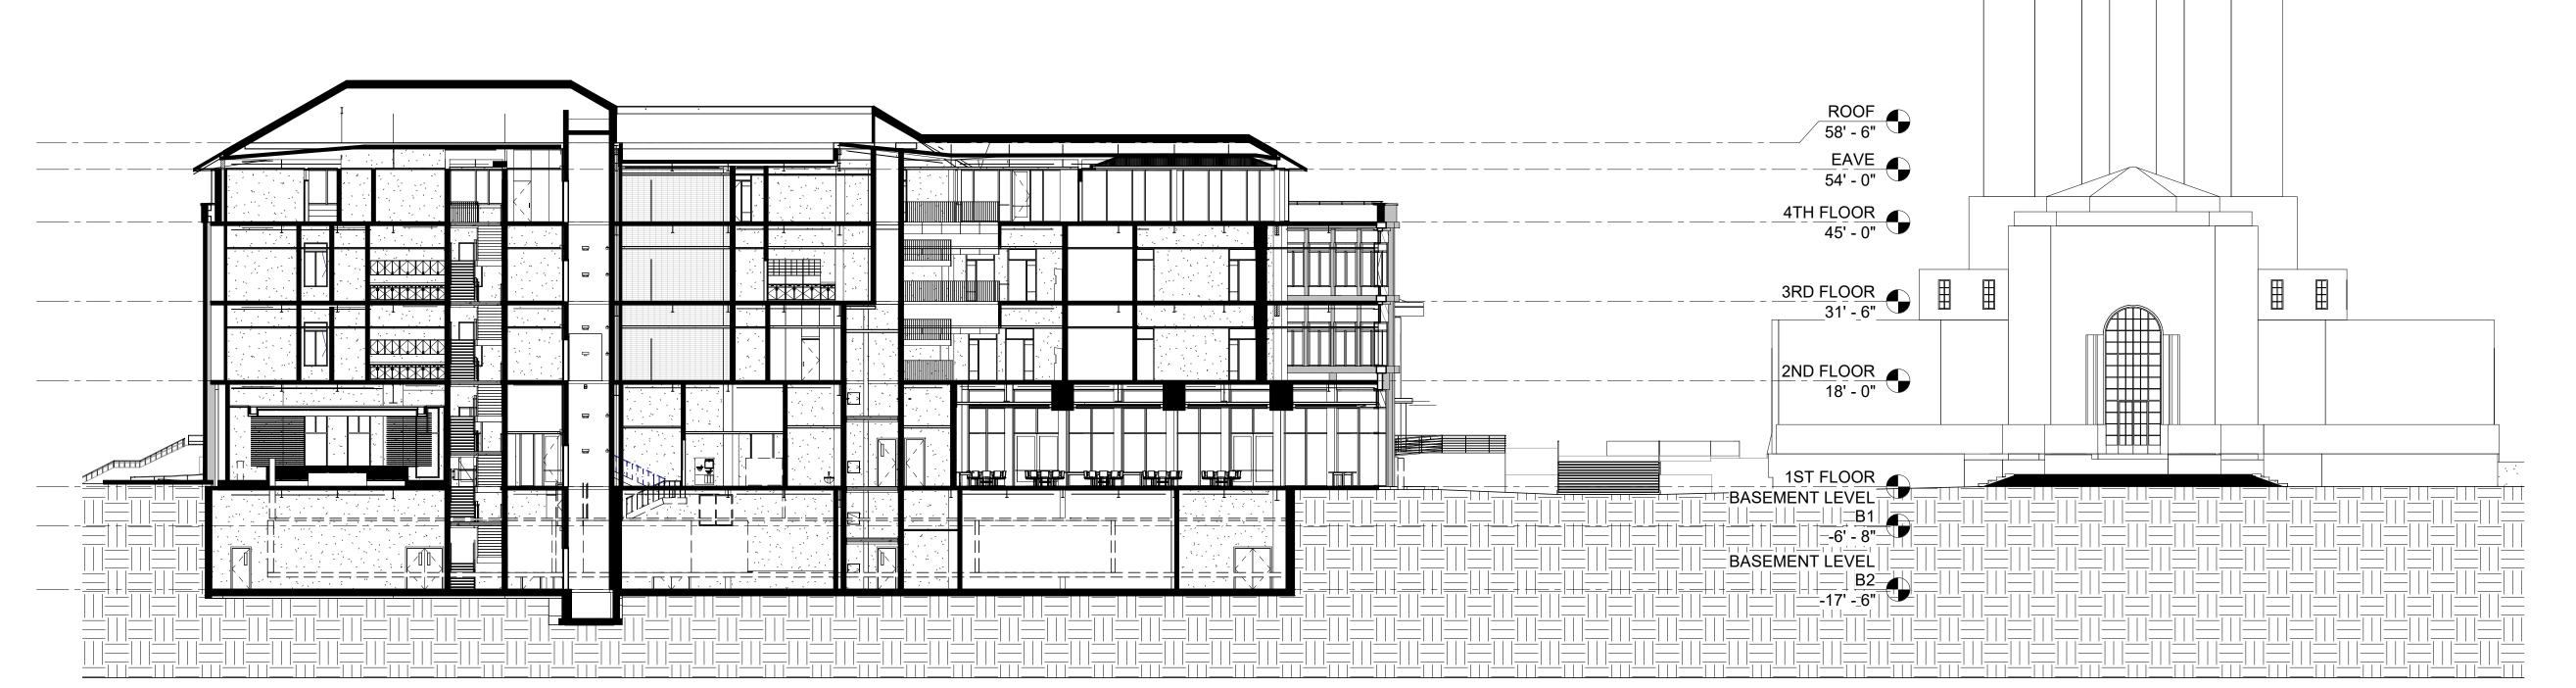580 SERRA MALL

STANFORD, CA 93405

SHEET TITLE

BUILDING SECTIONS

PROJECT NO.14029DRAWN BYTK, KC, ASCHECKED BYPN, MA, CSW


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A2.09







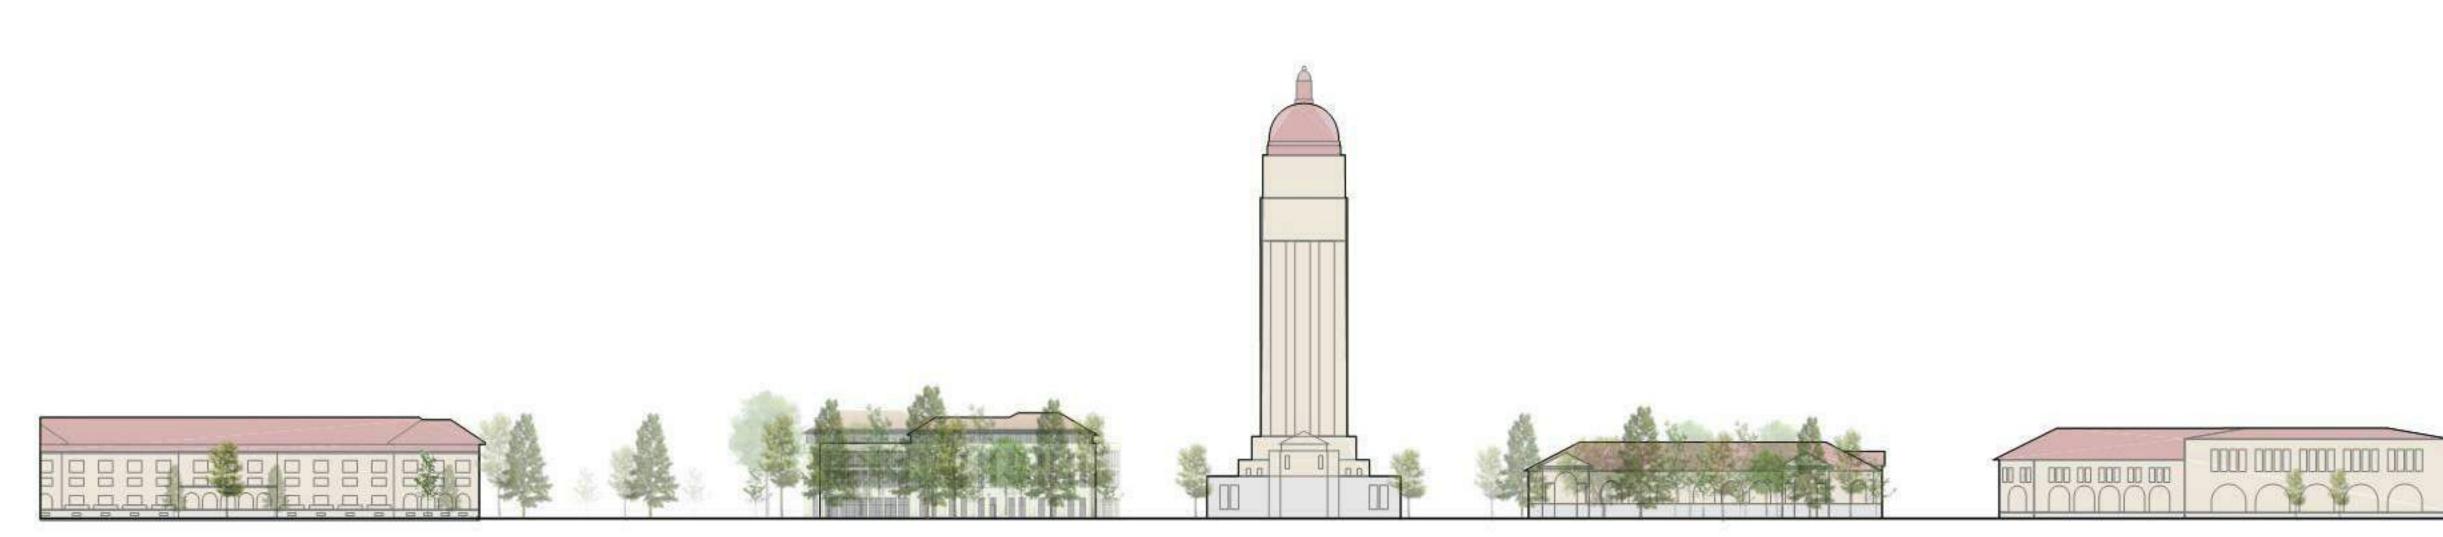

LONG ELEVATION : EAST/WEST ALONG



LONG ELEVATION: NORTH/SOUTH ALONG

CAV

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10 Post Office Sq.
Suite 1010
Boston, MA 02109



CONSULTANTS

PROJECT NAME

GEORGE P. SHULTZ BUILDING

HOOVER INSTITUTION

580 SERRA MALL

STANFORD, CA 93405

SHEET TITLE

MODEL VIEWS


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CHBISTOPHER SCOTT

CHESTOPHER SCOTT

ASME

C-22197

C-22197

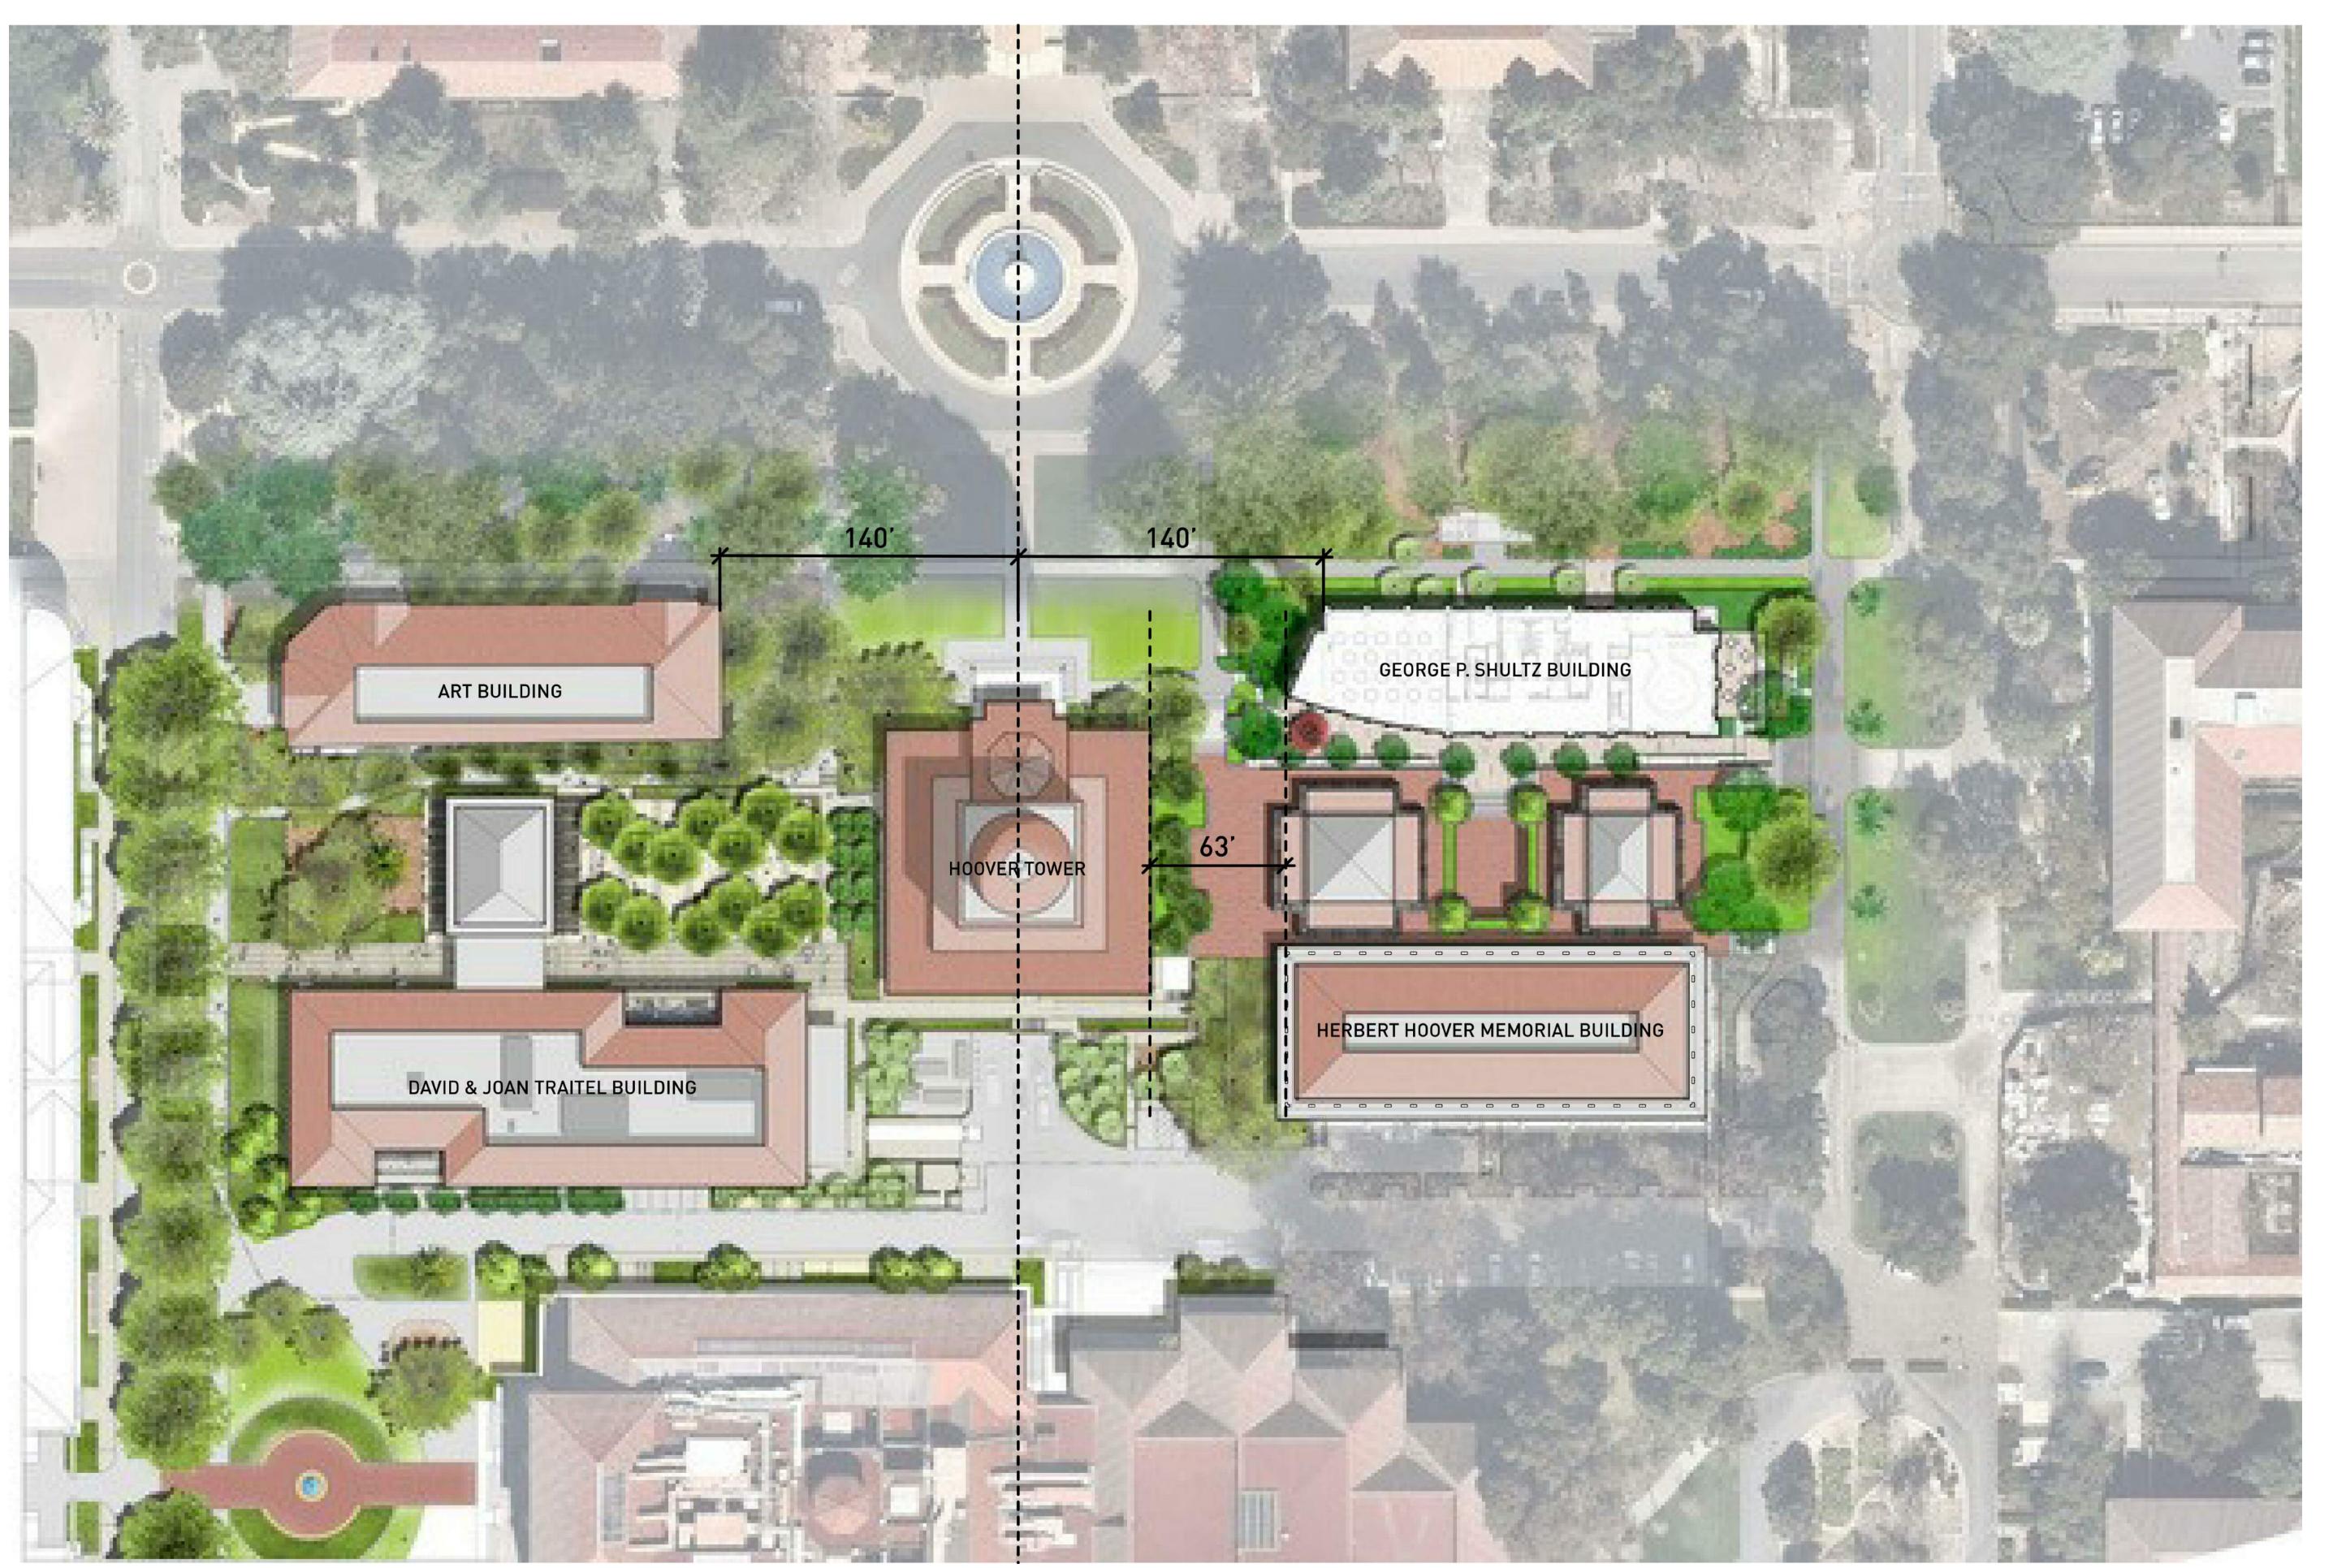C-22197

CONSULTANTS

MILESTONE DATE

PROJECT NAME

GEORGE P. SHULTZ BUILDING

HOOVER INSTITUTION

580 SERRA MALL

STANFORD, CA 93405

SHEET TITLE

SITE ALIGNMENT

PROJECT NO. 14029


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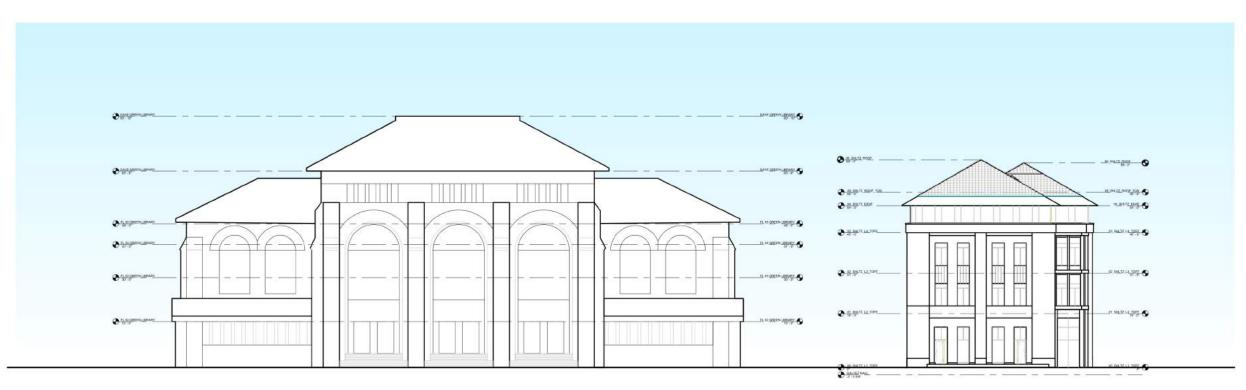
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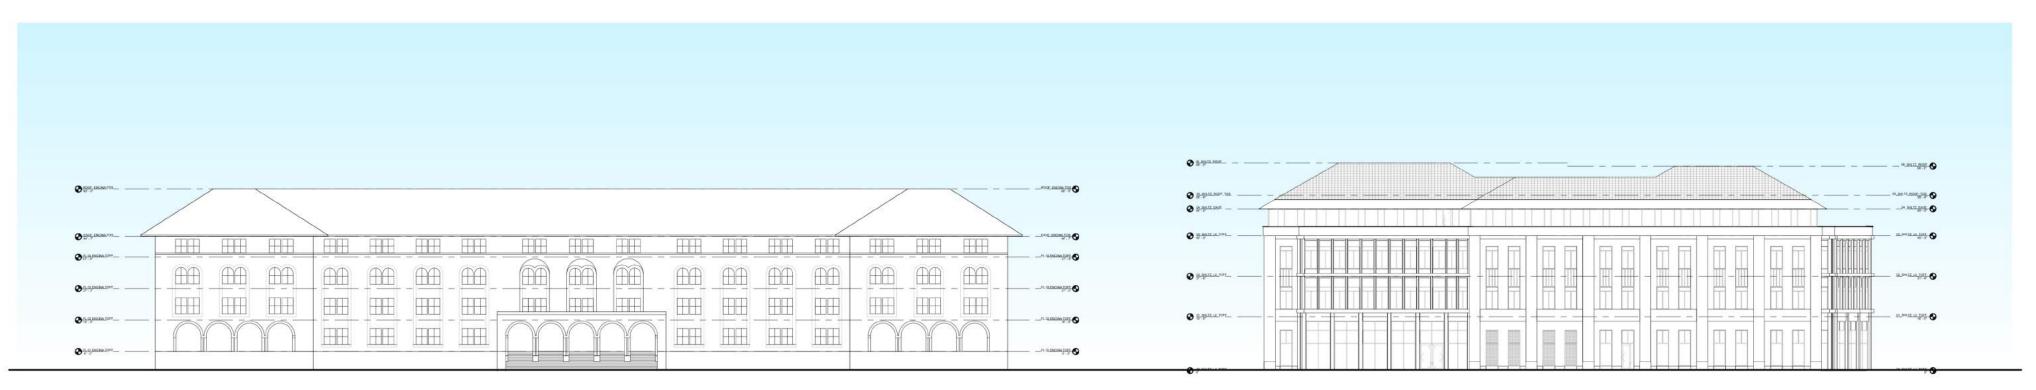
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HEIGHT COMPARISON - GREEN LIBRARY EAST WING



HEIGHT COMPARISON - GREEN LIBRARY WEST WING



HEIGHT COMPARISON - ENCINA HALL

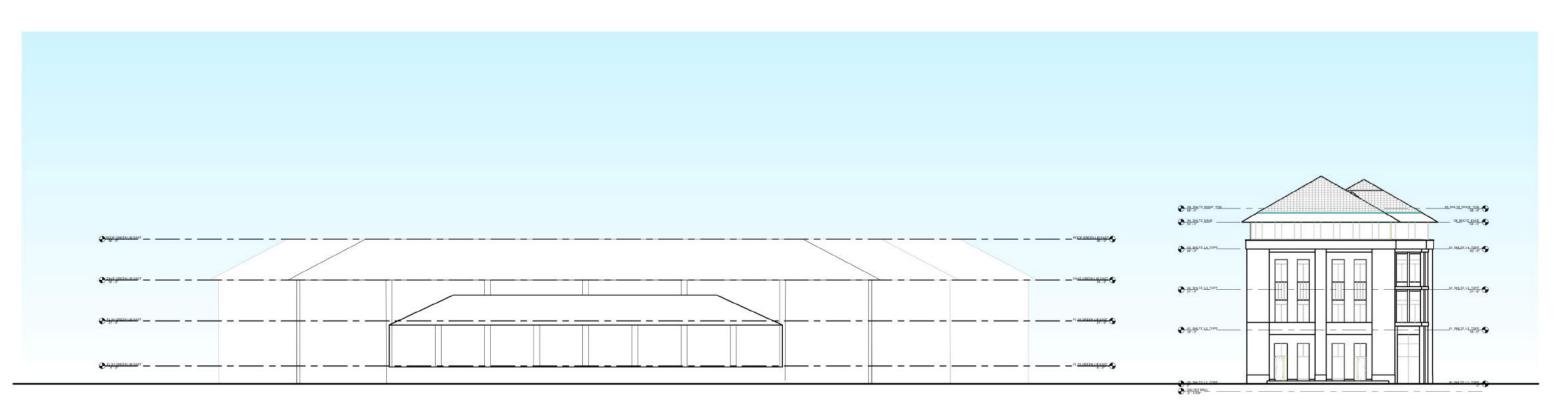

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CONSULTANTS

/ MILESTONE

DATE

PROJECT NAME

GEORGE P. SHULTZ BUILDING

HOOVER INSTITUTION

580 SERRA MALL

STANFORD, CA 93405

SHEET TITLE

HEIGHT COMPARISONS


PROJECT NO. 14029

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CONSULTANTS

MILESTONE

C ASA SUBMISSION 07/31/2019

DATE

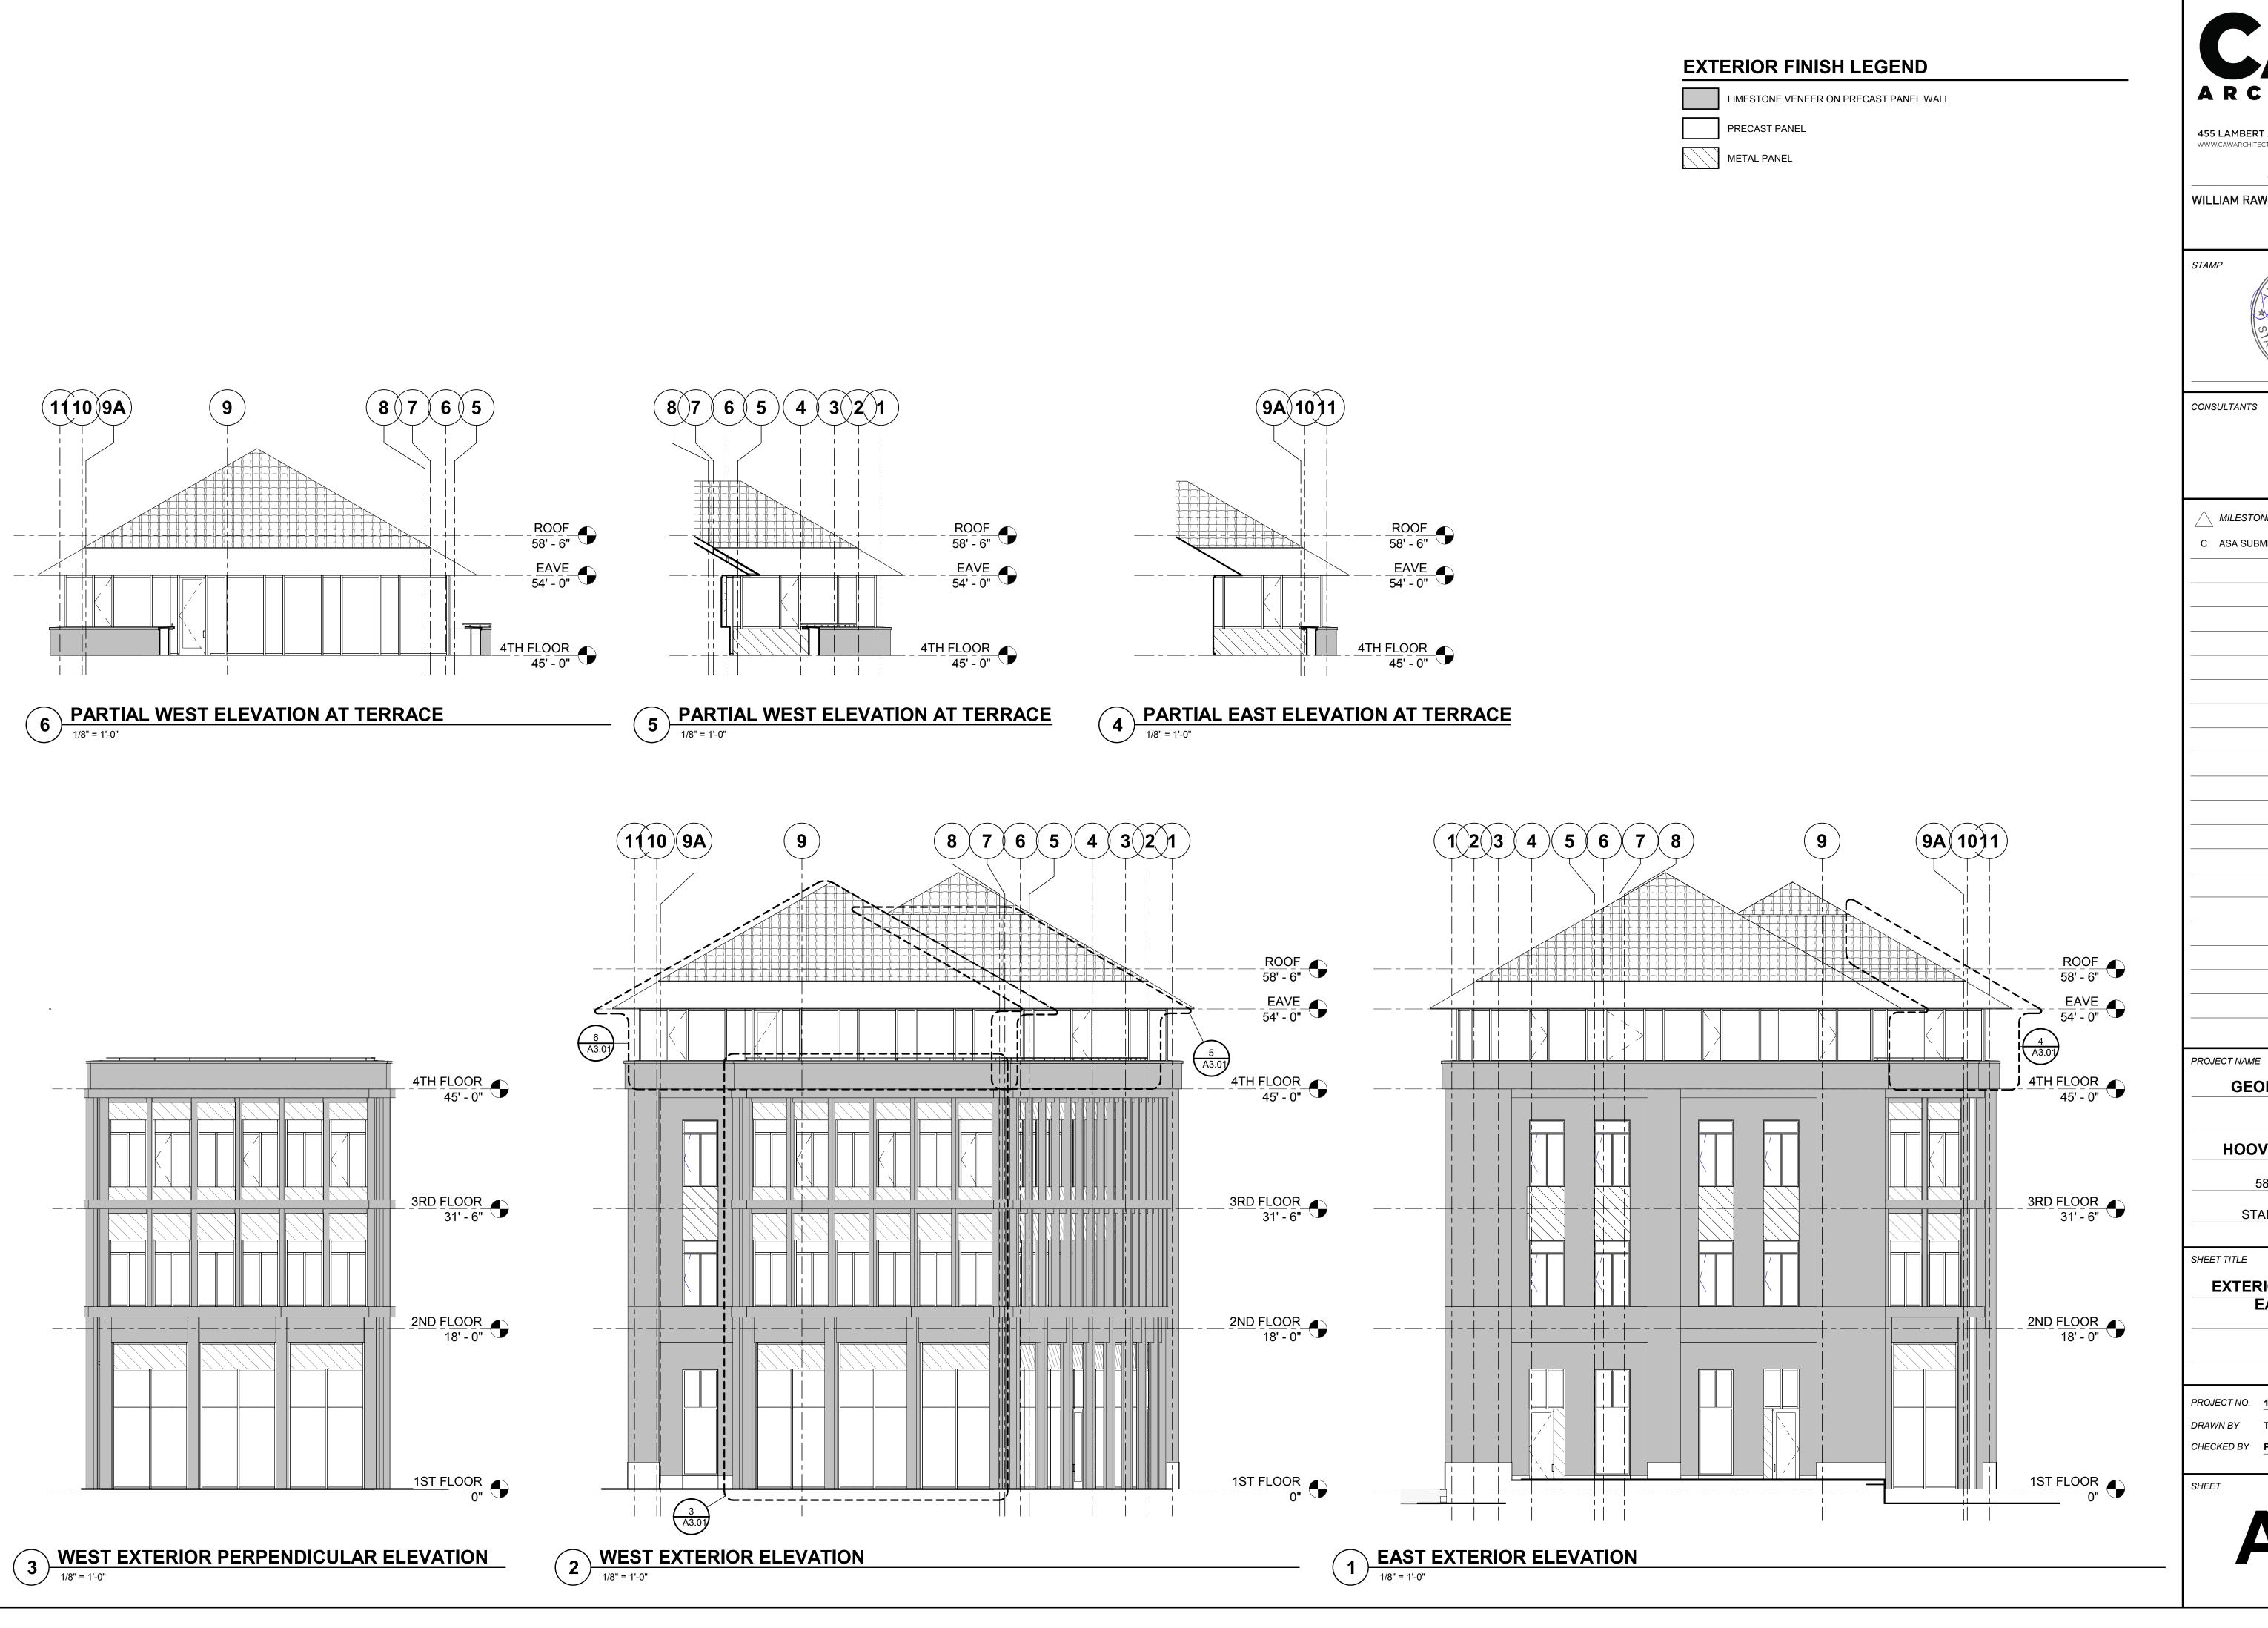GEORGE P. SHULTZ BUILDING

HOOVER INSTITUTION

580 SERRA MALL

STANFORD, CA 93405

SHEET TITLE

EXTERIOR ELEVATIONS -EAST & WEST

PROJECT NO. 14029

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A3.01


EXTERIOR FINISH LEGEND LIMESTONE VENEER ON PRECAST PANEL WALL PRECAST PANEL METAL PANEL COPYRIGHT 2017 BY CAW ARCHITECTS, INC. 10 Post Office Sq. Suite 1010 Boston, MA 02109 $(\, {f B}\,)\, (\, {f C}\,)$ CONSULTANTS MILESTONE DATE C ASA SUBMISSION 07/31/2019 4TH FLOOR 45' - 0" PARTIAL SOUTH ELEVATION AT TERRACE

1/8" = 1'-0" (\mathbf{K}) $(\mathbf{B})(\mathbf{C})$ $\left(\mathbf{D}\right)$ (\mathbf{G}) $(\,$ H)ROOF 58' - 6" EAVE 54' - 0" - 4TH FLOOR 45' - 0" PROJECT NAME **GEORGE P. SHULTZ** BUILDING **HOOVER INSTITUTION** - 3RD FLOOR 31' - 6" 580 SERRA MALL STANFORD, CA 93405 SHEET TITLE **EXTERIOR ELEVATIONS -**- 2ND FLOOR 18' - 0" SOUTH PROJECT NO. 14029 - - 1ST FLOOR 0" 1 SOUTH EXTERIOR ELEVATION

1/8" = 1'-0"


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NORTH EXTERIOR ELEVATION

1/8" = 1'-0"

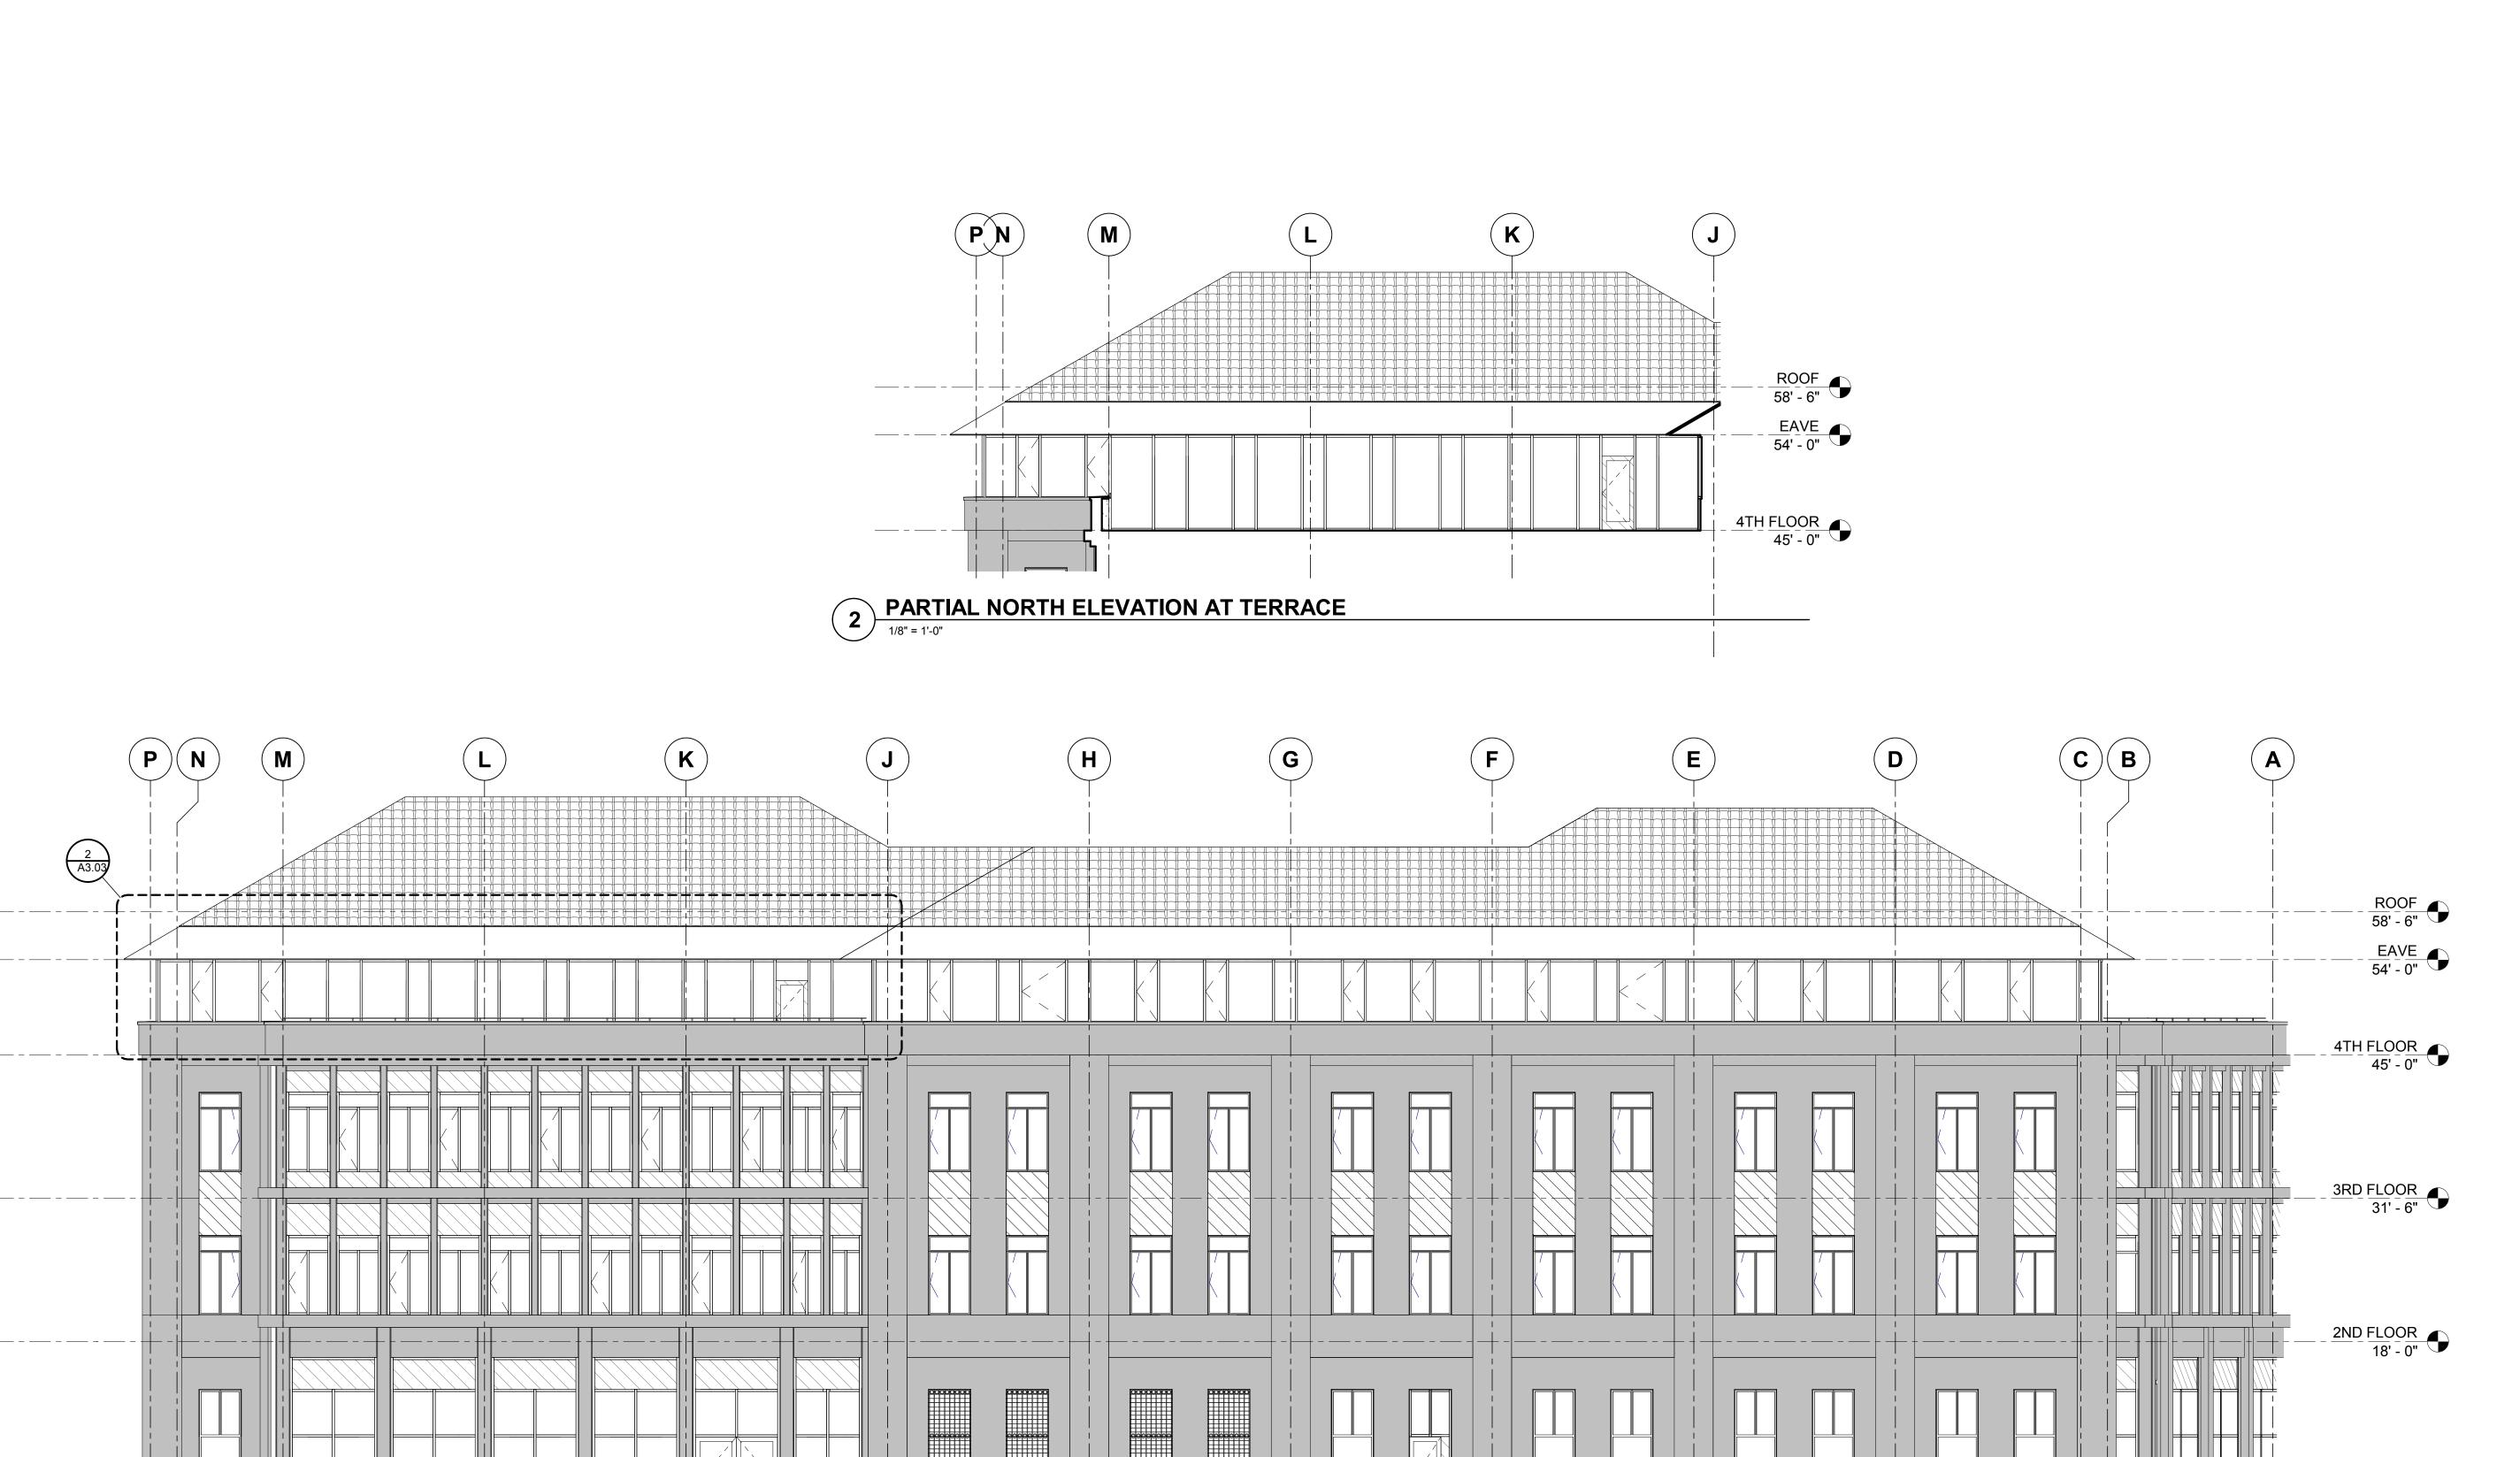

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C-22197

CONSULTANTS

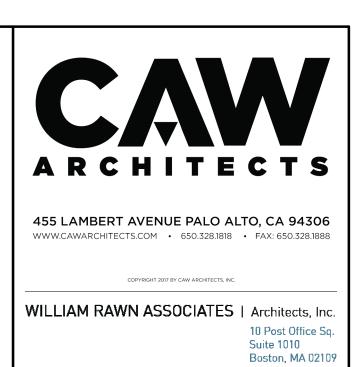EXTERIOR FINISH LEGEND

PRECAST PANEL

METAL PANEL

LIMESTONE VENEER ON PRECAST PANEL WALL

MILESTONE DATE

C ASA SUBMISSION 07/31/2019

PROJECT NAME

GEORGE P. SHULTZ BUILDING

HOOVER INSTITUTION
580 SERRA MALL

STANFORD, CA 93405

SHEET TITLE

EXTERIOR ELEVATIONS - NORTH

PROJECT NO. 14029

DRAWN BY TK, KC

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SHEET

1ST FLOOR 0"

A3.03