

AREA MAP



VICINITY MAP

BUILDING SITE APPROVAL/ GRADING AND DRAINAGE PLAN/ SEPTIC SYSTEM PLAN

PREPARED FOR:
PROPERTY LOCATION:
VINOD AND JANAK BANSAL
11391 CLAYTON ROAD
SAN JOSE, CALIFORNIA 95127

A.P.N.	612-37-016
PROPOSED LIVING AREA	4,450 SQUARE FEET
NUMBER OF BEDROOMS	3
LOT AREA	1.00 Ac. (43,560 SQUARE FEET)
ZONING	HS-D1
PROPOSED F.A.R.	4450/43560 x 100 = 10.2%

FRONT SETBACK	30'
REAR SETBACK	30'
SIDE SETBACK	30'
MAXIMUM NUMBER OF STORIES	2
MAXIMUM HEIGHT	35'
CONSTRUCTION TYPE	VN

SHEET INDEX

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SITE INFORMATION

GEOTECHNICAL ENGINEER

RICK HALTENHOFF
ASSOCIATED TERRA CONSULTANTS, INC.
1735 DELL AVENUE
CAMPBELL, CALIFORNIA 94030
PHONE (408) 866-1067
FAX (408) 866-1047

CIVIL ENGINEER

ANDREW E. ARNOLD, P.E.
STEVEN ARNOLD CIVIL ENGINEERING, INC.
492 PRINCE STREET
OAKLAND, CALIFORNIA 94610
PHONE (415) 786-9622
FAX (415) 871-2582
EMAIL arnoldengineering@comcast.net

OWNERS

VINOD AND JANAK BANSAL
3522 ADEGA CIRCLE
SAN JOSE, CALIFORNIA 95148
PHONE (650) 533-9484

ARCHITECTURAL DRAFTING/DESIGNER

JONATHAN COULTER
930 SAN BENITO STREET
HOLLISTER, CALIFORNIA 95023
PHONE (831) 537-4040

- NEW DRIVEWAY AND TURNAROUND WILL BE CONSTRUCTED AS SHOWN FOR ACCESS.
- NEW SEPTIC SYSTEM AND LEACH FIELD WILL BE INSTALLED AS SHOWN.
- NEW SINGLE FAMILY RESIDENTIAL CUSTOM HOME OF UP TO MAX. 3 BEDROOMS AND A MAXIMUM OF 4,450 SQUARE FEET OF LIVING SPACE WILL BE CONSTRUCTED AS SHOWN.
- DRAINAGE IMPROVEMENTS AND UTILITIES WILL BE INSTALLED AS SHOWN.
- NEW ROADWAY IMPROVEMENTS ARE PROPOSED FOR THE PRIVATE ACCESS ROAD FROM CLAYTON ROAD UP TO THE 45' EASEMENT EXTENSION.

CONSULTANTS

PROJECT DESCRIPTION

STEVEN ARNOLD CIVIL ENGINEERING, INC.
492 PRINCE STREET
OAKLAND, CALIFORNIA 94610
PHONE (415) 786-9622
EMAIL arnoldengineering@comcast.net



MARK	REVISIONS	DATE
	DEH REVIEW	01/11/2010
	ARCH. CHANGES	06/18/2010
	REVIEW DRAWINGS	01/25/2013
	DRX/BSA/GS SUBMITTAL	04/10/2013
	COMMENTS DATED 06/13/2013	12/10/2013
	COMMENTS DATED 01/21/2014 EMAIL DATED 03/17/2014	08/13/2014
	COMMENTS DATED 09/22/2014	12/04/2014
	DEH EMAIL COMMENTS 01/20/2015	02/18/2015

PROJECT TITLE

NEW CUSTOM HOME
LANDS OF BANSAL
11391 CLAYTON ROAD
SAN JOSE, CALIFORNIA, 95127

APN: 612-37-016

SHEET TITLE

COVER SHEET/
INDEX

DATE
FEBRUARY 18, 2015

SCALE
AS SHOWN


DRAWN
AEA

JOB
03-07

SHEET

C1


CLAYTON ROAD

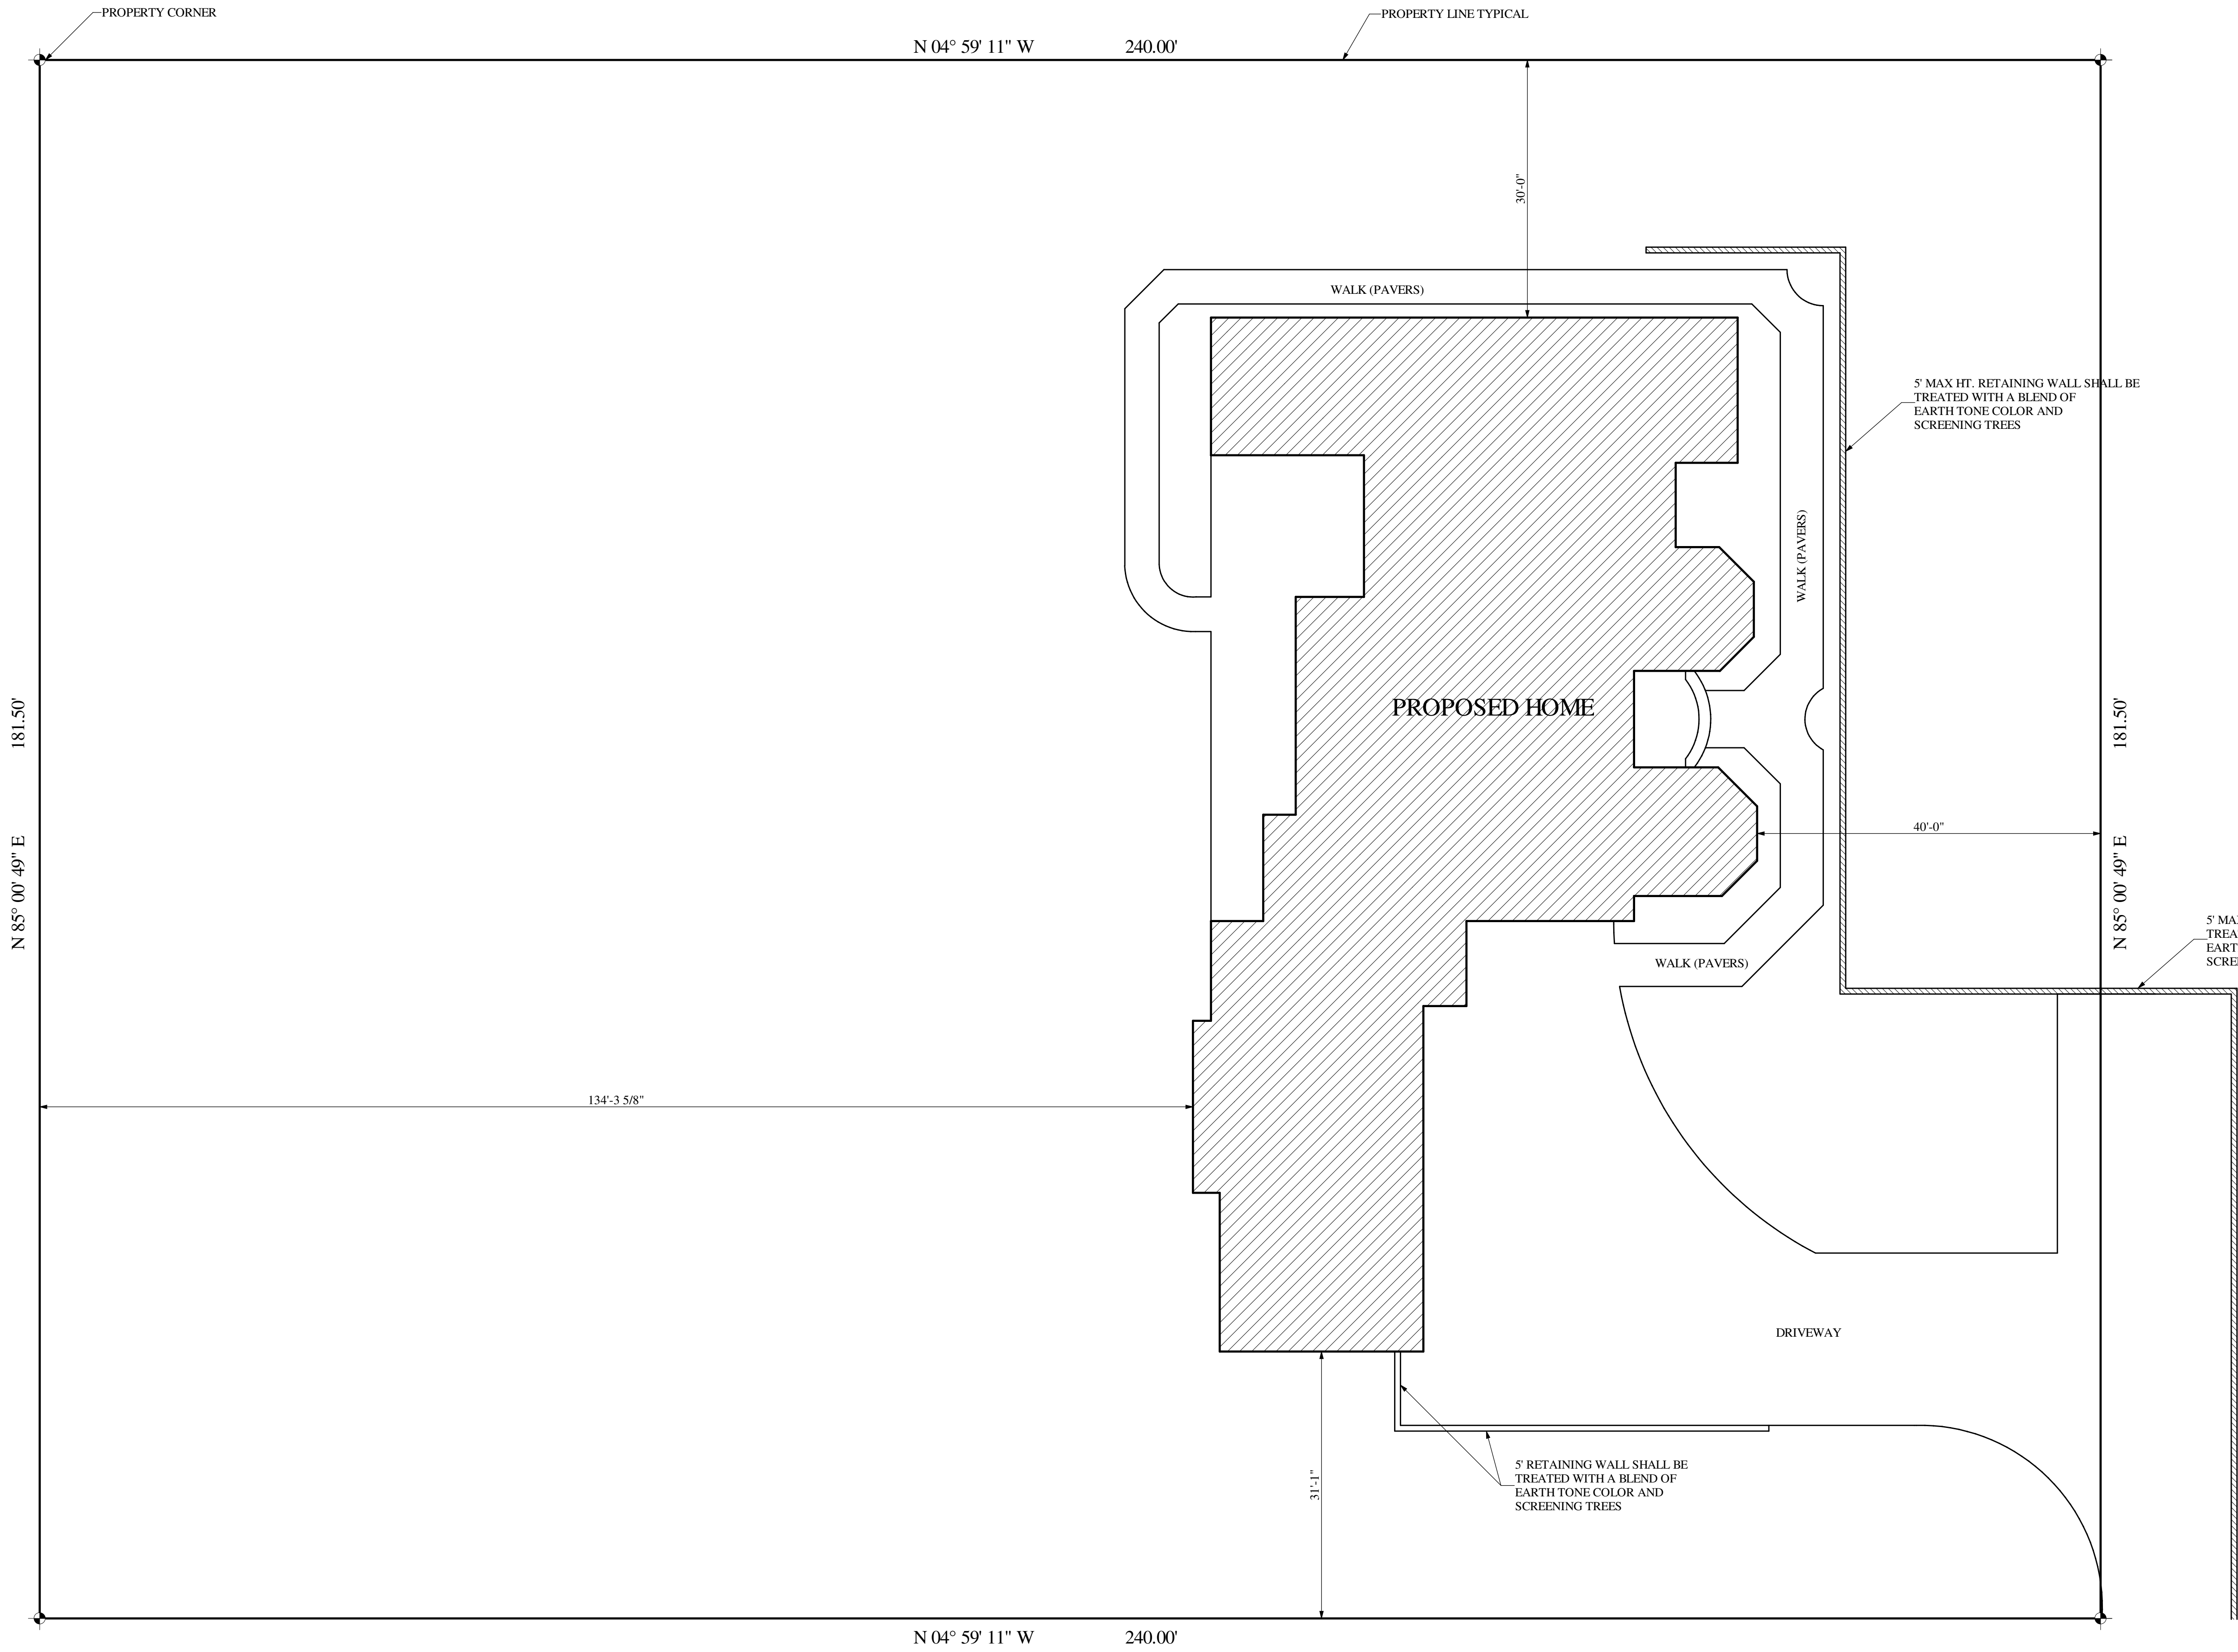

Site Plan

SCALE: 1"=10'

PLAN FOR:	MR & MRS BANSAL 11391 CLAYTON ROAD SAN JOSE, CA. 95127 (650) 533-9484
BY:	Jonathan Coulter 930 San Benito Street Hollister, Ca. 95023 Phone: (831) 637-8059 (831) 537-4040
DATE	
SCALE	
SHEET	A0

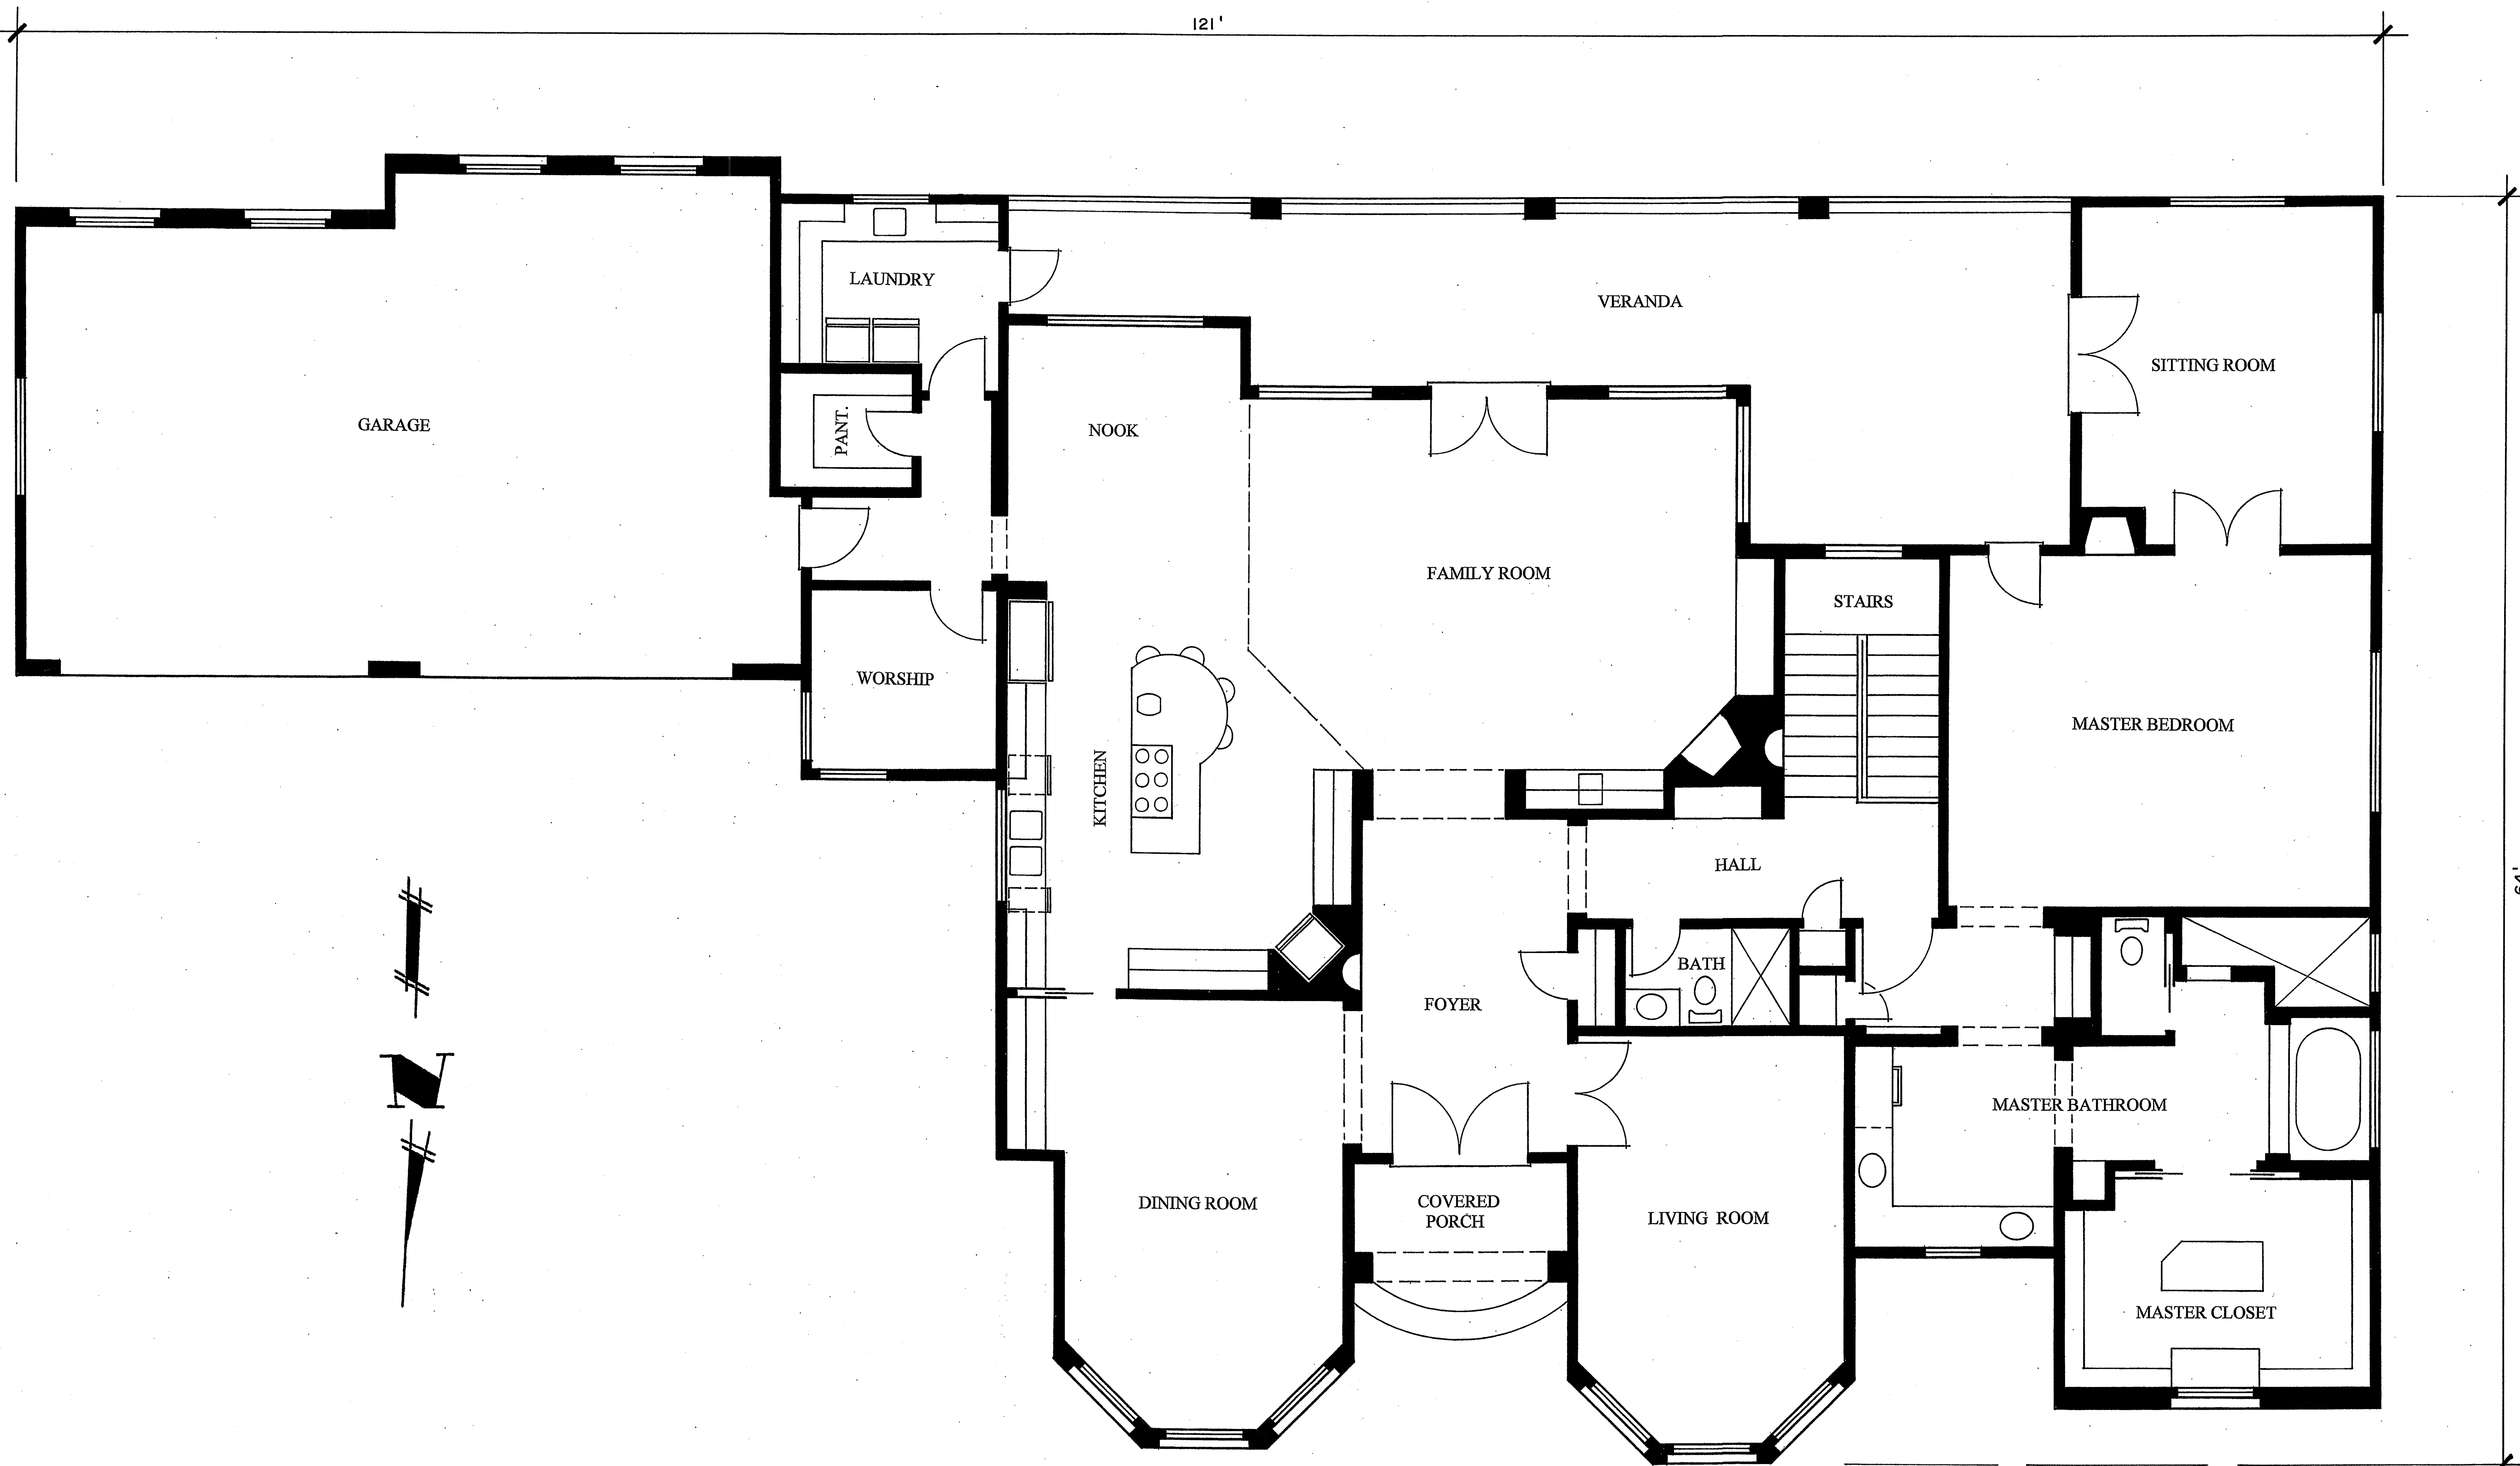


MAIN FLOORPLAN

SCALE: 1/4" = 1'-0"

TOTAL LIVING AREA
BOTH FLOORS= 4450 SF

PLAN BY:	Jonathan Coulter 930 San Benito Street Hollister, Ca. 95023 Phone: (831) 637-8059 (831) 537-4040
PLAN FOR:	MR. & MRS. BANSAL 11391 CLAYTON ROAD SAN JOSE, CA. 95127 (650) 533-9484
DATE	09/14/10
SCALE	
SHEET	A/

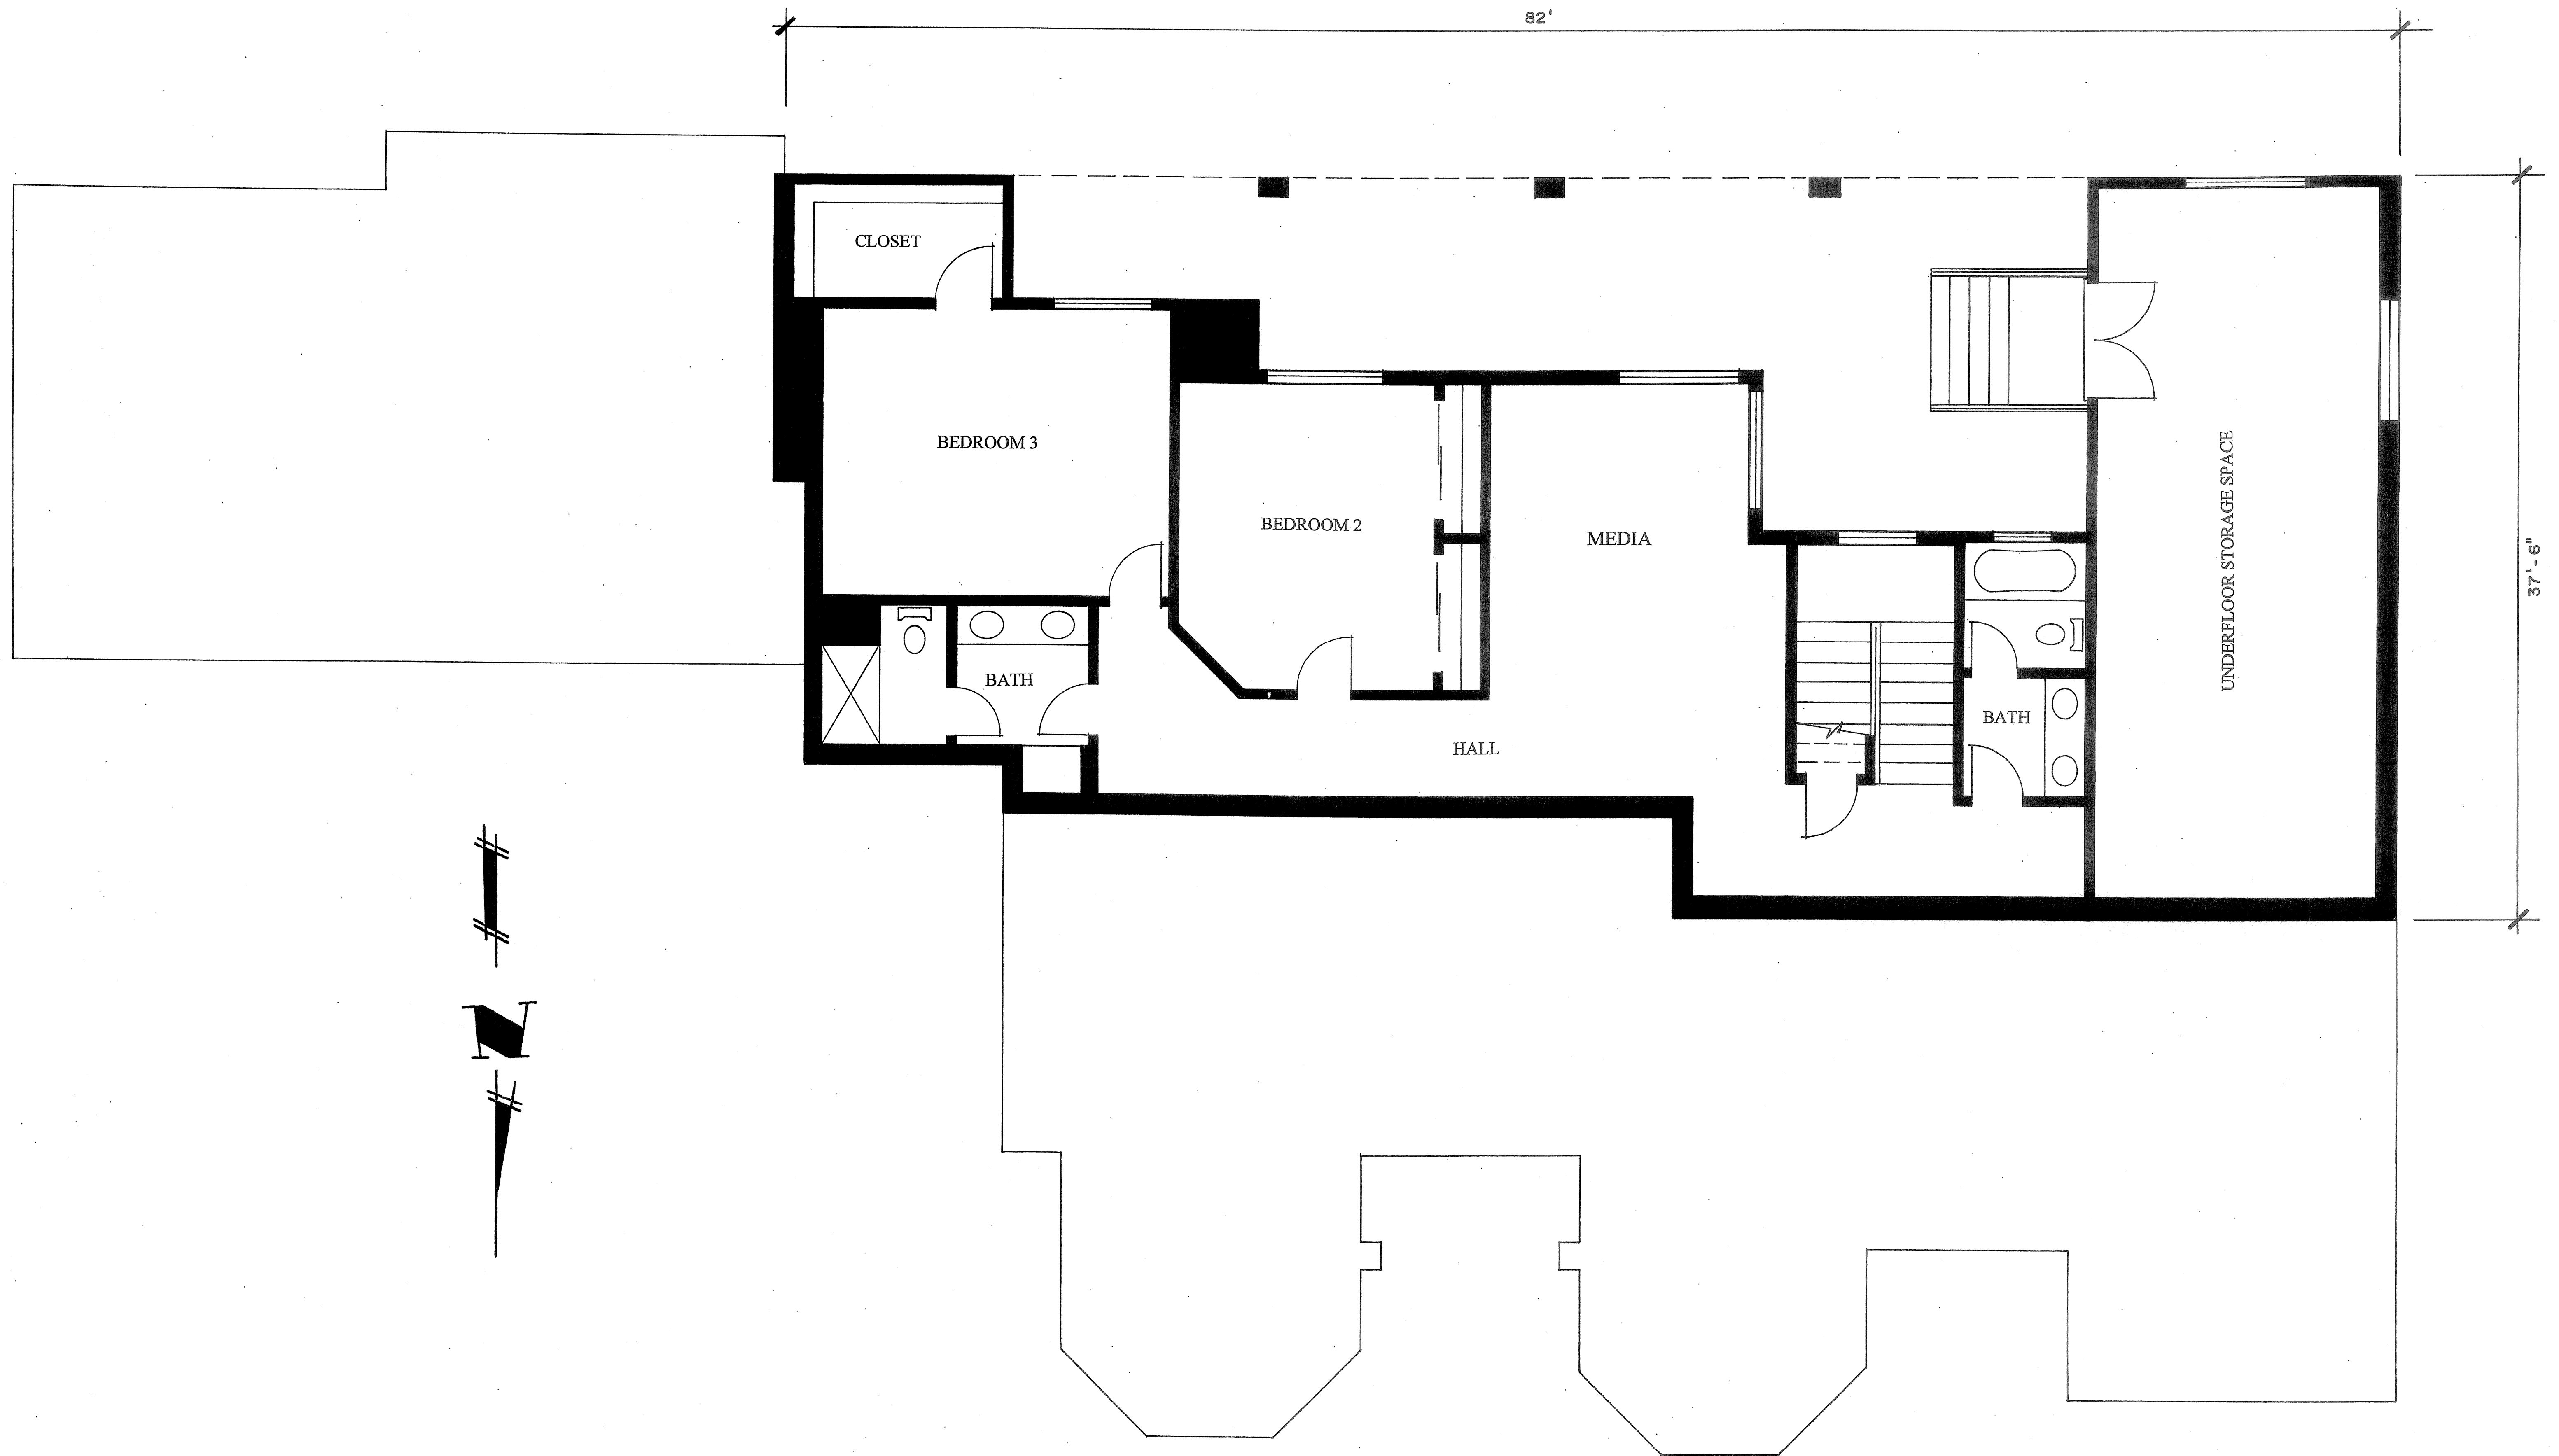


LOWER FLOORPLAN

SCALE: 1/4" = 1'-0"

TOTAL LIVING AREA
BOTH FLOORS= 4450 SF

PLAN BY: Jonathan Coulter 930 San Benito Street Hollister, Ca 95023 Phone: (831) 637-8059 (831) 537-4040	PLAN FOR: MR. & MRS. BANSAL 11331 CLAYTON ROAD SAN JOSE, CA. 95127 (650) 553-9484
DATE	SCALE
SHEET	

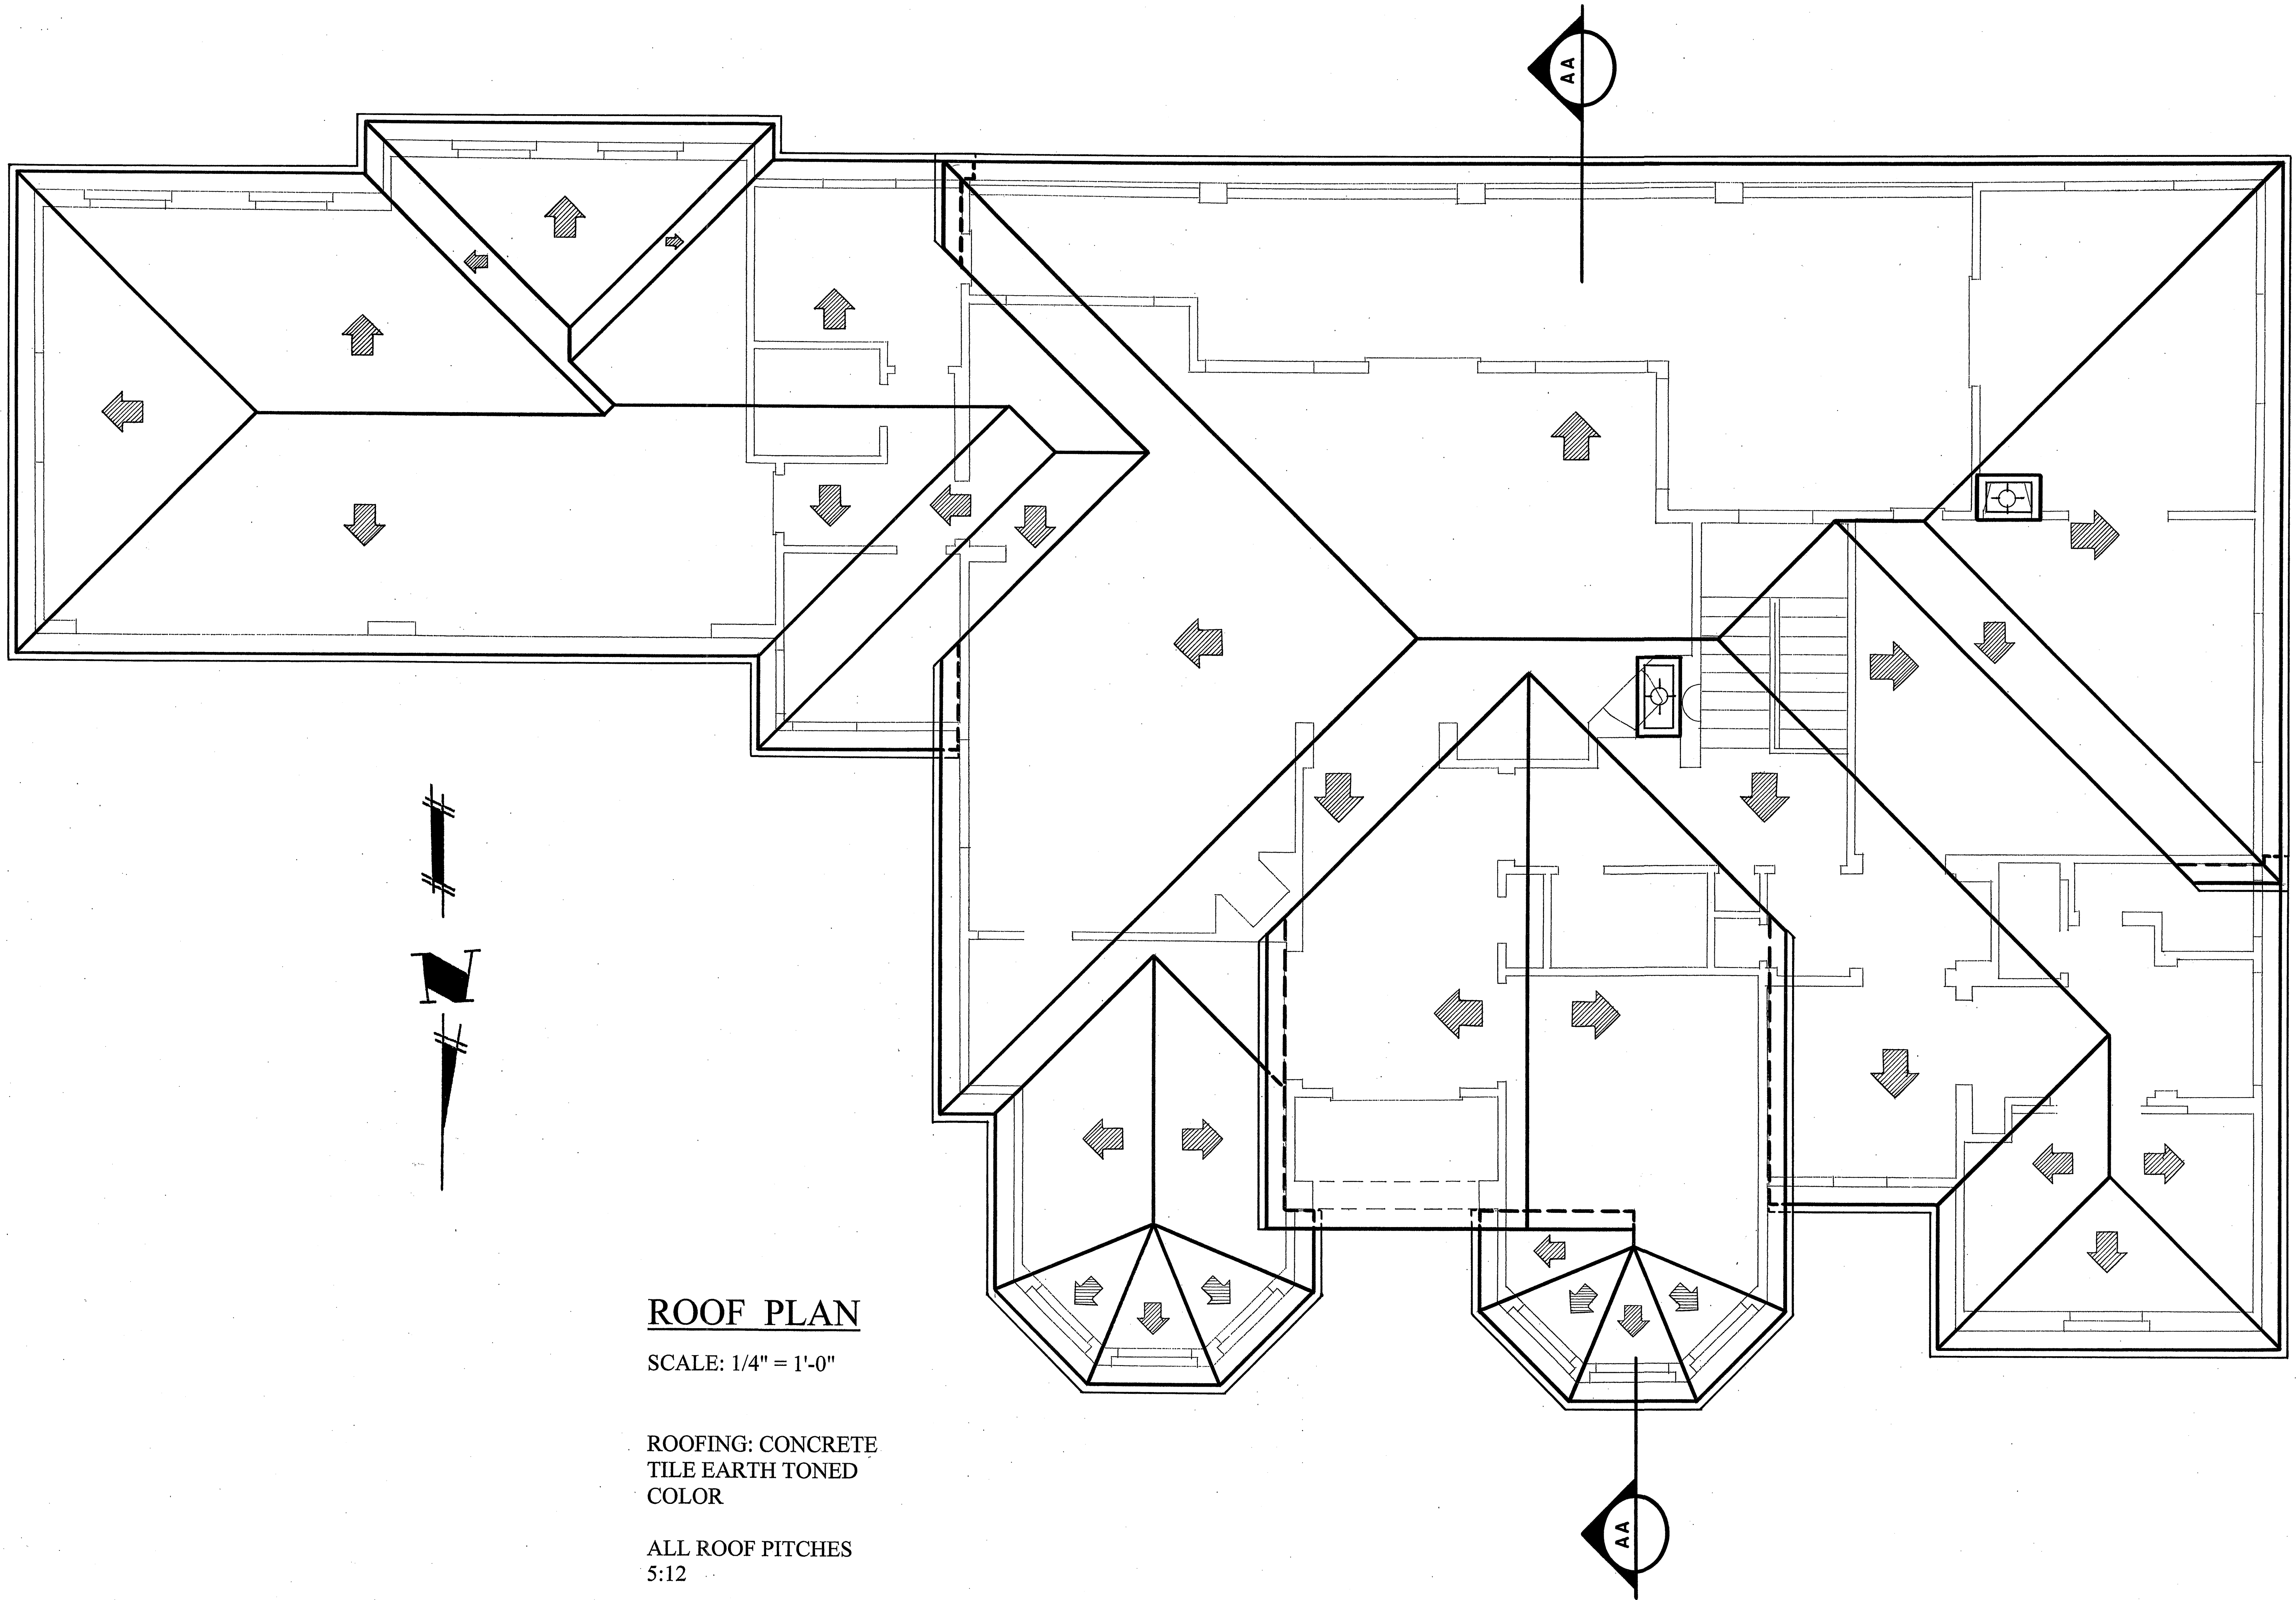


ROOF PLAN

SCALE: 1/4" = 1'-0"

ROOFING: CONCRETE
TILE EARTH TONED
COLOR

ALL ROOF PITCHES
5:12

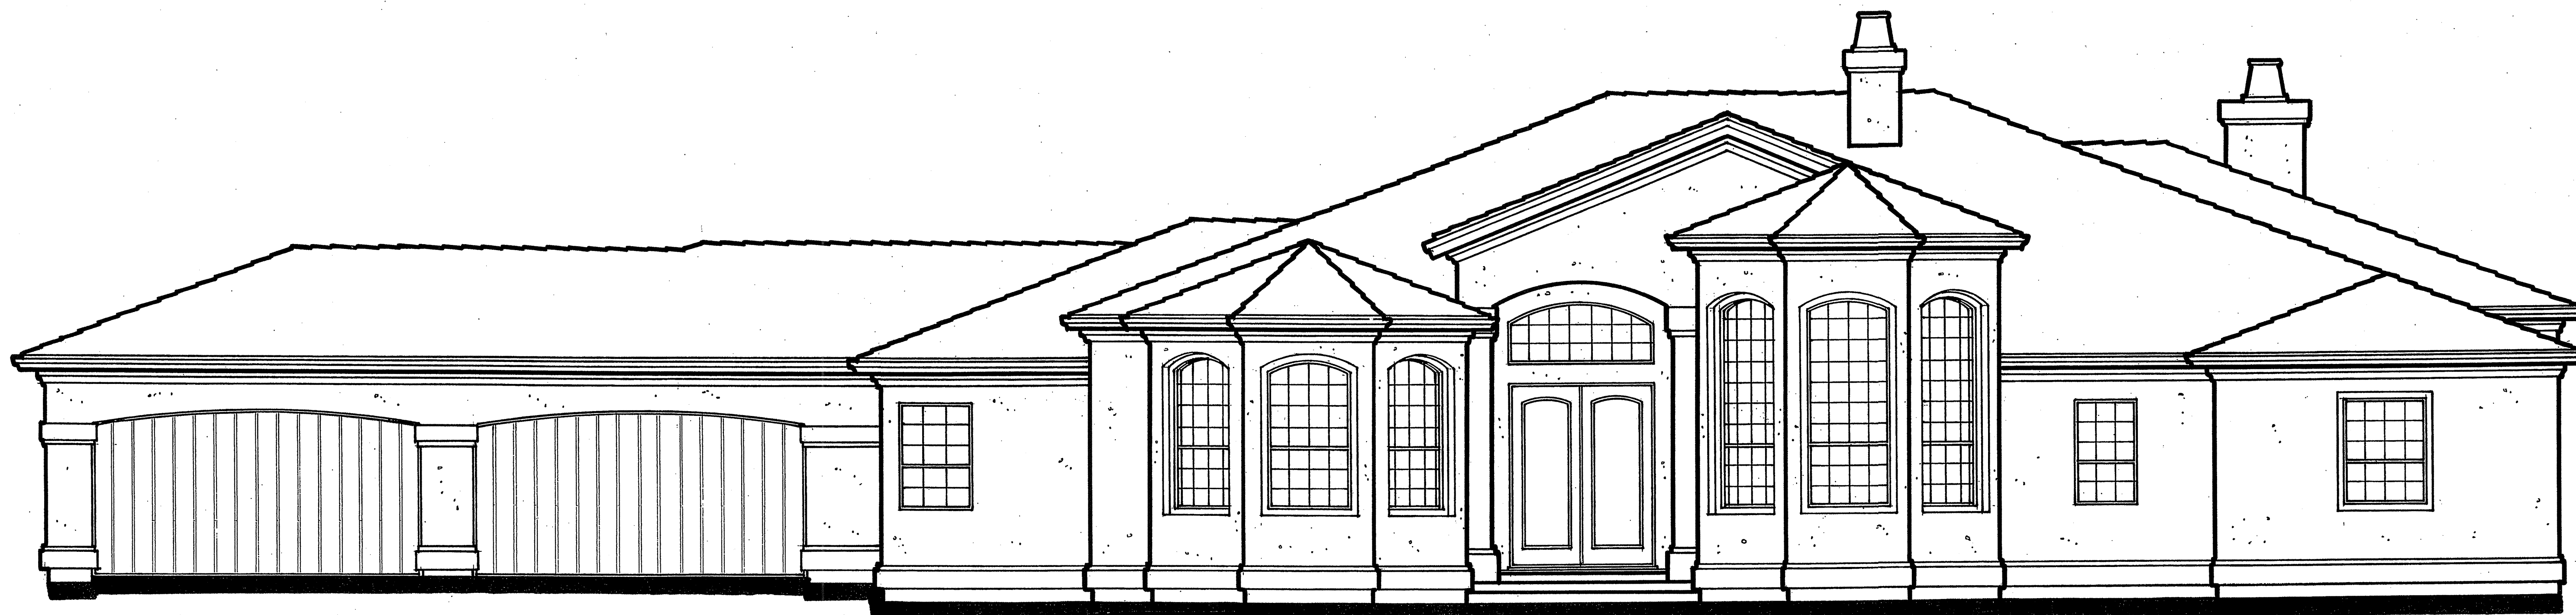

NORTH ELEVATION

FINISHED GRADE TYP

EXTERIOR FINISHES:
 - SAND FINISHED STUCCO
 EXTERIOR EARTH TONED
 COLORS
 - CONCRETE TILE ROOFING
 EARTH TONED COLORS
 - GUTTERS AND TRIM
 COMPLIMENTARY EARTH
 TONED COLORS




SOUTH ELEVATION

FINISHED GRADE
 TYPICAL

EXTERIOR ELEVATIONS


SCALE: 1/4"=1'-0"

30' HEIGHT AS
MEASURED IN
ACCORDANCE
WITH CHAPTER
1.30 4b COUNTY
ZONING
ORDINANCE

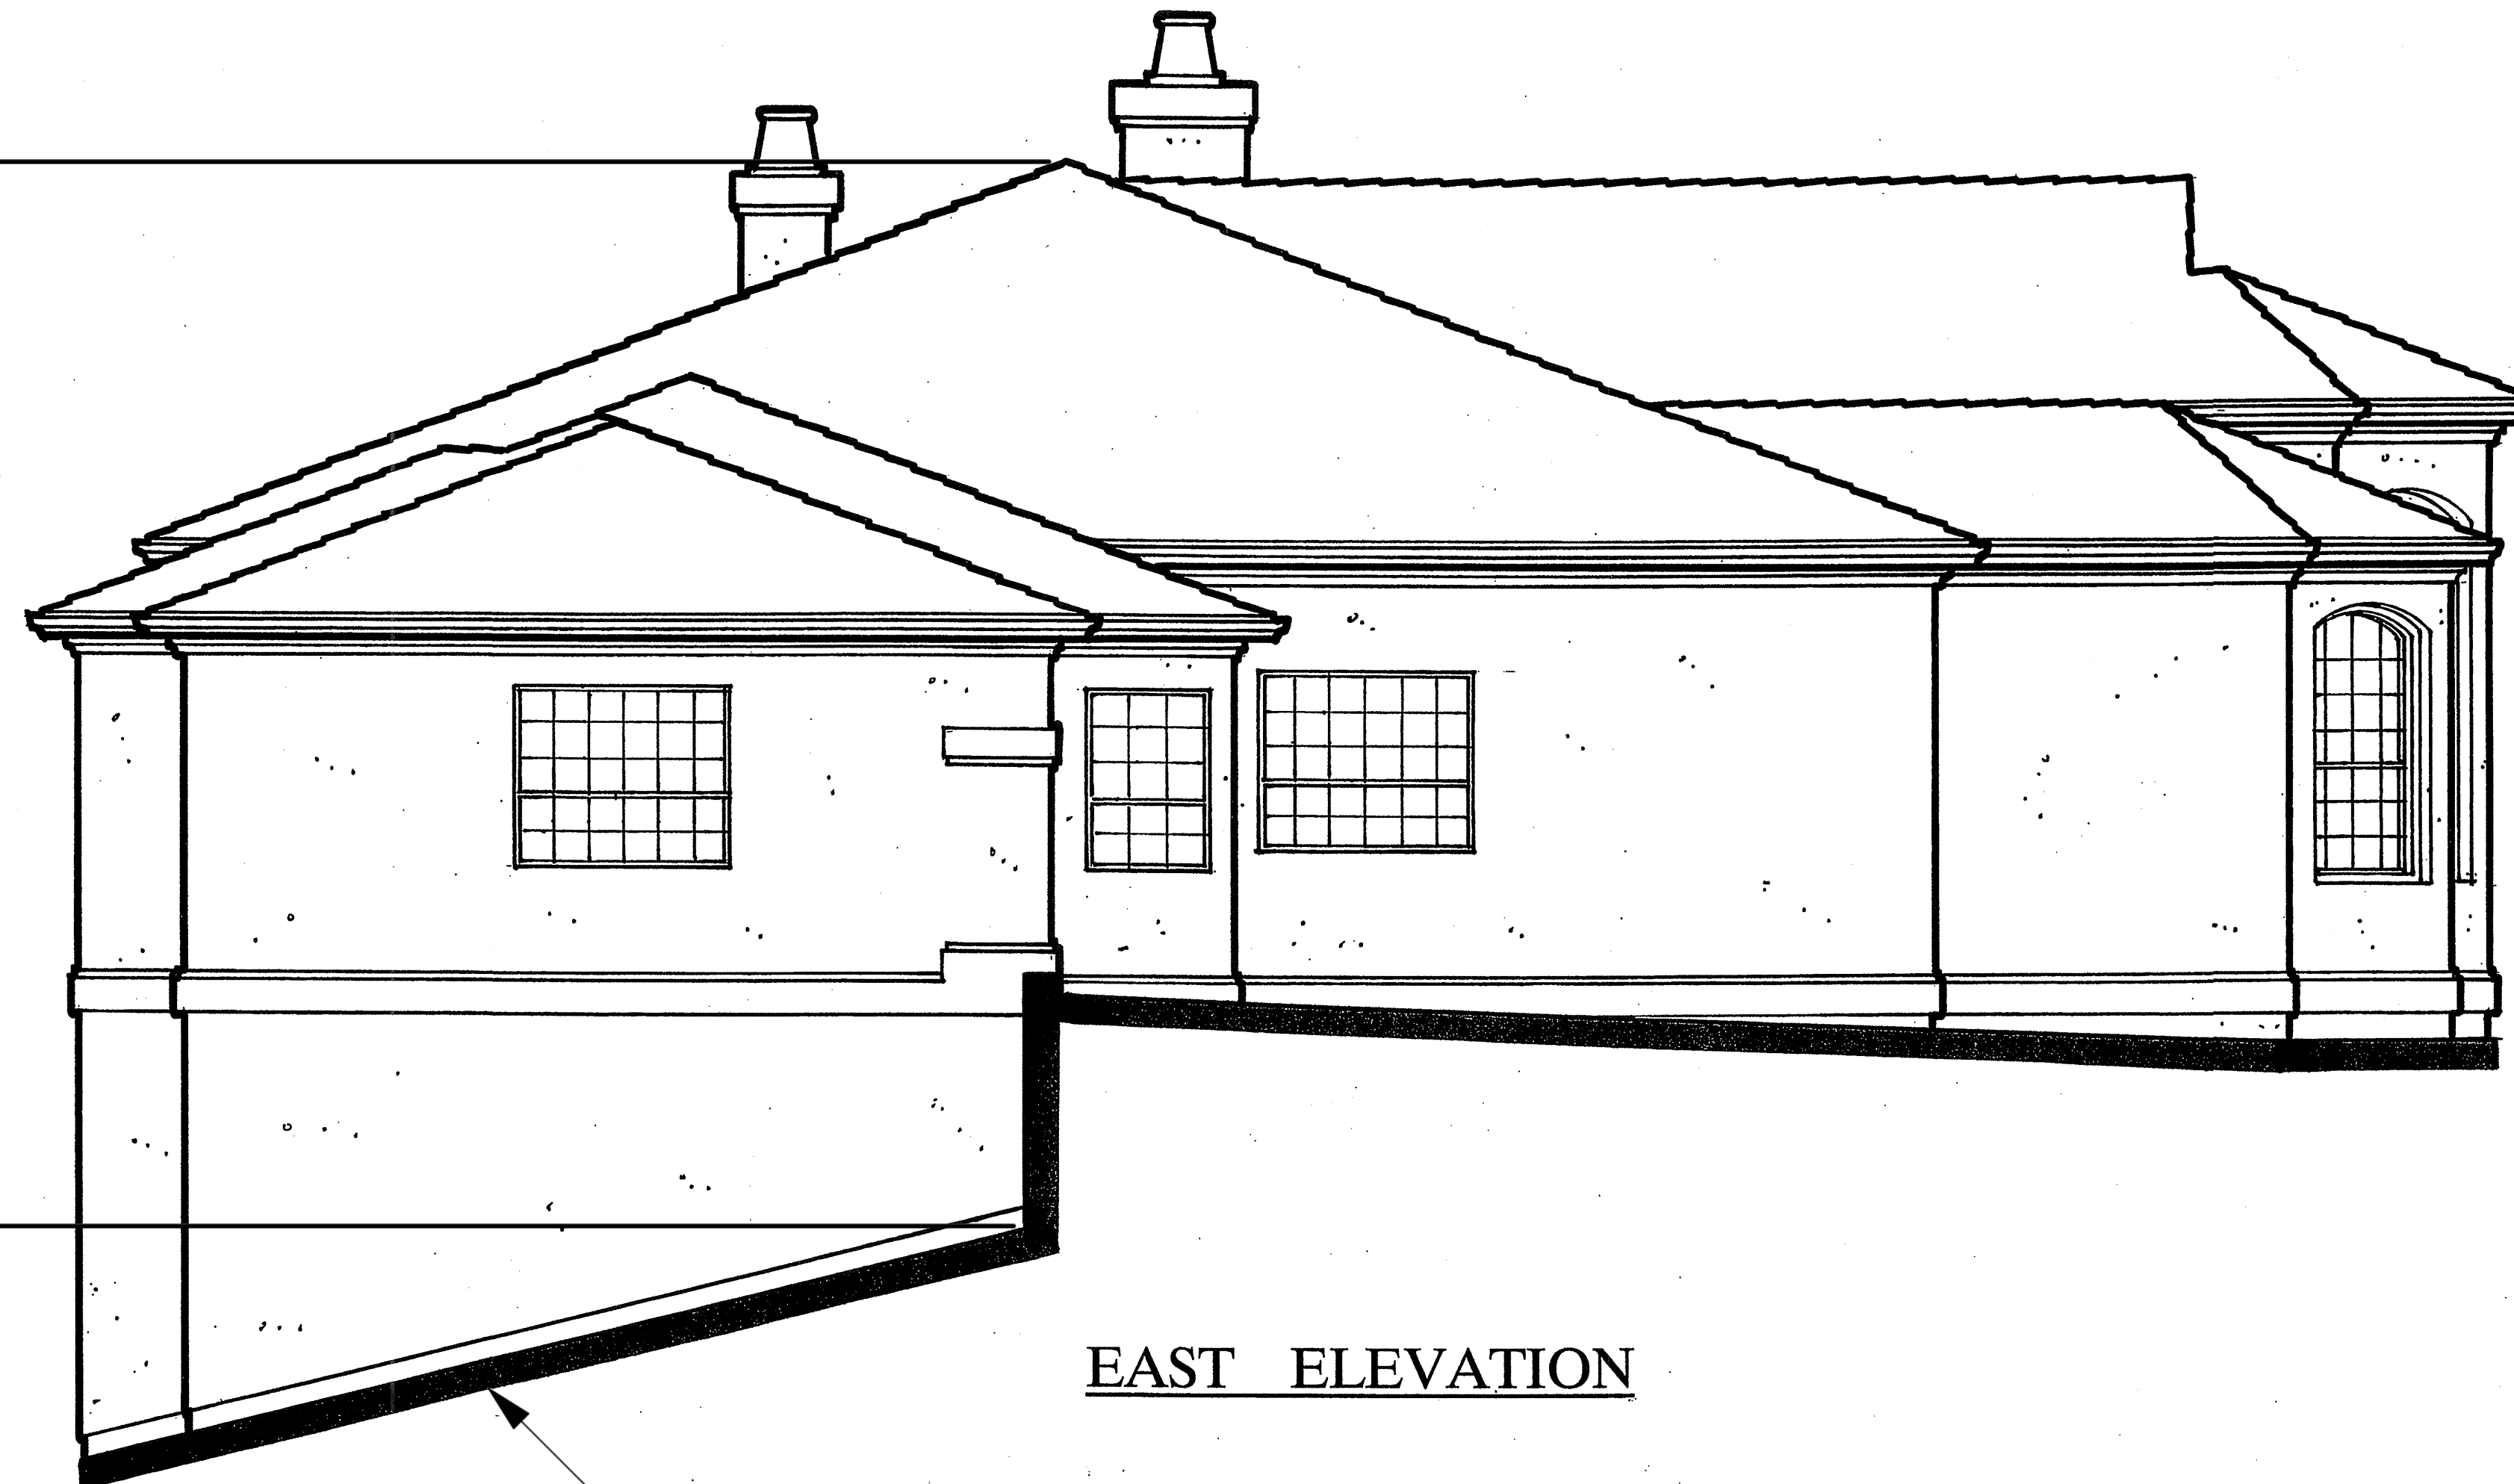

EAST ELEVATION

EXTERIOR FINISHES:
- SAND FINISHED STUCCO
EXTERIOR EARTH TONED
COLORS
- CONCRETE TILE ROOFING
EARTH TONED COLORS
- GUTTERS AND TRIM
COMPLIMENTARY EARTH
TONED COLORS

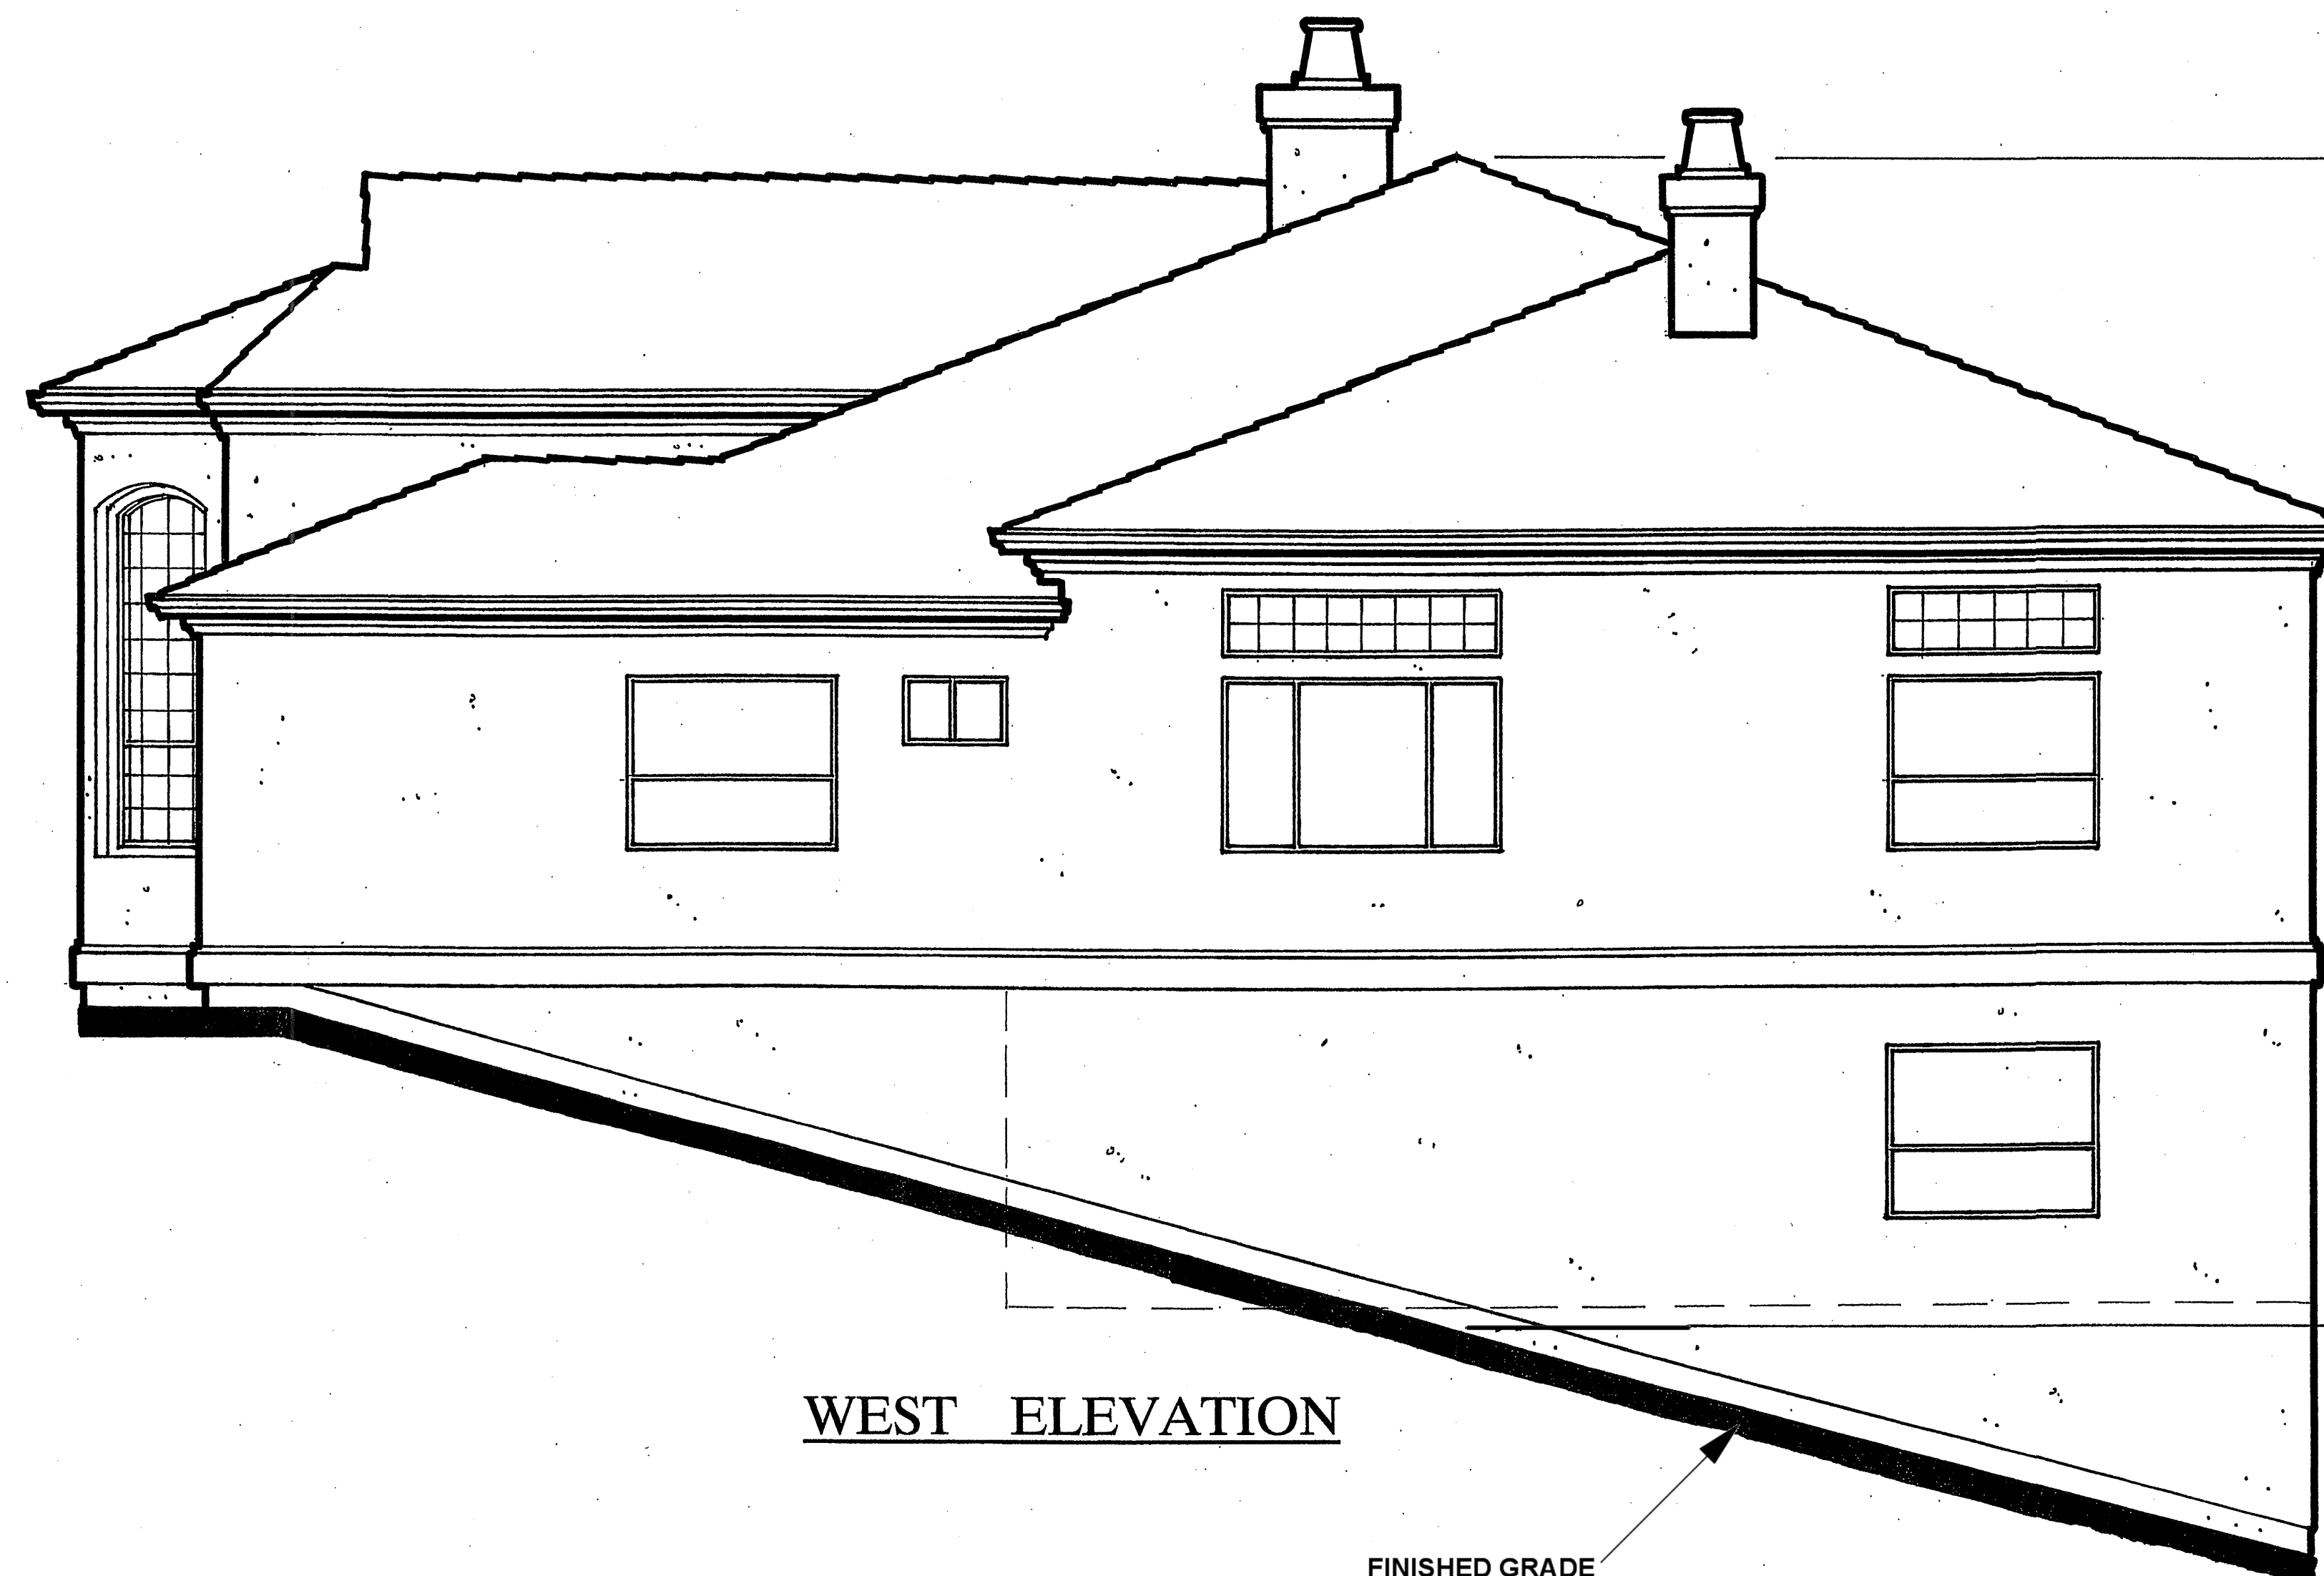

WEST ELEVATION

HEIGHT
MEASURED
ALONG GRADE
DOES NOT EXCEED
34' (35' MAX ALLOWABLE)

**AS MEASURED IN
ACCORDANCE
WITH CHAPTER
1.30 4b COUNTY
ZONING
ORDINANCE**

EXTERIOR ELEVATIONS

SCALE: 1/4"=1'-0"

Jonathan Coulter
930 San Benito Street
Hollister, Ca. 95023
Phone: (831) 637-8055 (831) 537-4040

PLAN BY:

MR. & MRS. BANSAL
11391 CLAYTON ROAD
SAN JOSE, CA. 95127 (650) 533-9484


PLAN FOR:

DATE
03/14/16

SCALE

SHEET

A5

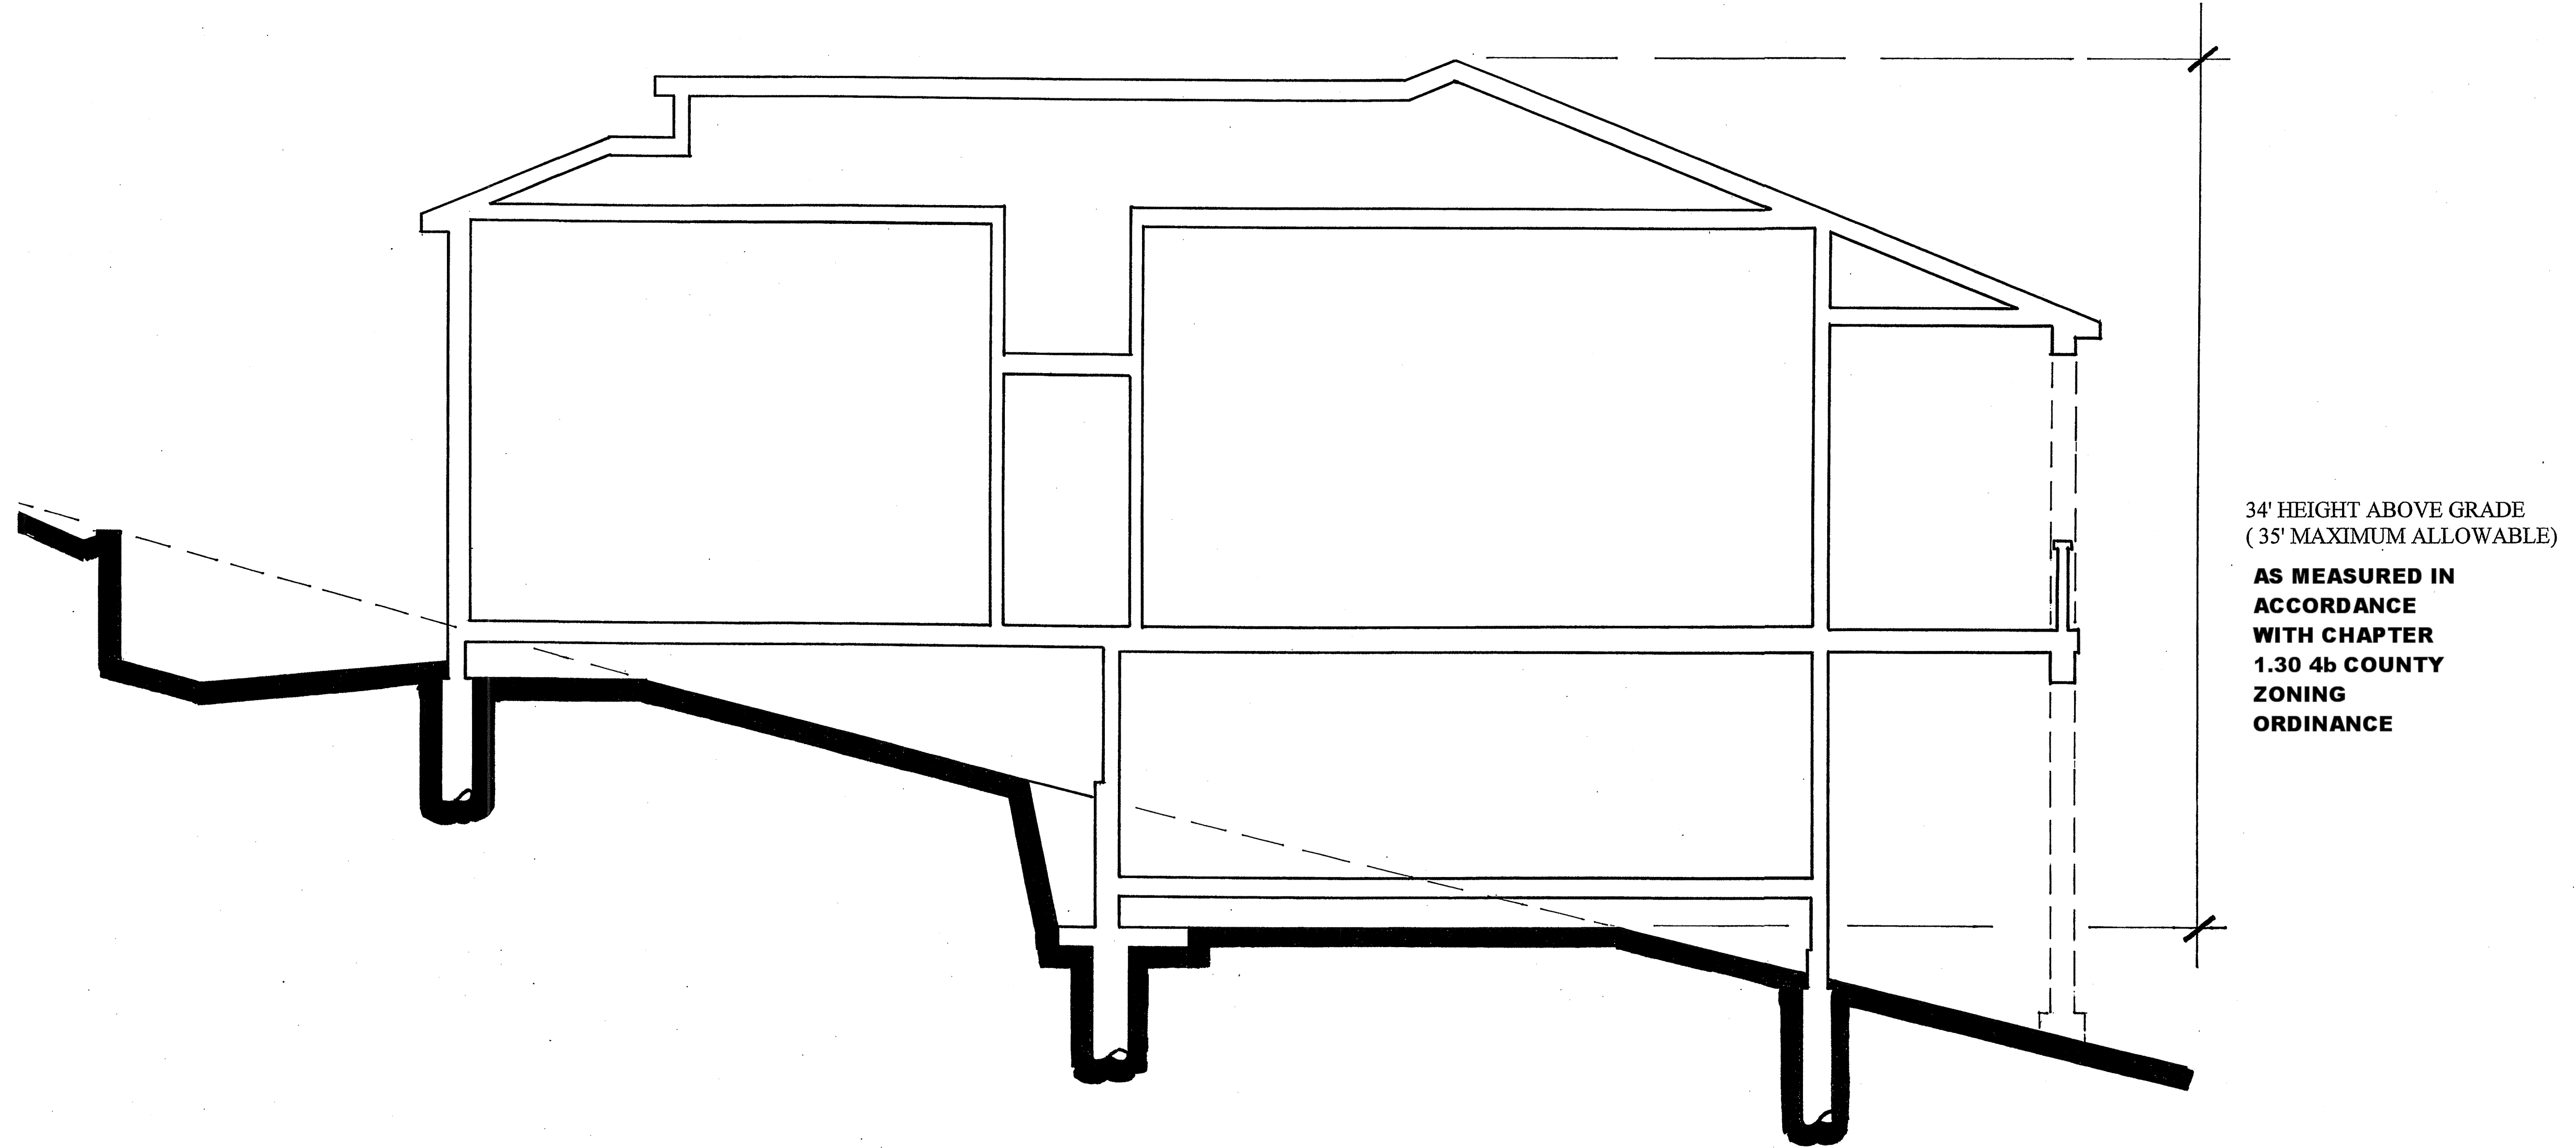

TYPICAL CROSS SECTION AA

SCALE: 1/4" = 1'-0"

PLAN
BY: Jonathan Coulter
930 San Benito Street
Hollister, Ca. 95023
Phone: (831) 637-8059 (831) 537-4040

MR. & MRS. RANSAL
11391 CLAYTON ROAD
SAN JOSE, CA. 95127 (650)333-9484


PLAN
FOR:

DATE
09/14/10

SCALE

SHEET

AC

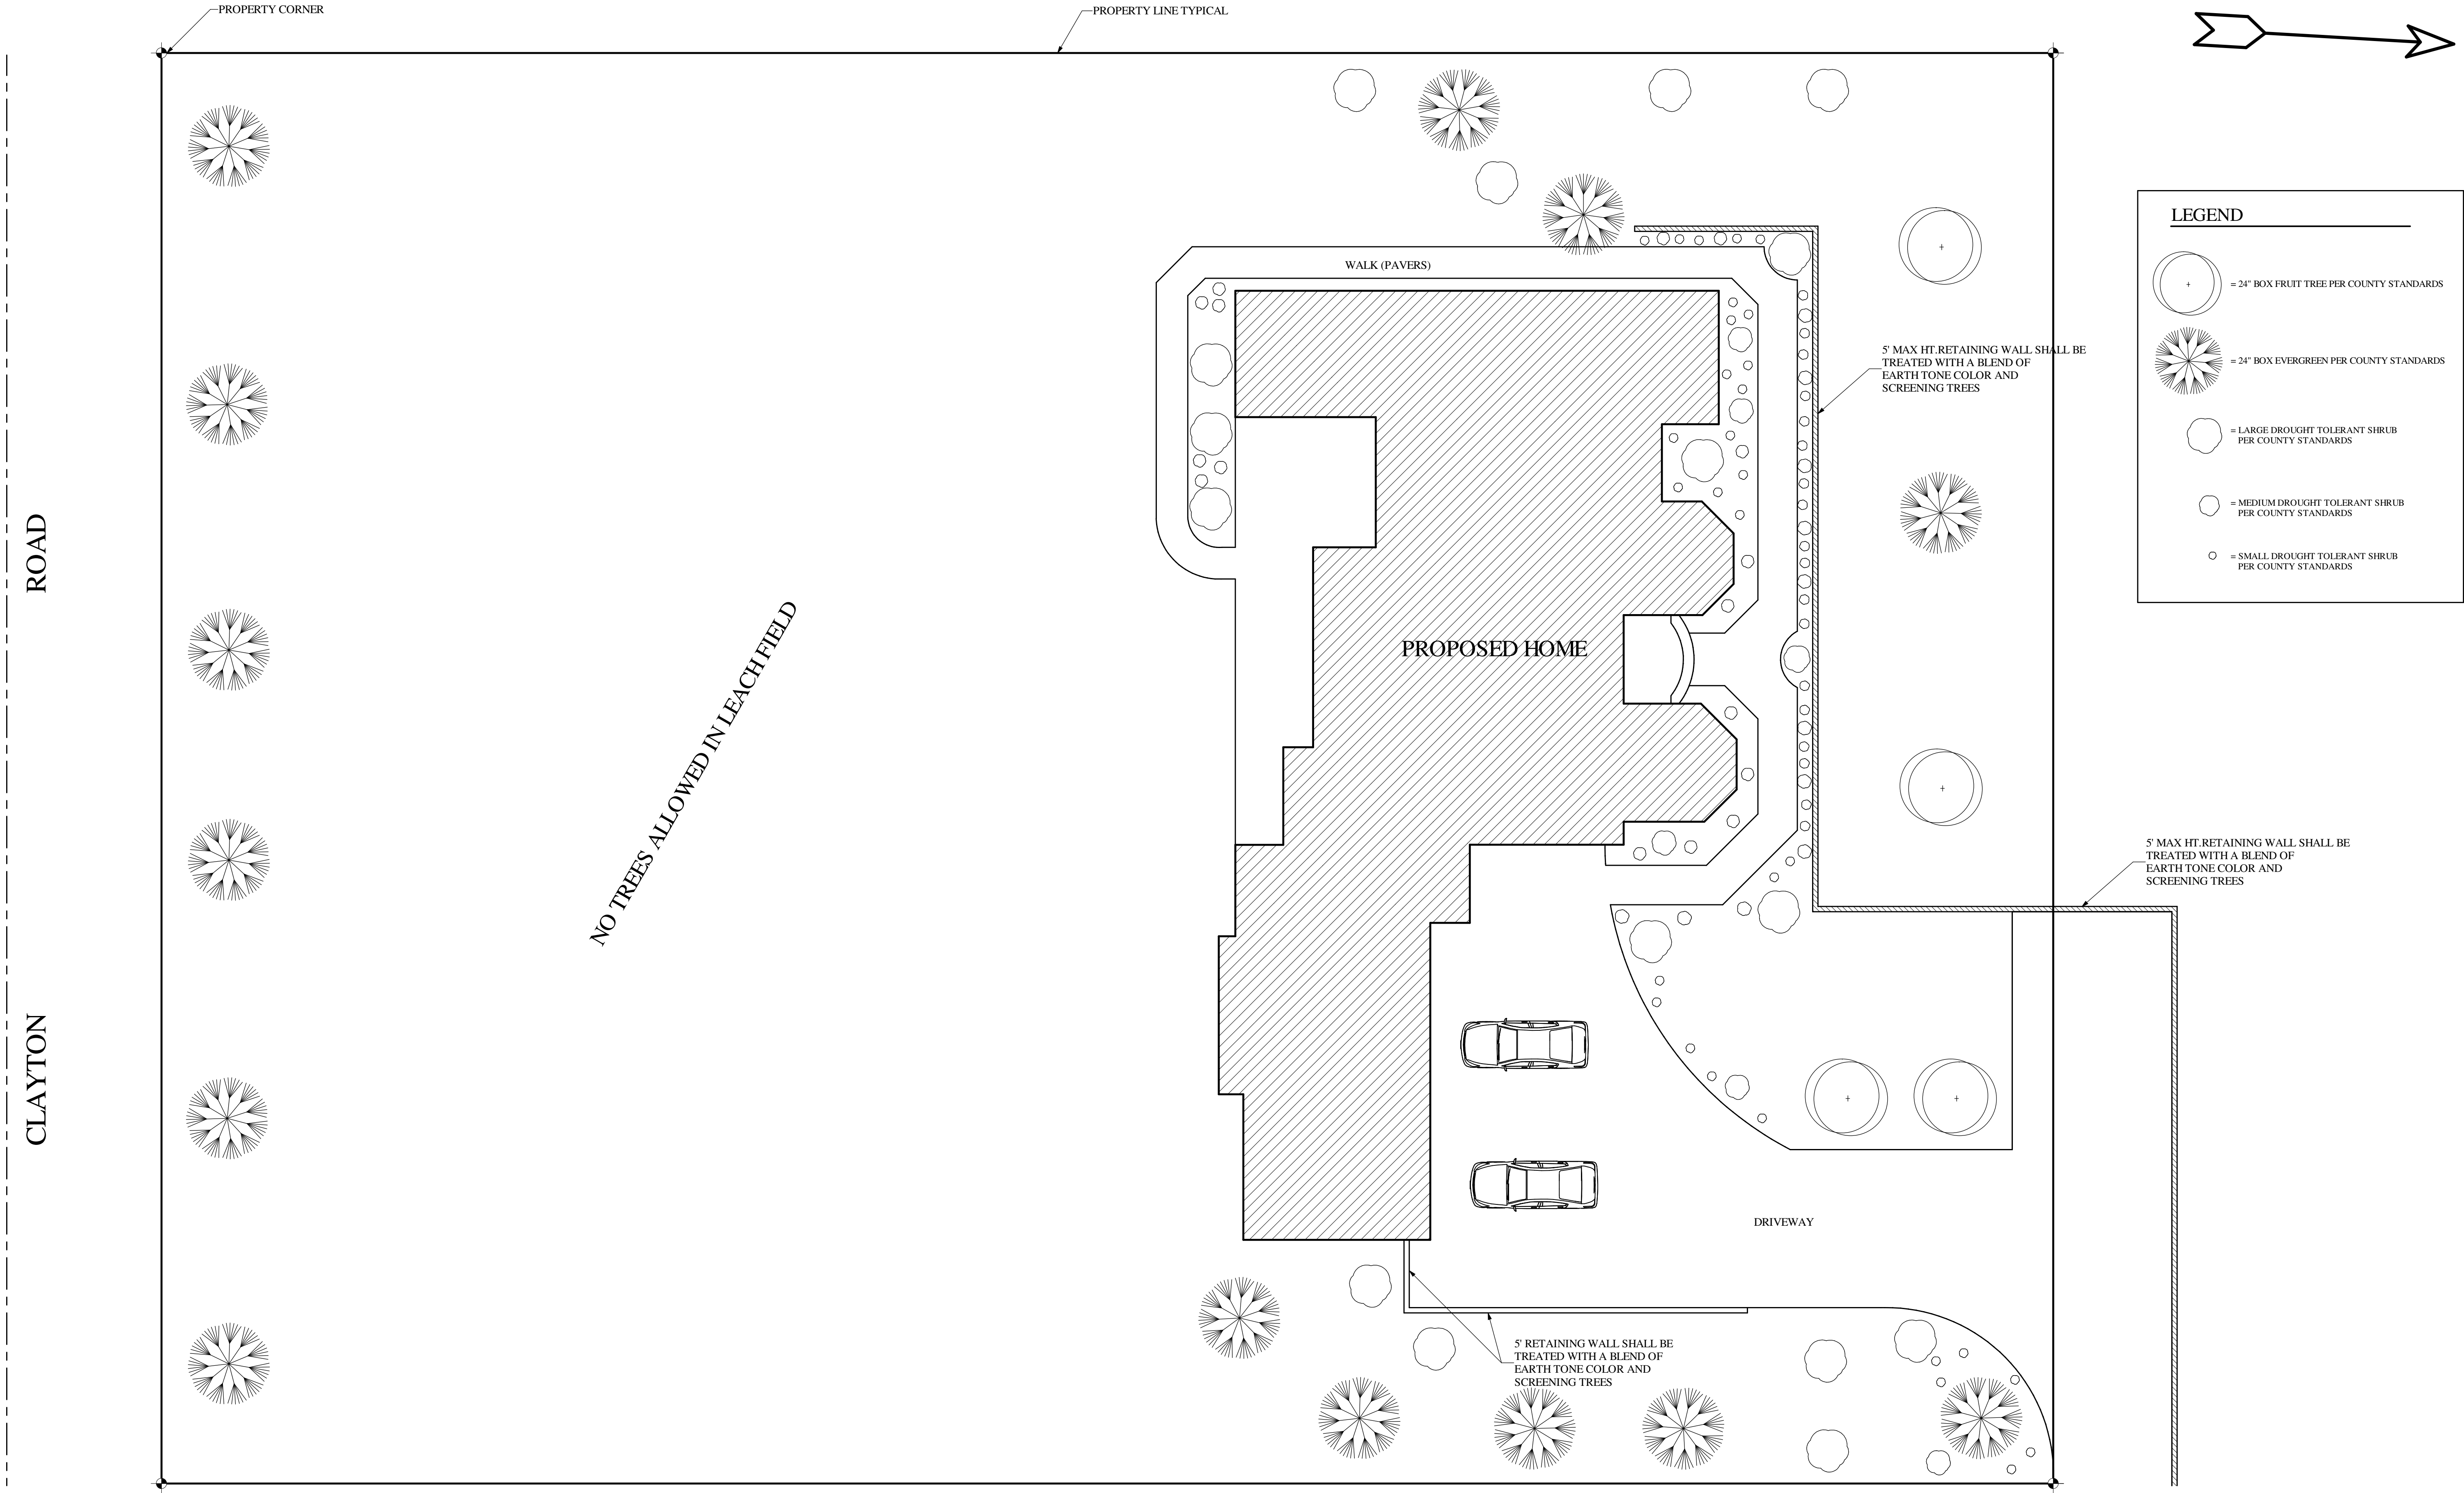

PLAN FOR:	MR & MRS BANSAL 11391 CLAYTON ROAD SAN JOSE, CA. 95127 (650) 533-9484
	DATE
PLAN BY:	Jonathan Coulter 930 San Benito Street Hollister, Ca. 95023 Phone: (831) 637-8059 (831) 537-4040
SHEET	L-1

COUNTY OF SANTA CLARA
GENERAL CONSTRUCTION
SPECIFICATIONS

1. ALL CONSTRUCTION WORK SHALL BE PERFORMED IN ACCORDANCE WITH THE SOILS AND/OR GEOTECHNICAL REPORT PREPARED BY ASSOCIATED TERRA CONSULTANTS, INC. FILE NO. 178831 DATED SEPTEMBER 11, 2002. THESE REPORTS ARE SUPPLEMENTED BY:
- 1) THESE PLANS AND SPECIFICATIONS; 2) THE COUNTY OF SANTA CLARA STANDARD DETAILS; 3) THE COUNTY SPECIFICATIONS; 2) THE COUNTY OF SANTA CLARA STANDARD DETAILS; 3) THE COUNTY OF SANTA CLARA STANDARD SPECIFICATIONS; 4) STATE OF CALIFORNIA STANDARD DETAILS; 5) STATE OF CALIFORNIA STANDARD SPECIFICATIONS;
- IN THE EVENT OF CONFLICT THE FORMER SHALL TAKE PRECEDENCE OVER THE LATTER. THE PERFORMANCE AND COMPLETION OF ALL WORK MUST BE TO THE SATISFACTION OF THE COUNTY.
2. DEVELOPER IS RESPONSIBLE FOR INSTALLATION OF THE IMPROVEMENTS SHOWN ON THESE PLANS AND HE OR HIS SUCCESSOR PROPERTY OWNERS ARE RESPONSIBLE FOR THEIR CONTINUED MAINTENANCE.
3. DEVELOPER SHALL BE RESPONSIBLE FOR CORRECTION OF ANY ERRORS OR OMISSIONS IN THESE PLANS. THE COUNTY SHALL BE AUTHORIZED TO REQUIRE DISCONTINUANCE OF ANY WORK AND SUCH CORRECTION AND MODIFICATION OF PLANS AS MAY BE NECESSARY TO COMPLY WITH COUNTY STANDARDS OR CONDITIONS OF DEVELOPMENT APPROVAL.
4. DEVELOPER SHALL OBTAIN ENCROACHMENT PERMITS FROM THE SANTA CLARA VALLEY WATER DISTRICT AND CALIFORNIA DEPARTMENT OF TRANSPORTATION WHERE NEEDED. COPIES OF THESE PERMITS SHALL BE KEPT AT THE JOB SITE FOR REVIEW BY THE COUNTY'S INSPECTOR.
5. DEVELOPER SHALL REMOVE OR TRIM ALL TREES TO PROVIDE AN UNOBSTRUCTED FIFTEEN (15) FOOT VERTICAL CLEARANCE FOR ROADWAY AREA.
6. THIS PLAN AUTHORIZES THE REMOVAL OF ONLY THOSE TREES WITH TRUNK DIAMETERS GREATER THAN 12 INCHES MEASURED 4.5 FEET ABOVE THE GROUND THAT ARE SHOWN TO BE REMOVED UNLESS AN AMENDED PLAN IS APPROVED OR A SEPARATE TREE REMOVAL PERMIT IS OBTAINED FROM THE PLANNING OFFICE. IT IS THE CONTRACTOR'S RESPONSIBILITY TO ENSURE THAT REMOVAL OF ADDITIONAL TREES HAS BEEN PERMITTED.
7. DEVELOPER SHALL PROVIDE ADEQUATE DUST CONTROL AS REQUIRED BY THE COUNTY INSPECTOR.
8. ALL PERSONS MUST COMPLY WITH SECTION 4442 OF THE PUBLIC RESOURCES CODE AND SECTION 13095 OF THE HEALTH AND SAFETY CODE RELATING TO THE USE OF SPARK ARRESTERS.
9. UPON DISCOVERING OR UNEARTHING ANY BURIAL SITE AS EVIDENCE BY HUMAN SKELETAL REMAINS OR ARTIFACTS, THE PERSON MAKING SUCH DISCOVERY SHALL IMMEDIATELY NOTIFY THE COUNTY CORONER AT (408) 454-2620 AND LAND DEVELOPMENT ENGINEERING OFFICE AT (408) 299-5730 NO FURTHER DISTURBANCE OF THE SITE MAY BE MADE EXCEPT AS AUTHORIZED BY THE LAND DEVELOPMENT OFFICE IN ACCORD WITH PROVISIONS OF THIS ORDINANCE. (COUNTY ORDINANCE CODE SECTION B6-18).

CONSTRUCTION STAKING

1. THE DEVELOPER'S ENGINEER IS RESPONSIBLE FOR THE INITIAL PLACEMENT AND REPLACEMENT OF CONSTRUCTION GRADE STAKES. THE STAKES ARE TO BE ADEQUATELY IDENTIFIED, LOCATED, STABILIZED, ETC. FOR THE CONVENIENCE OF CONTRACTORS. LATERAL OFFSET OF STAKES SET FOR CURBS AND GUTTERS SHALL NOT EXCEED 2 1/2 FEET FROM THE BACK OF CURB.
2. ANY PROPERTY LINE STAKES OR ROAD MONUMENTS DISTURBED DURING CONSTRUCTION SHALL BE REPLACED BY DEVELOPER'S ENGINEER OR LICENSED LAND SURVEYOR.

CONSTRUCTION INSPECTION

1. CONTRACTOR SHALL NOTIFY PERMIT INSPECTION UNIT, SANTA CLARA COUNTY PRIOR TO COMMENCING WORK AND FOR FINAL INSPECTION OF WORK AND SITE.
2. THE COUNTY REQUIRES A MINIMUM 24 HOUR ADVANCE NOTICE FOR GENERAL INSPECTION, 48 HOURS FOR ASPHALT CONCRETE INSPECTION.
3. INSPECTION BY SANTA CLARA COUNTY SHALL BE LIMITED TO INSPECTION OF MATERIALS AND PROCESSES, OF CONSTRUCTION TO OBSERVE THEIR COMPLIANCE WITH PLANS AND SPECIFICATIONS, BUT DOES NOT INCLUDE RESPONSIBILITY FOR THE SUPERINTENDENCE OF CONSTRUCTION, SITE CONDITIONS, EQUIPMENT OR PERSONNEL. CONTRACTOR SHALL NOTIFY THE COUNTY LAND DEVELOPMENT INSPECTOR AT PHONE (408) 299-6868 AT LEAST 24 HOURS PRIOR TO COMMENCING WORK AND FOR FINAL INSPECTION OF WORK AND SITE.
4. DEVELOPER AND/OR HIS AUTHORIZED REPRESENTATIVE MUST SUBMIT WRITTEN REQUEST FOR FINAL INSPECTION AND ACCEPTANCE. SAID REQUESTS SHALL BE DIRECTED TO THE INSPECTION OFFICE NOTED ON THE PERMIT FORM.

SITE PREPARATION (CLEARING & GRUBBING)

1. EXISTING TREES, ROOTS AND FOREIGN MATERIAL WILL BE REMOVED FROM AREAS TO BE IMPROVED TO AN AUTHORIZED DISPOSAL SITE AS FOLLOWS:
- a) TO A MINIMUM DEPTH OF TWO FEET BELOW THE FINISHED GRADE PROPOSED ROADWAYS (EITHER PRIVATE OR TO BE DEDICATED TO PUBLIC USE).
- b) FROM AREAS AFFECTED BY THE PROPOSED GRADING EXCEPT WHERE NOTED ON THE PLANS.
2. IT SHALL BE THE RESPONSIBILITY OF THE DEVELOPER TO MOVE OR RELOCATE UTILITY POLES AND OTHER OBSTRUCTIONS IN THE WAY OF CONSTRUCTION.

UTILITY LOCATION, TRENCHING & BACKFILL

1. CONTRACTOR SHALL NOTIFY USA (UNDERGROUND SERVICE ALERT) AT 800-227-2600 A MINIMUM 24 HOURS BEFORE BEGINNING UNDERGROUND WORK FOR VERIFICATION OF THE LOCATION OF UNDERGROUND UTILITIES.
2. ACCURATE VERIFICATION AS TO SIZE, LOCATION AND DEPTH OF EXISTING UNDERGROUND CONDUITS OR FACILITIES SHALL BE THE INDIVIDUAL CONTRACTORS RESPONSIBILITY. PLAN LOCATIONS ARE APPROXIMATE AND FOR GENERAL INFORMATION ONLY.
3. ALL UNDERGROUND INSTALLATIONS SHALL BE IN PLACE AND THE TRENCH BACKFILLED AND COMPACTED BEFORE PLACING AGGREGATE BASE MATERIAL OR SURFACE STRUCTURES. SURFACING MAY BE DONE IF THE UTILITY COMPANY CONCERNED INDICATES BY LETTER THAT IT WILL BORE, UNLESS SPECIFICALLY AUTHORIZED BY THE COUNTY. GAS AND WATER MAINS SHALL BE INSTALLED OUTSIDE THE PAVED AREA.
4. TRENCH BACKFILL IN EXISTING PAVEMENT AREAS SHALL BE SAND MATERIAL IN ACCORDANCE WITH THE APPLICABLE PROVISIONS OF THE STATE SPECIFICATIONS. THE STRUCTURAL SECTION FOR TRENCH REPLACEMENT SHALL CONSIST OF NOT LESS THAN 12 INCHES OF APPROVED AGGREGATE BASE MATERIAL, COMPACTED TO A RELATIVE COMPACTION OF AT LEAST 95%, AND 4 INCHES OF HOT ASPHALT CONCRETE PLACED IN TWO LIFTS. TRENCH RESTORATION FOR HIGHER TYPE PAVEMENTS SHALL BE MADE IN KIND OR AS DIRECTED BY THE COUNTY.
5. TRENCH BACKFILL IN NEW CONSTRUCTION AREAS SHALL BE SAND MATERIAL COMPACTED TO A RELATIVE COMPACTION OF AT LEAST 90%. THE REQUIREMENT FOR SELECT MATERIAL MAY BE WAIVED BY COUNTY IF THE NATIVE SOIL IS SUITABLE FOR USE AS TRENCH BACKFILL, BUT THE COMPACTION REQUIREMENTS WILL NOT BE THEREBY WAIVED.
6. BACKFILL AND TRENCH RESTORATION REQUIREMENTS SHALL APPLY AS MINIMUM STANDARDS TO ALL UNDERGROUND FACILITIES INSTALLED BY OTHER FIRMS OR PUBLIC AGENCIES.

REPLACEMENT OF DAMAGED IMPROVEMENTS

1. ANY EXISTING IMPROVEMENTS WHICH ARE SCARRED, DAMAGED, OR REMOVED DURING THE CONSTRUCTION OPERATIONS AND ANY EXISTING SHOULDER AREAS WHICH ARE STRUCTURALLY INADEQUATE COMPARED TO THE PROPOSED TYPICAL PAVEMENT SECTION, SHALL BE REMOVED, RECONSTRUCTED OR REPLACED AS REQUIRED BY THE COUNTY INSPECTOR IN THE FIELD.

GRADING

1. EXCAVATED MATERIAL SHALL BE PLACED IN THE FILL AREAS DESIGNATED OR SHALL BE HAULED AWAY FROM THE SITE. WHERE FILL MATERIAL IS TO BE PLACED ON NATURAL GROUND, IT SHALL BE STRIPPED OF ALL VEGETATION. TO ACHIEVE A PROPER BOND WITH THE FILL MATERIAL, THE SURFACE OF THE GROUND SHALL BE SCARIFIED TO DEPTH OF 6" BEFORE FILL IS PLACED. WHERE NATURAL GROUND IS STEEPER THAN 5:1, IT SHALL BE BENCHED AND THE EXISTING FILL SHALL BE REMOVED UNTIL MATERIAL COMPACTED TO 90% RELATIVE COMPACTION IS EXPOSED. THEN THE NEW FILL MATERIAL SHALL BE PLACED IN UNIFORM LIFTS NOT EXCEEDING 6" OF UNCOMPACTED THICKNESS BEFORE COMPACTION BEGINS. THE FILL SHALL BE BROUGHT TO A WATER CONTENT THAT WILL PERMIT PROPER COMPACTION BY EITHER: (1) AERATING THE FILL IF IT IS TOO WET, OR (2) MOISTENING THE FILL WITH WATER IF IT IS TOO DRY. EACH LIFT SHALL BE THOROUGHLY MIXED BEFORE COMPACTION TO ENSURE A UNIFORM DISTRIBUTION OF MOISTURE.
2. SURPLUS EARTH FILL MATERIAL SHALL BE PLACED IN A SINGLE (8" max) THICK LAYER COMPACTED TO WITHSTAND WEATHERING IN THE AREA(S) DELINEATED ON THE PLAN.
3. NO ORGANIC MATERIAL SHALL BE PLACED IN ANY FILL NO TREES SHALL BE REMOVED OUTSIDE OF CUT, FILL, OR ROADWAY AREAS.
4. THE UPPER 6" OF SUBGRADE BELOW DRIVEWAY, ACCESS ROAD, OR PARKING AREA SHALL BE COMPACTED TO 95% OF MAXIMUM DENSITY.
5. MAXIMUM CUT SLOPE SHALL BE 1 1/2 HORIZONTAL TO 1 VERTICAL. MAXIMUM FILL SLOPE SHALL BE 2 HORIZONTAL TO 1 VERTICAL.
- | | | |
|--------------------------|------|-------------|
| ESTIMATED VOLUME OF CUT | 2025 | CUBIC YARDS |
| ESTIMATED VOLUME OF FILL | 390 | CUBIC YARDS |
| EXCESS MATERIALS | 1635 | CUBIC YARDS |
| IMPORTED MATERIALS | - | CUBIC YARDS |
| MAXIMUM DEPTH OF CUT | 10 | FEET |
| MAXIMUM DEPTH OF FILL | 10 | FEET |
- APPROXIMATE EARTHWORK QUANTITIES
- | | | |
|----------------------------------|-------------|-------------|
| DESCRIPTION | CUT | FILL |
| ON SITE DRIVEWAY | 90 cu. yd. | 210 cu. yd. |
| BUILDING PAD | 200 cu. yd. | 130 cu. yd. |
| LANDSCAPE AND COURTYARD | 550 cu. yd. | 0 cu. yd. |
| GRADING IN EASEMENT OFF SITE | 335 cu. yd. | 0 cu. yd. |
| OFF SITE DRIVEWAY AND TURNAROUND | 800 cu. yd. | 0 cu. yd. |
| PRO RATA SHARE OF PRIVATE ROAD | 50 cu. yd. | 50 cu. yd. |

6. ALL EXCESS GRADING MATERIALS SHALL BE DISPOSED AT A COUNTY APPROVED DUMP SITE.

EROSION CONTROL

1. ALL FILL SLOPES SHALL BE COMPACTED AND LEFT IN A SMOOTH AND FIRM CONDITION CAPABLE OF WITHSTANDING WEATHERING.
2. ALL EXPOSED DISTURBED AREAS SHALL BE SEEDED WITH BROME SEED SPREAD AT THE RATE OF 5 POUNDS PER 1000 SQUARE FEET (OR APPROVED EQUAL). SEEDING AND WATERING SHALL BE MAINTAINED AS REQUIRED TO ENSURE GROWTH.
3. ALL DITCHES AT SLOPES GREATER THAN 5% SHALL BE LINED WITH 2" AC OR PCC THROUGHOUT.
4. ALL STORM DRAINAGE STRUCTURES SHALL BE INSTALLED WITH EFFECTIVE ENTRANCE AND OUTFALL EROSION CONTROLS. e.g. SACKED CONCRETE RIP-RAP. ENERGY DISSIPATORS SHALL BE INSTALLED AT ALL DITCH OUTFALLS. WHERE OUTFALLS ARE NOT INTO AN EXISTING CREEK OR WATER COURSE, RUN-OFF SHALL BE RELEASED TO SHEET FLOW.

DRIVEWAYS

1. DRIVEWAY LOCATIONS SHALL BE AS SHOWN ON THE IMPROVEMENT PLANS WITH CENTERLINE STATIONING. THE MINIMUM CONCRETE THICKNESS SHALL BE 6 INCHES THROUGHOUT. THE MAXIMUM APPROACH GRADE SHALL BE 5% FOR A LENGTH OF 20 FEET.

STREET LIGHTING

1. PACIFIC GAS & ELECTRIC ELECTROLIER SERVICE FEE SHALL BE PAID BY THE DEVELOPER AND/OR HIS AUTHORIZED REPRESENTATIVE

STORM DRAINAGE

1. DEVELOPER IS RESPONSIBLE FOR ALL NECESSARY DRAINAGE FACILITIES WHETHER SHOWN ON THE PLANS OR NOT AND HE OR HIS SUCCESSOR PROPERTY OWNERS ARE RESPONSIBLE FOR THE ADEQUACY AND CONTINUED MAINTENANCE OF THESE FACILITIES IN A MANNER WHICH WILL PRECLUDE ANY HAZARD TO LIFE, HEALTH OR DAMAGE TO ADJOINING PROPERTY.
2. DROP INLETS SHALL BE COUNTY STANDARD TYPE S UNLESS OTHERWISE NOTED ON THE PLANS THE DEVELOPER'S ENGINEER SHALL BE RESPONSIBLE FOR THE PROPER LOCATION OF DROP INLETS. WHERE STREET PROFILE GRADE EXCEEDS 6% DROP INLETS SHALL BE SET AT 30 DEGREE ANGLE CURB LINE TO ACCEPT WATER OR AS SHOWN ON THE PLANS.
3. WHERE CULVERTS ARE INSTALLED THE DEVELOPER SHALL BE RESPONSIBLE FOR GRADING THE OUTLET DITCH TO DRAIN TO AN EXISTING SWALE OR TO AN OPEN AREA OF SHEET FLOW.
4. UPON INSTALLATION OF DRIVEWAY CONNECTIONS, PROPERTY OWNERS SHALL PROVIDE FOR THE UNINTERRUPTED FLOW OF WATER IN ROADSIDE DITCHES.

SANITARY SEWERS

1. ALL MATERIALS AND METHODS OF CONSTRUCTION OF SANITARY SEWERS SHALL CONFORM TO THE SPECIFICATIONS OF THE JURISDICTION INVOLVED. INSPECTION OF SANITARY SEWER WORK SHALL BE DONE BY SAID JURISDICTION.

PORTLAND CEMENT CONCRETE

1. CONCRETE USED FOR STRUCTURAL PURPOSES SHALL BE CLASS "A" (6 SACK PER CUBIC YARD) AS SPECIFIED IN THE STATE STANDARD SPECIFICATIONS. CONCRETE PLACED MUST DEVELOP A MINIMUM STRENGTH FACTOR OF 2200 P.S.I. IN A SEVEN DAY PERIOD. THE CONCRETE MIX DESIGN SHALL BE UNDER THE CONTINUAL CONTROL OF THE COUNTY INSPECTOR.

BENCHMARK

GINNIE NO. 1 APPROXIMATELY 2 FEET FROM THE SOUTH EDGE OF CLAYTON ROAD NEAR THE WESTERLY PROPERTY LINE OF PARCEL.
ELEVATION = 100.0'

BASIS OF BEARING

THE BEARING N 85° 00' 49" E OF THE CENTERLINE OF CLAYTON ROAD AS SHOWN ON THE PARCEL MAP BOOK 644 OF MAPS AT PAGE 24 IN THE OFFICE OF THE COUNTY RECORDER OF THE COUNTY OF SANTA CLARA, STATE OF CALIFORNIA WAS TAKEN AS THE BASIS OF BEARINGS SHOWN ON THIS MAP.

STATEMENT OF PURPOSE

PURPOSE OF GRADING AND DRAINAGE PLAN ILLUSTRATES PROPOSED SINGLE FAMILY CUSTOM HOME AND THE REQUIRED GRADING.

SCOPE OF WORK

1. CLEAR AND GRUB.
2. COMPLETE GRADING FOR INSTALLATION OF PROPOSED RESIDENCE AND DRIVEWAY.
3. INSTALL ROAD AND DRIVEWAY FOR ACCESS AS SHOWN.
4. A CONSTRUCTION OBSERVATION LETTER FROM THE RESPONSIBLE GEOTECHNICAL ENGINEER DETAILING CONSTRUCTION OBSERVATIONS AND CERTIFYING THAT THE WORK WAS DONE IN ACCORDANCE WITH THE RECOMMENDATIONS IN THE GEOTECHNICAL REPORT SHALL BE SUBMITTED PRIOR TO GRADING COMPLETION AND RELEASE OF BOND.

GRADING AND DRAINAGE PLAN
LANDS OF BANSAL
APN 612-37-016
11391 CLAYTON ROAD
SAN JOSE, CALIFORNIA 95127

COUNTY OF SANTA CLARA
Development Services Office
Land Development Engineering Division
Construction Permit No.: _____
Issued by: _____ Date: _____

NOTES:

1. THE WATER AND SANITARY UTILITIES SHOWN ON THESE PLANS ARE SHOWN FOR REFERENCE ONLY.
2. PRIOR TO GRADING COMPLETION AND RELEASE OF BOND, ALL GRADED AREAS SHALL BE RESEEDED IN CONFORMANCE WITH THE COUNTY GRADING ORDINANCE TO MINIMIZE THE VISUAL IMPACTS OF THE GRADED SLOPES AND REDUCE THE POTENTIAL FOR EROSION ON THE SUBJECT SITE.
3. ROADWAYS DESIGNATED AS NOT COUNTY MAINTAINED ROADS AS SHOWN UPON THIS PLAN WILL NOT BE ELIGIBLE FOR COUNTY MAINTENANCE UNTIL THE ROADWAYS ARE IMPROVED (AT NO COST TO THE COUNTY) TO PUBLIC MAINTENANCE ROAD STANDARDS APPROVED BY THE BOARD OF SUPERVISORS AND IN EFFECT AT SUCH TIME THAT THE ROADWAYS ARE CONSIDERED FOR ACCEPTANCE INTO THE COUNTY'S ROAD SYSTEM.

AS-BUILT PLAN STATEMENT

THIS IS A TRUE COPY OF THE AS-BUILT PLANS. THERE (____)WERE) (____)WERE NOT) MINOR FIELD CHANGES--MARKED WITH ____ THERE (____)WERE) (____)WERE NOT) PLAN REVISIONS INDICATING SIGNIFICANT CHANGES REVIEWED BY THE COUNTY ENGINEER AND MARKED WITH THE SYMBOL ____.

DATE _____ SIGNATURE _____

NOTE: THIS STATEMENT IS TO BE SIGNED BY THE PERSON AUTHORIZED BY THE COUNTY ENGINEER TO PERFORM THE INSPECTION WORK. A REPRODUCIBLE COPY OF THE AS-BUILT PLANS WILL BE FURNISHED TO THE COUNTY ENGINEER AFTER CONSTRUCTION.

CONSTRUCTION/ENCROACHMENT/GRADING PERMIT

PERMIT(S) NO. : _____
FILE(S) NO.: _____ DATE: _____
ISSUED BY: _____

LAND DEVELOPMENT ENGINEERING & SURVEYING
ENVIRONMENTAL RESOURCES AGENCY
COUNTY OF SANTA CLARA

ENGINEER'S STATEMENT


I HEREBY STATE THAT THESE PLANS ARE IN COMPLIANCE WITH ADOPTED COUNTY STANDARDS, THE APPROVED TENTATIVE MAP (OR PLAN) AND CONDITIONS OF APPROVAL PERTAINING THERETO

DATED _____, FILE(S) No. _____
DATE _____ ANDREW E. ARNOLD _____ RCE 66537 EXP. 06/30/2016
NAME SIGNATURE R.C.E. No. / EXPIRATION DATE

COUNTY ENGINEER'S NOTE


ISSUANCE OF A PERMIT AUTHORIZING CONSTRUCTION DOES NOT RELEASE THE DEVELOPER, PERMITTEE OR ENGINEER FROM RESPONSIBILITY FOR THE CORRECTION OF ERRORS OR OMISSIONS CONTAINED IN THE PLANS, IF, DURING THE COURSE OF THE CONSTRUCTION, THE PUBLIC INTEREST REQUIRES A MODIFICATION OF (OR A DEPARTURE FROM) THE SPECIFICATIONS OR THE PLANS. THE COUNTY SHALL HAVE THE AUTHORITY TO REQUIRE THE SUSPENSION OF WORK, AND THE NECESSARY MODIFICATION OR DEPARTURE AND TO SPECIFY THE MANNER IN WHICH THE SAME IS TO BE MADE.

DATE _____ CHRISTOPHER L. FREITAS _____ RCE 42107 EXP. 03/31/2016
NAME SIGNATURE R.C.E. No. / EXPIRATION DATE

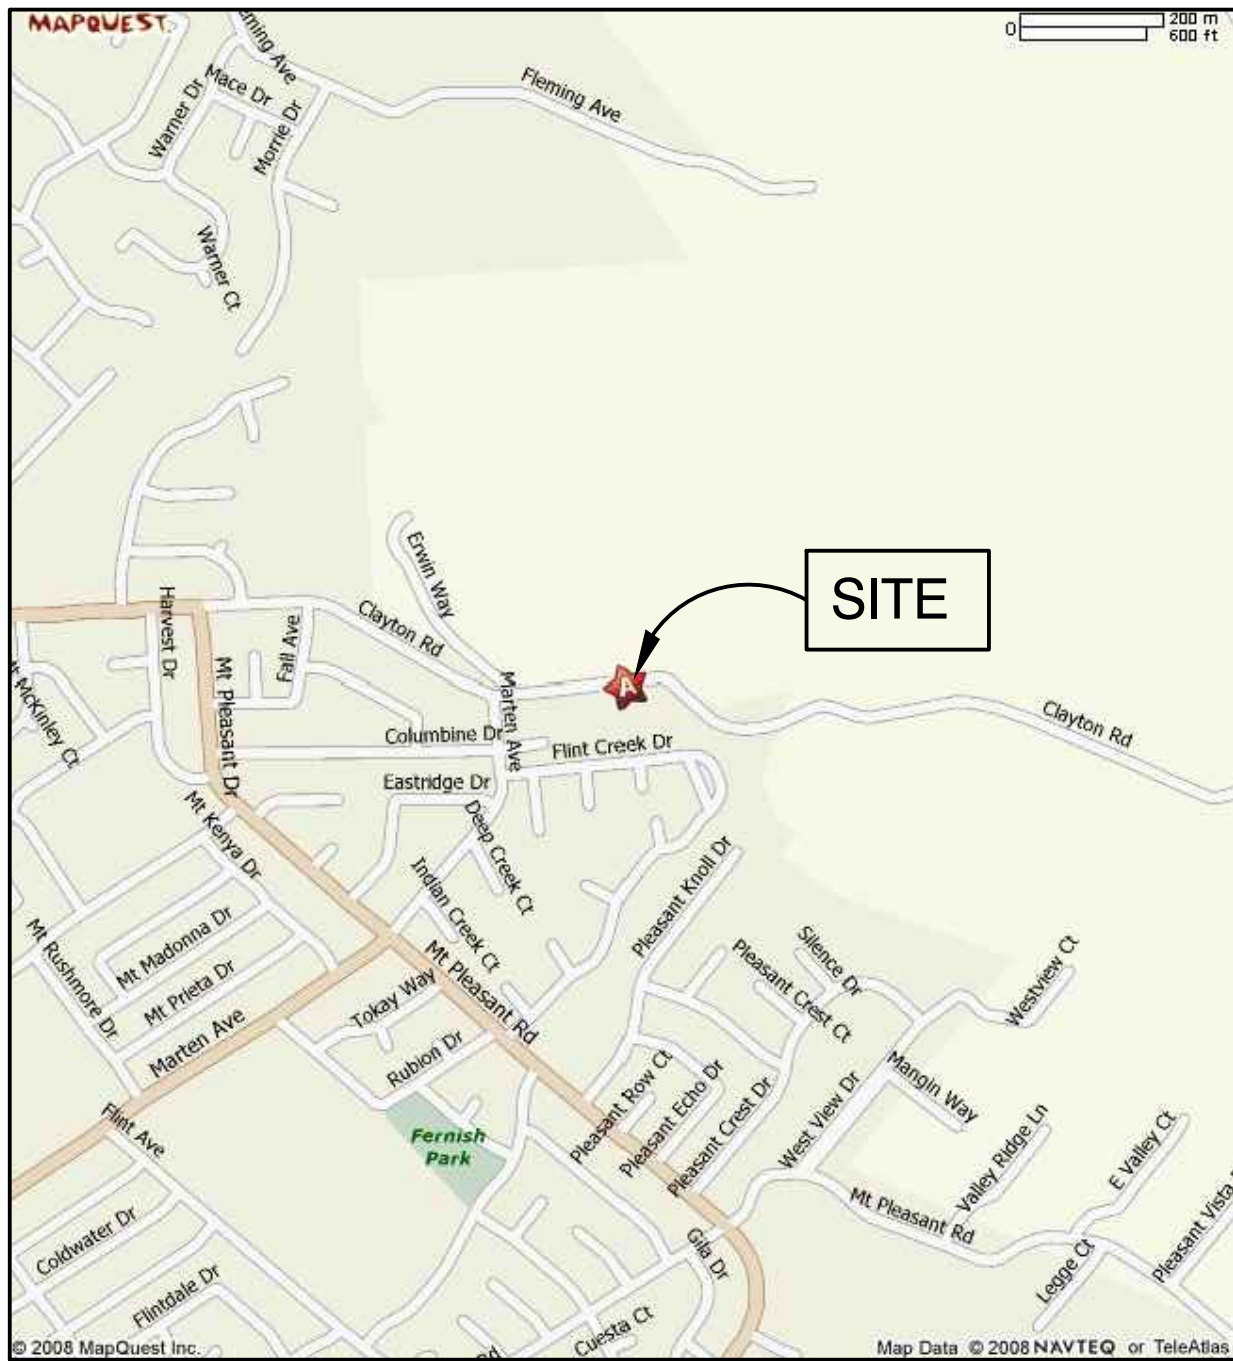

VICINITY MAP

NTS

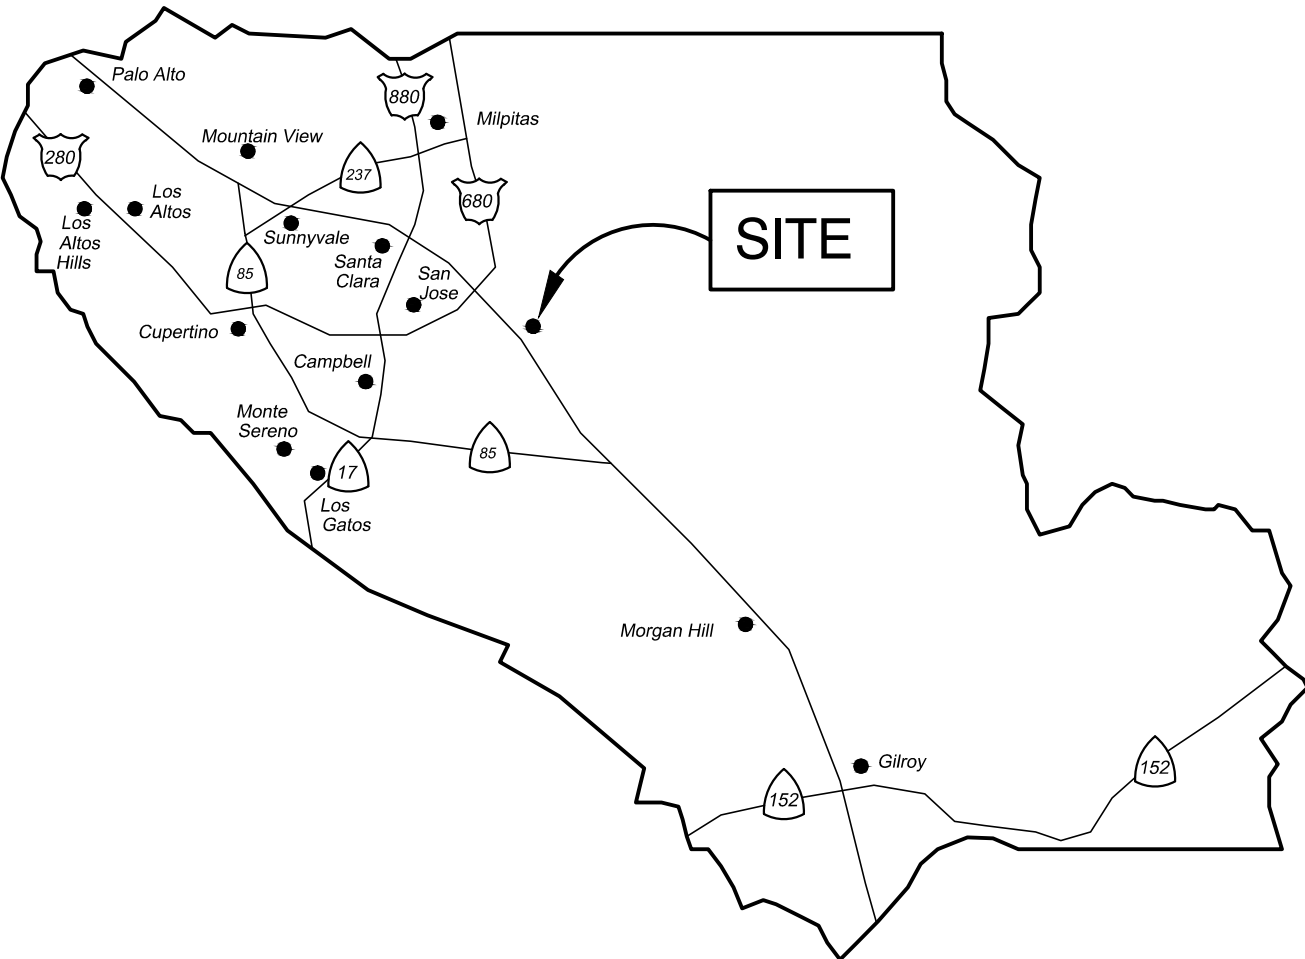

COUNTY LOCATION MAP

NTS

STEVEN ARNOLD CIVIL ENGINEERING, INC.
492 PRINCE STREET
OAKLAND, CALIFORNIA 94610
PHONE (415) 786-9622
EMAIL arnoldengineering@comcast.net



MARK	REVISIONS	DATE
	DEH REVIEW	01/11/2010
	ARCH. CHANGES	06/18/2010
	REVIEW DRAWINGS	01/25/2013
	DRX/BSA/GS SUBMITTAL	04/10/2013
	COMMENTS DATED 06/13/2013	12/10/2013
	COMMENTS DATED 01/21/2014 EMAIL DATED 03/17/2014	08/13/2014
	COMMENTS DATED 09/22/2014	12/04/2014
	DEH EMAIL COMMENTS 01/20/2015	02/18/2015

PROJECT TITLE

NEW CUSTOM HOME
LANDS OF BANSAL
11391 CLAYTON ROAD
SAN JOSE, CALIFORNIA, 95127

APN: 612-37-016

SHEET TITLE

GRADING
TITLE SHEET


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SCALE	AS SHOWN
DRAWN	AEA
JOB	03-07
SHEET	

G-1

APPLICANT: BANSAL

ROAD NAME: CLAYTON ROAD

COUNTY FILE NO.

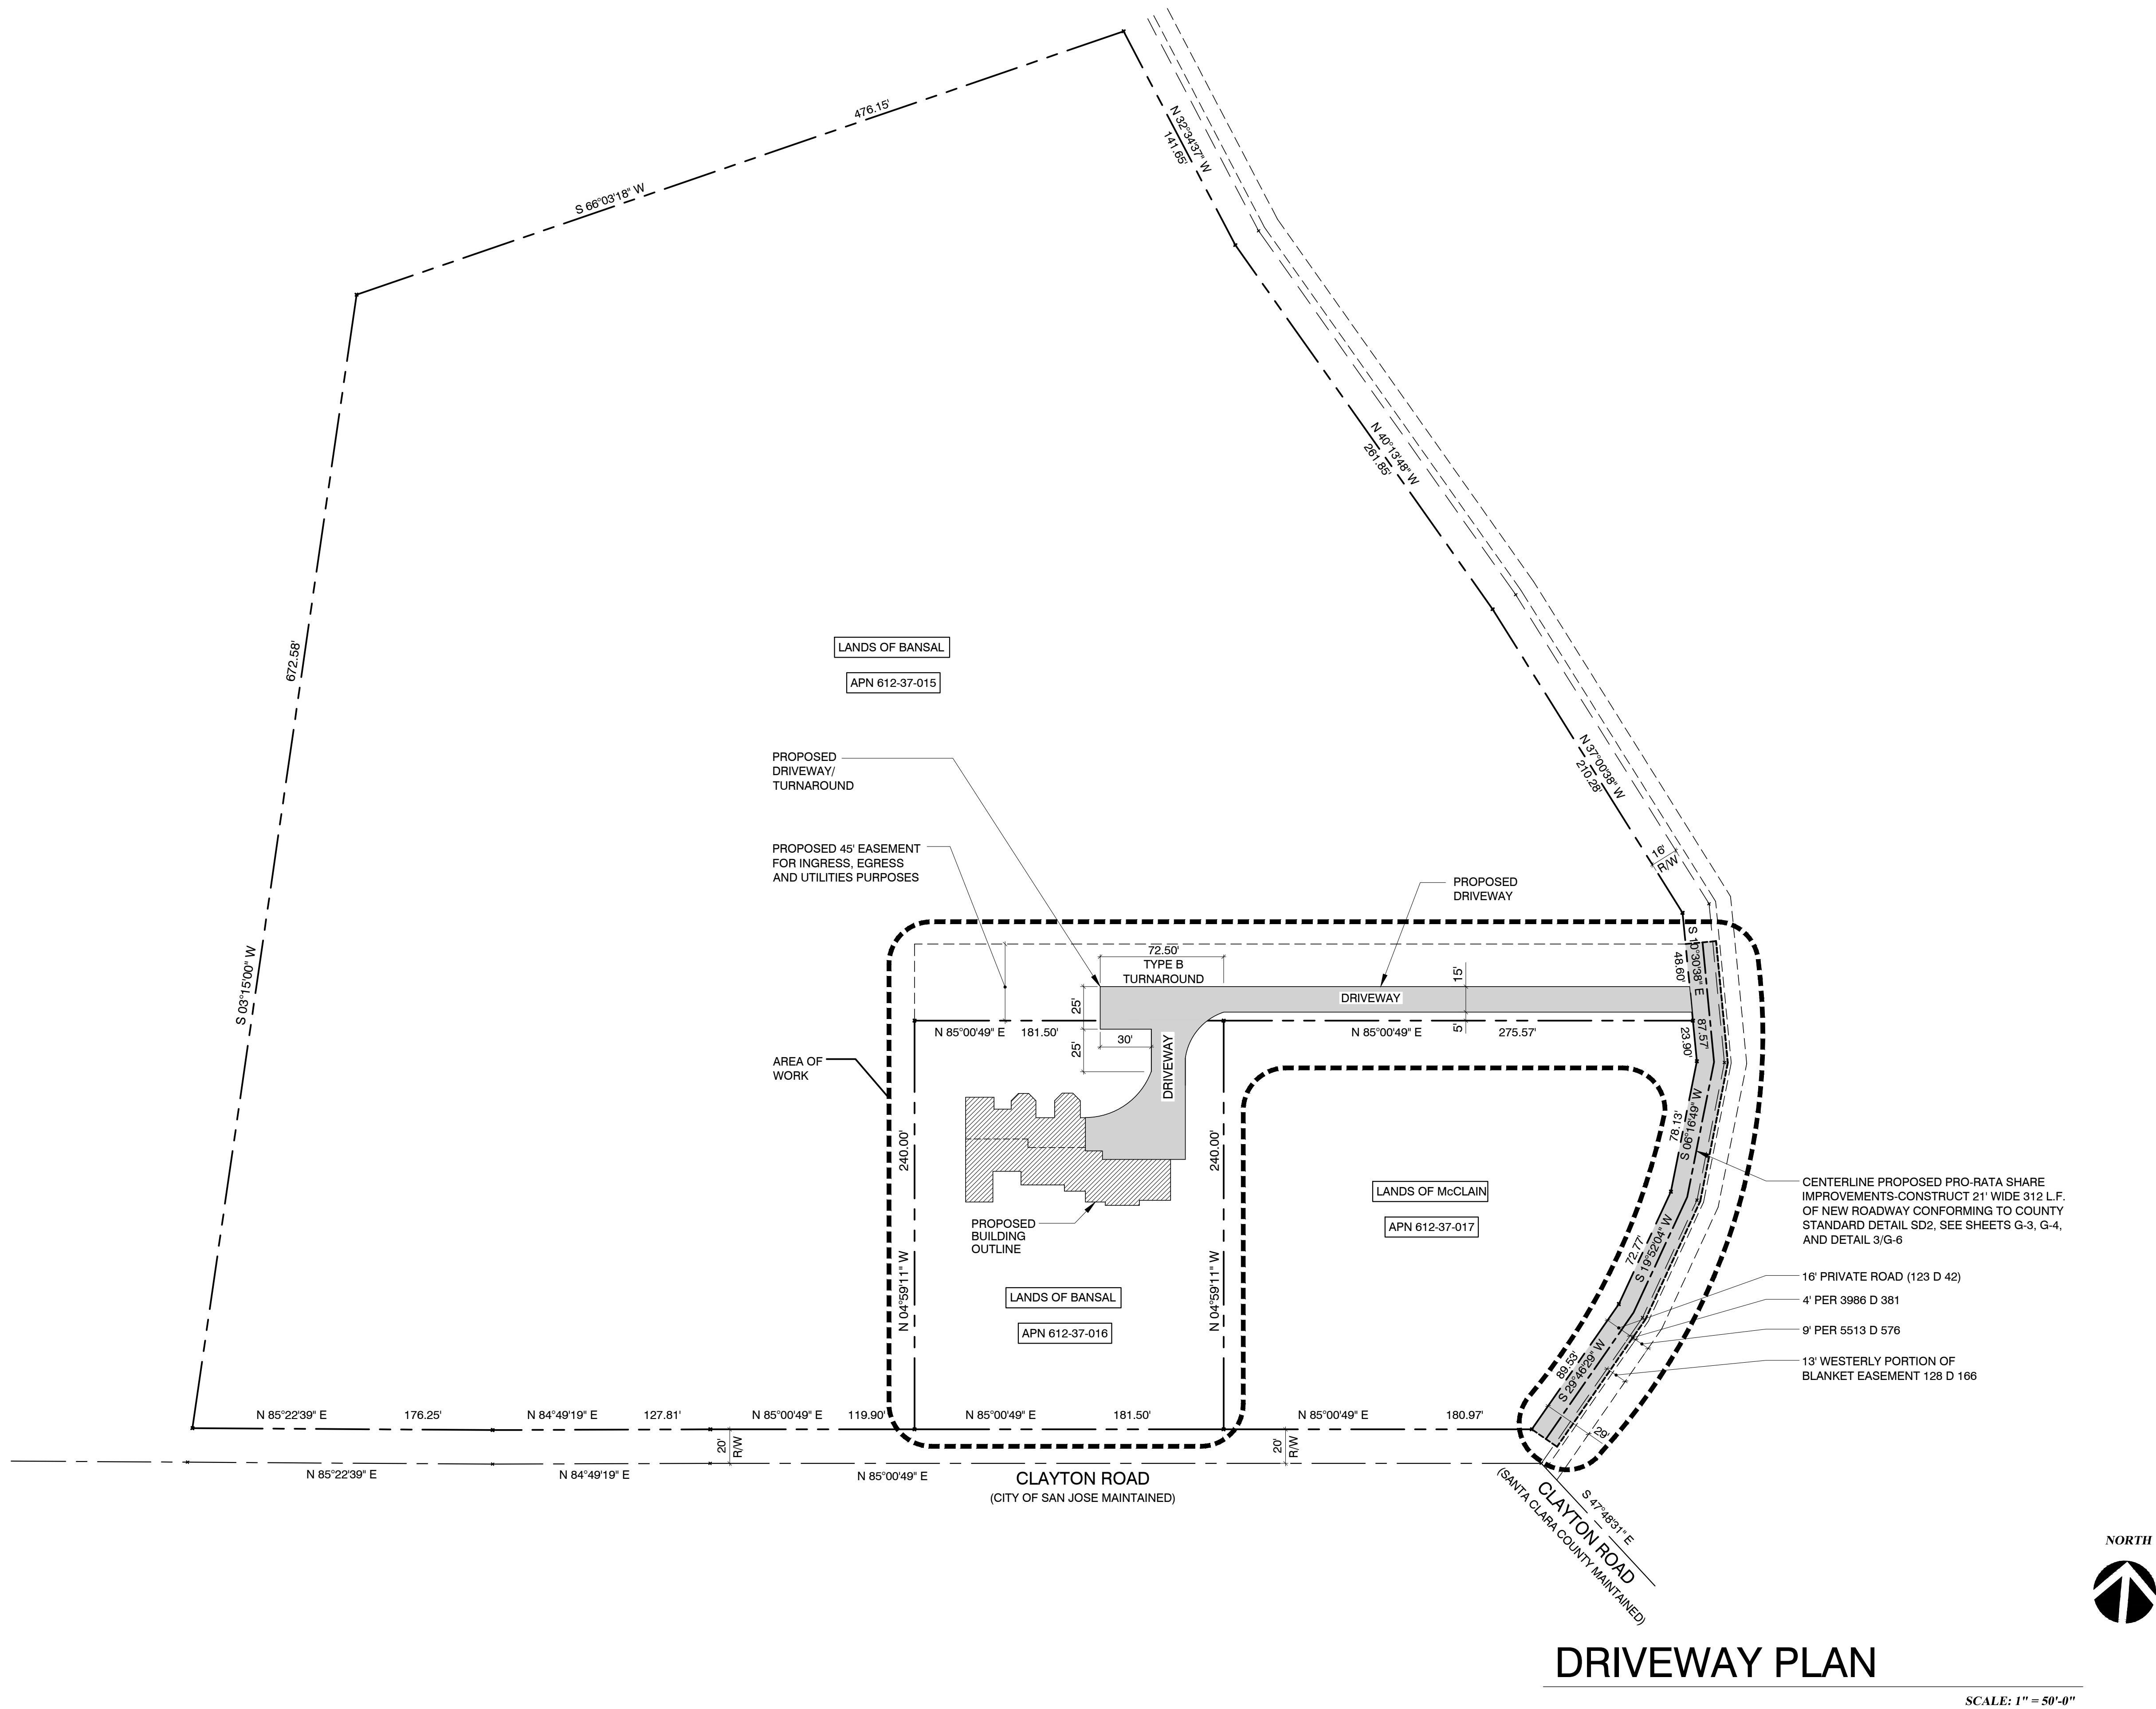

MARK	REVISIONS	DATE
	DEH REVIEW	01/11/2010
	ARCH. CHANGES	06/18/2010
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PROJECT TITLE

NEW CUSTOM HOME
LANDS OF BANSAL
11391 CLAYTON ROAD
SAN JOSE, CALIFORNIA, 95127

APN: 612-37-016

SHEET TITLE

DRIVEWAY PLAN

DATE

FEBRUARY 18, 2015

SCALE

AS SHOWN

DRAWN


AEA

JOB

03-07

SHEET

G-2

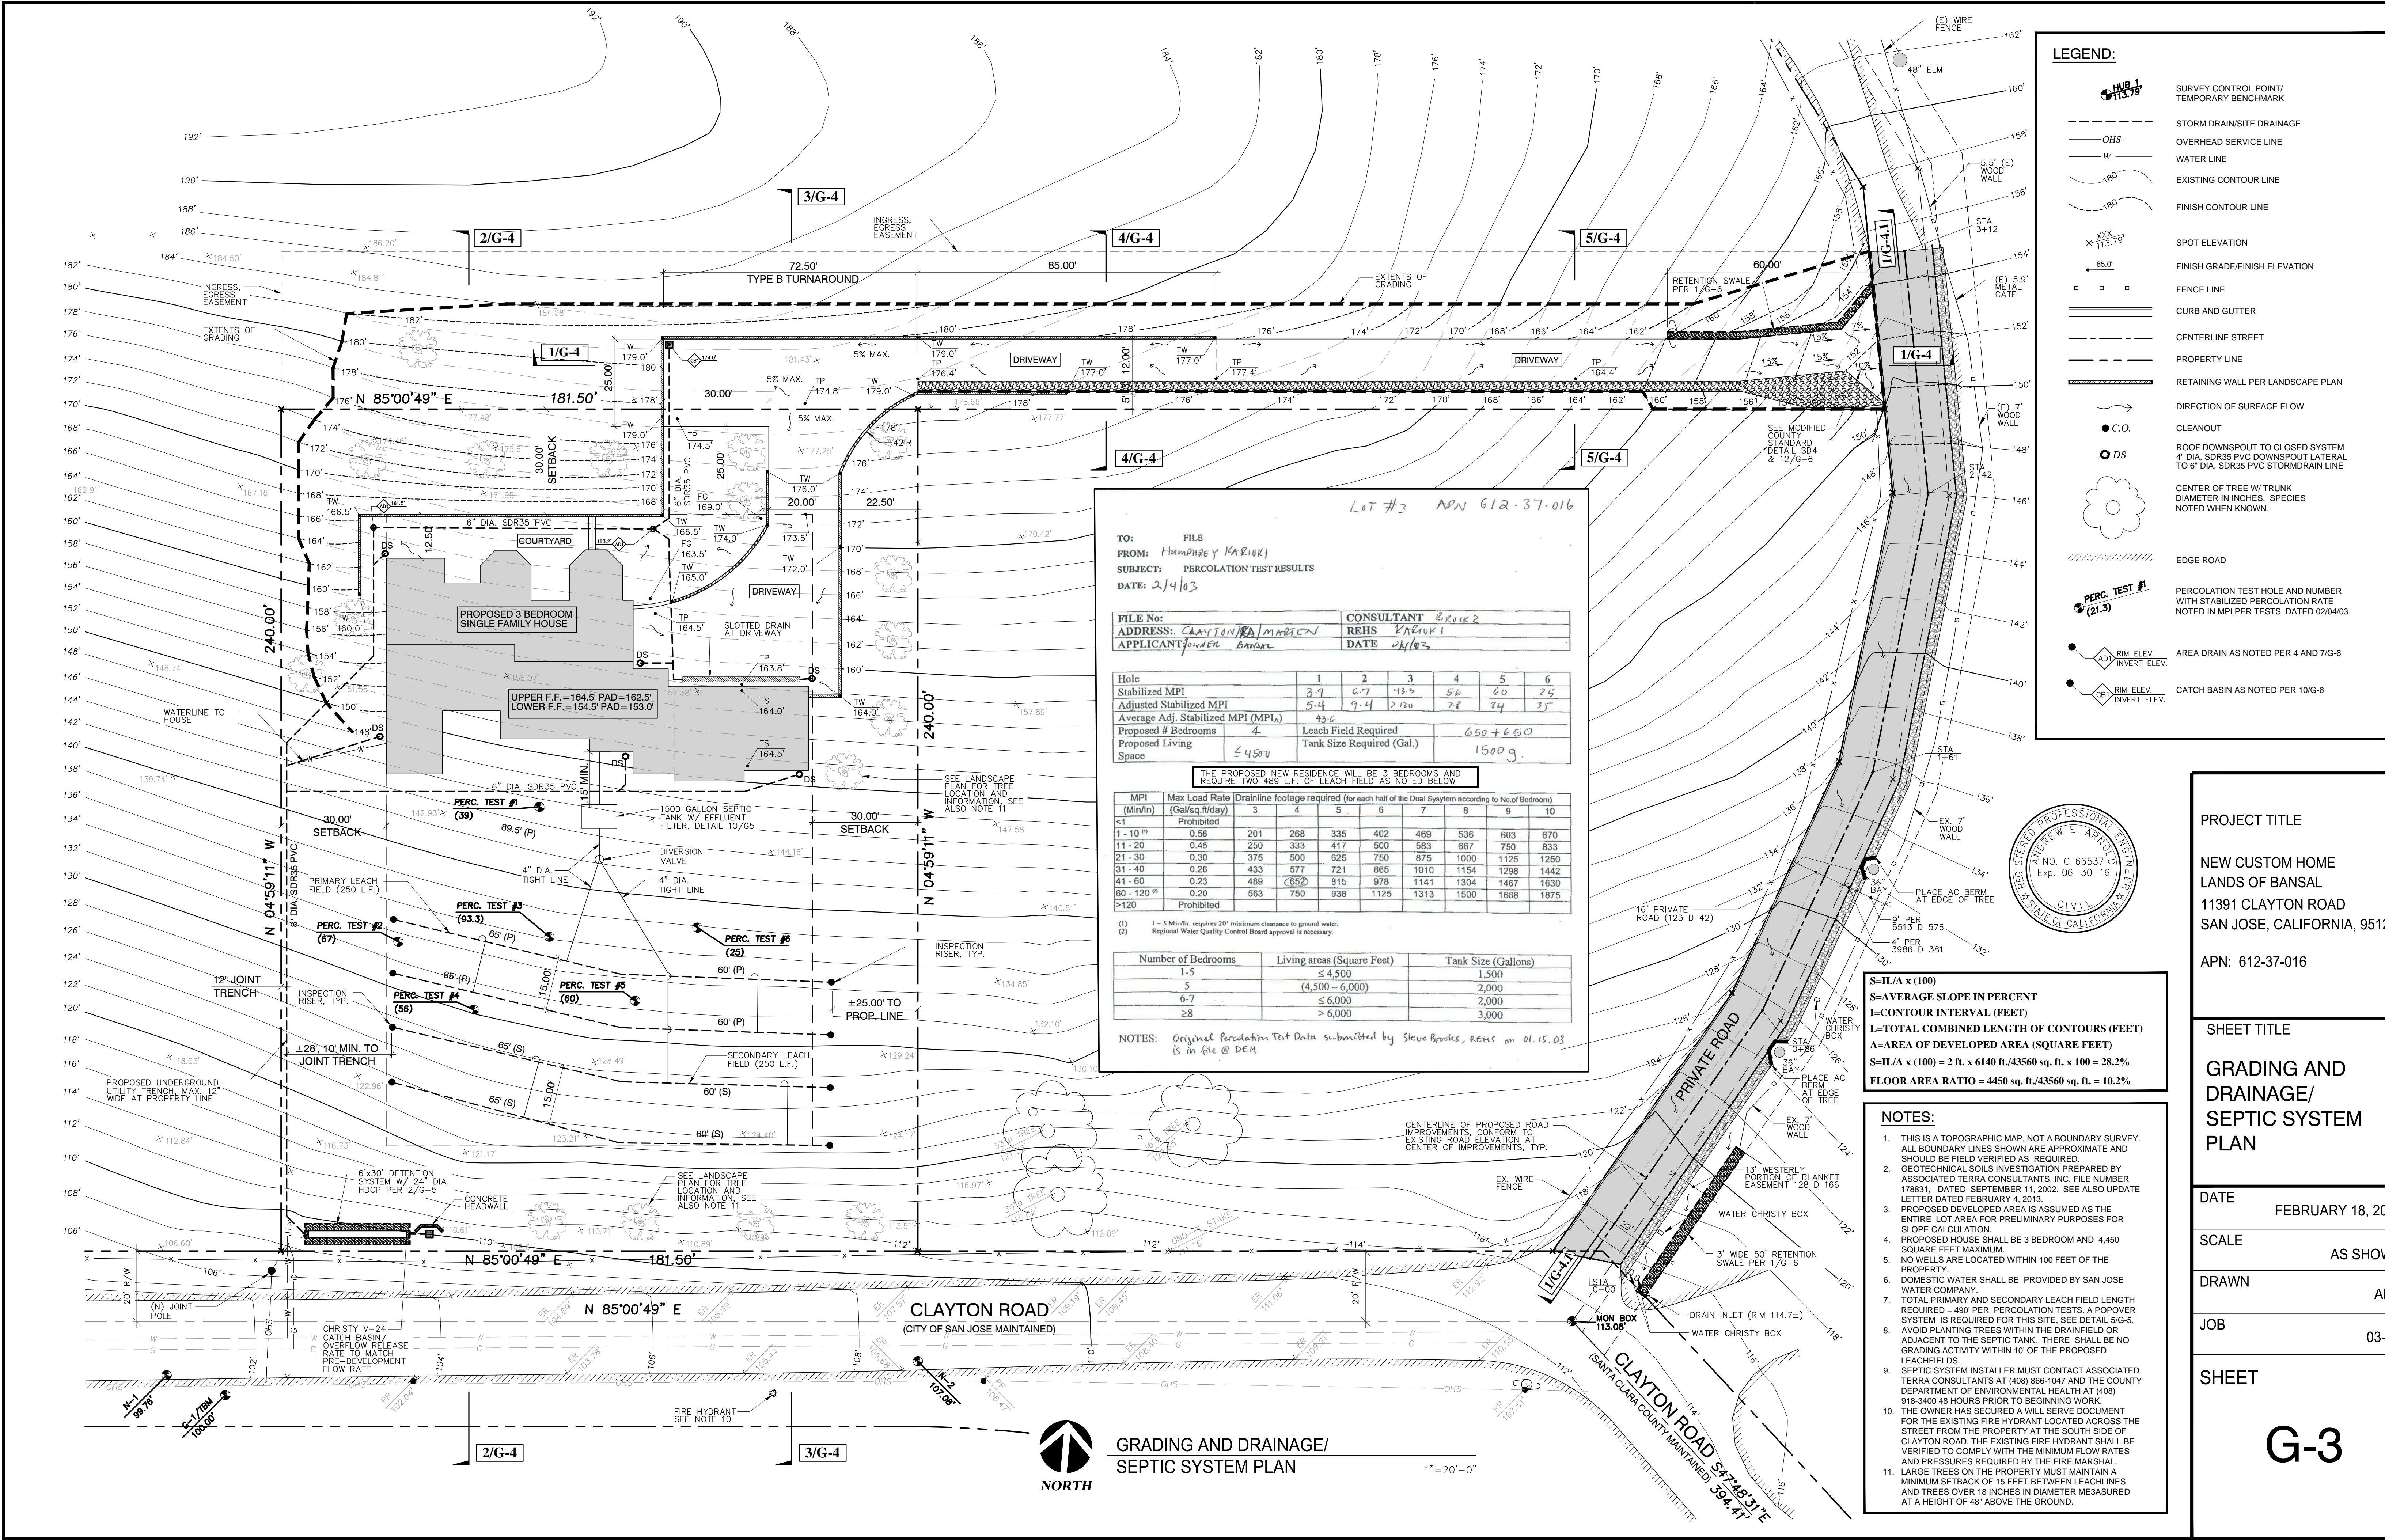

APPLICANT: BANSAL

ROAD NAME: CLAYTON ROAD


COUNTY FILE NO.

PROJECT TITLE
NEW CUSTOM HOME
LANDS OF BANSAL
11391 CLAYTON ROAD
SAN JOSE, CALIFORNIA, 95127
APN: 612-37-016


SHEET TITLE
GRADING AND
DRAINAGE/
SEPTIC SYSTEM
PLAN

DATE
FEBRUARY 18, 2015
SCALE
AS SHOWN
DRAWN
AEA
JOB
03-07
SHEET


G-3

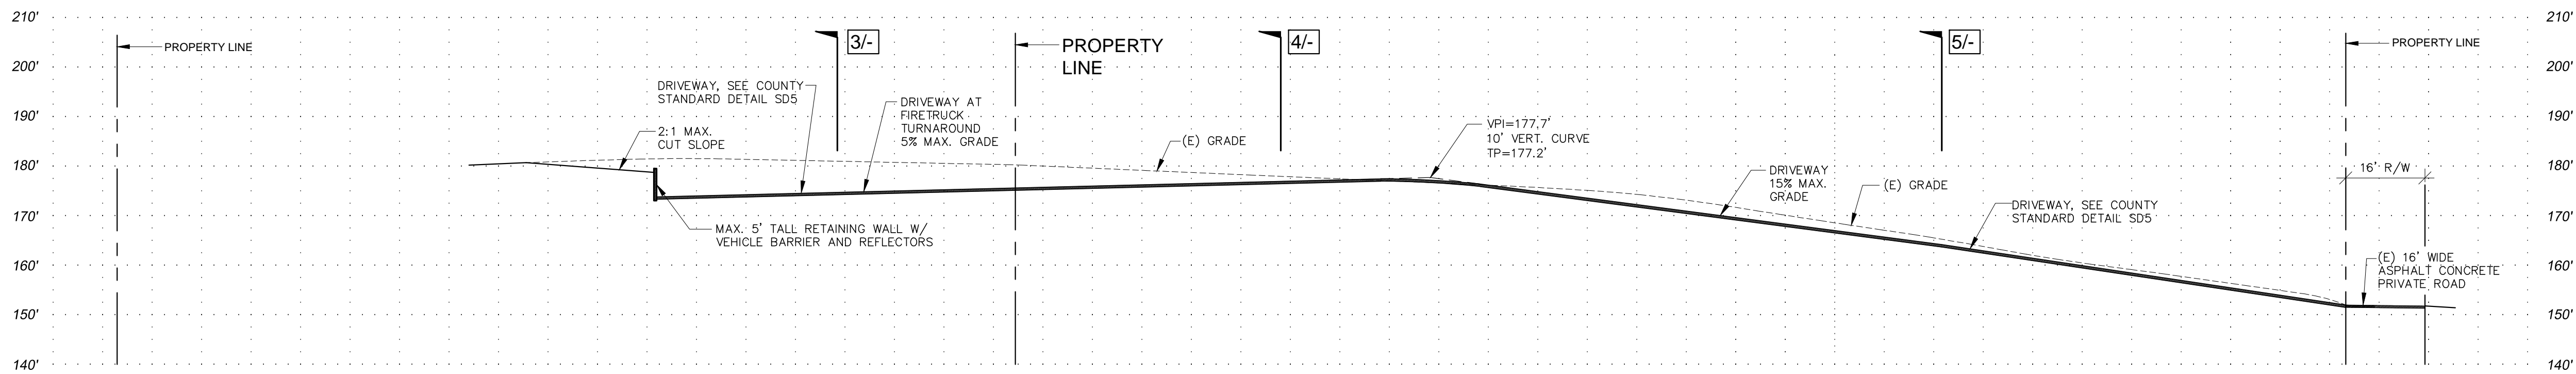


1 DRIVEWAY PROFILE
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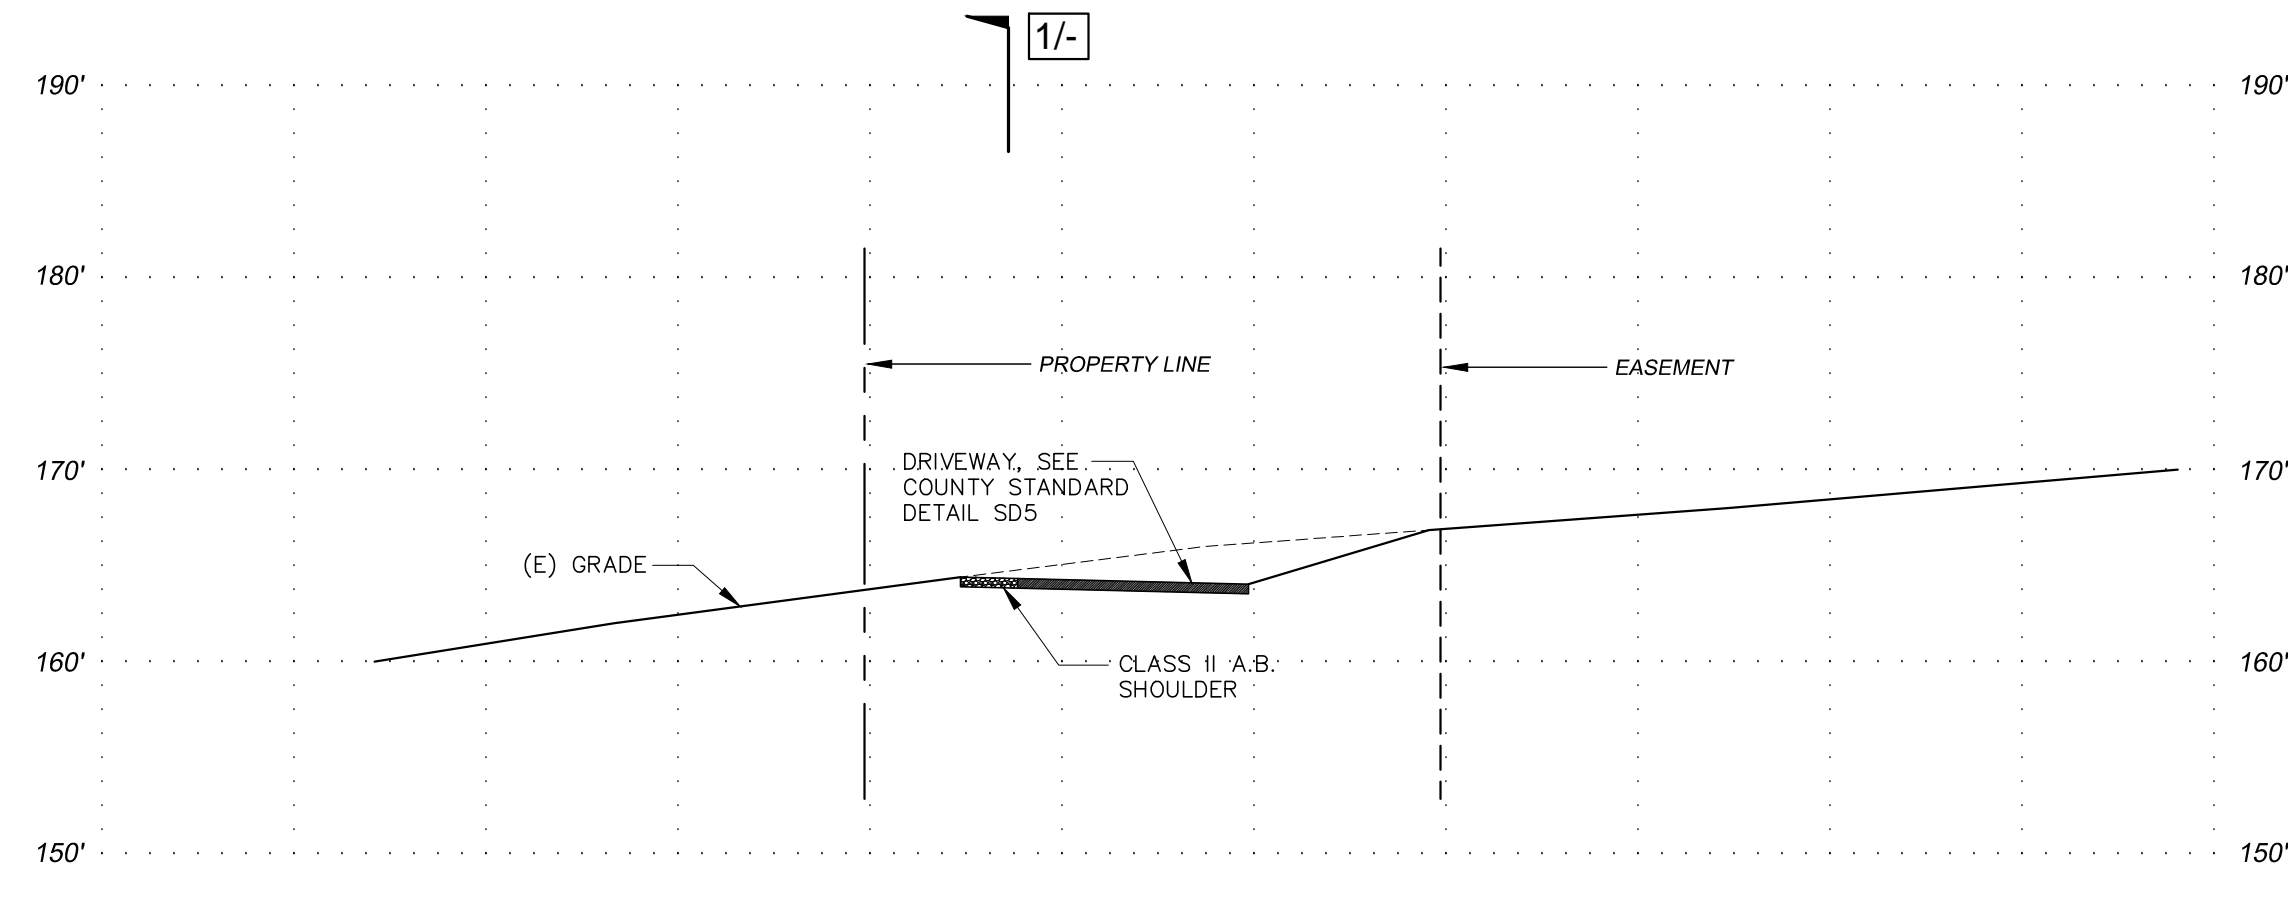
2 SECTION
SCALE: 1"=20'-0" H/V

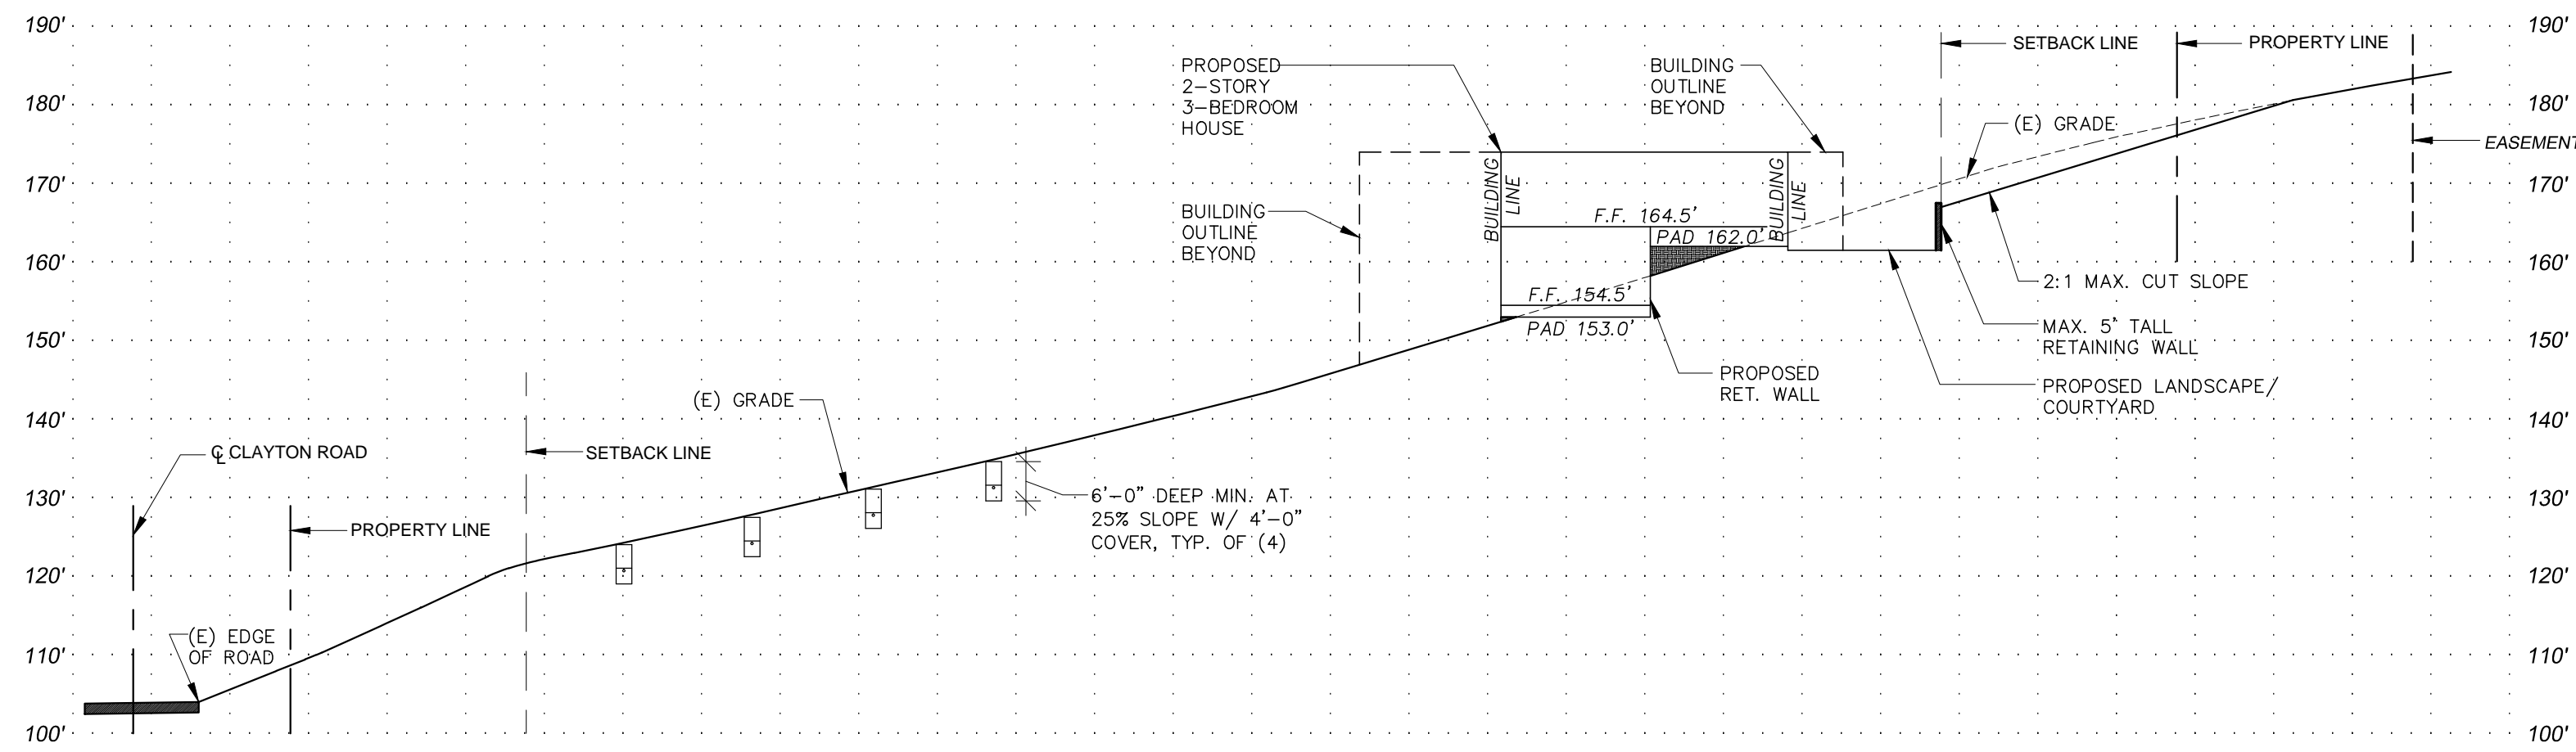

3 SECTION
SCALE: 1"=20'-0" H/V

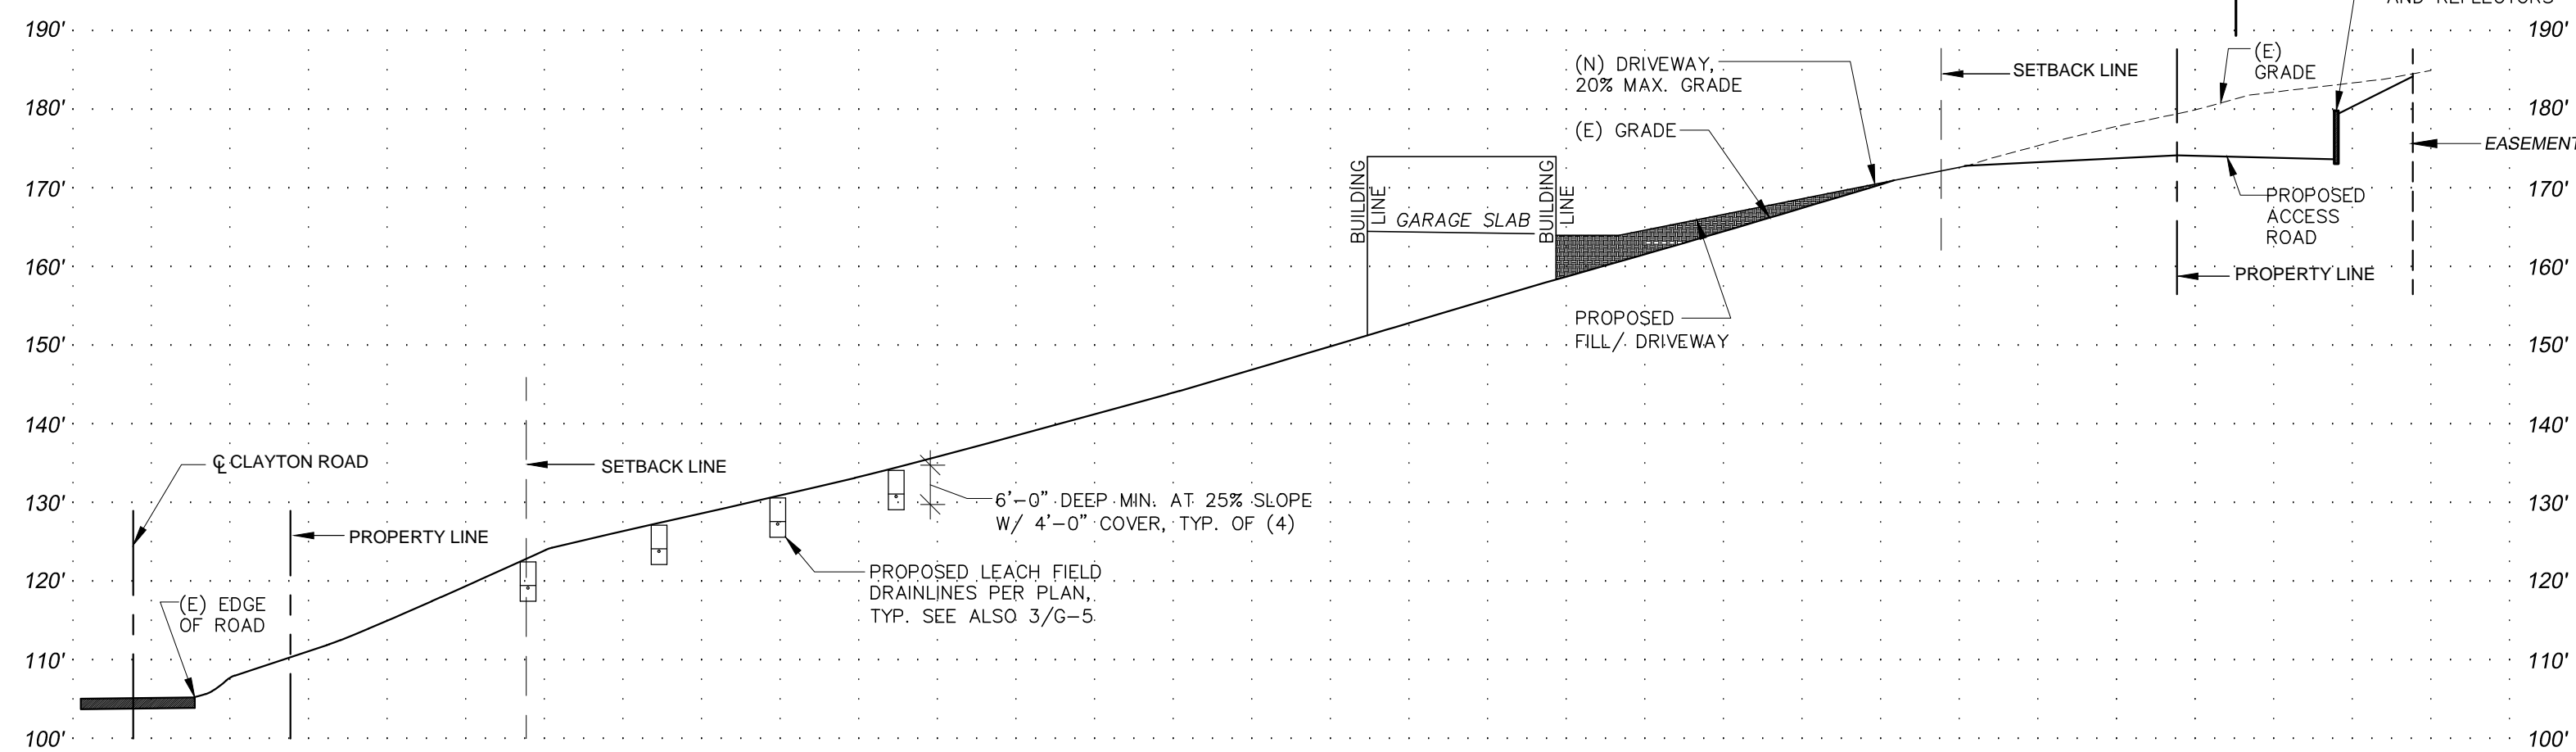

4 SECTION
SCALE: 1"=10'-0" H/V

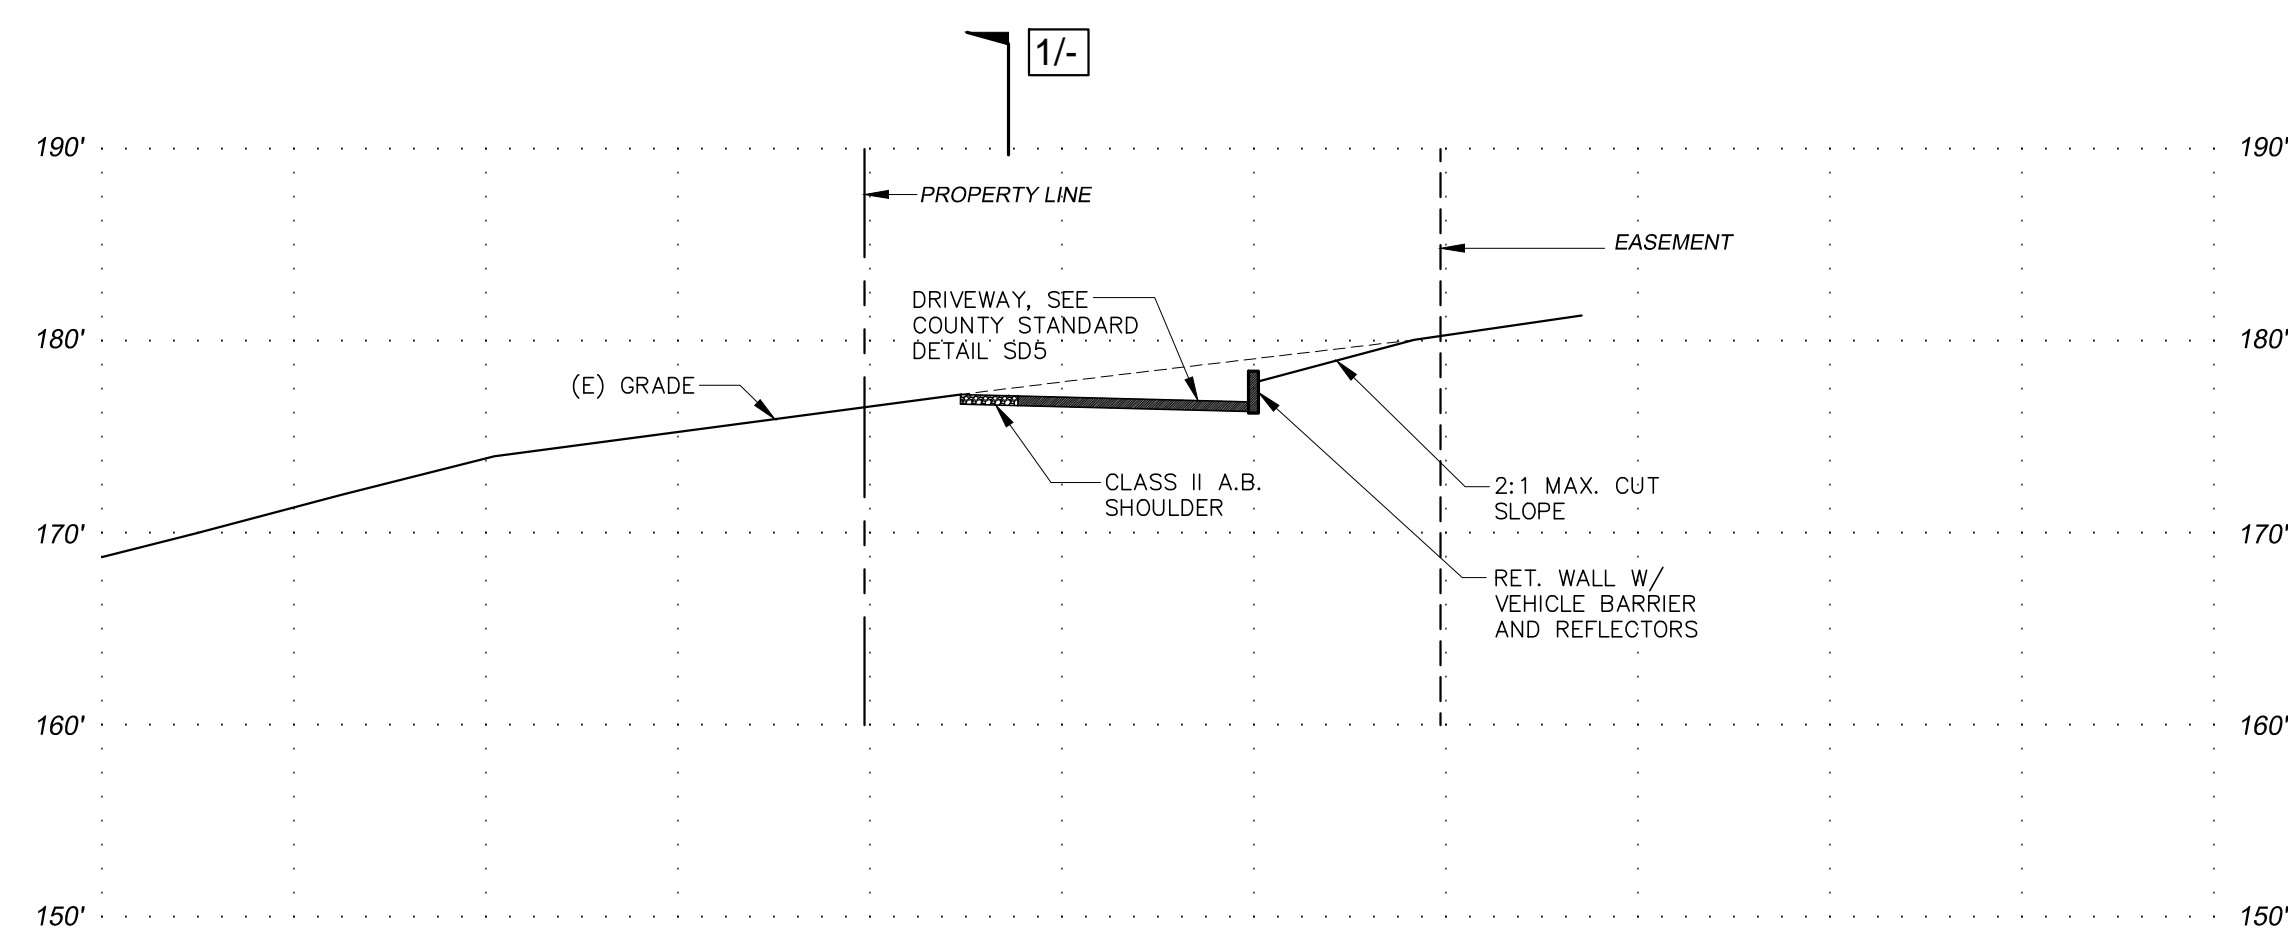

5 SECTION
SCALE: 1"=10'-0" H/V

APPROVED FOR ISSUANCE
REFER TO ENCROACHMENT AND/OR
CONSTRUCTION PERMIT AND PLAN
COVER SHEET FOR SPECIAL
CONDITIONS AND PERMIT NUMBERS

STEVEN ARNOLD CIVIL ENGINEERING, INC.
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PROJECT TITLE

NEW CUSTOM HOME
LANDS OF BANSAL
11391 CLAYTON ROAD
SAN JOSE, CALIFORNIA, 95127

APN: 612-37-016

SHEET TITLE

GRADING
SECTIONS

DATE FEBRUARY 18, 2015

SCALE AS SHOWN

DRAWN AEA

JOB 03-07

SHEET

G-4

APPLICANT: BANSAL

ROAD NAME: CLAYTON ROAD

COUNTY FILE NO.

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PROJECT TITLE

NEW CUSTOM HOME
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11391 CLAYTON ROAD
SAN JOSE, CALIFORNIA, 95127

APN: 612-37-016

SHEET TITLE

GRADING
SECTIONS

DATE
FEBRUARY 18, 2015

SCALE
AS SHOWN


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AEA

JOB
03-07


SHEET

G-4.1


APPROVED FOR ISSUANCE
REFER TO ENCROACHMENT AND/OR
CONSTRUCTION PERMIT AND PLAN
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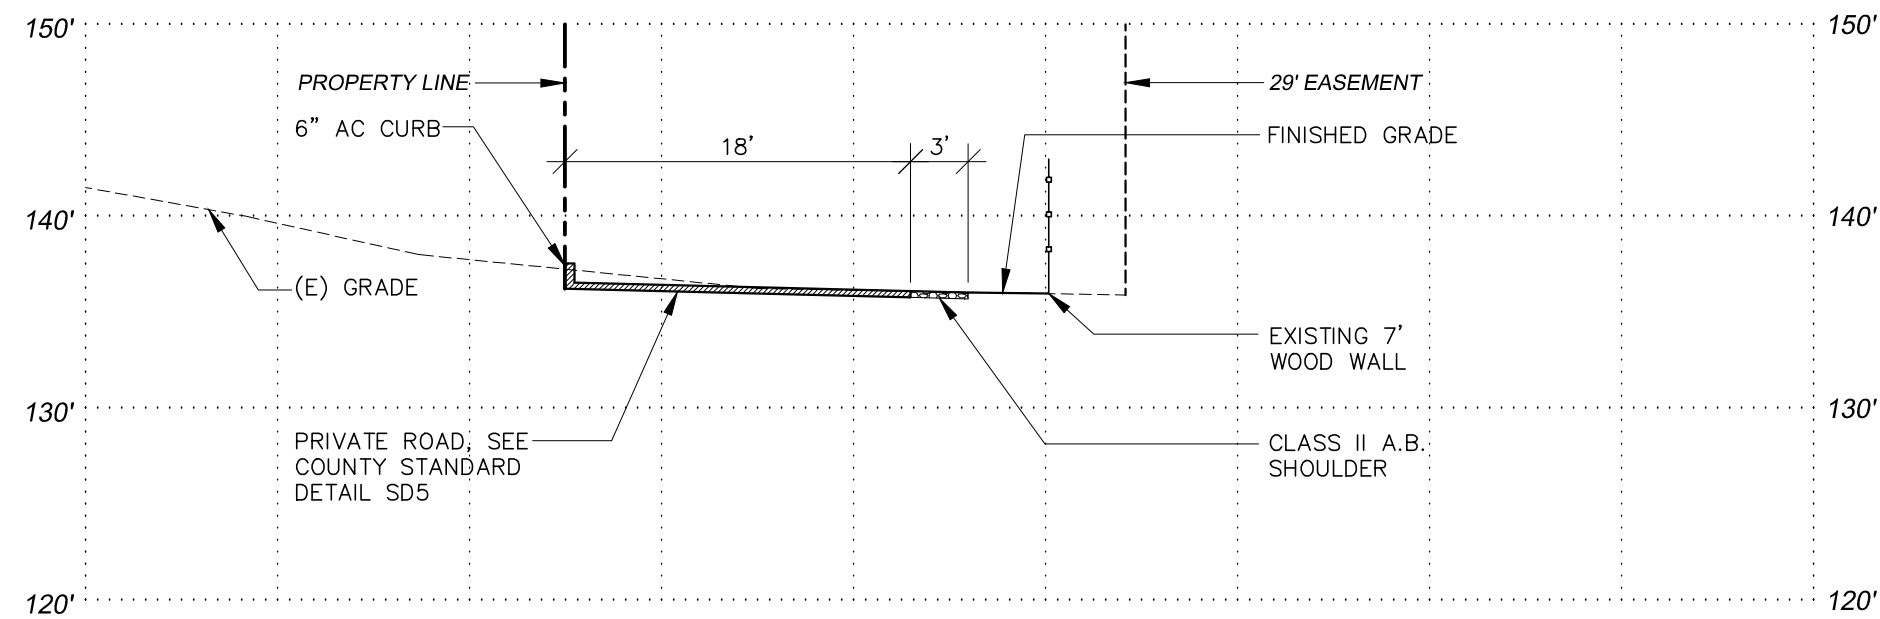
A PRIVATE ROAD
SCALE: 1"=20'-0" H.V.

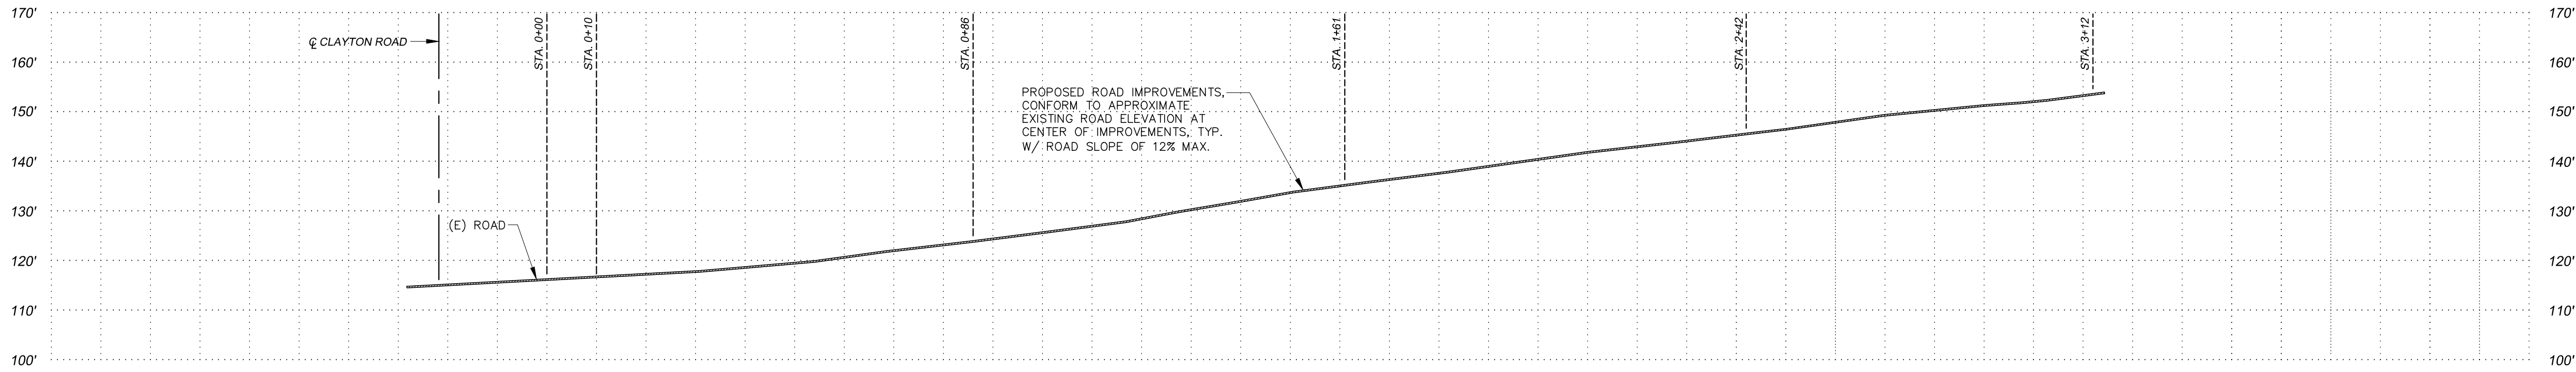


1 STA. 0+10
SCALE: 1"=10'-0" H.V.

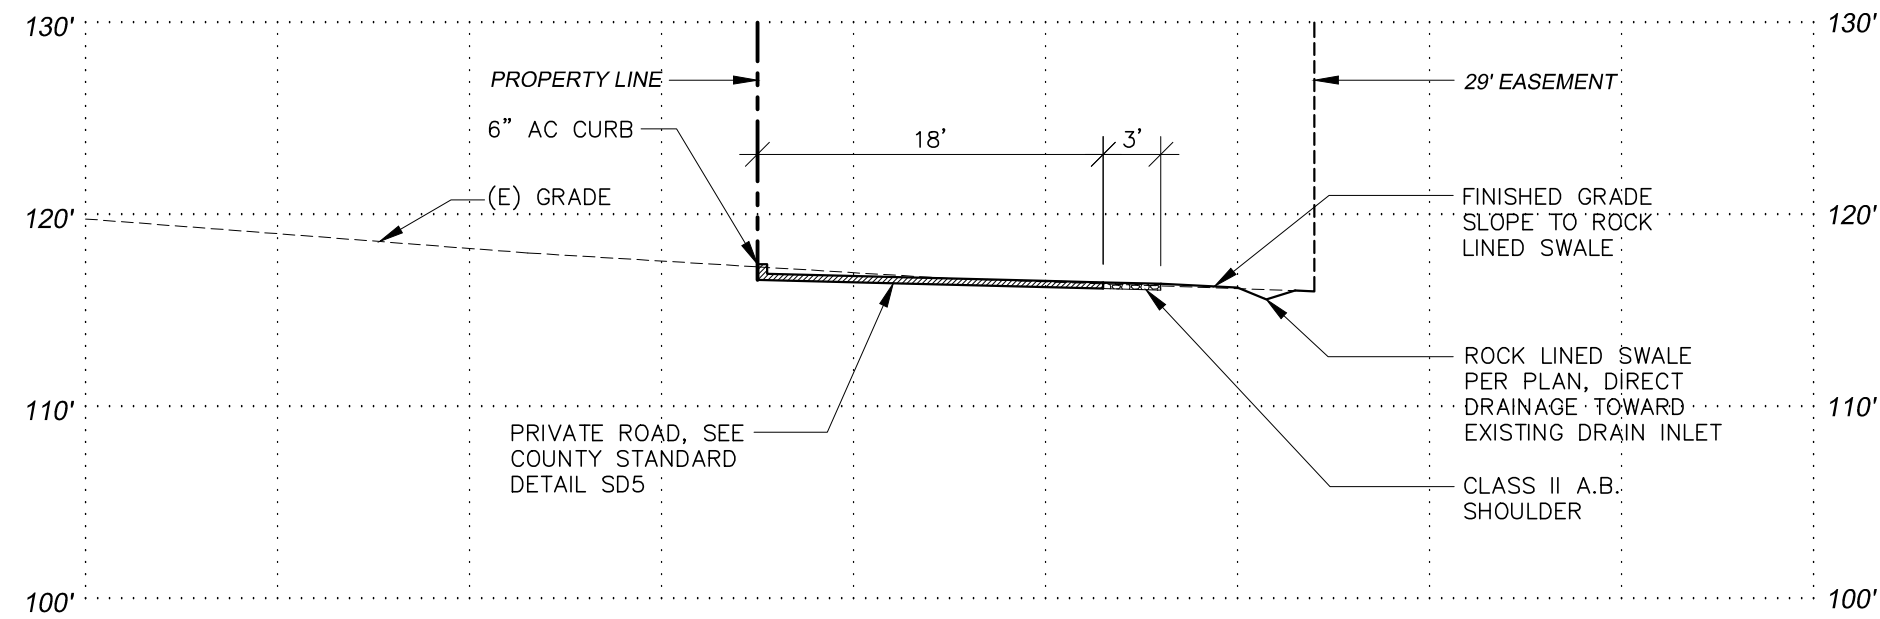


2 STA. 0+86
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3 STA. 1+61
SCALE: 1"=10'-0" H.V.

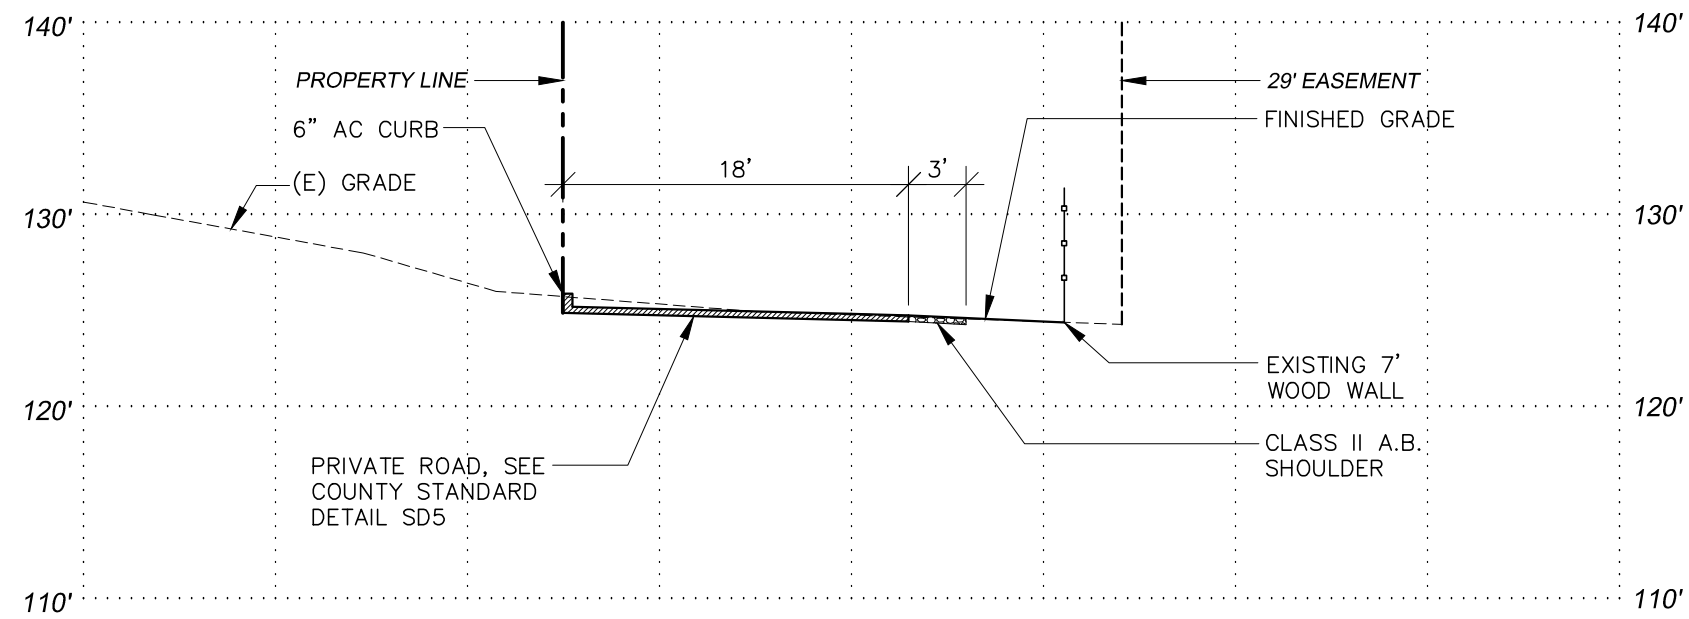

4 STA. 2+42
SCALE: 1"=10'-0" H.V.

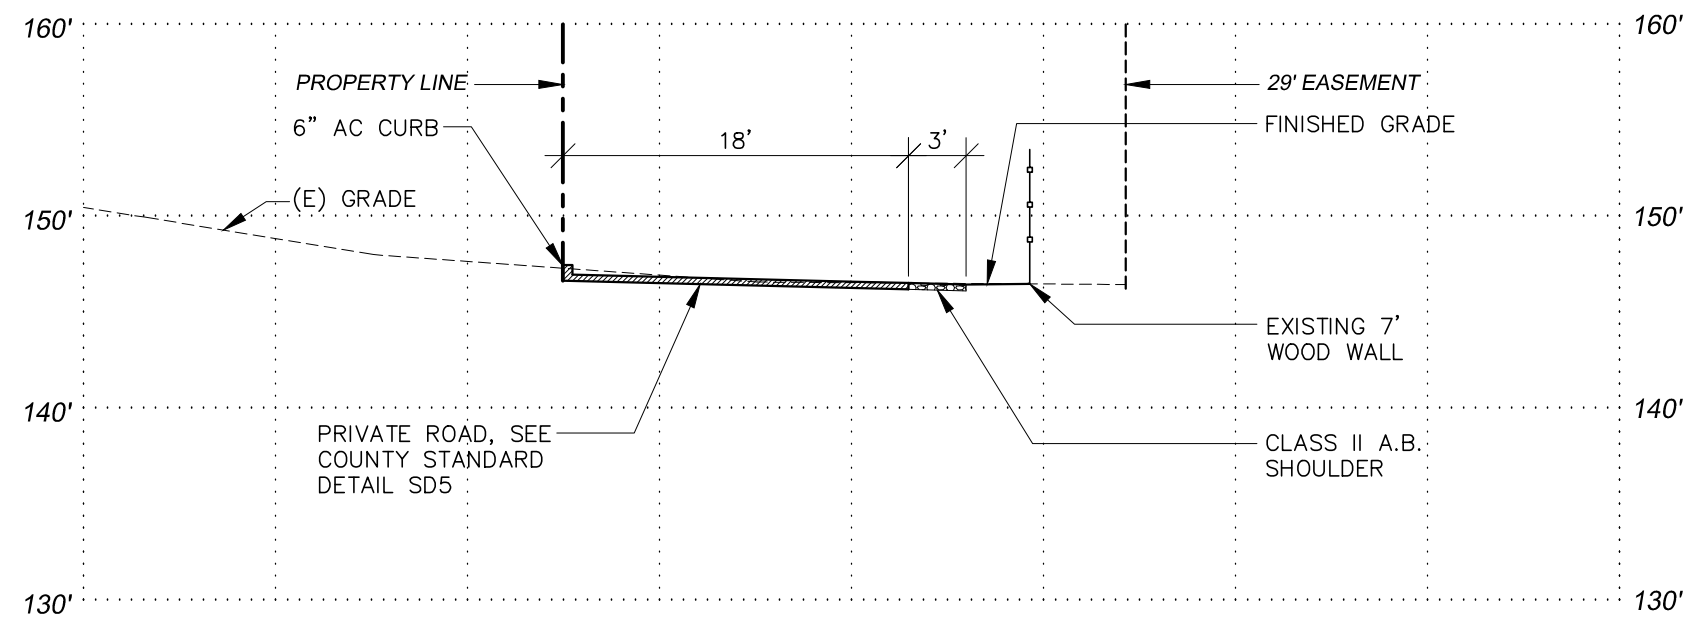

10	DRAIN INLET/SILT BASIN (V-64)	NTS	7	AREA DRAIN (V-1)	NTS	4	AREA DRAIN (NDS-90B)	NTS	1	ROCK LINED INFILTRATION SWALE	NTS
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THE EXACT LAYOUT CANNOT BE CONSTRUCTED DUE TO THE EXISTING FIELD CONDITIONS AND ADJACENT PROPERTY RESTRAINTS, SEE DETAIL 12/- FOR PROPOSED DESIGN

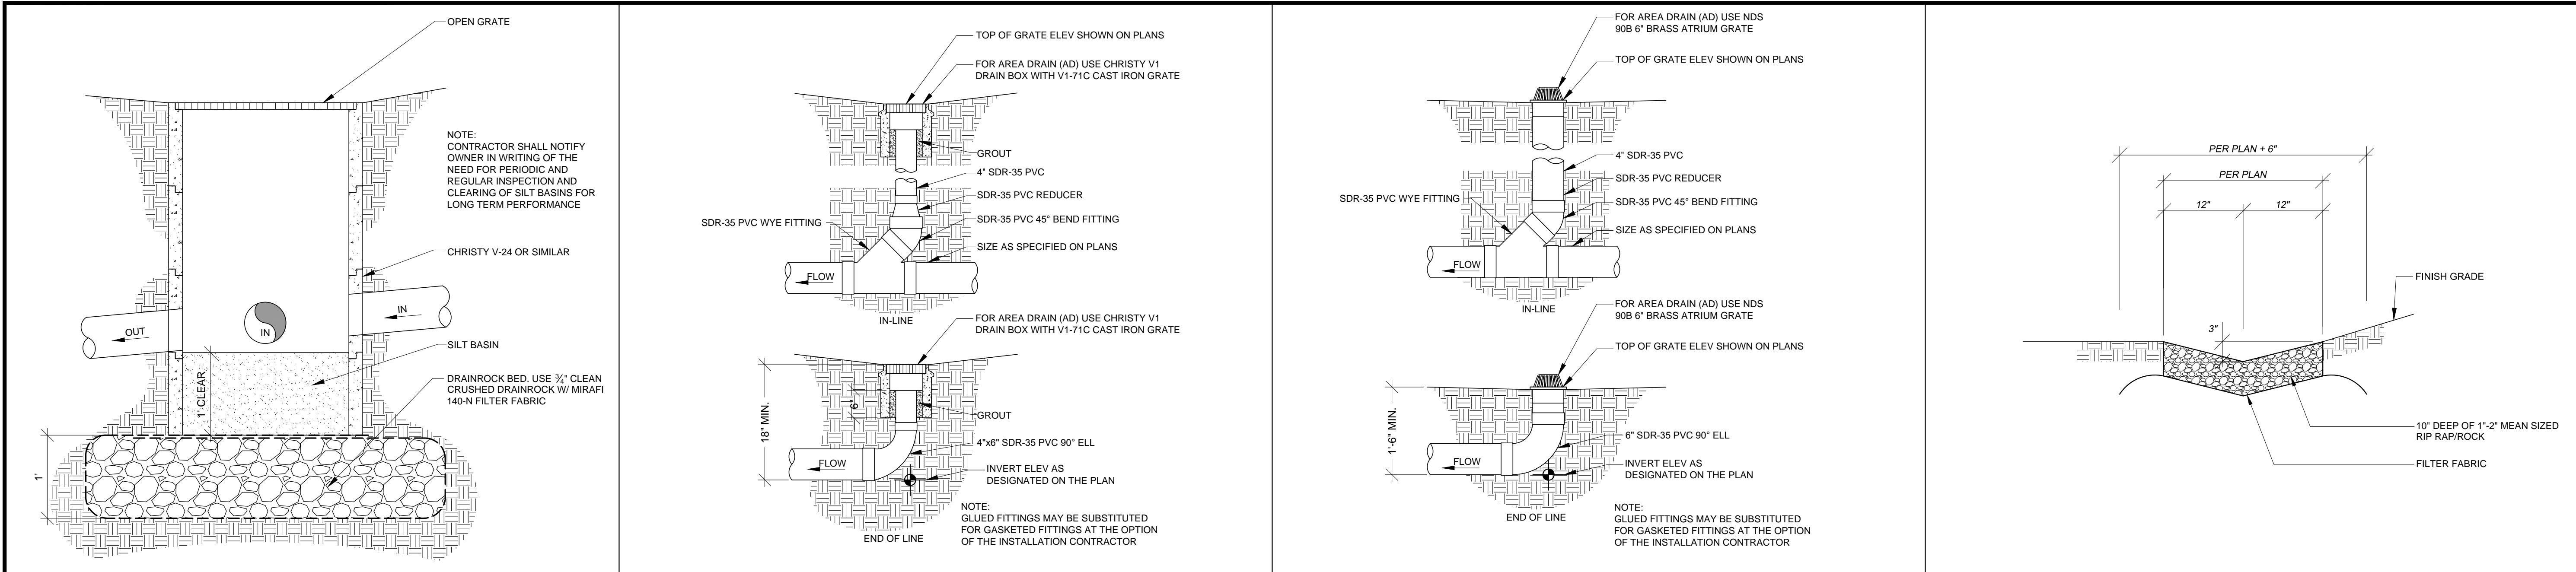APPLICANT: BANSAL

ROAD NAME: CLAYTON ROAD

COUNTY FILE NO.

12	DRIVEWAY TO PRIVATE ROAD	NTS	9	COUNTY STANDARD DETAIL-SD5	NTS	6	COUNTY STANDARD DETAIL-SD4	NTS	3	COUNTY STANDARD DETAIL-SD2	NTS
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PROJECT TITLE

NEW CUSTOM HOME LANDS OF BANSAL
11391 CLAYTON ROAD
SAN JOSE, CALIFORNIA, 95127

APN: 612-37-016

SHEET TITLE

GRADING DETAILS

DATE FEBRUARY 18, 2015

SCALE AS SHOWN

DRAWN AEA

JOB 03-07

SHEET

G-6