



# BUILDING SITE APPROVAL/ GRADING AND DRAINAGE PLAN/ SEPTIC SYSTEM PLAN

PREPARED FOR: PROPERTY LOCATION: VINOD AND JANAK BANSAL 11391 CLAYTON ROAD SAN JOSE, CALIFORNIA 95127

G-1

G-2

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G-4.1

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L-1

SHEET INDEX

COVER SHEET/INDEX

LOWER FLOOR PLAN

**EXTERIOR ELEVATIONS** 

**EXTERIOR ELEVATIONS** 

**GRADING TITLE SHEET** 

SEPTIC SYSTEM PLAN

**GRADING SECTIONS** 

**GRADING SECTIONS** 

GRADING DETAILS

GRADING DETAILS

LANDSCAPE PLAN

GRADING AND DRAINAGE PLAN/

MAIN FLOOR PLAN

**CROSS SECTION** 

DRIVEWAY PLAN

SITE PLAN

**ROOF PLAN** 

l	MARK	REVISIONS	DATE
		DEH REVIEW	01/11/2010
ł		ARCH. CHANGES	06/18/2010
		REVIEW DRAWINGS	01/25/2013
		DRX/BSA/GS SUBMITTAL	04/10/2013
		COMMENTS DATED 06/13/2013	12/10/2013
		COMMENTS DATED 01/21/2014 EMAIL DATED 03/17/2014	08/13/2014
		COMMENTS DATED 09/22/2014	12/04/2014
		DEH EMAIL COMMENTS 01/20/2015	02/18/2015

# PROJECT TITLE

NEW CUSTOM HOME LANDS OF BANSAL 11391 CLAYTON ROAD SAN JOSE, CALIFORNIA, 95127

APN: 612-37-016

SHEET TITLE

COVER SHEET/ INDEX

FEBRUARY 18, 2015

SCALE **AS SHOWN** 

DRAWN AEA

03-07

SHEET

AREA MAP **VICINITY MAP** 

PROPOSED LIVING AREA

NUMBER OF BEDROOMS

**LOT AREA** 

ZONING

A.P.N.

PROPOSED F.A.R.

612-37-016

4,450 SQUARE FEET

1.00 Ac. (43,560 SQUARE FEET)

HS-D1

4450/43560 x 100 = 10.2%

FRONT SETBACK REAR SETBACK SIDE SETBACK MAXIMUM NUMBER OF STORIES **MAXIMUM HEIGHT CONSTRUCTION TYPE** 

# SITE INFORMATION

# **GEOTECHNICAL ENGINEER**

RICK HALTENHOFF ASSOCIATED TERRA CONSULTANTS, INC. 1735 DELL AVENUE

CAMPBELL, CALIFORNIA 94030 (408) 866-1067 PHONE (408) 866-1047 FAX

# CIVIL ENGINEER

ANDREW E. ARNOLD, P.E. STEVEN ARNOLD CIVIL ENGINEERING, INC. 492 PRINCE STREET OAKLAND, CALIFORNIA 94610

PHONE (415) 786-9622 FAX (415) 871-2582

arnoldengineering@comcast.net **EMAIL** 

APPLICANT: BANSAL

# **OWNERS**

VINOD AND JANAK BANSAL 3522 ADEGA CIRCLE SAN JOSE, CALIFORNIA 95148 (650) 533-9484 PHONE

# ARCHITECTURAL DRAFTING/DESIGNER

JONATHAN COULTER 930 SAN BENITO STREET **HOLLISTER, CALIFORNIA 95023** (831) 537-4040 PHONE


- NEW DRIVEWAY AND TURNAROUND WILL BE CONSTRUCTED AS SHOWN FOR ACCESS.
- NEW SEPTIC SYSTEM AND LEACH FIELD WILL BE INSTALLED AS SHOWN.
- NEW SINGLE FAMILY RESIDENTIAL CUSTOM HOME OF UP TO MAX. 3 BEDROOMS AND A MAXIMUM OF 4,450 SQUARE FEET
- INSTALLED AS SHOWN.
- NEW ROADWAY IMPROVEMENTS ARE PROPOSED FOR THE PRIVATE ACCESS ROAD FROM CLAYTON ROAD UP TO THE 45'

OF LIVING SPACE WILL BE CONSTRUCTED AS SHOWN. - DRAINAGE IMPROVEMENTS AND UTILITIES WILL BE

EASEMENT EXTENSION.

PROJECT DESCRIPTION CONSULTANTS

> **ROAD NAME: CLAYTON ROAD** COUNTY FILE NO.

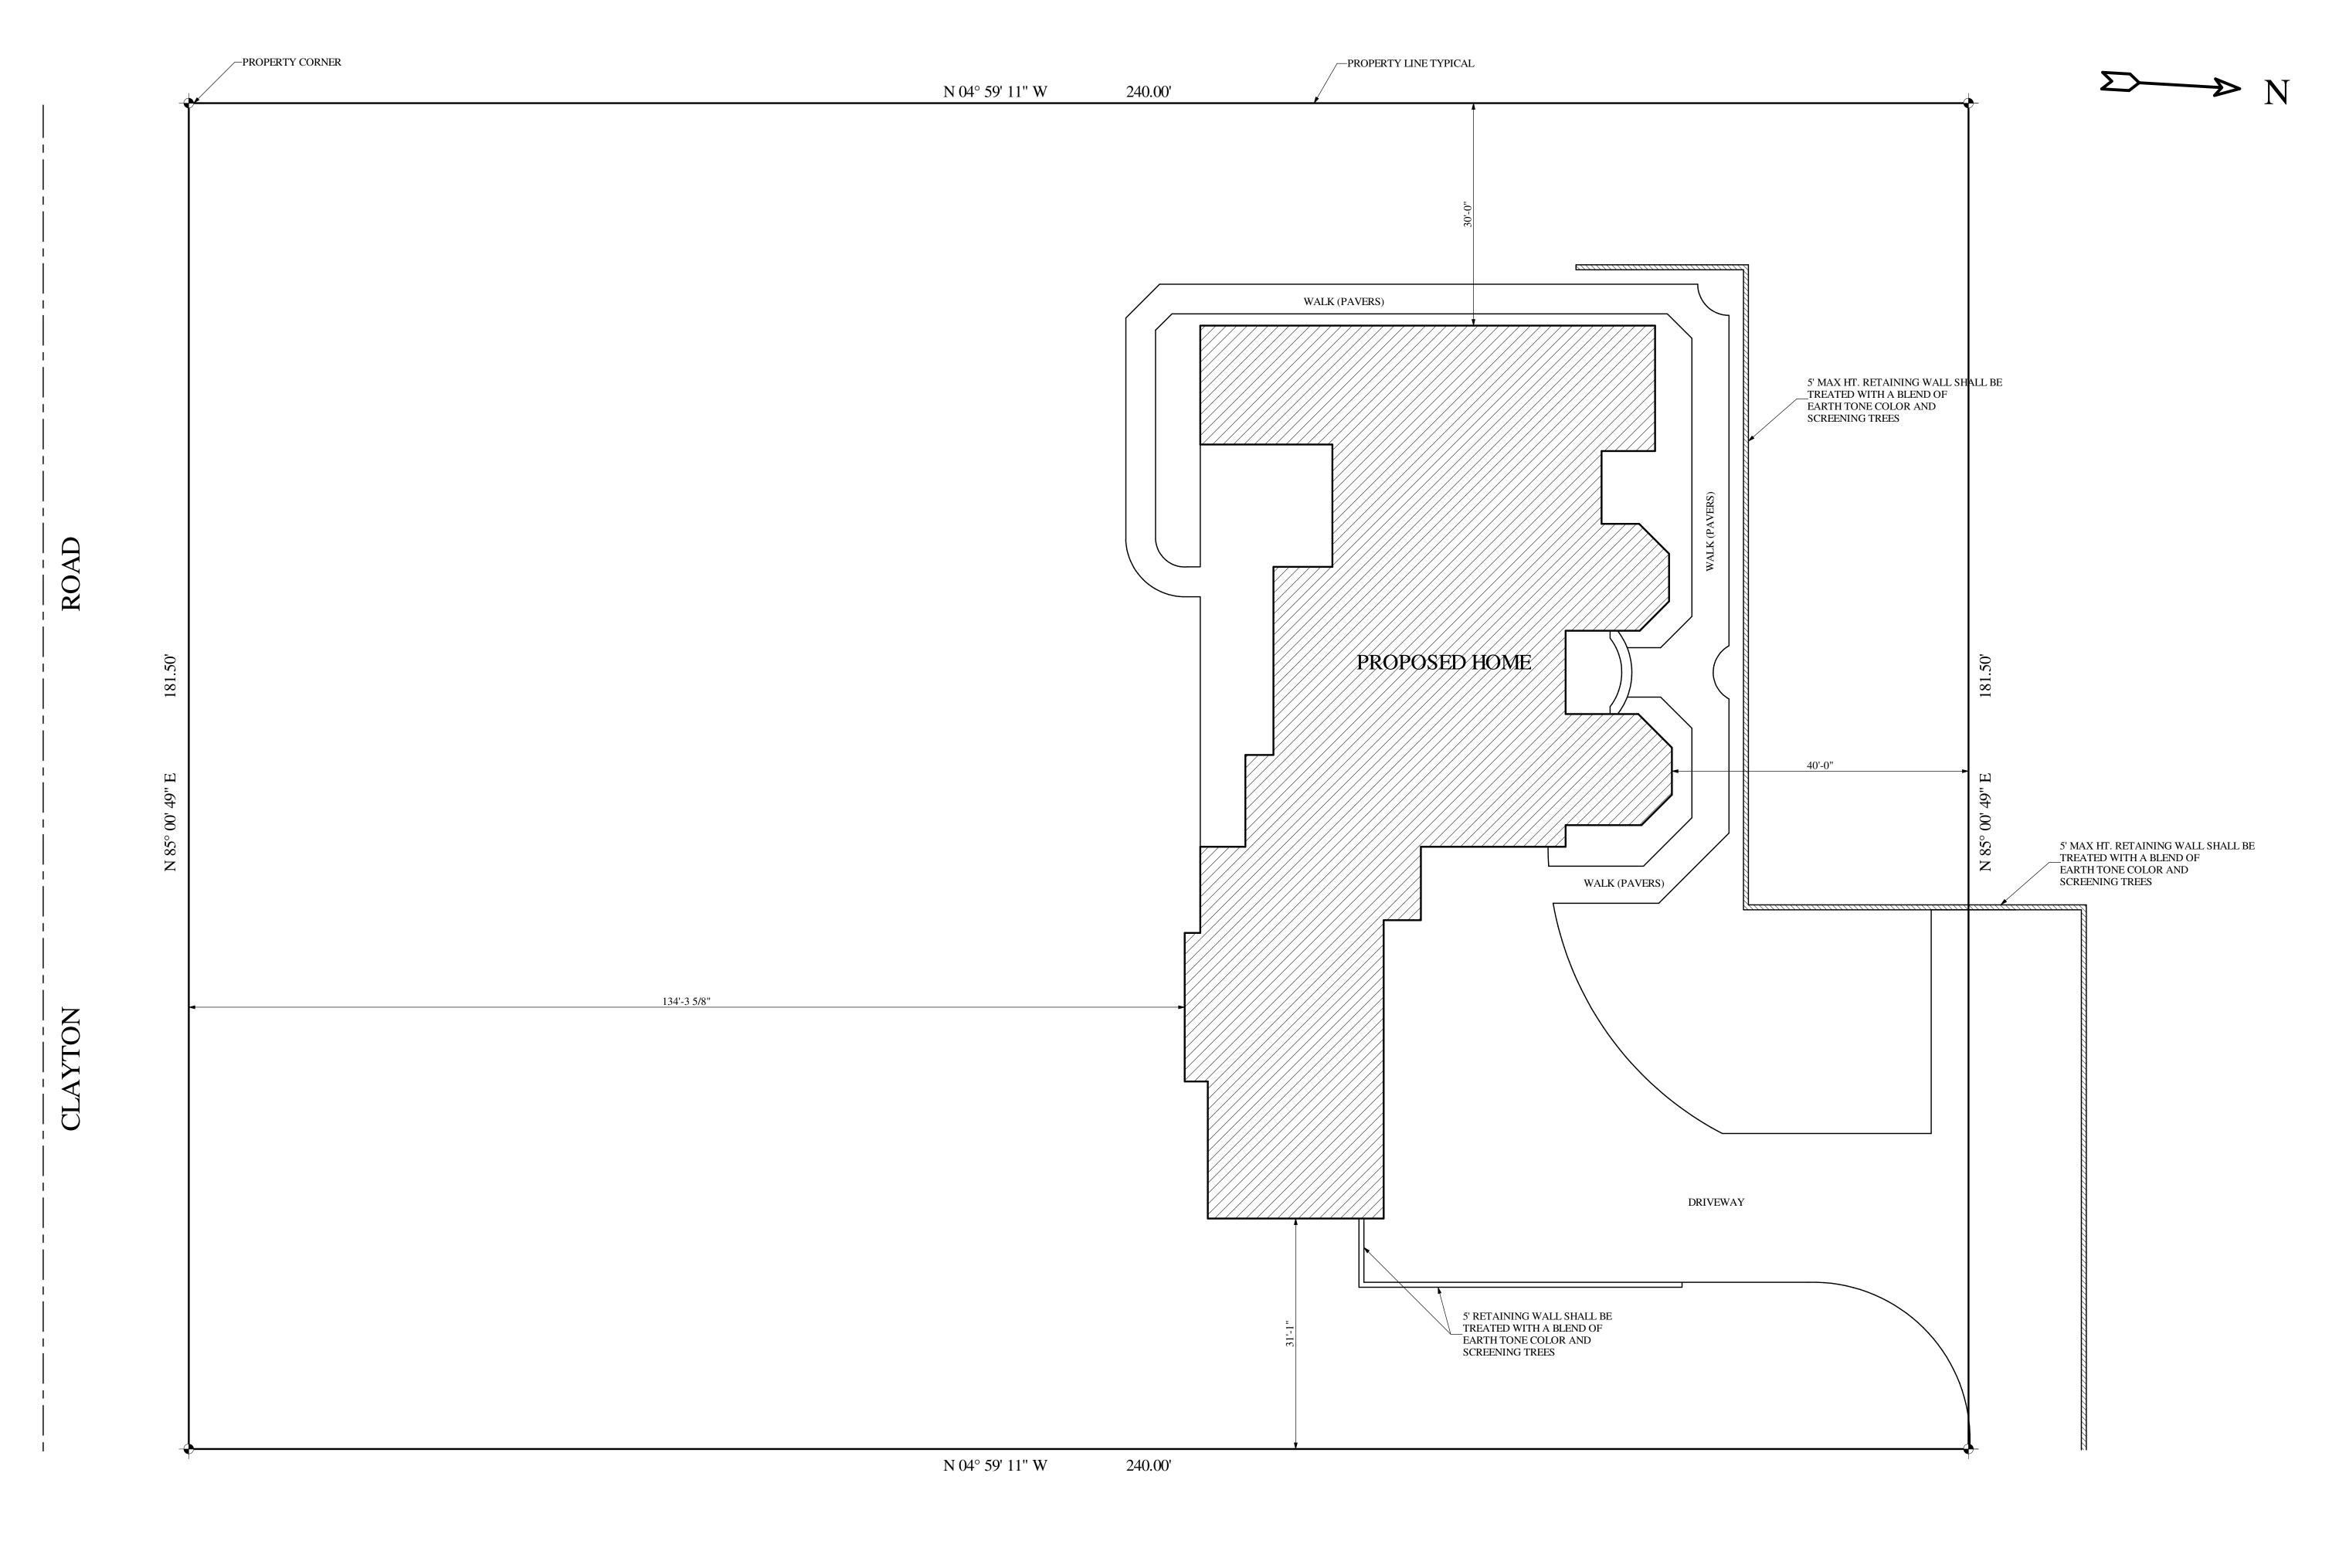



AN Jonathan Coulter
930 San Benito Street
Hollister, Ca. 95023
Phone: (831) 637-8059 (831) 537-4040


CLAYTON ROAD IOSE, CA. 95127 (650) 533-9484


PLAN FOR:

SCALE

SHEE A(

TOTAL LIVING AREA BOTH FLOORS= 4450 SF

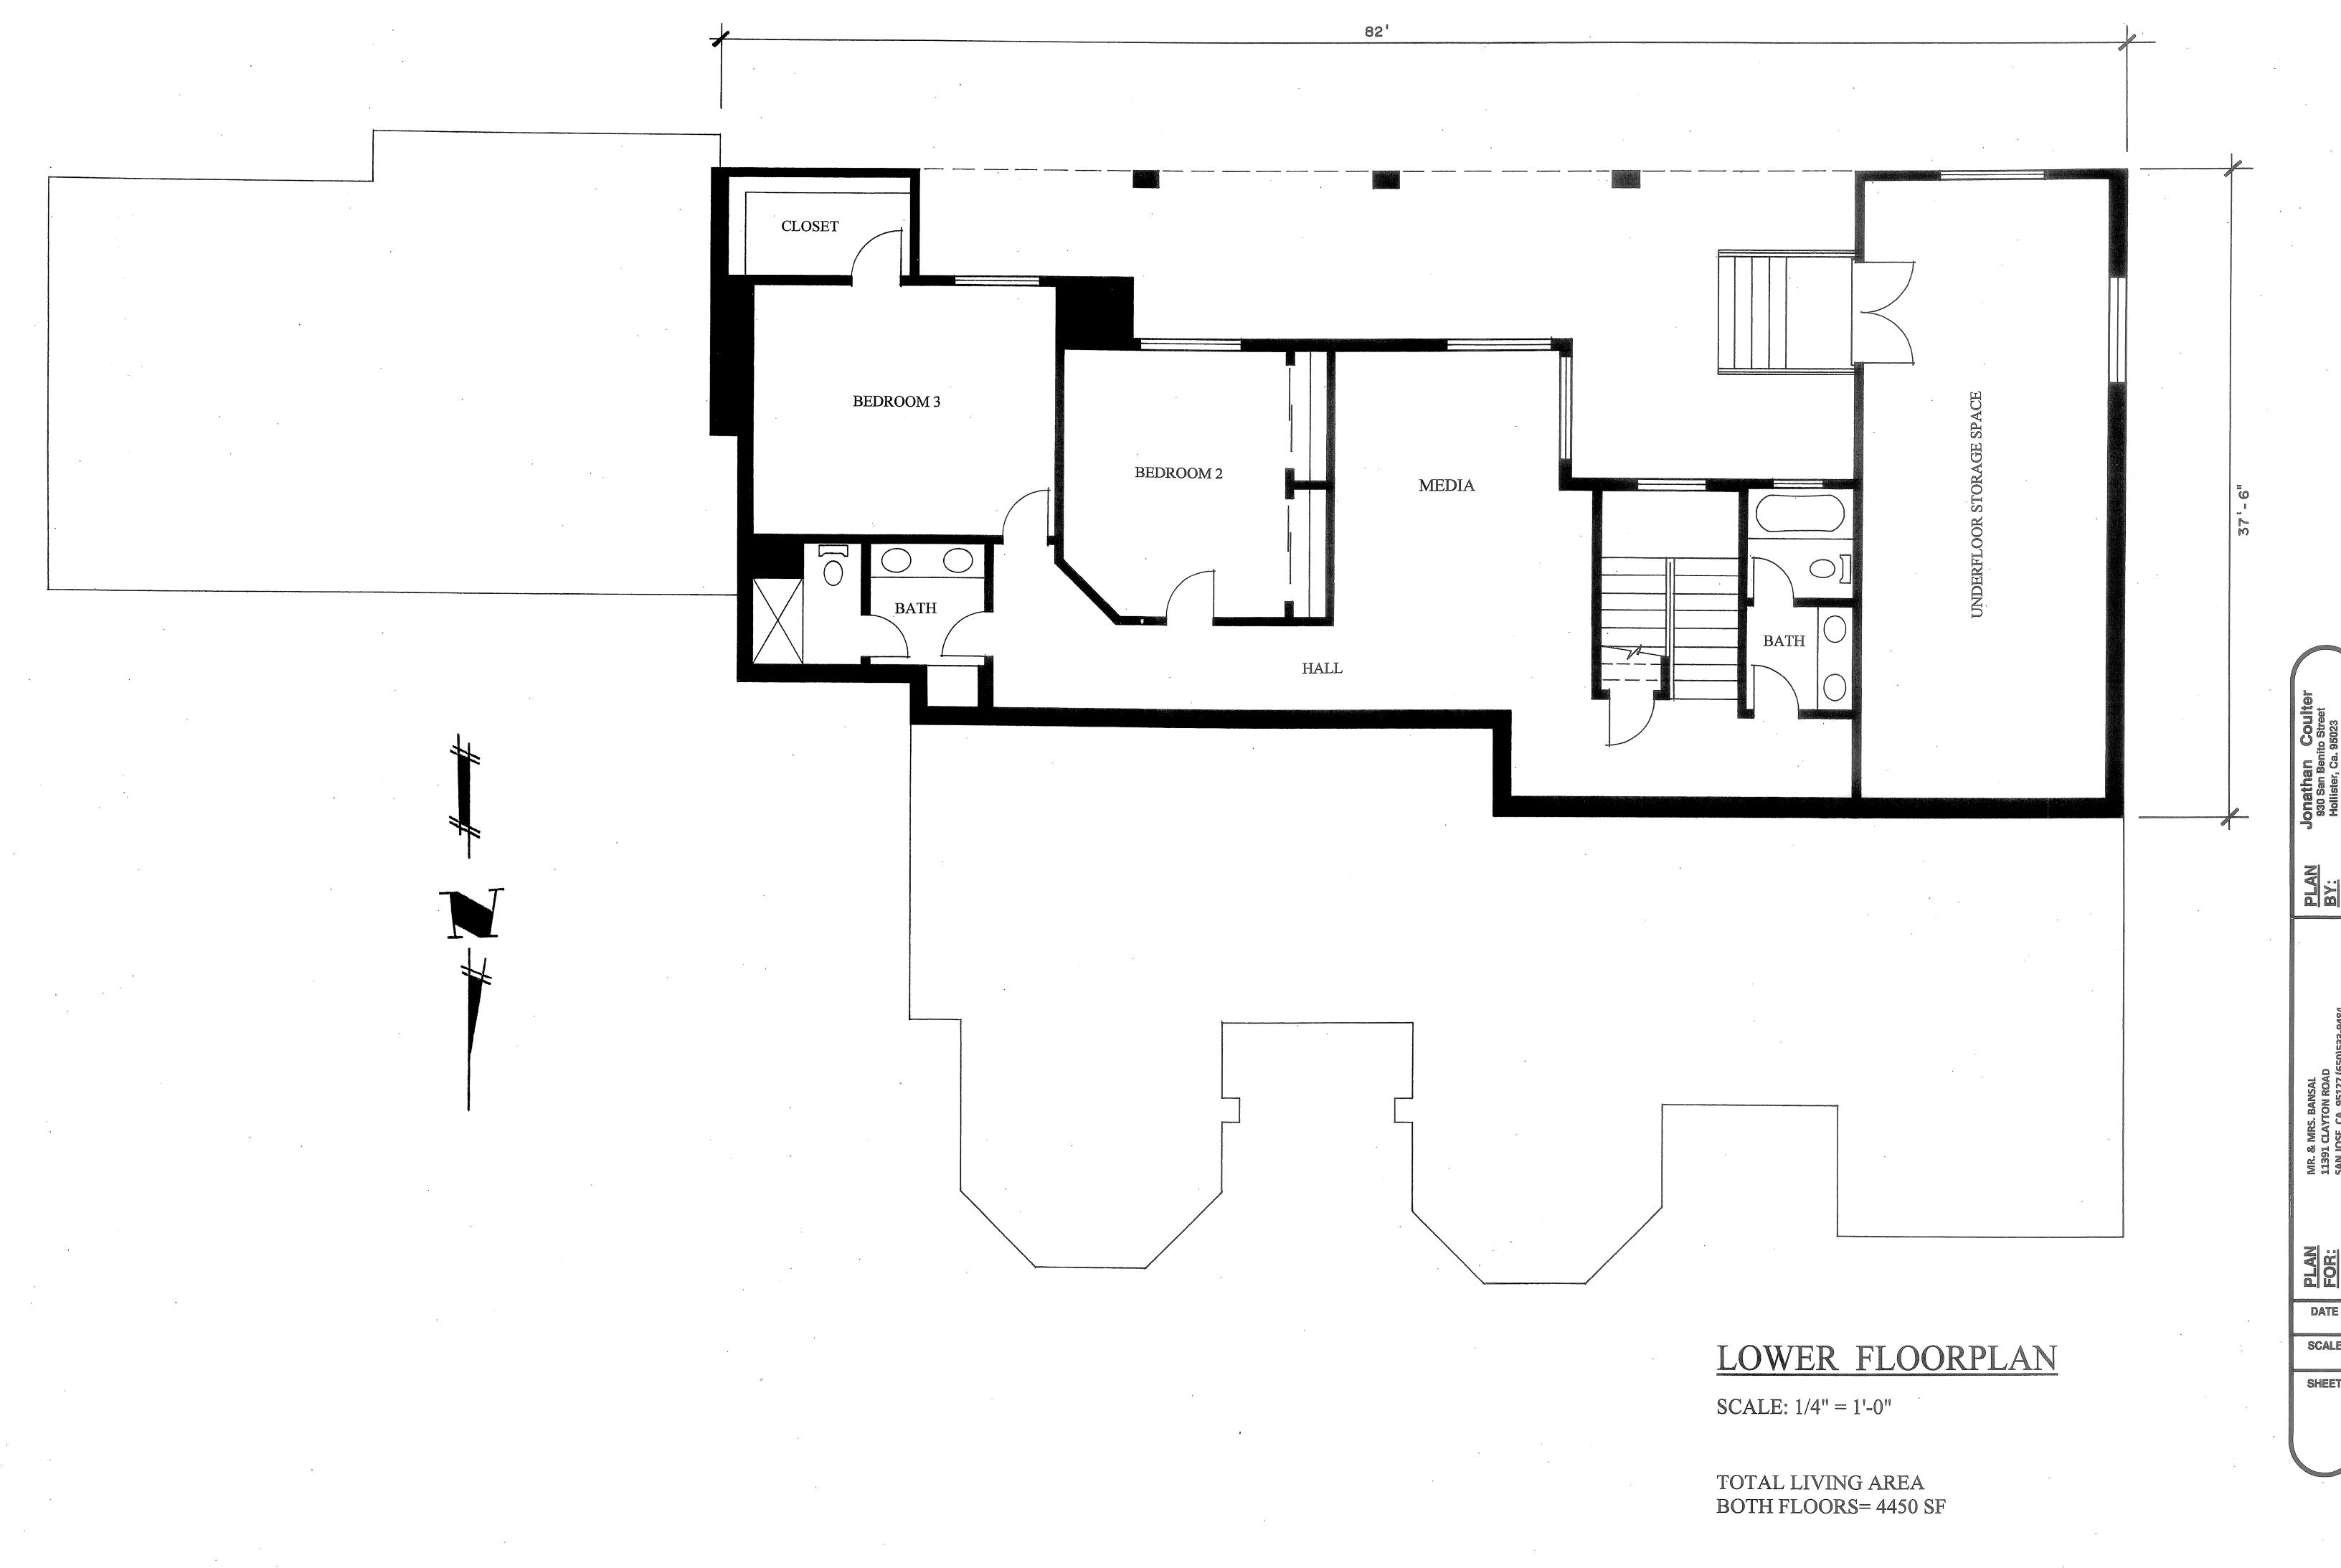

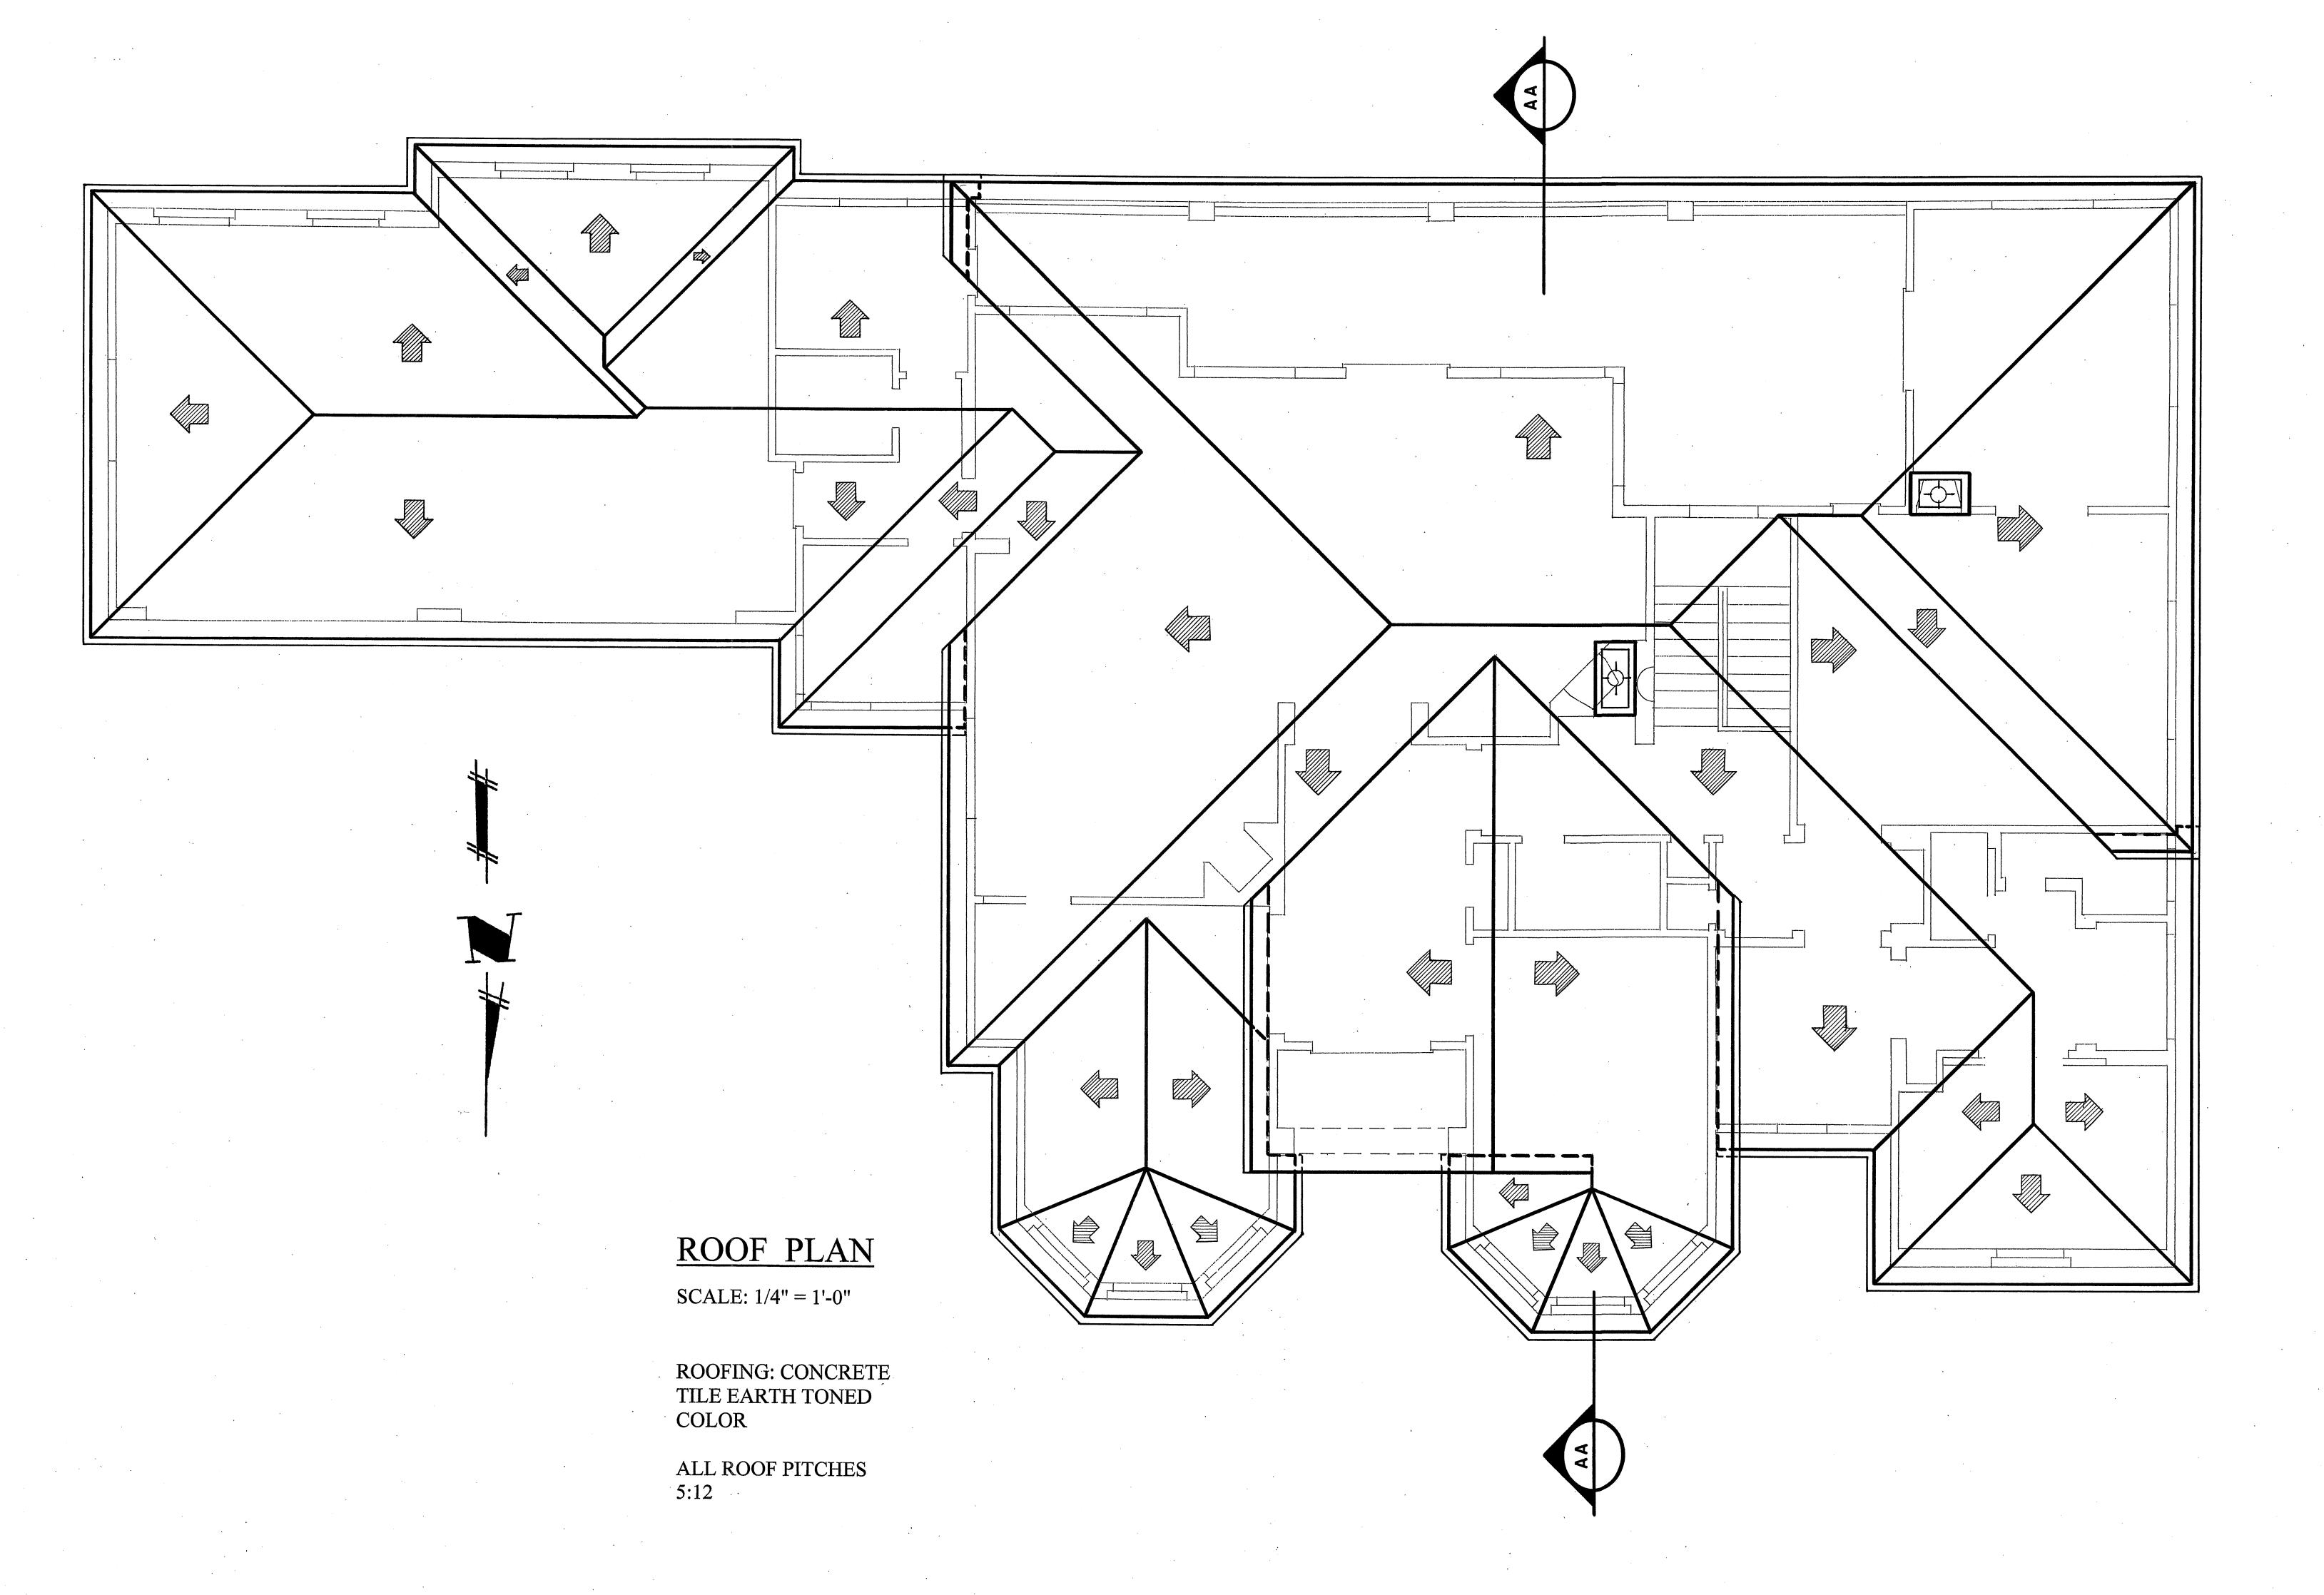


LAN Jonathan Coulter 930 San Benito Street Y: Hollister, Ca. 95023 Phone: (831) 637-8059 (831) 537-4040

> . . (650)533-9484

MR. & MRS. BANSAL 11391 CLAYTON ROAD SAN JOSE, CA. 95127 (650

DATE 09 H 10 SCALE

SHEET

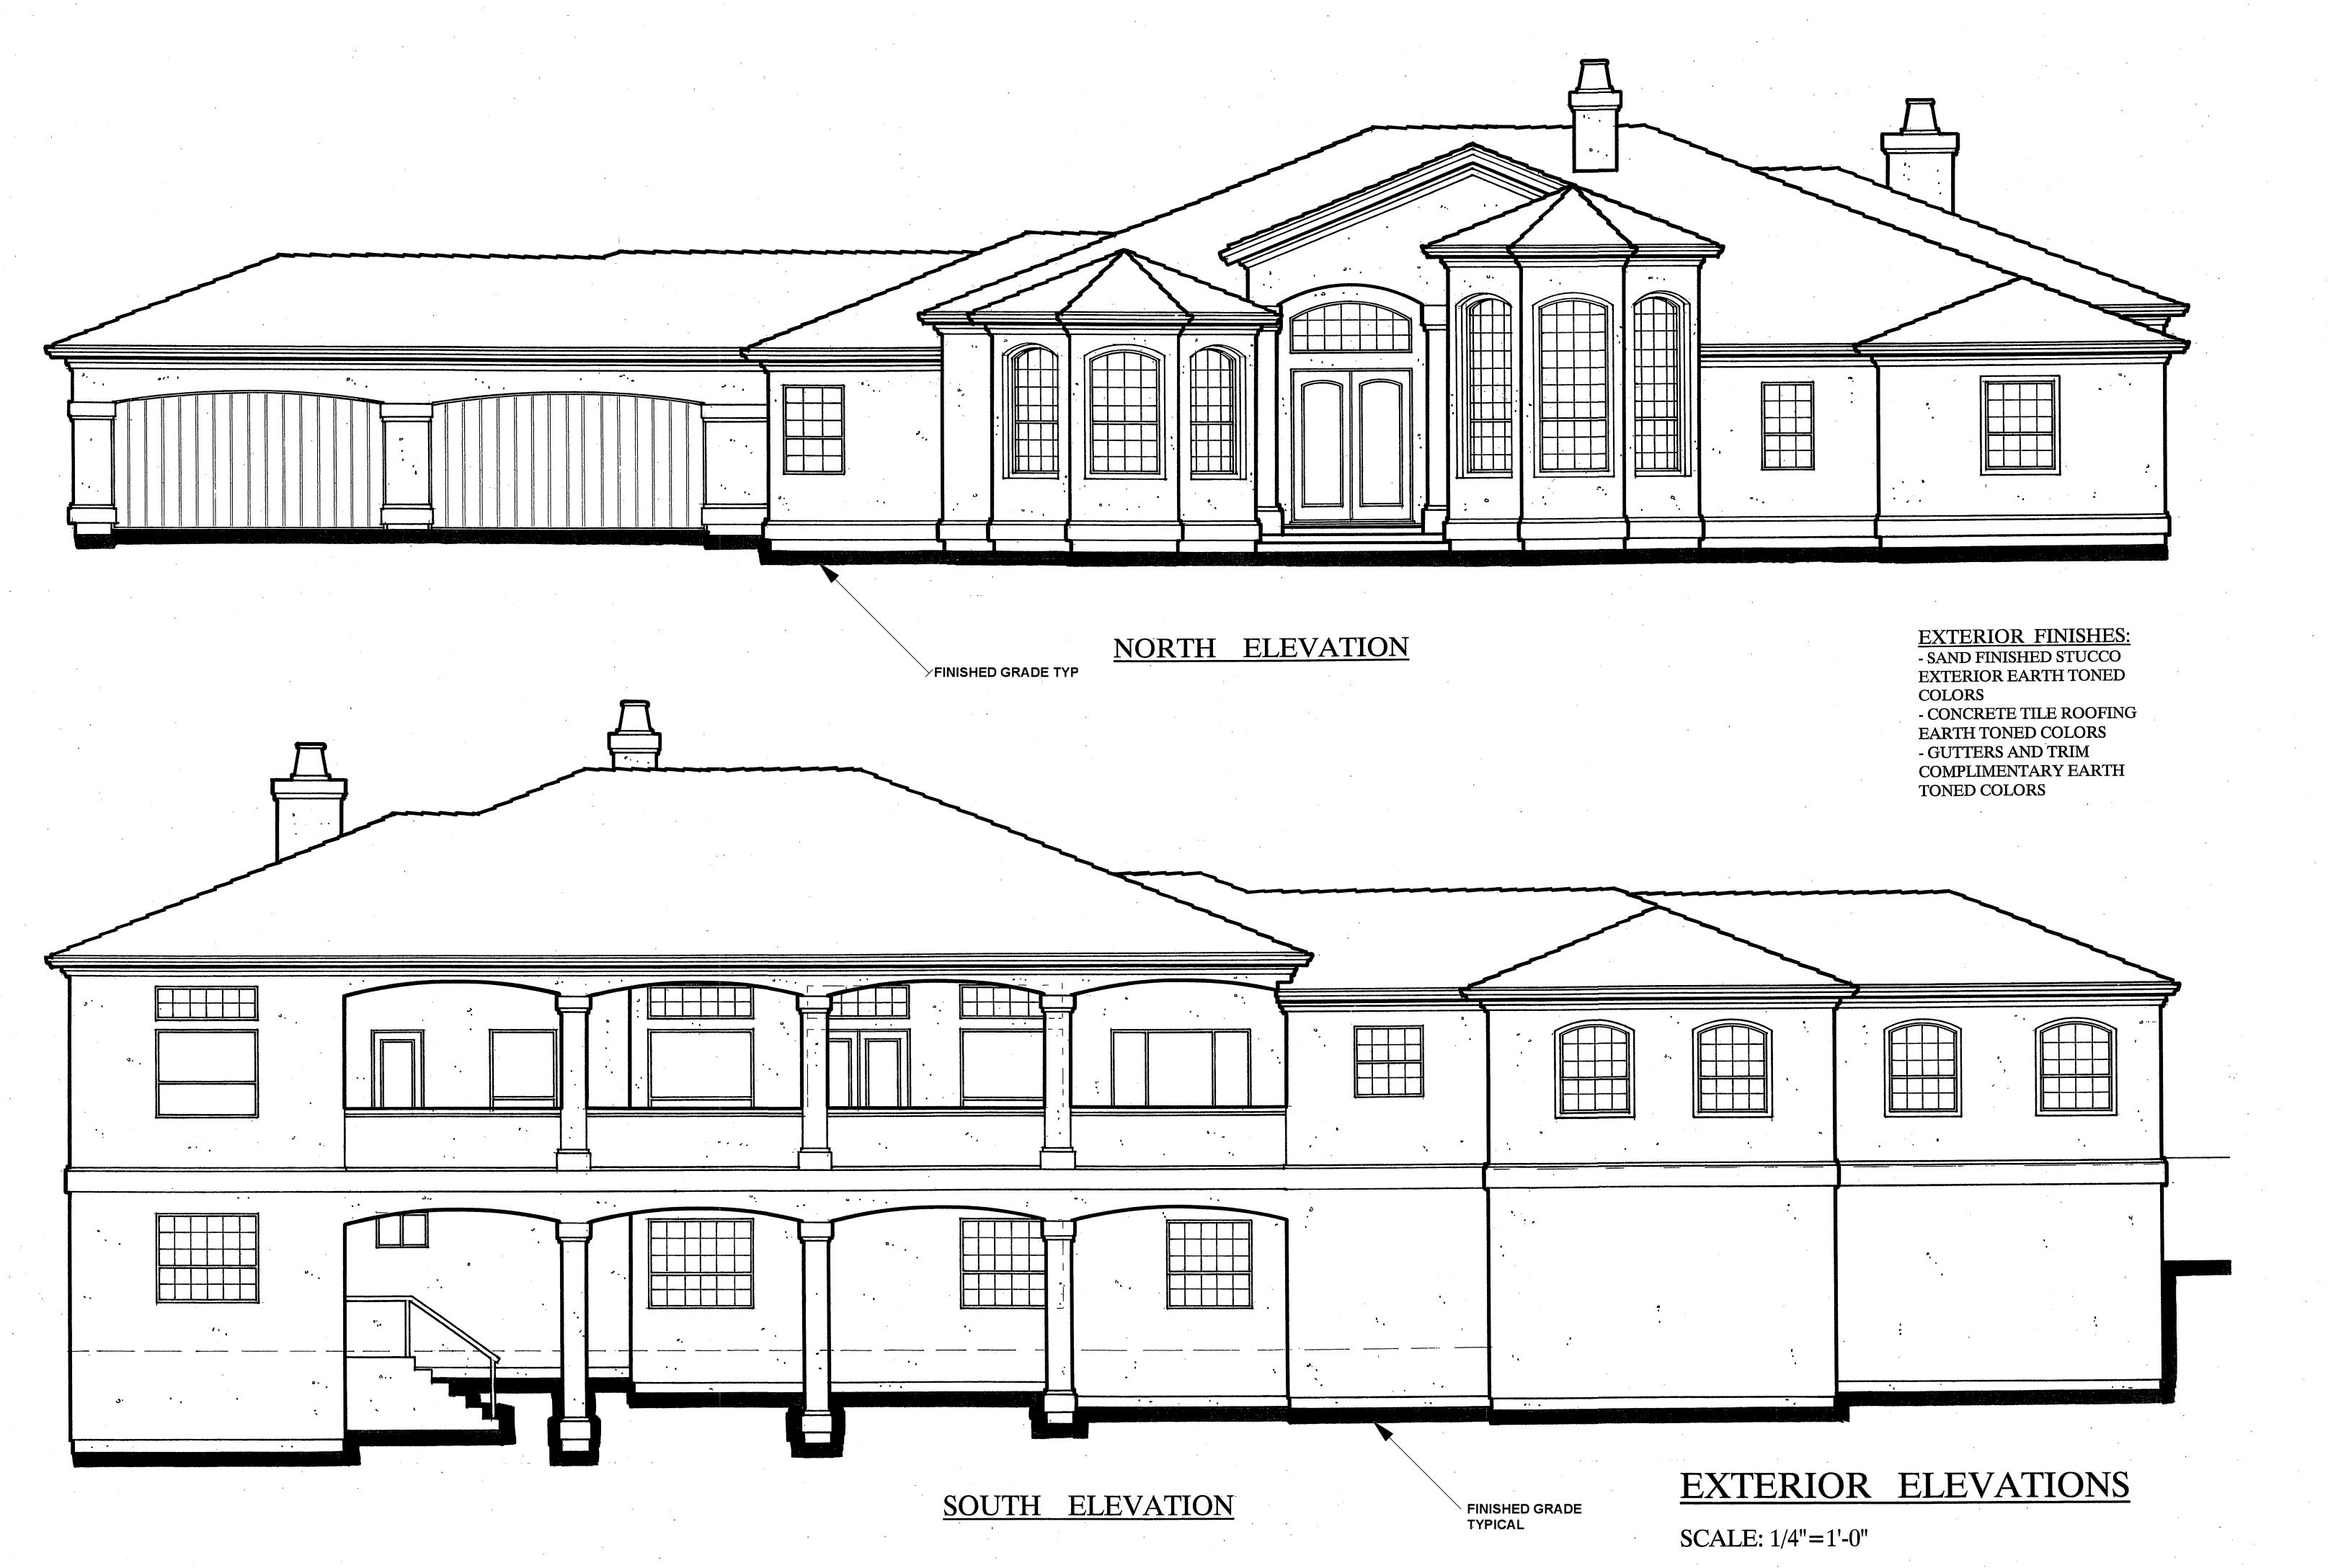


PLAN Jonathan Coulter 930 San Benito Street BY: Hollister, Ca. 95023 Phone: (831) 637-8059 (831) 537-4040

> MR. & MRS. BANSAL 11391 CLAYTON ROAD SAN JOSE, CA. 95127 (650)533-5

DATE 09/14/10 SCALE

A4

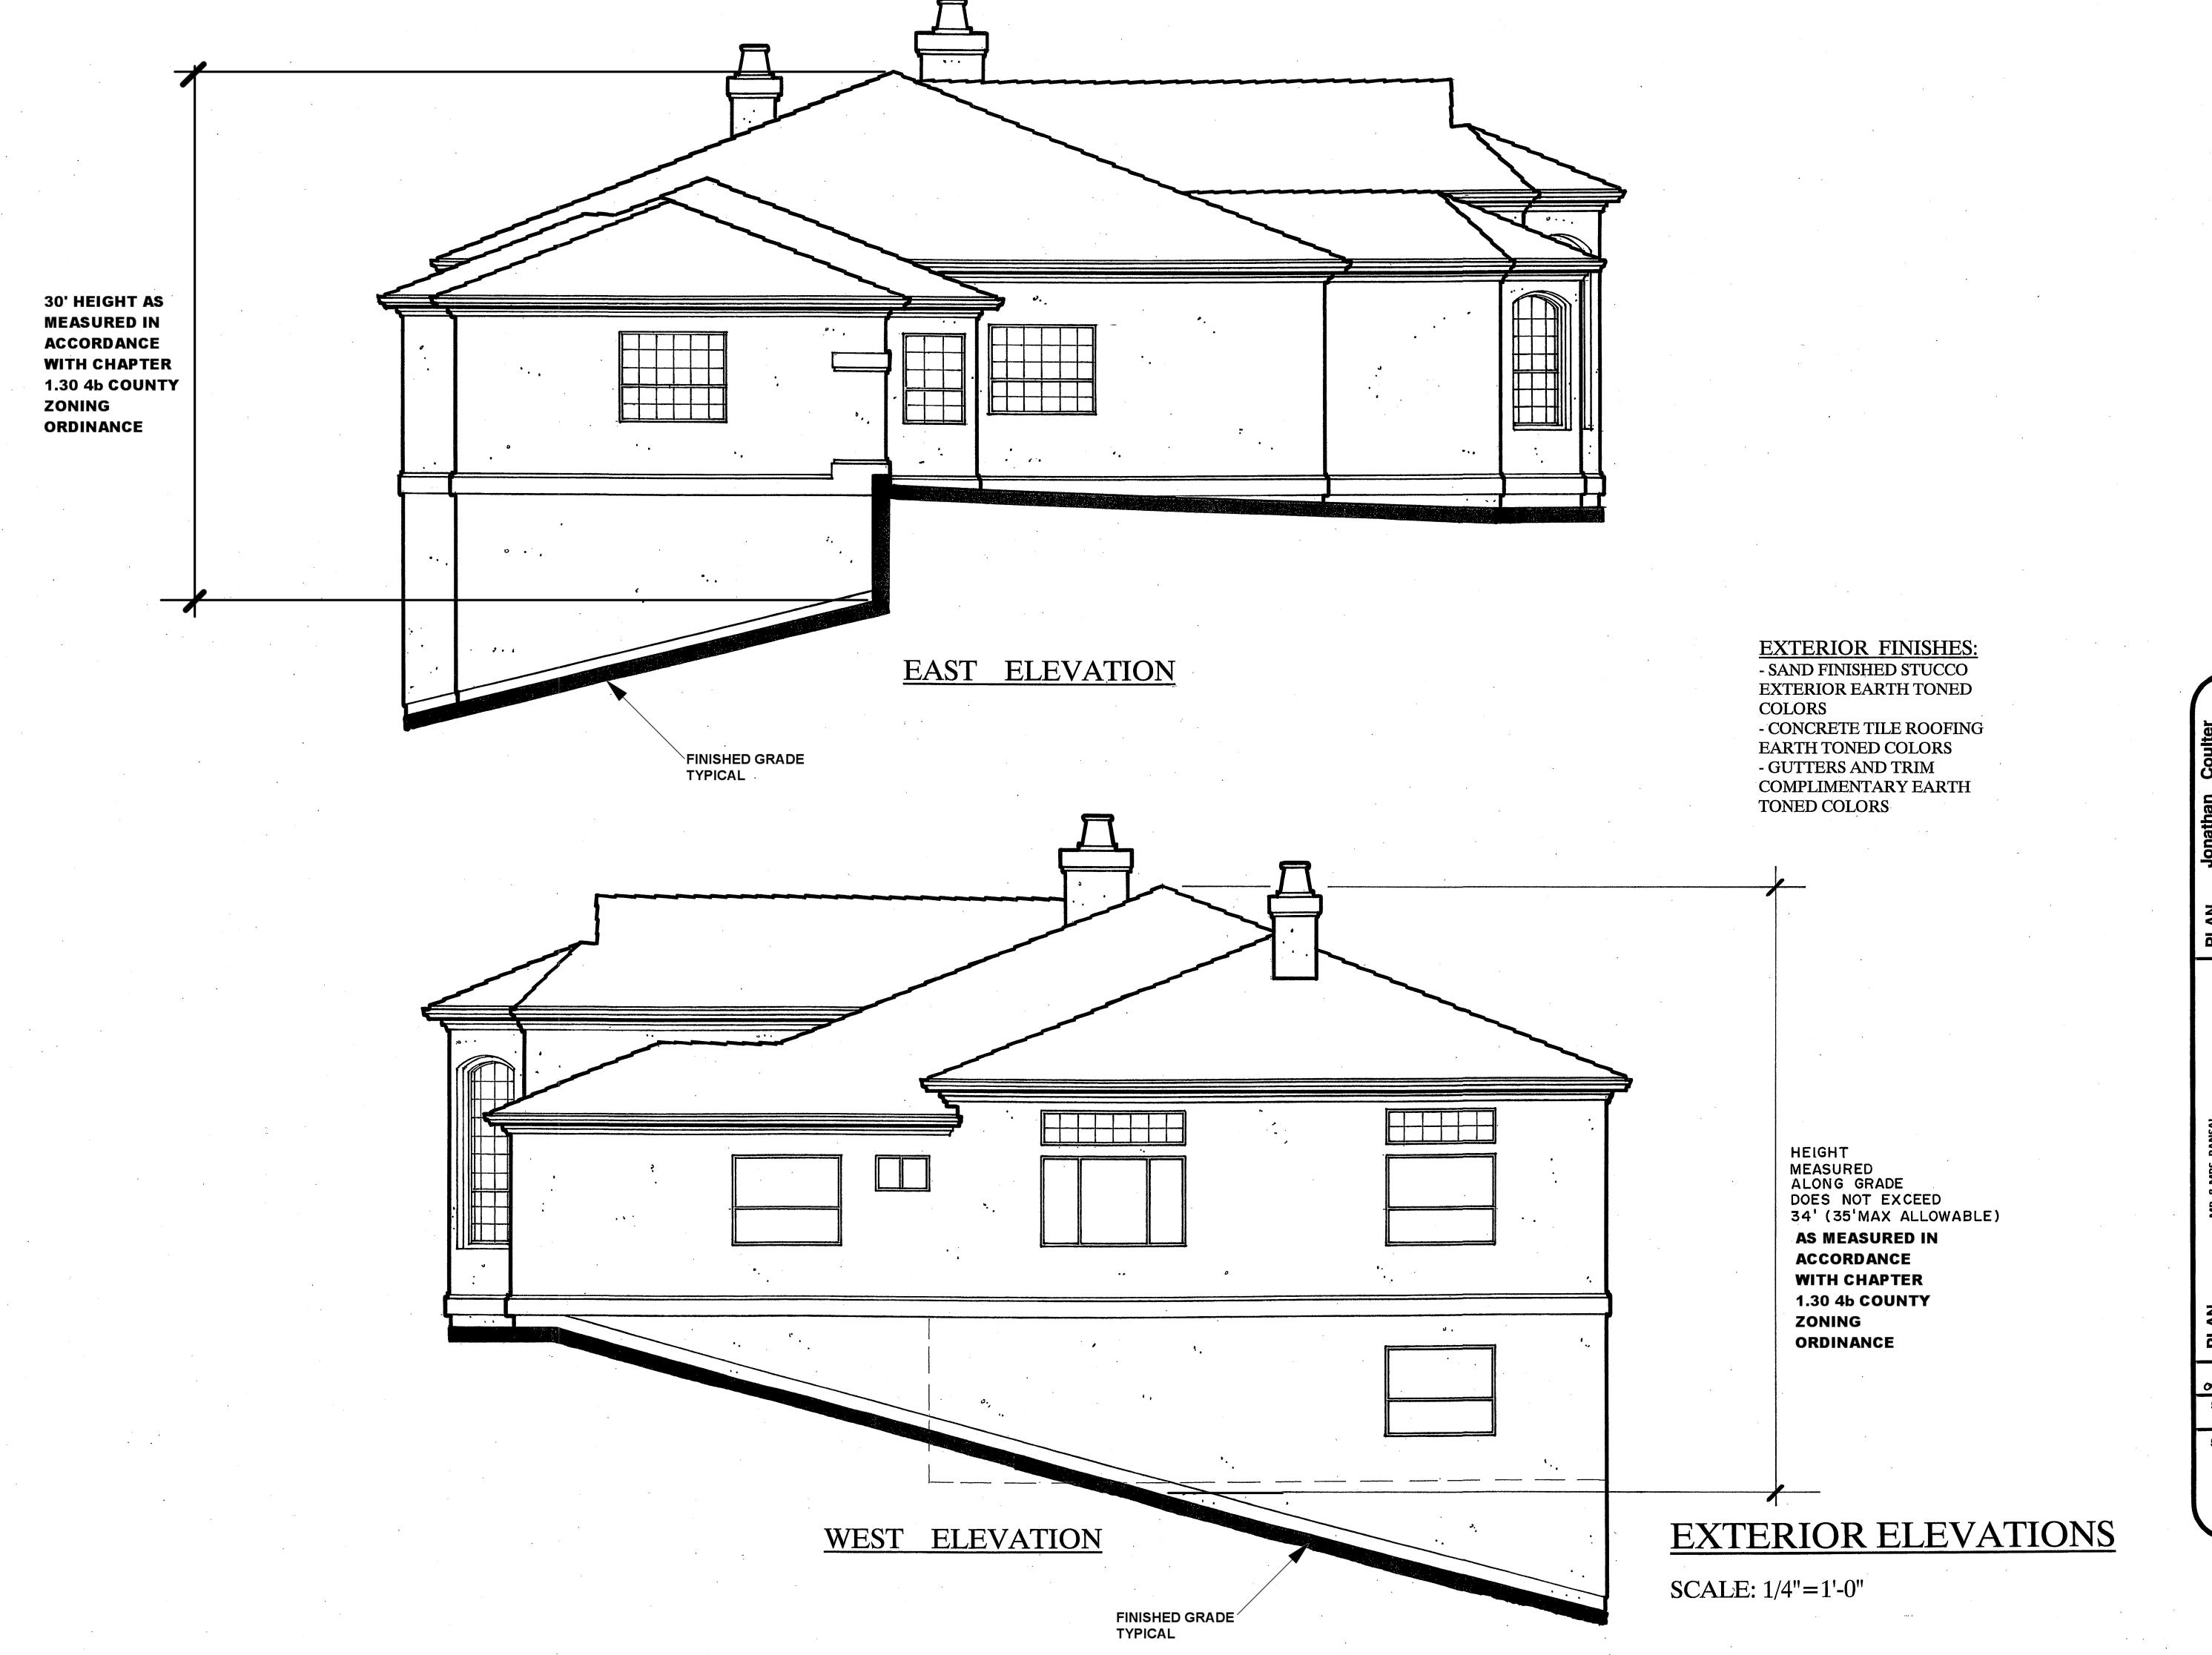


DATE, 09 | 14/16 SCALE

SHEET

# TYPICAL CROSS SECTION AA

SCALE: 1/4" = 1'-0"

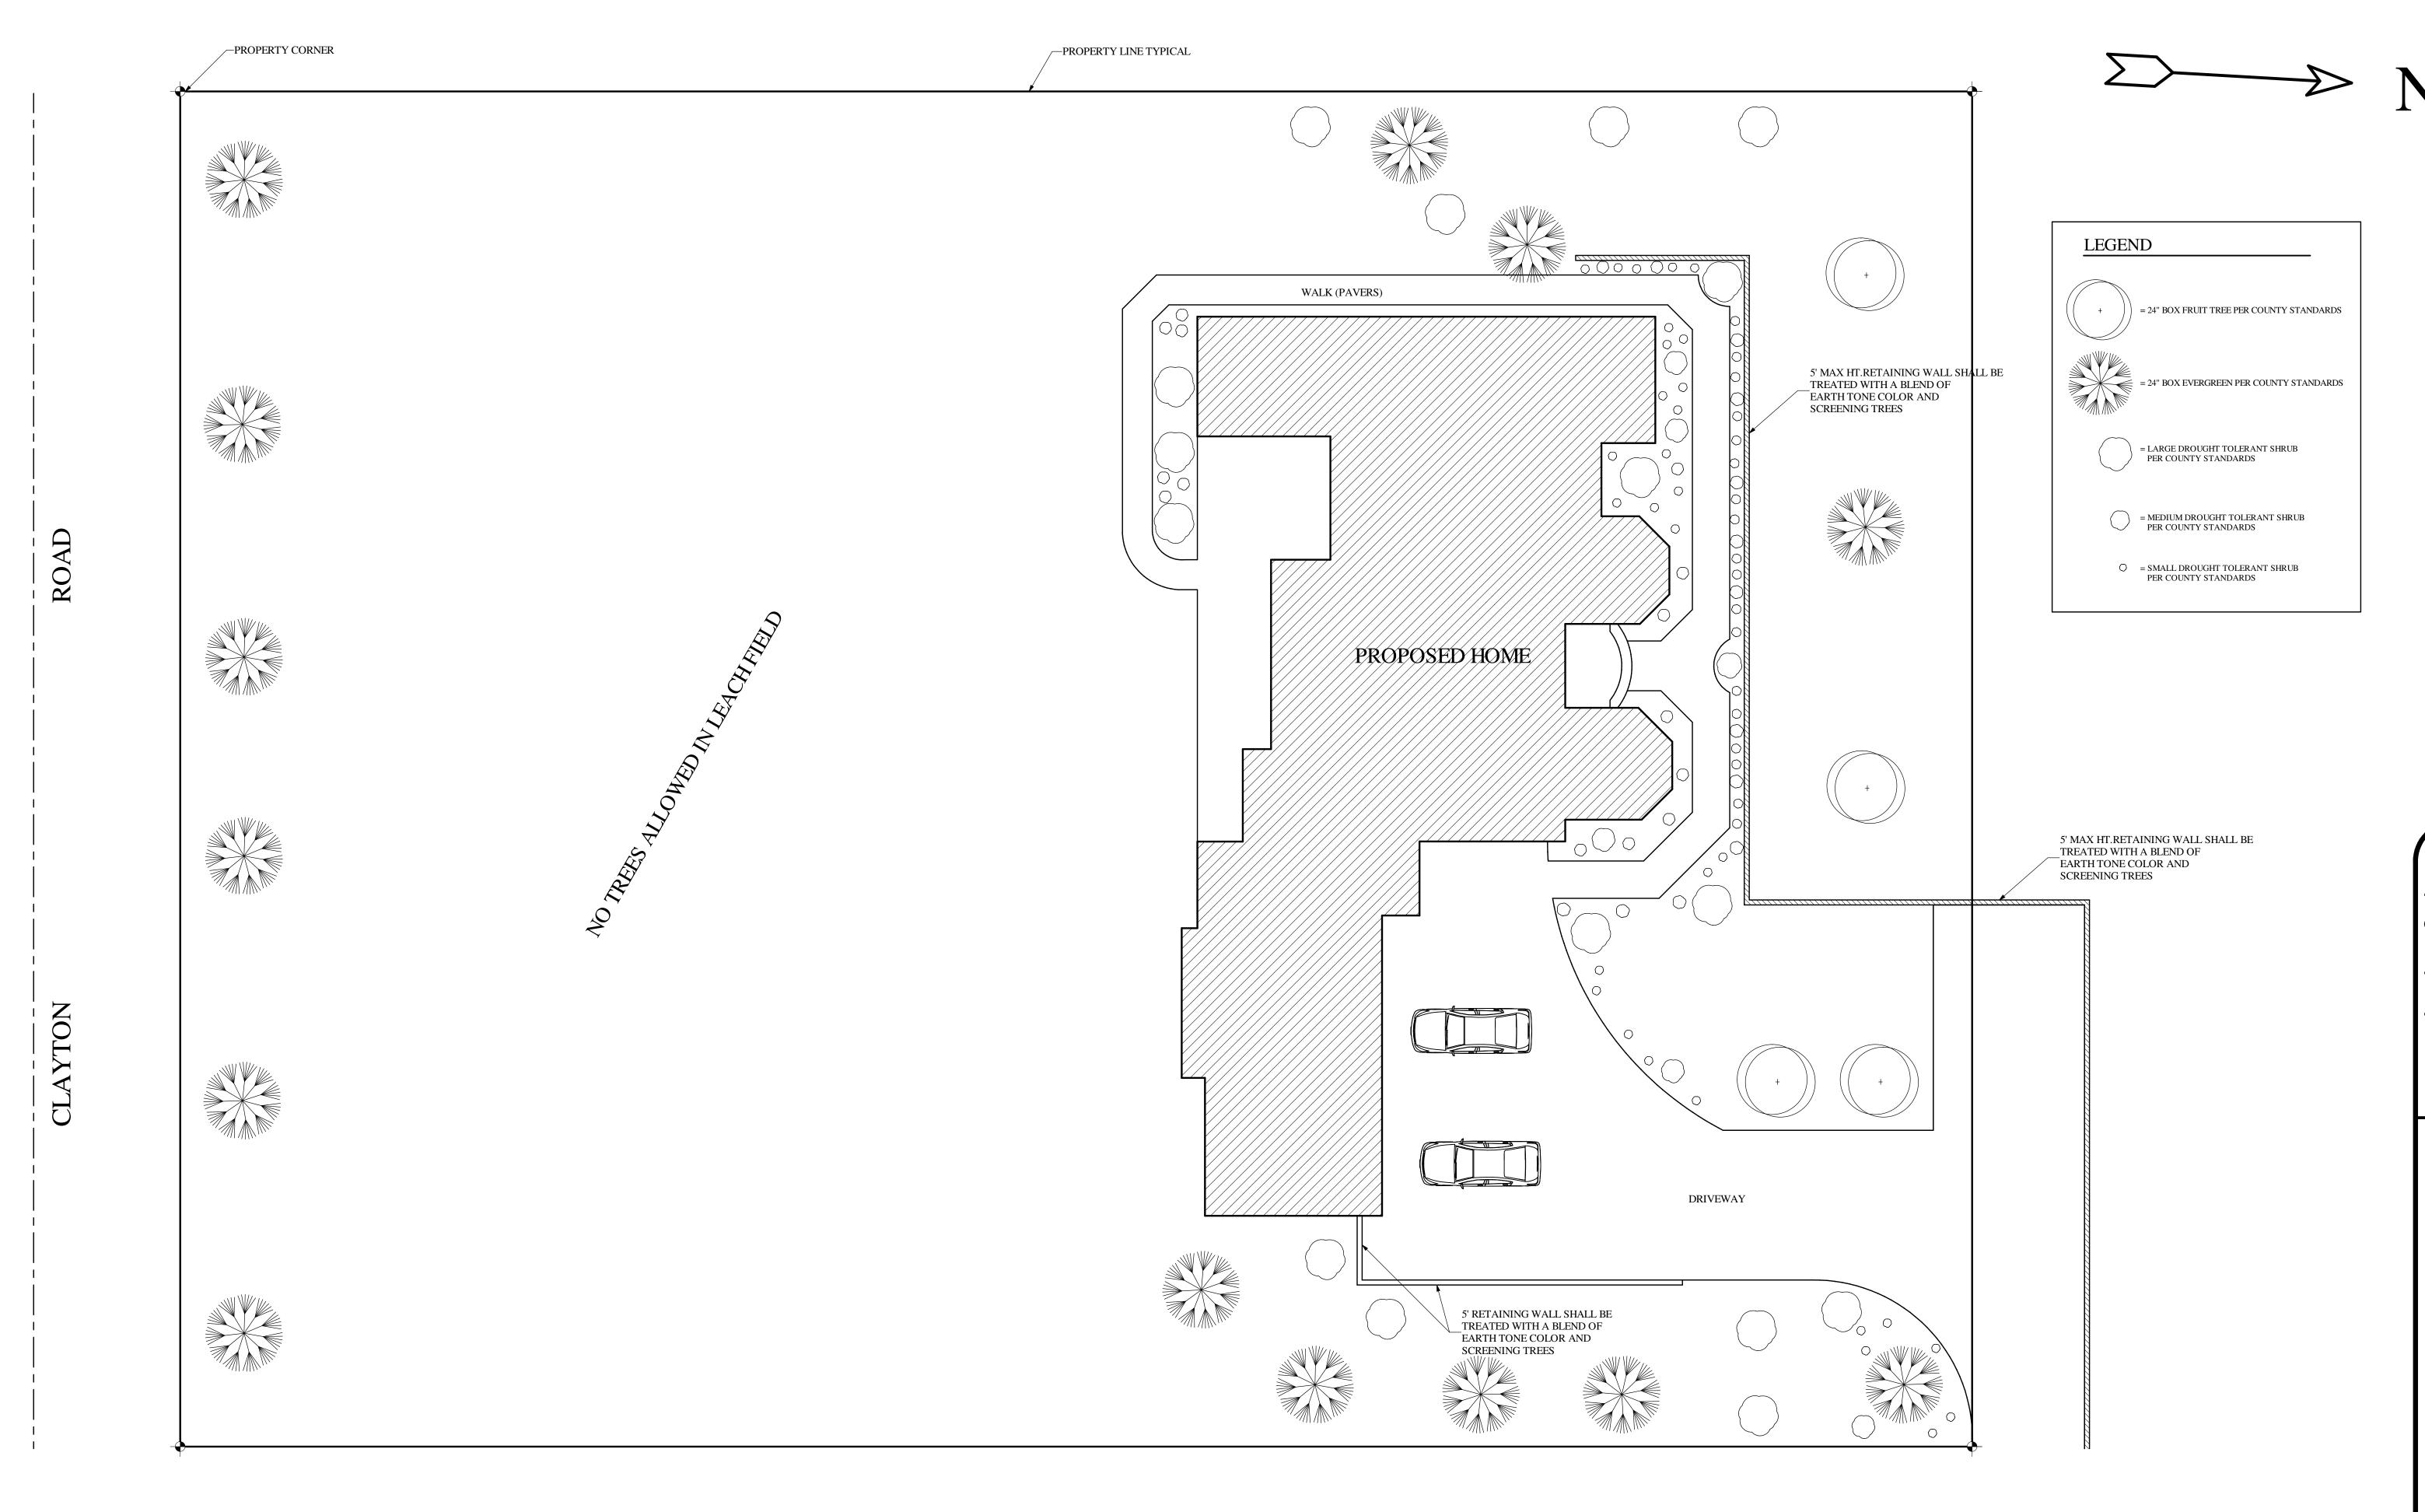

# Landscaping Plan SCALE: 1"=10'

PLAN FOR: DATE

SCALE

# COUNTY OF SANTA CLARA GENERAL CONSTRUCTION **SPECIFICATIONS**

- 1. ALL CONSTRUCTION WORK SHALL BE PERFORMED IN ACCORDANCE WITH THE SOILS AND/OR GEOTECHNICAL REPORT PREPARED BY ASSOCIATED TERRA CONSULTANTS, INC. FILE NO. 178831 DATED SEPTEMBER 11. 2002. THESE REPORTS ARE SUPPLEMENTED BY:
- 1) THESE PLANS AND SPECIFICATIONS; 2) THE COUNTY OF SANTA CLARA STANDARD DETAILS; 3) THE COUNTY SPECIFICATIONS; 2) THE COUNTY OF SANTA CLARA STANDARD DETAILS; 3) THE COUNTY OF SANTA CLARA STANDARD SPECIFICATIONS; 4) STATE OF CALIFORNIA STANDARD DETAILS; 5) STATE OF CALIFORNIA STANDARD SPECIFICATIONS.
- IN THE EVENT OF CONFLICT THE FORMER SHALL TAKE PRECEDENCE OVER THE LATTER. THE PERFORMANCE AND COMPLETION OF ALL WORK MUST BE TO THE SATISFACTION OF THE COUNTY.
- 2. DEVELOPER IS RESPONSIBLE FOR INSTALLATION OF THE IMPROVEMENTS SHOWN ON THESE PLANS AND HE OR HIS SUCCESSOR PROPERTY OWNERS ARE RESPONSIBLE FOR THEIR CONTINUED MAINTENANCE
- 3. DEVELOPER SHALL BE RESPONSIBLE FOR CORRECTION OF ANY ERRORS OR OMISSIONS IN THESE PLANS. THE COUNTY SHALL BE AUTHORIZED TO REQUIRE DISCONTINUANCE OF ANY WORK AND SUCH CORRECTION AND MODIFICATION OF PLANS AS MAY BE NECESSARY TO COMPLY WITH COUNTY STANDARDS OR CONDITIONS OF DEVELOPMENT APPROVAL.
- 4. DEVELOPER SHALL OBTAIN ENCROACHMENT PERMITS FROM THE SANTA CLARA VALLEY WATER DISTRICT AND CALIFORNIA DEPARTMENT OF TRANSPORTATION WHERE NEEDED. COPIES OF THESE PERMITS SHALL BE KEPT AT THE JOB SITE FOR REVIEW BY THE COUNTY'S INSPECTOR.
- 5. DEVELOPER SHALL REMOVE OR TRIM ALL TREES TO PROVIDE AN UNOBSTRUCTED FIFTEEN (15) FOOT VERTICAL CLEARANCE FOR ROADWAY AREA.
- 6. THIS PLAN AUTHORIZES THE REMOVAL OF ONLY THOSE TREES WITH TRUNK DIAMETERS GREATER THAN 12 INCHES MEASURED 4.5 FEET ABOVE THE GROUND THAT ARE SHOWN TO BE REMOVED UNLESS AN AMENDED PLAN IS APPROVED OR A SEPARATE TREE REMOVAL PERMIT IS OBTAINED FROM THE PLANNING OFFICE. IT IS THE CONTRACTOR'S RESPONSIBILITY TO ENSURE THAT REMOVAL OF ADDITIONAL TREES HAS BEEN PERMITTED.
- 7. DEVELOPER SHALL PROVIDE ADEQUATE DUST CONTROL AS REQUIRED BY THE COUNTY
- 8. ALL PERSONS MUST COMPLY WITH SECTION 4442 OF THE PUBLIC RESOURCES CODE AND SECTION 13005 OF THE HEALTH AND SAFETY CODE RELATING TO THE USE OF SPARK
- 9. UPON DISCOVERING OR UNEARTHING ANY BURIAL SITE AS EVIDENCE BY HUMAN SKELETAL REMAINS OR ARTIFACTS, THE PERSON MAKING SUCH DISCOVERY SHALL IMMEDIATELY NOTIFY THE COUNTY CORONER AT (408) 454-2520 AND LAND DEVELOPMENT ENGINEERING OFFICE AT (408) 299-5730 NO FURTHER DISTURBANCE OF THE SITE MAY BE MADE EXCEPT AS AUTHORIZED BY THE LAND DEVELOPMENT OFFICE IN ACCORD WITH PROVISIONS OF THIS ORDINANCE. (COUNTY ORDINANCE CODE SECTION B6-18). **CONSTRUCTION STAKING**
- 1. THE DEVELOPER'S ENGINEER IS RESPONSIBLE FOR THE INITIAL PLACEMENT AND REPLACEMENT OF CONSTRUCTION GRADE STAKES. THE STAKES ARE TO BE ADEQUATELY IDENTIFIED, LOCATED, STABILIZED, ETC. FOR THE CONVENIENCE OF CONTRACTORS. LATERAL OFFSET OF STAKES SET FOR CURBS AND GUTTERS SHALL NOT EXCEED 2 1/2 FEET FROM THE BACK OF CURB.
- 2. ANY PROPERTY LINE STAKES OR ROAD MONUMENTS DISTURBED DURING CONSTRUCTION SHALL BE REPLACED BY DEVELOPER'S ENGINEER OR LICENSED LAND SURVEYOR.

## CONSTRUCTION INSPECTION

OF WORK AND SITE.

- 1. CONTRACTOR SHALL NOTIFY PERMIT INSPECTION UNIT, SANTA CLARA COUNTY PRIOR TO COMMENCING WORK AND FOR FINAL INSPECTION OF WORK AND SITE.
- 2. THE COUNTY REQUIRES A MINIMUM 24 HOUR ADVANCE NOTICE FOR GENERAL INSPECTION, 48
- HOURS FOR ASPHALT CONCRETE INSPECTION 3. INSPECTION BY SANTA CLARA COUNTY SHALL BE LIMITED TO INSPECTION OF MATERIALS AND PROCESSES, OF CONSTRUCTION TO OBSERVE THEIR COMPLIANCE WITH PLANS AND SPECIFICATIONS. BUT DOES NOT INCLUDE RESPONSIBILITY FOR THE SUPERINTENDENCE OF CONSTRUCTION, SITE CONDITIONS, EQUIPMENT OR PERSONNEL. CONTRACTOR SHALL NOTIFY THE COUNTY LAND DEVELOPMENT INSPECTOR AT

PHONE (408) 299-6868 AT LEAST 24 HOURS PRIOR TO COMMENCING WORK AND FOR FINAL INSPECTION

4. DEVELOPER AND/OR HIS AUTHORIZED REPRESENTATIVE MUST SUBMIT WRITTEN REQUEST FOR FINAL INSPECTION AND ACCEPTANCE. SAID REQUESTS SHALL BE DIRECTED TO THE INSPECTION OFFICE NOTED ON THE PERMIT FORM.

# SITE PREPARATION (CLEARING & GRUBBING)

- 1. EXISTING TREES, ROOTS AND FOREIGN MATERIAL WILL BE REMOVED FROM AREAS TO BE
- IMPROVED TO AN AUTHORIZED DISPOSAL SITE AS FOLLOWS: a) TO A MINIMUM DEPTH OF TWO FEET BELOW THE FINISHED GRADE PROPOSED
  - ROADWAYS (EITHER PRIVATE OR TO BE DEDICATED TO PUBLIC USE) b) FROM AREAS AFFECTED BY THE PROPOSED GRADING EXCEPT WHERE NOTED ON THE PLANS.
- 2. IT SHALL BE THE RESPONSIBILITY OF THE DEVELOPER TO MOVE OR RELOCATE UTILITY POLES AND OTHER OBSTRUCTIONS IN THE WAY OF CONSTRUCTION.

# UTILITY LOCATION, TRENCHING & BACKFILL

- 1. CONTRACTOR SHALL NOTIFY USA (UNDERGROUND SERVICE ALERT) AT 800-227-2600 A MINIMUM 24 HOURS BEFORE FEGINNING UNDERGROUND WORK FOR VERIFICATION OF THE LOCATION OF UNDERGROUND UTILITIES.
- 2. ACCURATE VERIFICATION AS TO SIZE, LOCATION AND DEPTH OF EXISTING UNDERGROUND CONDUITS OR FACILITIES SHALL BE THE INDIVIDUAL CONTRACTORS RESPONSIBILITY. PLAN LOCATIONS ARE APPROXIMATE AND FOR GENERAL INFORMATION ONLY.
- 3. ALL UNDERGROUND INSTALLATIONS SHALL BE IN PLACE AND THE TRENCH BACKFILLED AND COMPACTED BEFORE PLACING AGGREGATE BASE MATERIAL OR SURFACE STRUCTURES. SURFACING MAY BE DONE IF THE UTILITY COMPANY CONCERNED INDICATES BY LETTER THAT IT WILL BORE. UNLESS SPECIFICALLY AUTHORIZED BY THE COUNTY, GAS AND WATER MAINS SHALL BE INSTALLED OUTSIDE THE PAVED AREA.
- 4. TRENCH BACKFILL IN EXISTING PAVEMENT AREAS SHALL BE SAND MATERIAL IN ACCORDANCE. WITH THE APPLICABLE PROVISIONS OF THE STATE SPECIFICATIONS. THE STRUCTURAL SECTION FOR TRENCH REPLACEMENT SHALL CONSIST OF NOT LESS THAN 12 INCHES OF APPROVED AGGREGATE BASE MATERIAL, COMPACTED TO A RELATIVE COMPACTION OF AT LEAST 95%, AND 4 INCHES OF HOT ASPHALT CONCRETE PLACED IN TWO LIFTS. TRENCH RESTORATION FOR HIGHER TYPE PAVEMENTS SHALL BE MADE IN KIND OR AS DIRECTED BY THE COUNTY.
- 5. TRENCH BACKFILL IN NEW CONSTRUCTION AREAS SHALL BE SAND MATERIAL COMPACTED TO A RELATIVE COMPACTION OF AT LEAST 90%. THE REQUIREMENT FOR SELECT MATERIAL MAY BE WAIVED BY COUNTY IF THE NATIVE SOIL IS SUITABLE FOR USE AS TRENCH BACKFILL, BUT THE COMPACTION REQUIREMENTS WILL NOT BE THEREBY WAIVED.
- 6. BACKFILL AND TRENCH RESTORATION REQUIREMENTS SHALL APPLY AS MINIMUM STANDARDS TO ALL UNDERGROUND FACILITIES INSTALLED BY OTHER FIRMS OR PUBLIC AGENCIES.

# REPLACEMENT OF DAMAGED IMPROVEMENTS

1. ANY EXISTING IMPROVEMENTS WHICH ARE SCARRED, DAMAGED, OR REMOVED DURING THE CONSTRUCTION OPERATIONS AND ANY EXISTING SHOULDER AREAS WHICH ARE STRUCTURALLY INADEQUATE COMPARED TO THE PROPOSED TYPICAL PAVEMENT SECTION. SHALL BE REMOVED, RECONSTRUCTED OR REPLACED AS REQUIRED BY THE COUNTY INSPECTOR IN THE FIELD.

- 1. EXCAVATED MATERIAL SHALL BE PLACED IN THE FILL AREAS DESIGNATED OR SHALL BE HAULED AWAY FROM THE SITE. WHERE FILL MATERIAL IS TO BE PLACED ON NATURAL GROUND, IT SHALL BE STRIPPED OF ALL VEGETATION. TO ACHIEVE A PROPER BOND WITH THE FILL MATERIAL, THE SURFACE OF THE GROUND SHALL BE SCARIFIED TO DEPTH OF 6" BEFORE FILL IS PLACED. WHERE NATURAL GROUND IS STEEPER THAN 5:1, IT SHALL BE BENCHED AND THE EXISTING FILL SHALL BE REMOVED UNTIL MATERIAL COMPACTED TO 90% RELATIVE COMPACTION IS EXPOSED. THEN THE NEW FILL MATERIAL SHALL BE PLACED IN UNIFORM LIFTS NOT EXCEEDING 6" OF UNCOMPACTED THICKNESS BEFORE COMPACTION BEGINS, THE FILL SHALL BE BROUGHT TO A WATER CONTENT THAT WILL PERMIT PROPER COMPACTION BY EITHER: (1) AERATING THE FILL IF IT IS TOO WET, OR (2) MOISTENING THE FILL WITH WATER IF IT IS TOO DRY. EACH LIFT SHALL BE THOROUGHLY MIXED BEFORE COMPACTION TO ENSURE A UNIFORM DISTRIBUTION OF MOISTURE.
- 2. SURPLUS EARTH FILL MATERIAL SHALL BE PLACED IN A SINGLE (8" max) THICK LAYER COMPACTED TO WITHSTAND WEATHERING IN THE AREA(S) DELINEATED ON THE PLAN.
- 3. NO ORGANIC MATERIAL SHALL BE PLACED IN ANY FILL NO TREES SHALL BE REMOVED OUTSIDE OF CUT. FILL. OR ROADWAY AREAS.
- 4. THE UPPER 6" OF SUBGRADE BELOW DRIVEWAY, ACCESS ROAD, OR PARKING AREA SHALL BE COMPACTED TO 95% OF MAXIMUM DENSITY.
- 5. MAXIMUM CUT SLOPE SHALL BE 1 1/2 HORIZONTAL TO 1 VERTICAL. MAXIMUM FILL SLOPE SHALL BE 2 HORIZONTAL TO 1 VERTICAL. 2025 CUBIC YARDS ESTIMATED VOLUME OF CUT ESTIMATED VOLUME OF FILL 390 CUBIC YARDS **EXCESS MATERIALS** 1635 CUBIC YARDS

10 FEET

### IMPORTED MATERIALS CUBIC YARDS 10 FEET MAXIMUM DEPTH OF CUT

### APPROXIMATE EARTHWORK QUANTITIES

MAXIMUM DEPTH OF FILL

ON SITE DRIVEWAY	90 cu. yd.	210 cu. yd.
BUILDING PAD	200 cu. yd.	130 cu. yd.
LANDSCAPE AND COURTYARD	550 cu. yd.	0 cu. yd
GRADING IN EASEMENT OFF SITE	335 cu. yd.	0 cu. yd
OFF SITE DRIVEWAY AND TURNAROUND	800 cu. yd.	0 cu. yd
PRO RATA SHARE OF PRIVATE ROAD	50 cu. yd.	50 cu. yd

- ALL EXCESS GRADING MATERIALS SHALL BE DISPOSED AT A COUNTY APPROVED DUMP SITE.
- 1. ALL FILL SLOPES SHALL BE COMPACTED AND LEFT IN A SMOOTH AND FIRM CONDITION CAPABLE OF WITHSTANDING WEATHERING.
- 2. ALL EXPOSED DISTURBED AREAS SHALL BE SEEDED WITH BROME SEED SPREAD AT THE RATE OF 5 POUNDS PER 1000 SQUARE FEET (OR APPROVED EQUAL). SEEDING AND WATERING SHALL BE MAINTAINED AS REQUIRED TO ENSURE GROWTH.
- 3. ALL DITCHES AT SLOPES GREATER THAN 5% SHALL BE LINED WITH 2" AC OR PCC THROUGHOUT.
- 4. ALL STORM DRAINAGE STRUCTURES SHALL BE INSTALLED WITH EFFECTIVE ENTRANCE AND OUTFALL EROSION CONTROLS, e.g. SACKED CONCRETE RIP-RAP. ENERGY DISSIPATORS SHALL BE INSTALLED AT ALL DITCH OUTFALLS. WHERE OUTFALLS ARE NOT INTO AN EXISTING CREEK OR WATER COURSE, RUN-OFF SHALL BE RELEASED TO SHEET FLOW.

1. DRIVEWAY LOCATIONS SHALL BE AS SHOWN ON THE IMPROVEMENT PLANS WITH CENTERLINE STATIONING. THE MINIMUM CONCRETE THICKNESS SHALL BE 6 INCHES THROUGHOUT. THE MAXIMUM APPROACH GRADE SHALL BE 5% FOR A LENGTH OF 20 FEET.

# STREET LIGHTING

1. PACIFIC GAS & ELECTRIC ELECTROLIER SERVICE FEE SHALL BE PAID BY THE DEVELOPER AND/OR HIS AUTHORIZED REPRESENTATIVE

- 1. DEVELOPER IS RESPONSIBLE FOR ALL NECESSARY DRAINAGE FACILITIES WHETHER SHOWN ON THE PLANS OR NOT AND HE OR HIS SUCCESSOR PROPERTY OWNERS ARE RESPONSIBLE FOR THE ADEQUACY AND CONTINUED MAINTENANCE OF THESE FACILITIES IN A MANNER WHICH WILL PRECLUDE ANY HAZARD TO LIFE, HEALTH OR DAMAGE TO ADJOINING PROPERTY.
- 2. DROP INLETS SHALL BE COUNTY STANDARD TYPE 5 UNLESS OTHERWISE NOTED ON THE PLANS THE DEVELOPER'S ENGINEER SHALL BE RESPONSIBLE FOR THE PROPER LOCATION OF DROP INLETS. WHERE STREET PROFILE GRADE EXCEEDS 6% DROP INLETS SHALL BE SET AT 30 DEGREE ANGLE CURB LINE TO ACCEPT WATER OR AS SHOWN ON THE PLANS.
- 3. WHERE CULVERTS ARE INSTALLED THE DEVELOPER SHALL BE RESPONSIBLE FOR GRADING THE OUTLET DITCH TO DRAIN TO AN EXISTING SWALE OR TO AN OPEN AREA OF SHEET FLOW.
- 4. UPON INSTALLATION OF DRIVEWAY CONNECTIONS, PROPERTY OWNERS SHALL PROVIDE FOR THE UNINTERRUPTED FLOW OF WATER IN ROADSIDE DITCHES.

# SANITARY SEWERS

1. ALL MATERIALS AND METHODS OF CONSTRUCTION OF SANITARY SEWERS SHALL CONFORM TO THE SPECIFICATIONS OF THE JURISDICTION INVOLVED. INSPECTION OF SANITARY SEWER WORK SHALL BE DONE BY SAID JURISDICTION.

# PORTLAND CEMENT CONCRETE

1. CONCRETE USED FOR STRUCTURAL PURPOSES SHALL BE CLASS "A" (6 SACK PER CUBIC YARD) AS SPECIFIED IN THE STATE STANDARD SPECIFICATIONS. CONCRETE PLACED MUST DEVELOP A MINIMUM STRENGTH FACTOR OF 2200 P.S.I. IN A SEVEN DAY PERIOD. THE CONCRETE MIX DESIGN SHALL BE UNDER THE CONTINUAL CONTROL OF THE COUNTY INSPECTOR.

GINNIE NO. 1 APPROXIMATELY 2 FEET FROM THE SOUTH EDGE OF CLAYTON ROAD NEAR THE WESTERLY PROPERTY LINE OF PARCEL. ELEVATION = 100.00'

THE BEARING N 85° 00' 49" E OF THE CENTERLINE OF CLAYTON ROAD AS SHOWN ON THE PARCEL MAP BOOK 644 OF MAPS AT PAGE 24 IN THE OFFICE OF THE COUNTY RECORDER OF THE COUNTY OF SANTA CLARA, STATE OF CALIFORNIA WAS TAKEN AS THE BASIS OF BEARINGS SHOWN ON THIS MAP.

# STATEMENT OF PURPOSE

PURPOSE OF GRADING AND DRAINAGE PLAN ILLUSTRATES PROPOSED SINGLE FAMILY CUSTOM HOME AND THE REQUIRED GRADING.

# SCOPE OF WORK

# CLEAR AND GRUB.

- 2. COMPLETE GRADING FOR INSTALLATION OF PROPOSED RESIDENCE AND DRIVEWAY.
- 3. INSTALL ROAD AND DRIVEWAY FOR ACCESS AS SHOWN.
- 4. A CONSTRUCTION OBSERVATION LETTER FROM THE RESPONSIBLE GEOTECHNICAL ENGINEER DETAILING CONSTRUCTION OBSERVATIONS AND CERTIFYING THAT THE WORK WAS DONE IN ACCORDANCE WITH THE RECOMMENDATIONS IN THE GEOTECHNICAL REPORT SHALL BE SUBMITTED PRIOR TO GRADING COMPLETION AND RELEASE OF BOND.

# GRADING AND DRAINAGE PLAN LANDS OF BANSAL APN 612-37-016 11391 CLAYTON ROAD SAN JOSE, CALIFORNIA 95127

COUNTY OF SANTA CLARA

Development Services Office

Land Development Engineering Division

1. THE WATER AND SANITARY UTILITIES SHOWN ON THESE PLANS ARE SHOWN

POTENTIAL FOR EROSION ON THE SUBJECT SITE.

AS-BUILT PLAN STATEMENT

AND MARKED WITH THE SYMBOL

ISSUED BY:

COUNTY OF SANTA CLARA

**ENGINEER'S STATEMENT** 

COUNTY ENGINEER'S NOTE

CONSTRUCTION/ENCROACHMENT/GRADING PERMIT

PERMIT(S) NO. : \_\_\_\_\_

LAND DEVELOPMENT ENGINEERING & SURVEYING

ENVIRONMENTAL RESOURCES AGENCY

2. PRIOR TO GRADING COMPLETION AND RELEASE OF BOND, ALL GRADED AREAS

3. ROADWAYS DESIGNATED AS NOT COUNTY MAINTAINED ROADS AS SHOWN UPON

SHALL BE RESEEDED IN CONFORMANCE WITH THE COUNTY GRADING ORDINANCE

THIS PLAN WILL NOT BE ELIGIBLE FOR COUNTY MAINTENANCE UNTIL THE ROADWAY:

STANDARDS APPROVED BY THE BOARD OF SUPERVISORS AND IN EFFECT AT SUCH TIME

THAT THE ROADWAYS ARE CONSIDERED FOR ACCEPTANCE INTO THE COUNTY'S ROAD SYSTEM.

SIGNATURE

PLANS MUST BE FURNISHED TO THE COUNTY ENGINEER AFTER CONSTRUCTION.

I HEREBY STATE THAT THESE PLANS ARE IN COMPLIANCE WITH ADOPTED COUNTY STANDARDS, THE

RCE 66537 EXP. 06/30/2016

RCE 42107 EXP. 03/31/2016

R.C.E. No. / EXPIRATION DATE

R.C.E. No. / EXPIRATION DATE

APPROVED TENTATIVE MAP (OR PLAN) AND CONDITIONS OF APPROVAL PERTAINING THERETO

ISSUANCE OF A PERMIT AUTHORIZING CONSTRUCTION DOES NOT RELEASE THE DEVELOPER,

OMISSIONS CONTAINED IN THE PLANS, IF, DURING THE COURSE OF THE CONSTRUCTION, THE PUBLIC INTEREST REQUIRES A MODIFICATION OF (OR A DEPARTURE FROM) THE SPECIFICATIONS

PERMITTEE OR ENGINEER FROM RESPONSIBILITY FOR THE CORRECTION OF ERRORS OR

SUSPENSION OF WORK, AND THE NECESSARY MODIFICATION OR DEPARTURE AND TO

CHRISTOPHER L. FREITAS

OR THE PLANS, THE COUNTY SHALL HAVE THE AUTHORITY TO REQUIRE THE

SPECIFY THE MANNER IN WHICH THE SAME IS TO BE MADE.

\_, FILE(S) No.

ANDREW E. ARNOLD

ENGINEER TO PERFORM THE INSPECTION WORK. A REPRODUCIBLE COPY OF THE AS-BUILT

ARE IMPROVED (AT NO COST TO THE COUNTY) TO PUBLIC MAINTENANCE ROAD

THIS IS A TRUE COPY OF THE AS-BUILT PLANS. THERE ( \_\_\_\_\_WERE) ( \_\_\_\_\_WERE NOT)


MINOR FIELD CHANGES--MARKED WITH . THERE (\_\_\_\_\_WERE) (\_\_\_\_\_WERE NOT)

PLAN REVISIONS INDICATING SIGNIFICANT CHANGES REVIEWED BY THE COUNTY ENGINEER


NOTE: THIS STATEMENT IS TO BE SIGNED BY THE PERSON AUTHORIZED BY THE COUNTY

TO MINIMIZE THE VISUAL IMPACTS OF THE GRADED SLOPES AND REDUCE THE

Construction Permit No.:

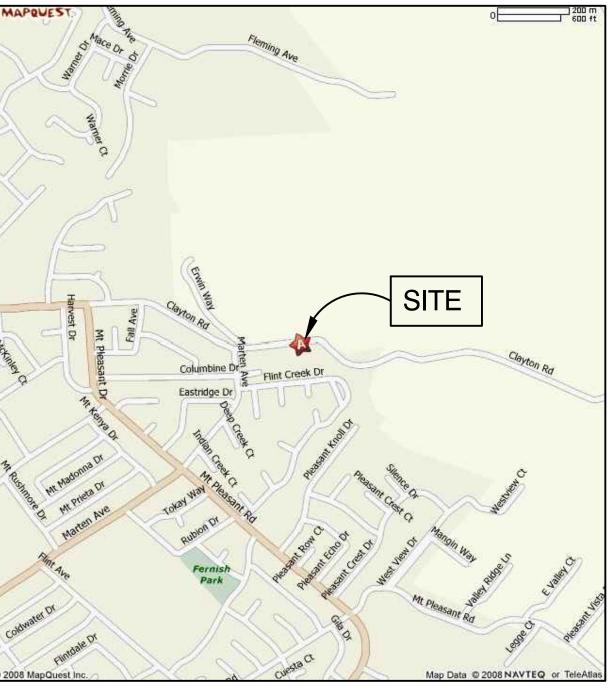

NTS

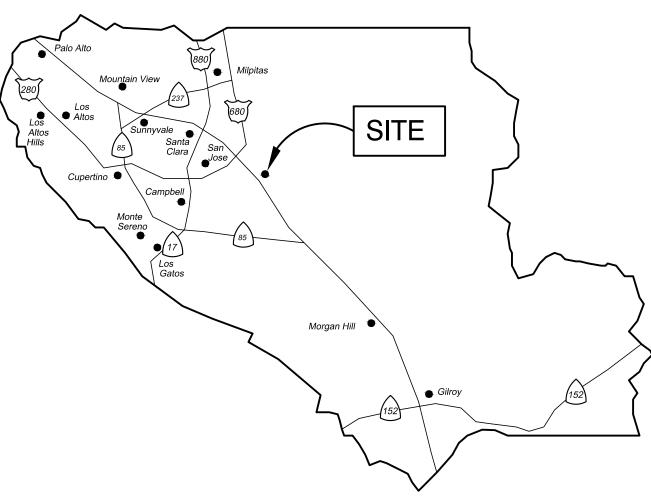

PROJECT TITLE NEW CUSTOM HOME LANDS OF BANSAL 11391 CLAYTON ROAD SAN JOSE, CALIFORNIA, 95127

COUNTY LOCATION MAP

**FEBRUARY 18, 2015** 

**AS SHOWN** 

AEA

03-07

∕ NO. C 66537

**REVISIONS** 

DEH REVIEW

ARCH. CHANGES

REVIEW DRAWINGS

COMMENTS DATED

COMMENTS DATED

COMMENTS DATED

COMMENTS 01/20/2015

06/13/2013

01/21/2014

03/17/2014

09/22/2014

APN: 612-37-016

SHEET TITLE

GRADING

SCALE

DRAWN

SHEET

TITLE SHEET

EMAIL DATED

DRX/BSA/GS SUBMITTAL

Exp. 06 - 30 - 16

DATE

01/11/2010

06/18/2010

01/25/2013


04/10/2013

12/10/2013

08/13/2014

APPLICANT: BANSAL **ROAD NAME: CLAYTON ROAD** COUNTY FILE NO.


**VICINITY MAP** 

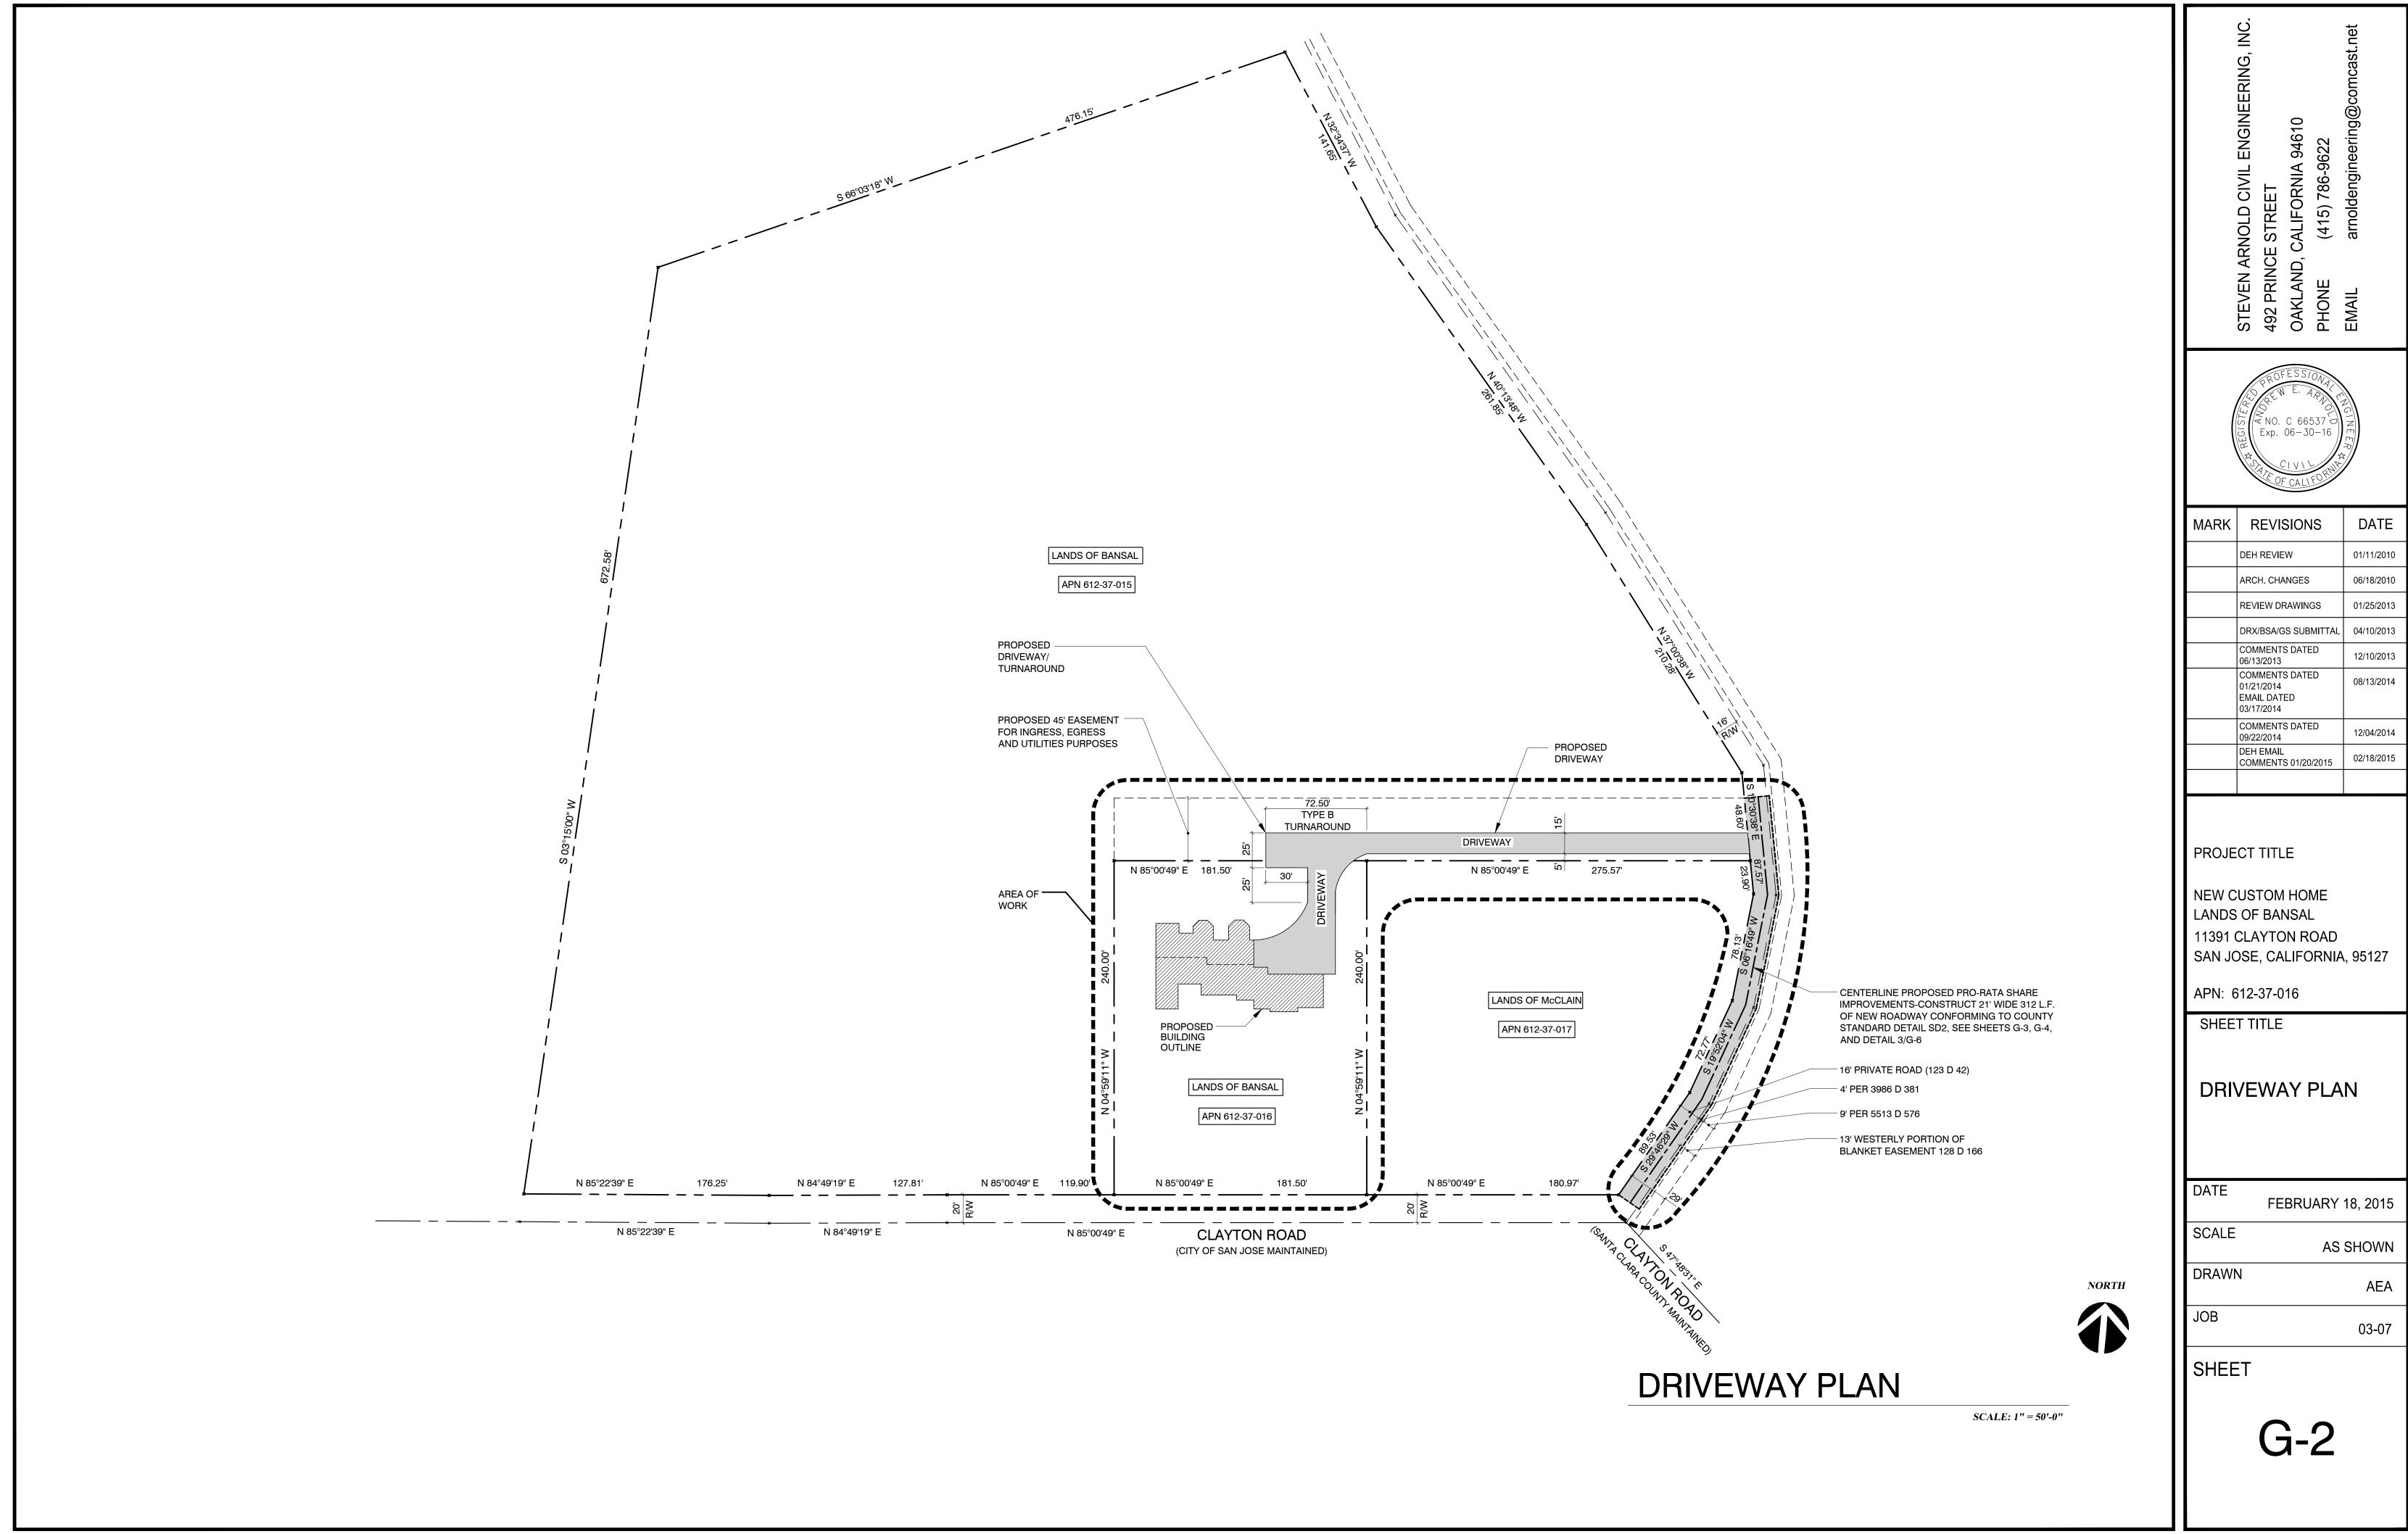

APPLICANT: BANSAL

ROAD NAME: CLAYTON ROAD


COUNTY FILE NO.

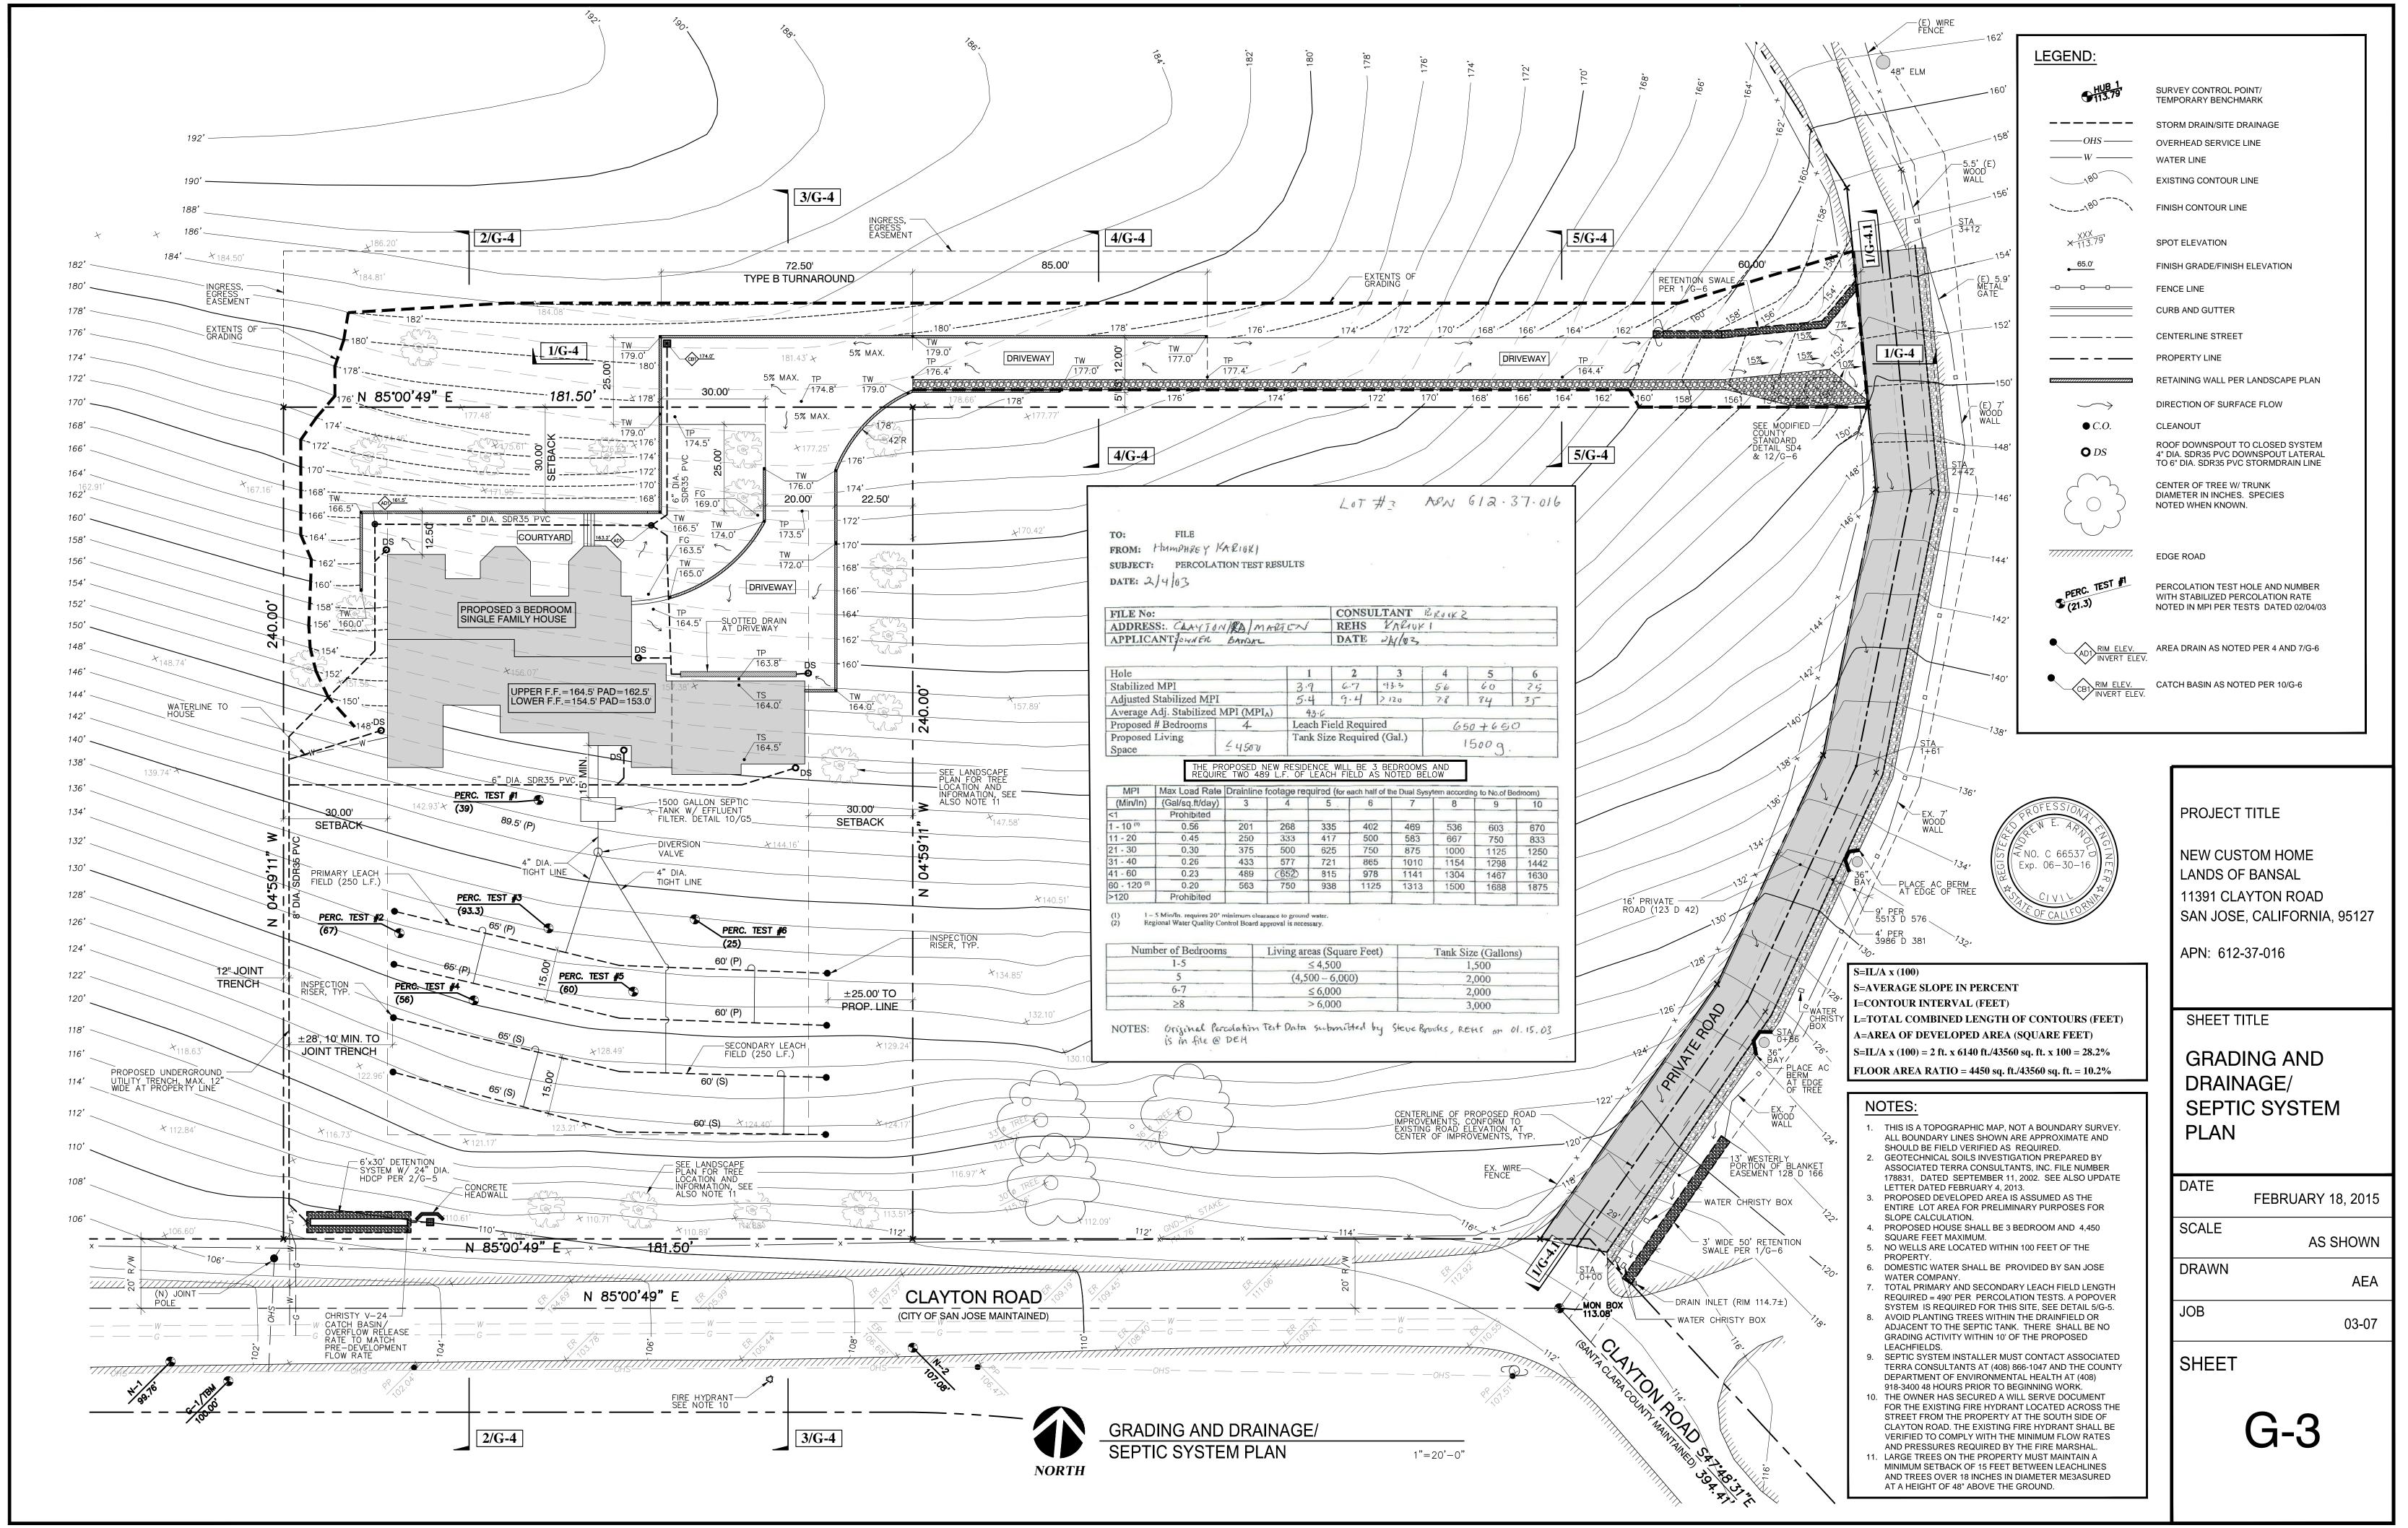


APPLICANT: BANSAL


**ROAD NAME: CLAYTON ROAD** 


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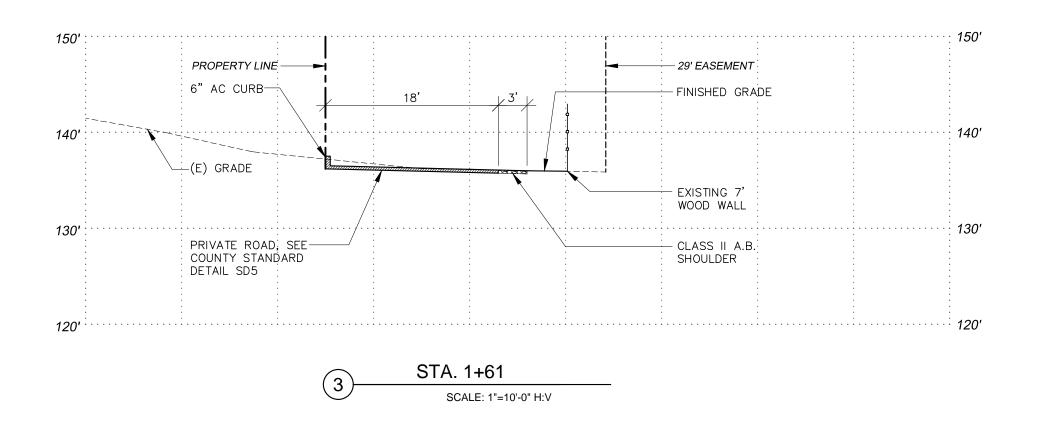


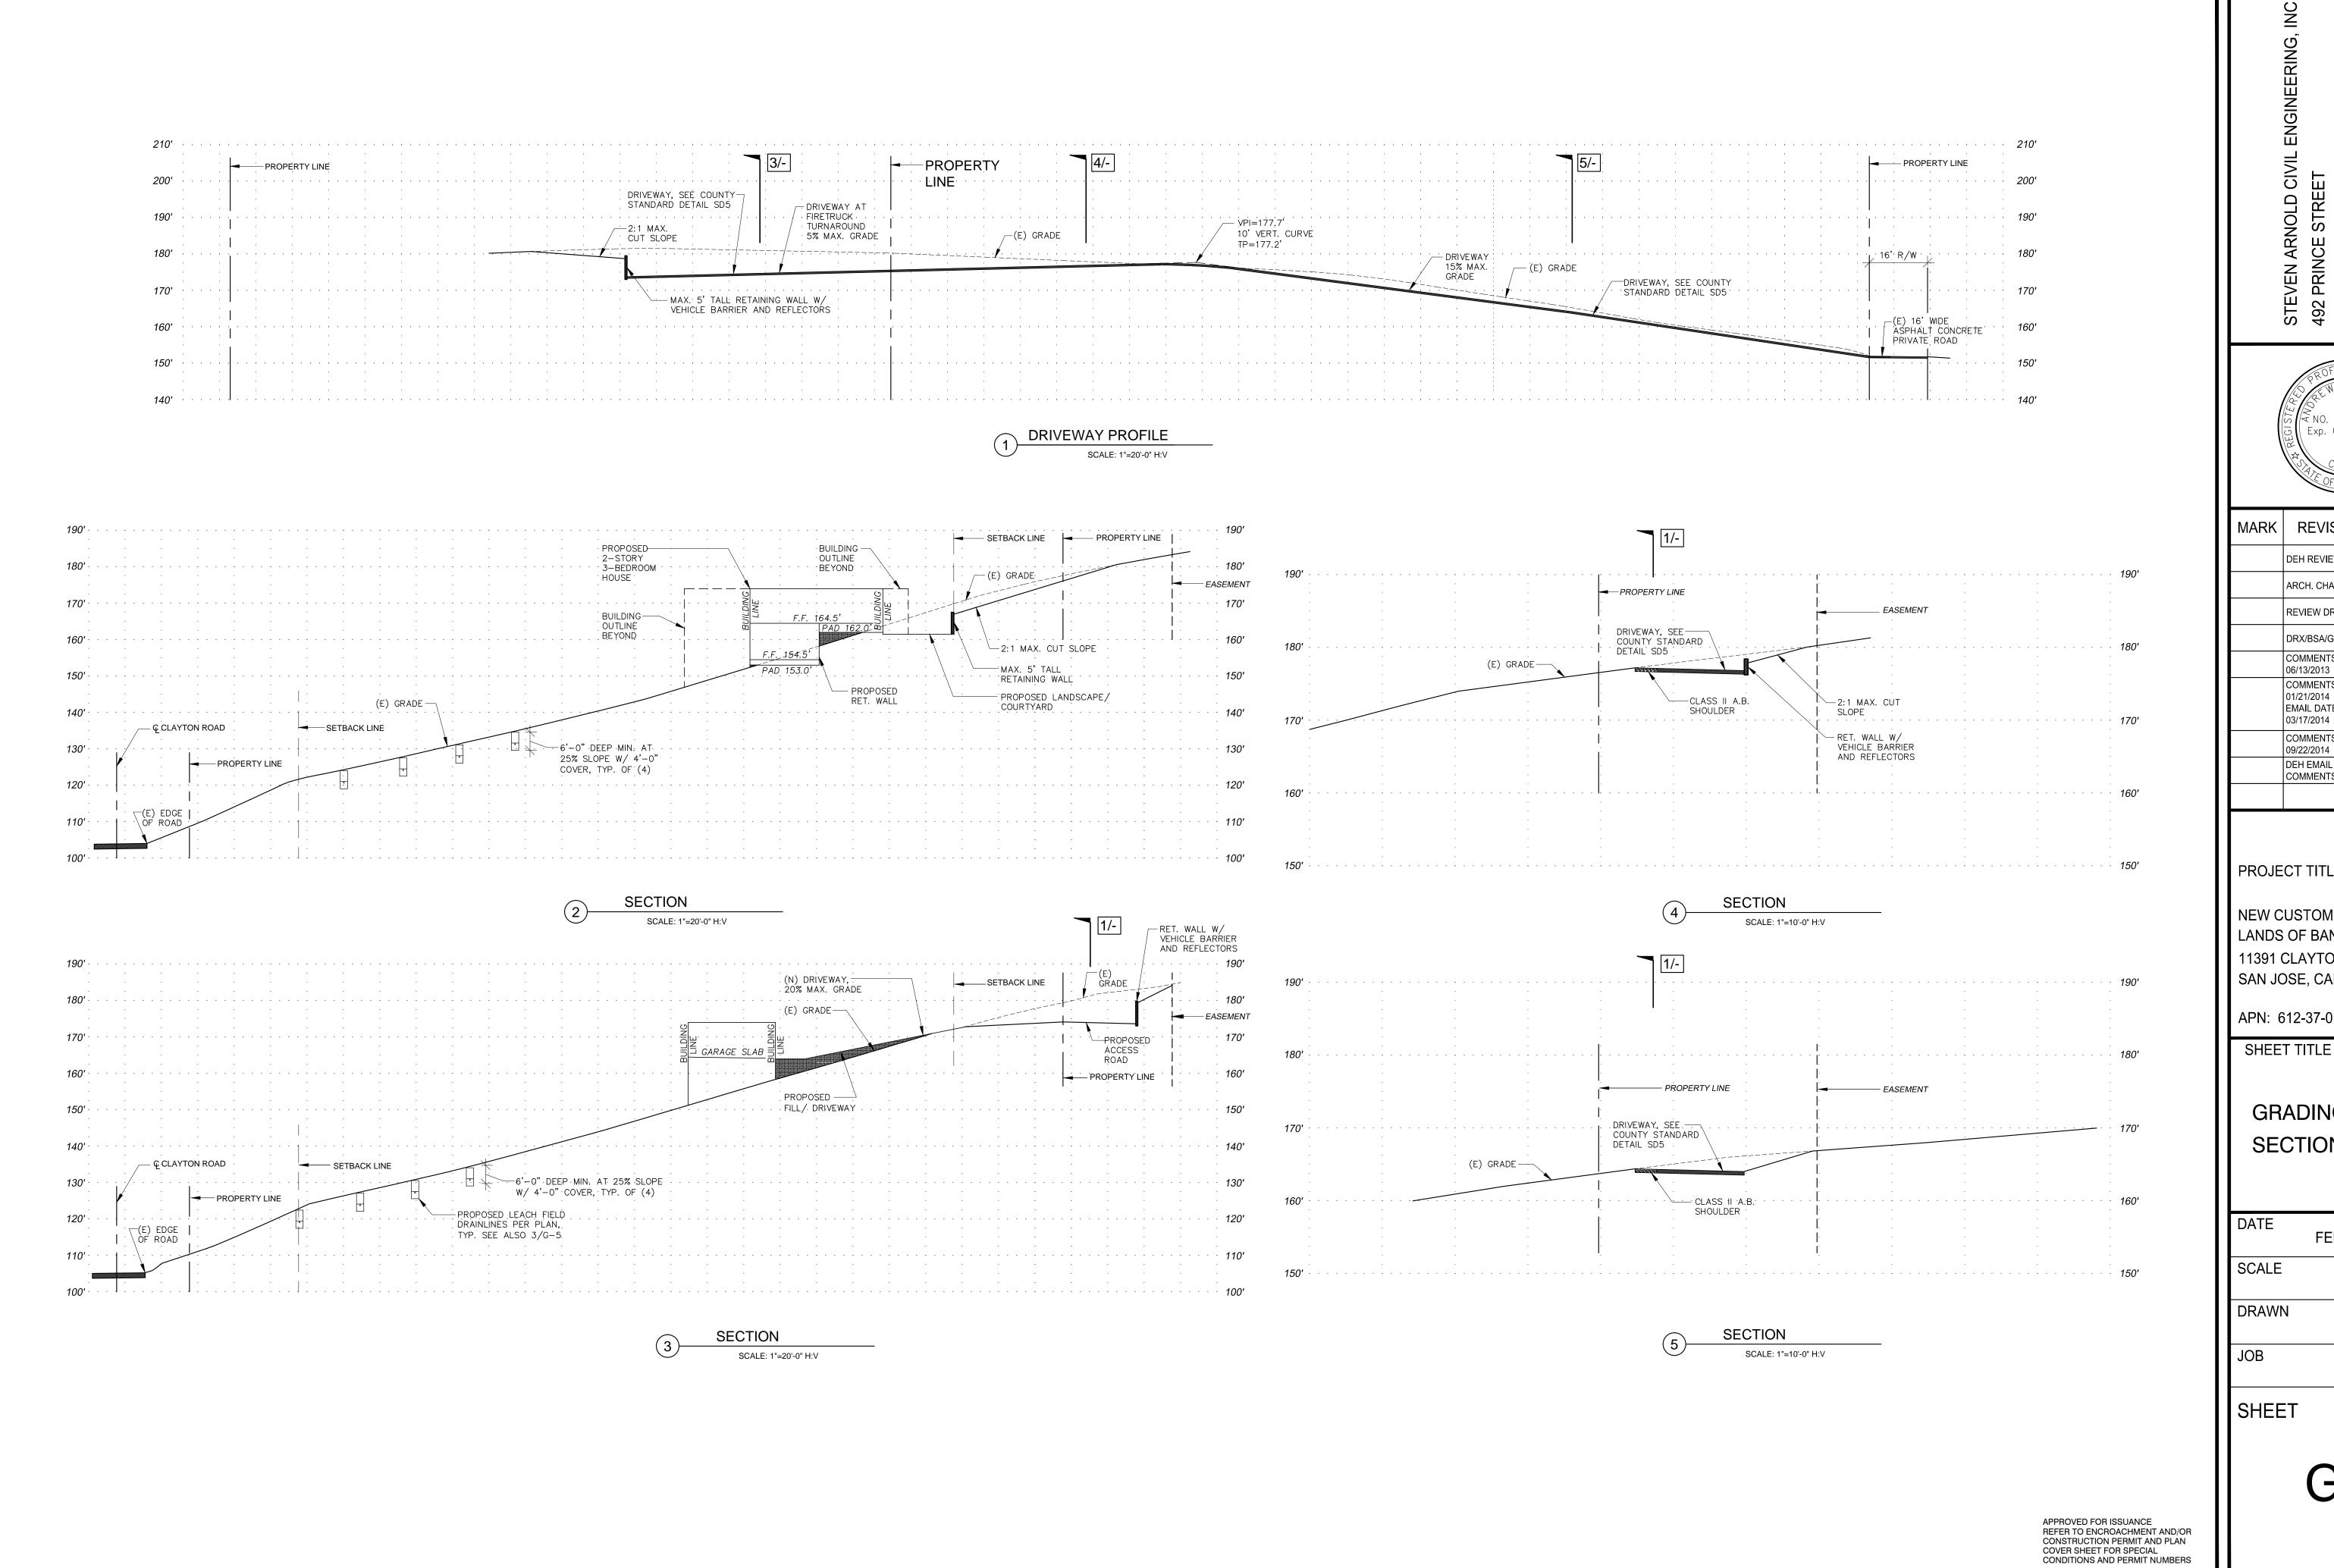
Exp. 06-30-16 DEH REVIEW 01/11/2010 ARCH. CHANGES 06/18/2010 REVIEW DRAWINGS 01/25/2013 06/13/2013 COMMENTS DATED 08/13/2014 01/21/2014 EMAIL DATED 03/17/2014 COMMENTS DATED 09/22/2014 COMMENTS 01/20/2015 PROJECT TITLE NEW CUSTOM HOME LANDS OF BANSAL 11391 CLAYTON ROAD SAN JOSE, CALIFORNIA, 95127 APN: 612-37-016 SHEET TITLE GRADING SECTIONS FEBRUARY 18, 2015 AS SHOWN AEA 03-07



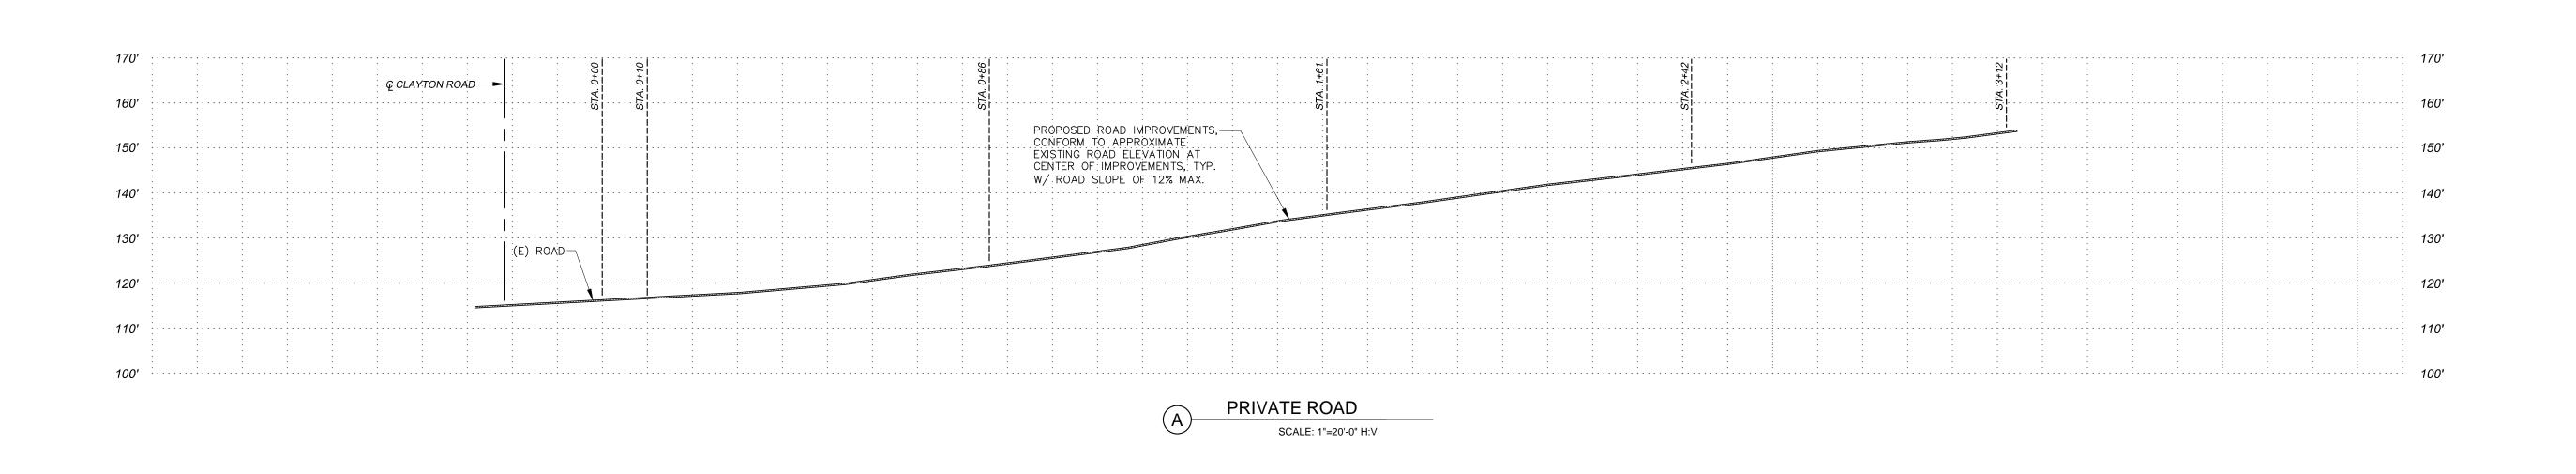

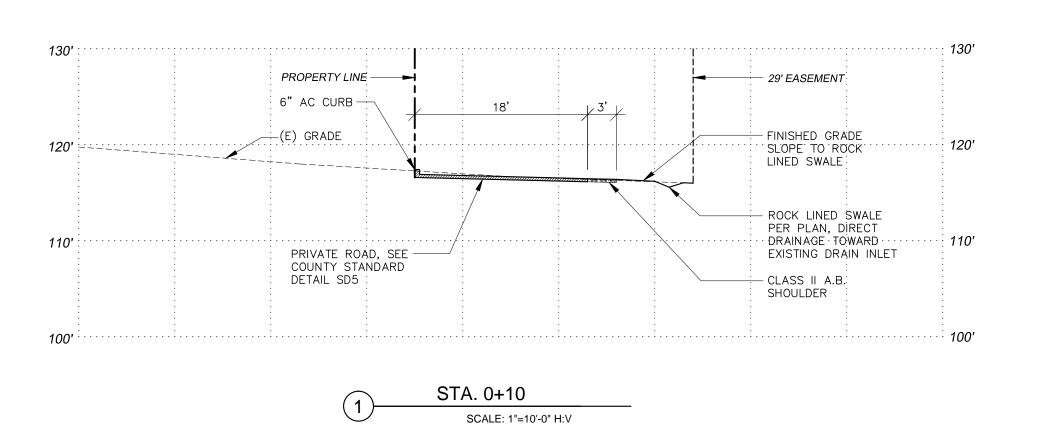

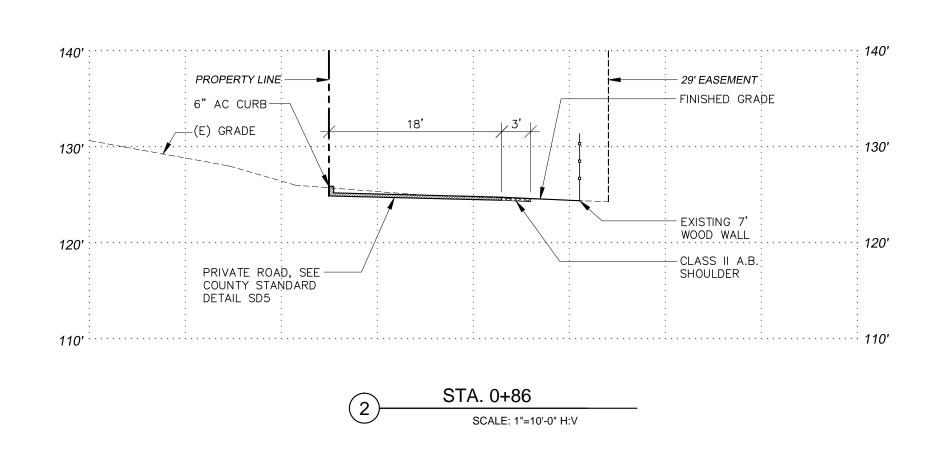

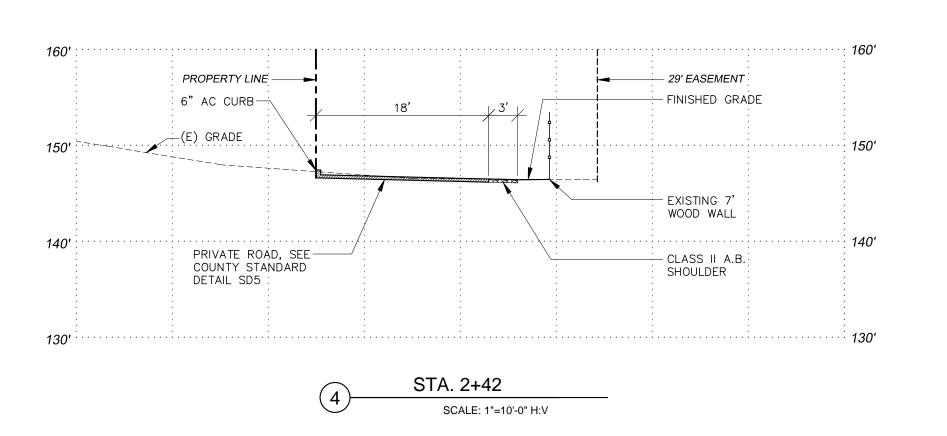

APPROVED FOR ISSUANCE
REFER TO ENCROACHMENT AND/OR
CONSTRUCTION PERMIT AND PLAN
COVER SHEET FOR SPECIAL
CONDITIONS AND PERMIT NUMBERS

STEVEN ARNOLD CIVIL ENGINEERING, INC.
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MARK	REVISIONS	DATE
	DEH REVIEW	01/11/2010
	ARCH. CHANGES	06/18/2010
	REVIEW DRAWINGS	01/25/2013
	DRX/BSA/GS SUBMITTAL	04/10/2013
	COMMENTS DATED 06/13/2013	12/10/2013
	COMMENTS DATED 01/21/2014 EMAIL DATED 03/17/2014	08/13/2014
	COMMENTS DATED 09/22/2014	12/04/2014
	DEH EMAIL COMMENTS 01/20/2015	02/18/2015

PROJECT TITLE

NEW CUSTOM HOME
LANDS OF BANSAL
11391 CLAYTON ROAD
SAN JOSE, CALIFORNIA, 95127

APN: 612-37-016

SHEET TITLE

GRADING SECTIONS

FEBRUARY 18, 2015

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SCALE AS SHOWN

DRAWN AEA

JOB 03-07

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