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C0.3 - PROPOSED EASEMENT

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C1.1 - EXISTING ACCESS ROAD PLAN & PROFILE

C1.2 - PROPOSED ACCESS ROAD PLAN & PROFILE

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C1.4 - PROPOSED ACCESS ROAD PLAN & PROFILE

C1.5 - PROPOSED ACCESS ROAD PLAN & PROFILE

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CI.O EXISTING INTERNATION FOND FEAR

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WW1 - PRELIMINARY OWTS DISPOSAL PLAN

LSS 01 - LIVESTOCK SHELTER FLOOR PLAN

LSS 02 - LIVESTOCK SHELTER ELEVATIONS
LSS 03 - LIVESTOCK SHELTER SECTIONS

LSS 04 - LIVESTOCK SHELTER VIEWS

NOTES

A.P.N. 029-35-007
PRESENT USE: AGRICULTURE/RANCH LAND

PROPOSED USE:

AGRICULTURE/RANCH LAND
PRESENT ZONING:
HS-D2
PROPOSED ZONING:
HS-D2
SANITARY SEWER:
SEPTIC

WATER SUPPLY: PRIVATE WELL
GAS & ELECTRIC: P.G. & E.
TELEPHONE: A.T.&T.
EXISTING IMPROVEMENTS: NONE

TOTAL PROJECT ACREAGE: 15.768 ACRES

GENERAL NOTES

NO CHANGE TO THE GRADING PLAN SHALL BE PERMITTED WITHOUT PRIOR APPROVAL BY THE OWNER OR OWNERS REPRESENTATIVES.


CONTRACTOR SHALL VERIFY LOCATIONS, ELEVATIONS AND INVERTS OF EXISTING UTILITY PRIOR TO COMMENCEMENT OF WORK AND SHALL NOTIFY OWNER OR OWNERS REPRESENTATIVES OF VARIANCE FROM THOSE SHOWN ON THE PLANS.

UNDERGROUND FACILITIES AND UTILITIES HAVE BEEN SHOWN BASED ON RECORD DRAWINGS AND VISIBLE EVIDENCE FOUND IN FIELD. NO WARRANTY IS MADE REGARDING THE COMPLETENESS OR ACCURACY OF SUCH INFORMATION. PRIOR TO CONSTRUCTION, DETERMINE THE EXACT LOCATION OF UNDERGROUND FACILITIES AND UTILITIES, AND PRESERVE SAME FROM DAMAGE. PRIOR TO CONSTRUCTION, VERIFY LOCATION AND ELEVATION OF EXISTING UNDERGROUND UTILITIES AT THE CROSSING POINTS WITH PROPOSED UTILITIES. THE CONTRACTOR SHALL NOTIFY THE OWNER OR OWNERS REPRESENTATIVES IF CONDITIONS DIFFER FROM THOSE SHOWN ON THE DRAWINGS AND SHALL NOT BEGIN CONSTRUCTION UNTIL THE CHANGED CONDITION HAS BEEN EVALUATED. CONTACT UNDERGROUND SERVICES ALERT (USA) (1-800-227-2600) TWO (2) WEEKS PRIOR TO DIGGING. REPAIR UNDERGROUND UTILITIES DAMAGED BY CONSTRUCTION OPERATIONS. CONTRACTOR SHALL BE RESPONSIBLE FOR ANY AND ALL DAMAGES ASSOCIATED WITH CONTRACTOR'S FAILURE TO EXACTLY LOCATED AND PRESERVE UNDERGROUND FACILITIES AND UTILITIES.

CONTRACTOR SHALL BE RESPONSIBLE FOR ALL COORDINATION WITH THE APPROPRIATE UTILITY COMPANIES AND/OR AGENCIES TO VERIFY THE EXISTENCE AND/OR LOCATION OF ALL UNDERGROUND UTILITIES PRIOR TO COMMENCEMENT OF WORK. AND SHALL NOTIFY U.S.A. @ (800) 227-2600 AT LEAST 48-HOURS IN ADVANCE OF EXCAVATION.

IF ANY INDICATIONS OF ARCHEOLOGICAL REMIANS ARE ENCOUNTERED DURING GRADING ACTIVITIES FOR ANY DEVELOPMENT WITHIN THE PROJECT SITE, ALL WORK SHALL BE HALTED WITHIN 200 FOOT RADIUS OF THE FIND. OWNER SHALL RETAIN A QUALIFIED ARCHEOLOGIST RETAINED TO DETERMINE THE NATURE OF THE DISCOVERY AND RECOMMEND APPROPRATE EVALUATION PROCEDURES.

BARSANA RESIDENCE APN: 029-35-007

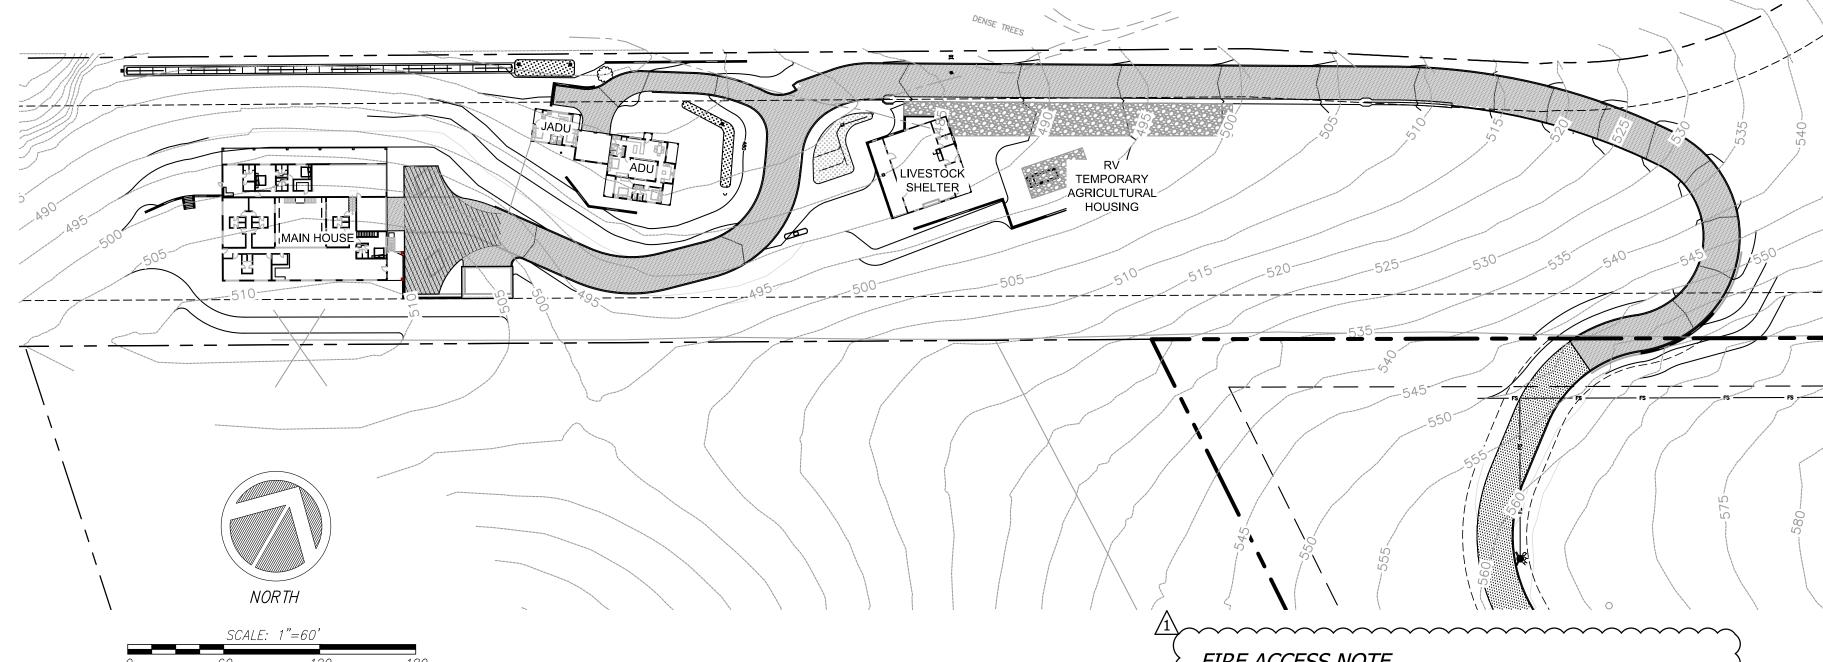

OWNER/DEVELOPER:

BARSANA LLC, 40762 GREYSTONE TERRACE FREMONT , CA 94538 PHONE-(216) 496-9596 EMAIL: vijay.datt@ihf-usa.org

CIVIL ENGINEER:

C2G/CIVIL CONSULTANTS GROUP, INC 4444 SCOTTS VALLEY DRIVE STE. 6 SCOTTS VALLEY, CA 95066 OFFICE: (831) 438-4420

<u>SURVEYOR</u>

ALPHA LAND SURVEYS, INC. 4444 SCOTTS VALLEY DRIVE STE. 7 SCOTTS VALLEY, CA 95066 OFFICE: (831) 438-4453

<u>SCOPE</u>

- MULTIPLE SMALL STRUCTURES TO BE BUILT INCLUDING THE MAIN SINGLE FAMILY RESIDENCE WITH GARAGE, JADU WITH ADU, AND ANIMAL SHELTERS. FOR MORE DETAILS AND SECTIONS FOR THE PROPOSED STRUCTURES PLEASE REFERENCE TO THE ARCHITECTURAL PLANS FOR THE PROPOSED SITE.

PROPOSED STRUCTURE SIZES
-PROPOSED MAIN BUILDING AND GARAGE = 7,999 SQ FT
-PROPOSED DETACHED GARAGE = 462 SQ FT
-PROPOSED JADU & ADU = 1,698 SQ FT

-PROPOSED ANIMAL SHELTERS = 1,452 SQ FT -PROPOSED RV TEMPORARY AGRICULTURAL RESIDENCE = 248 SQ FT

(N) IMPERVIOUS AREAS TABLE			
DESCRIPTION	AREA (SQ. FT.)	AREA (ACRES)	EQUIVALENT AREA (ACRES)
EXISTING	0	0	0
MAIN BULDING & GARAGE	9,439	0.217	0.217
JADU & ADU	2,537	0.058	0.058
AC ROAD	23,632	0.543	0.543
CONCRETE VALLEY GUTTER	1,072	0.025	0.025
PROPOSED LIVESTOCK SHELTER	2,600	0.060	0.060
GRAVEL BASEROCK (PARKING)	2,201	0.051	0.031
TOTAL (N) IMPERVIOUS AREA	41,481	0.952	0.933
TOTAL LOT AREA	686,854	15.768	15.768
IMPERVIOUS % OF TOTAL LOT			11.8%

IMPERVIOUS AREA IN APN 029-34-004					
DESCRIPTION	AREA (SQ. FT.)	AREA (ACRES)	EQUIVALENT AREA (ACRES)		
NEW ASPHALT ROAD	18,780	0.431	0.431		

NOTE: EXISTING GRAVEL ROAD TO BE ASPHALTED PER 2022 RECLAMATION PLAN AMENDMENT FROM STATION 5+50 TO 15+26

FIRE ACCESS NOTE

FIRE DEPARTMENT ACCESS SHALL BE MADE OF AN "ALL WEATHER" MATERIAL CAPABLE OF HOLDING 75,000 POUNDS.

DEFFERED SUBMITAL NOTE

THE FOLLOWING SHALL BE DEFERRED AND SUBMITTED SEPARATELY FROM THIS APPLICATION:
A. RESIDENTIAL FIRE SPRINKLERS.
B. FIRE PROTECTION UNDERGROUND (STANDARD FIRE HYDRANT).

BUILDING SITE APPROVAL SLOPE CALCULATIONS

 $S = \frac{I * L}{A} (100)$

S = AVERAGE SLOPE OF THE AREA IN PERCENT
I = IS THE CONTOUR INTERVAL IN FEET
L = IS THE COMBINED LENGTH OF CONTOUR LINES IN FEET
A = SITE DEVELOPMENT AREA IN SQUARE FEET

PROPOSED DEVELOPED AREA FOR LOT

 $S = \frac{1*30,251}{158,412 \text{ SQ.FT.}} (100) = 19.10\% \text{ AVE. SLOPE}$

PROJECT EARTHWORK QUANTITIES


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NOTE: THE EARTHWORK QUANTITIES SHOWN HEREON ARE
EXCLUSIVE OF WALL FOOTINGS, EXISTING PAVEMENT REMOVAL
AND OVER EXCAVATION AND RECOMPACTION, UTILITY TRENCH SPOILS &
SOIL EXPANSION AND CONTRACTION FACTORS.

DESCRIPTION	CUT (cu.yds)	FILL (cu.yds)	NET (cu.yds)	MAX CUT (ft) HEIGHT	MAX FILL (ft) HEIGHT
MAIN BUILDING	682	418	264(C)	8	6
ADU/JADU	401	323	78(C)	5	4
ROAD (APN 029-35-007)	2808	2786	22(C)	11	7
ROAD (APN 029-34-004)	1746	2219	473(F)	6	8
LIVESTOCK SHELTER & RV PARKING	445	142	303(C)	3	3
TOTAL	6082	5888	194(C)		

NET VOLUME = 194 CU.YDS. OF CUT

THE ABOVE QUANTITIES ARE FOR INFORMATION PURPOSES ONLY.
THE CONTRACTOR IS RESPONSIBLE TO PROVIDE THE NECESSARY CUT
AND FILL TO ACCOMPLISH FINISH GRADE SHOWN ON THESE PLANS.

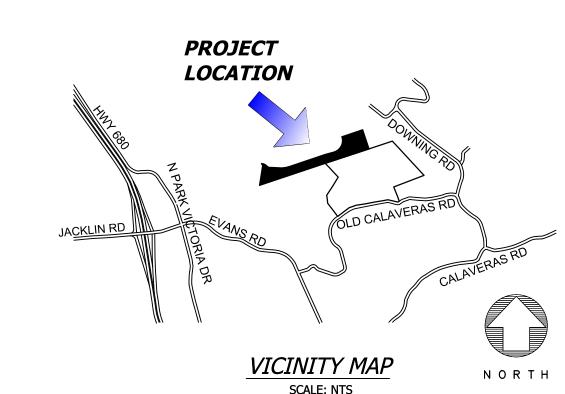

CONTRACTOR RESPONSIBILITY

CONTRACTOR AGREES THAT HE SHOULD ASSUME SOLE AND COMPLETE RESPONSIBILITY FOR JOB SITE CONDITIONS, INCLUDING THE SAFETY OF ALL PERSONS AND PROPERTY, DURING THE COURSE OF CONSTRUCTION OF THIS PROJECT, AND THAT REQUIREMENT SHALL APPLY CONTINUOUSLY AND NOT BE LIMITED DURING WORKING HOURS. THE CONTRACTOR SHALL DEFEND, INDEMNIFY AND HOLD THE OWNER AND THE DESIGN PROFESSIONALS HARMLESS FROM ANY AND ALL LIABILITY, REAL OR ALLEGED, IN CONNECTION WITH THE PERFORMANCE OF WORK ON THIS PROJECT, EXCEPTING FOR LIABILITY ARISING FROM THE SOLE NEGLIGENCE OF THE OWNER OR DESIGN PROFESSIONAL.

DISCREPANCIES

IF THERE ARE ANY DISCREPANCIES BETWEEN THE CONSTRUCTION DOCUMENTS AND EXISTING CONDITIONS WHICH WILL AFFECT THE WORK, THE CONTRACTOR SHALL BRING SUCH DISCREPANCIES TO THE DESIGN PROFESSIONAL FOR ADJUSTMENT BEFORE PROCEEDING WITH THE WORK. THE CONTRACTOR SHALL BE RESPONSIBLE FOR THE PROPER FITTING OF ALL WORK AND FOR THE COORDINATION OF ALL TRADES, SUBCONTRACTORS, AND PERSONS ENGAGED UPON THIS CONTRACT.

CONSTRUCTION SURVEYING / STAKING

CONTRACTOR IS RESPONSIBLE TO PROVIDE ALL SURVEYING AND OR STAKING BY A LICENSED SURVEYOR FOR ALL CONSTRUCTION PURPOSES.

ADDITIONAL NOTES

- CONTRACTOR AGREES THAT HE SHALL ASSUME SOLE AND COMPLETE RESPONSIBILITY FOR JOB SITE CONDITIONS DURING THE COURSE OF CONSTRUCTION OF THIS PROJECT, INCLUDING SAFETY OF ALL PERSONS AND PROPERTY; THAT THIS REQUIREMENT SHALL APPLY CONTINUOUSLY AND NOT BE LIMITED TO NORMAL WORKING HOURS; AND THAT THE CONTRACTOR SHALL DEFEND, INDEMNIFY, AND HOLD THE OWNER AND THE ENGINEER HARMLESS FROM ANY AND ALL LIABILITY, REAL OR ALLEGED, IN CONNECTION WITH THE PERFORMANCE OF WORK ON THIS PROJECT, EXCEPTING FOR LIABILITY ARISING FROM THE SOLE NEGLIGENCE OF THE OWNER OR THE ENGINEER.

- THE STANDARD SPECIFICATIONS AND DETAILS, LATEST EDITION, OF THE COUNTY OF SANTA CLARA SHALL GOVERN UNLESS OTHERWISE SPECIFIED HEREIN.

UNAUTHORIZED CHANGES AND USES

CAUTION: THE ENGINEER PREPARING THESE PLANS WILL NOT BE RESPONSIBLE FOR, OR LIABLE FOR, UNAUTHORIZED CHANGES TO OR USES OF THESE PLANS. ALL CHANGES TO THE PLANS MUST BE IN WRITING AND MUST BE APPROVED BY THE PREPARER OF THE PLANS

FIRE PROTECTION NOTES

- 1. ALL DRIVEWAYS AND ACCESS ROADS TO MEET COUNTY STANDARD SD1.
- ALL DRIVEWAYS, ACCESS ROAD, AND PARKING LOTS TO BE MADE
 OF AN ALL WEATHER SURFACE CAPABLE OF SUPPORTING 75,000
 POUNDS AND HAVE A MAXIMUM SLOPE OF 16%.
 WATER TANKS TO HAVE A MINIMUM HEIGHT OF 12 FEET AND MEET
- STANDARDS SET IN CFMO W2 & W5. TANKS GREATER THAN 12
 FEET IN HEIGHT WILL REQUIRE A SEPARATE BUILDING PERMIT.

 4. FIRE HYDRANT SHALL MEET STANDARDS SET IN CFMO-W2.
- 5. WATER TANK SHALL BE SIZED PER NFPA 1142 TO INCLUDE SPRINKLER DEMAND AND HYDRANT DEMAND.
- 6. ALL STRUCTURES SHALL MEET WILDLAND URBAN INTERFACE
- (WUI) REQUIREMENTS AT BUILDING PERMIT SUBMITTAL
 7. NFPA 13 FIRE SPRINKLERS SHALL BE INSTALLED IN ALL
- BUILDINGS AND WILL BE A DEFERRED SUBMITTAL.

 8. ALL DEFERRED SUBMITTALS FOR FIRE PROTECTION
- UNDERGROUND, FIRE HYDRANTS, WATER TANKS, & FIRE PUMP.

 9. PROPERTY TO MAINTAIN 100 FEET DEFENSIBLE SPACE AT ALL
- TIMES.
 10. STRUCTURES SHALL CONFORM TO WUI BUILDING REQUIREMENTS.

ALL CONSTRUCTION SHALL COMPLY WITH ALL LOCAL CODES AND ORDINANCES AND THE CODES LISTED BELOW OR THE MOST CURRENT CODES AND ORDINANCES AT THE TIME OF SUBMITTAL

2022 CALIFORNIA CODES

- 1. 2022 CALIFORNIA BUILDING CODE
- 2. 2022 CALIFORNIA ELECTRICAL CODE
- 3. 2022 CALIFORNIA MECHANICAL CODE
- 4. 2022 CALIFORNIA PLUMBING CODE 5. 2022 CALIFORNIA GREEN CODE
- 6. 2022 CALIFORNIA ENERGY CODE
- 7. 2022 CALIFORNIA RESIDENTIAL CODE8. 2022 CALIFORNIA FIRE CODE


COVER SHEET DE \simeq S Date: 09/27/23 1" = 60' Scale: Drawn: 3007.02 Sheet:


REVISIONS


RESPONSE TO SCC
COMMENTS 11/05/21


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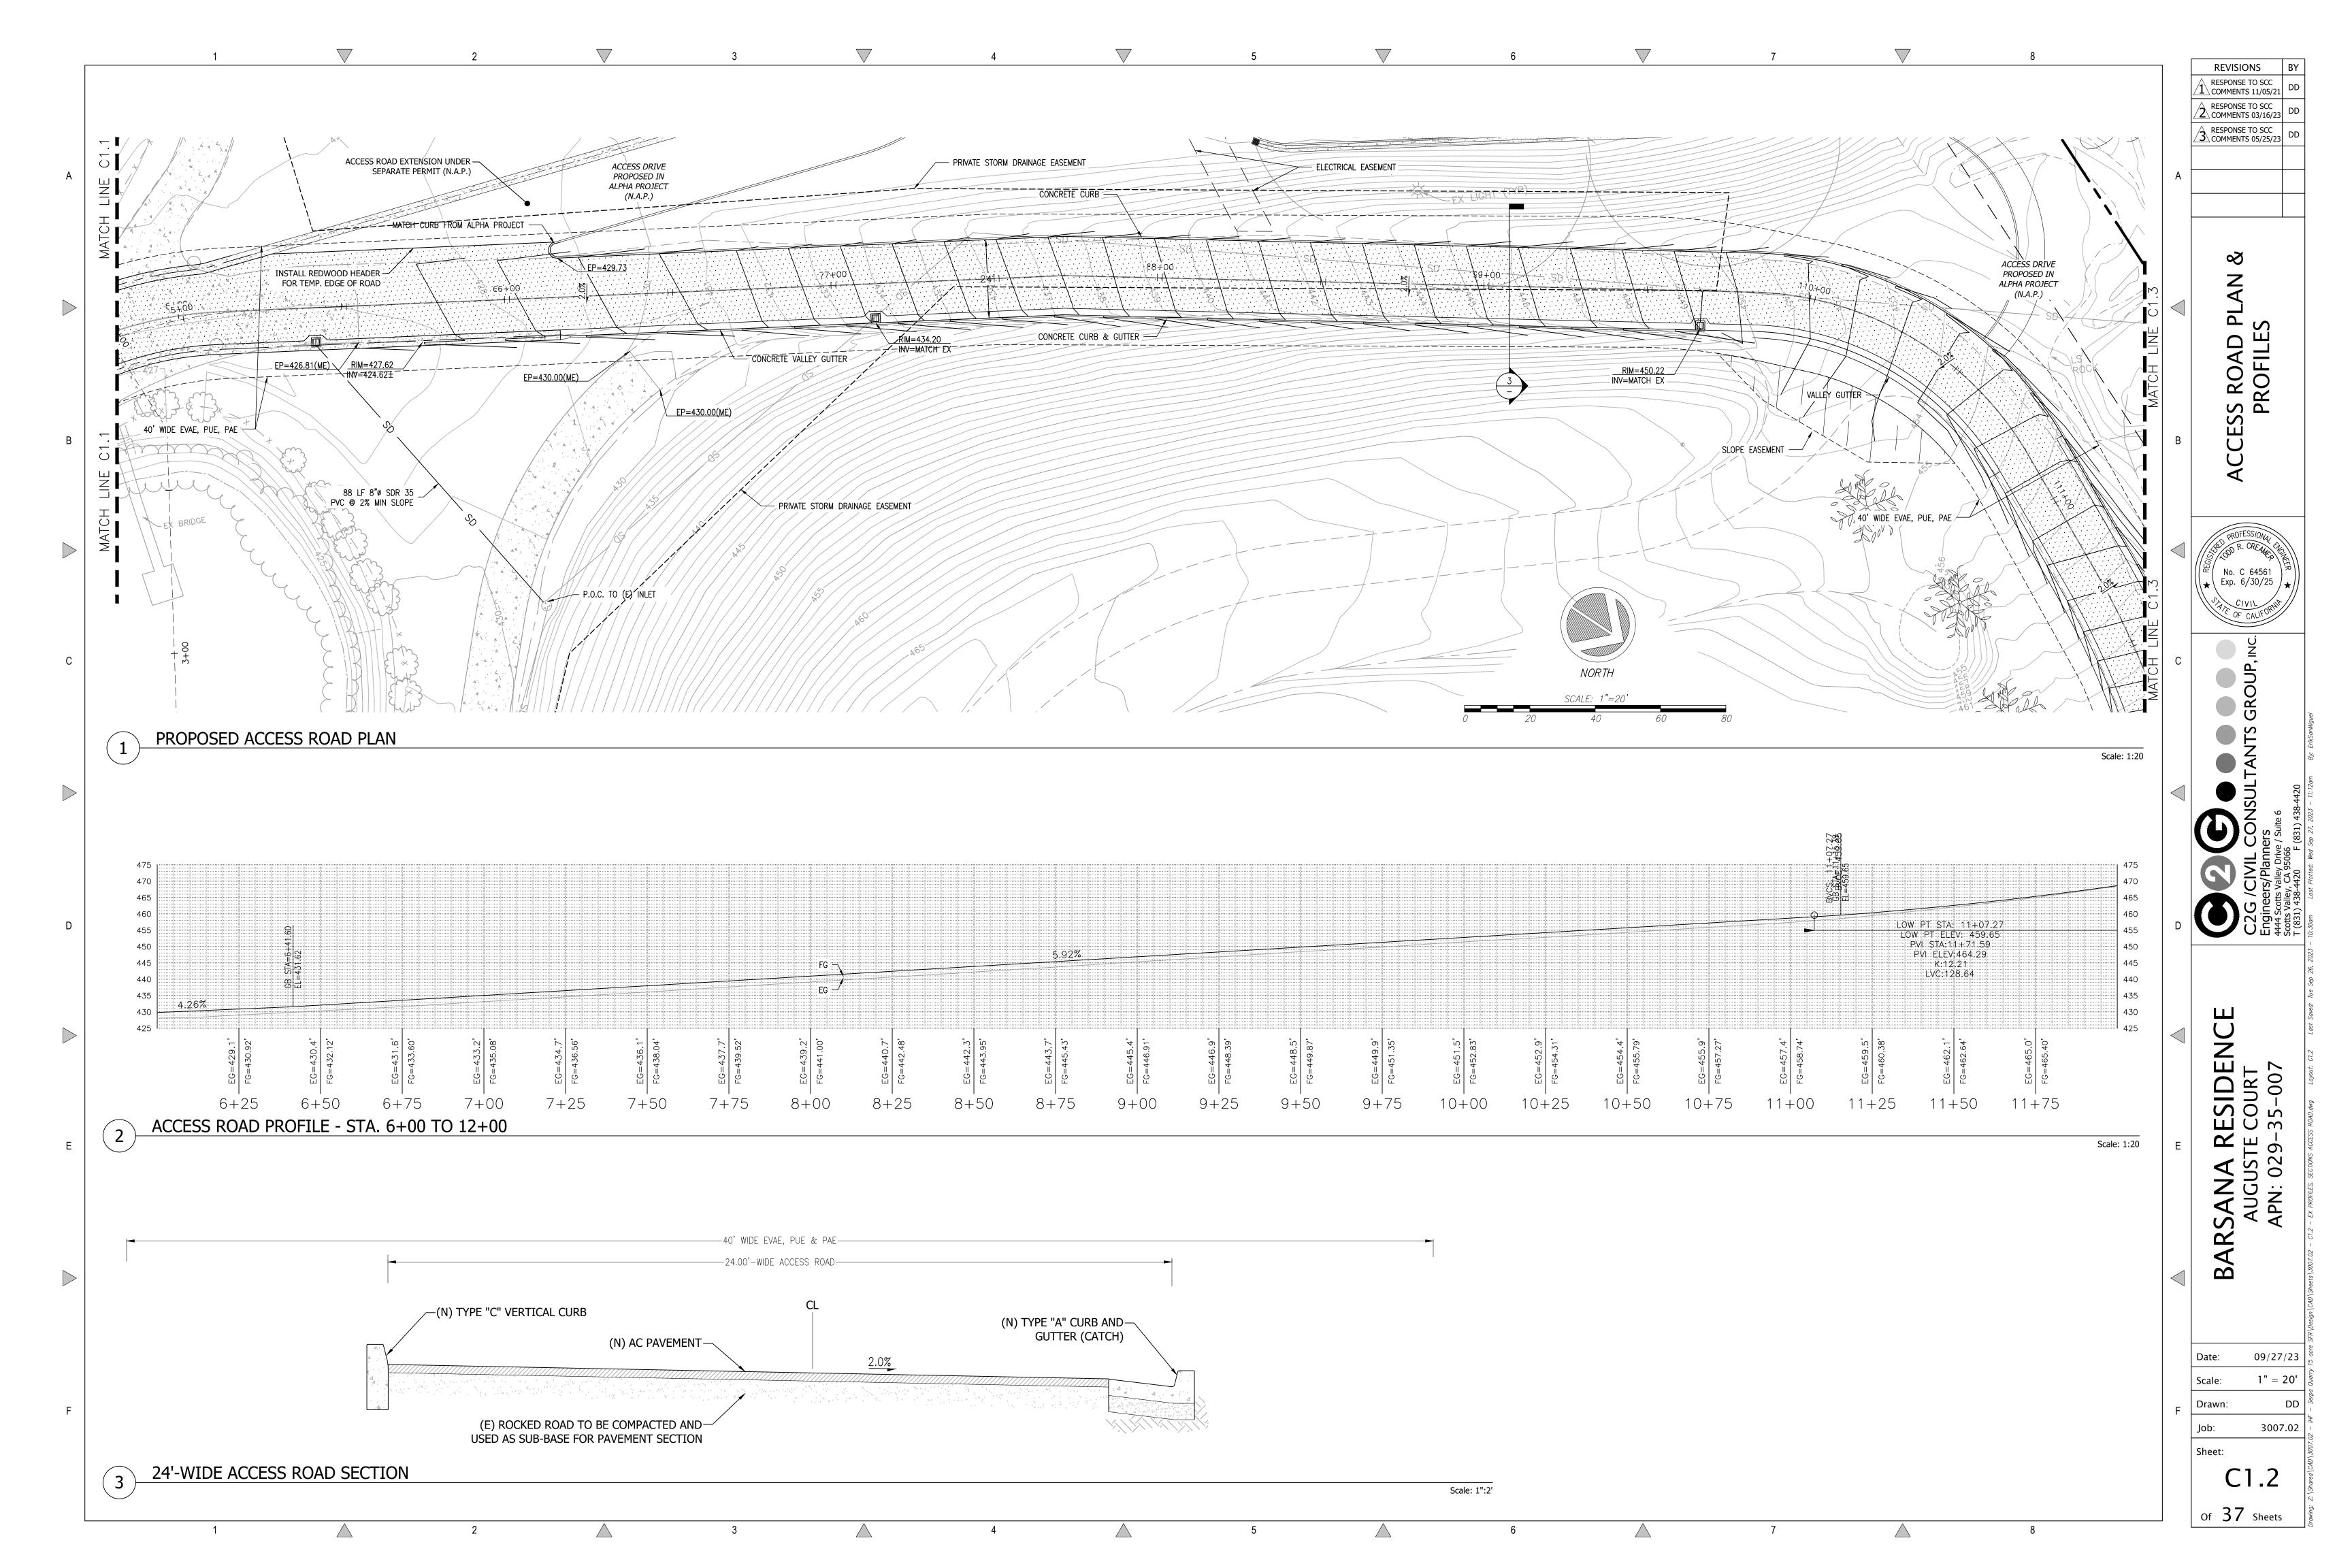
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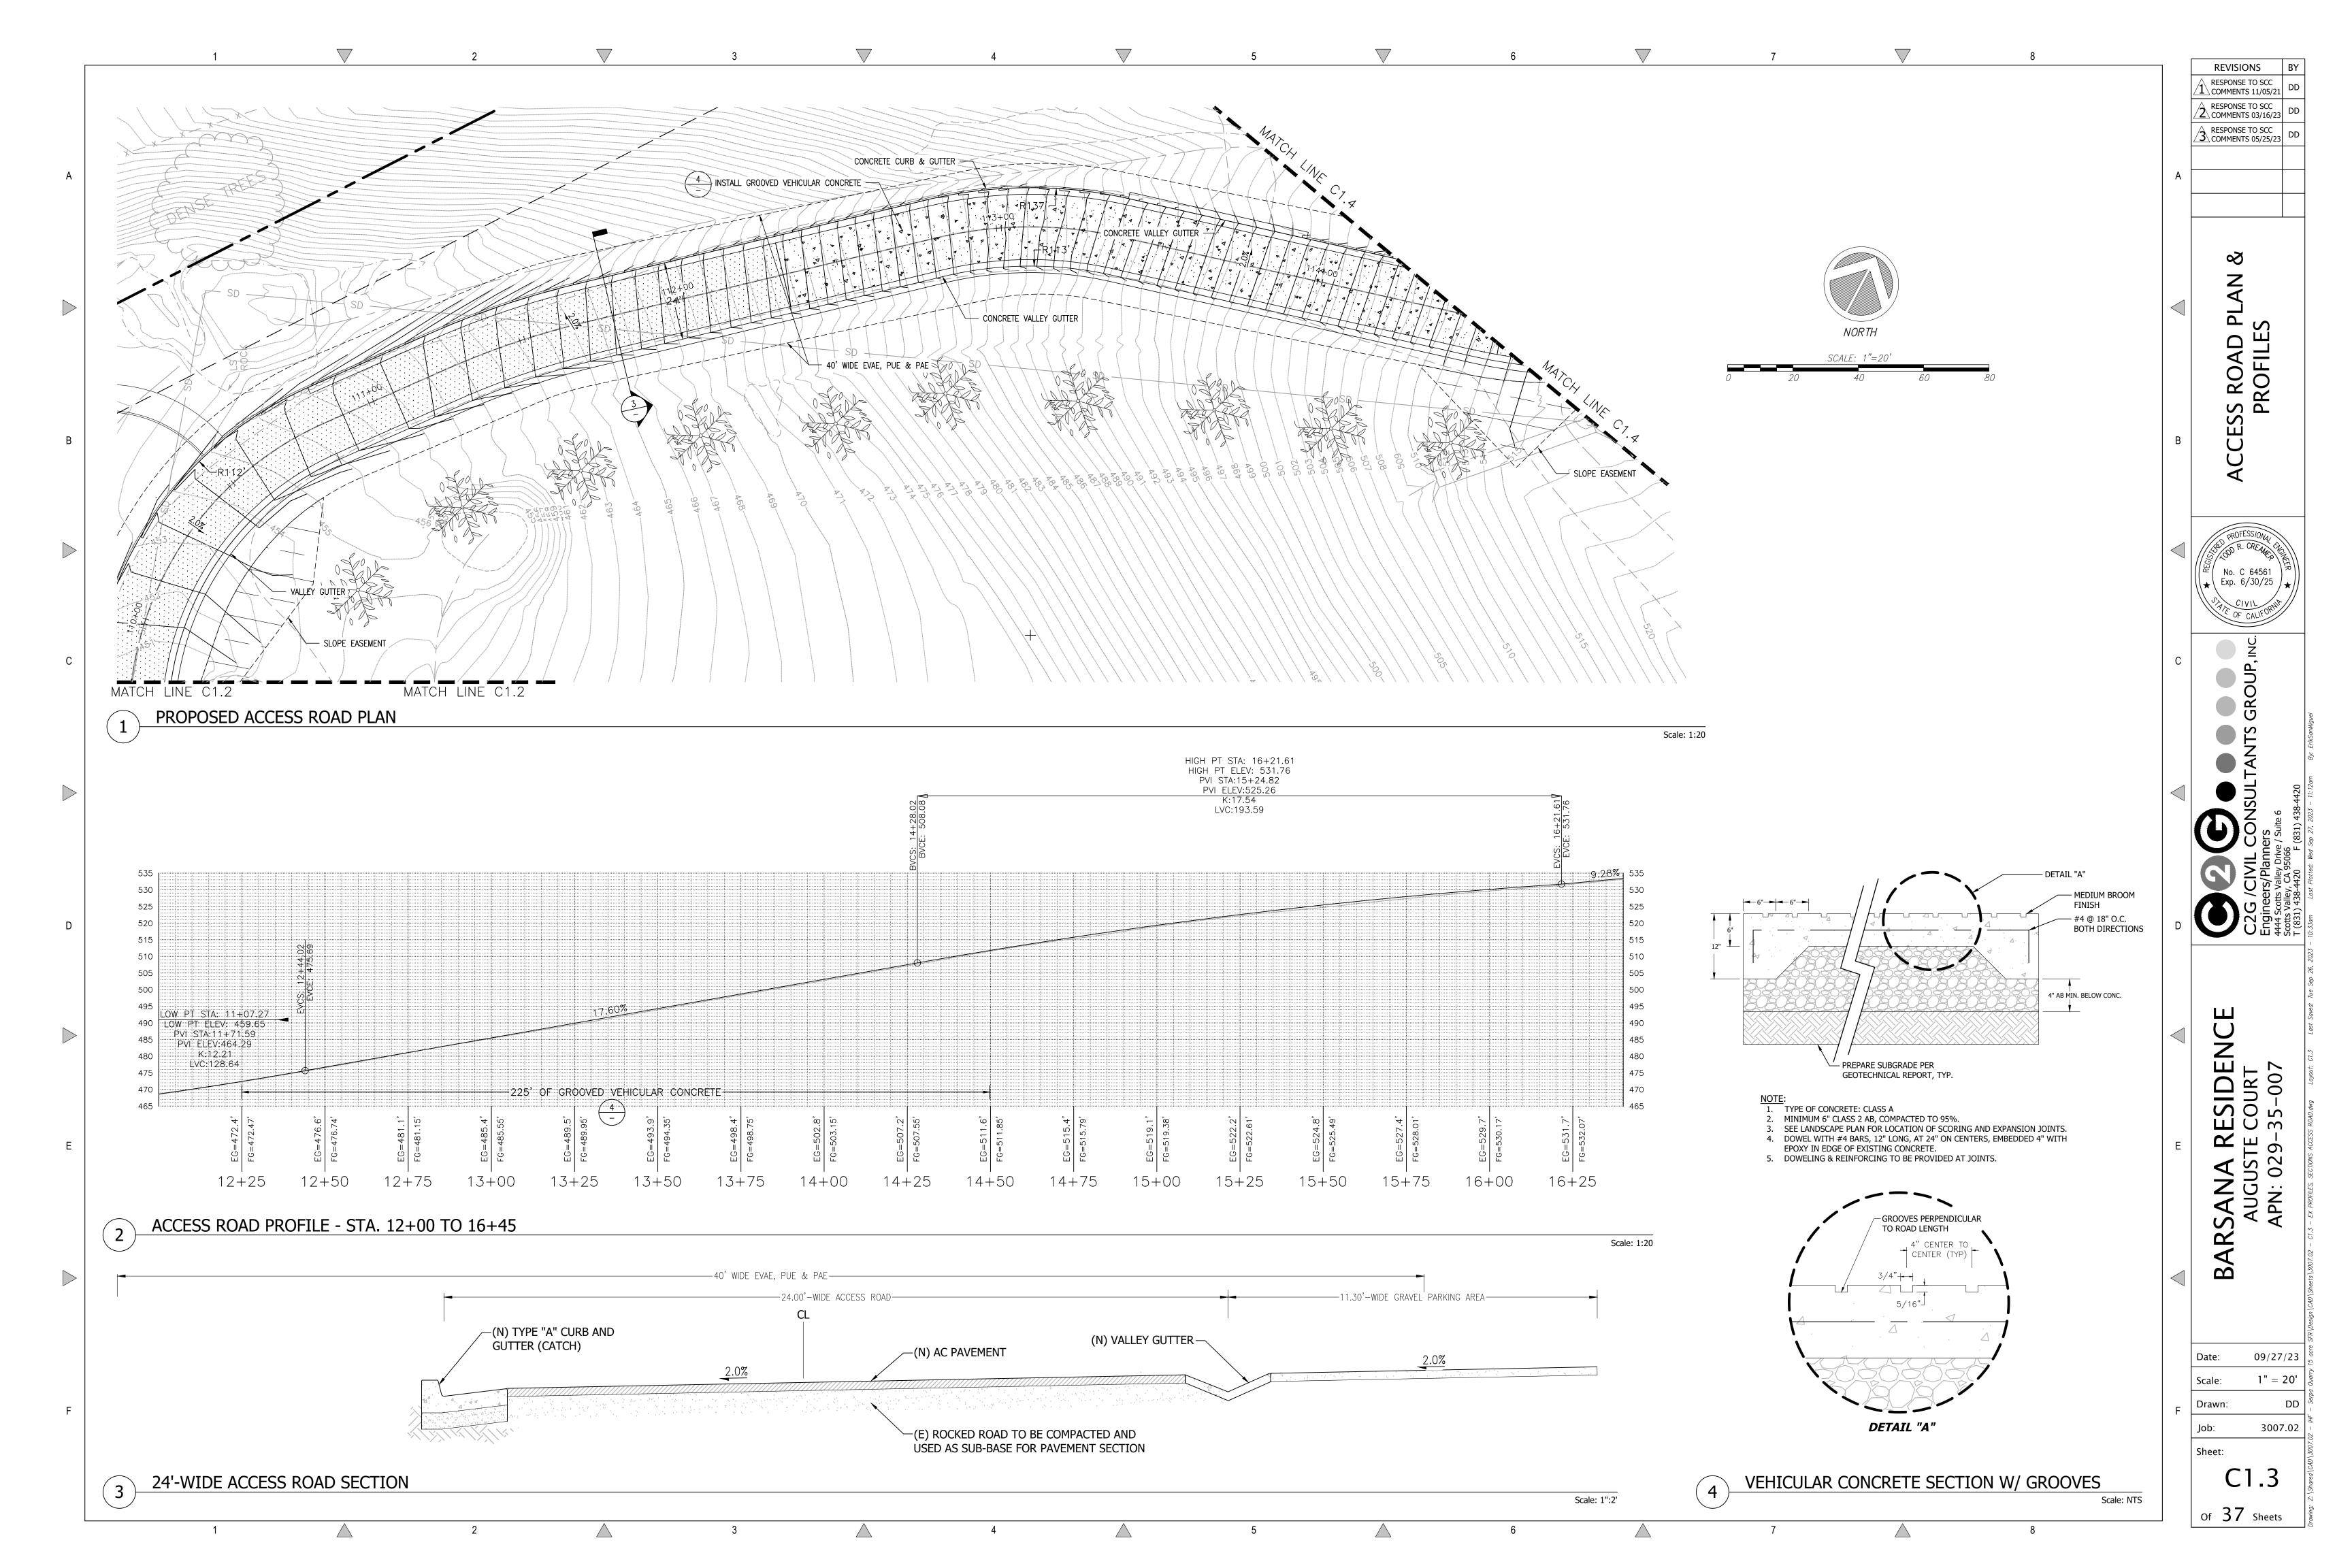





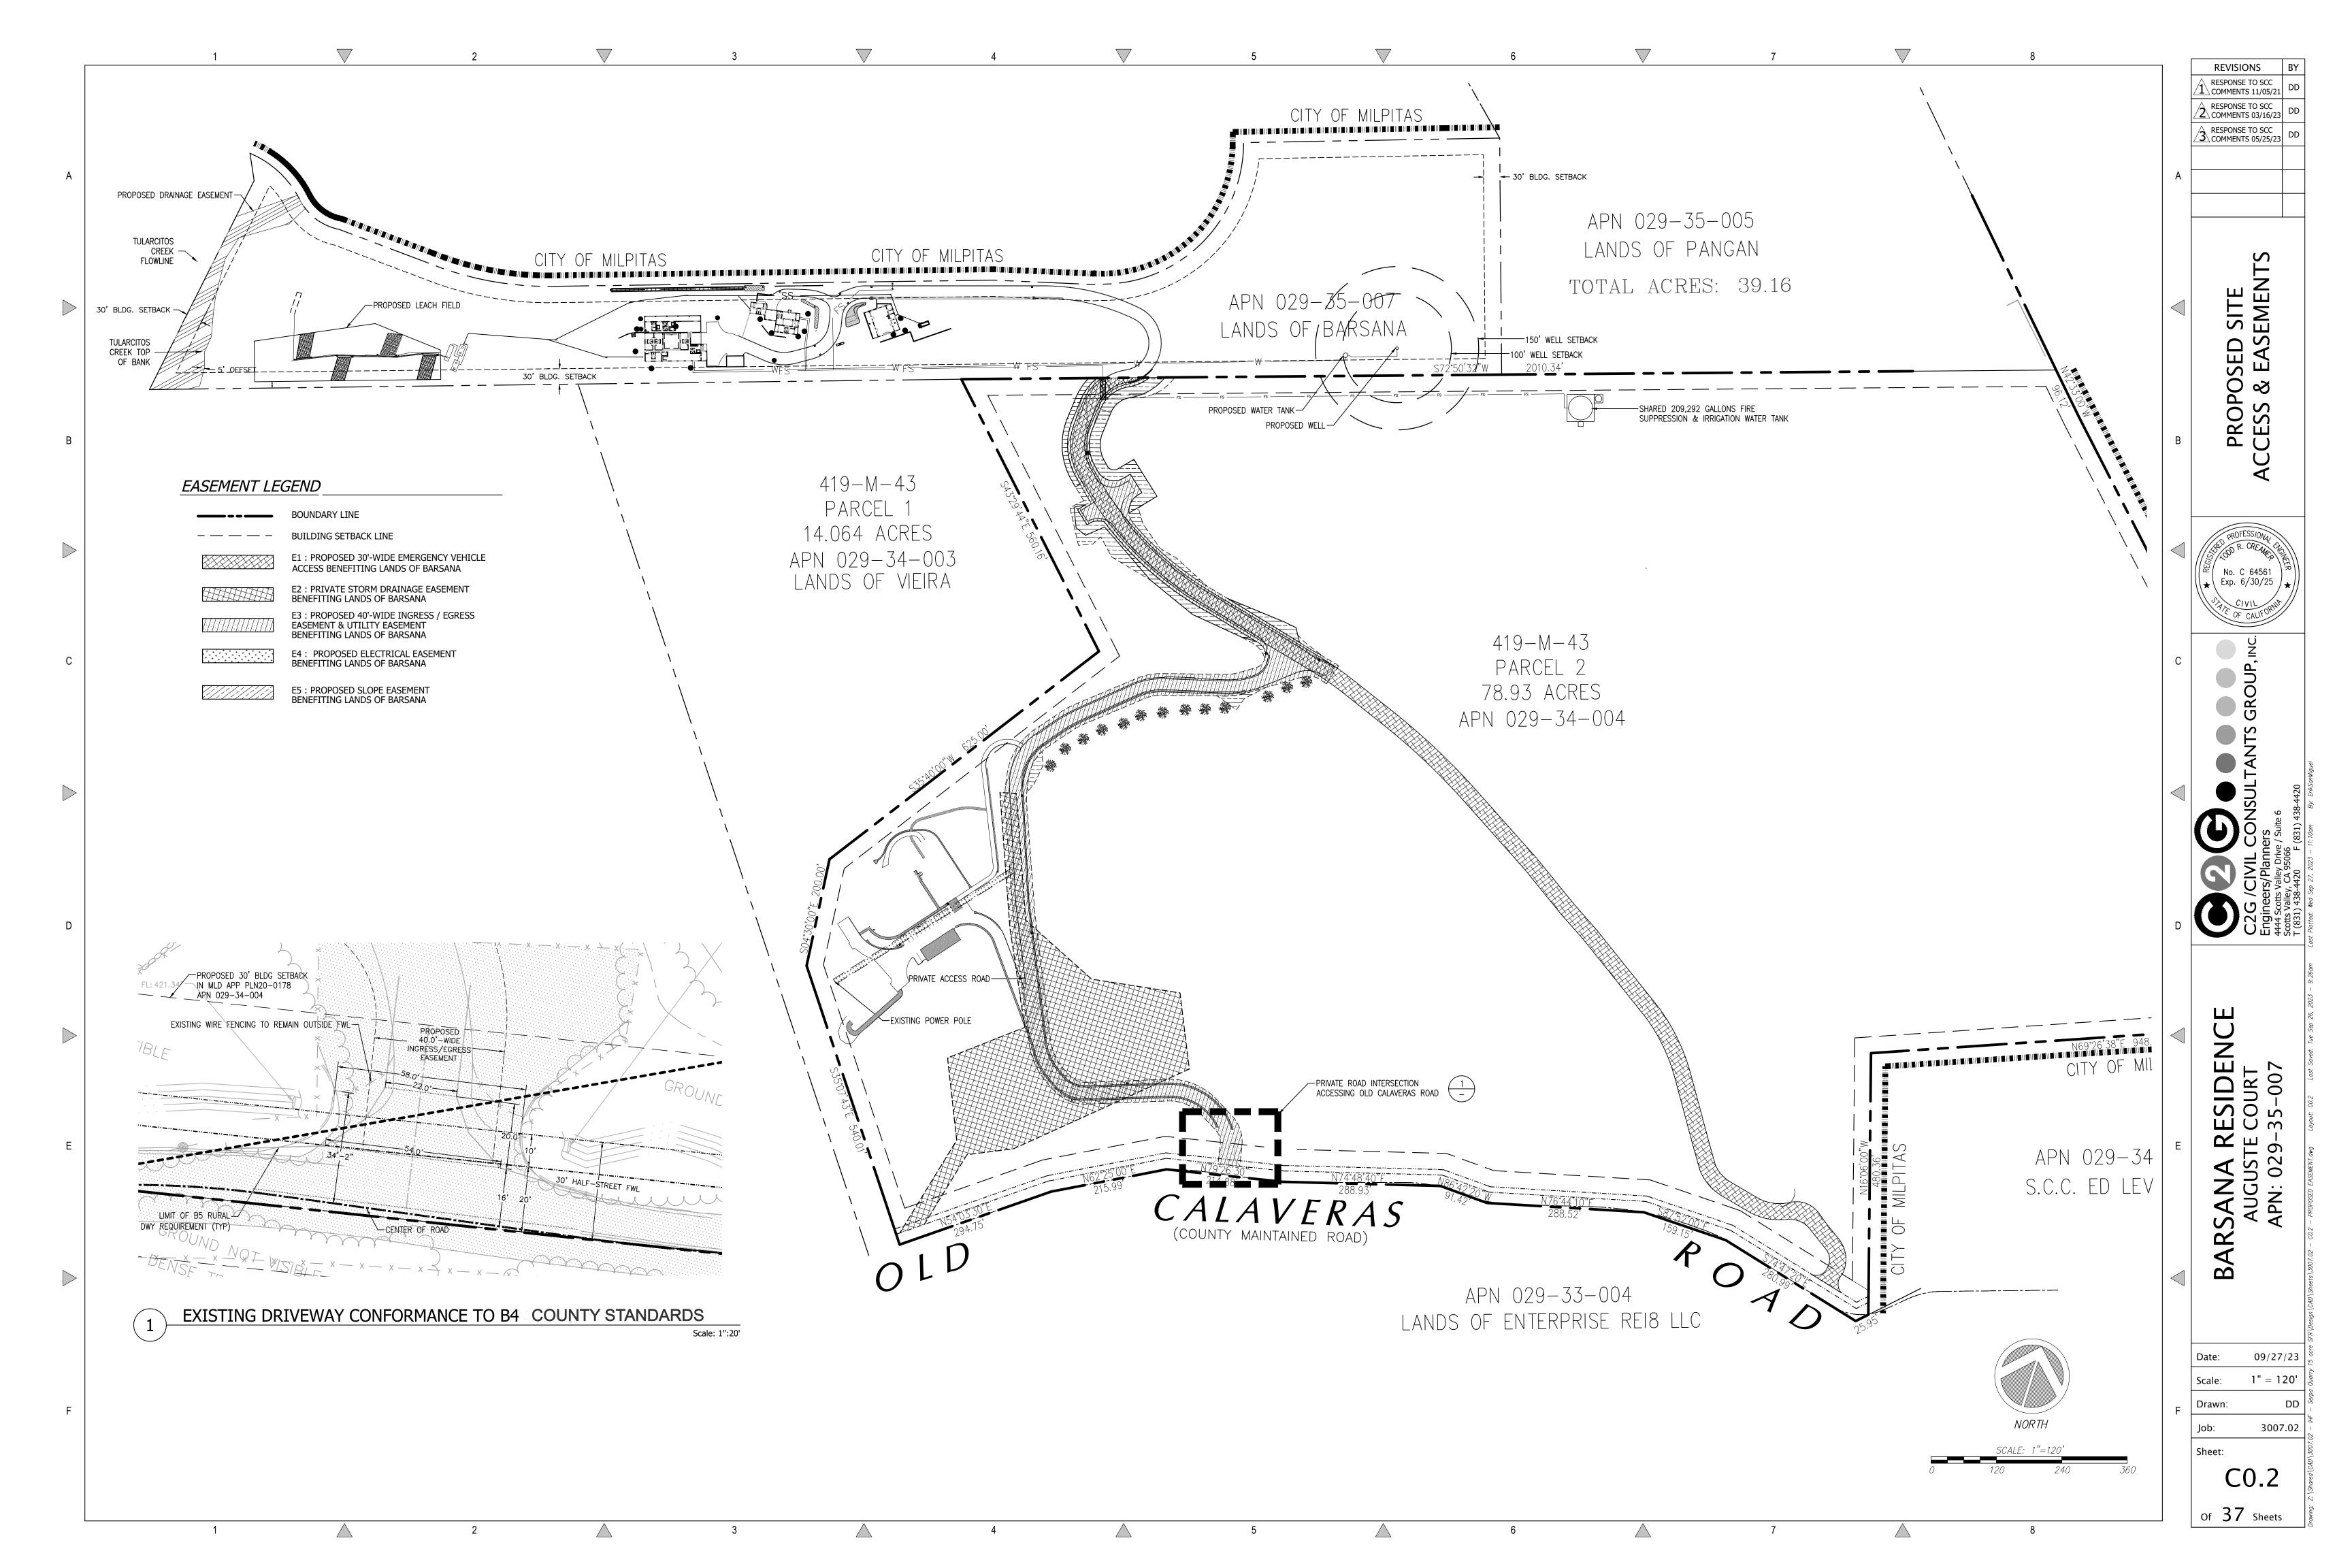


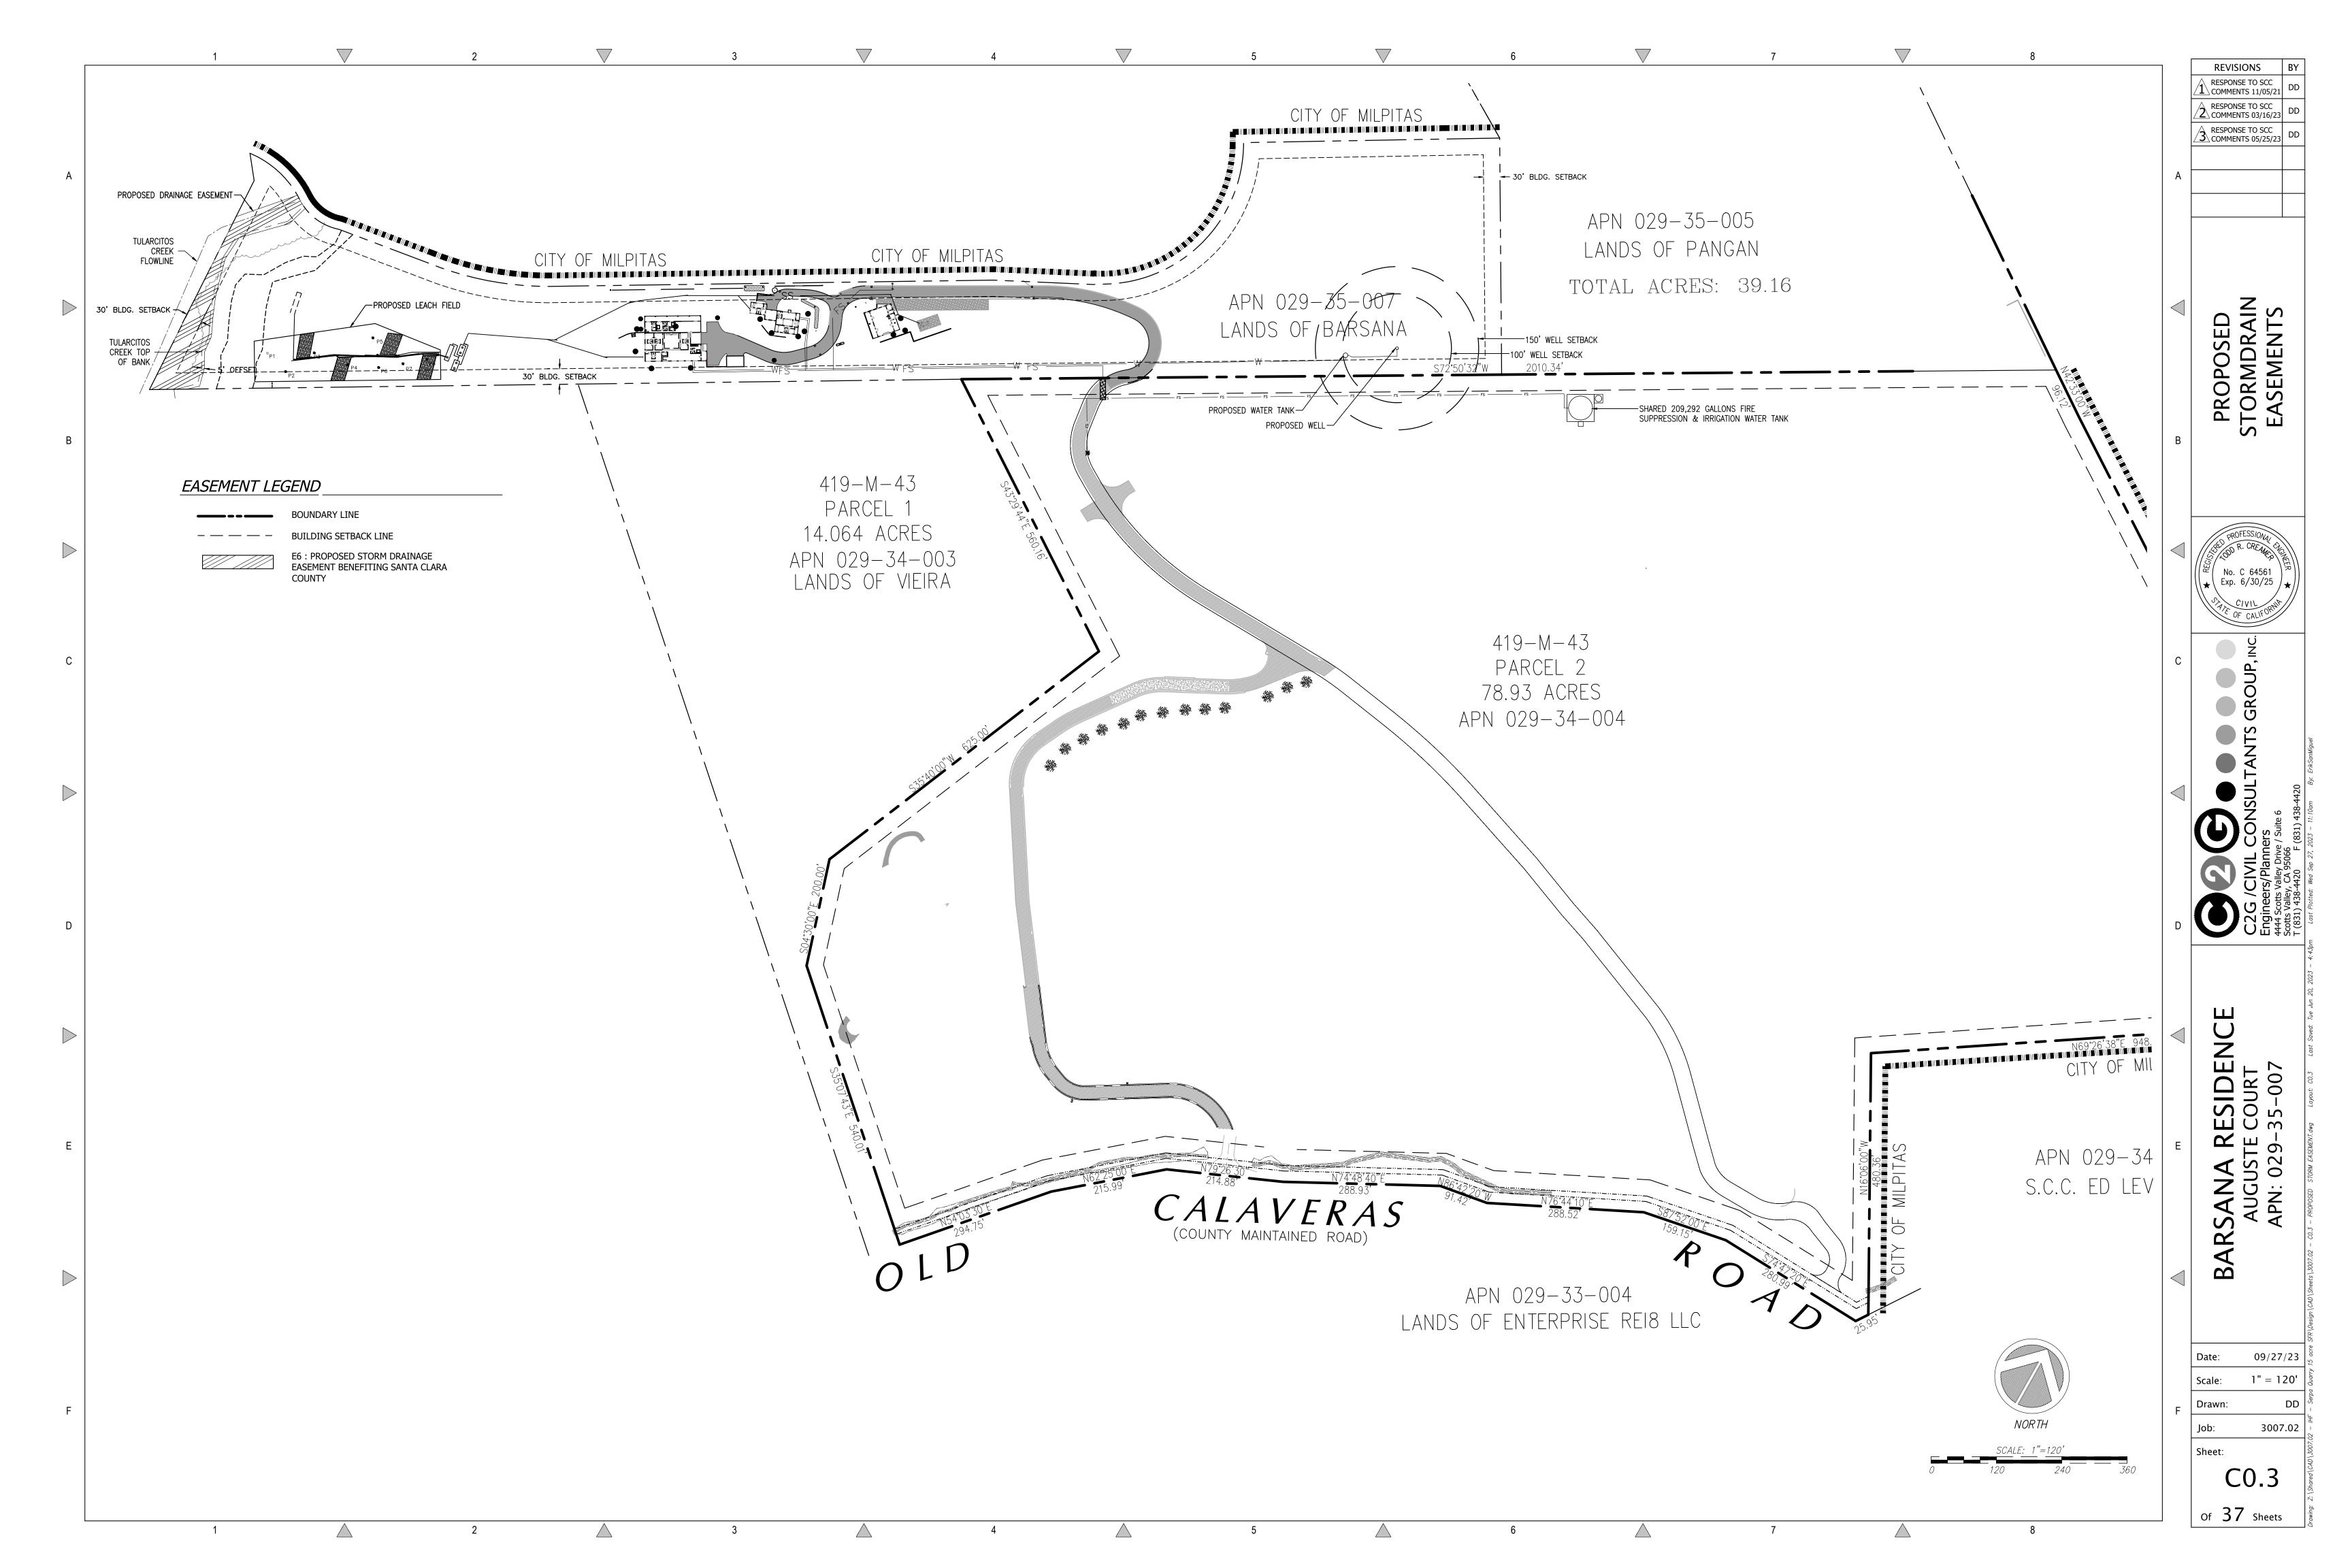


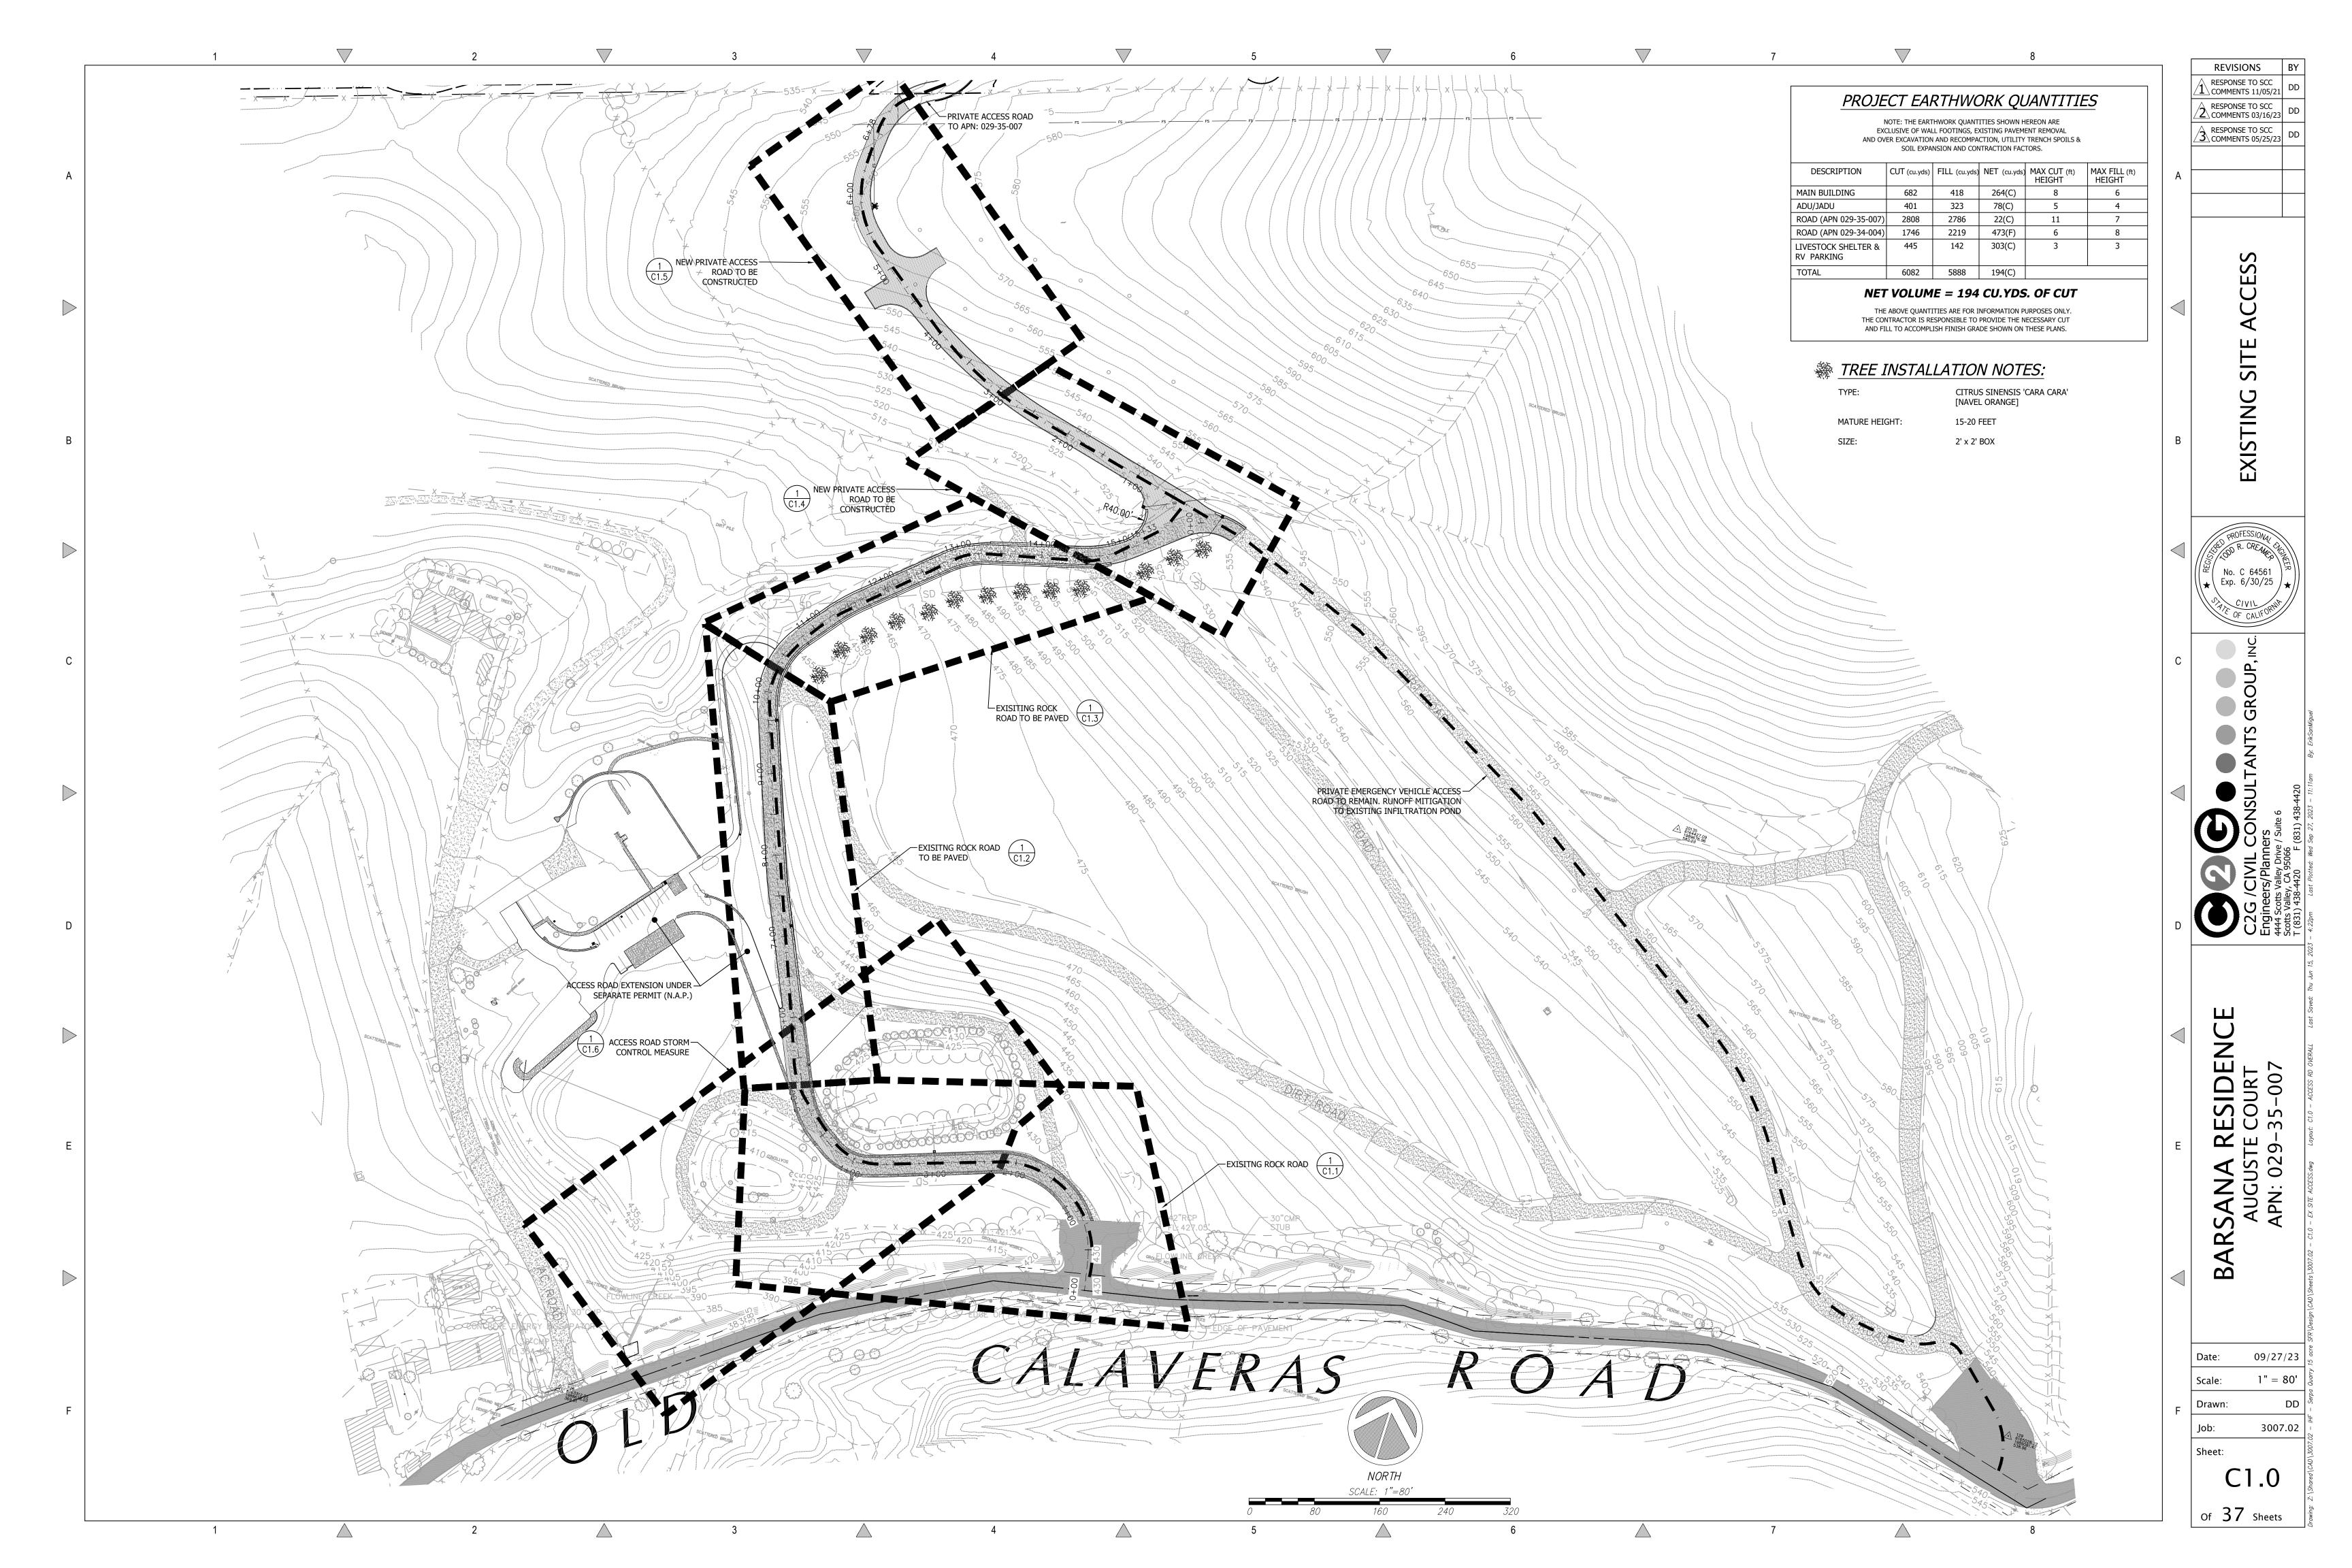

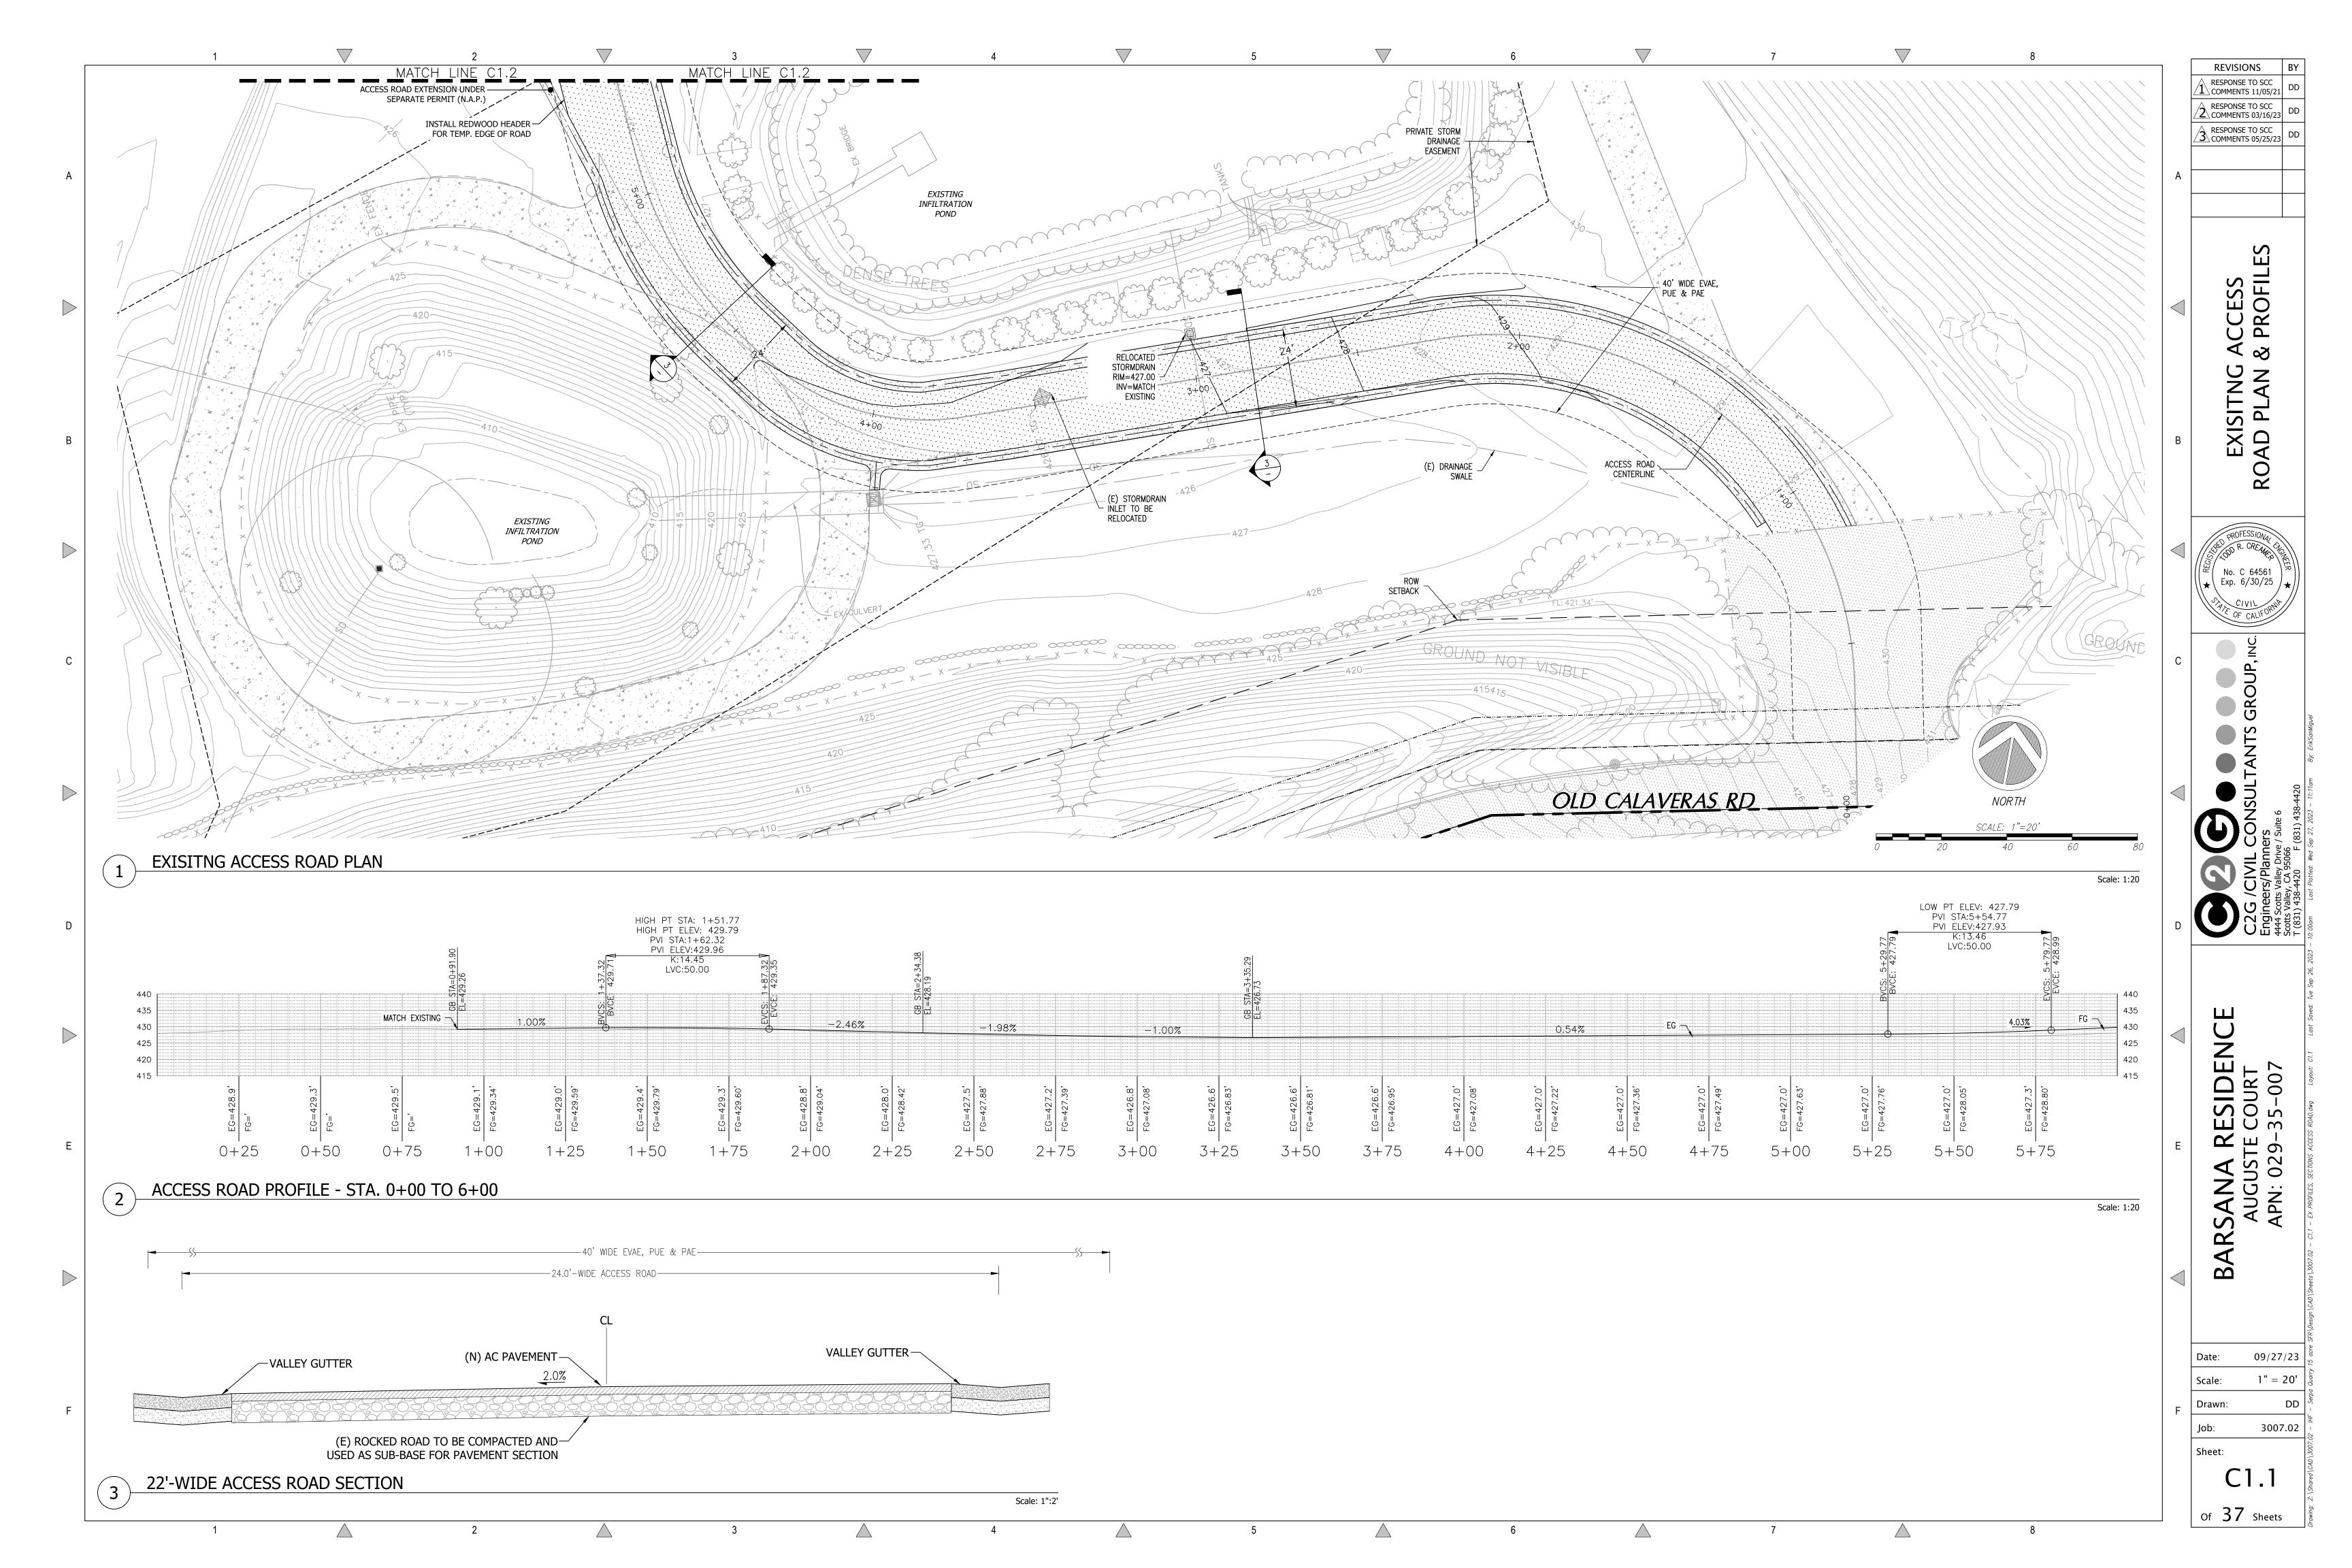

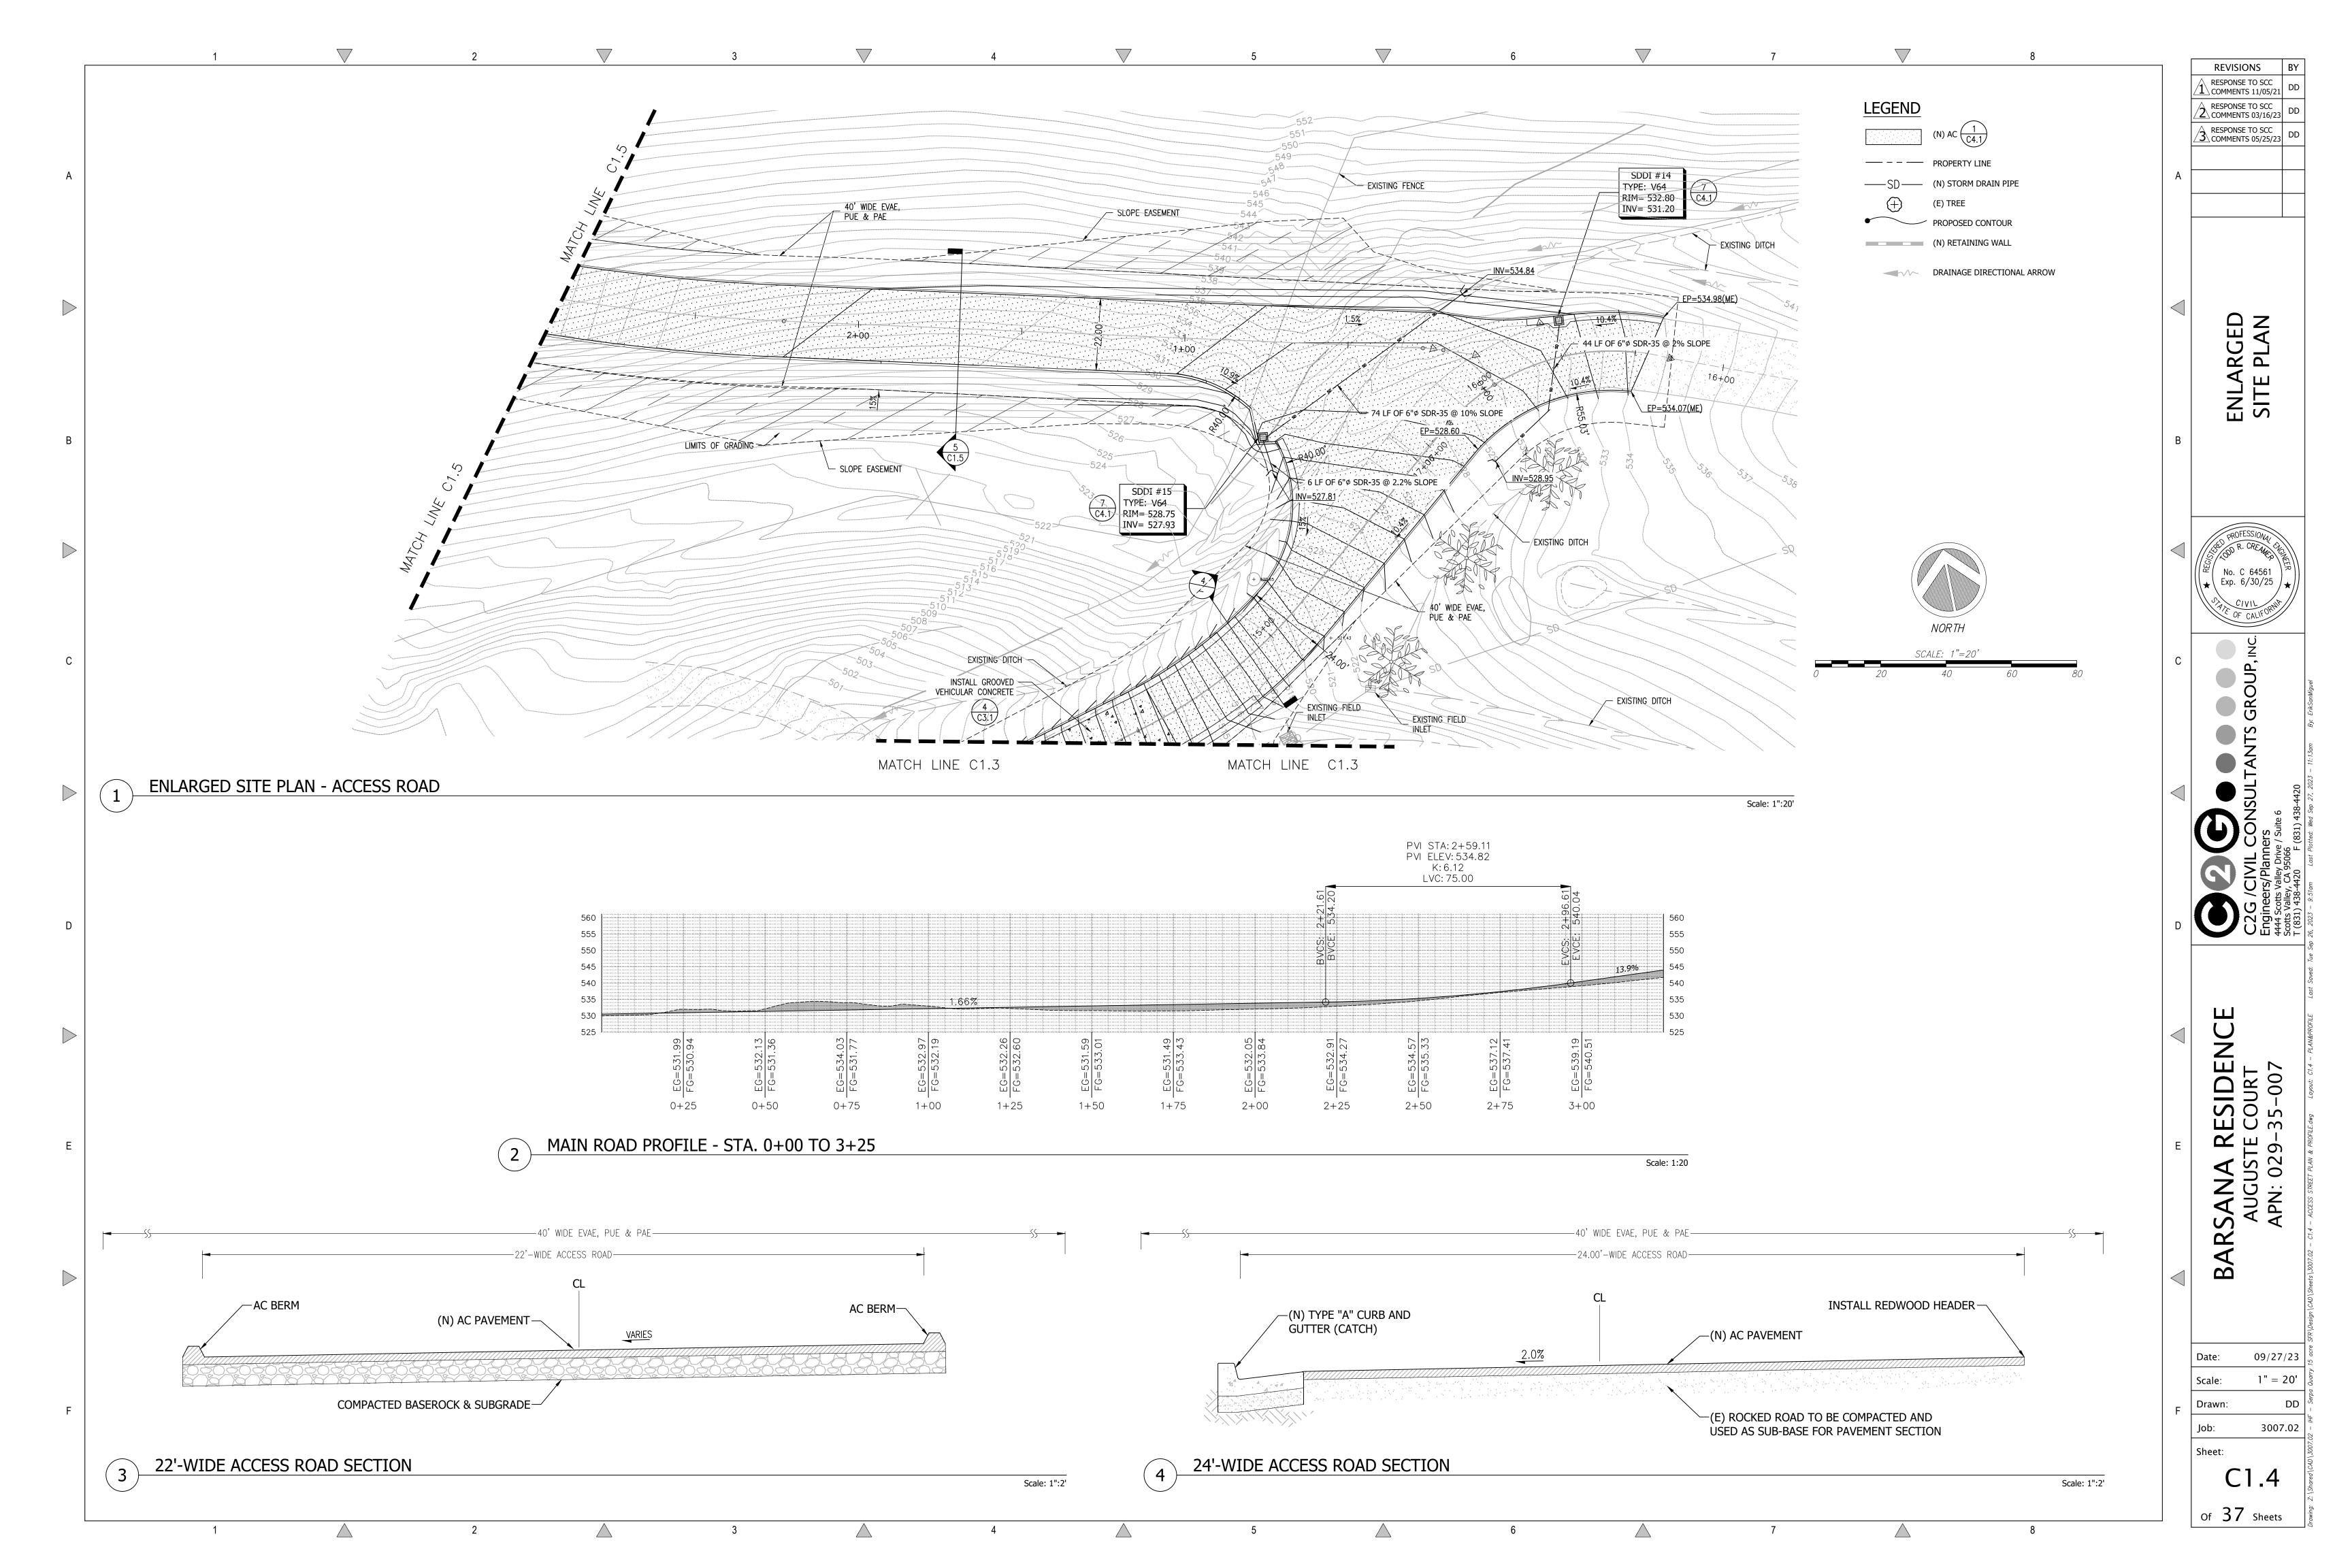

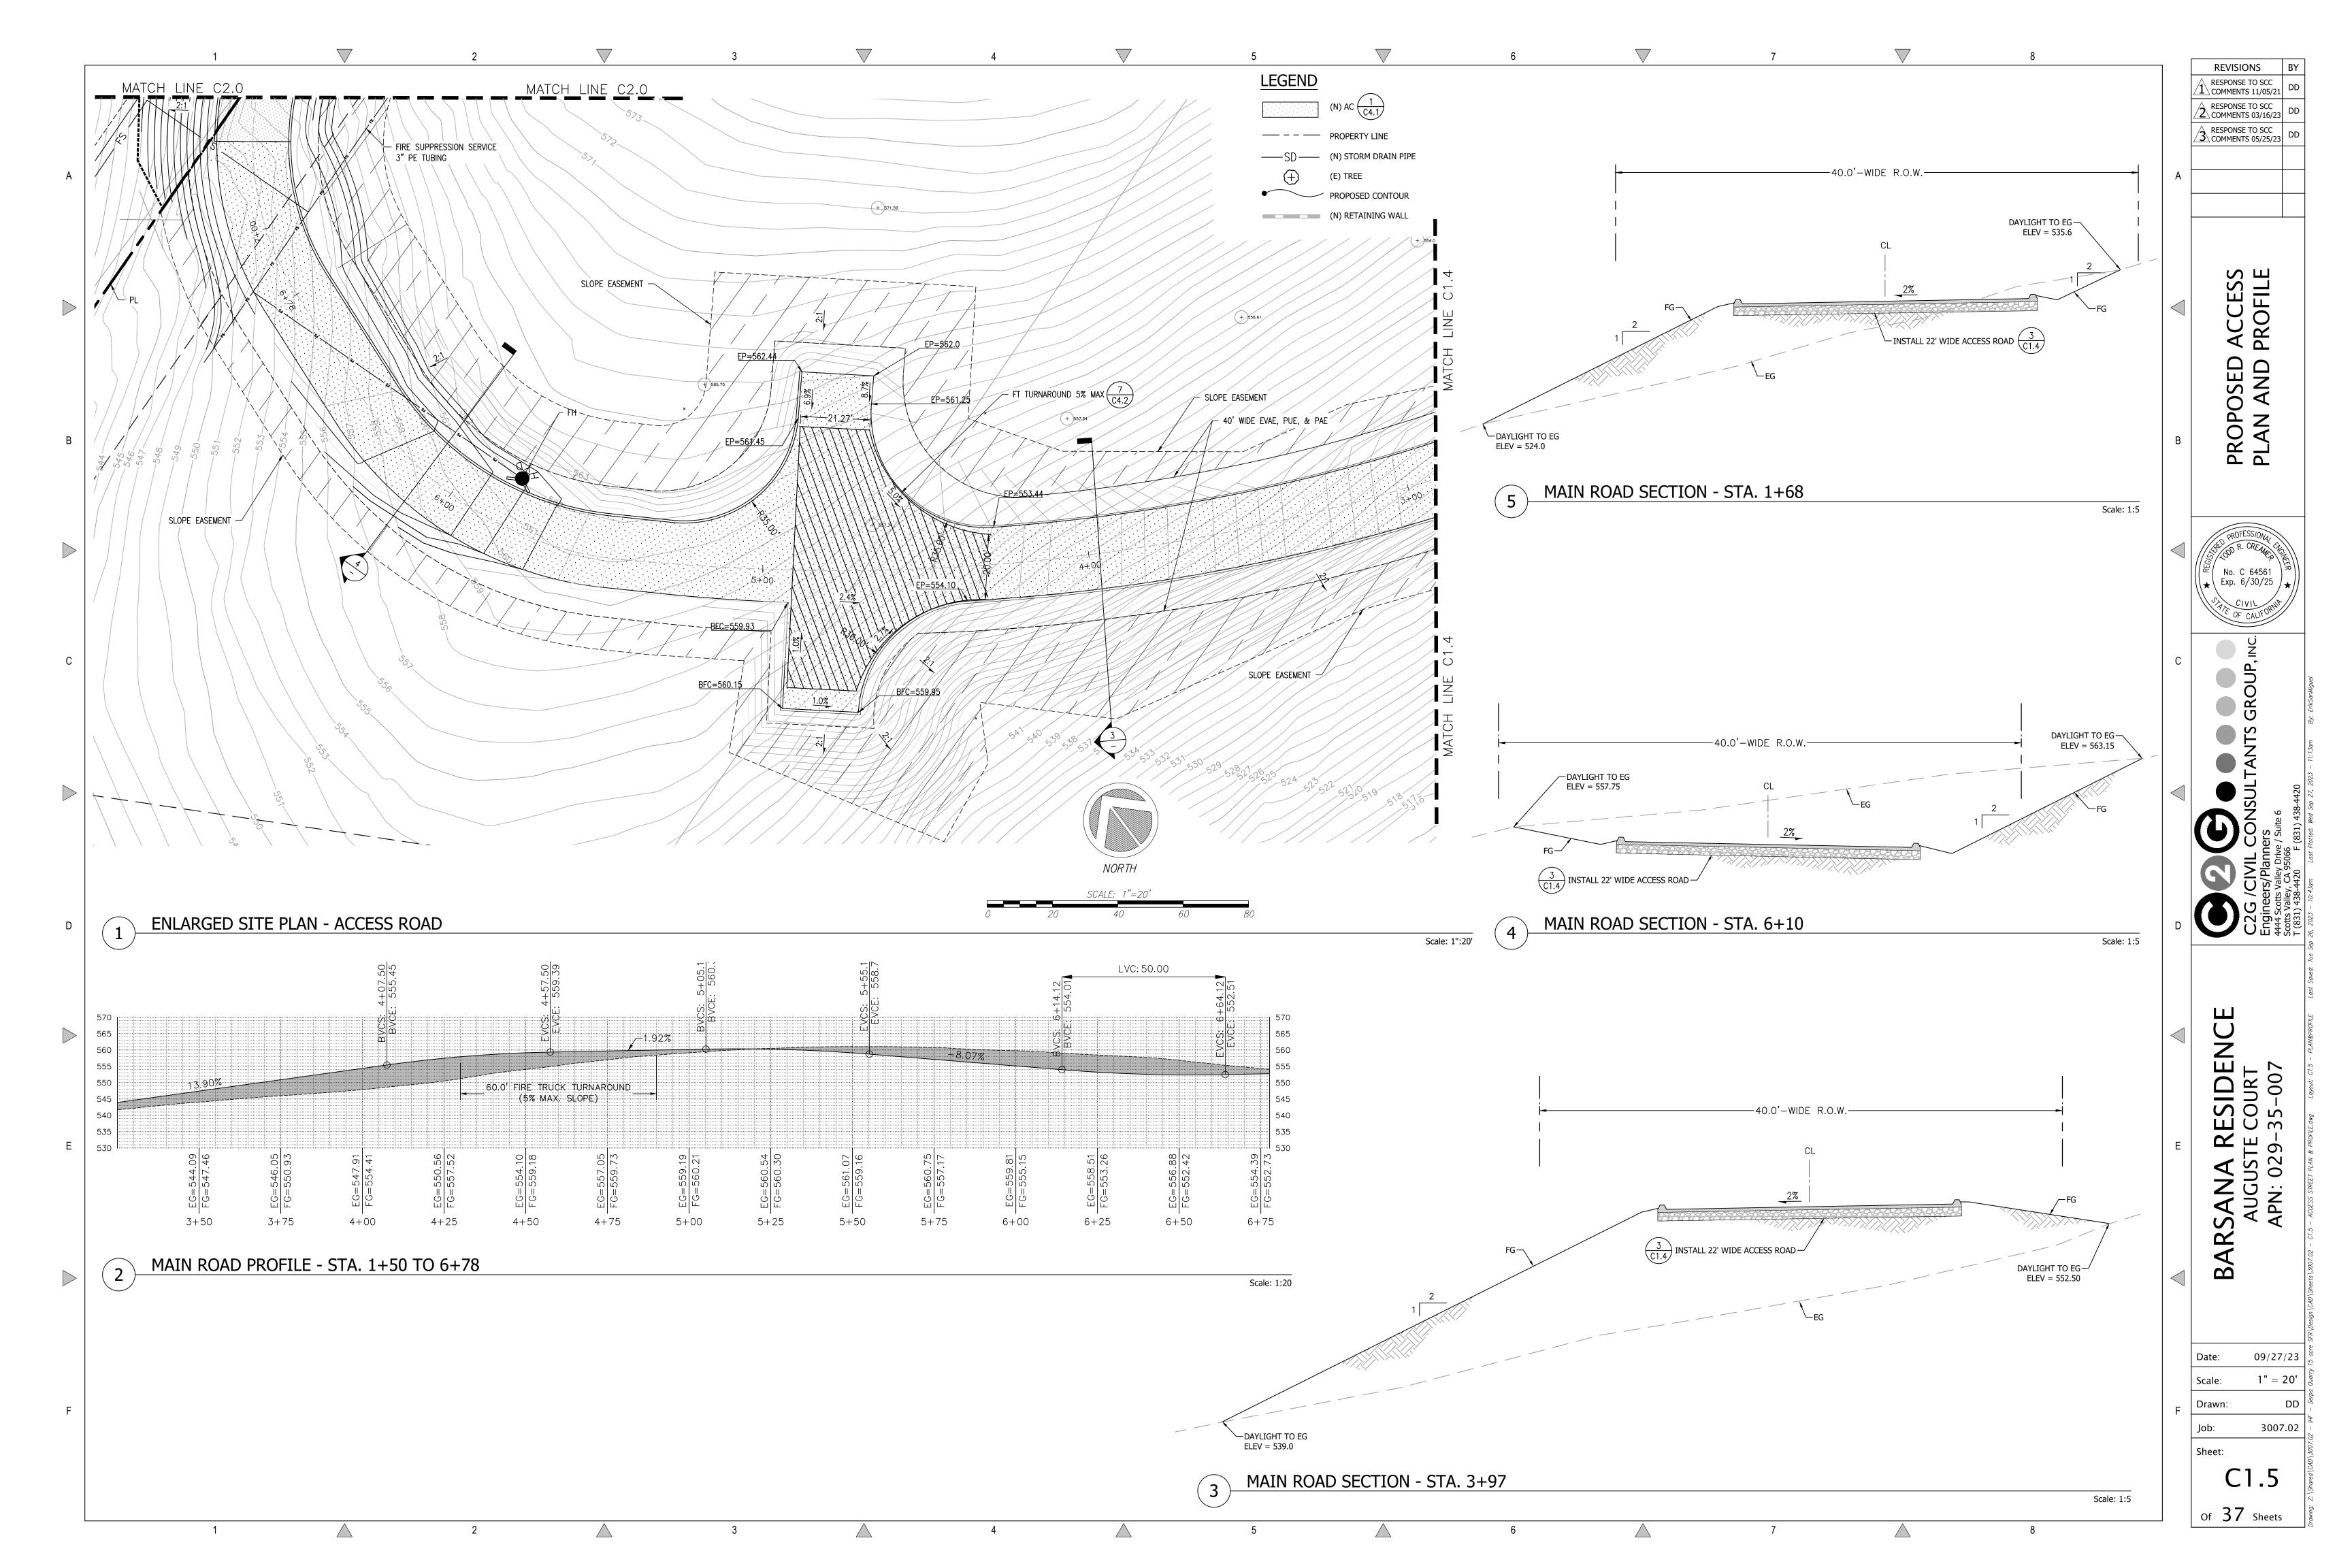

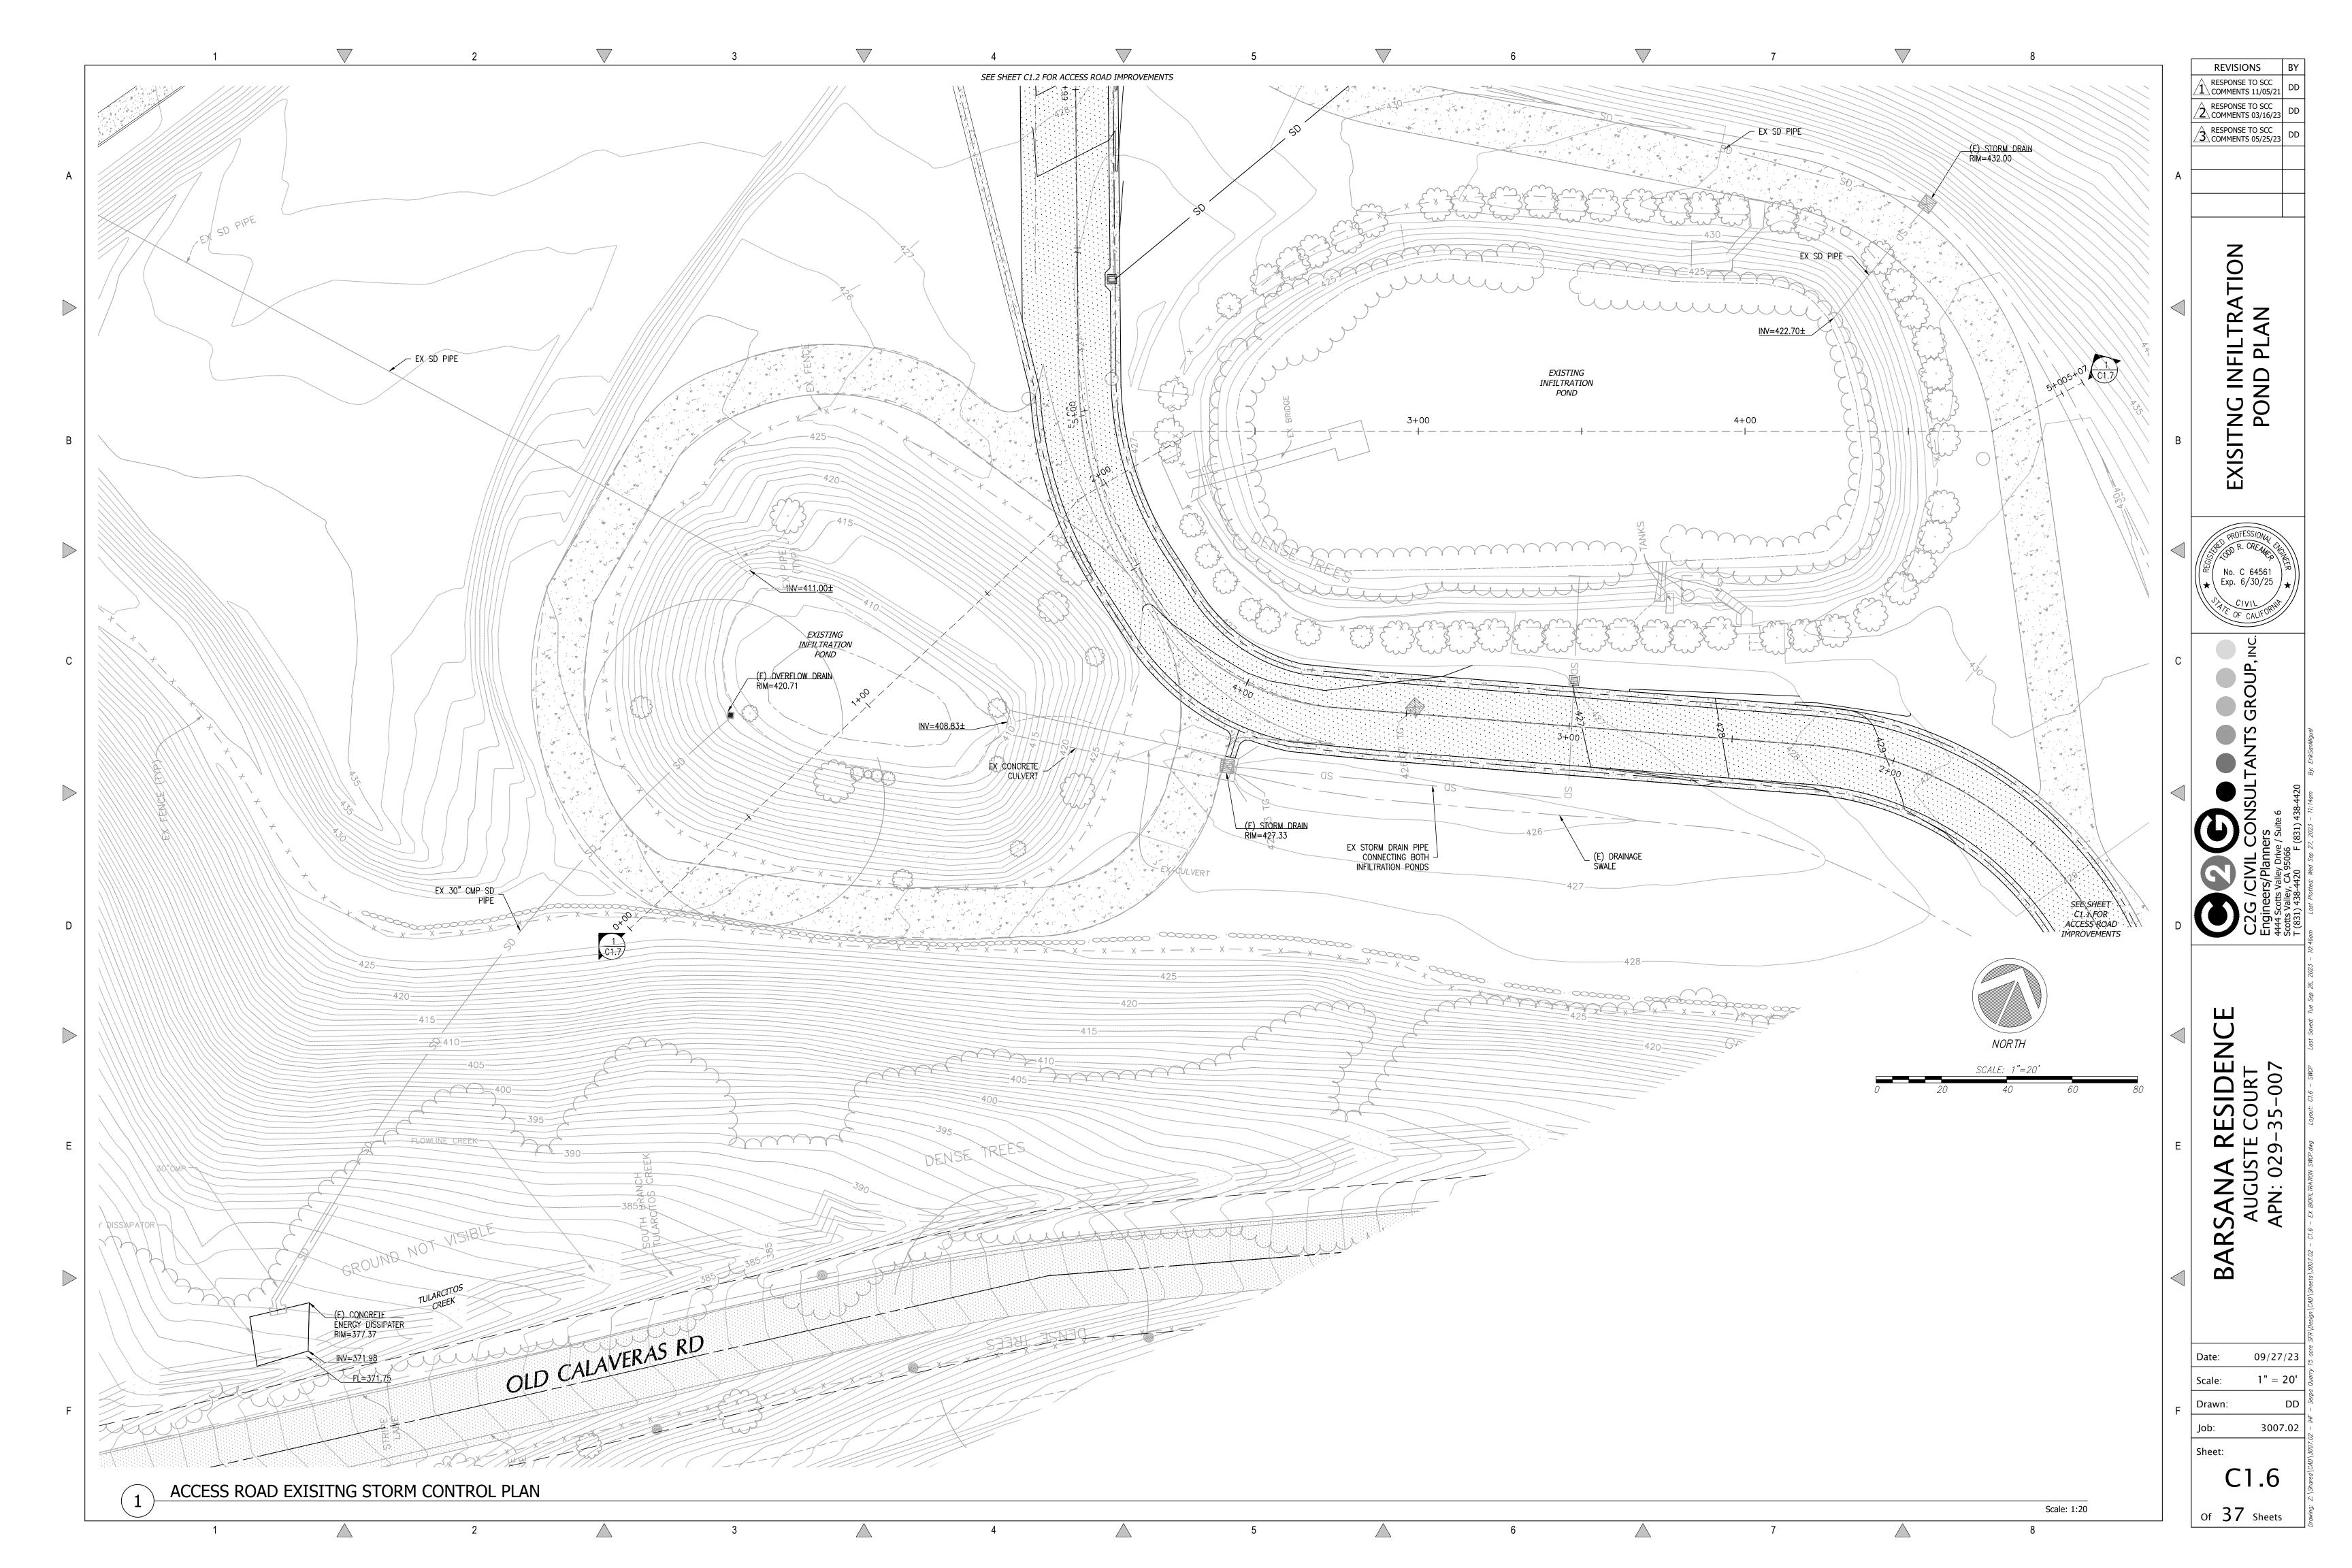

LOWEST POINT @ TOP OF BANK OF INFILTRATION POND AREA LOWEST POINT @ TOP OF -LOWEST POINT @ TOP OF BANK-OF RETENTION POND BANK OF RETENTION POND ELEV = 427.00ELEV = 425.00ELEV = 425.00__EX TOP OF OVERFLOW INLET EXISTING INFILTRATION POND /--(E) WATER SURFACE 435 ELEV= 420.71± ELEV= 422.00 (E) GRAVEL ROAD-SD INV (IN)=422.70-430 425 AVAILABLE STORAGE-420 (92,422 CU.FT.) (E) CONNECTOR PIPE 415 CALCULATED STORAGE OF ALL PROJECTS-410 EL = 410,51 5+25 3+00 0 + 754+00

EXISTING INFILTRATION POND, DRAIN AND OVERFLOW STRUCTURE

BARSANA (15-ACRE LOT) SFH PROJECT

IMPERVIOUS AREA IN APN 029-34-	004		
DESCRIPTION	AREA (SQ. FT.)	AREA (ACRES)	EQUIVALENT AREA (ACRES)
NEW ASPHALT ROAD	18,780	0.431	0.431
NOTE: EXISTING GRAVEL ROAD TO 2022 RECLAMATION PLAN AMEND 5+50 TO 15+26			

GOKULAM BUILDING PERMIT FOR LIVESTOCK SHELTERS

SHED 1: DEV22-3196 SHED 2: DEV22-3201 DEV22-3202 DEV22-3206 DEV22-3207 STORAGE 1: STORAGE 2:

IMPERVIOUS AREA					
DESCRIPTION	SQ. FT.	ACRES			
ROOF	738	0.0169			
CONC.	485	0.0111			
TOTAL	1223	0.0281			

GOKULAM WATER TANK IMPROVEMENT PROJECT

DEV23-0115					
IMPERVIOUS AREA					
DESCRIPTION	SQ. FT.	ACRES			
WATER TANK	1998	0.0459			
CONC.	699	0.0160			
TOTAL	2697	0.0619			

GOKULAM LIVESTOCK SHELTER ACCESS ROAD AND PARKING

FUTURE CARPORT FOR THE UTILITY VEHICLE APPROVED UNDER PLN20-125 FUTURE LIVESTOCK SHELTER APPROVED UNDER PLN20-125 FUTURE FEE STORAGE SHED APPROVED UNDER PLN20-125 FUTURE AGRICULTURAL SHED APPROVED UNDER PLN20-125

NEW IMPERVIOUS AREA					
DESCRIPTION	ACRES				
ROOF	5803	0.1332			
AC	37307	0.8565			
CONC.	8728	0.2004			
TOTAL	51838	1.1900			

GOKULAM SMALL SCALE PERMANENT AGRICULTURAL EMPLOYEE HOUSING

NEW IMPERVIOUS AREA					
DESCRIPTION	AREA (SF)	ACRES			
BUILDING & GARAGE	1849	0.0424			
CONCRETE DRIVEWAY	372	0.0085			
ASPHALT ROAD	571	0.0131			
CONCRETE WALKWAYS	413	0.0095			
TOTAL (N) IMPERVIOUS AREA	3205	0.0736			
EXISTING IMPERVIOUS AREA TBR	0	0.0000			
NET INCREAS OF IMPERVIOUS AREA	3205	0.0736			

5/3/2023							
All Projects		l		l	<u> </u>	<u> </u>	<u> </u>
	isting retentio	n pond					
	MAP (inches) =	30				CPOST =	0.90
	DMA Area (sf) =	78192				CPRE =	
	Imp. Area (sf)=	78192				01112	0.23
		70132					
	length (ft)=	71				Void Space=	1
Prop. Struct. =	width (ft)=	71			Infi	It Rate (in/hr)=	5
Struct. =	depth (ft) =	6.00					
T (min)	100-Yr Depth (in)	Intensity (in/hr)	Peak Flow (CFS)	Volume In (CU.FT.)	Volume Out (CU.FT.)	Soil Infiltration Rate (cfs)	Storage Vol. (Cu. Ft.)
5	0.38	4.53	7.32	2582.047	147.399	0.491	2434.649
10	0.53	3.21	5.18	3657.784	294.797	0.491	3362.986
15	0.63	2.52	4.07	4310.813	442.196	0.491	3868.617
30	0.85	1.70	2.75	5813.094	884.392	0.491	4928.703
60	1.20	1.20	1.94	8228.209	1768.783	0.491	6459.425
120	1.82	0.91	1.47	12443.414	3537.567	0.491	8905.848
180	2.38	0.79	1.28	16255.439	5306.350	0.491	10949.089
360	3.81	0.63	1.03	26055.401	10612.700	0.491	15442.701
720	5.69	0.47	0.77	38911.910	21225.400	0.491	17686.510
1440	8.12	0.34	0.55	55526.516	42450.800	0.491	13075.716
2880	10.99	0.23	0.37	75185.806	84901.600	0.491	-9715.794
5760	12.85	0.13	0.22	87890.721	169803.200	0.491	-81912.479
Depth of ne	ew runoff in po	ond (ft)=					3.51

Scale: 1" = 20'

IMPERVIOUS AREA TABULATION OF CURRENT PROJECTS

STORM WATER CALCULATION PER SANTA CLARA DESIGN MANUAL

REVISIONS BY RESPONSE TO SCC COMMENTS 11/05/21 RESPONSE TO SCC COMMENTS 03/16/23 RESPONSE TO SCC COMMENTS 05/25/23 DD


EXISTING INFILTRATION POND PLAN





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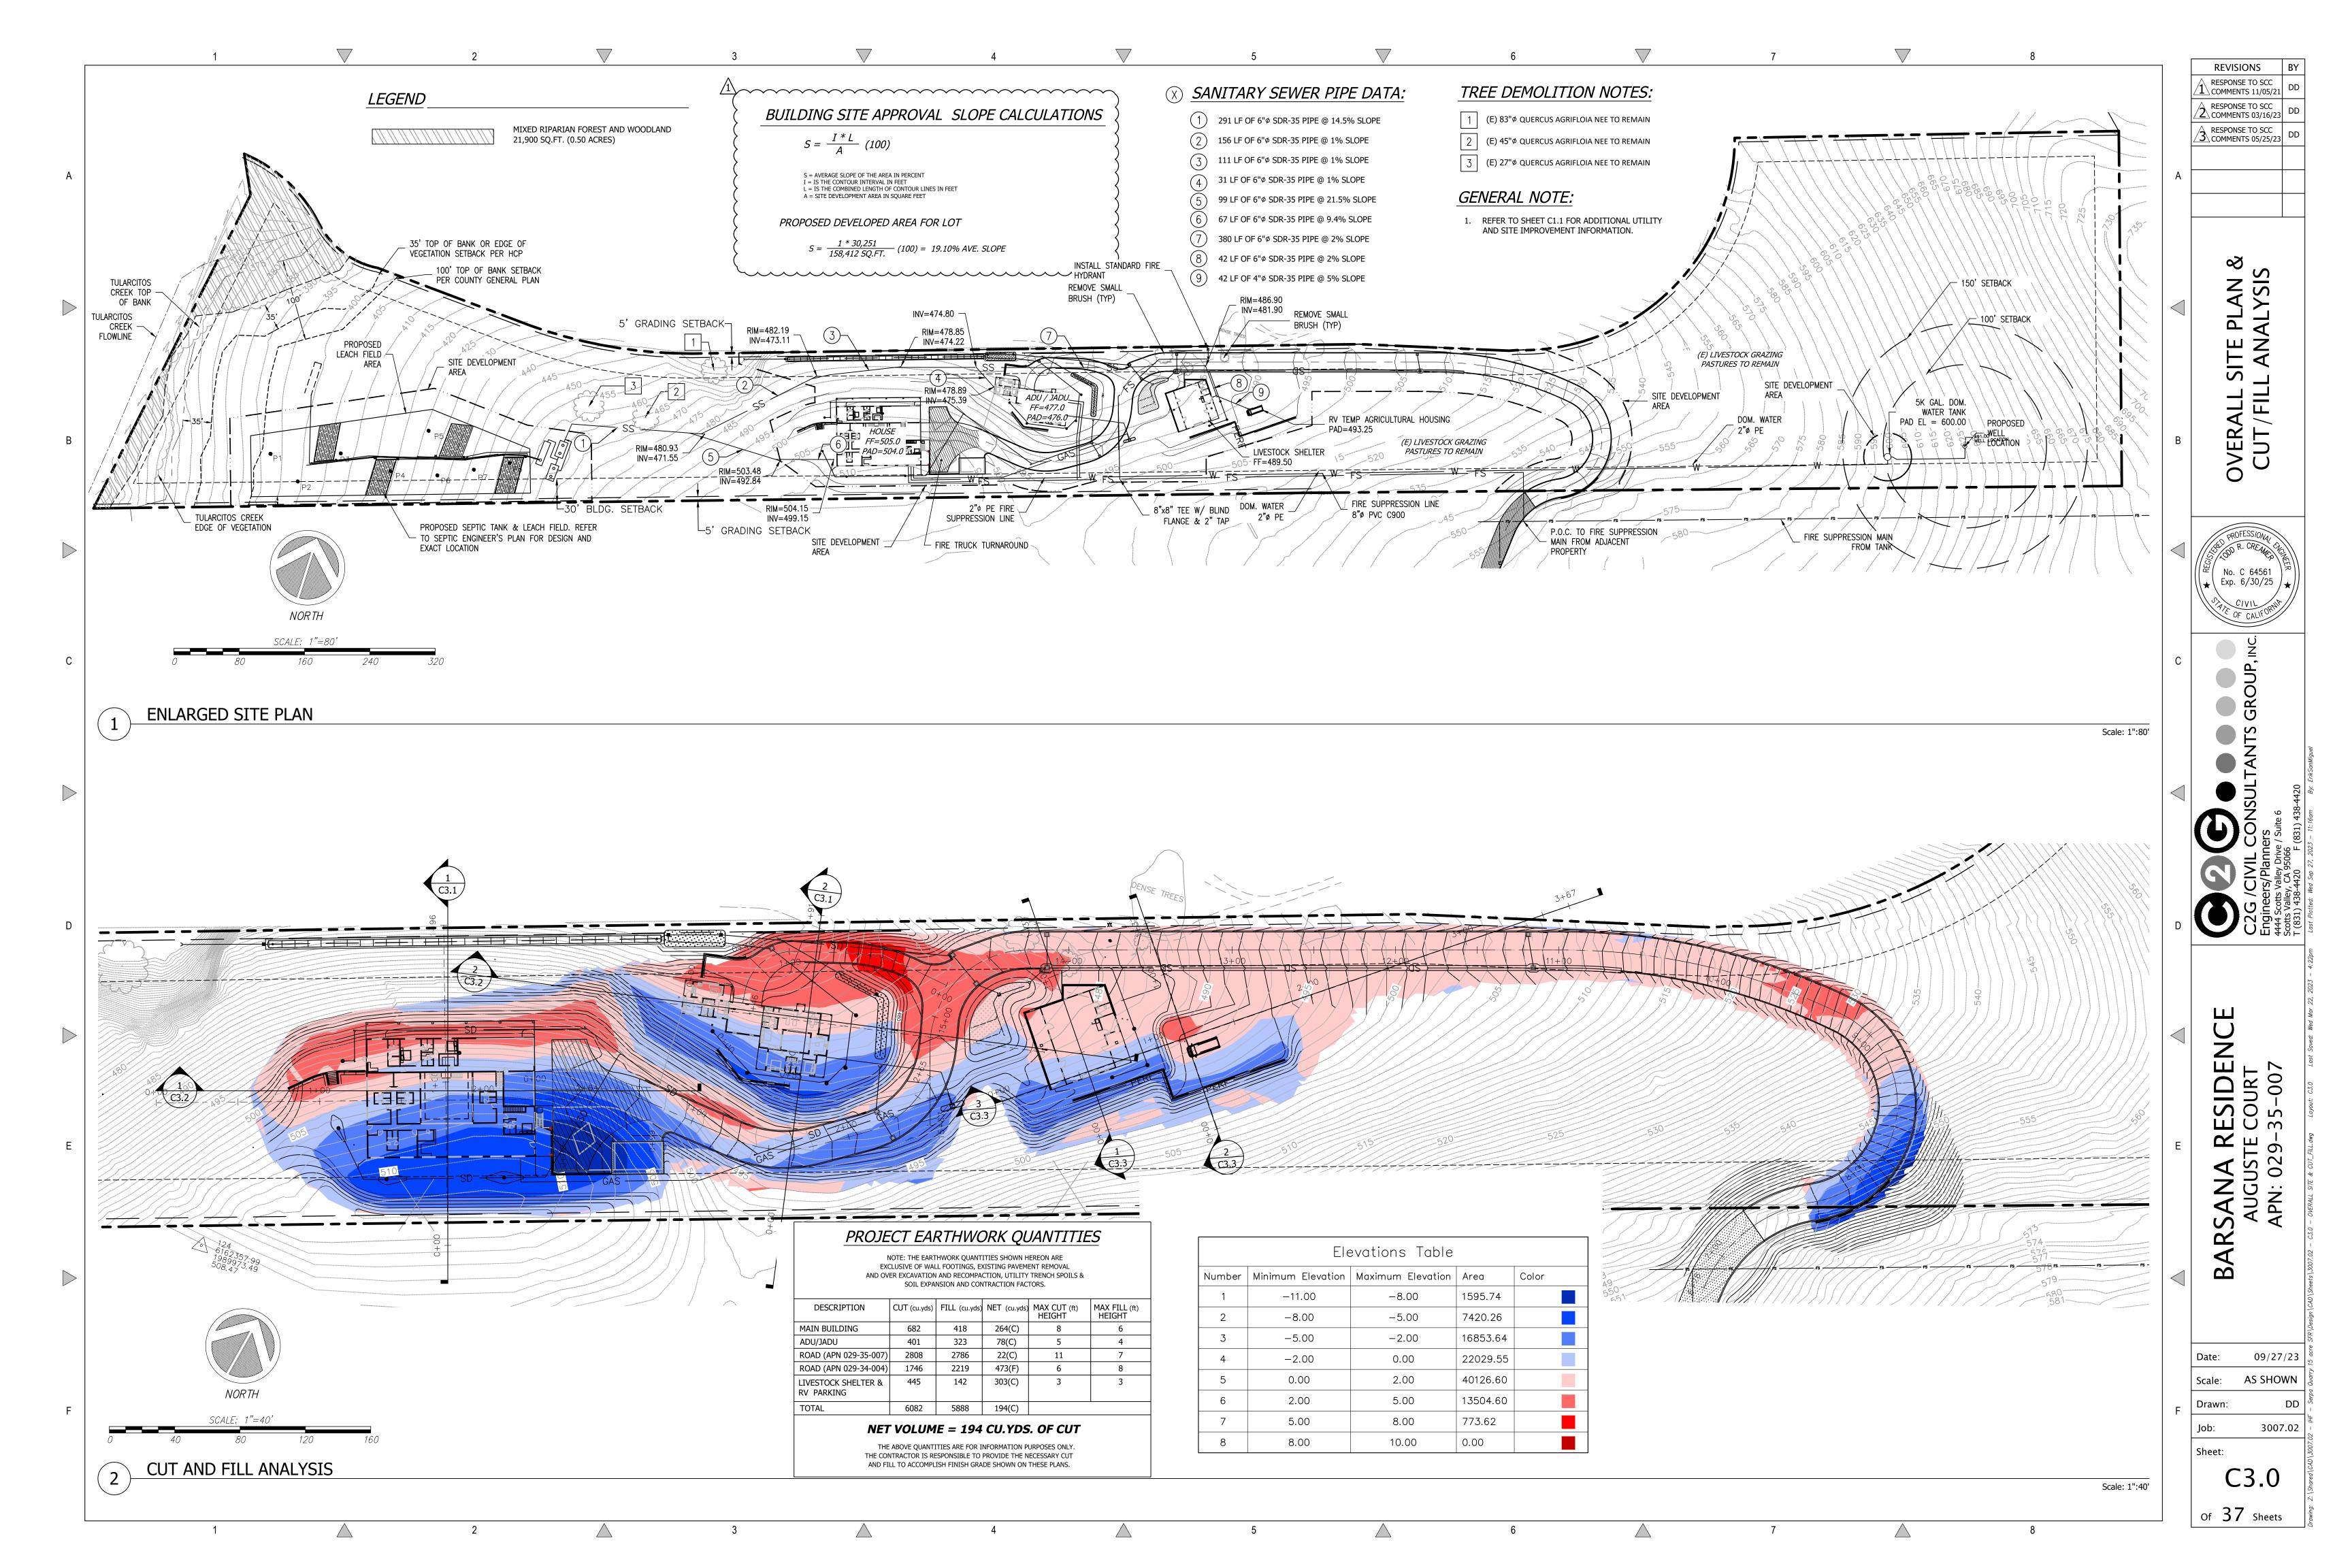
09/27/23 1" = 20' Drawn: 3007.02


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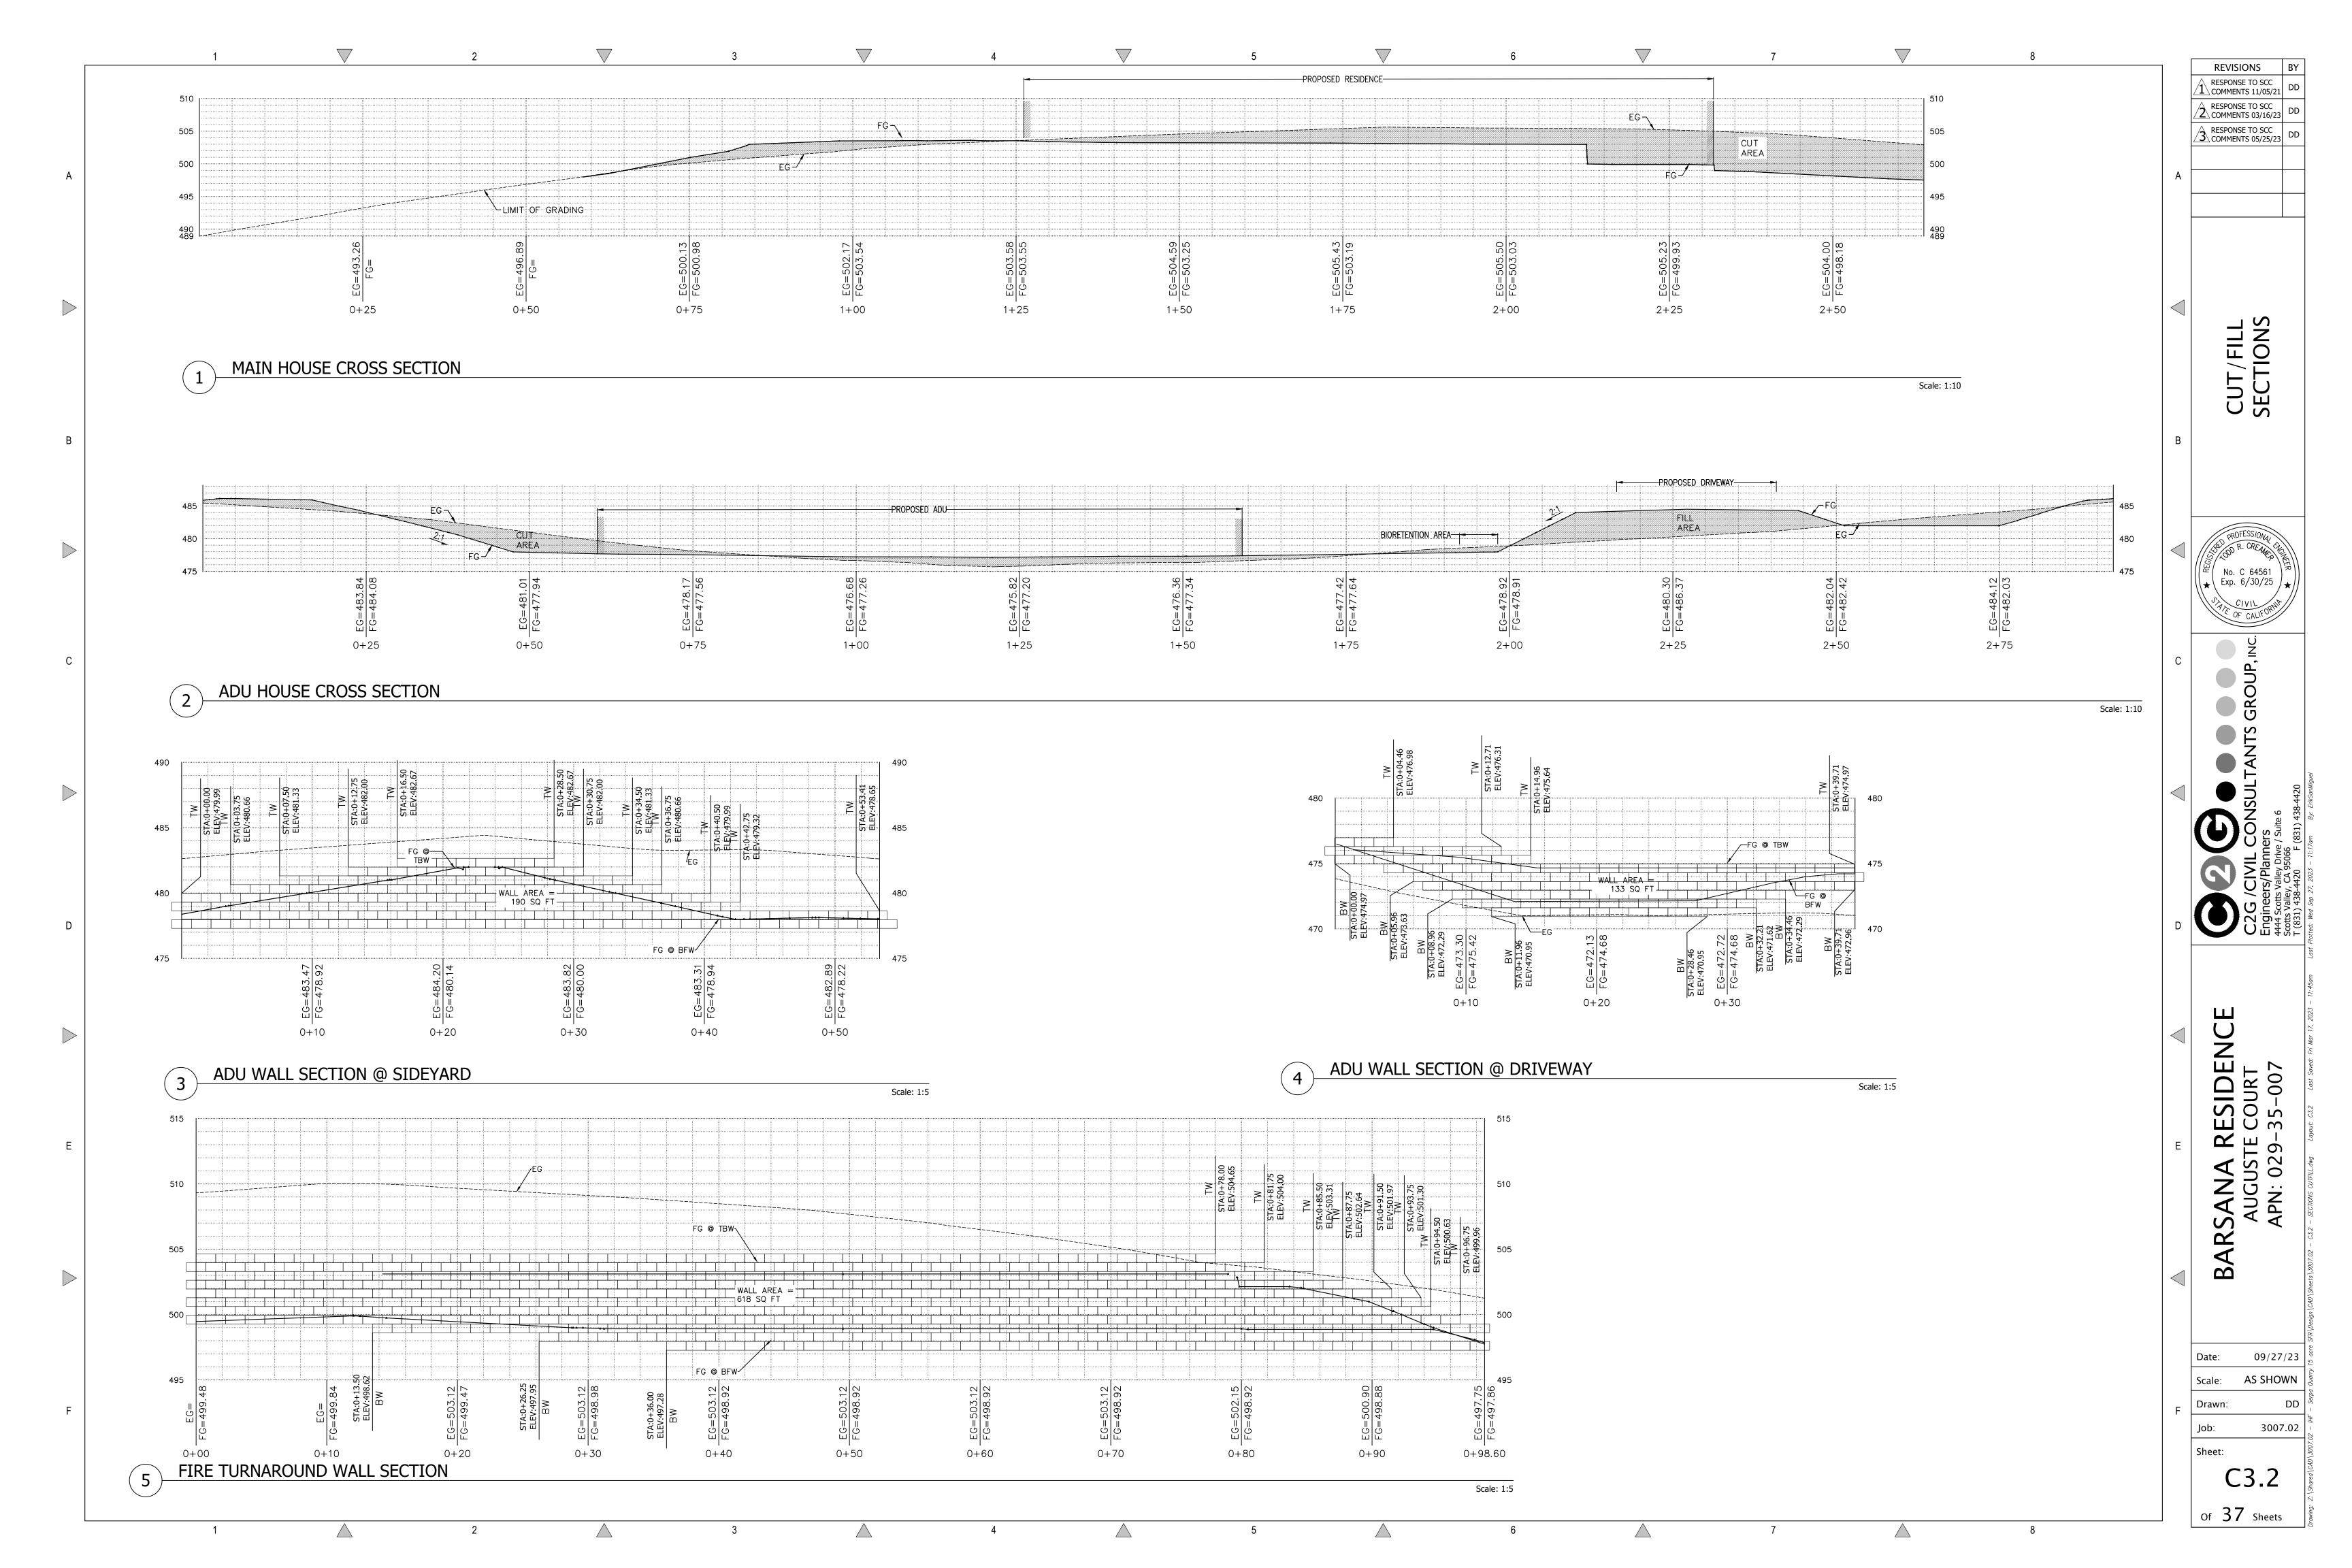





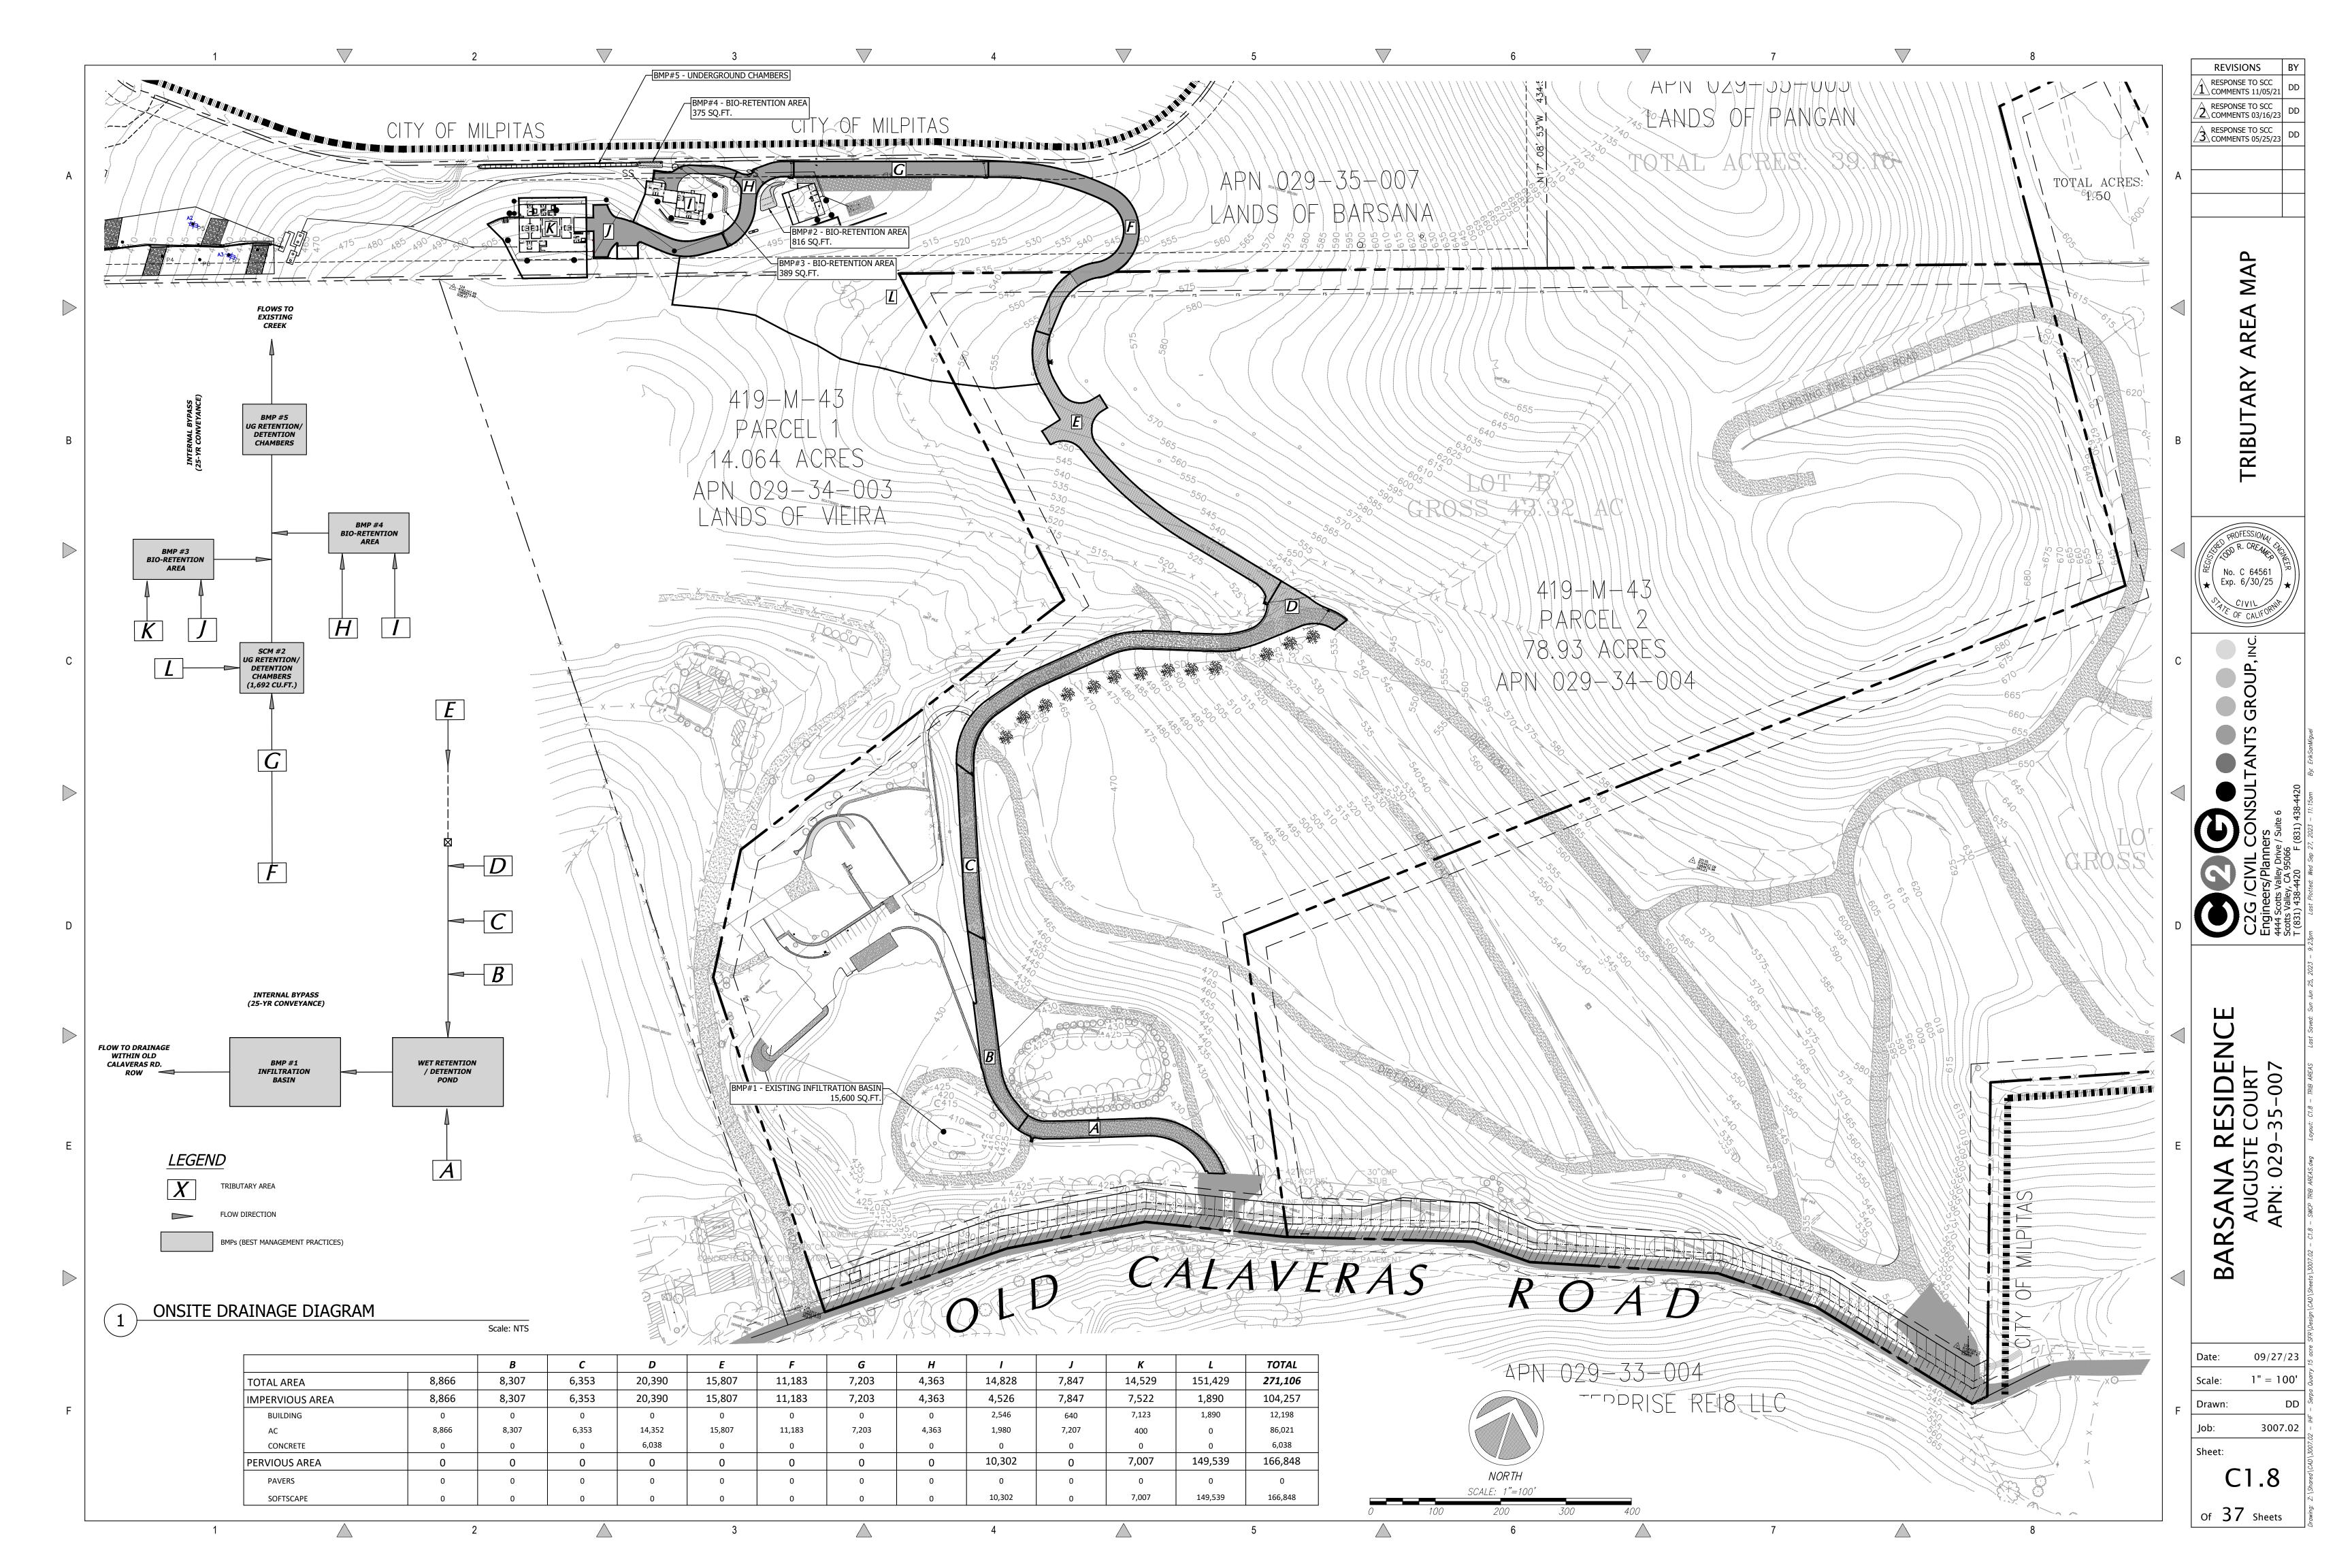


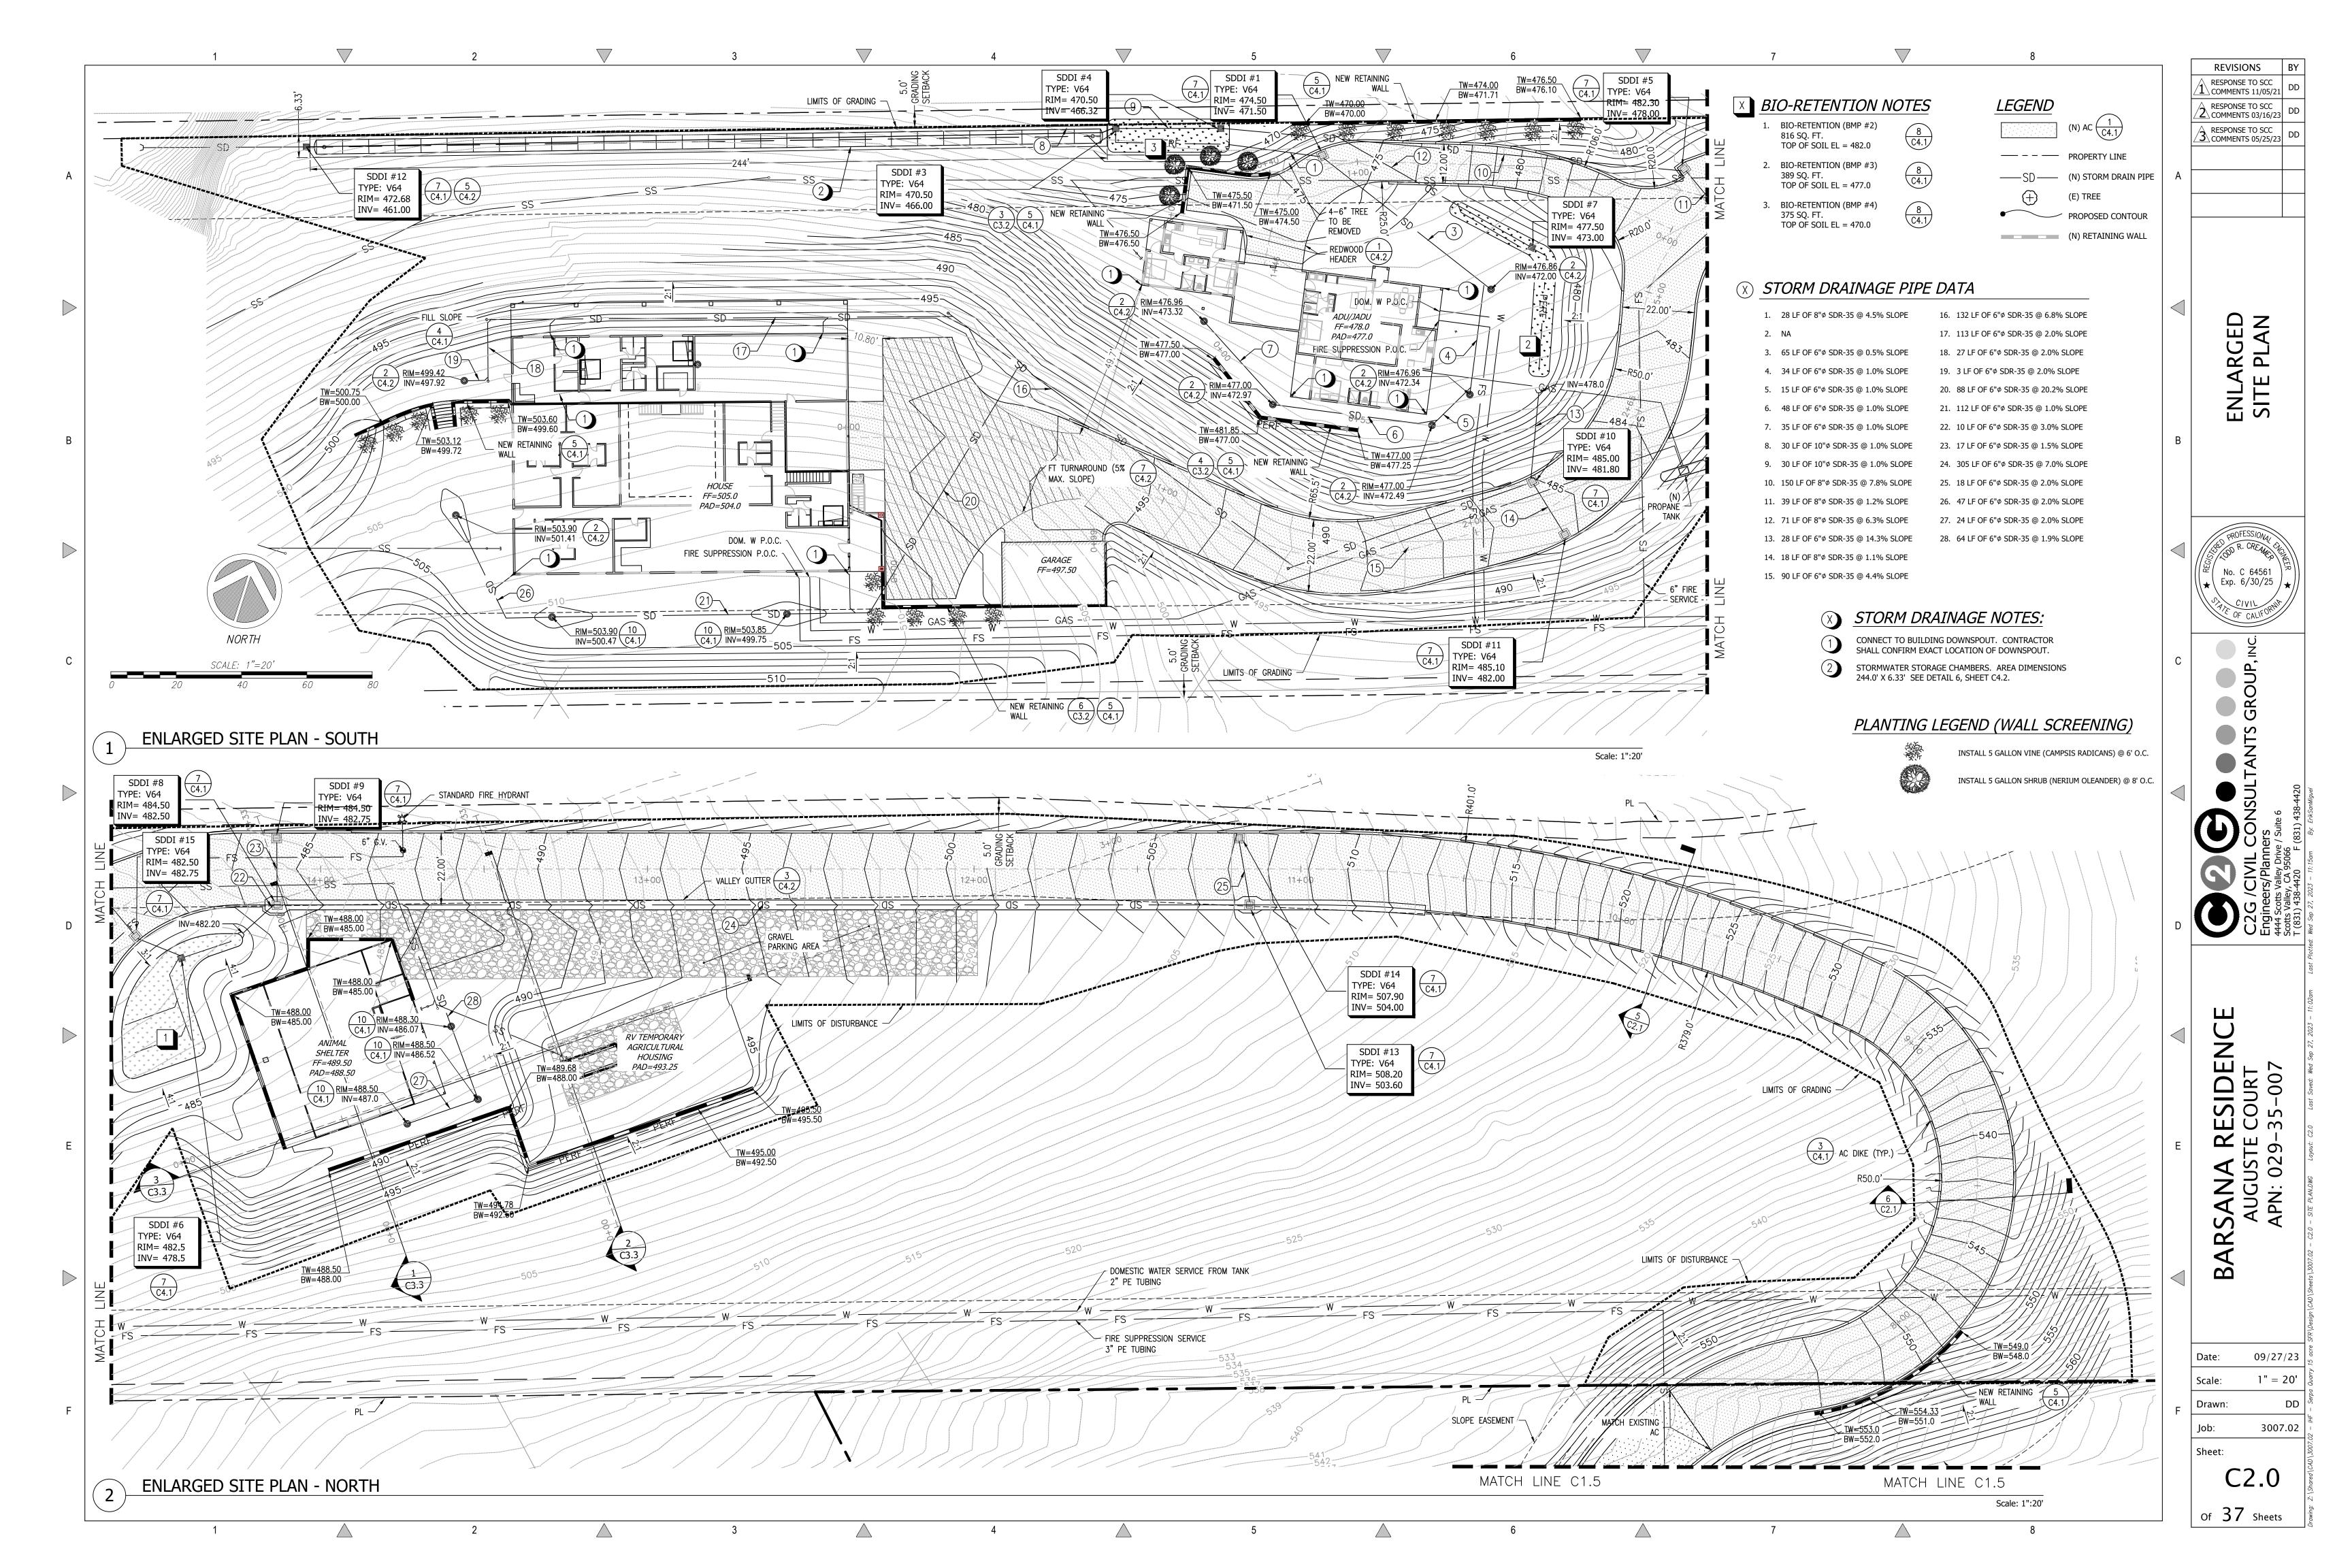


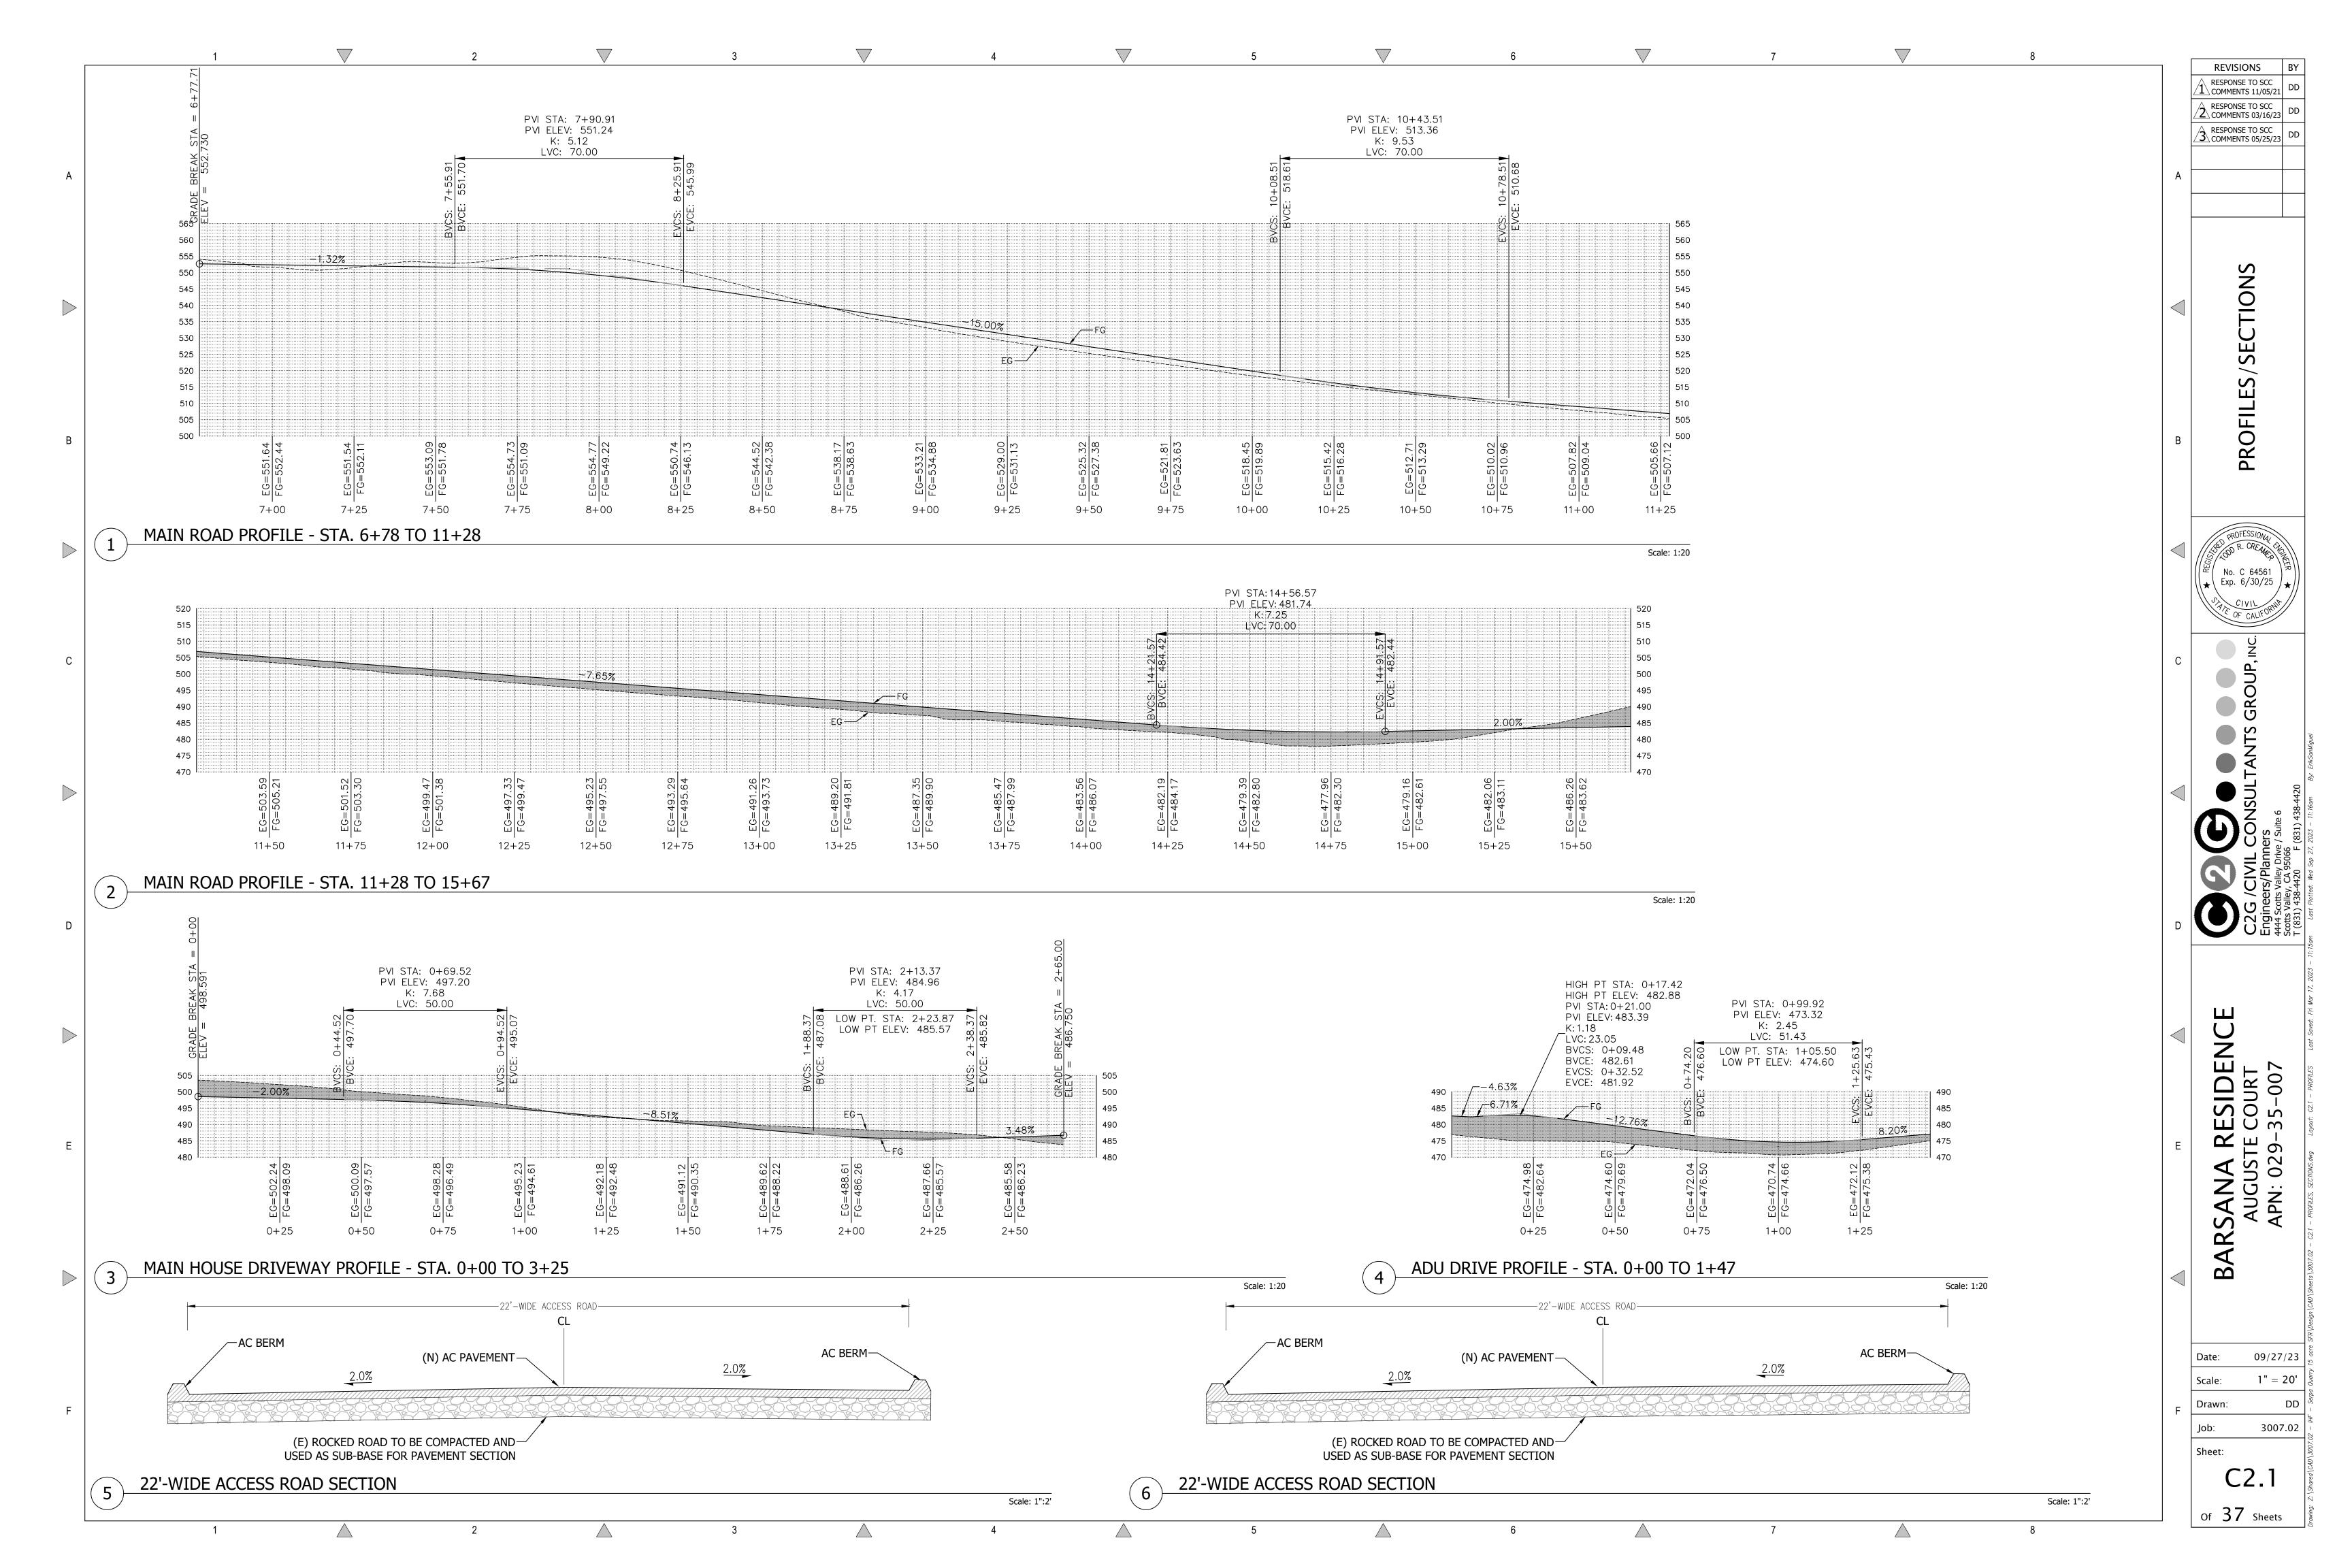


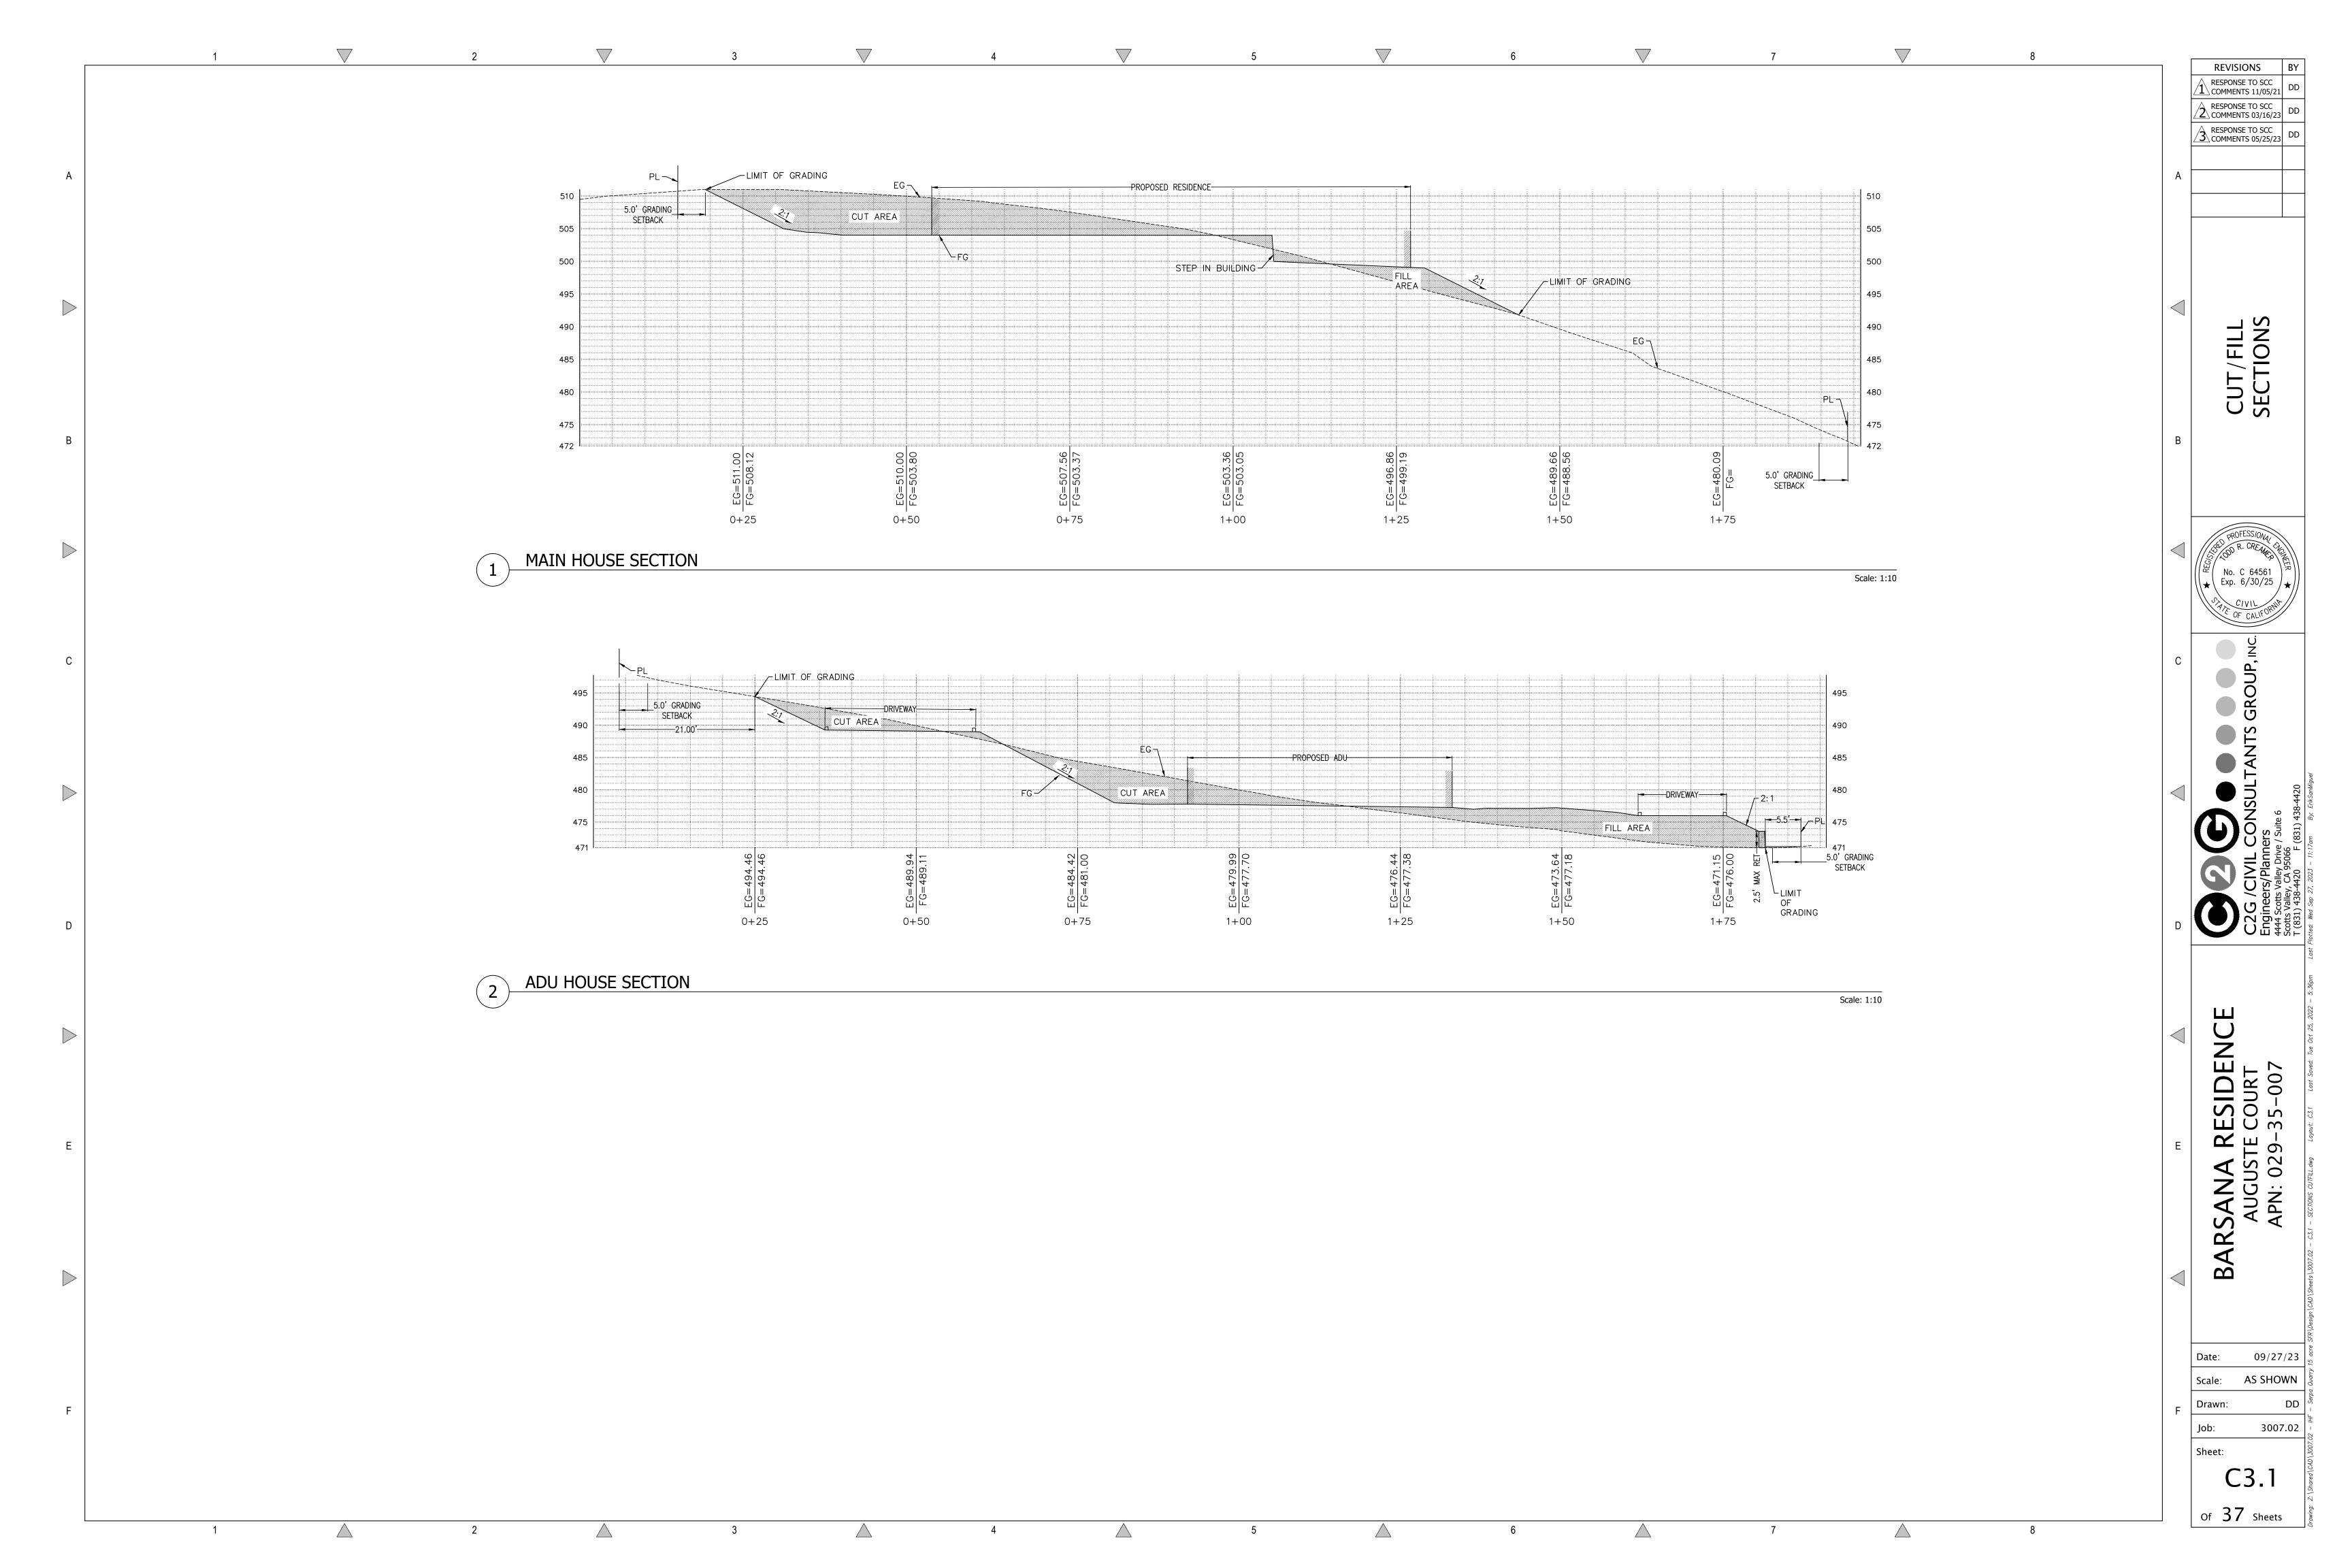


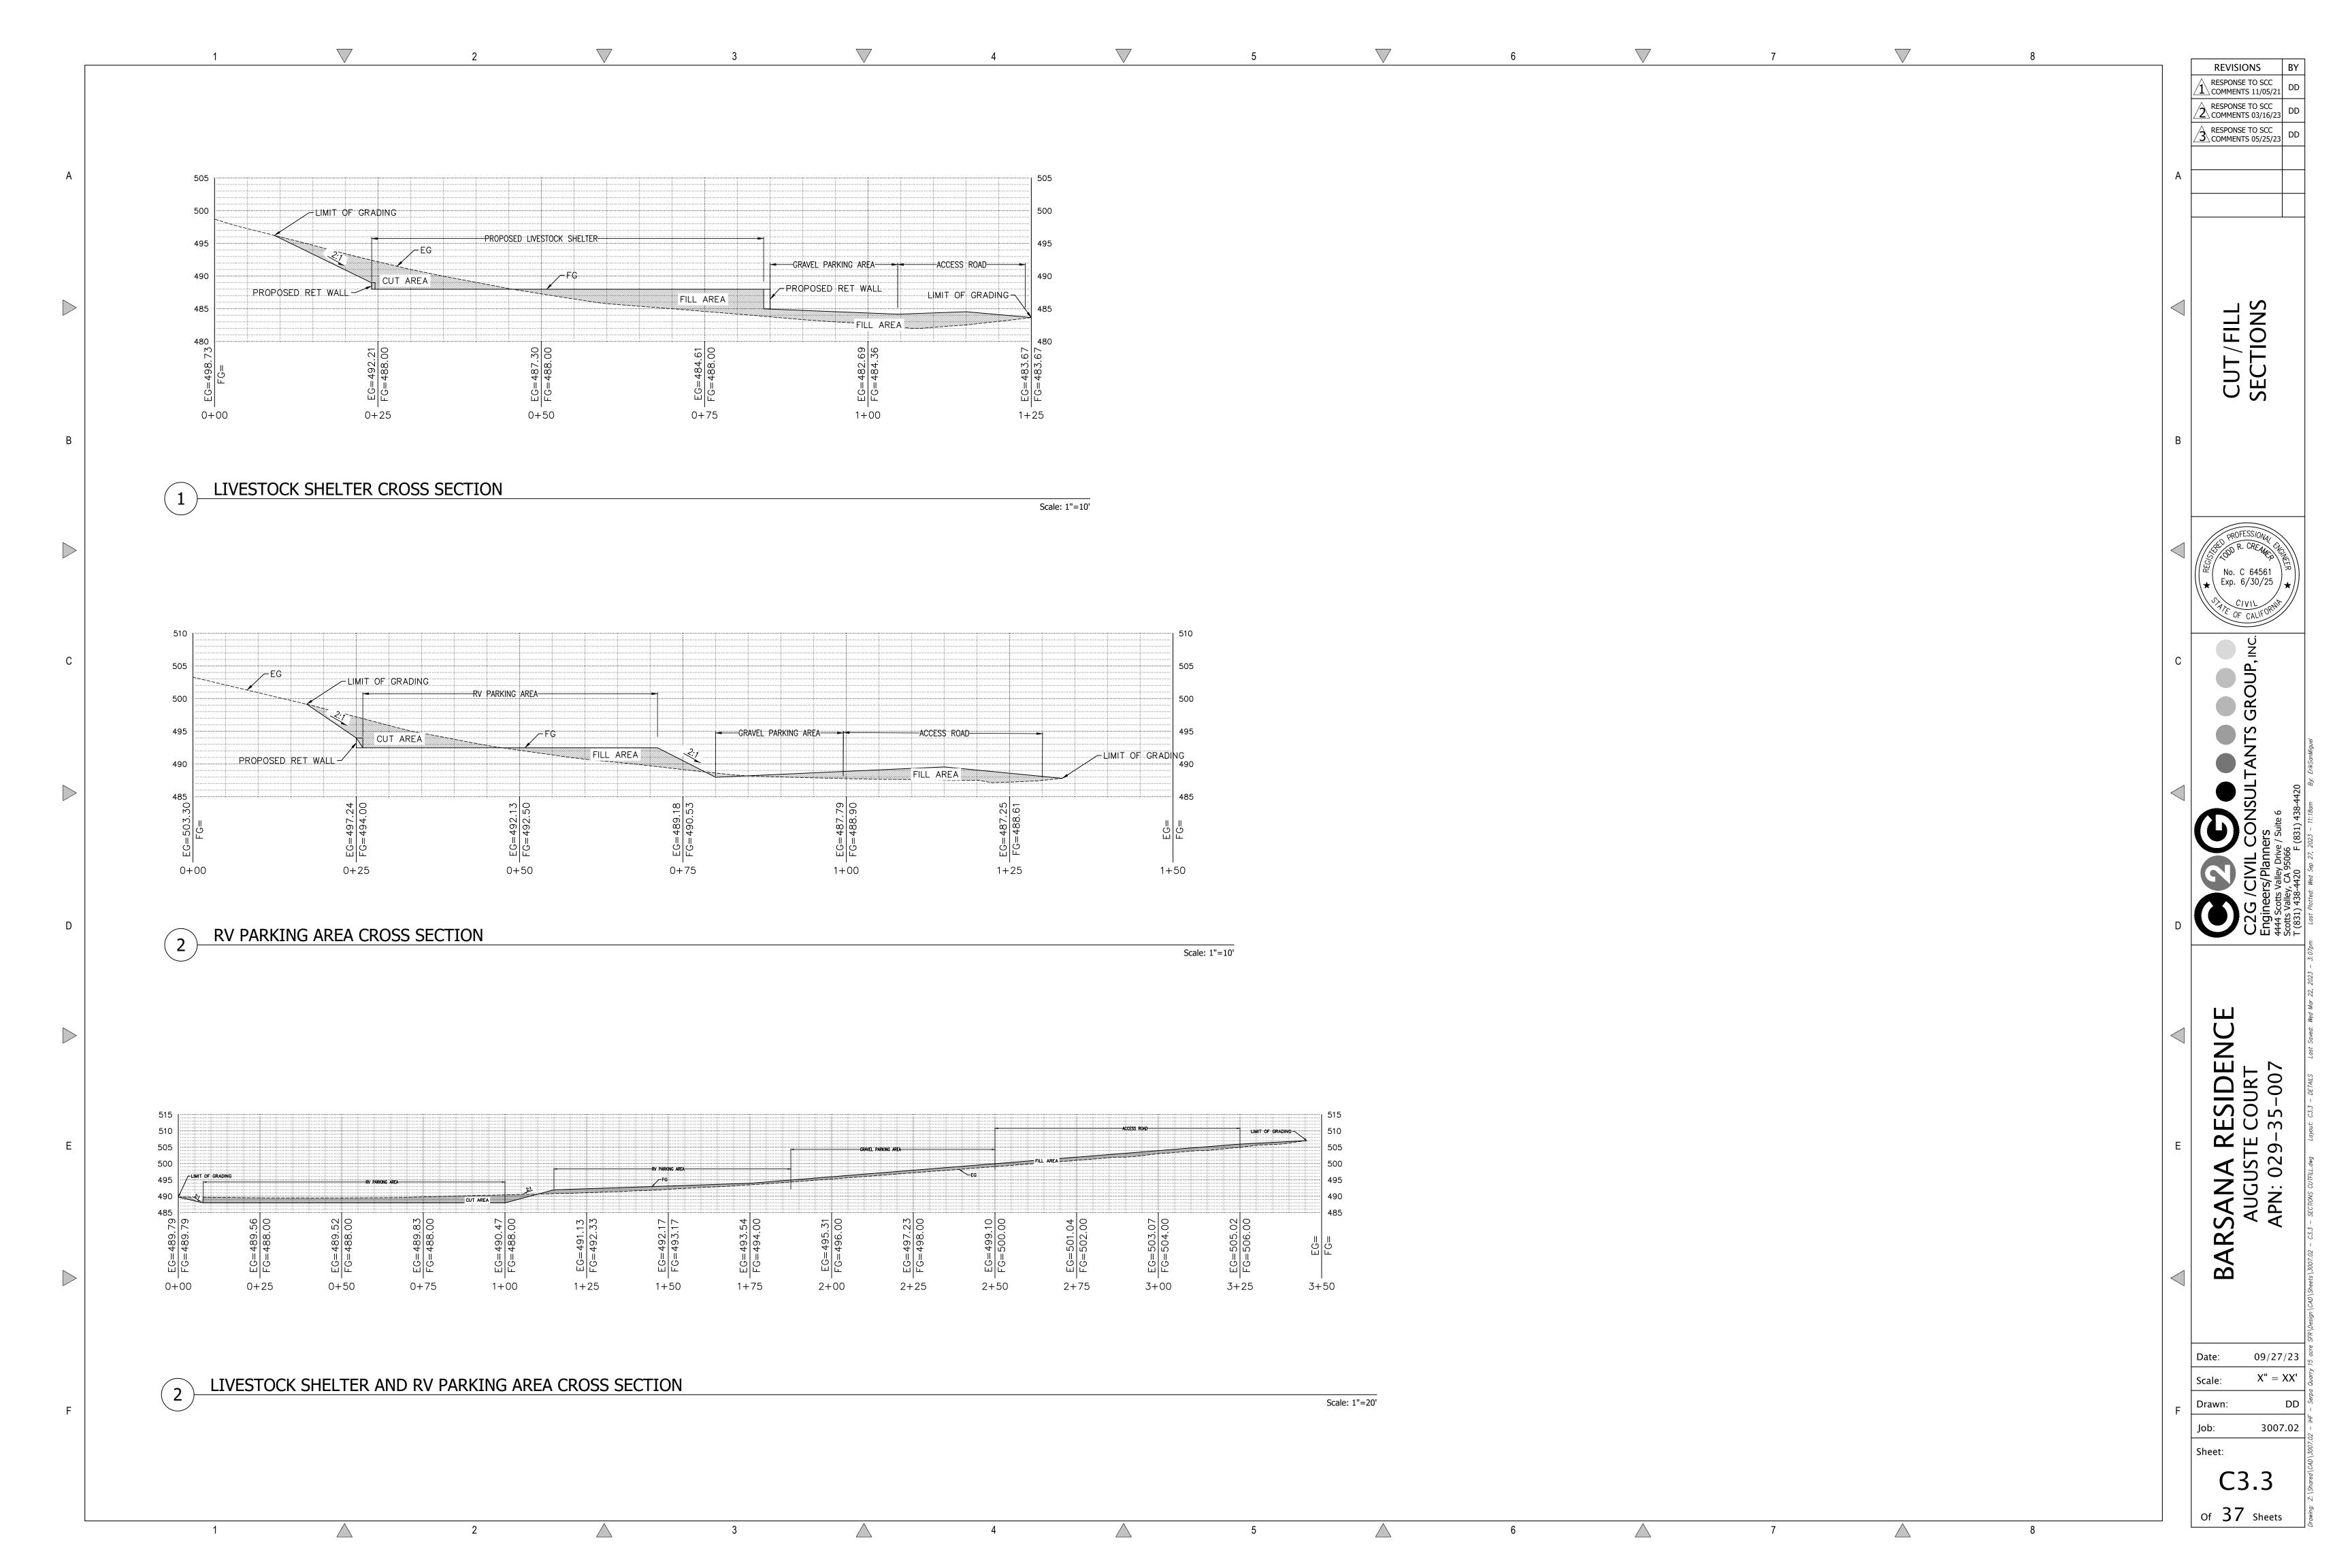


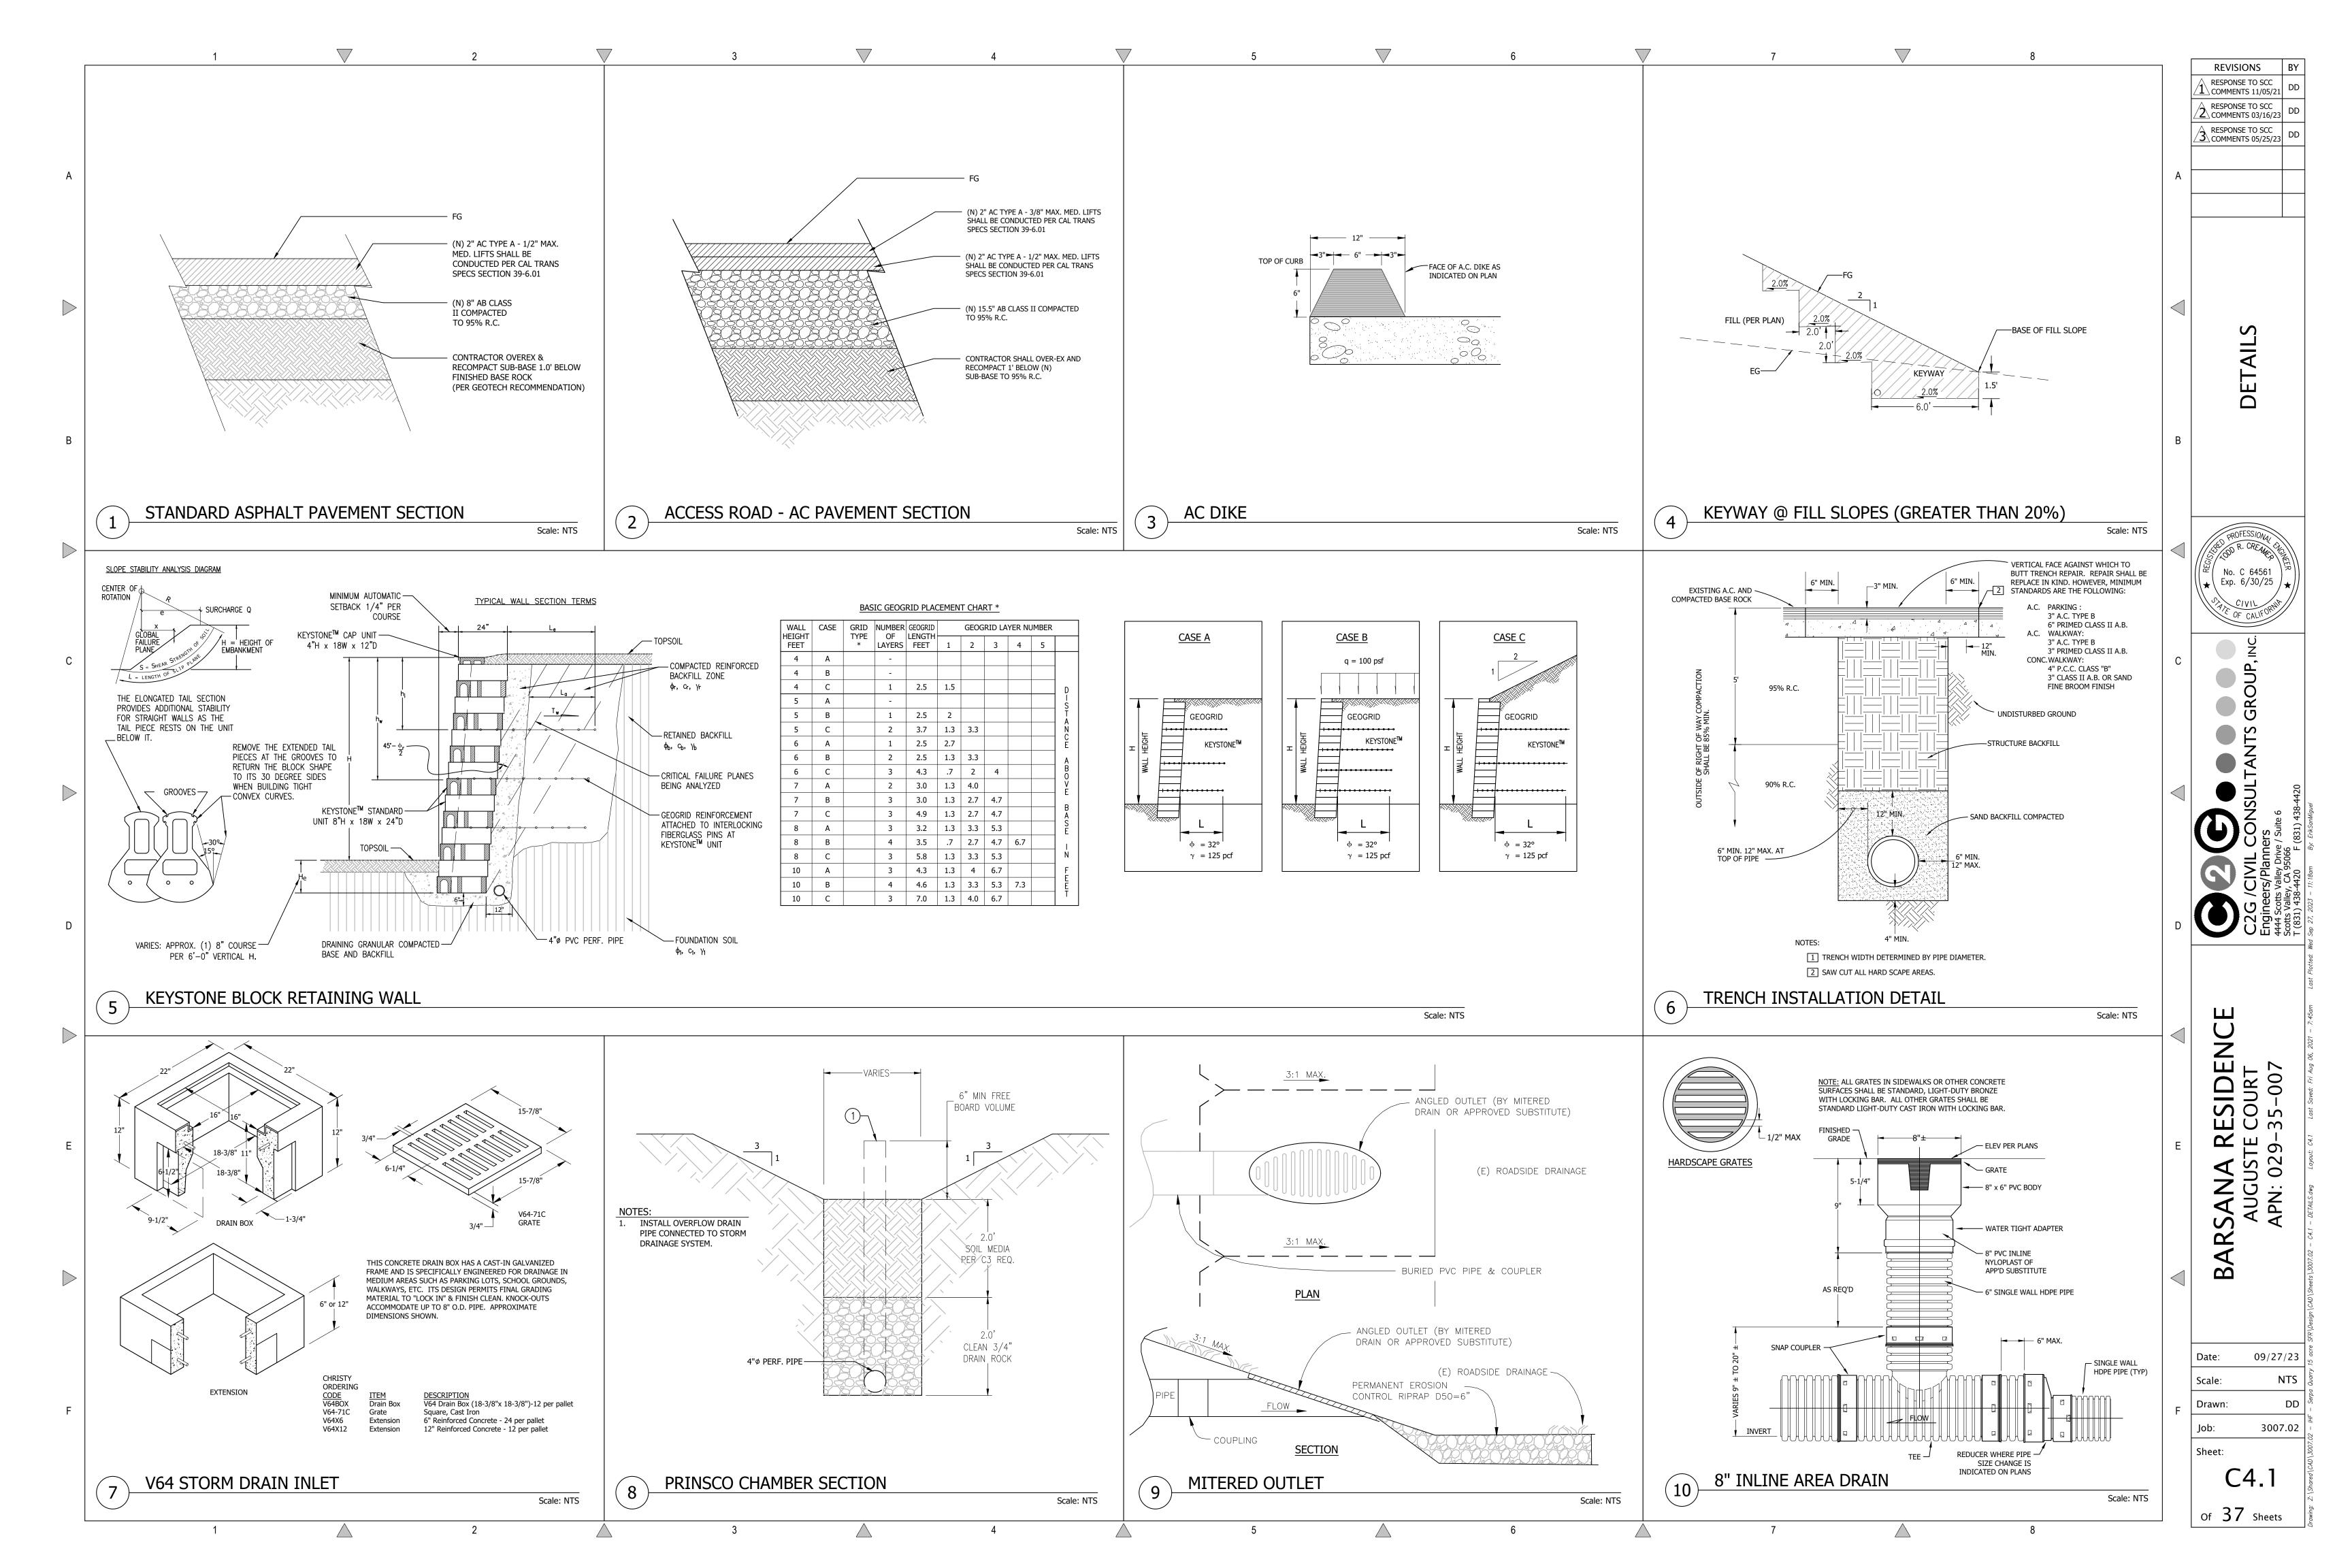


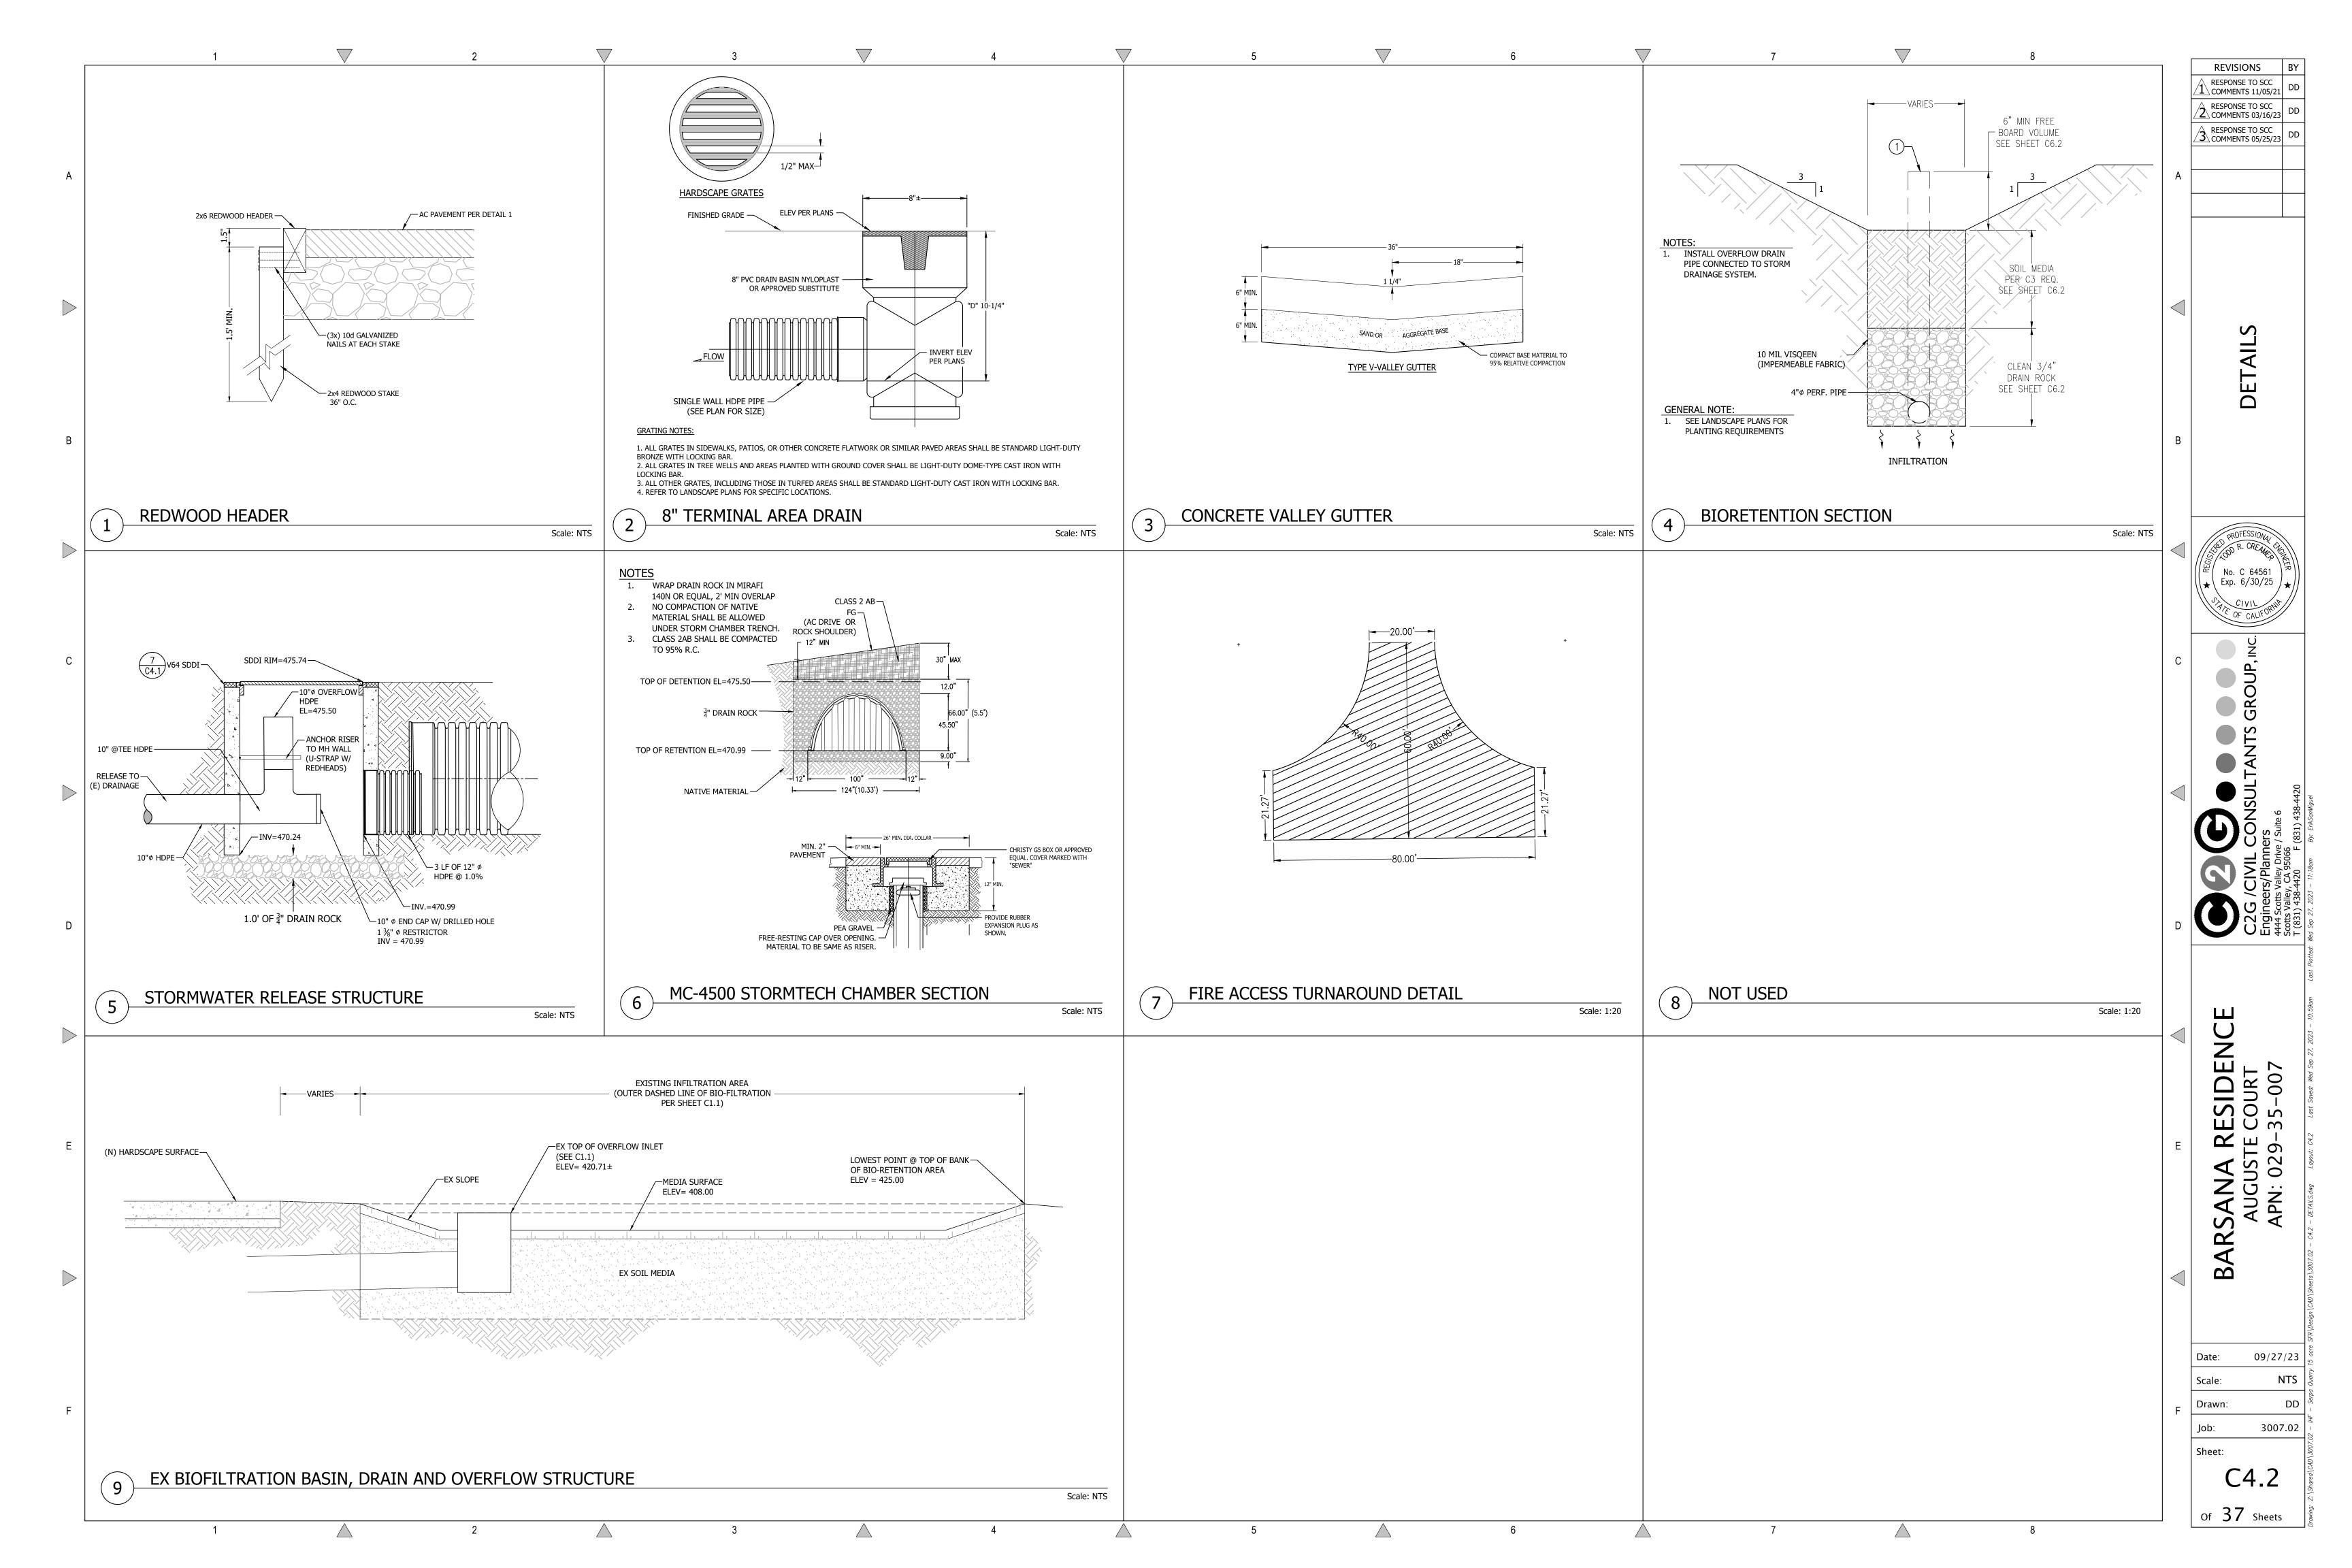


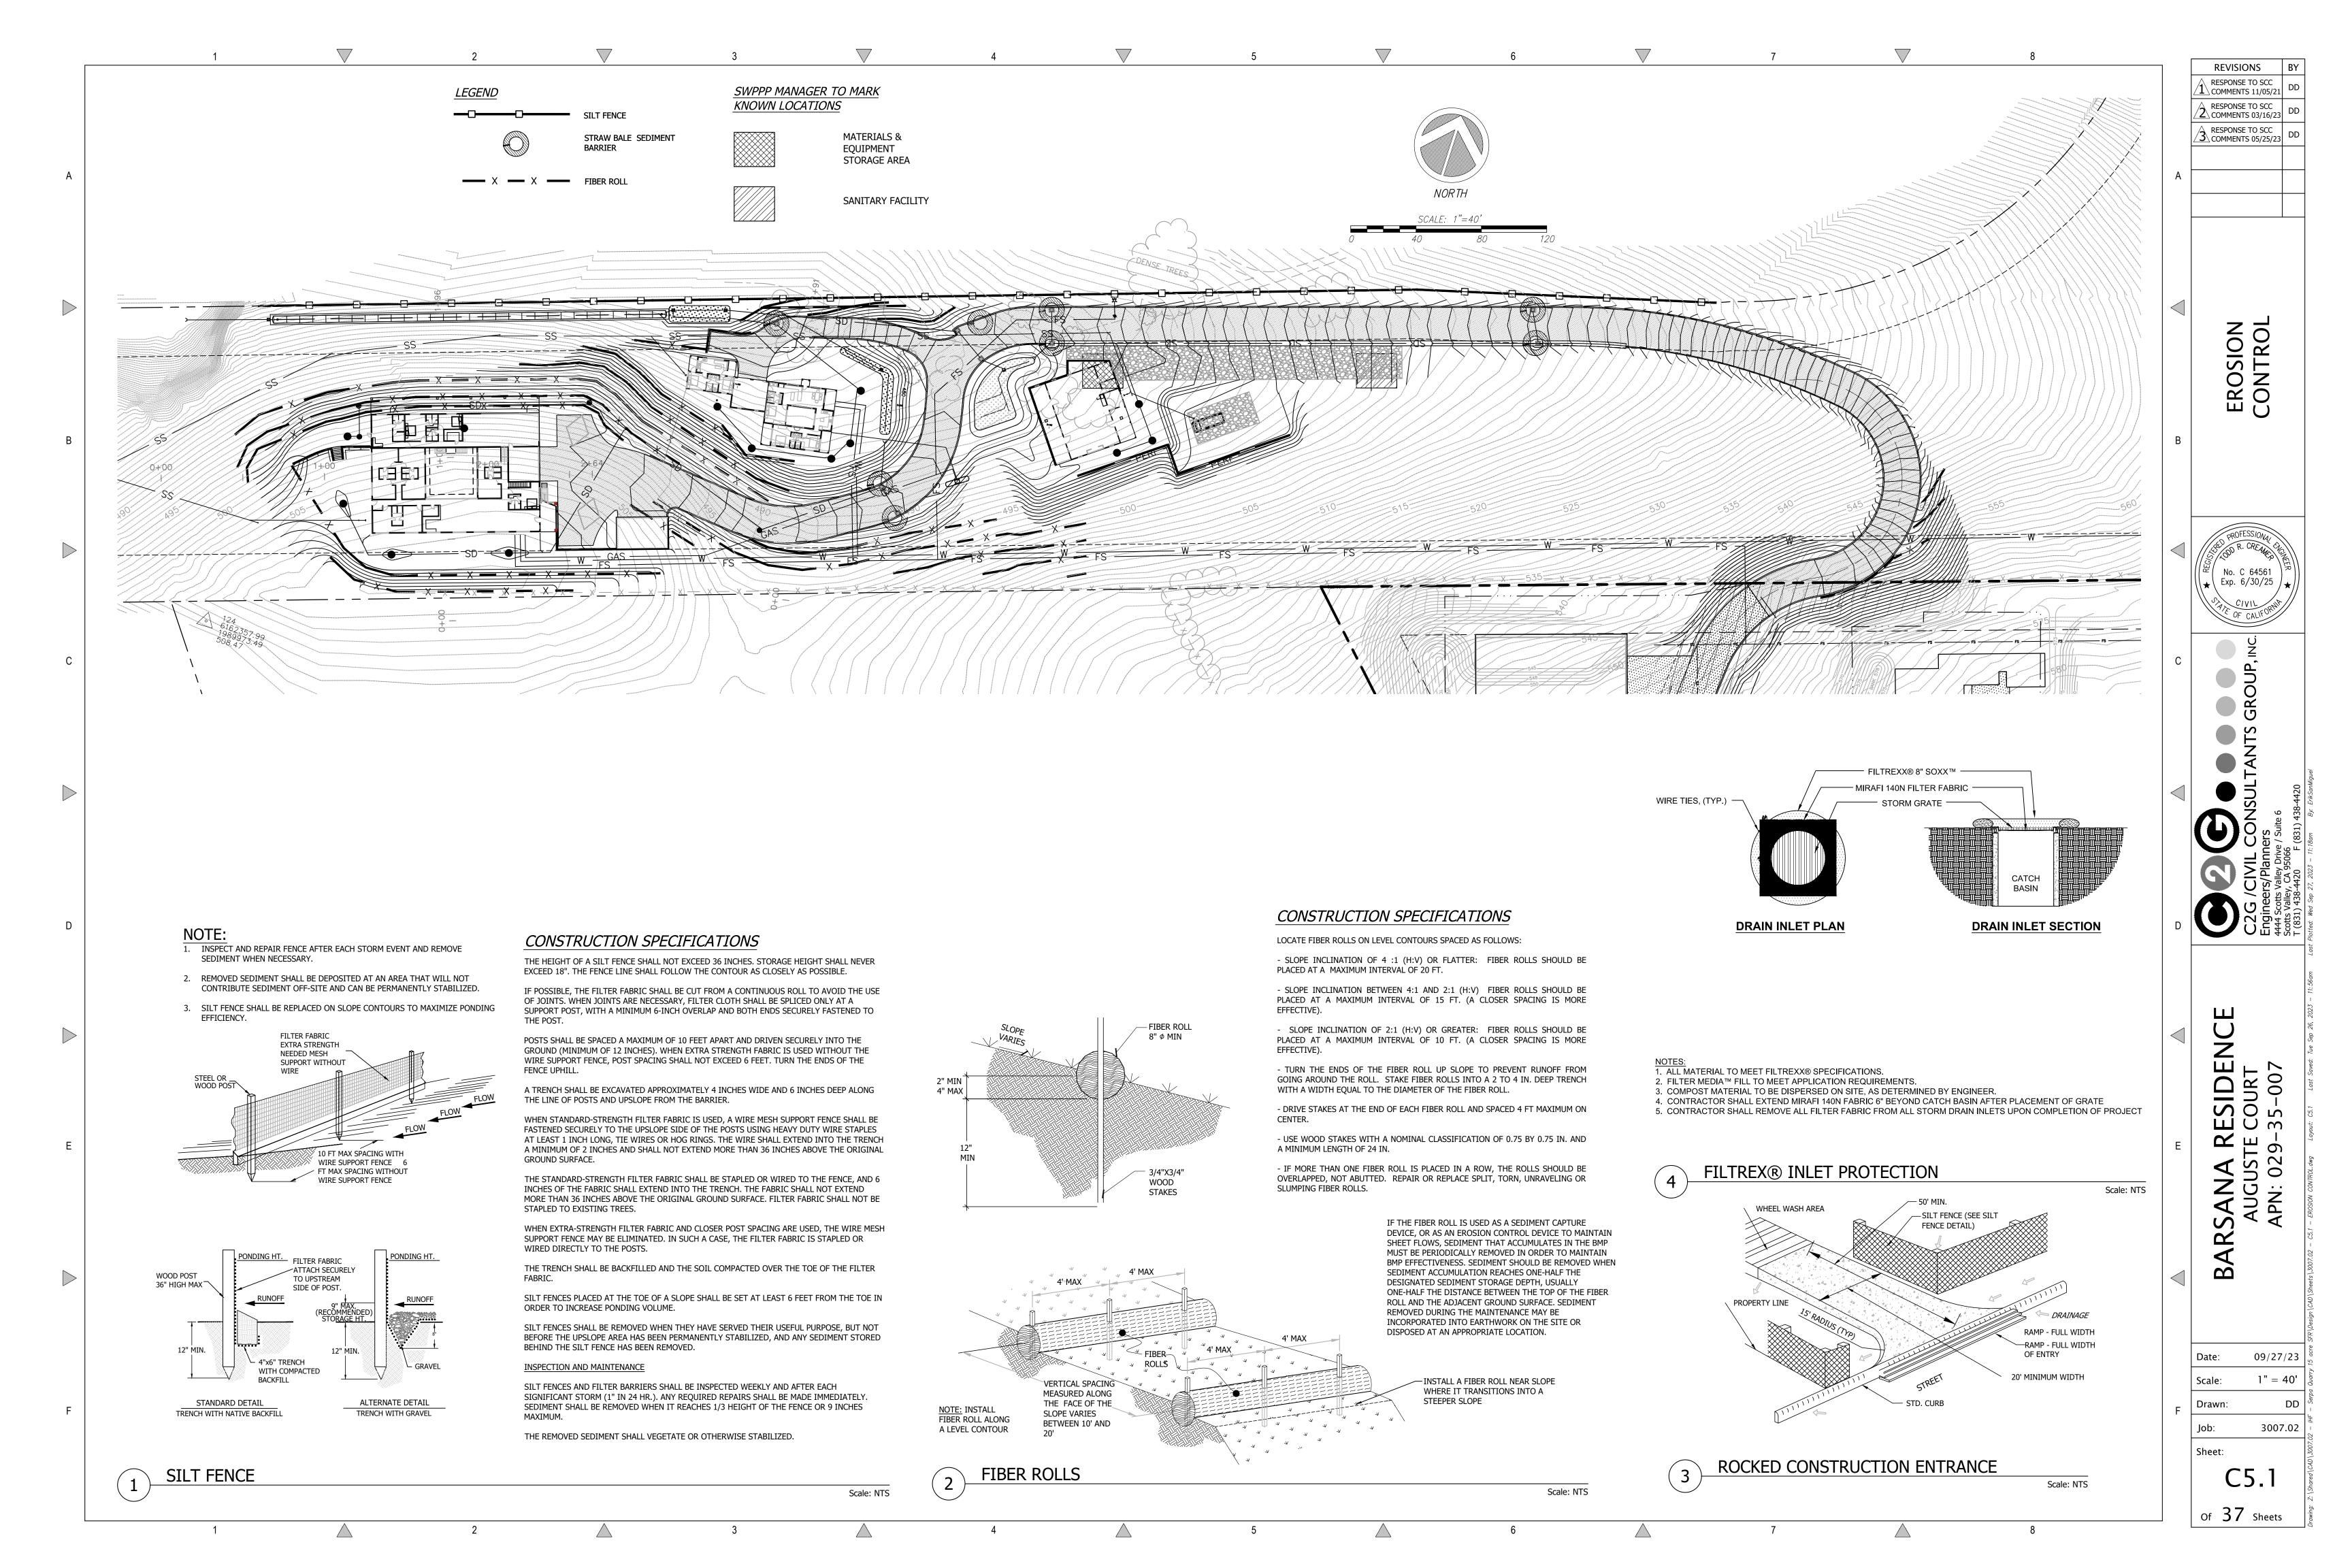


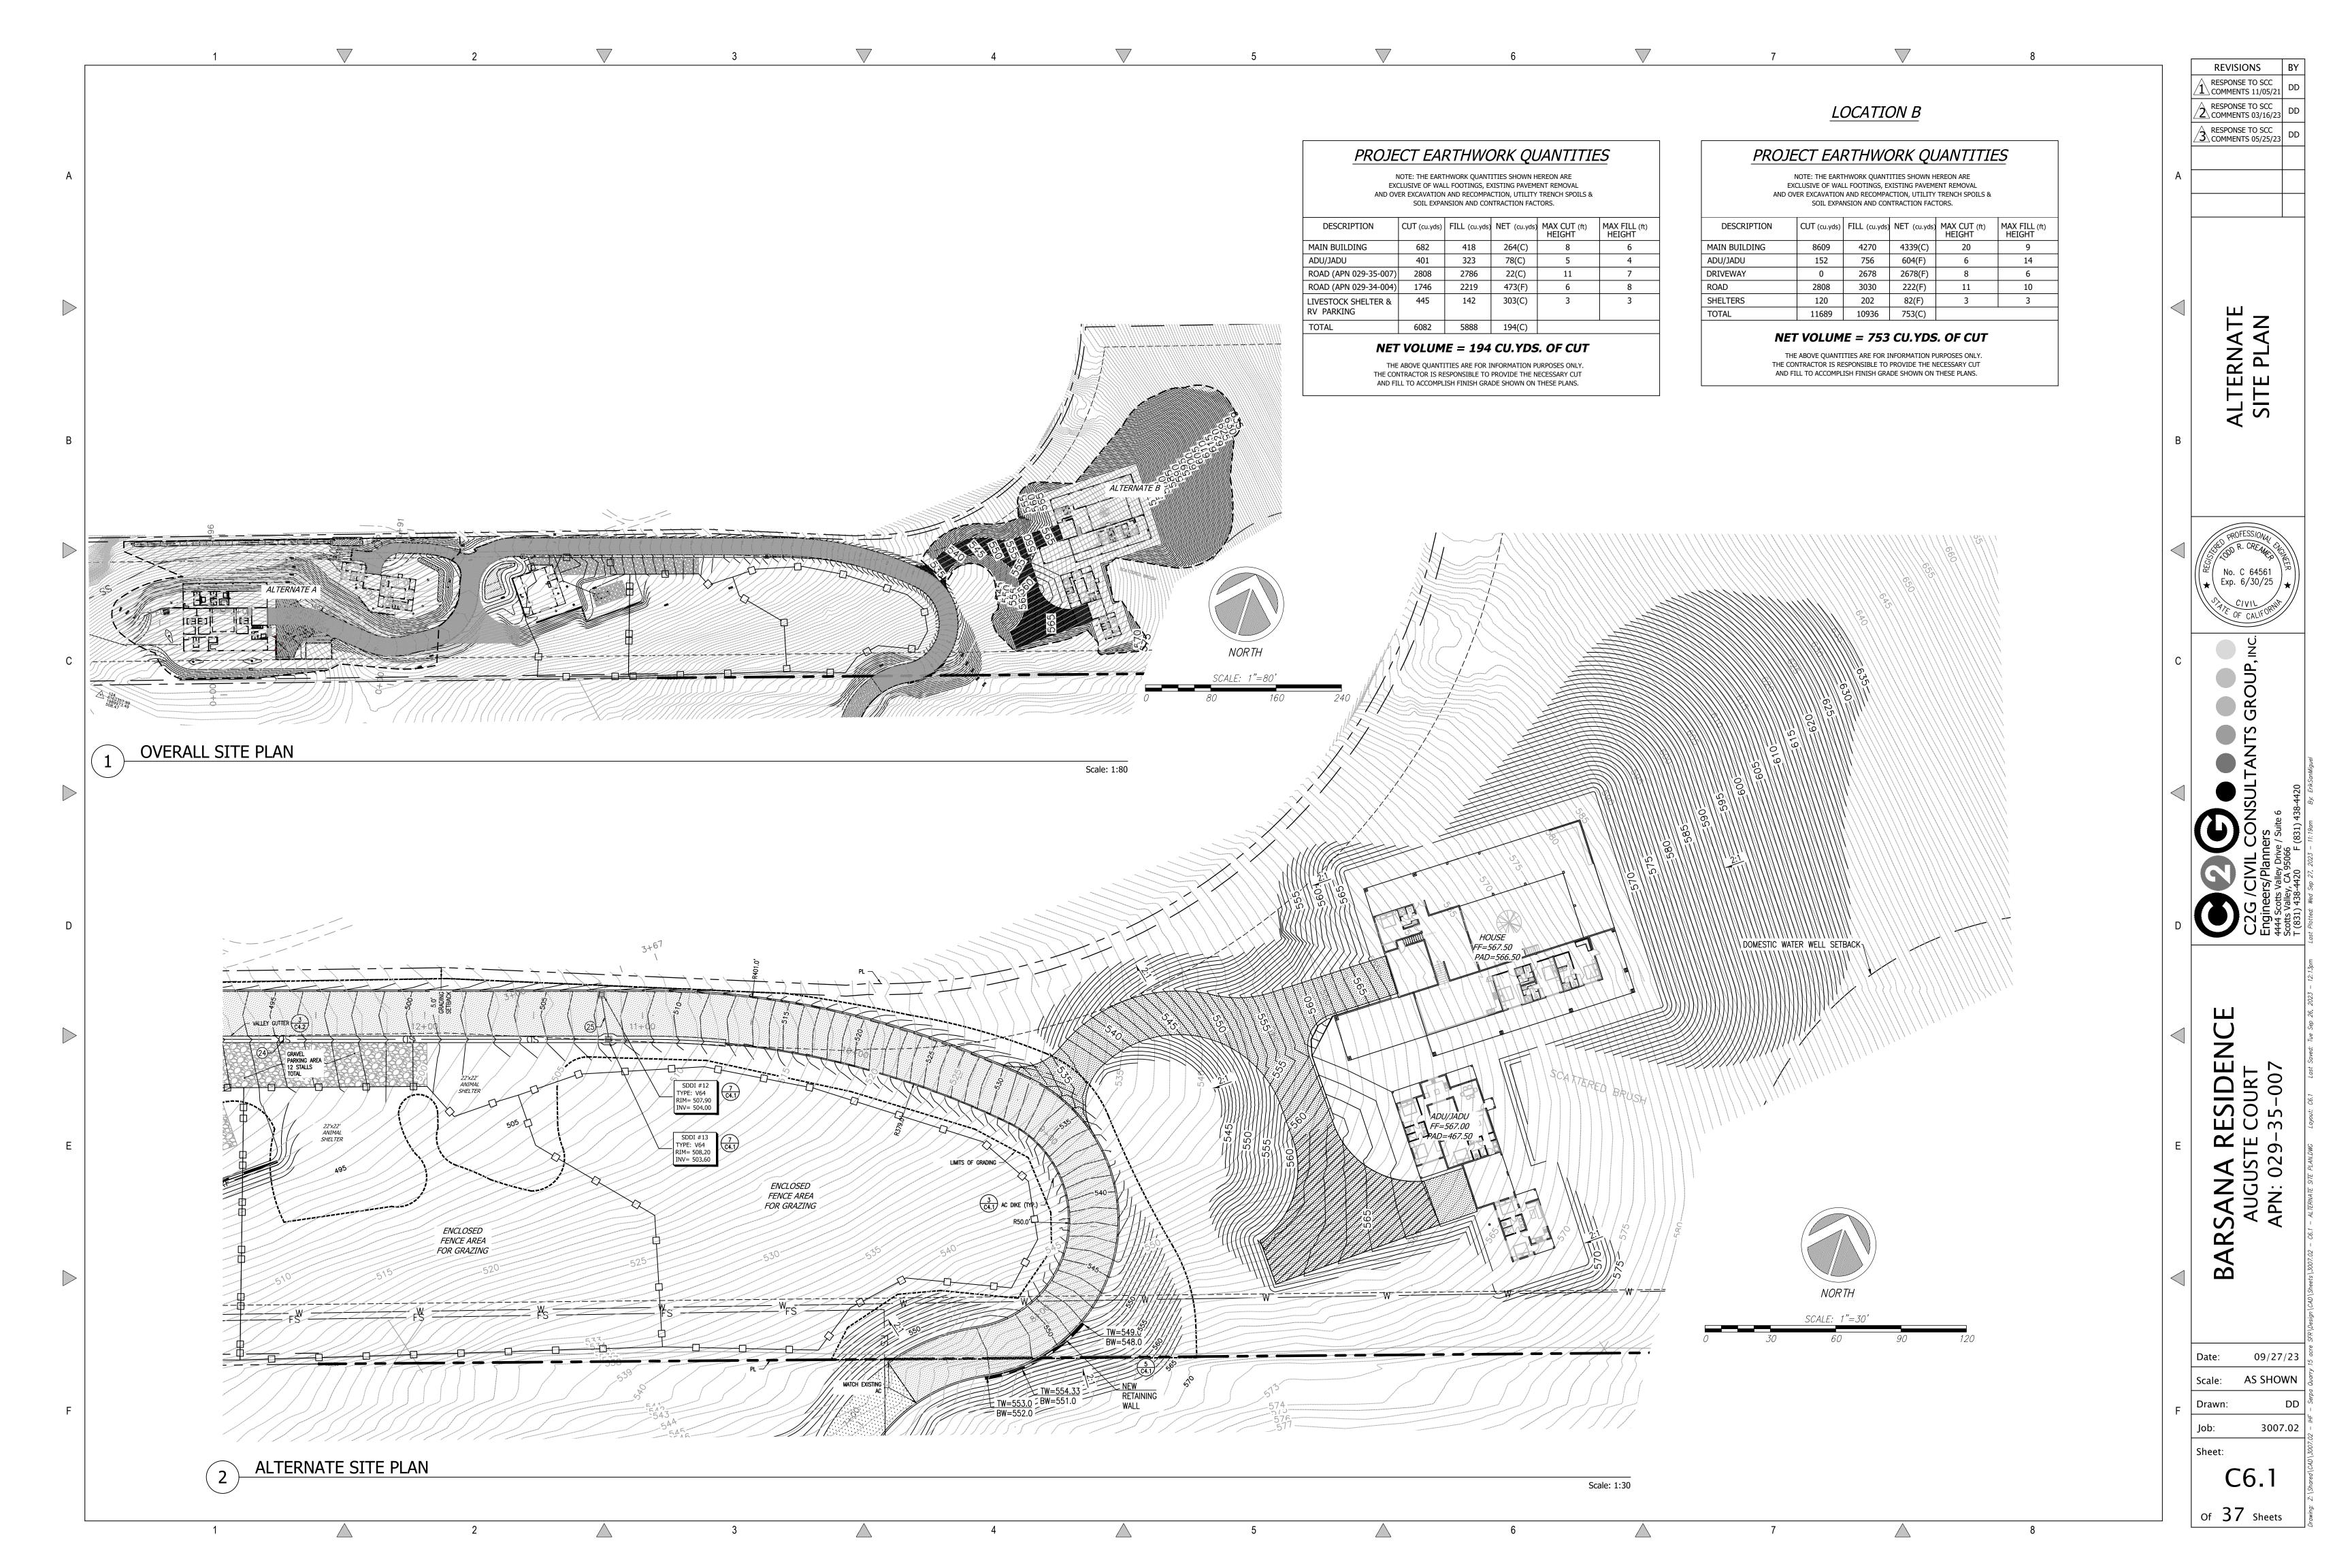


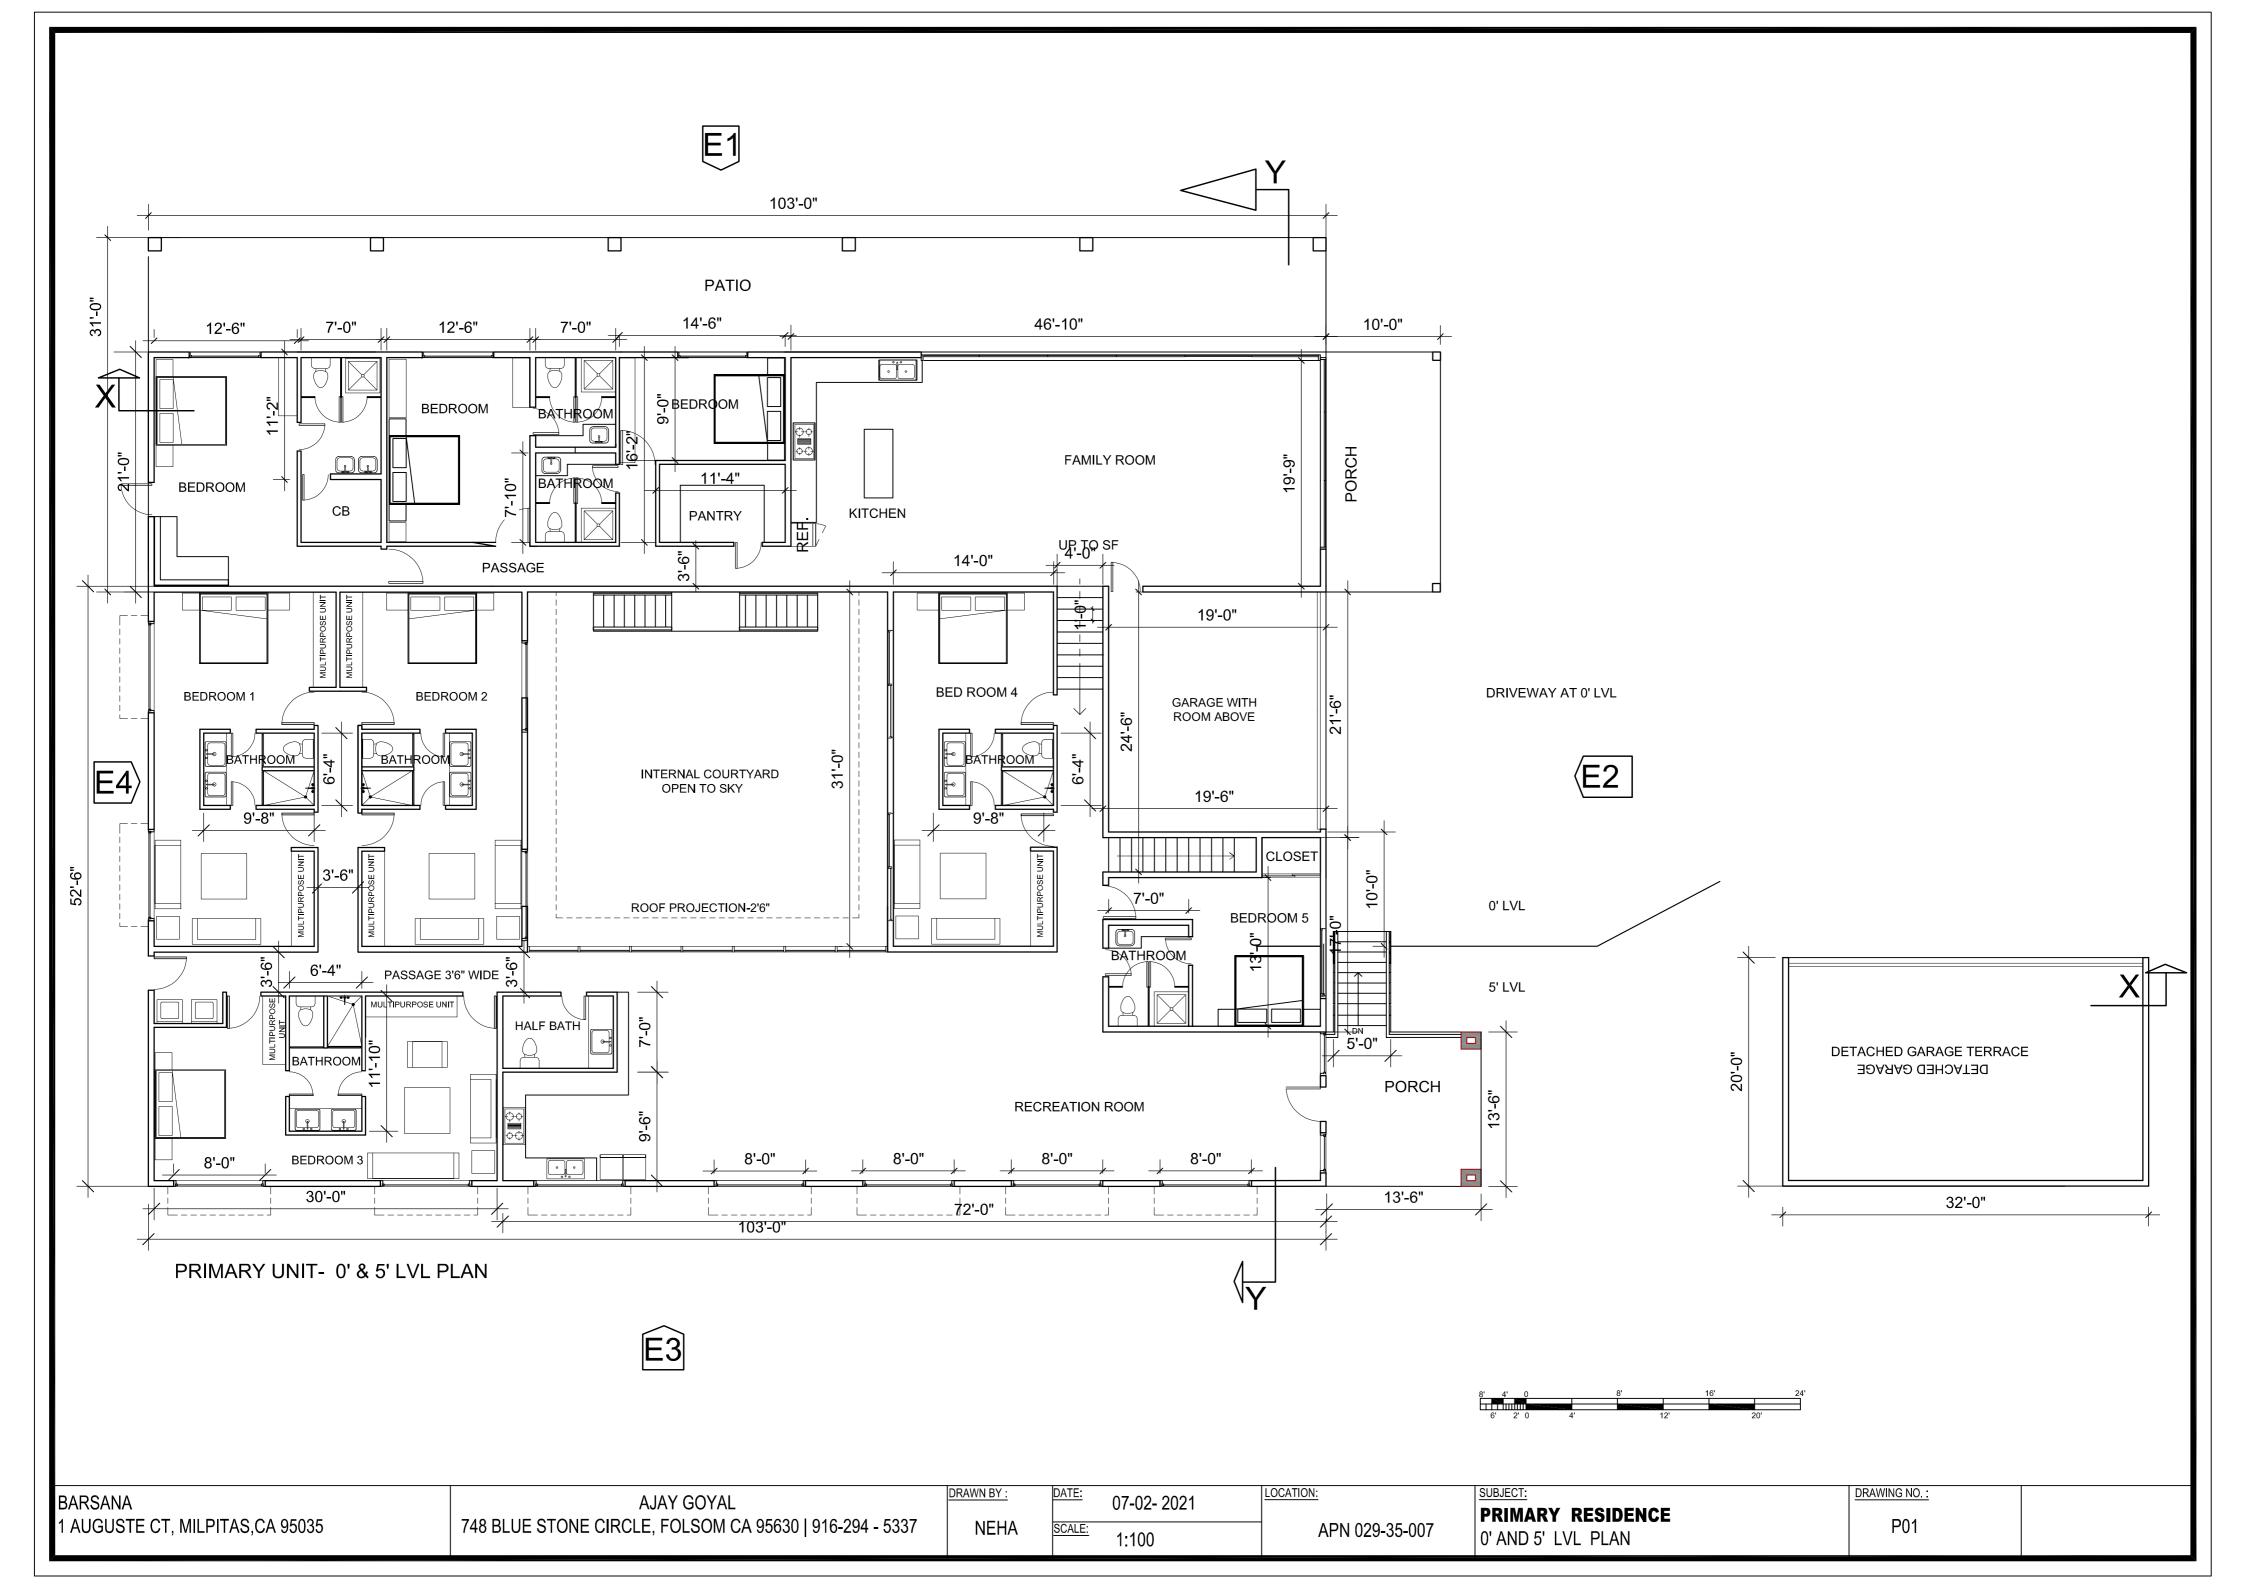


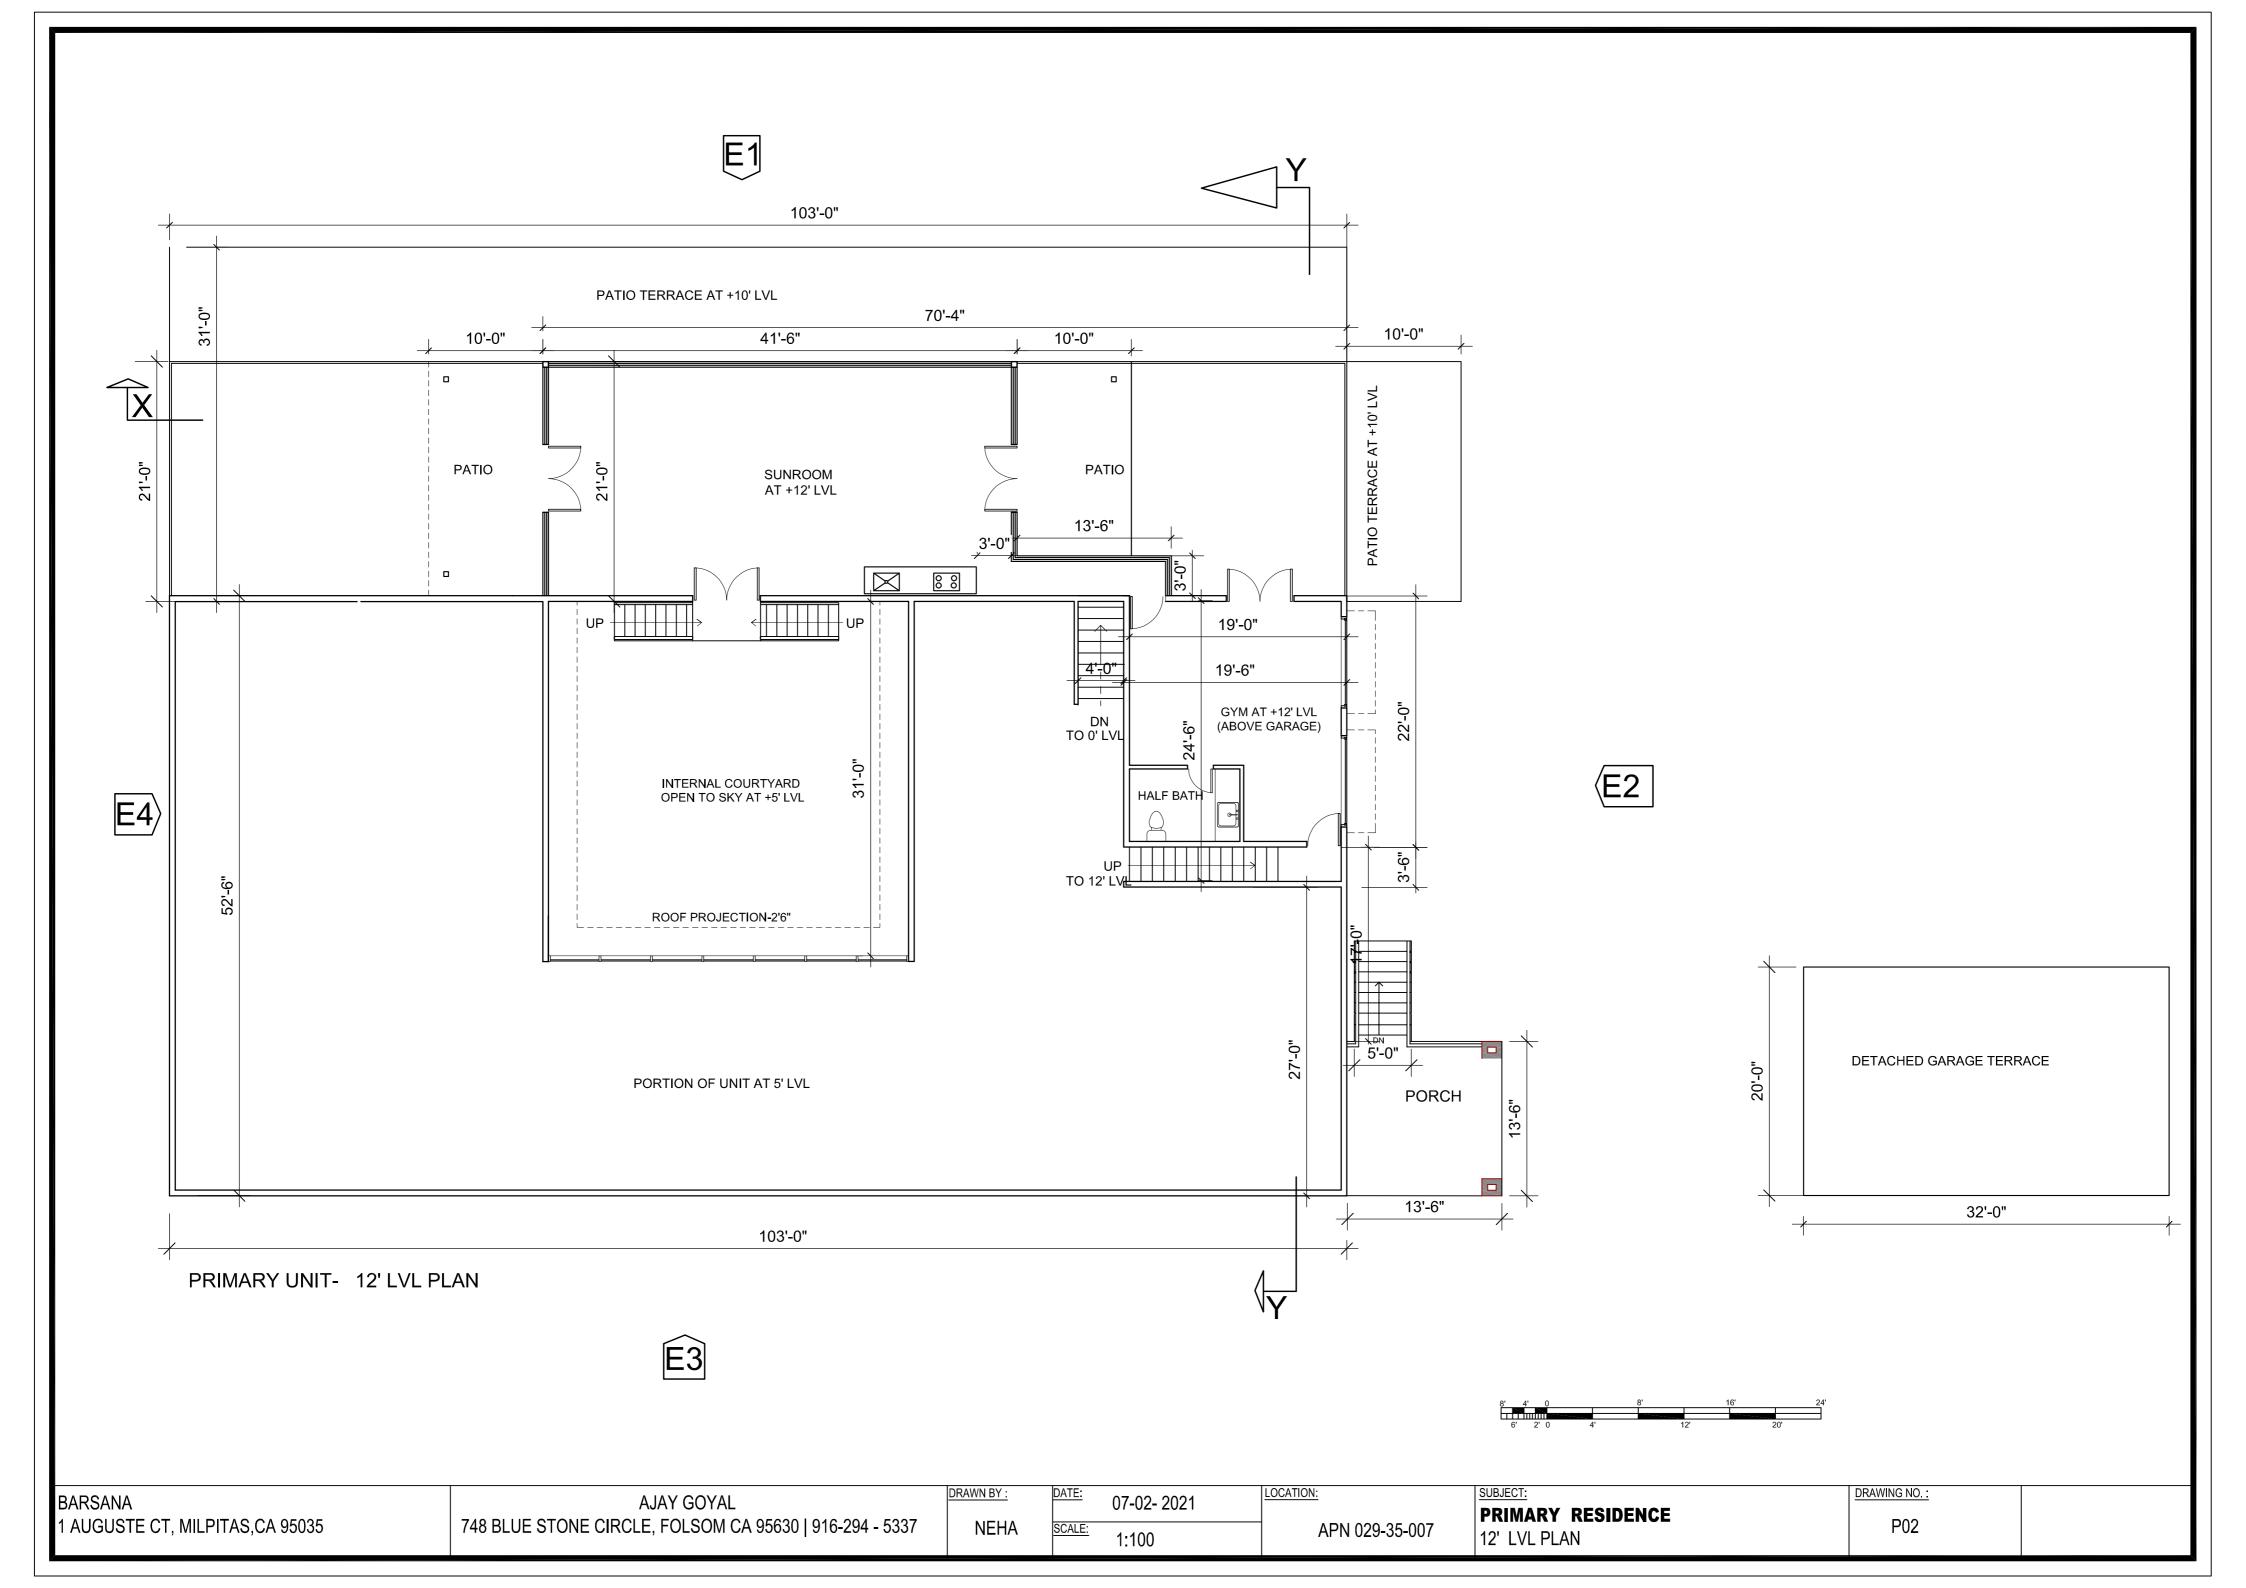


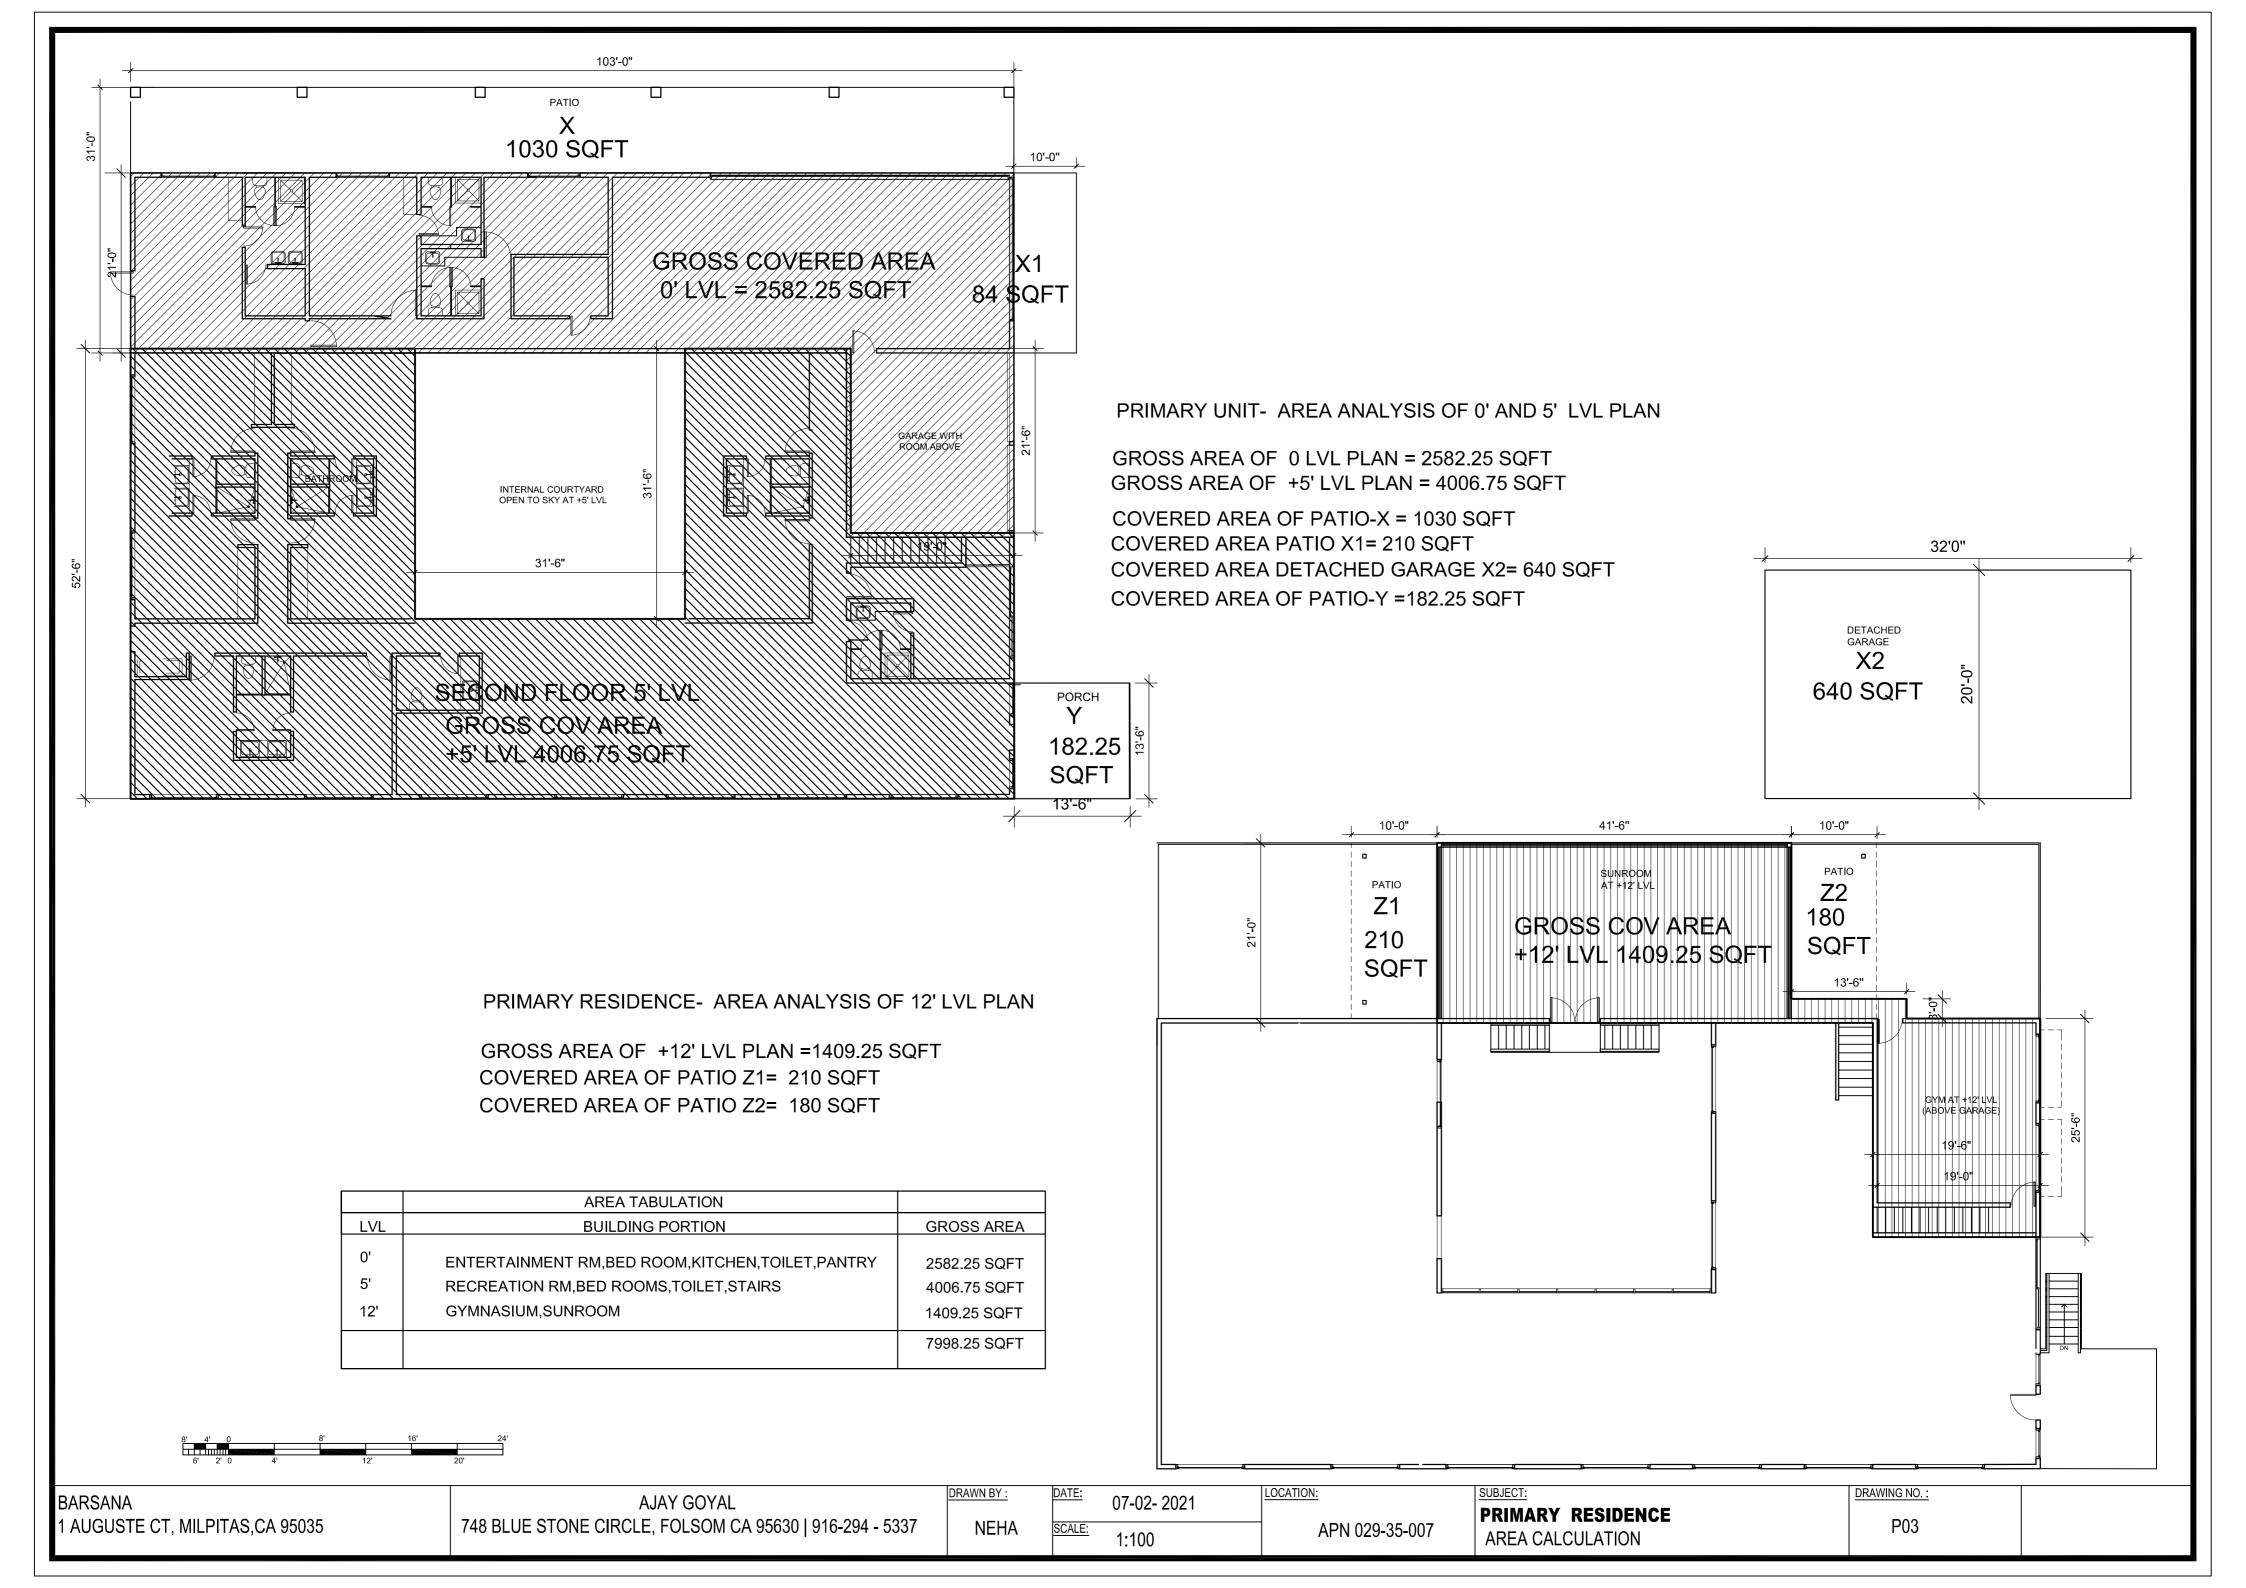


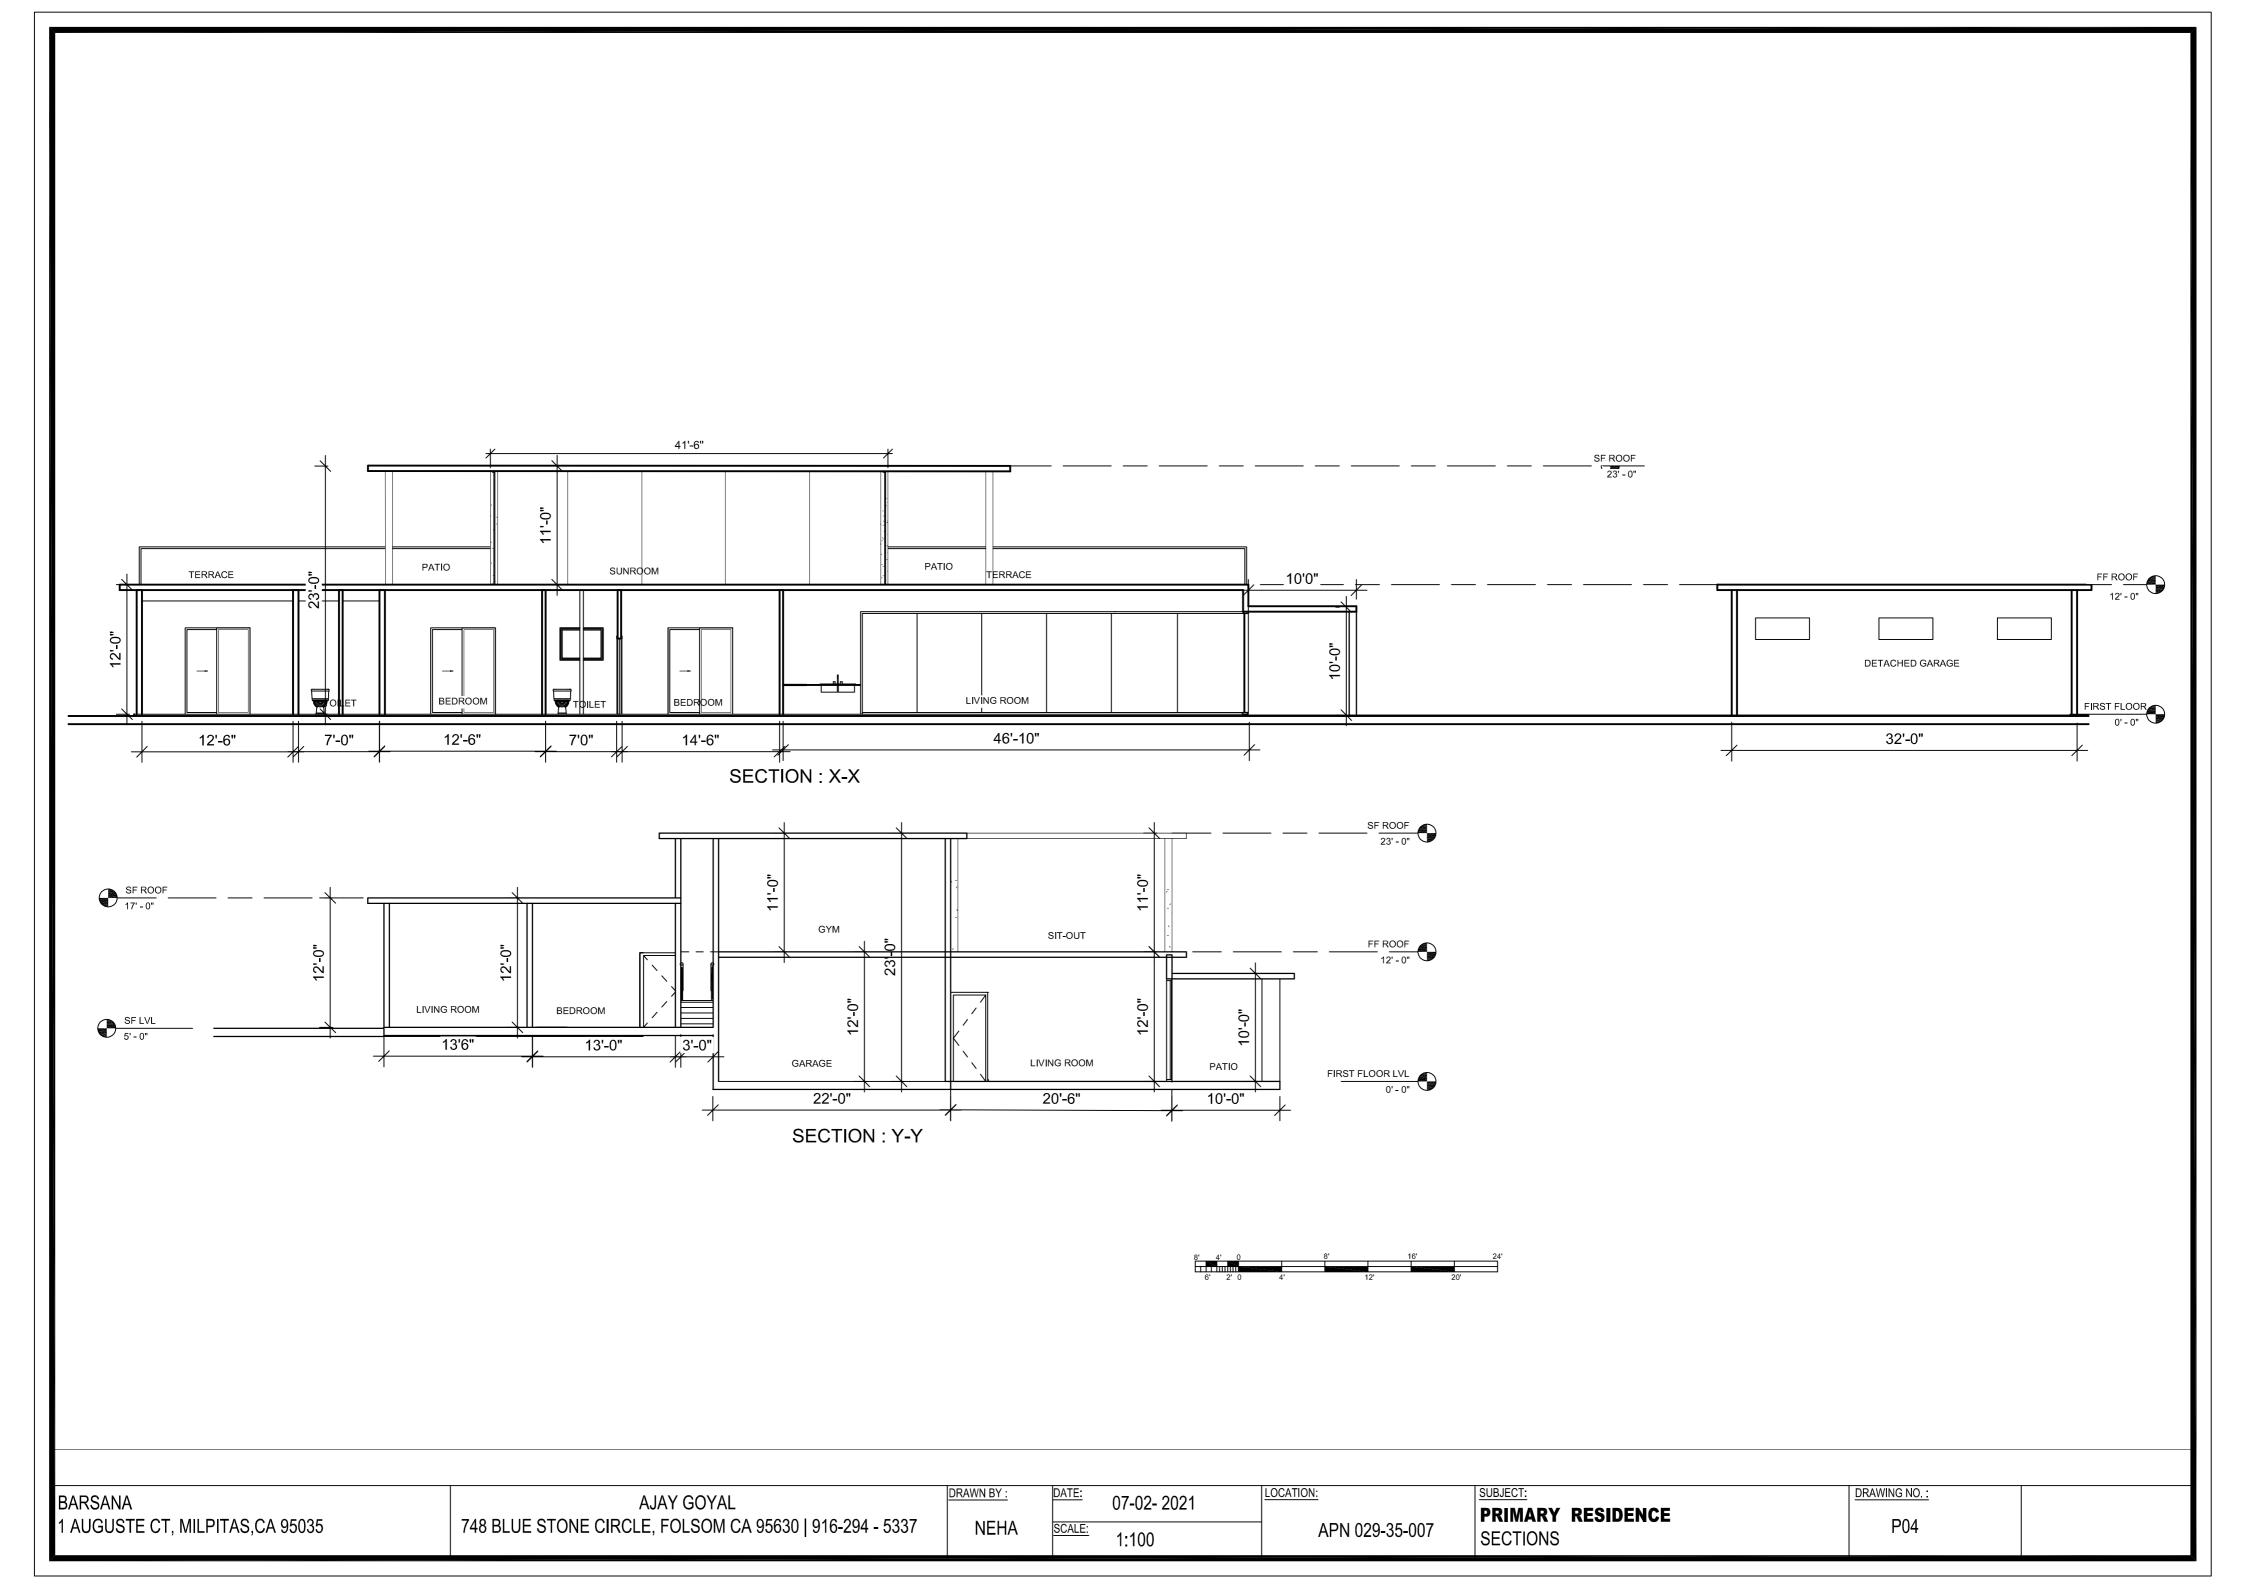


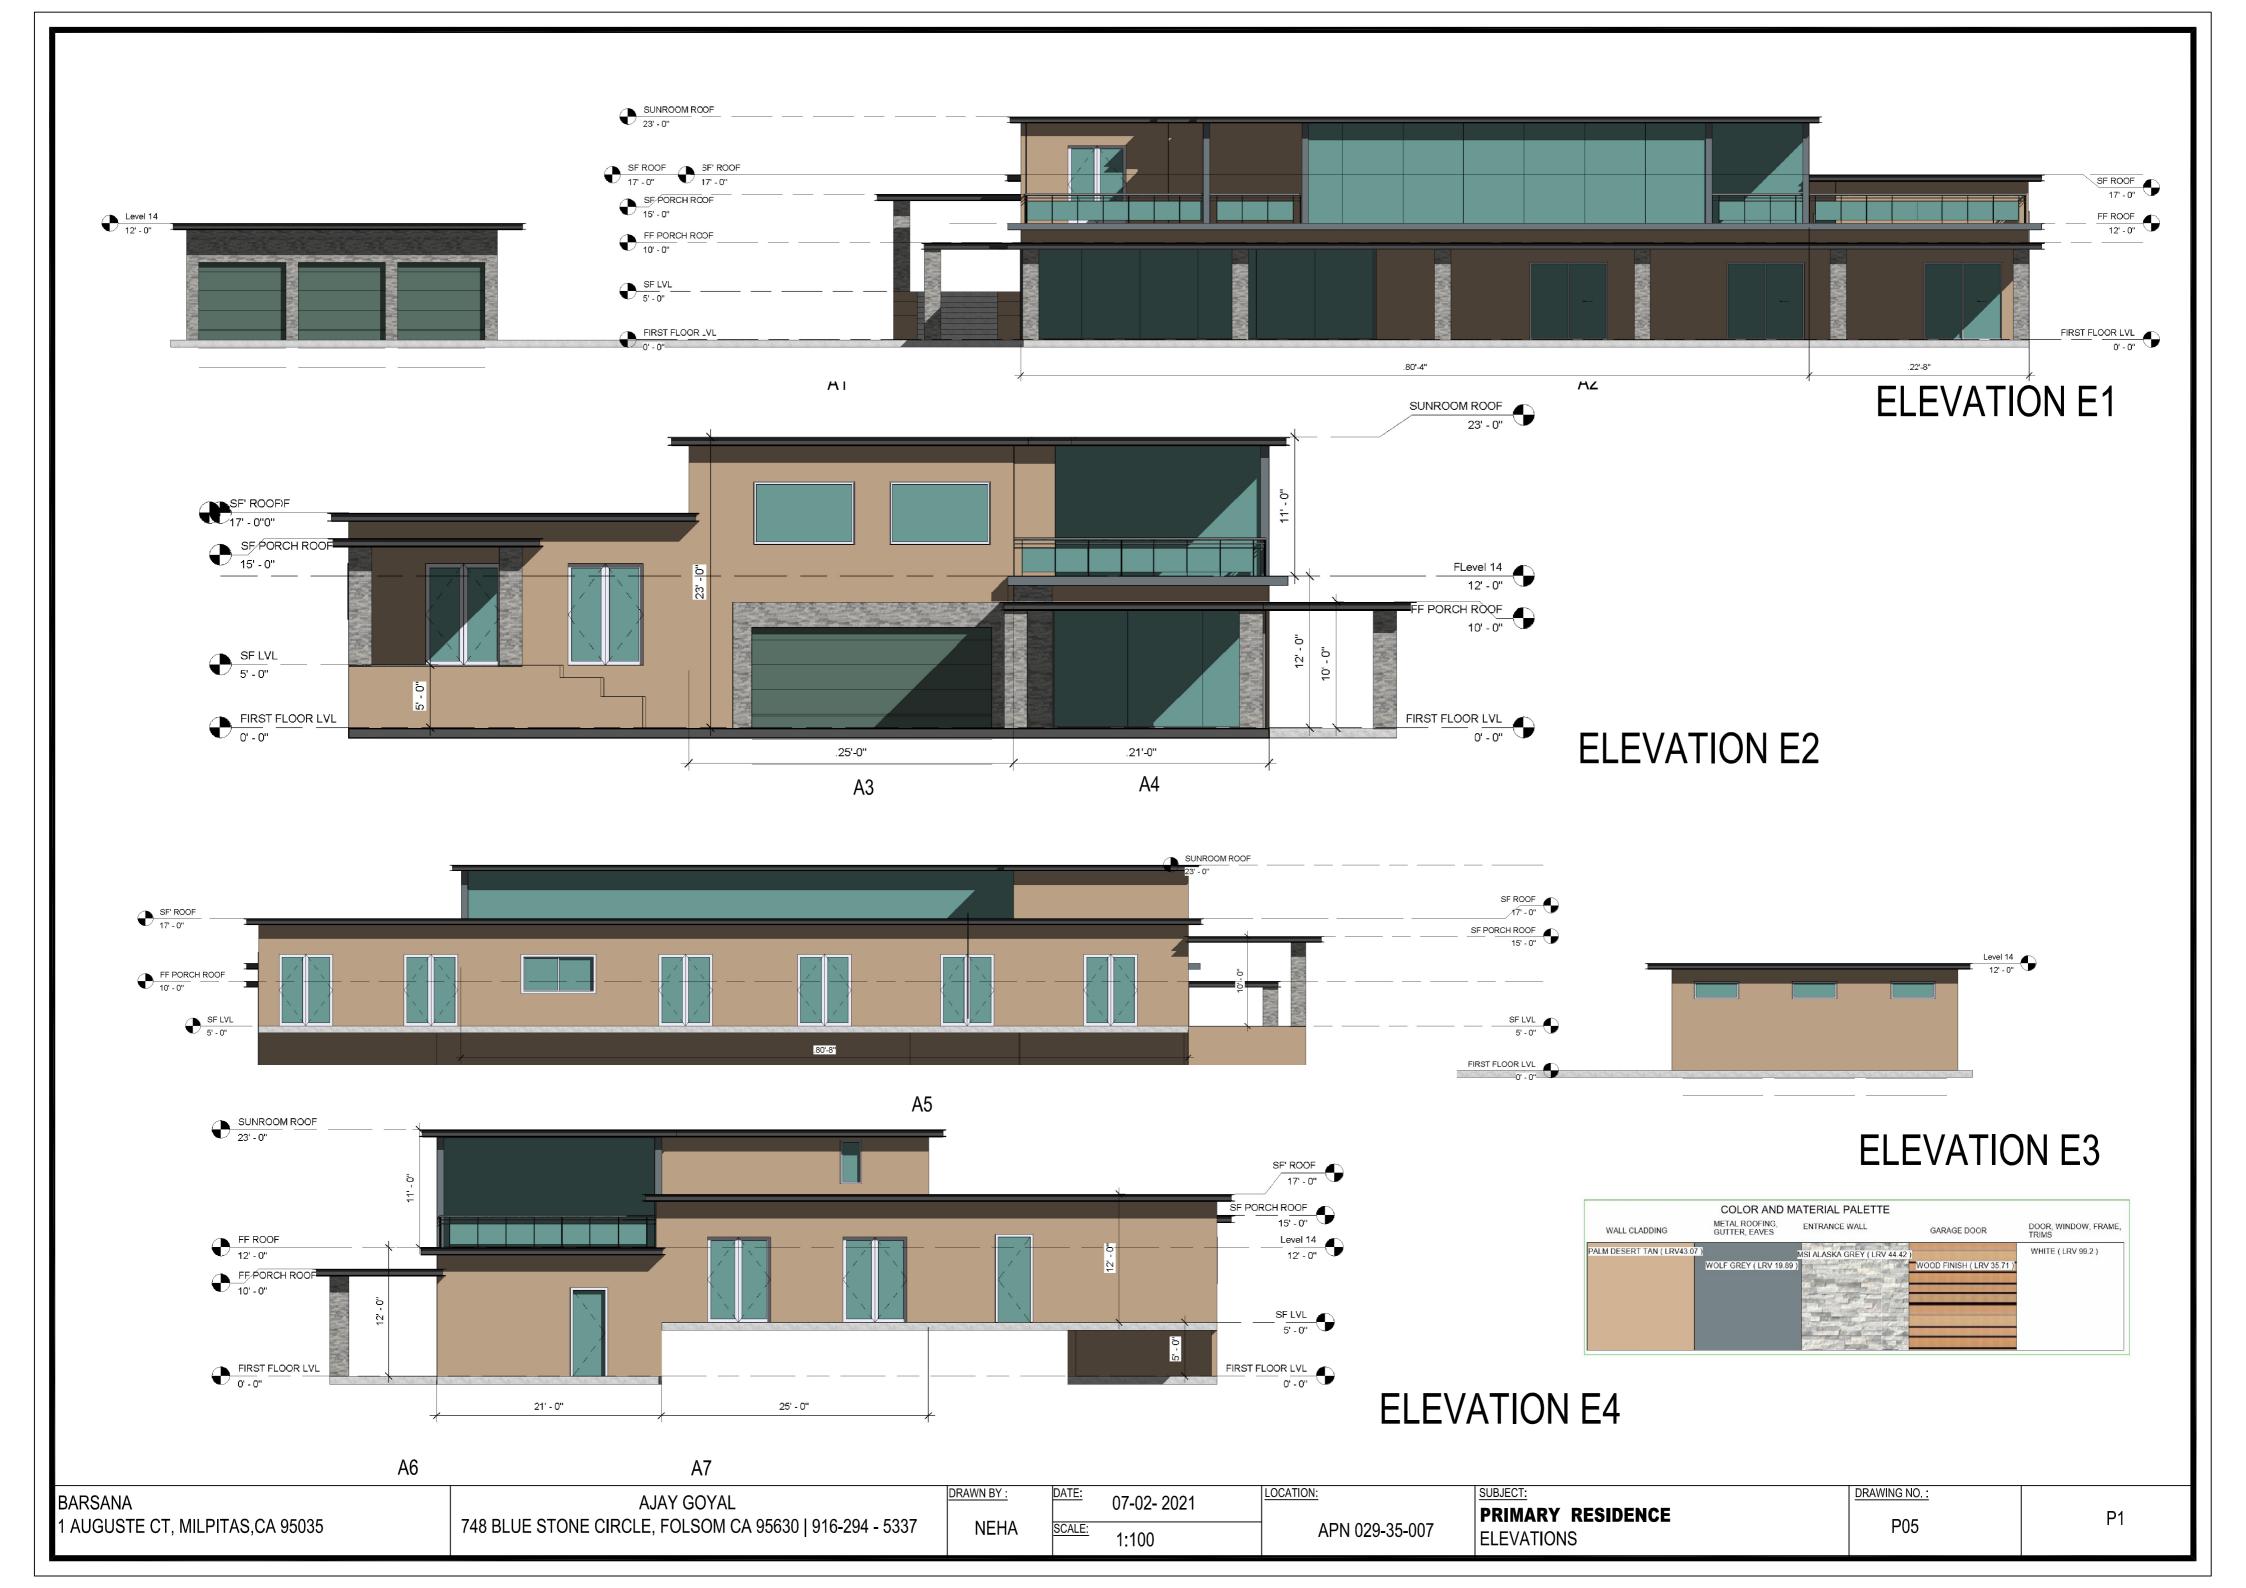


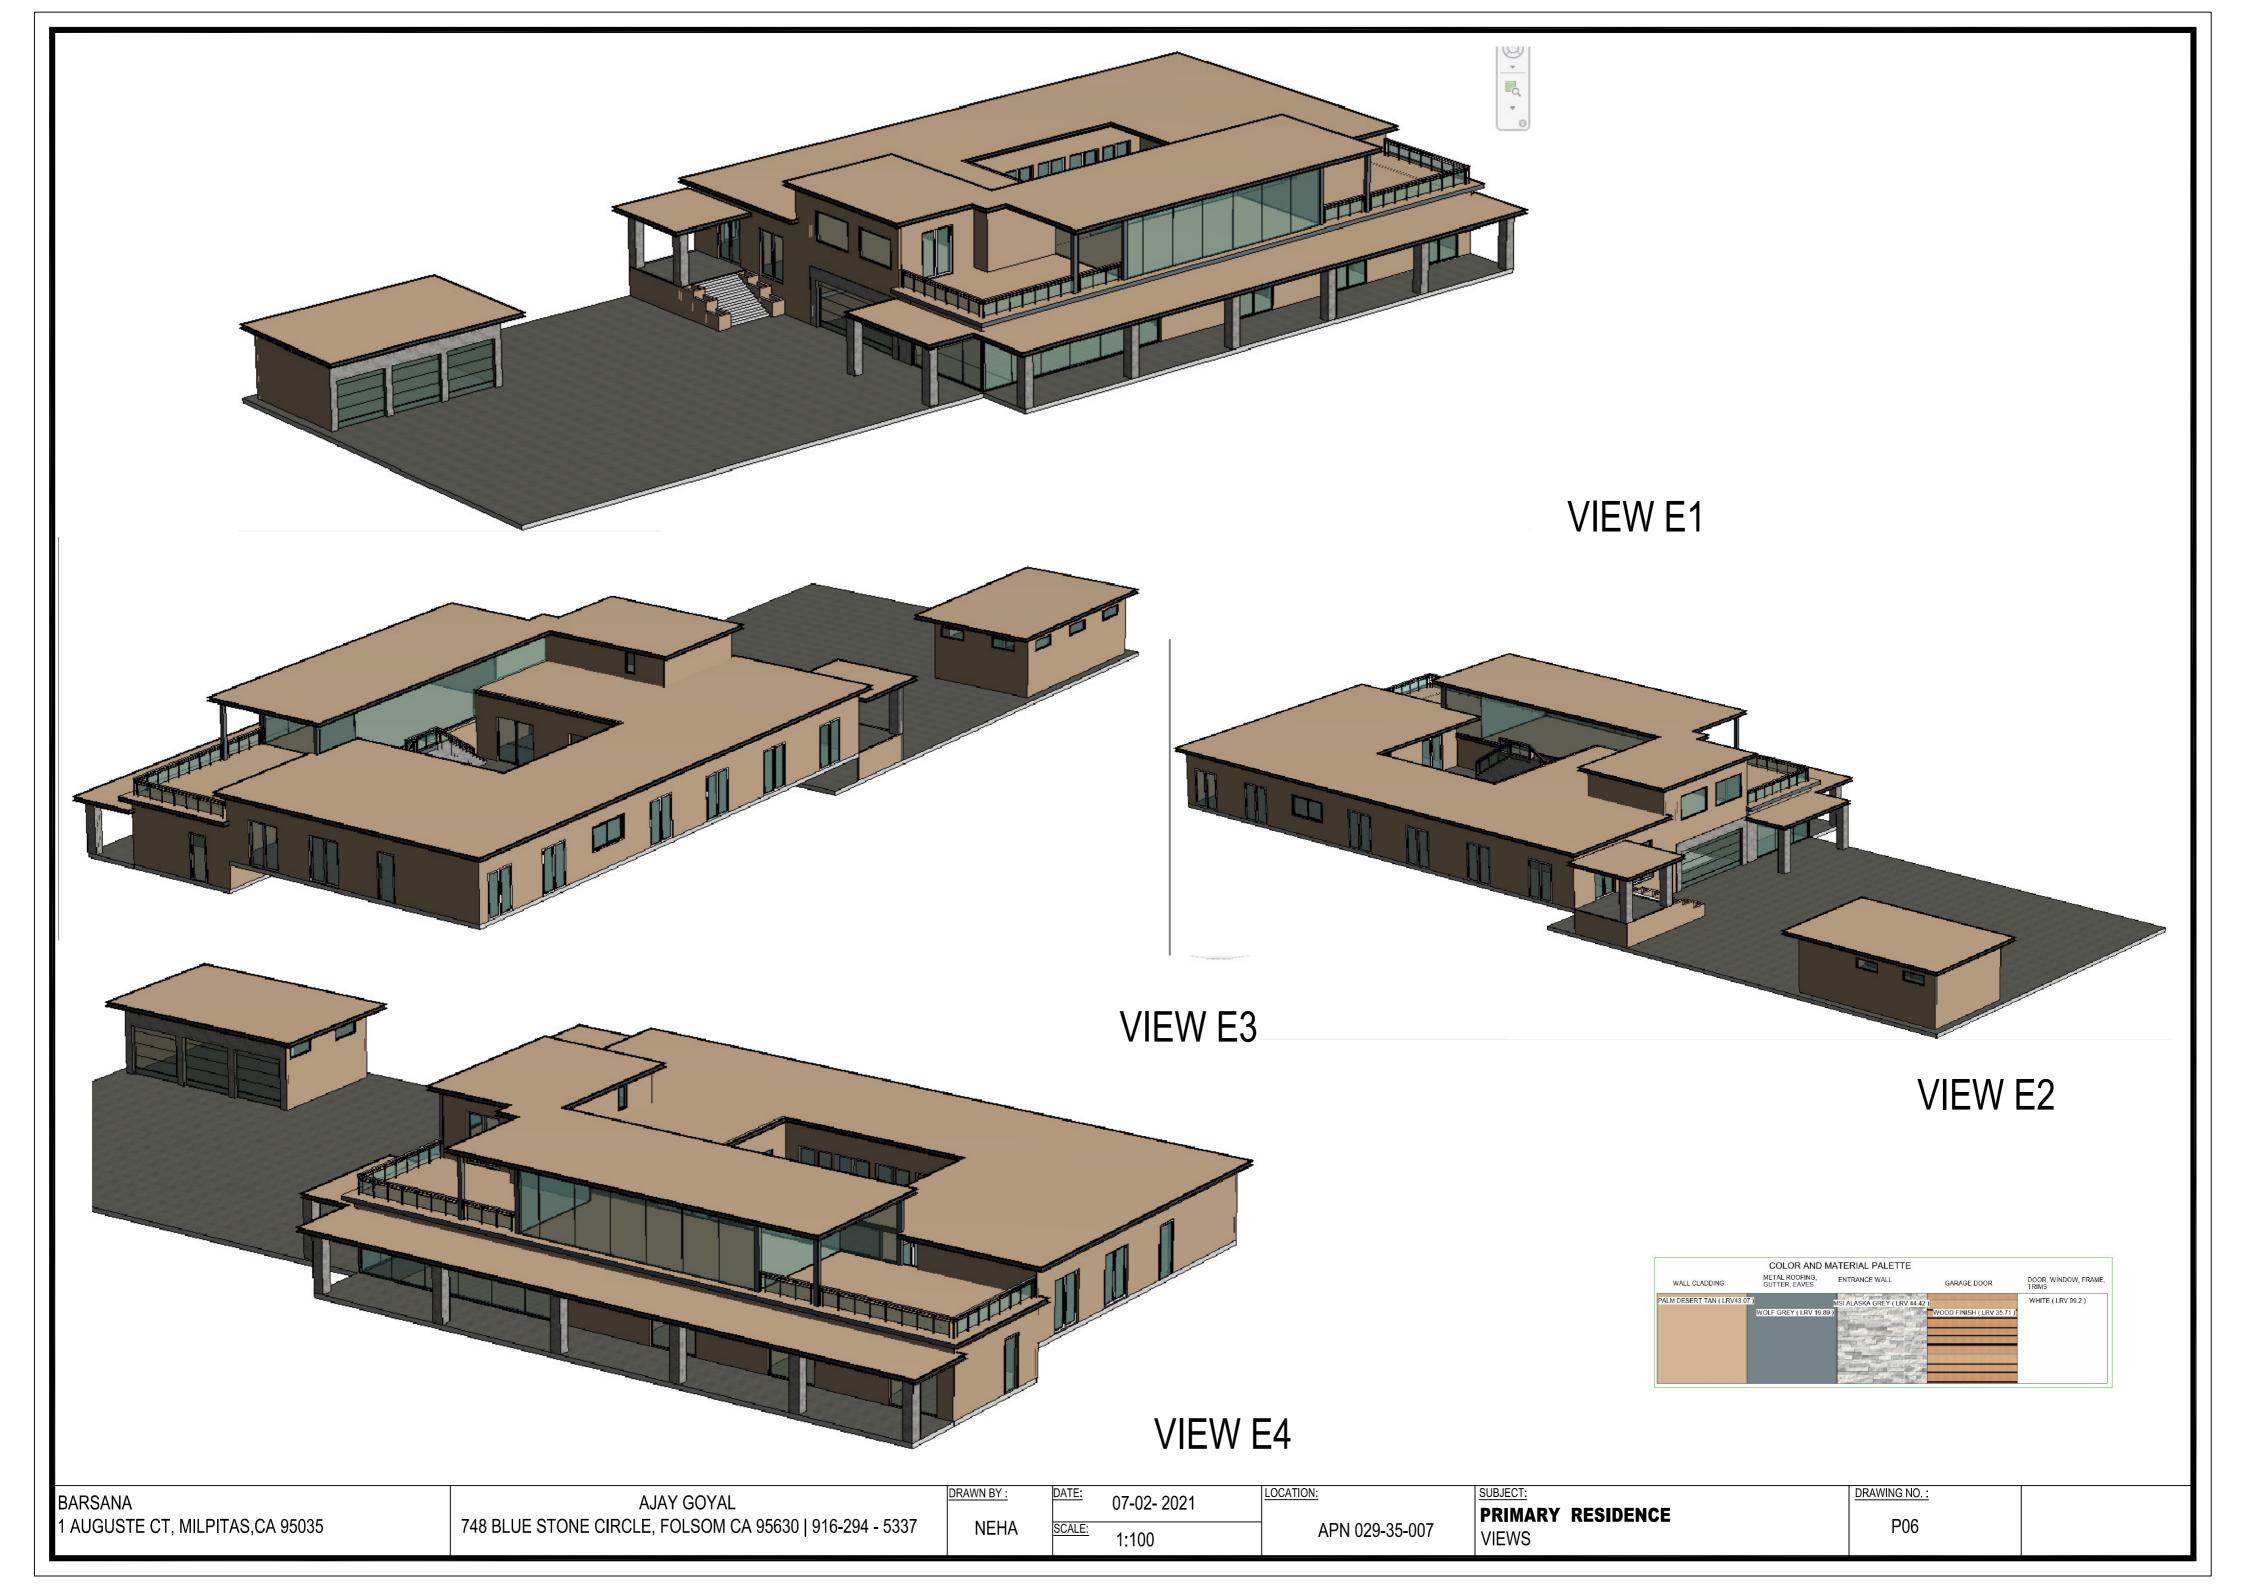

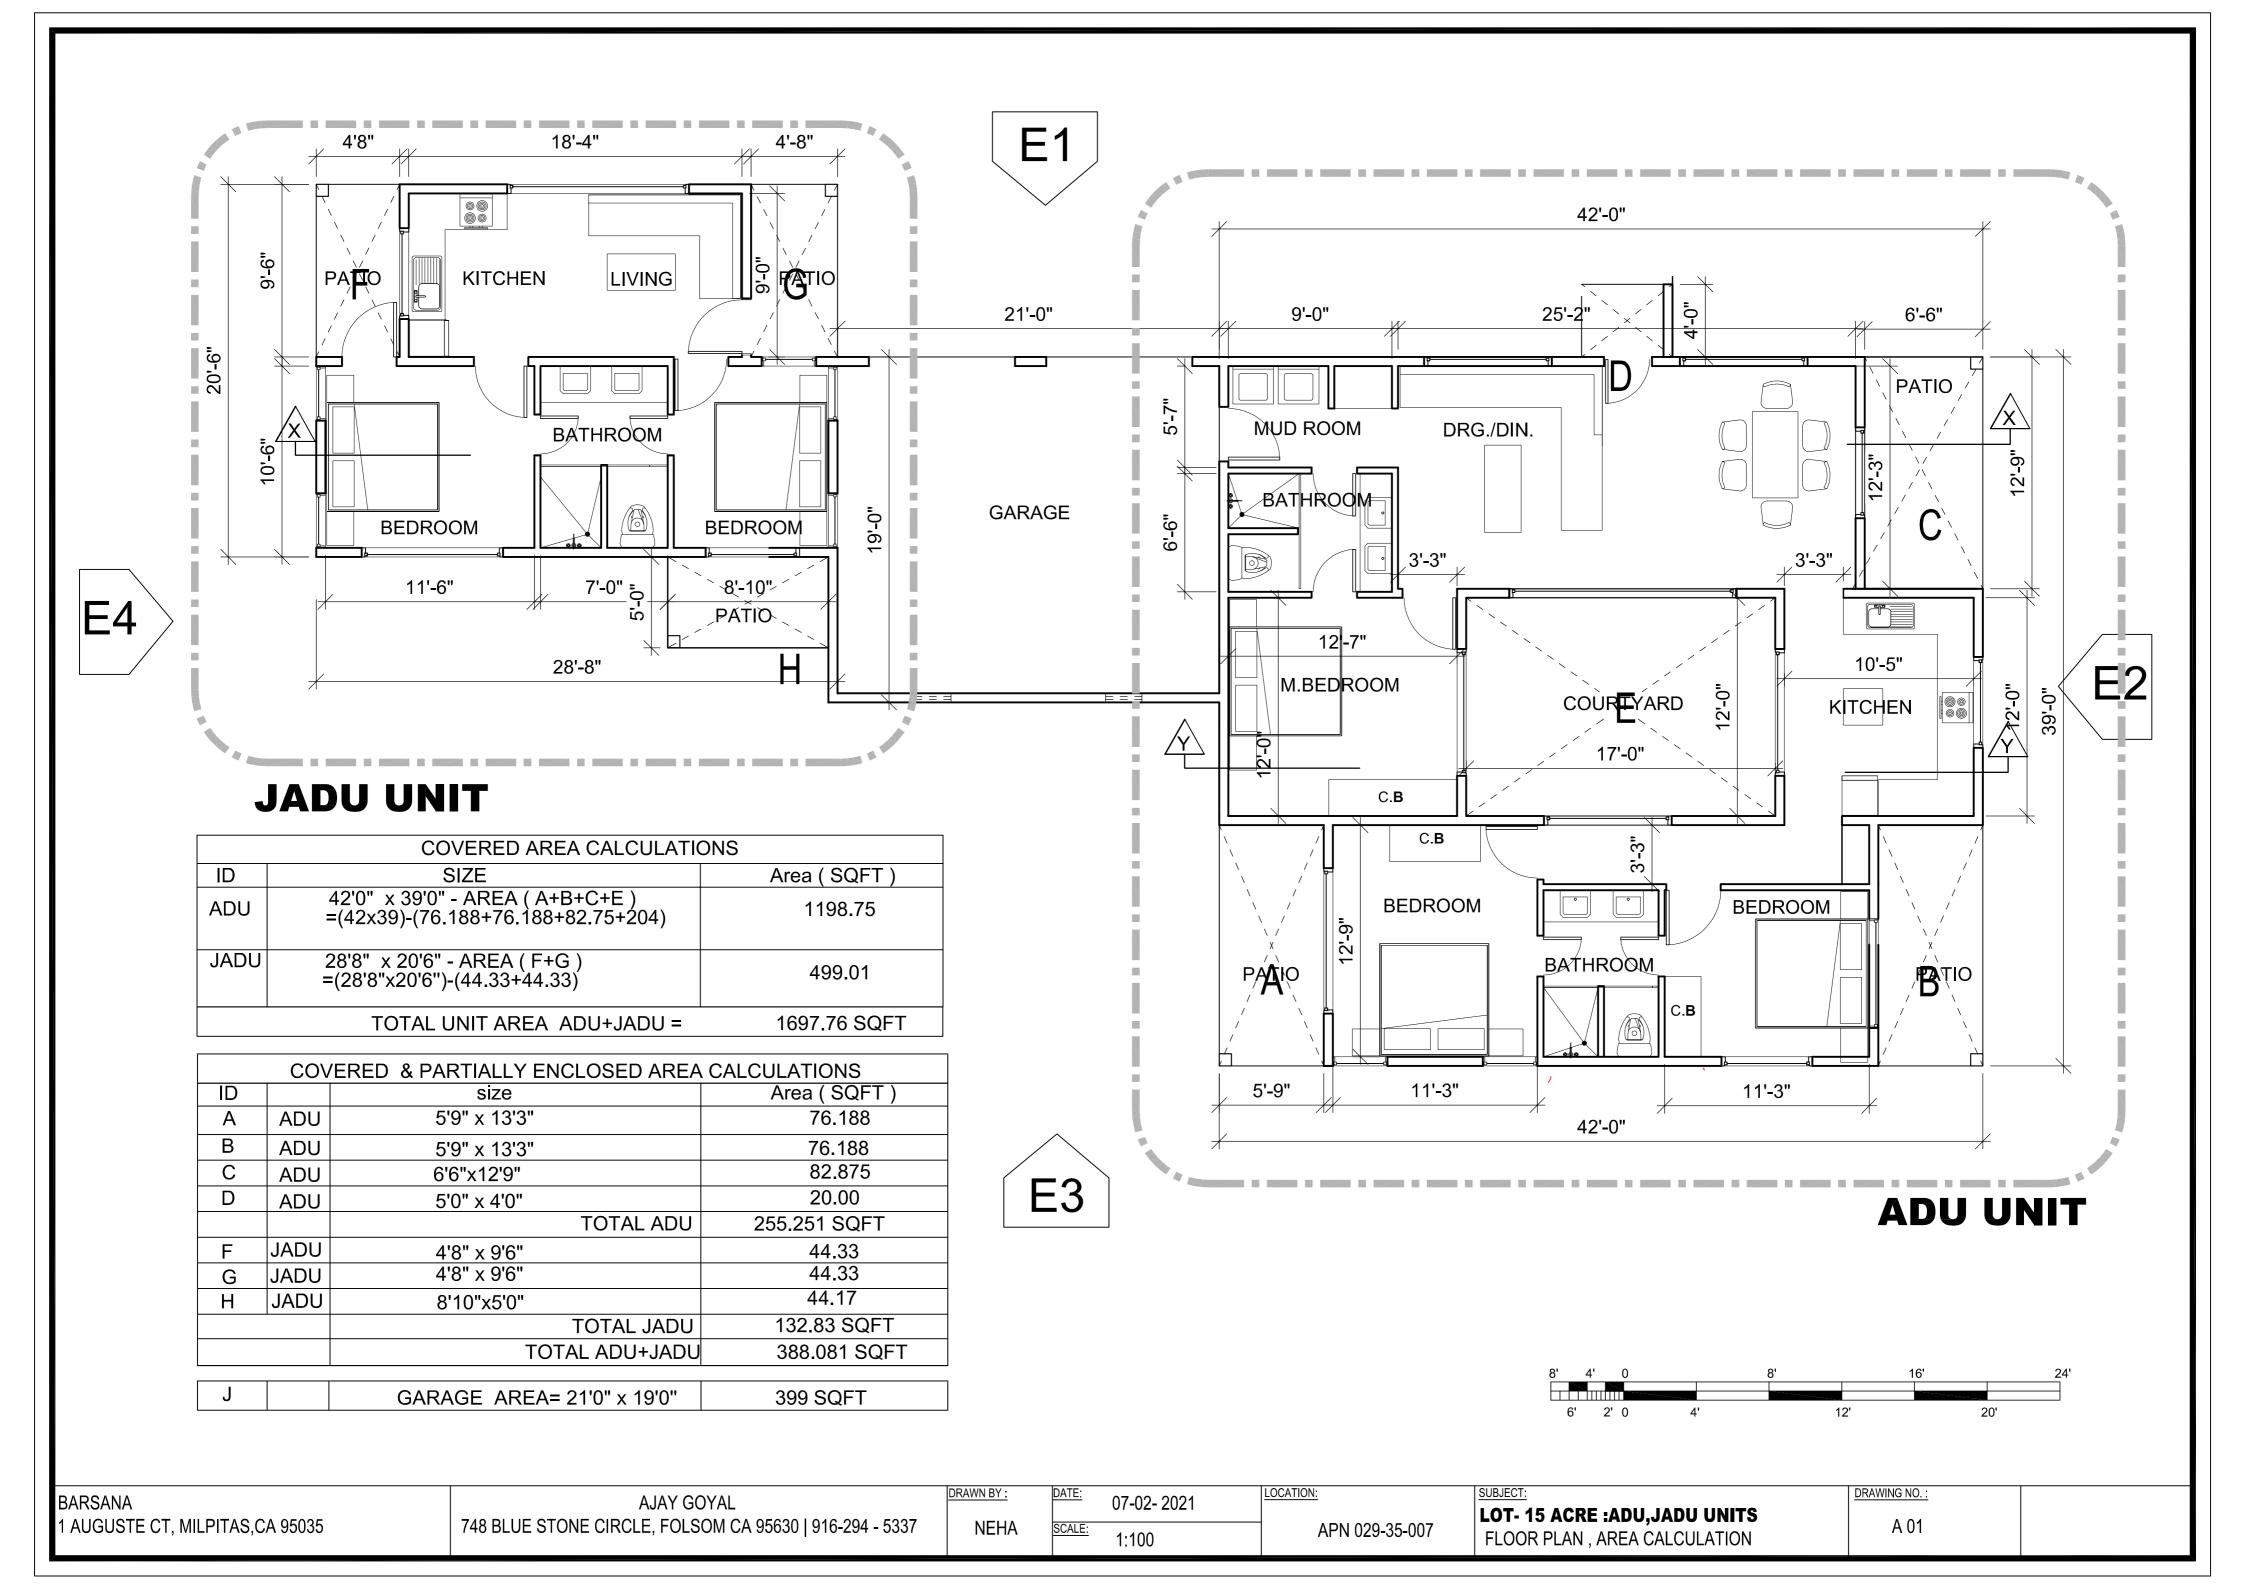

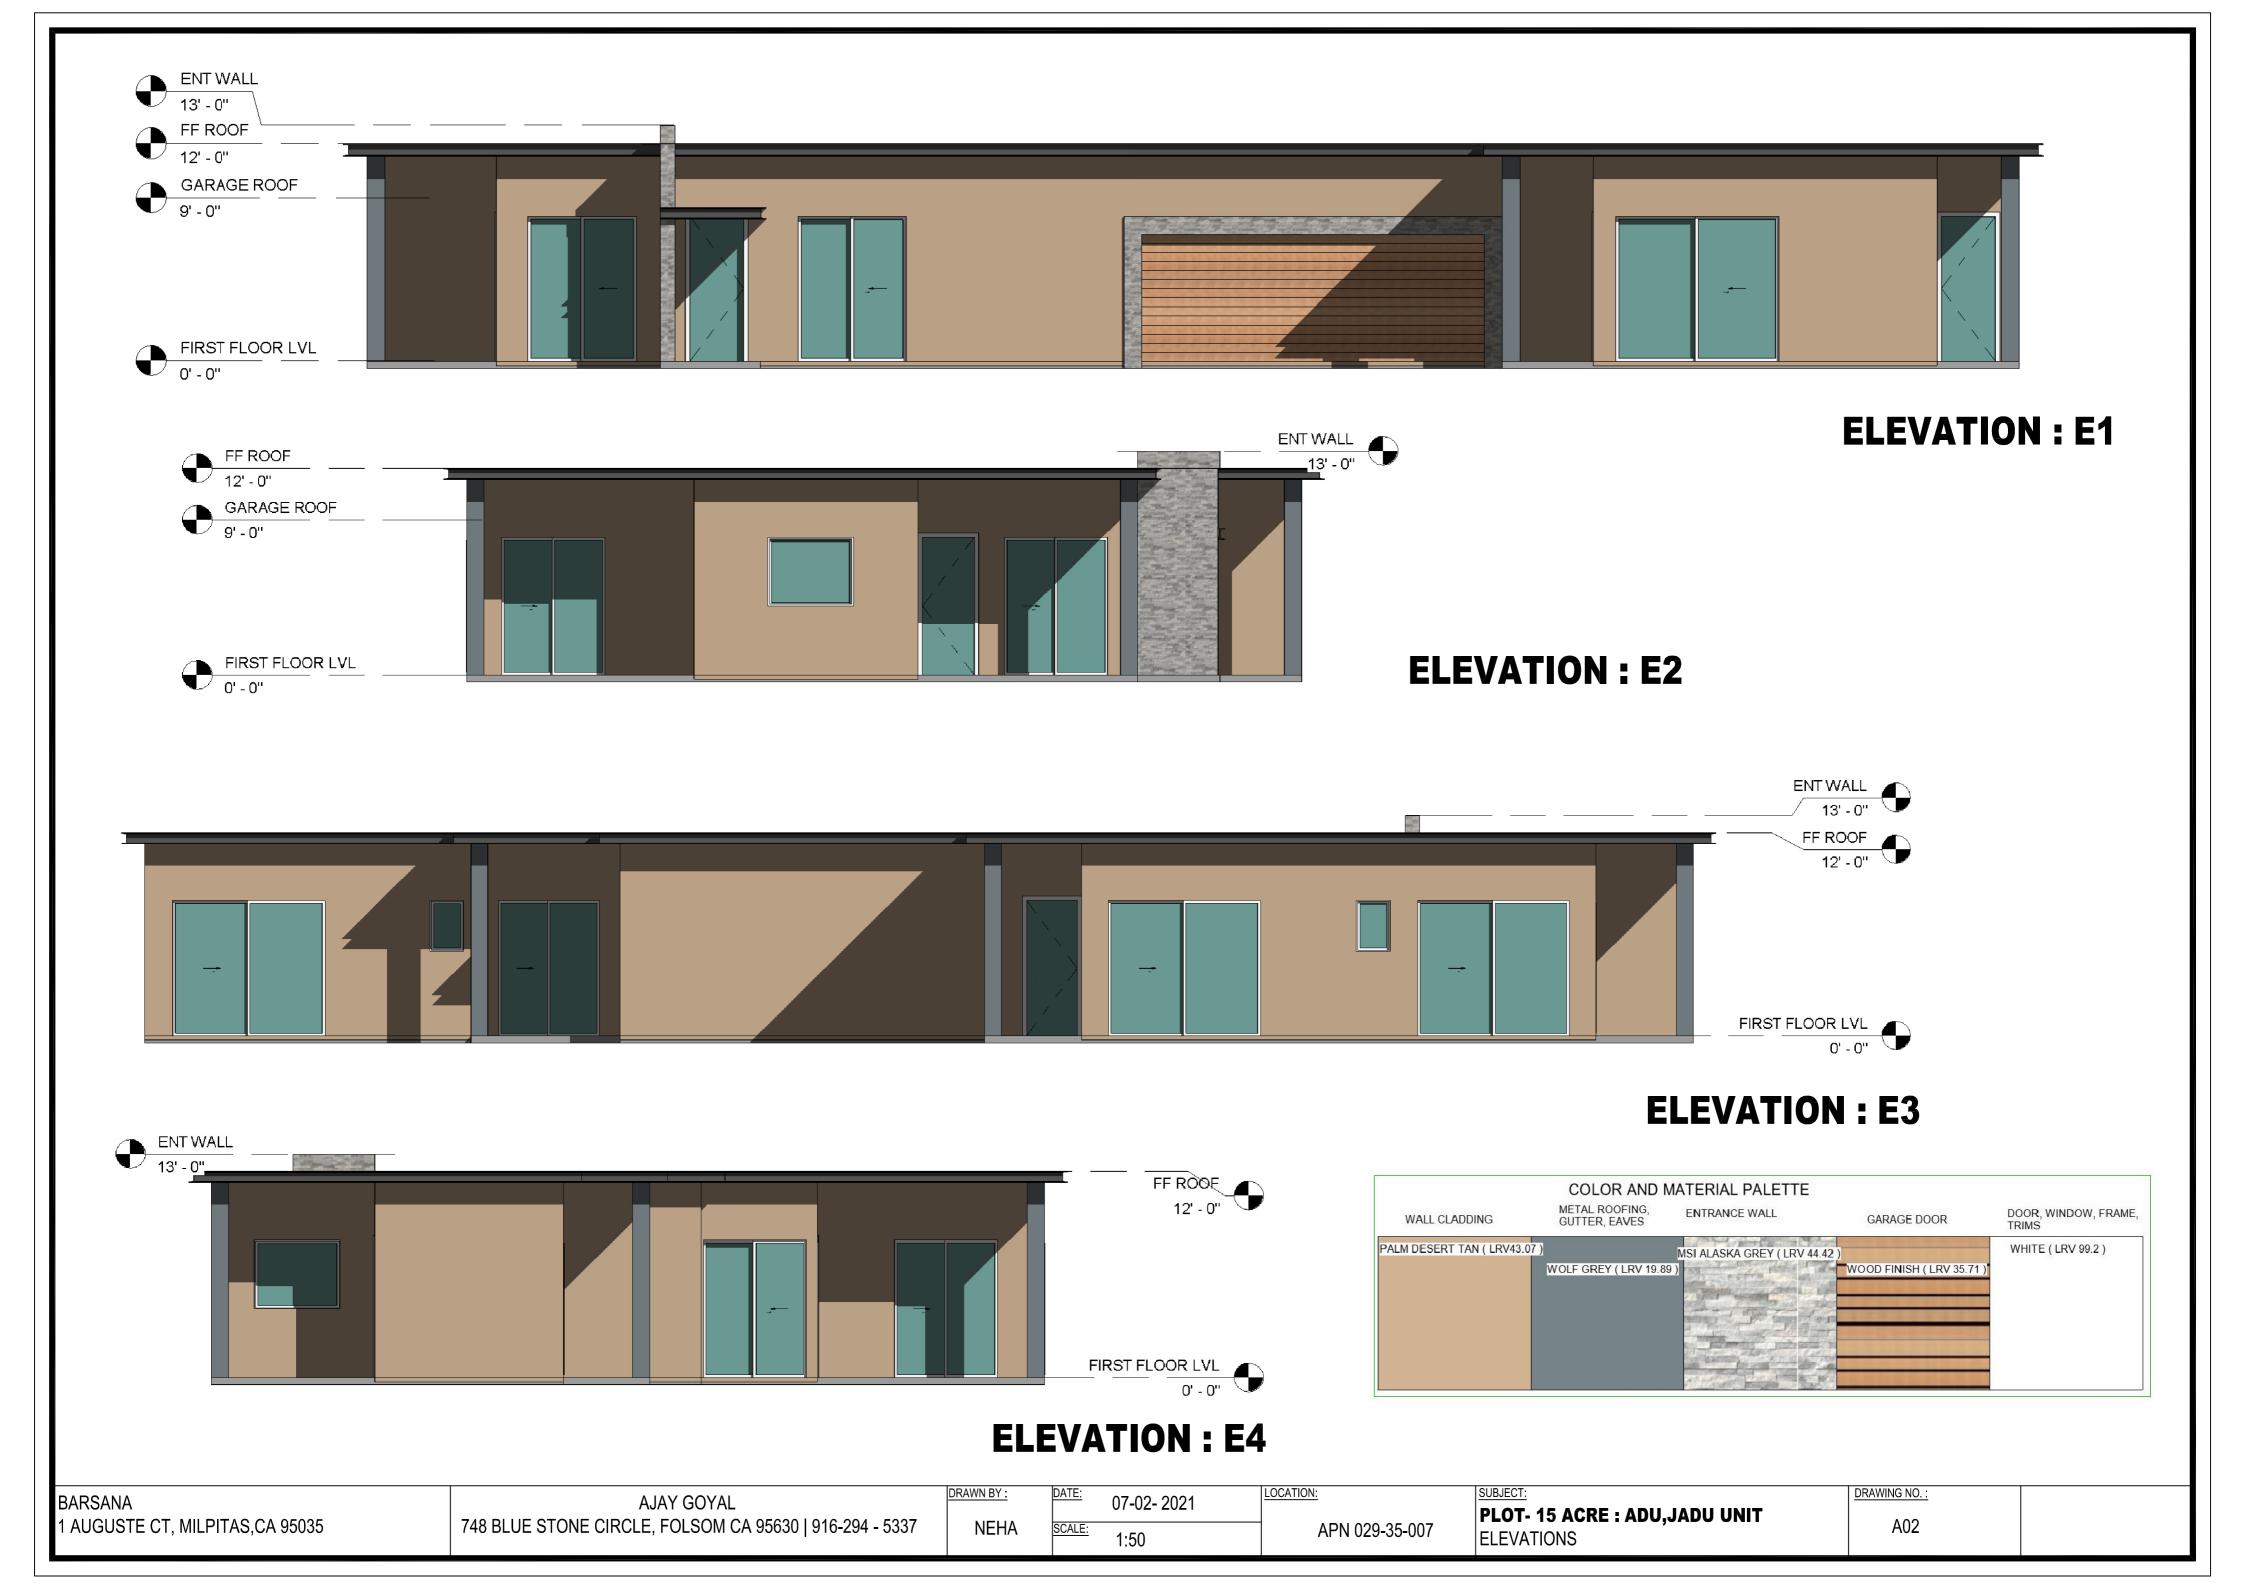


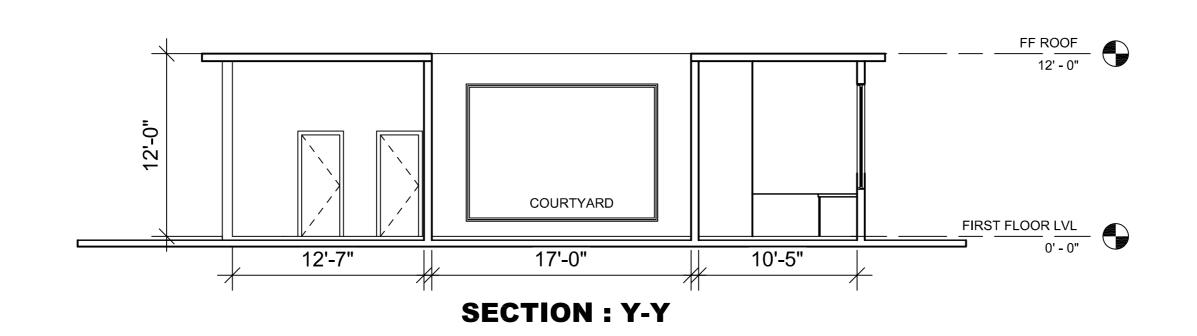


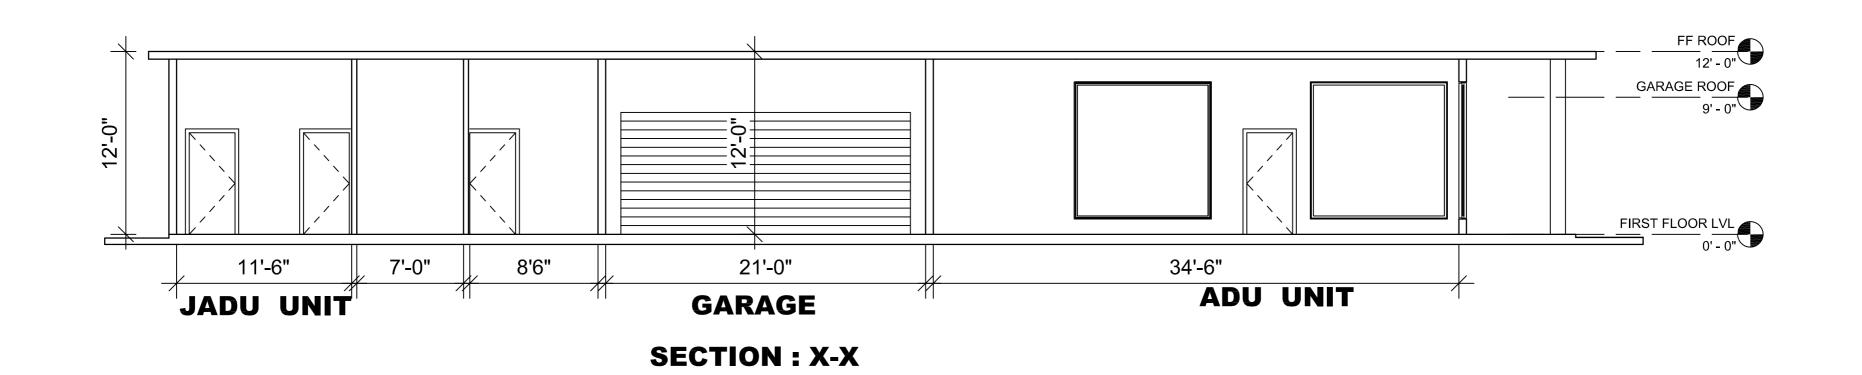



BARSANA 1 AUGUSTE CT, MILPITAS,CA 95035	AJAY GOYAL 748 BLUE STONE CIRCLE, FOLSOM CA 95630 916-294 - 5337	DRAWN BY: NEHA	DATE: 07-02- 2021 SCALE: 1:50	APN 029-35-007	SUBJECT: PLOT-15 ACRE: ADU, JADU UNIT SECTIONS	DRAWING NO.: A03	
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11'-0"

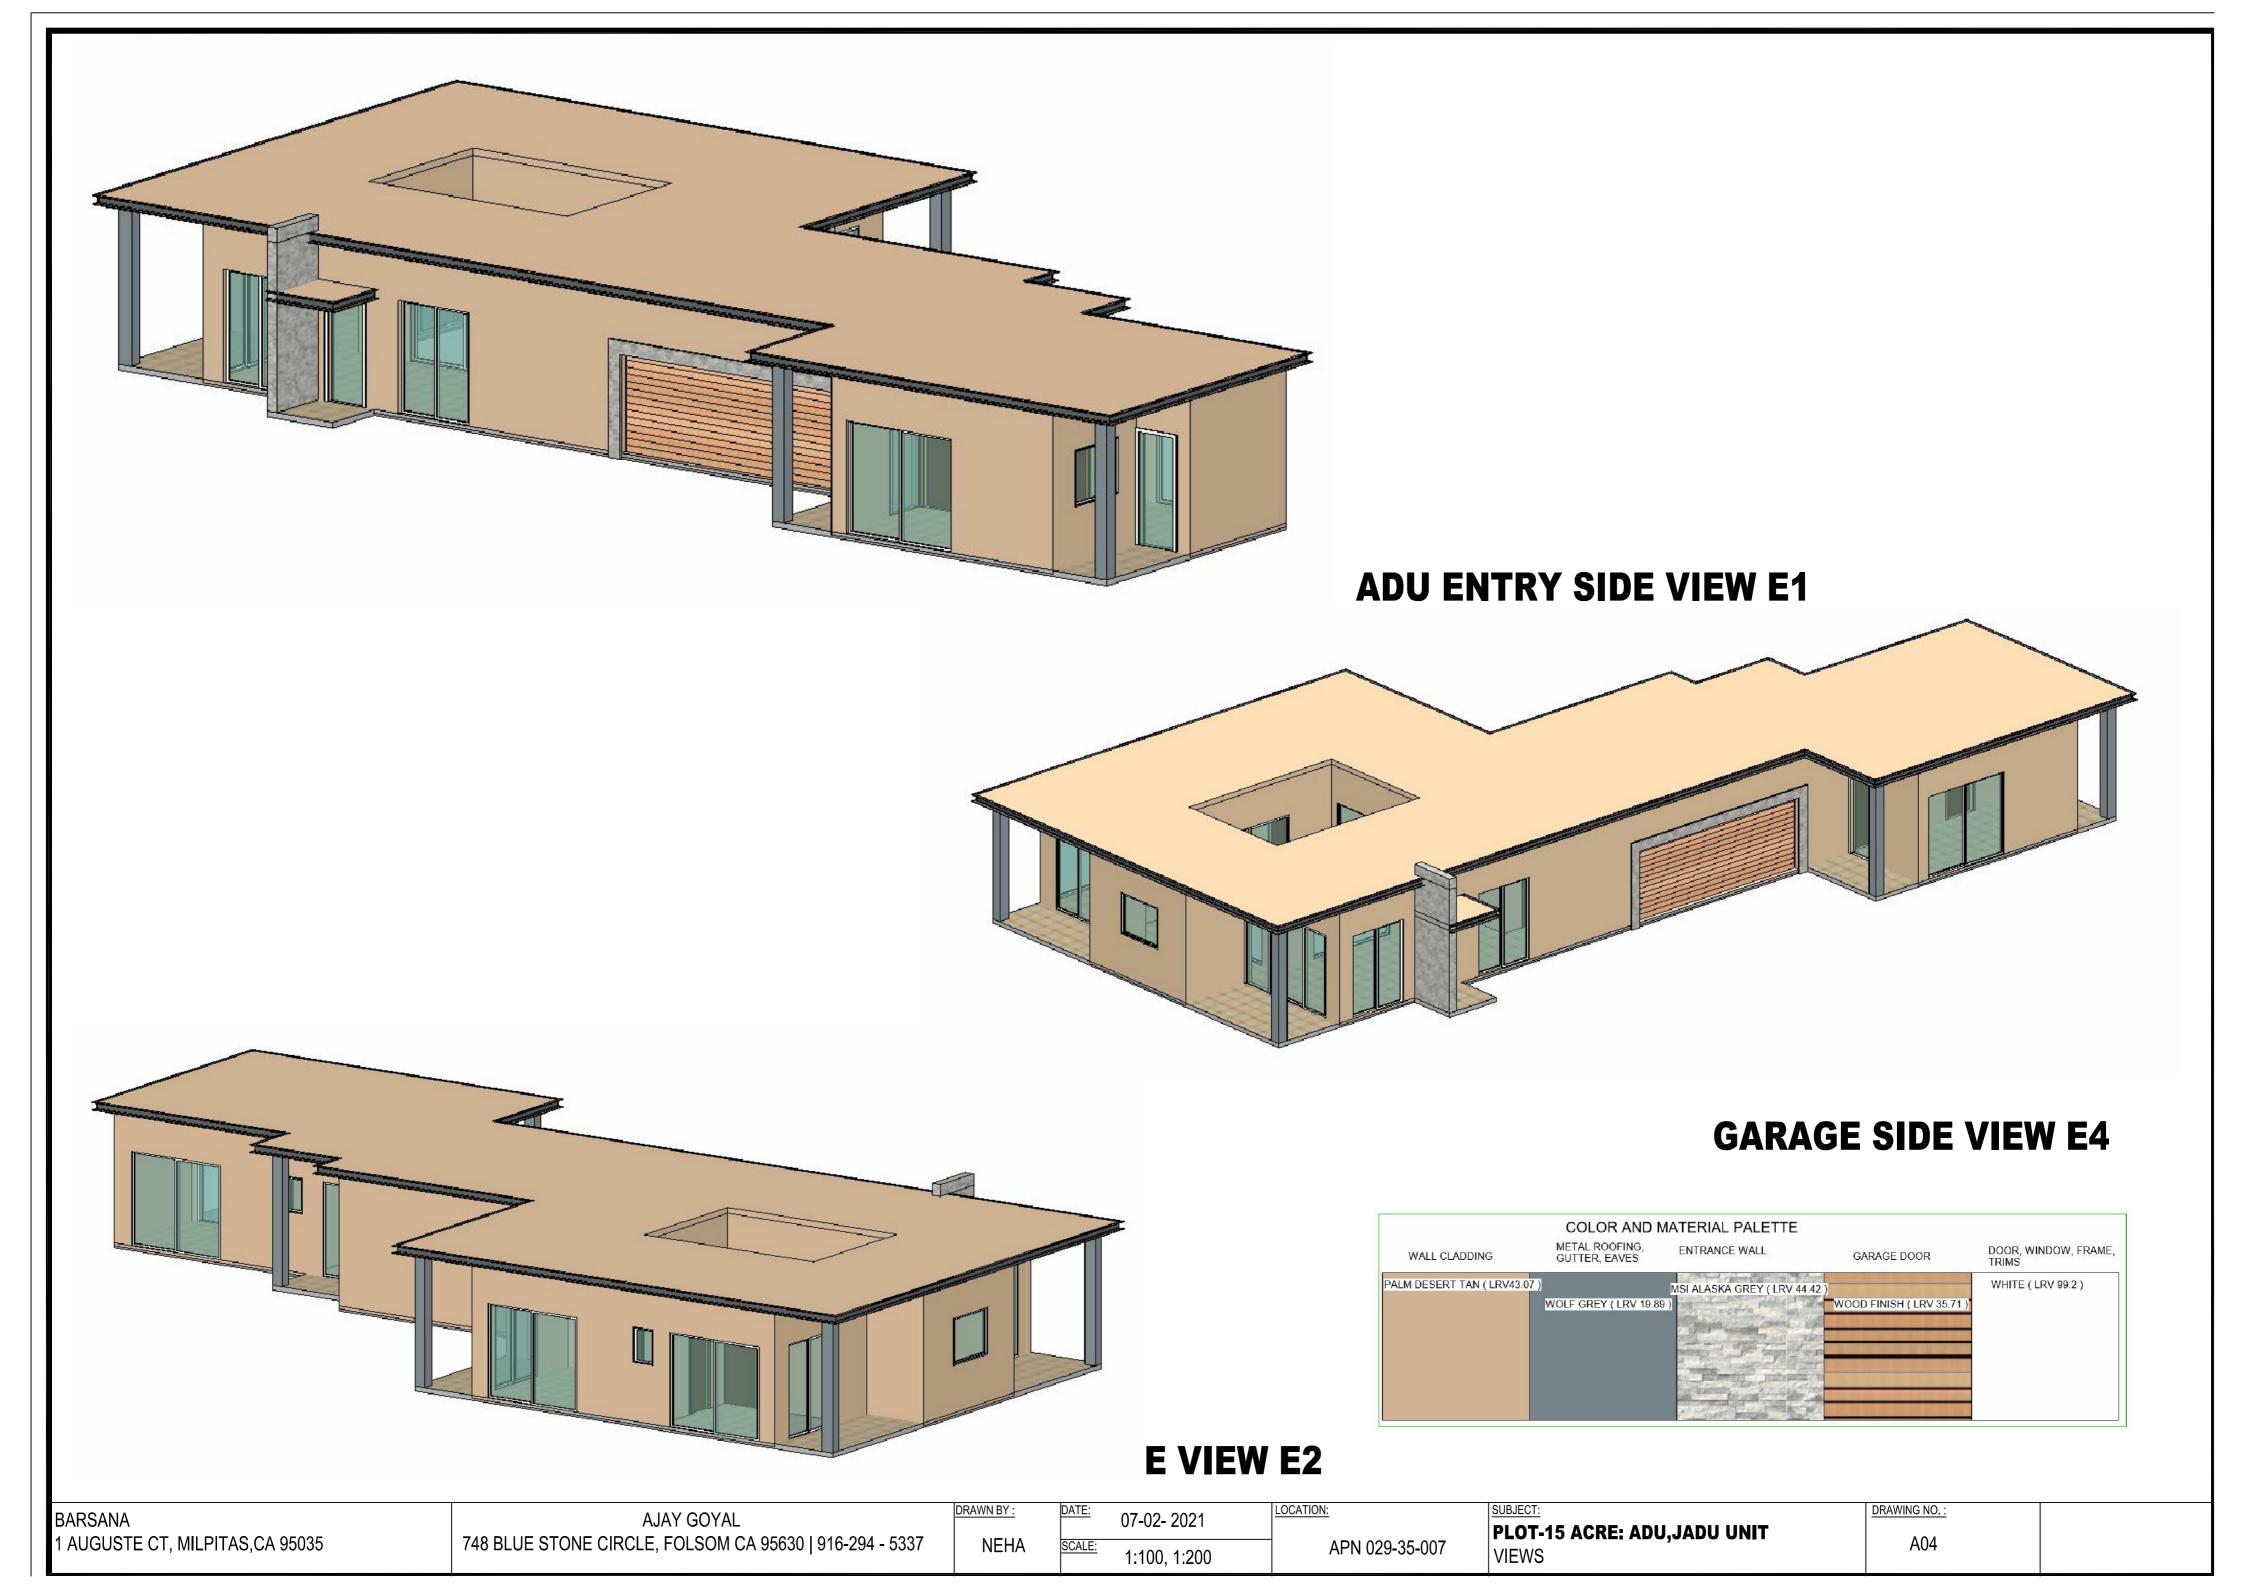7'-0"

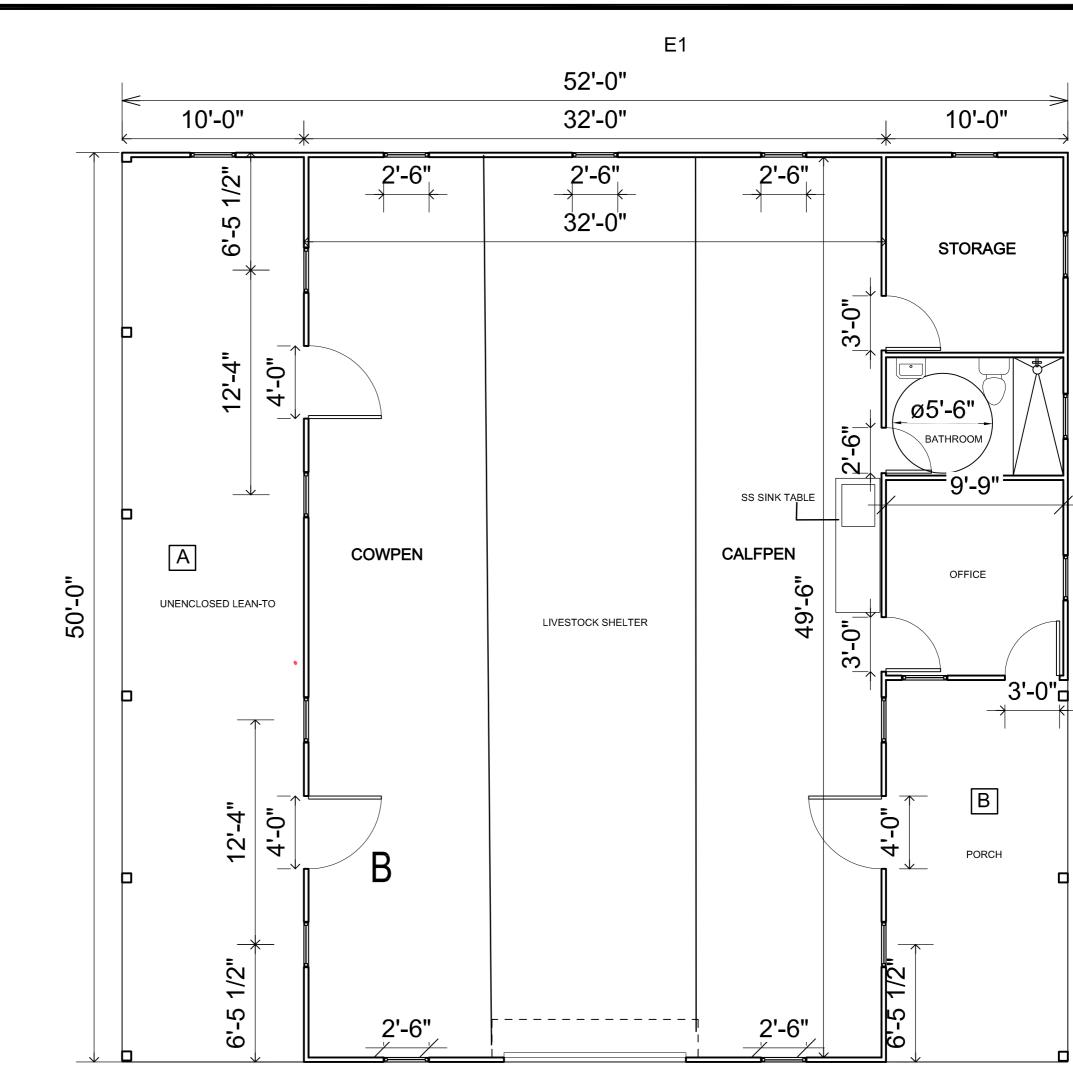11'-0"

| E1

21'-0"

10'-0"

E2

 COVERED & PARTIALLY ENCLOSED AREA CALCULATIONS

 ID
 size
 Area (SQFT)

 A
 50' x 10'
 500

 B
 21' x 10'
 210

 TOTAL
 710.00 SQFT

TOTAL UNIT AREA LIVESTOCK SHED =

COVERED AREA CALCULATIONS

SIZE

52'0" x 50'0" - AREA (A+B) =(2600)-(500+210)

ID

LSS

E4

Area (SQFT)

1890.00 SQFT

1890.00

8' 4' 0 8' 16' 24 6' 2' 0 4' 12' 20'

10'-0"

LIVE STOCK SHED PLAN

E3

BARSANA
1 AUGUSTE CT, MILPITAS,CA 95035

AJAY GOYAL
748 BLUE STONE CIRCLE, FOLSOM CA 95630 | 916-294 - 5337

AJAY GOYAL
NEHA

DRAWN BY: DATE: 14-07- 2022
NEHA
SCALE: 1:100

APN 029-35-007


APN 029-35-007


APN 029-35-007


SUBJECT: LIVESTOCK SHED FLOOR PLAN, AREA CALCULATION


LSS 01

10'-0"

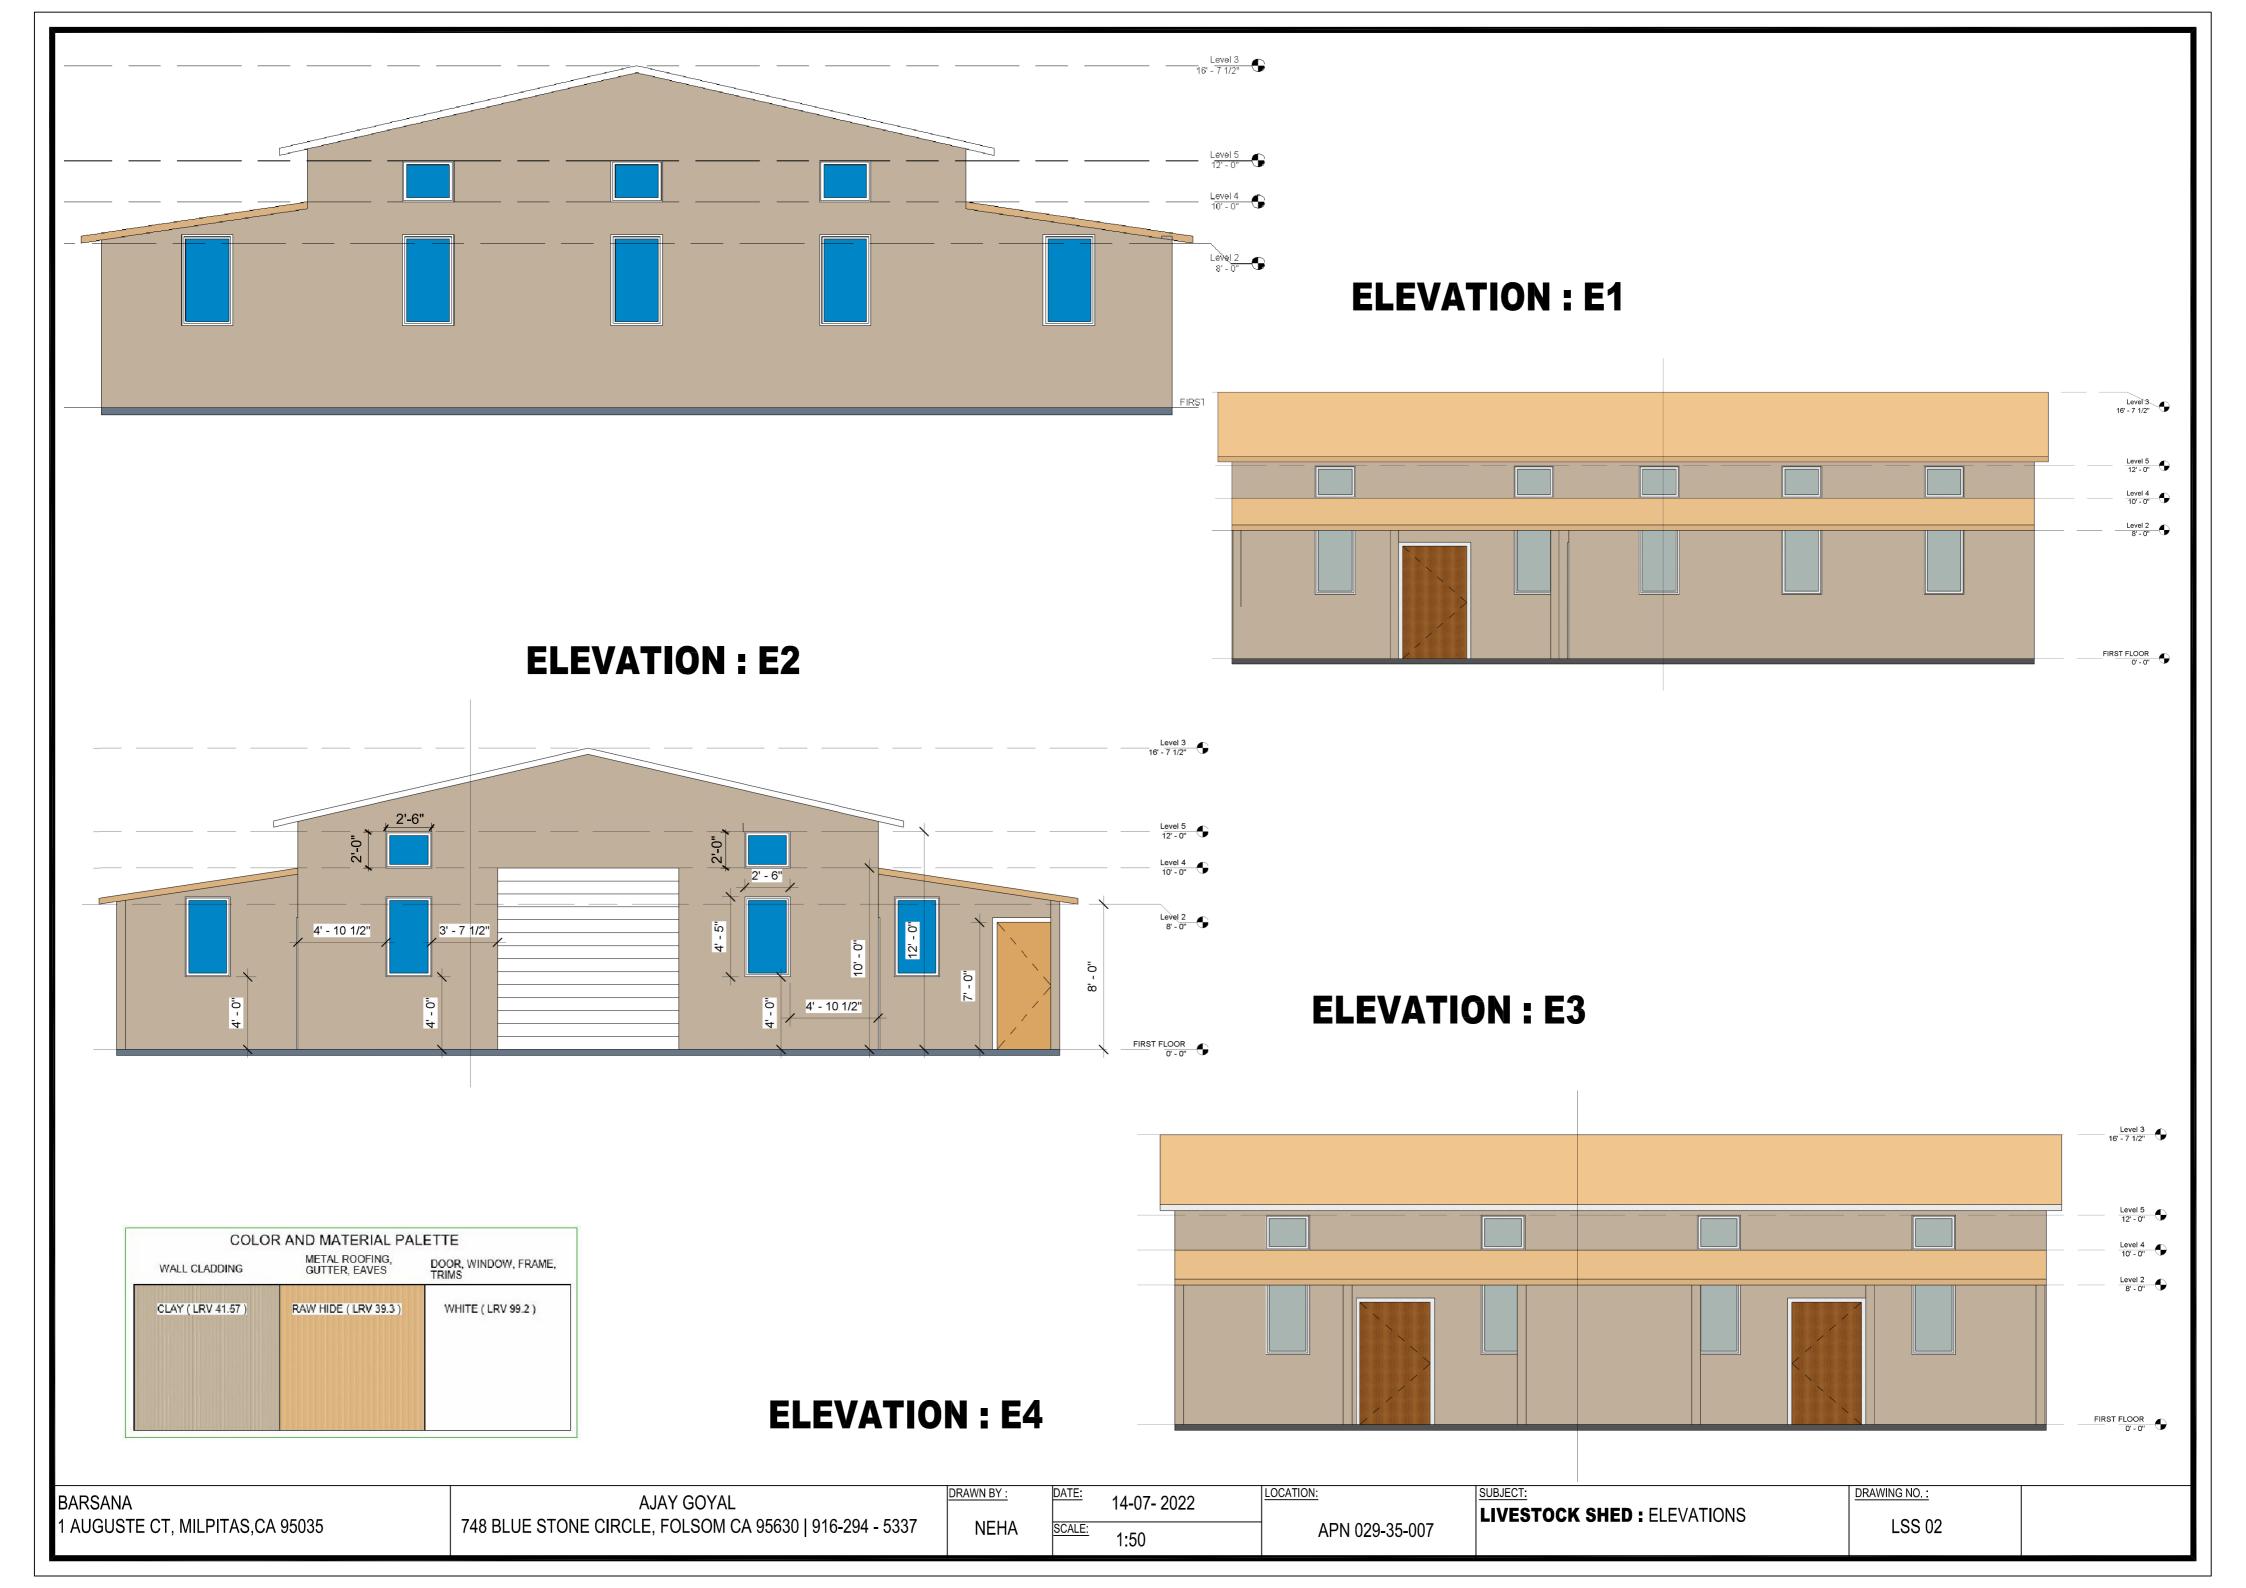

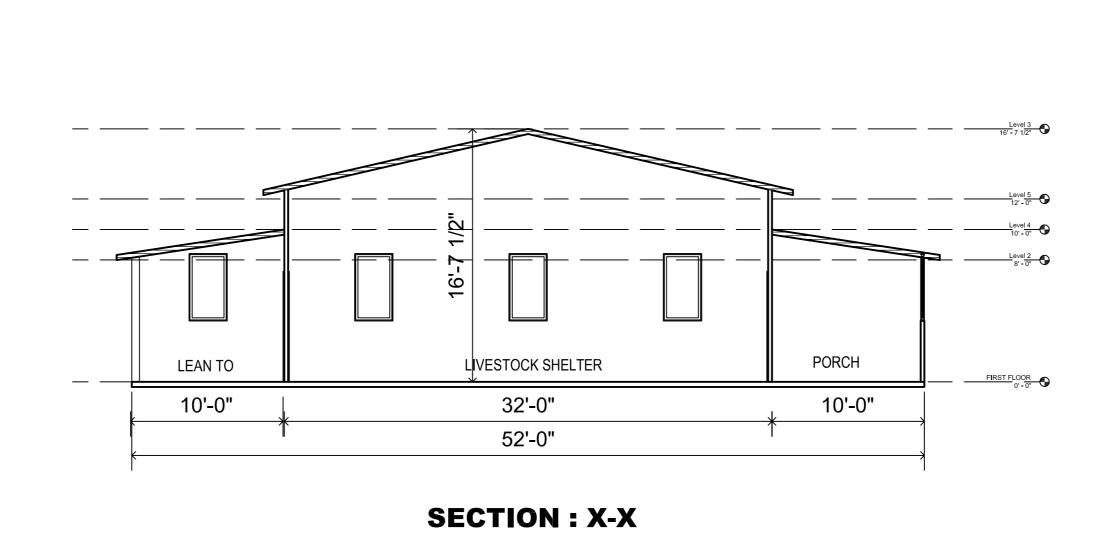

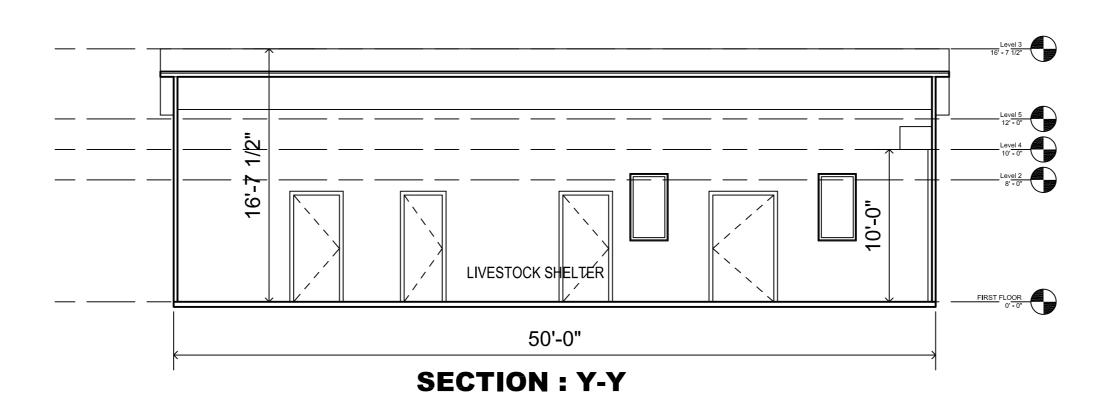

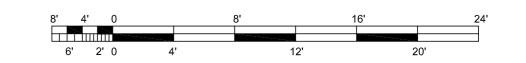

BARSANA
1 AUGUSTE CT, MILPITAS,CA 95035

AJAY GOYAL
748 BLUE STONE CIRCLE, FOLSOM CA 95630 | 916-294 - 5337

NEHA


DATE: 14-07- 2022
NEHA


SCALE: 1:50


APN 029-35-007

LOCATION:
APN 029-35-007

SUBJECT:
LIVESTOCK SHED : SECTIONS
LSS 03

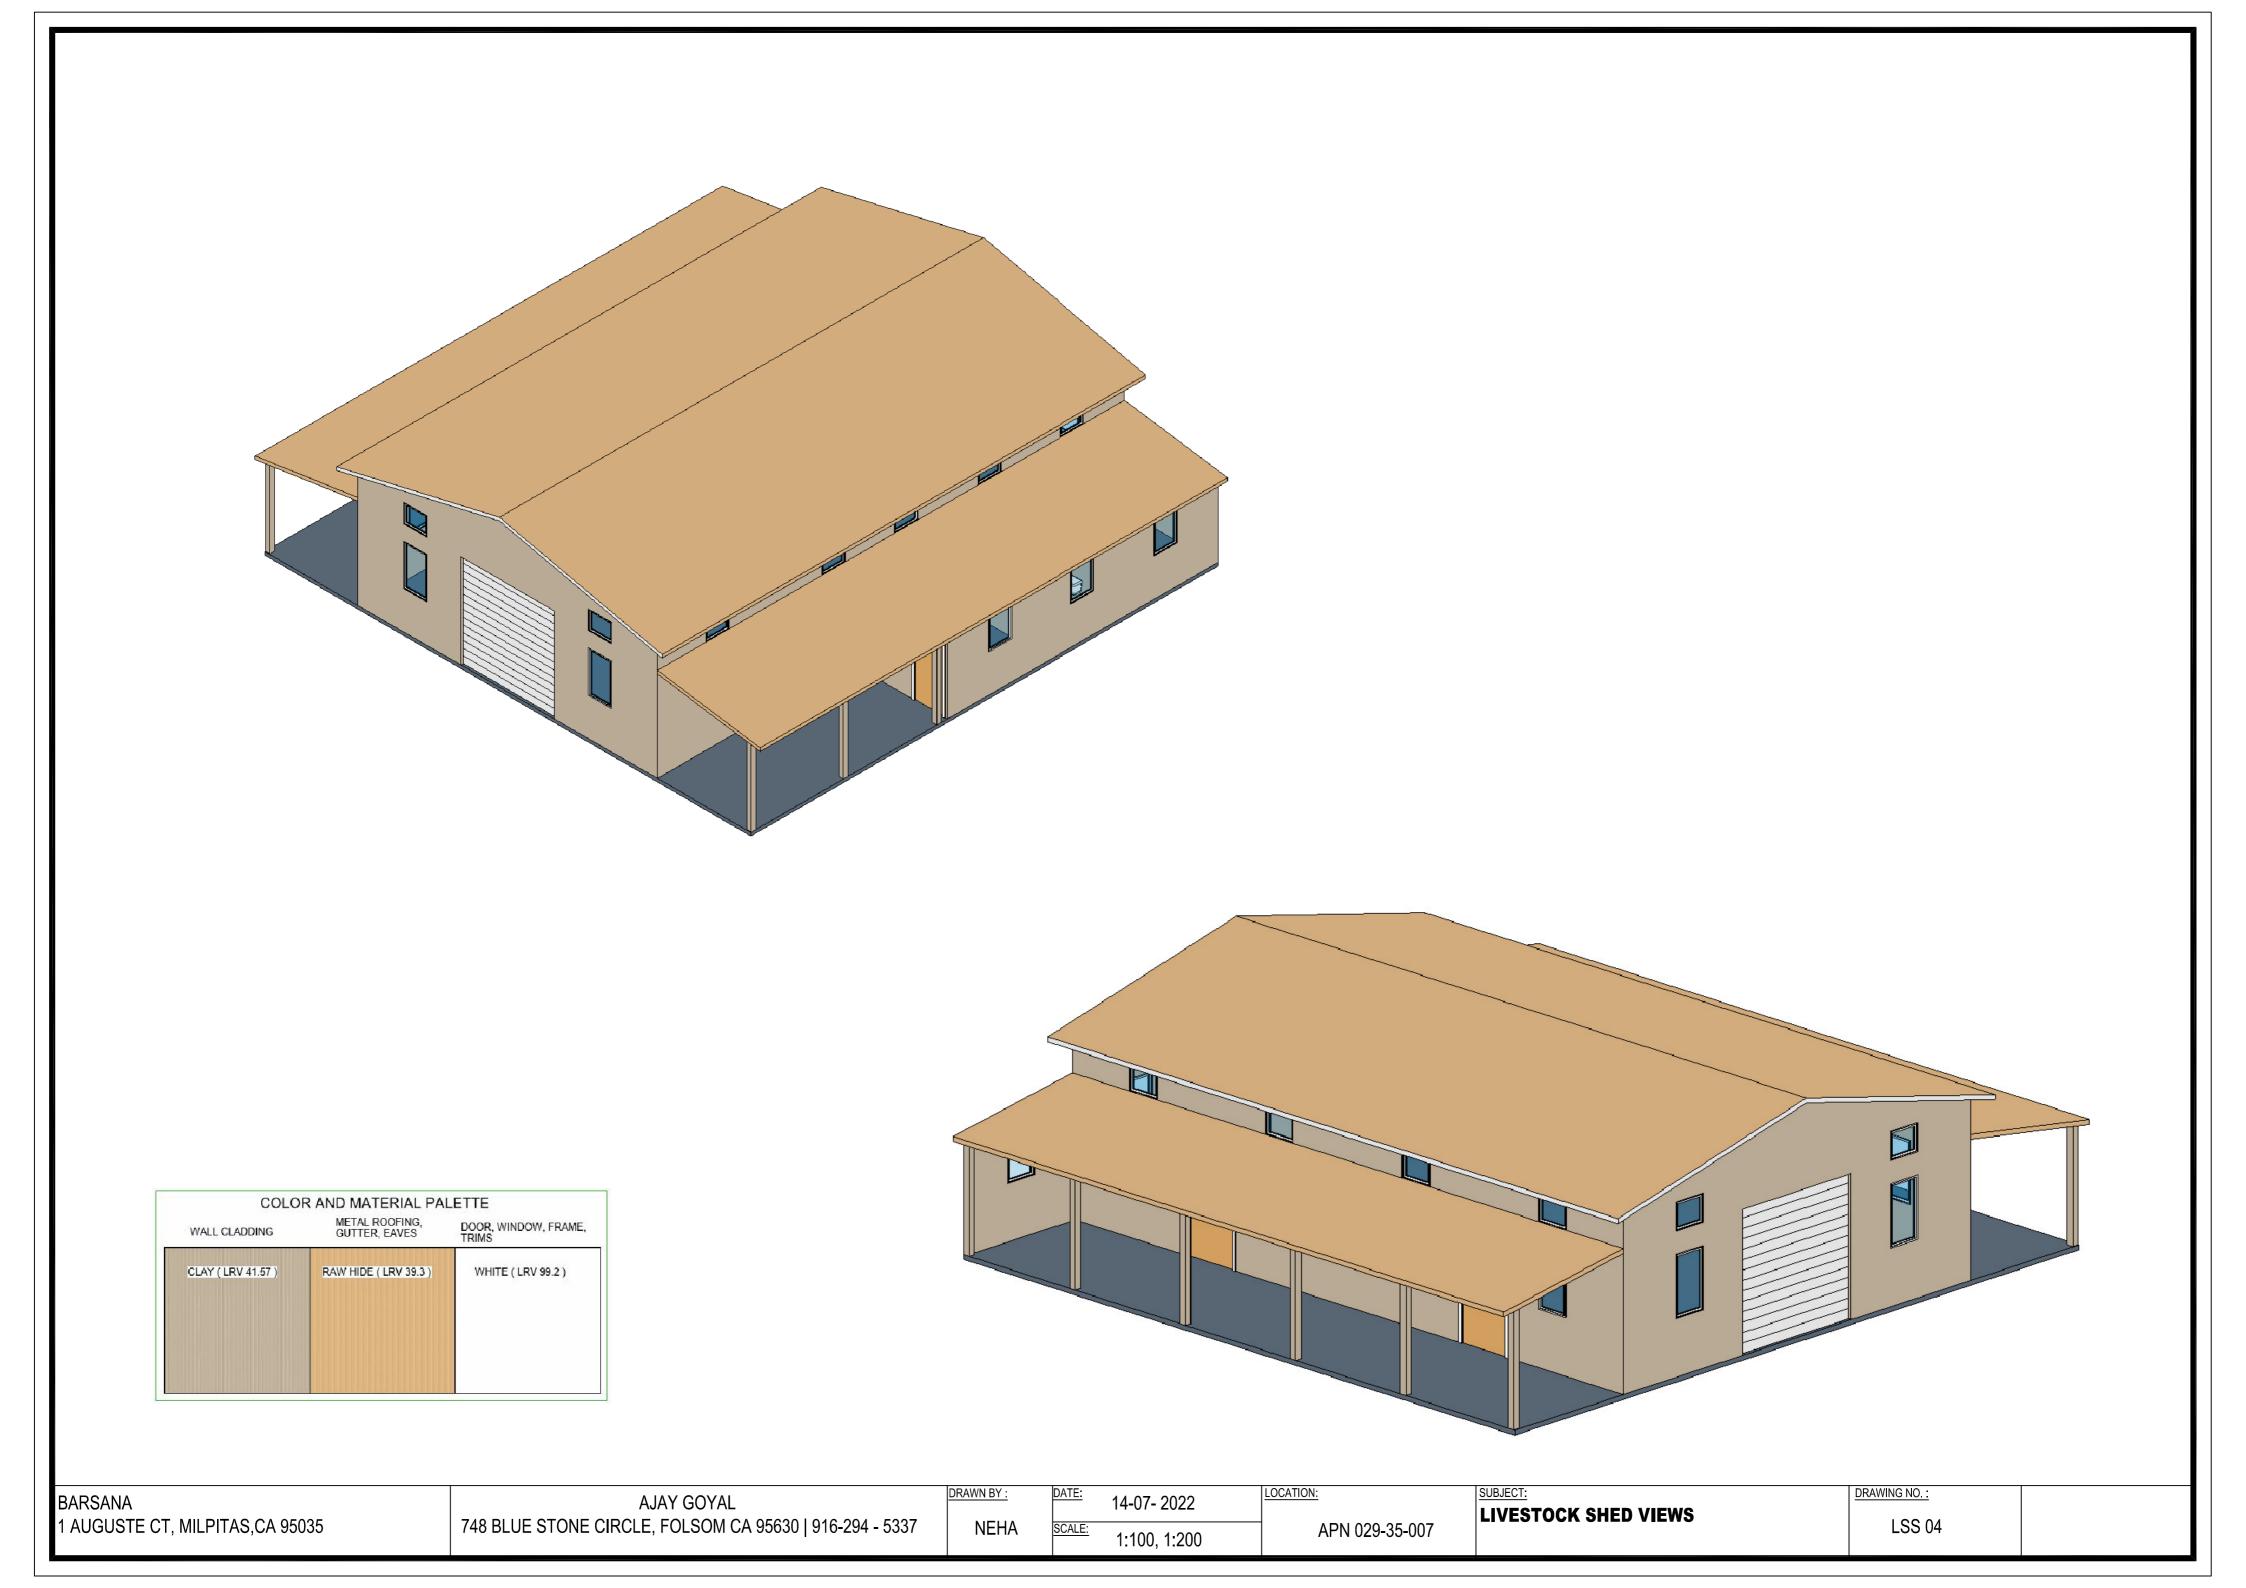

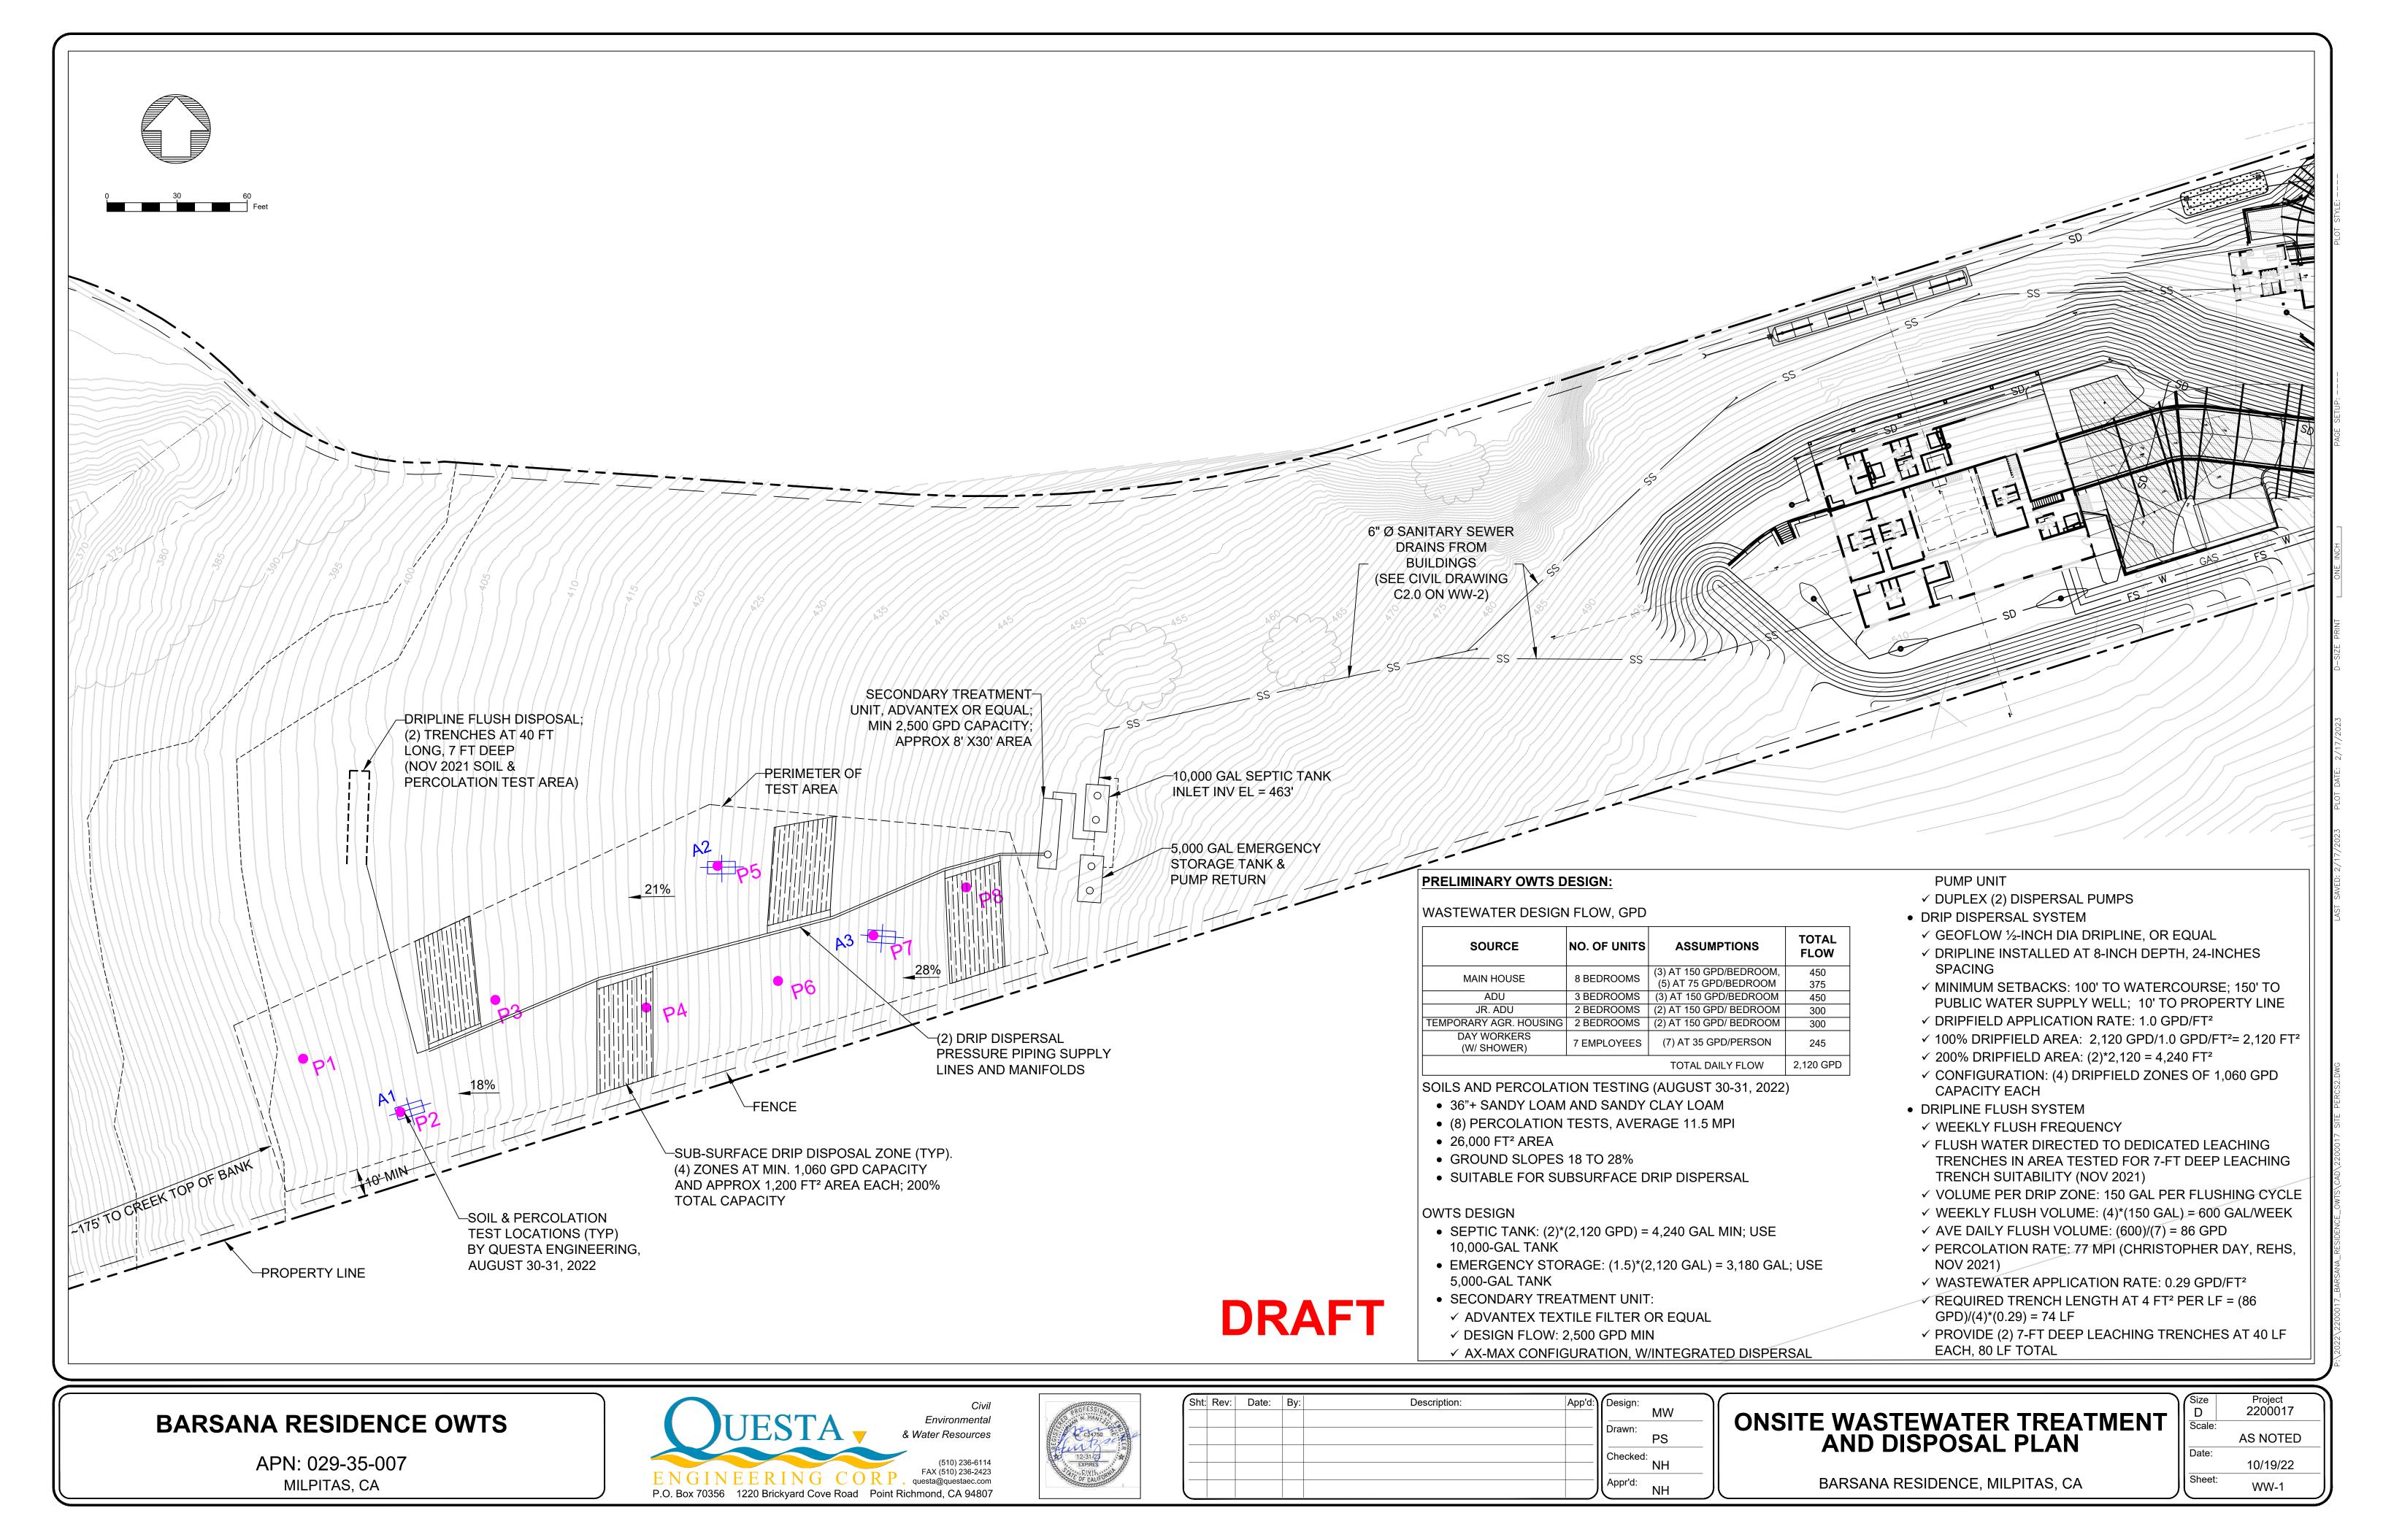

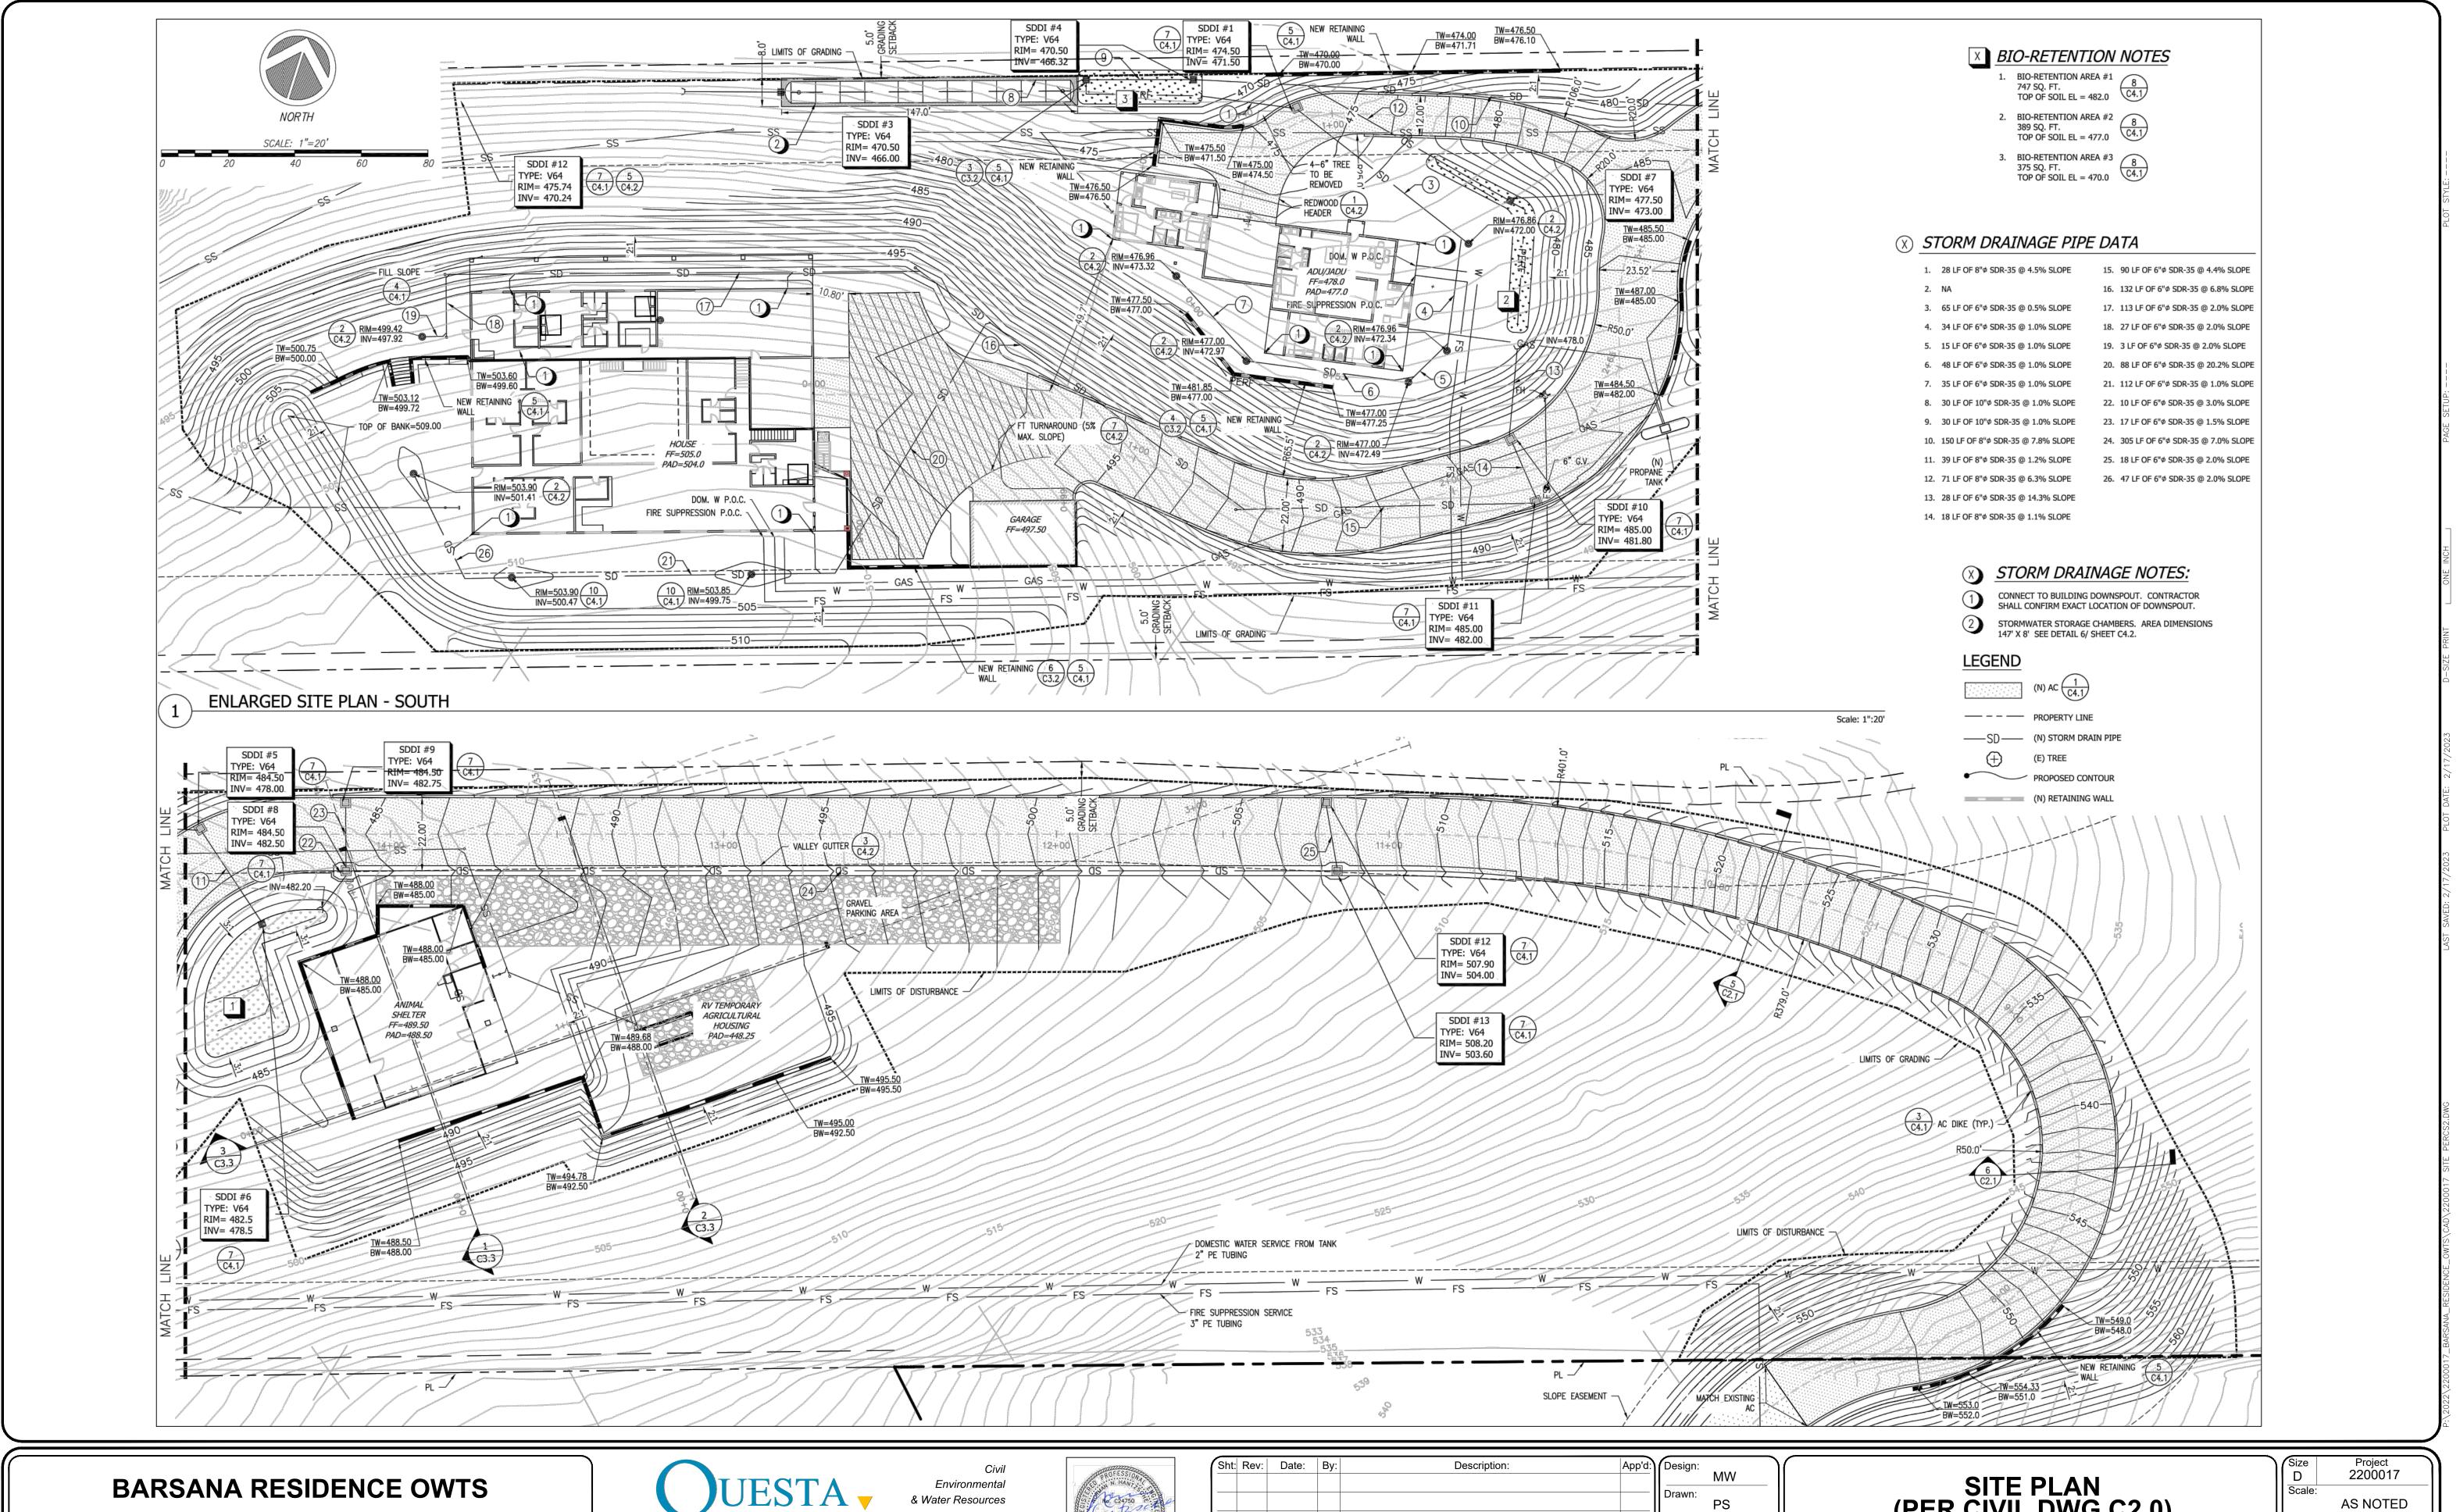

APN: 029-35-007 MILPITAS, CA



82	SWAN	N. HAN	COT.	S. B	1
REGI		13	20	NEER.	
BA:	and the same of	2-31-23 EXPIRES		*	
B	S;	CIVIL. OF CALL	ORNIA	000	

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					Drawn:
					Checked:
					Appr'd:

NH

NH

SITE PLAN (PER CIVIL DWG C2.0)

BARSANA RESIDENCE, MILPITAS, CA

7	Size	Project
	D	2200017
	Scale:	
		AS NOTED
	Date:	
		10/19/22
	Sheet	_2