### **PUBLIC WORK NOTES**

ANY WORK IN THE CITY RIGHT-OF-WAY., SUCH AS STREET, SIDEWALK AREA, PUBLIC EASEMENTS, AND UTILITY EASEMENTS IS REQUIRED TO OBTAIN AN ENCROACHMENT PERMIT PRIOR TO STARING WORK.

ALL WORK WITH IN CITY RIGHT-OF- WAY SHALL COMPLY WITH CITY STANDARDS AND DETAILS.

THE PROJECT SHALL COMPLY WITH THE CITY'S NPDES PERMIT REQUIREMENTS TO PREVENT STORM WATER POLLUTION. ALL CONSTRUCTION WORK SHALL BE DONE IN ACCORDANCE WITH THE MOST CURRENT APWA-AGC STANDARD SPECIFICATIONS FOR PUBLIC WORKS CONSTRUCTION. THE CALIFORNIA STORMWATER QUALITY ASSOCIATION'S STORMWATER BEST MANAGEMENT PRACTICE HANDBOOK .AND THE CITY OF BURLINGAME STORMWATER MANAGEMENT AND DISCHARGE CONTROL ORDINANCE (MUNICIPAL CODE CHAPTER 15.14). UPON COMPETITION OF THE WORK, ALL ST ORMWATER PROTECTION MEASURES SHALL BE BE ENTIRELY REMOVED AND THE RIGHT-OF-WAY SHALL BE LEFT IN AS PRESENTABLE A CONDITION AS EXISTED BEFORE WORK STARTED

ALL DAMAGED AND DISPLACED CURB, GUTTER AND/OR SIDEWALK FRONTING SITE MUST BE REPLACED PRIOR TO FINAL OF BUILDING PERMIT CONSTRUCTION HOURS IN THE CITY PUBLIC RIGHT-OF-WAY ARE LIMITED TO WEEKDAYS AND NON-CITY HOLIDAYS BETWEEN 8:00A.M. AND 5:00P M THIS INCLUDES HAULING

PER MUNICIPAL CODE SECTION 18.08.090, NO STORM WATER OR UNDERGROUND WATER DRAINING FORM ANY LOT, BUILDING, OR PAVEL AREA SHALL BE ALLOWED TO DRAIN TO ADJACENT PROPERTIES NOR SHALL THIS WATER BE CONNECTED TO THE CITY'S SANITARY SEWER SYSTEM. REGARDLESS OF THE SLOPE OF THE SOURCE PROPERTY, SUCH WATER SHALL DRAIN TO FITHER ARTIFICIAL OR NATURAL STORM DRAINAGE FACILITIES BY GRAVITY OR PUMPING

ALL WATER LINES CONNECTIONS TO CITY WATER MAINS FOR SERVICES OR FIRE LINE PROTECTION ARE TO BE INSTALLED PER CIT STANDARDS PROCEDURES AND MATERIAL SPECIFICATIONS. CONTACT THE CITY'S WATER DEPARTMENT FOR CONNECTION FEE. IF REQUIRED, ALL FIRE SERVICE AND SERVICE 2" AND OVER SHALL BE INSTALLED BY BUILDER. ALL UNDERGROUND FIRE SERVICE CONNECTIONS SHALL BE SUBMITTED AS SEPARATE UNDERGROUND FIRE SERVICE PERMIT FOR REVIEW AND APPROVAL. NO STRUCTURE SHALL BE BUILT INTO CITY'S RIGHT-OF-WAY.

ALL DEBRIS/GARBAGE CONTAINERS LOCATION SHALL BE ON PROPERTY. NO WET GARBAGE FLUID SHALL ENTER PUBLIC RIGHT-OF-WAY OR THE STORM DRAIN SYSTEM

10. IT IS THE RESPONSIBILITY OF THE OWNER AND/OR CONTRACTOR TO NOTIFY UNDERGROUND SERVICE ALERT(USA) AT LEAST 48 HOURS BEFORE THE START OF ANY EXCAVATION WORK.

#### **REQUIREMENT TO PREVENT, CONTROL AND REDUCE STORM WATER POLLUTANTS**

A. AUTHORIZATION TO ADOPT AND IMPOSE BEST MANAGEMENT PRACTICES (BMP). THE CITY WILL ADOPT REQUIREMENTS IDENTIFYING BEST /ANAGEMENT PRACTICES FOR ANY ACTIVITY. OPERATION OR FACILITY WHICH MAY CAUSE OR CONTRIBUTE TO POLLUTION OR CONTAMINATION OF STORM WATER. THE MS4 SYSTEM OR WATERS OF THE UNITED STATES AS A SEPARATE BMP GUIDANCE SERIES. WHERE BEST MANAGEMENT PRACTICE REQUIREMENTS ARE PROMULIGATED BY THE CITY OR ANY FEDERAL. STATE OF CALIFORNIA OR REGIONAL AGENCY FOR ANY ACTIVIT OPERATION OR FACILITY WHICH WOULD OTHERWISE CAUSE THE DISCHARGE OF POLILITANTS TO THE MS4 SYSTEM OR WATER OF THE UNITED STATES, EVERY PERSON UNDERTAKING SUCH ACTIVITY OR OPERATION OR OWNING OR OPERATING SUCH FACILITY SHALL COMPLY WITH SUCH REQUIREMENTS.

MANAGEMENT PRACTICES TO CONTROL THE VOLUME, RATE AND POTENTIAL POLLUTANT LOAD OF STORM WATER RUNOFF FROM NEW DEVELOPMENT AND REDEVELOPMENT PROJECTS AS MAY BE APPROPRIATE TO MINIMIZE THE GENERATION. TRANSPORT AND DISCHARGE OF POLLUTANTS. THE CITY SHALL INCORPORATE SUCH REQUIREMENTS IN ANY LAND USE ENTITLEMENT AND CONSTRUCTION OR BUILDING-RELATED PERMIT TO BE ISSUED RELATIVE TO SUCH DEVELOPMENT OR REDEVELOPMENT. THE OWNER AND DEVELOPER SHALL COMPLY WITH THE TERMS. PROVISIONS AND CONDITIONS OF SUCH LAND USE ENTITLEMENTS AND BUILDING PERMITS AS REQUIRED IN THIS CHAPTER

C RESPONSIBILITY TO IMPLEMENT BEST MANAGEMENT PRACTICES, NOTWITHSTANDING THE PRESENCE OR ABSENCE OF REQUIREMENTS SUBSECTIONS A AND B ANY PERSON ENGAGED IN ACTIVITIES OR OPERATIONS OR OWNING FACILITIES OR PROPERTY WHICH WILL OR MAY RESULT IN POLLUTANTS ENTERING STORM WATER. THE MS4 SYSTEM OR WATERS OF THE UNITED STATES SHAL MANAGEMENT PRACTICES TO THE EXTENT THEY ARE TECHNOLOGICALLY ACHIEVABLE 1 BEST MANAGEMENT PRACTICES REQUIRED BY THE CITY CAN BE OBTAINED FROM THE PUBLIC WORKS DEPARTMENT BY REQUESTING THE BMP MANUAL APPROPRIATE TO A COMMERCIAL OR INDUSTRIAL ACTIVITY FROM THE BMP GUIDANCE SERIES

GREEMENTS, ALL STRUCTURAL AND NON-STRUCTURAL PERMANENT STORM WATER BMPS NOT IN THE CONTROL OF THE CITY SHALL HAVE AN ENFORCEABLE MAINTENANCE AGREEMENT TO ENSURE THE SYSTEM FUNCTIONS AS DESIGNED. THE AGREEMENT SHALL INCLUDE ANY AND ALL MAINTENANCE EASEMENTS REQUIRED TO ACCESS AND INSPECT THE STORM WATER BMPS AND TO PERFORM ROUTINE MAINTENANCE AS REQUIRED. SUCH AGREEMENTS SHALL SPECIFY THE PARTIES RESPONSIBLE FOR THE PROPER MAINTENANCE OF ALL STORM WATER BMPS. (ORD. 1253 § 1, 2004)

## POLLUTANT CONTROL (CALGREEN)

- DUCT AND MECHANICAL SYSTEMS PROTECTION. AT THE TIME OF ROUGH INSTALLATION. DURING STORAGE ON THE CONSTRUCTION SITE AND UNTIL FINAL STARTUP OF THE HEATING, COOLING AND VENTILATING EQUIPMENT, ALL DUCT AND OTHER RELATED AIR DISTRIBUTION COMPONENTS OPENINGS SHALL BE COVERED WITH TAPE. PLASTIC, SHEET METALS, OR OTHER METHODS ACCEPTABLE TO THE ENFORCING AGENCY TO REDUCE THE AMOUNT OF WATER, DUST OR DEBRIS, WHICH MAY ENTER THE SYSTEM PER CGC 4.504.1.
- FINISH MATERIAL POLLUTANT CONTROL. FINISH MATERIALS SHALL COMPLY WITH SECTIONS 4.504.2.1 THROUGH 4.504.5.1. ADHESIVES, SEALANTS AND CAULKS. ADHESIVES, SEALANTS AND CAULKS USED ON THE PROJECT SHALL MEET THE REQUIREMENTS OF THE STANDARDS LISTED IN CGC 4.504.2.1
- PAINTS AND COATINGS. PAINTS AND COATINGS SHALL COMPLY WITH VOC LIMITS PER CGC 4.504.2.2.
- AEROSOL PAINTS AND COATINGS. AEROSOL PAINTS AND COATINGS SHALL MEET THE PRODUCT-WEIGHTED MIR LIMITS FOR ROC AND OTHER REQUIREMENTS PER CGC 4.504.2.3. VERIFICATION. DOCUMENTATION WILL BE PROVIDED, AT THE REQUEST OF THE BUILDING DIVISION, TO VERIFY COMPLIANCE WITH VOC FINISH
- MATERIALS PER CGC 4.504.2.4. CARPET SYSTEMS. ALL CARPET INSTALLED IN THE BUILDING INTERIOR SHALL MEET THE TESTING AND PRODUCT REQUIREMENT PER CGC
- 4.504.3. . CARPET CUSHION AND ADHESIVE ALSO MUST COMPLY. COMPOSITE WOOD PRODUCTS. HARDWOOD PLYWOOD, PARTICLEBOARD AND MEDIUM DENSITY FIBERBOARD COMPOSITE WOOD PRODUCTS. USED ON THE INTERIOR AND EXTERIOR OF THE BUILDING SHALL COMPLY WITH THE LOW FORMALDEHYDE EMISSION STANDARDS PER CGC 4.504.5
- DOCUMENTATION. VERIFICATION OF COMPLIANCE WITH THIS SECTION SHALL BE PROVIDED AT THE REQUEST OF THE ENFORCING AGENCY. PROTECT ANNULAR SPACES AROUND PIPES, ELECTRIC CABLES, CONDUITS AT EXTERIOR WALLS AGAINST THE PASSAGE OF RODENTS PER
- CALGREEN SECTION 4.406.1 COVER DUCT OPENINGS AND OTHER RELATED AIR DISTRIBUTION COMPONENT OPENINGS DURING CONSTRUCTION PER CALGREEN SECTION 4 504 1
- PAINTS, STAINS AND OTHER COATINGS SHALL BE COMPLIANT WITH VOC LIMITS PER CALGREEN 4.504.2.2
- MINIMUM 80% OF FLOOR AREA RECEIVING RESILIENT FLOORING SHALL COMPLY WITH CALGREEN SECTION 4 504.4 PARTICLEBOARD, MEDIUM DENSITY FIBERBOARD (MDF) AND HARDWOOD PLYWOOD USED IN INTERIOR FINISH SYSTEMS SHALL COMPLY WITH
- LOW FORMALDEHYDE EMISSION STANDARDS INSTALL CAPILLARY BREAK AND VAPOR RETARDER AT SLAB ON GRADE FOUNDATIONS PER CALGREEN SECTION 4.505.2.
- CHECK MOISTURE CONTENT OF BUILDING MATERIALS USED IN WALL AND FLOOR FRAMING BEFORE ENCLOSURE PER CALGREEN SECTION

## GENERAL NOTES (APPLY TO ALL SHEETS)

- GENERAL CONDITIONS FOR THE PERFORMANCE OF THE CONTRACT IS HEREBY INCORPORATED INTO THE DRAWINGS AND SHALL BE
- CONSIDERED AS PART OF THE REQUIREMENTS FOR THE COMPLETION OF THE PROJECT
- CONTRACTOR SHALL THOROUGHLY REVIEW CONTRACT DOCUMENTS AND NOTIFY ARCHITECT OF ANY CONDITIONS NOT COVERED CONTRACTOR SHALL FIELD-VERIFY SITE DIMENSIONS AND CONDITIONS PRIOR TO BIDDING. ANY DISCREPANCIES SHALL BE REPORTED TO THE
- ARCHITECT PRIOR TO COMMENCEMENT OF THE WORK. NOTES AND DIMENSIONS TAKE PRECEDENCE OVER SCALE OF THE DRAWINGS. DURING CONSTRUCTION, CONTRACTOR SHALL NOTIFY THE ARCHITECT AND SEEK CLARIFICATION IF ANY DISCREPANCIES ARE FOUND. CONTRACTORS SHALL BE RESPONSIBLE FOR REMEDIAL WORK IF RELATED WORK IS CONTINUED AFTER A DISCREPANCY IS IDENTIFIED.
- CONTRACTOR SHALL REMOVE TRASH AND DEBRIS STEMMING FROM THEIR WORK ON A DAILY BASIS. PROJECT SITE SHALL BE MAINTAINED IN A CLEAN AND ORDERLY CONDITION.
- CONTRACTOR SHALL BE RESPONSIBLE FOR VERIFYING THAT MATERIALS, LABOR, INSTALLATION, ETC., CONFORMS TO ALL APPLICABLE CODES AND REQUIREMENTS OF LOCAL GOVERNING AGENCIES.
- CONTRACTOR WILL BE SOLELY AND COMPLETELY RESPONSIBLE FOR CONDITIONS ON THE JOB SITE, INCLUDING HEALTH AND SAFETY OF ALL PERSONS AND PROPERTY DURING PERFORMANCE OF THE WORK. CONTRACTOR TO LIMIT TRAFFIC AND ACCESS TO WORK AREAS. CLEAN UP AND REPAIRS: AT THE COMPLETION OF CONSTRUCTION, REMOVE ALL EXCESS MATERIALS AND RESIDUES FROM SITE. LEAVE ALL
- SURFACES WITHIN CONSTRUCTION SITE FREE FROM DUST, DIRT AND STAINS PATCHING: PROPERLY PREPARE SURFACES FOR RECEIVING THE SPECIFIED FINISHES INCLUDING PATCHING SURFACES ALTERED BY CONSTRUCTION. ON PATCHED AREAS OR AREAS WHERE A FINISH IS NOT SPECIFIED. THE FINISH SHALL MATCH ADJACENT MATERIAL IN
- CONSTRUCTION, COLOR AND TEXTURE. ALL WORK NOTED "N.I.C." OR NOT IN CONTRACT IS TO BE ACCOMPLISHED BY A CONTRACTOR OTHER THAN THE GENERAL CONTRACTOR AND IS
- NOT TO BE PART OF THE WORK. INSTALLATION: ALL ITEMS SPECIFIED SHALL BE INSTALLED AS PER MANUFACTURERS' RECOMMENDATION. ALL OPERATING MANUALS AND WARRANTEES SHALL BE GIVEN TO OWNER BY PROJECT COMPLETION.
- NO WORK SHALL COMMENCE WITH UNAPPROVED MATERIALS. ANY WORK DONE WITH UNAPPROVED MATERIALS AND EQUIPMENT IS AT THE
- CONTRACTOR'S RISK. SUBSTITUTIONS OR CHANGES MUST BE APPROVED BY THE ARCHITECT PRIOR TO PROCEEDING WITH THE WORK. NEW/EXISTING FINISHES AND CONSTRUCTION SHALL BE PROTECTED BY THE CONTRACTOR FROM POTENTIAL DAMAGE CAUSED BY
- CONSTRUCTION ACTIVITY. DAMAGE TO FINISHES OR CONSTRUCTION CAUSED IN THIS MANNER SHALL BE REPAIRED OR REPLACED (OWNER'S DECISION) BY THE CONTRACTOR WITH IDENTICAL MATERIAL AND/OR FINISHES. GUARANTEES: THE CONTRACTOR SHALL GUARANTEE THAT THE PROJECT WILL BE FREE OF DEFECTS OF WORKMANSHIP AND MATERIAL FOR A
- PERIOD OF ONE YEAR FROM THE DATE OF ACCEPTANCE BY THE OWNER. NO WORK DEFECTIVE IN CONSTRUCTION OR QUALITY OR DEFICIENT IN ANY REQUIREMENT OF THE DRAWINGS OR NOTES WILL BE ACCEPTABLE IN CONSEQUENCE OF THE OWNER'S OR ARCHITECT'S FAILURE TO POINT OUT DEFECTS OR DEFICIENCIES DURING CONSTRUCTION. DEFECTS OR WORKMANSHIP OR MATERIALS REVEALED WITHIN A PERIOD OF ONE YEAR FROM THE ACCEPTANCE OF DEFECTIVE WORK OR IMPROPER MATERIALS.
- ALL DEMOLITION INDICATED ON PLANS SHALL BE CAREFULLY CUT AND REMOVED TO MINIMIZE DISRUPTION AND DAMAGE OF EXISTING SPACE. CONSTRUCTION MATERIALS STORED ON SITE SHALL BE PROPERLY STACKED AND PROTECTED SO AS TO PREVENT DAMAGE OR DETERIORATION
- UNTIL USED. FAILURE IN THIS REGARD MAY BE CAUSE FOR REJECTION OF MATERIAL AND/OR WORK ALL TYPICAL DETAILS SHALL APPLY UNLESS NOTED OTHERWISE. THE DETAILS REFLECT THE DESIGN INTENT FOR TYPICAL CONDITIONS. CONTRACTOR SHALL VERIFY ALL FIELD CONDITIONS AND SHALL INCLUDE IN THIS SCOPE THE COST FOR COMPLETE FINISHED INSTALLATIONS.
- INCLUDING ANOMALIES, OF ALL TRADES. NEW WEATHER HEADS/OVERHEAD RACEWAYS SHALL BE A MINIMUM OF 1-1/4" GALVANIZED STEEL CONDUIT, OR 2" RIGID ALUMINUM CONDUIT.
- THERE SHALL BE A SYSTEM DISCONNECT LOCATED ON THE EXTERIOR OF THE STRUCTURE OR PROVIDE A SHUNT-TRIP. THIS WOULD INCLUDE ANY SHUTDOWN DEVICE FOR ALTERNATE SOURCES OF POWER SUCH AS SOLAR, BATTERY, GENERATORS, ETC

#### UTILITY NOTES

- MEET THE PROPOSED REQUIREMENT
- PROVIDE NEW GAS LINE FROM GAS METER TO BBQ EXPANSION AND NEW ADU INSTALLATION OF UNDERGROUND GAS LINE

- TO MEET THE PROPOSED REQUIREMENT
- WALKWAY AND CONCRETE GUTTER AFTER UTILITY INSTALLATION
- SWIMMING POOL. OUTDOOR SHOWER AREA AND NEW ADU PROVIDE NEW CONCRETE WALKWAY OR LANDSCAPE TO MATCH EXISTING AFTER INSTALLATION OF UNDERGROUND WATER LINE
- PROVIDE NEW WATER LINE FROM THE PUBLIC WATER UTILITY COMPANY TO THE

SANITARY LINE

- THE PROPOSED REQUIREMENT
- WALKWAY AND CONCRETE GUTTER AFTER UTILITY INSTALLATION
- HOUSE
- INSTALLATION OF UNDERGROUND SANITARY LINE
- CLEANOUTS
- AREA AND FUTURE SWIMMING POOL

#### <u>ELECTRICI</u>T


- AT NEAREST PUBLIC STREET TO THE NEW
- WALKWAY AND CONCRETE GUTTER AFTER UTILITY INSTALLATION

#### STORM DRAIN LINE

- ADU AND THE DAYLIGHT LEADER ON STREET CONCRETE GUTTER
- FROM DOWNSPOUTS OF THE ADU UNDERGROUND STORM WATER LINE TO CONCRETE GUTTER
- FIRE SPRINKLER

- WALKWAY AND CONCRETE GUTTER AFTER UTILITY INSTALLATION

# VICINITY MAP

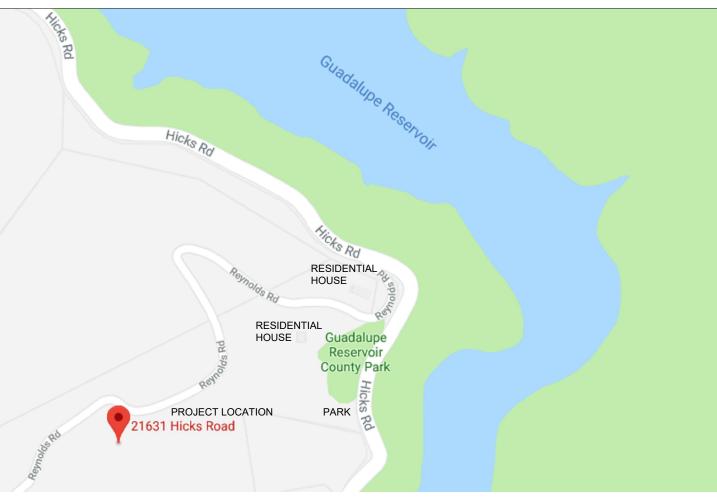

• PROVIDE PRICE TO UPGRADE EXISTING GAS METER TO ACCOMMODATE GAS DEMAND TO PROVIDE ALT PRICE TO REMOVE EXISTING CONCRETE WALKWAY, AC PAVING ON STREET,

CONCRETE PUBLIC WALKWAY AND GUTTER, UPGRADE EXISTING UTILITY LINE TO THE METER AND INSTALL CONCRETE WALKWAY, AC PAVING ON STREET, CONCRETE PUBLIC WALKWAY AND CONCRETE GUTTER AFTER UTILITY INSTALLATION

PROVIDE NEW CONCRETE WALKWAY OR LANDSCAPE TO MATCH EXISTING AFTER

PROVIDE PRICE TO UPGRADE EXISTING WATER METER TO ACCOMMODATE WATER DEMAND

 PROVIDE ALT PRICE TO REMOVE EXISTING CONCRETE WALKWAY, AC PAVING ON STREET, CONCRETE PUBLIC WALKWAY AND GUTTER, UPGRADE EXISTING UTILITY LINE TO THE METER AND INSTALL CONCRETE WALKWAY, AC PAVING ON STREET, CONCRETE PUBLIC

PROVIDE NEW WATER LINE FROM GAS METER TO BBQ EXPANSION AREA, FUTURE

UPGRADED WATER METER FOR WATER DEMAND REQUIREMENT IF NEEDED

 PROVIDE PRICE TO UPGRADE OR INSTALL NEW EXISTING SANITARY CLEANOUT (PER CITY STANDARD) TO ACCOMMODATE PROPOSED SANITARY FIXTURE UNIT DEMAND TO MEET

• PROVIDE ALT PRICE TO REMOVE EXISTING CONCRETE WALKWAY, AC PAVING ON STREET CONCRETE PUBLIC WALKWAY AND GUTTER, UPGRADE EXISTING UTILITY LINE TO THE METER AND INSTALL CONCRETE WALKWAY, AC PAVING ON STREET, CONCRETE PUBLIC

 PROVIDE NEW SANITARY LINE FROM BBQ EXPANSION AREA, FUTURE SWIMMING POOL. OUTDOOR SHOWER AREA AND NEW ADU TO SANITARY CLEANOUTS OUTSIDE THE MAIN

• PROVIDE NEW CONCRETE WALKWAY OR LANDSCAPE TO MATCH EXISTING AFTER PROVIDE POWER AND BOOSTER PUMP TO PUMP THE SEWER TO THE OUTDOOR SANITARY

• PROVIDE ALT PRICE TO UPGRADE EXISTING SANITARY LINE FROM THE OUTDOOR CLEANOUTS TO THE PUBLIC SANITARY LINE ON STREET IF NEEDED • CONTRACTOR SHALL PROVIDE SURVEY TO CONFIRM THE SANITARY ELEVATION AT PUBLIC UTILITY, SANITARY CLEANOUTS, NEW ADU, BBQ EXPANSION AREA, OUTDOOR SHOWER

PROVIDE UNDERGROUND CONDUIT AND UTILITIES FROM THE PUBLIC ELECTRICAL UTILITY

 ELECTRICAL METER AND PANEL AS SHOWN ON PROPOSED FLOOR PLAN PROVIDE ALT PRICE TO REMOVE EXISTING CONCRETE WALKWAY, AC PAVING ON STREET, CONCRETE PUBLIC WALKWAY AND GUTTER, UPGRADE EXISTING UTILITY LINE TO THE METER AND INSTALL CONCRETE WALKWAY, AC PAVING ON STREET, CONCRETE PUBLIC

CONTRACTOR SHALL PROVIDE SURVEY TO CONFIRM THE TOPOGRAPHIC ELEVATION AT

 PROVIDE ALT PRICE TO REMOVE EXISTING CONCRETE WALKWAY, AC PAVING ON STREET, CONCRETE PUBLIC WALKWAY AND GUTTER, UPGRADE EXISTING UTILITY LINE TO THE METER AND INSTALL CONCRETE WALKWAY. AC PAVING ON STREET. CONCRETE PUBLIC WAI KWAY AND CONCRETE GUTTER AFTER NEW 3" DIAMETER STORM DRAIN INSTALLATION

• PROVIDE POWER AND BOOSTER PUMP TO PUMP THE STORM WATER FROM ADU THRU

• PROVIDE PRICE TO UPGRADE EXISTING WATER METER TO ACCOMMODATE WATER DEMAND TO MEET THE PROPOSED FIRE SPRINKLER REQUIREMENT OF THE ADU PROVIDE ALTERNATE PRICE TO PROVIDE NEW WATER METER TO ACCOMMODATE WATER DEMAND TO MEET THE PROPOSED FIRE SPRINKLER REQUIREMENT OF THE ADU PROVIDE ALT PRICE TO REMOVE EXISTING CONCRETE WALKWAY, AC PAVING ON STREET, CONCRETE PUBLIC WALKWAY AND GUTTER, UPGRADE EXISTING UTILITY LINE TO THE METER AND INSTALL CONCRETE WALKWAY, AC PAVING ON STREET, CONCRETE PUBLIC

 PROVIDE NEW WATER LINE FROM THE PUBLIC WATER UTILITY COMPANY TO THE EXISTING OR NEW DEDICATED WATER METER FOR THE PROPOSED FIRE SPRINKLER SYSTEM PROVIDE NEW CONCRETE WALKWAY OR LANDSCAPE TO MATCH EXISTING AFTER INSTALLATION OF UNDERGROUND WATER LINE

# NEW SITE IMPROVEMENT

## 21631 HICKS ROAD, LOS GATOS, CA

#### SITE AND BUILDING ANALYSIS

#### APN: 57511009 ZONING: HS-SR

OCCUPANCY:R-3/ U (1-HR FIRE RATED OCCUPANCY - NO CHANGE) CONSTRUCTION TYPE: V-B

SETBACK CLARIFICATION:

FRONT SETBACK : 30'-0" 20'-0" SIDE SETBACK: REAR SETBACK: 25'-0" STREET SIDE SETBACK: 20'-0"

NUMBER OF PROPOSED STORY: 2 STORY

LOT AREA: 20.67 ACRES

PROPOSED BUILDING AREA: 8.991 SF PROPOSED LANDSCAPE AREA: SF = % PROPOSED HARDSCAPE AREA SF PROPOSED GARAGE: SF

LIVING AREA: PROPOSED 1ST FLOOR:

3,893 SF PROPOSED 2ND FLOOR: 5.098 SF TOTAL: 8,991 SF

PROPOSED REAR PORCH AT FIRST FLOOR PROPOSED SECOND FLOOR PATIO A: PROPOSED SECOND FLOOR PATIO B: PROPOSED SECOND FLOOR PATIO C: PROPOSED SECOND FLOOR PATIO D:

1,680 SF 633 SF 758 SF 290 SF 145 SF

SCOPE OF WORK

NEW GROUND UP RESIDENTIAL BUILDING NEW GROUND UP ADU

## ABBREVIATIONS

ANCHOR BOLT ASPHALTIC CONCRETE AIR CONDITIONING ACOUSTICAL ACOUSTICAL TILE ADJUSTABLE/ADJACENT ABOVE FINISH FLOOR ALUMINUM ANODIZED BOARD BUILDING BLOCK BOTTOM OF CABINET CATCH BASIN CEMENT CERAMIC CAST IRON CONSTRUCTION JOINT CENTERLINE CEILING CLEAR COLUMN COMPOSITION CONCRETE CONNECTION CONTINUOUS CARPET CERAMIC TILE

DIMENSION DOOR DOWNSPOU DRAWING EXISTING EACH ELECTRICAL ELEVATOR EQUAL FORCED AIR UNIT FLOOR DRAIN FIRE EXTINGUISHER FINISH FLOOR FOOTING GAUGE GALVANIZE (D) GENERAL CONTRACTOR GROUND FAULT INTERRUPTER GLASS FIBER REINFORCED CONCRETE GALVANIZED IRON GATE VALVE GYPSUM HOSE BIBB HEADER HARDWOOD HARDWARE HOLLOW METAL HORIZONTAL HEIGHT HOT\_WATER HEATING VENTILATING JANITOR JUNCTION BOX LAVATORY

DIAMETER

MAXIMUM MACHINE BOLT MECHANICAL MINIMUM METAL NEW NOT IN CONTRACT NOT TO SCALE ON CENTER OUTSIDE DIAMETER OVERFLOW ROOF DRAIN OFFICE OPENING OPPOSITE PLATE PLASTIC LAMINATE PLASTER PLYWOOD RISER RELOCATE(D) REINFORCED CONCRETE PIPE ROOF DRAIN REDWOOD RECESSED REINFORCED ROUND HEAD MACHINE SCREW ROOM ROUGH OPENING RAINWATER LEADER SOLID CORE STORM DRAIN SECTION SIMILAR SANITARY NAPKIN DISPENSER

MATERIAL

SPECIFICATION

#### **PROJECT DATA**

JURISDICTION CITY OF LOS GATOS

CODE

2019 CALIFORNIA BUILDING CODE 2019 CALIFORNIA MECHANICAL CODE 2019 CALIFORNIA PLUMBING CODE 2019 CALIFORNIA ELECTRICAL CODE 2019 CALIFORNIA FIRE CODE 2019 CALIFORNIA GREEN BUILDING CODE 2019 CALIFORNIA RESIDENTIAL CODE 2019 CALIFORNIA ENERGY CODE

## PROJECT DIRECTORY

ARCHITECT

**ARCHIT STUDIO ARCHITECTURE** CONTACT: MARCO FUNG LICENSE : C-32363 80 EUREKA SQUARE, SUITE 115, PACIFICA, CA 94044 MFUNG@ARCHITSTUDIOARCHITECTURE.COM T:650.270.1754

## SHEET INDEX

ARCHITECTURAL DRAWING A0.01 TITLE SHEET A0.02 RENDERINGS A1.00 SITE PLAN A1.01 SITE PLAN WITH TOPOGRAPHIC SURVEY A2.00 PROPOSED FLOOR PLAN A2.01 PROPOSED ROOF PLAN A3.00 PROPOSED ELEVATION A3.01 PROPOSED ELEVATION A3.02 MATERIAL BOARD A6.00 SECTION: BUILDING A A6.01 SECTION: BUILDING B




SQUARE SANITARY SEWER STAINLESS STEEL STANDARD STEEL STORAGE STRUCTURA SUSPENDED TREAD TOP OF CURB/CONCRETE TELEPHONE TONGUE AND GROOVE THICKNESS TOP OF TOP OF SLAB TYPICAL TITLE 24 UNLESS OTHERWISE NOTED VAN ACCESSIBLE VITREOUS CLAY PIPE VINYL COMPOSITION TILE VERTICAL VERIFY IN FIELD WATER CLOSET WOOD WATER HEATER WEATHERSTRIPPING WELDED WIRE FABRIC




Α


В

		A C H I T S T U D I O ARCHITECTURE PLANNING INTERIOR B0 EUREKA SQUARE, SUITE 115, PACIFICA, CA 94044 T: 650.270.1754 E: mfung@architstudioarchitecture.com
		B       G
		NEW RESIDENTIAL BUILDING 21631 HICKS RD LDS GATDS, CA 95032 PROPERTY OWNER ARCHITECT ARCHIT STUDIO 20 EUREKA SQUARE, SUITE 115 PACIFICA, CA 94044 ATTN: MARCO FUNG E: mfung@architstudioarchitecture.com T: 650.270.1754
		VICINITY MAP
		Date Project No. 2021.111.29 Sheet Title
KEYPLAN	K K	RENDERINGS         Sheet       No.         A002         Released for Construction         Not Released for Construction

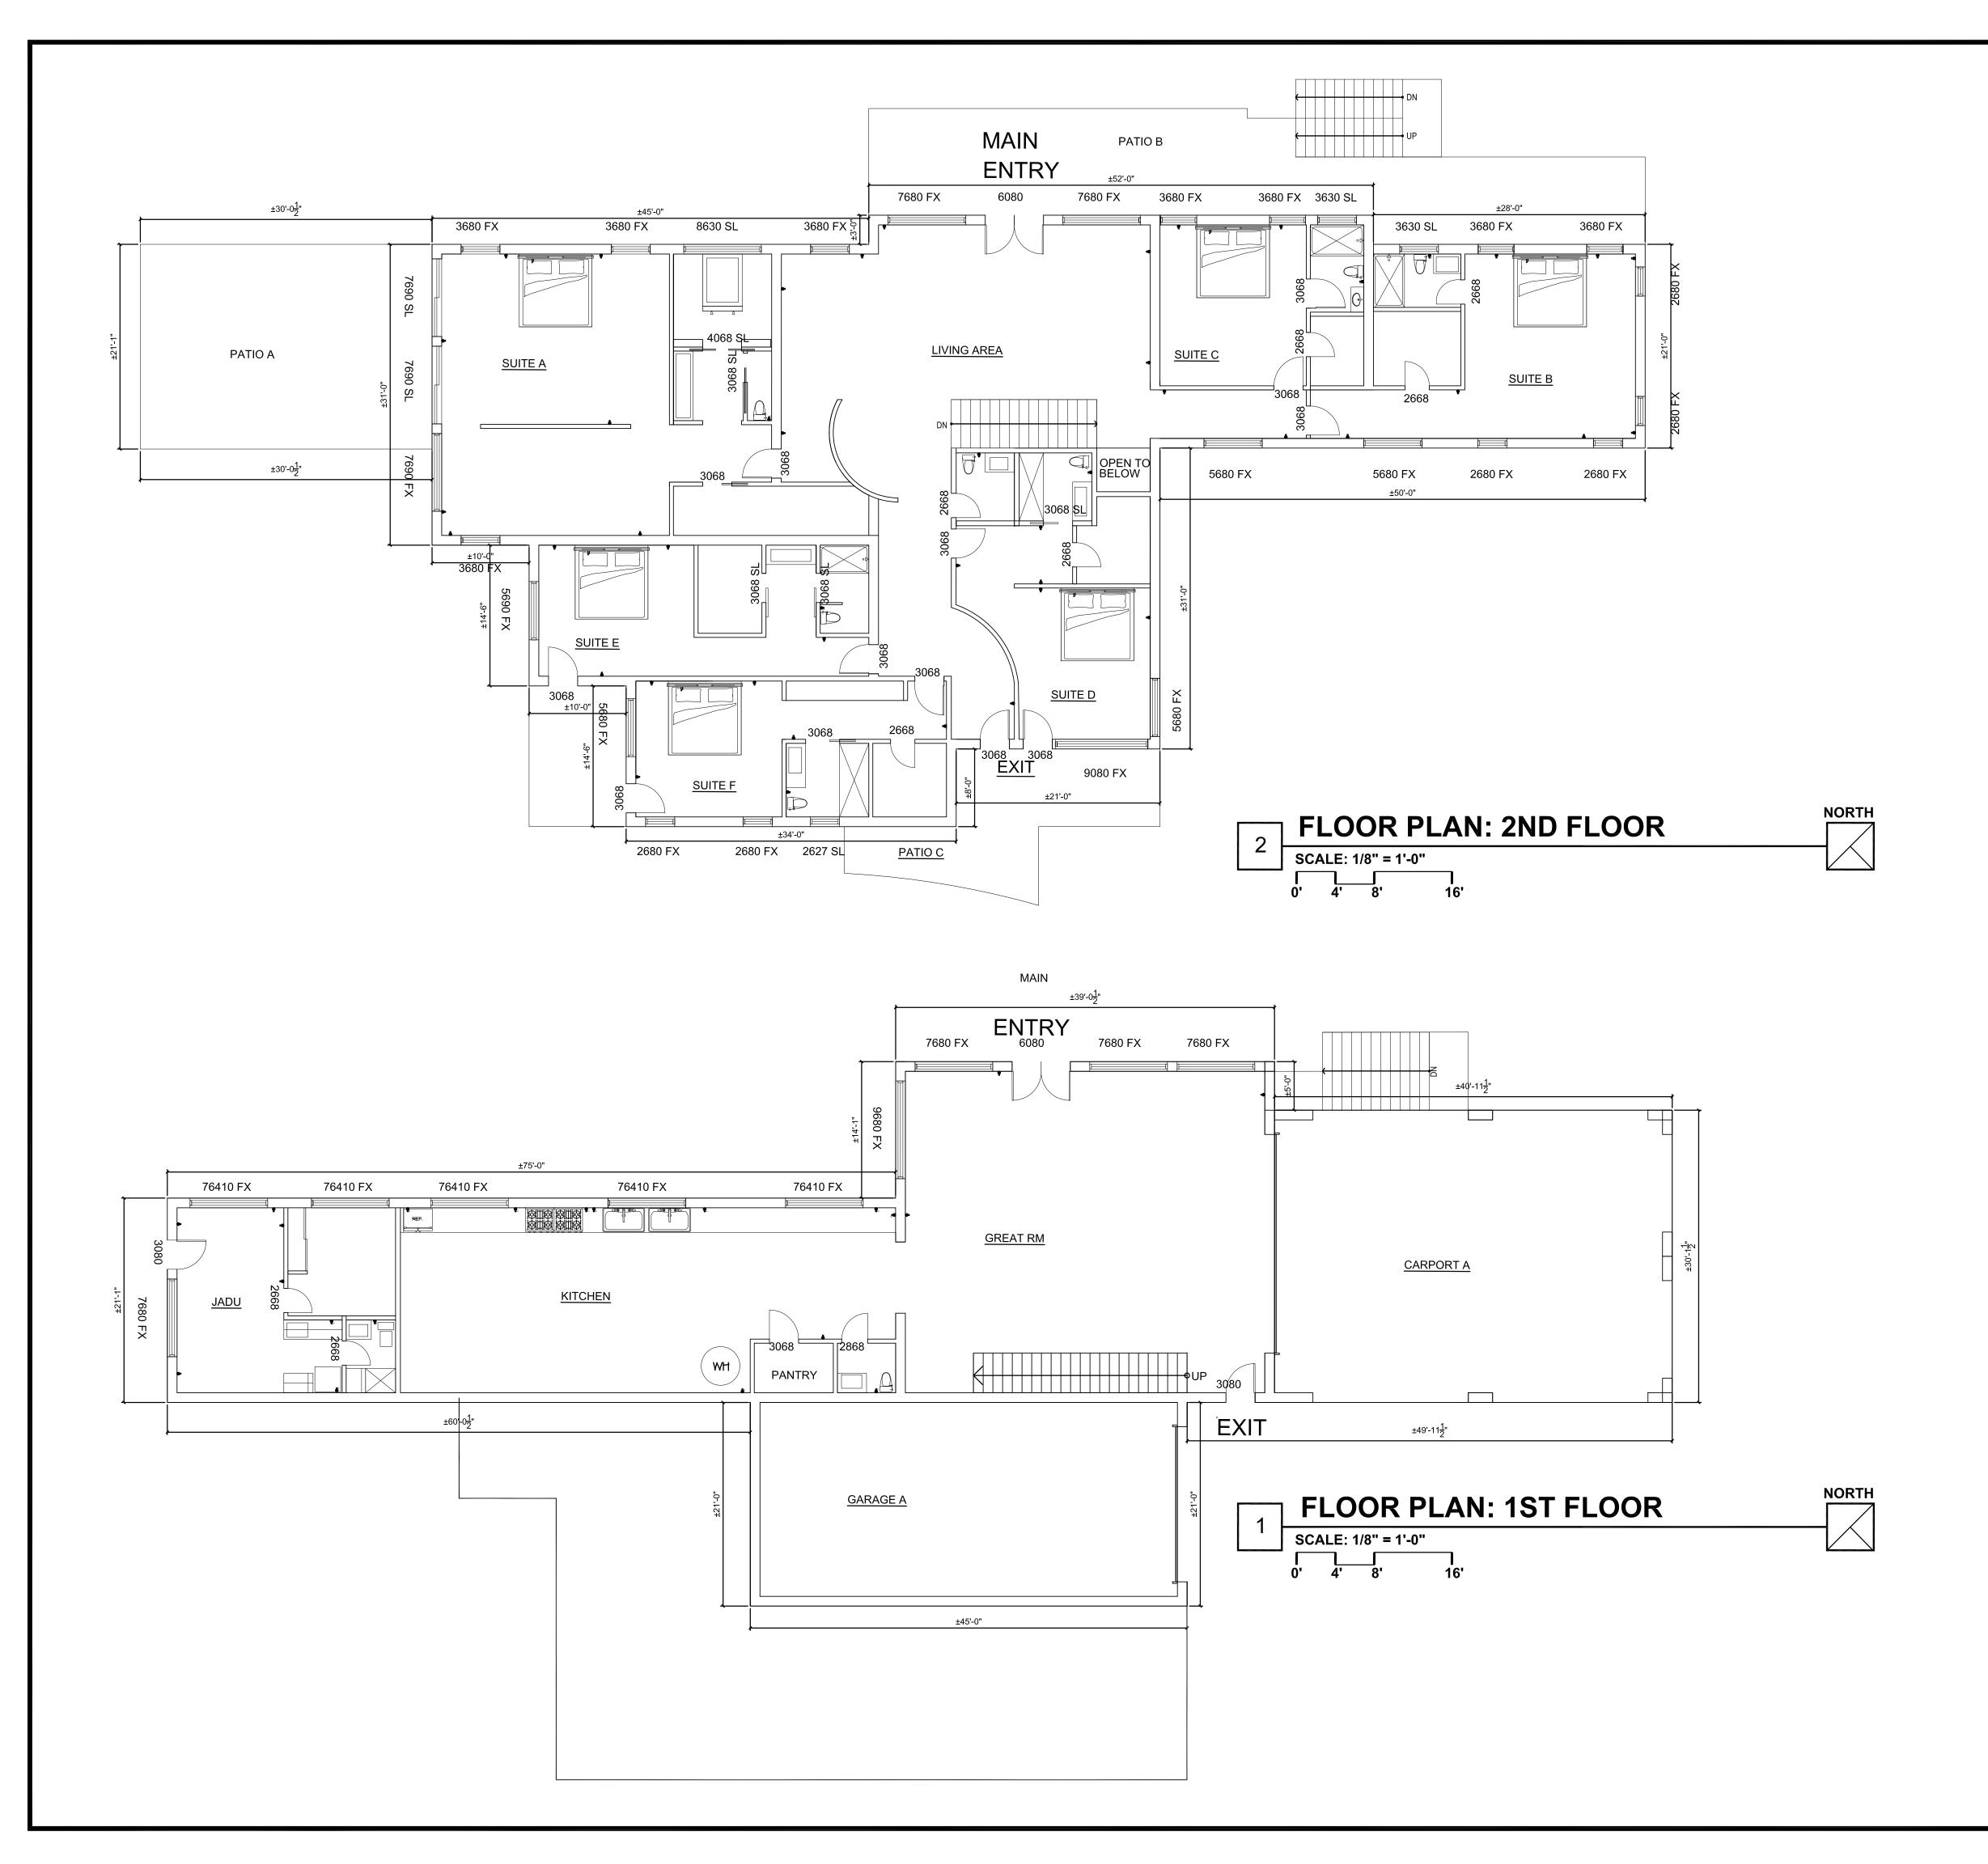


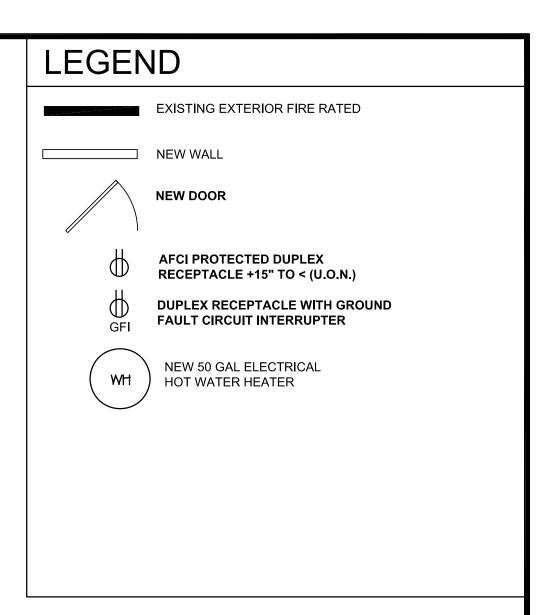





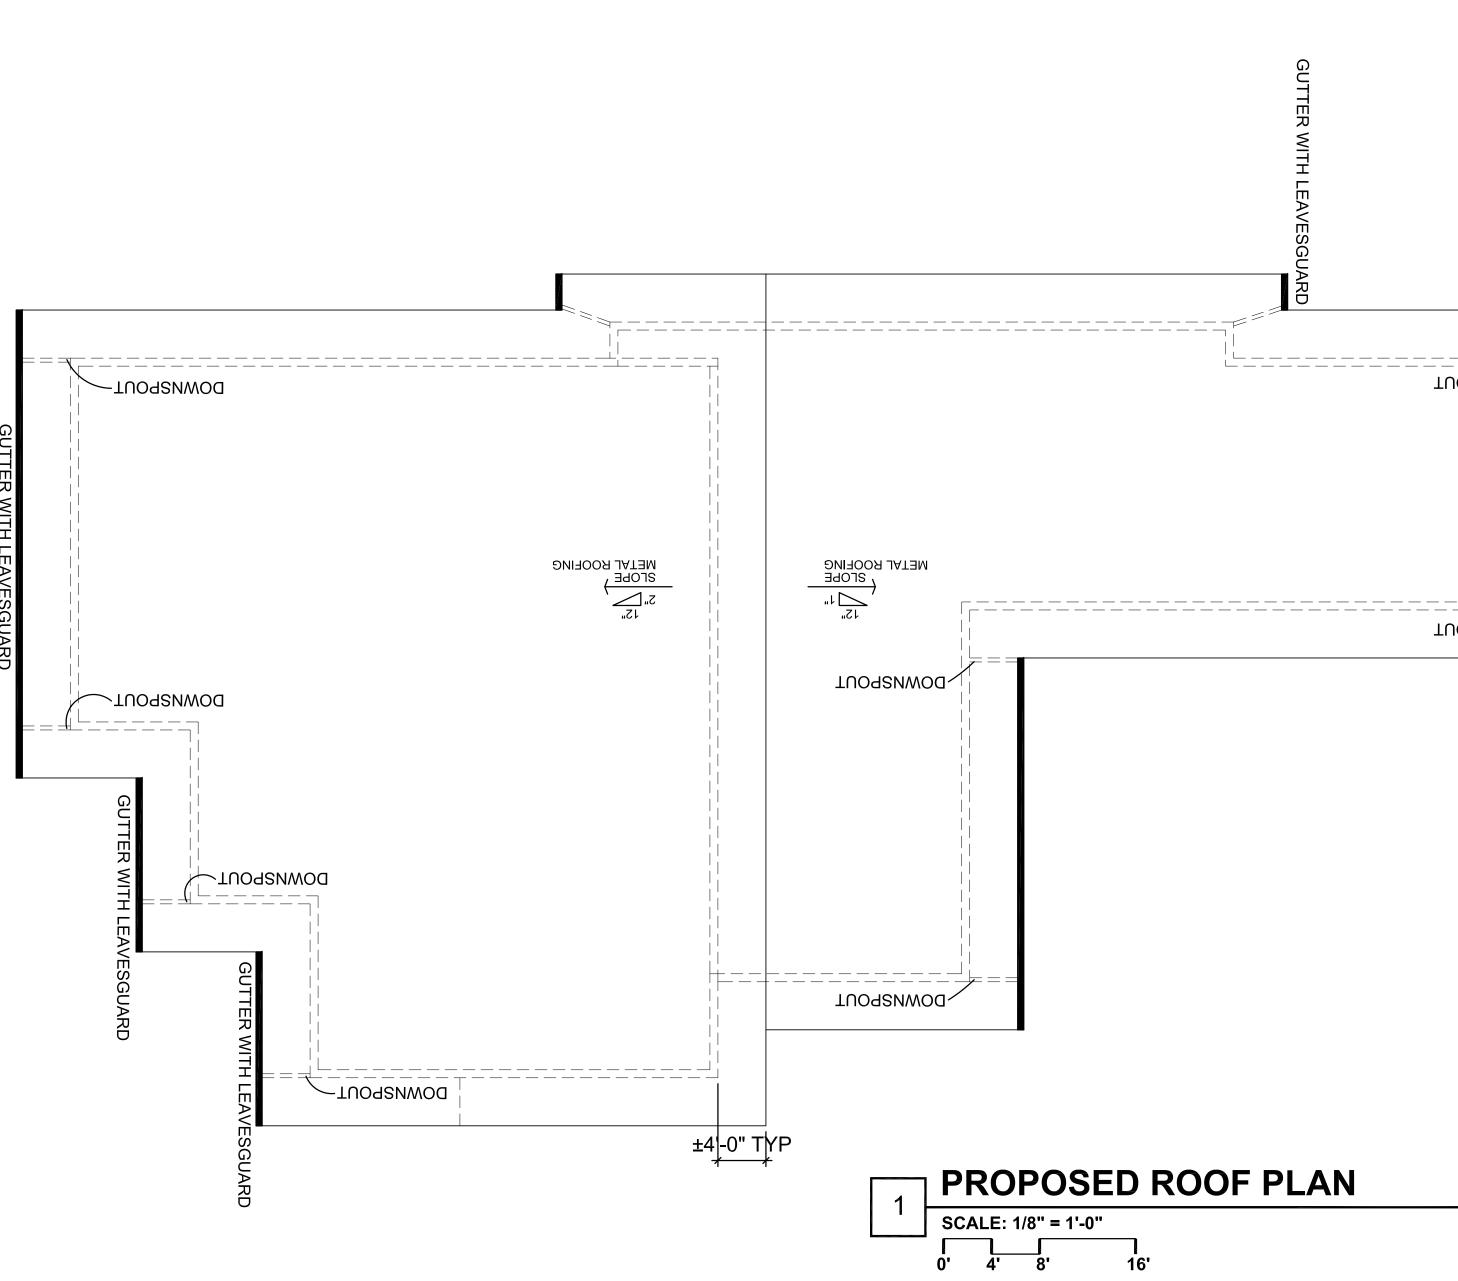



	e و و و و و و و و و و و و و و و و و و و
	A R C H I S T U D I ARCHITECTURE PLANNING INTERIOR B0 EUREKA SQUARE, SUITE 115, PACIFICA, CA 94044 T: 650.270.1754 E: mfung@architstudioarchitecture.com
	A C H I T ARCHITECTURE PLAN UREKA SQUARE, SUITE 115, F 50.270.1754 E: mfung@archi
LOOdSNMOD	A R ARCHI 80 EUREKA S T: 650.270.17
	MARCO CHAM-YIN FUNG C-32363 NOV 30 2021 RENEWAL DATE DATE
THOUSINMOU	80 Eureka Square, Suite 115, Pacifica, CA 94044 t.650.270.1754 e-mail: mfung@architstudioarchitecture.com Print Record
	NEW RESIDENTIAL BUILDING 21631 HICKS RD
	21631 HICKS RD LOS GATOS, CA 95032 PROPERTY OWNER ARCHITECT ARCHIT STUDIO 20 EUREKA SQUARE, SUITE 115 PACIFICA, CA 94044 ATTN: MARCO FUNG
NORTH	E: mfung@architstudioarchitecture.com T: 650.270.1754
	HICKS RD BURGER DE ROJECT LOCATION DURAURE DURAURE COUNTY PROV
	NORTH NORTH
	Date Project No. 2021.11.29 2021.117 Sheet Title ROOF PLAN Sheet
	A201  Released for Construction  Not Released for Construction

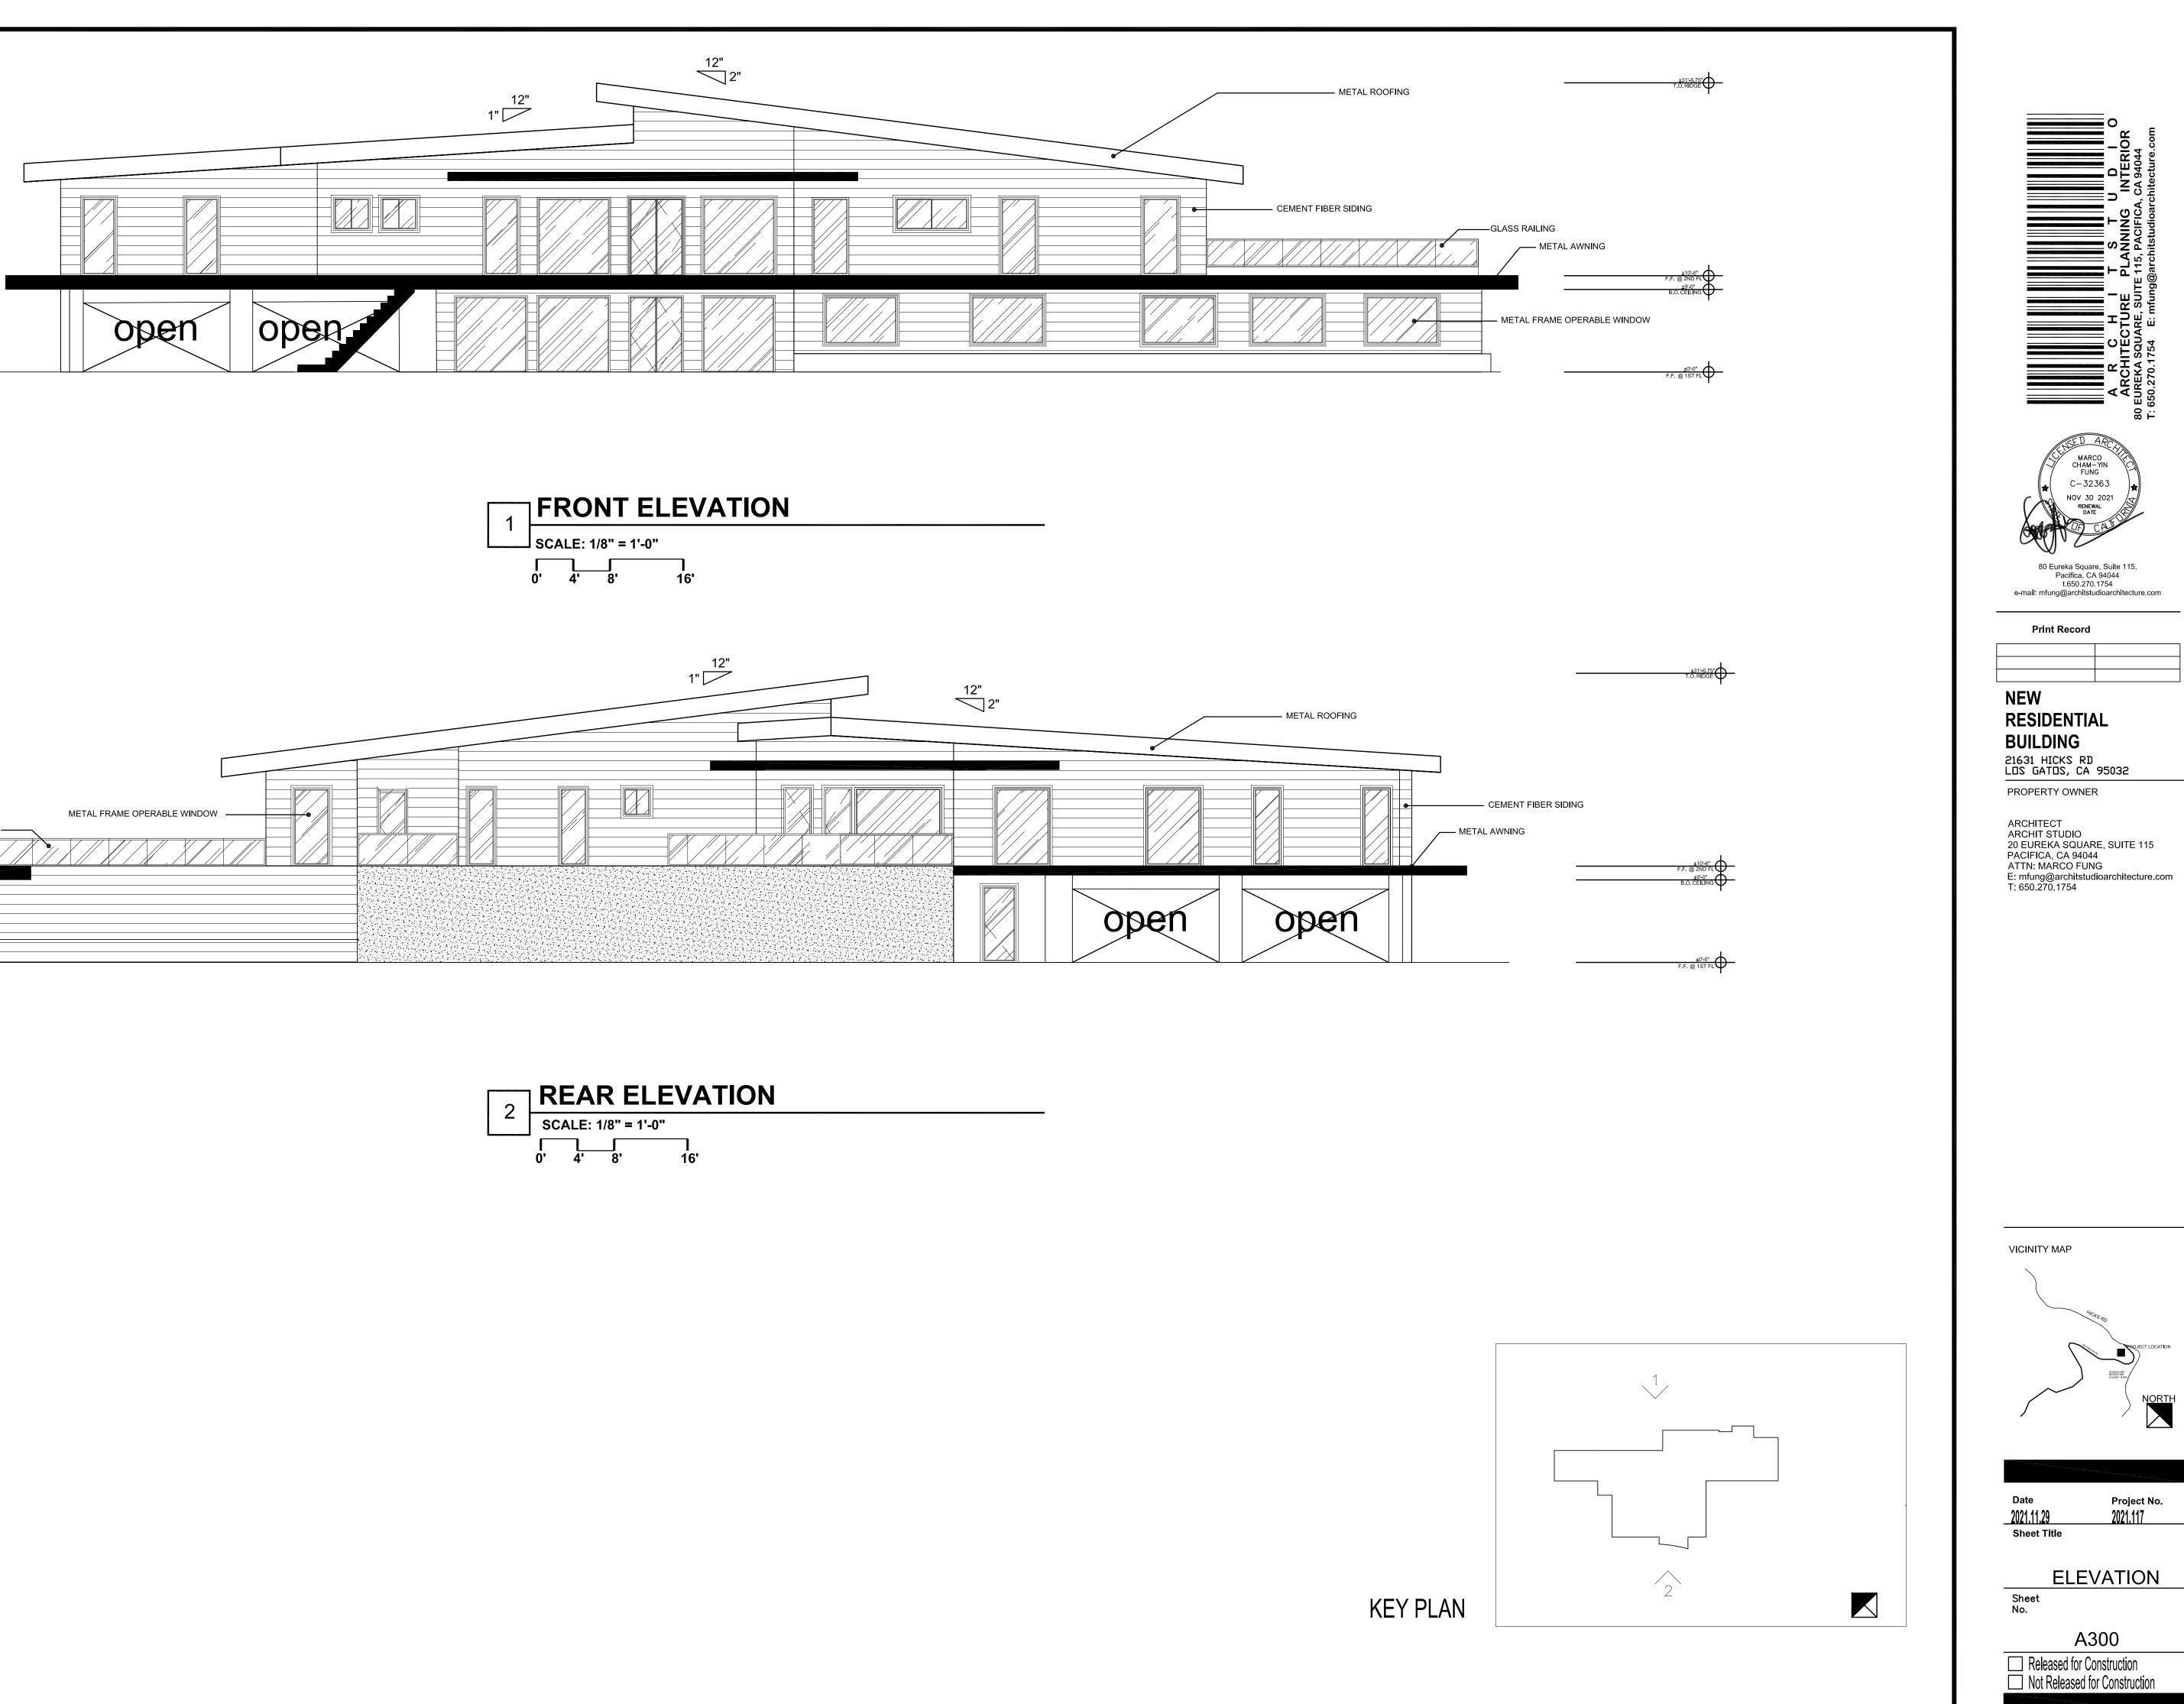


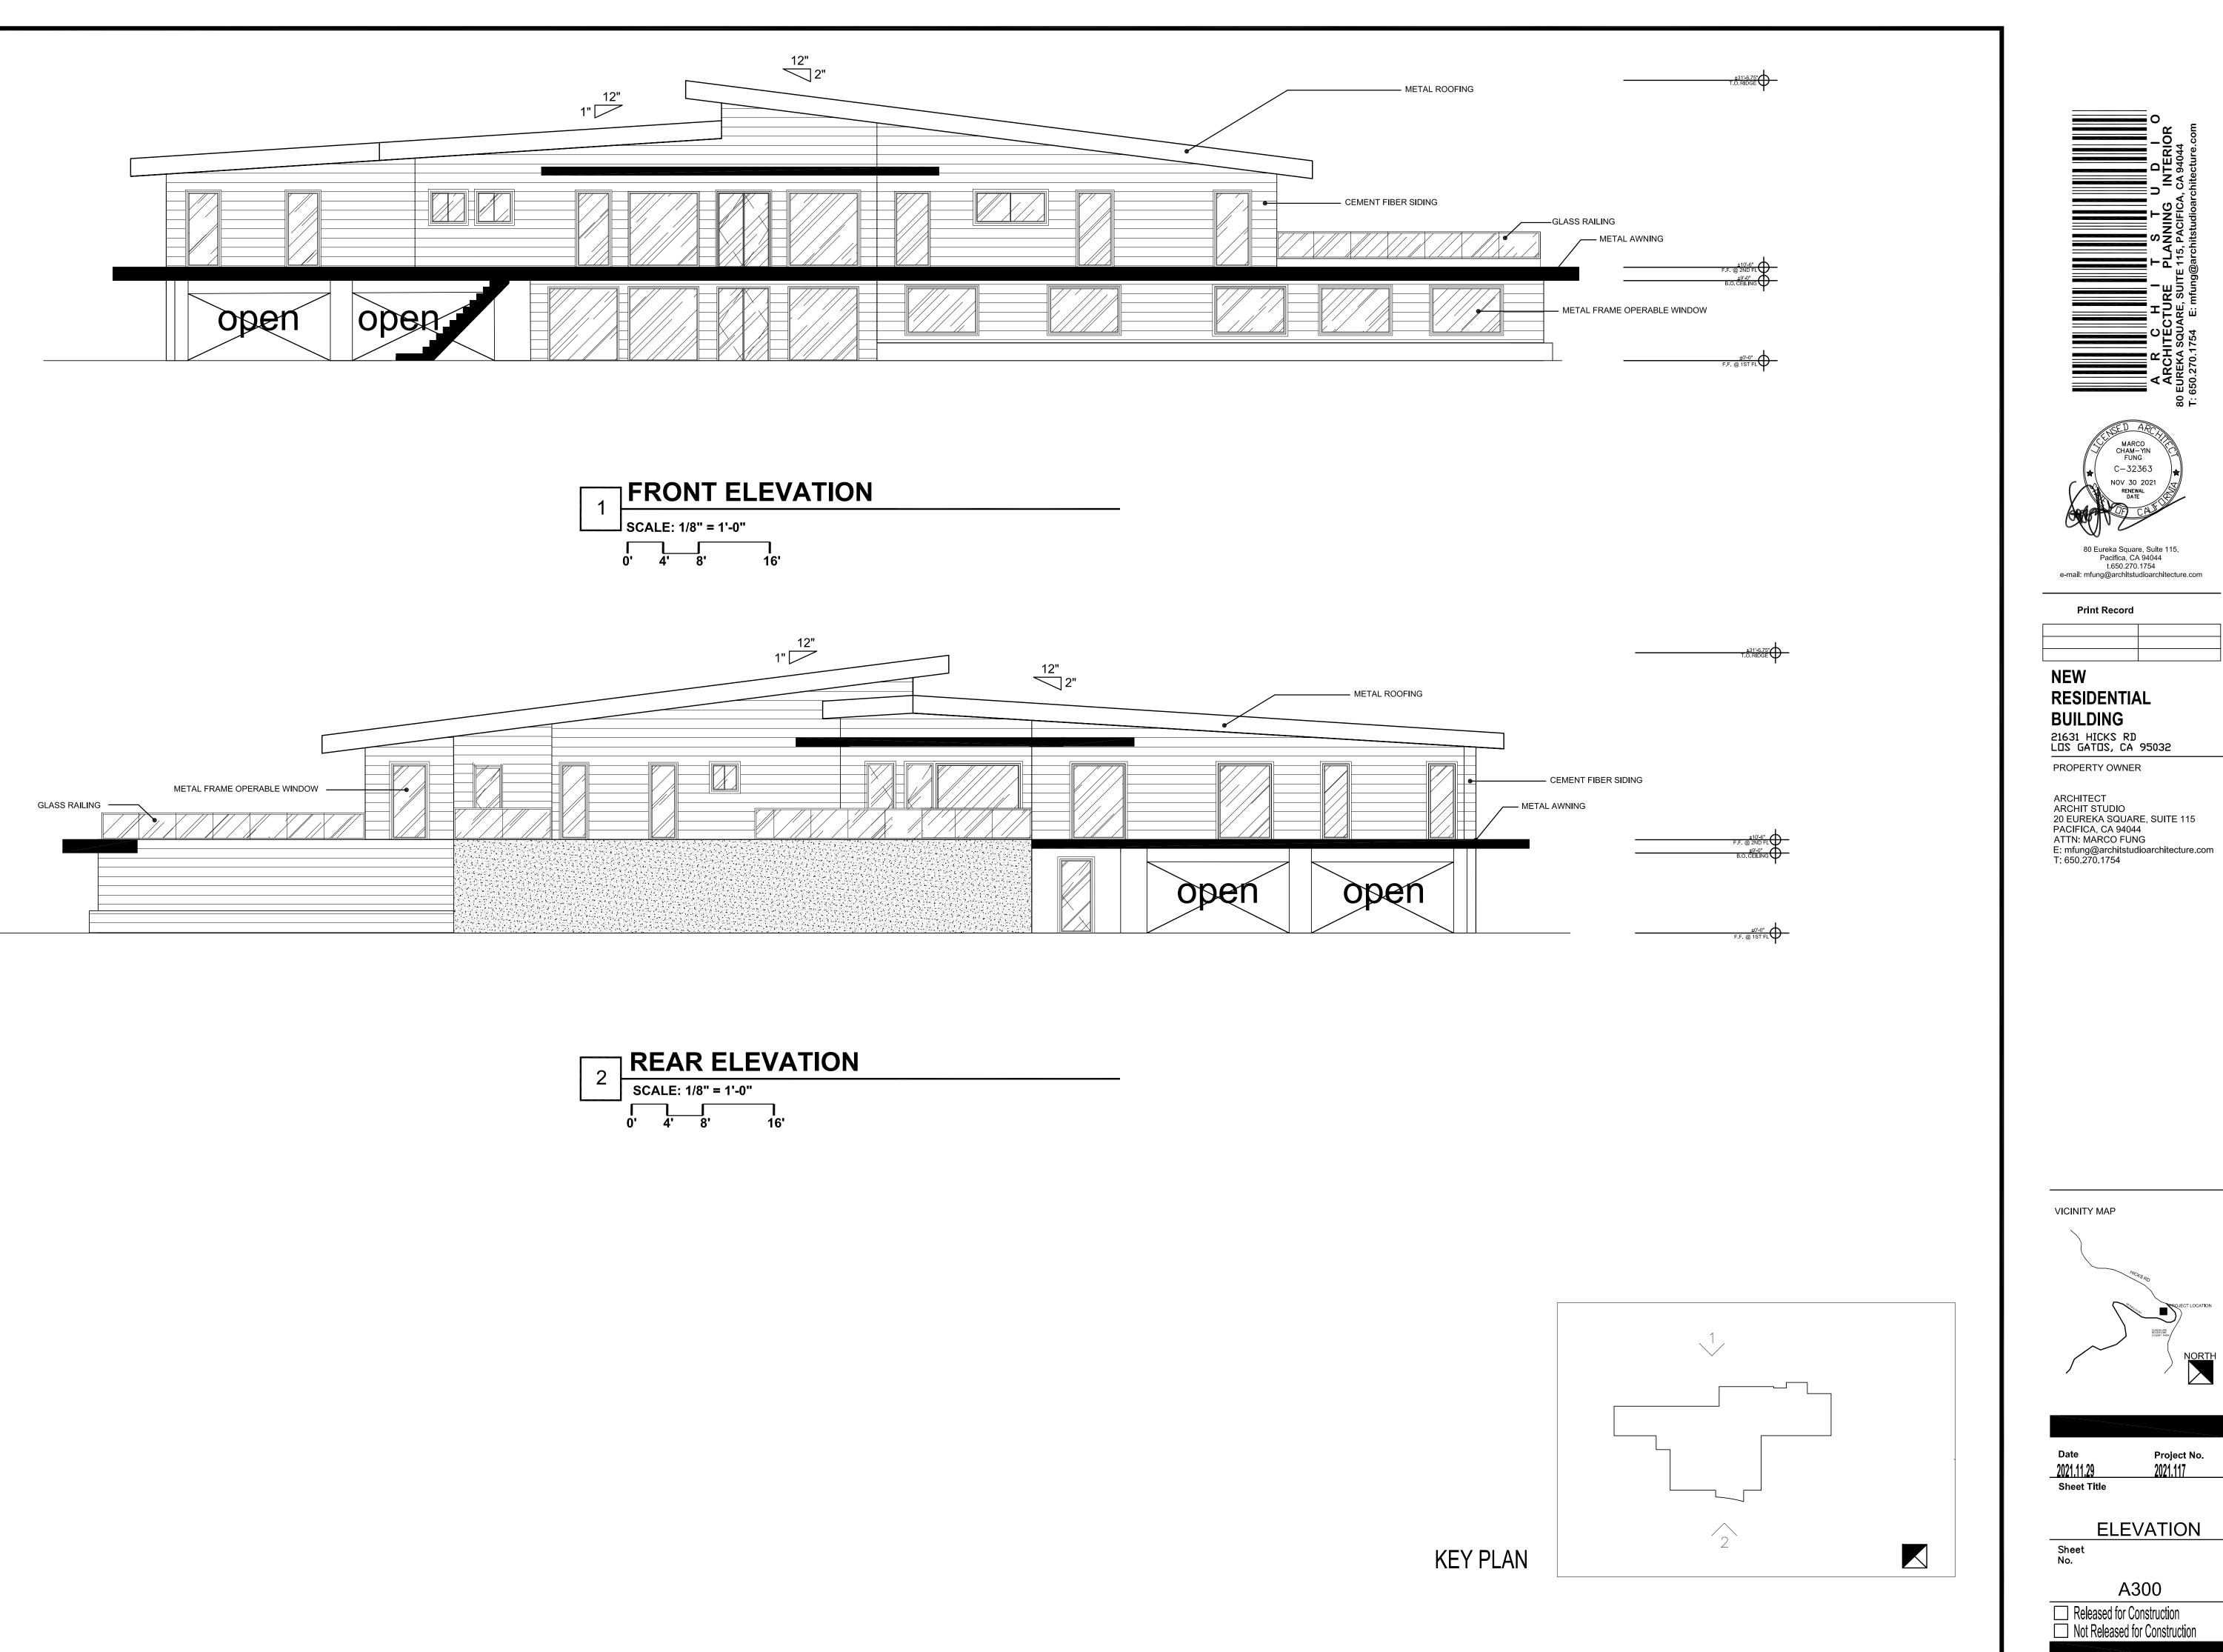


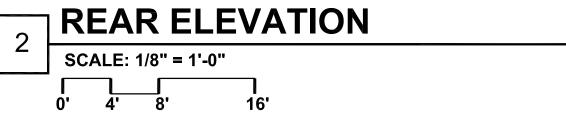

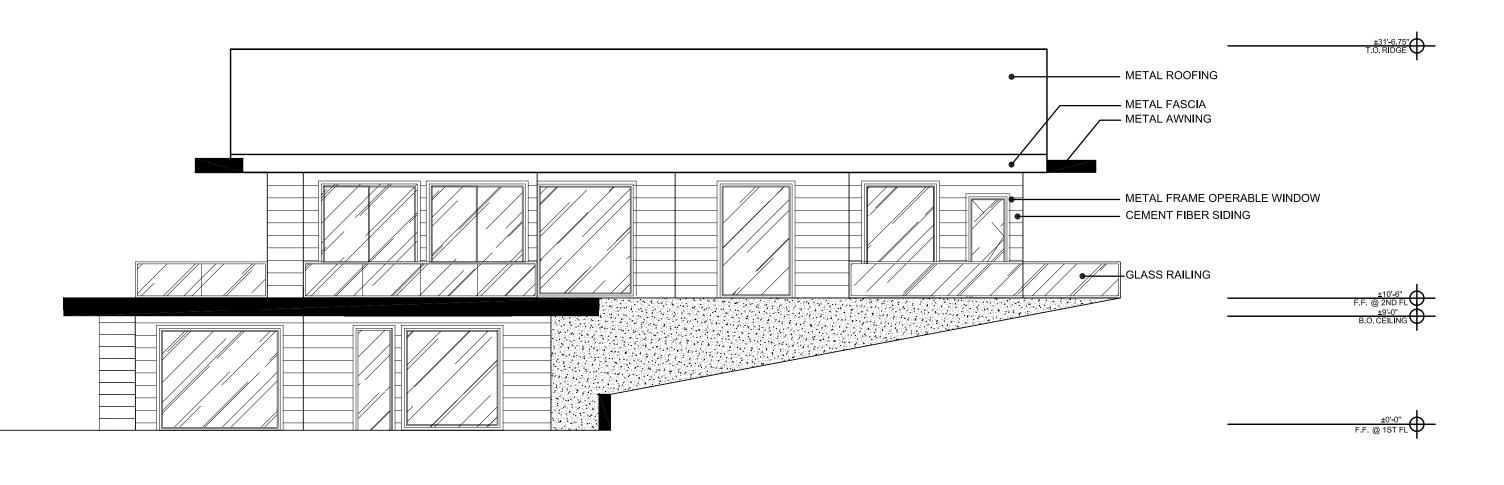

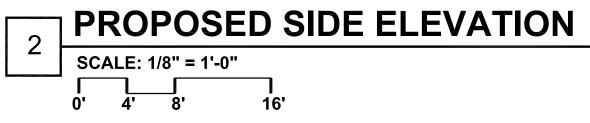

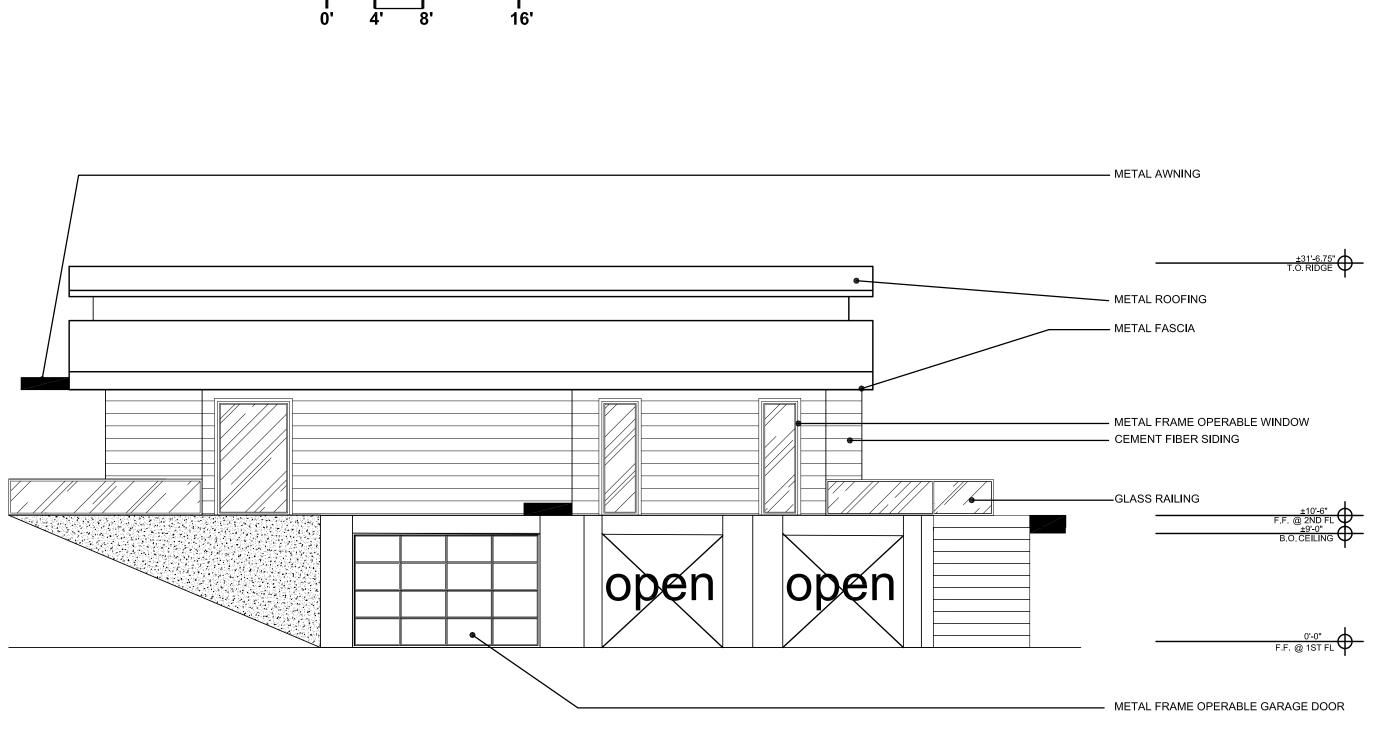

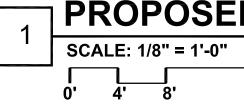


#### PROPOSED SIDE ELEVATION


ו 16'

A C H I T S T U D I O ARCHITECTURE PLANNING INTERIOR ARCHITECTURE PLANNING INTERIOR 80 EUREKA SQUARE, SUITE 115, PACIFICA, CA 94044 T: 650.270.1754 E: mfung@architstudioarchitecture.com
Received a constraint of the second s
NEW BESIDENTIAL BULDING2631 HICKS RD LDS GATDS, CA 95032PROPERTY OWNERARCHITECT ARCHIT STUDIO 20 EUREKA SQUARE, SUITE 115 PACIFICA, CA 94044 ATTN: MARCO FUNGEmfung@architstudioarchitecture.com T. 650.270.1754
VICINITY MAPImage: state s
Date Project No. 2021.11.29 2021.117 Sheet Title PROPOSED ELEVATION Sheet No. A301 Released for Construction Not Released for Construction

KEY PLAN

2

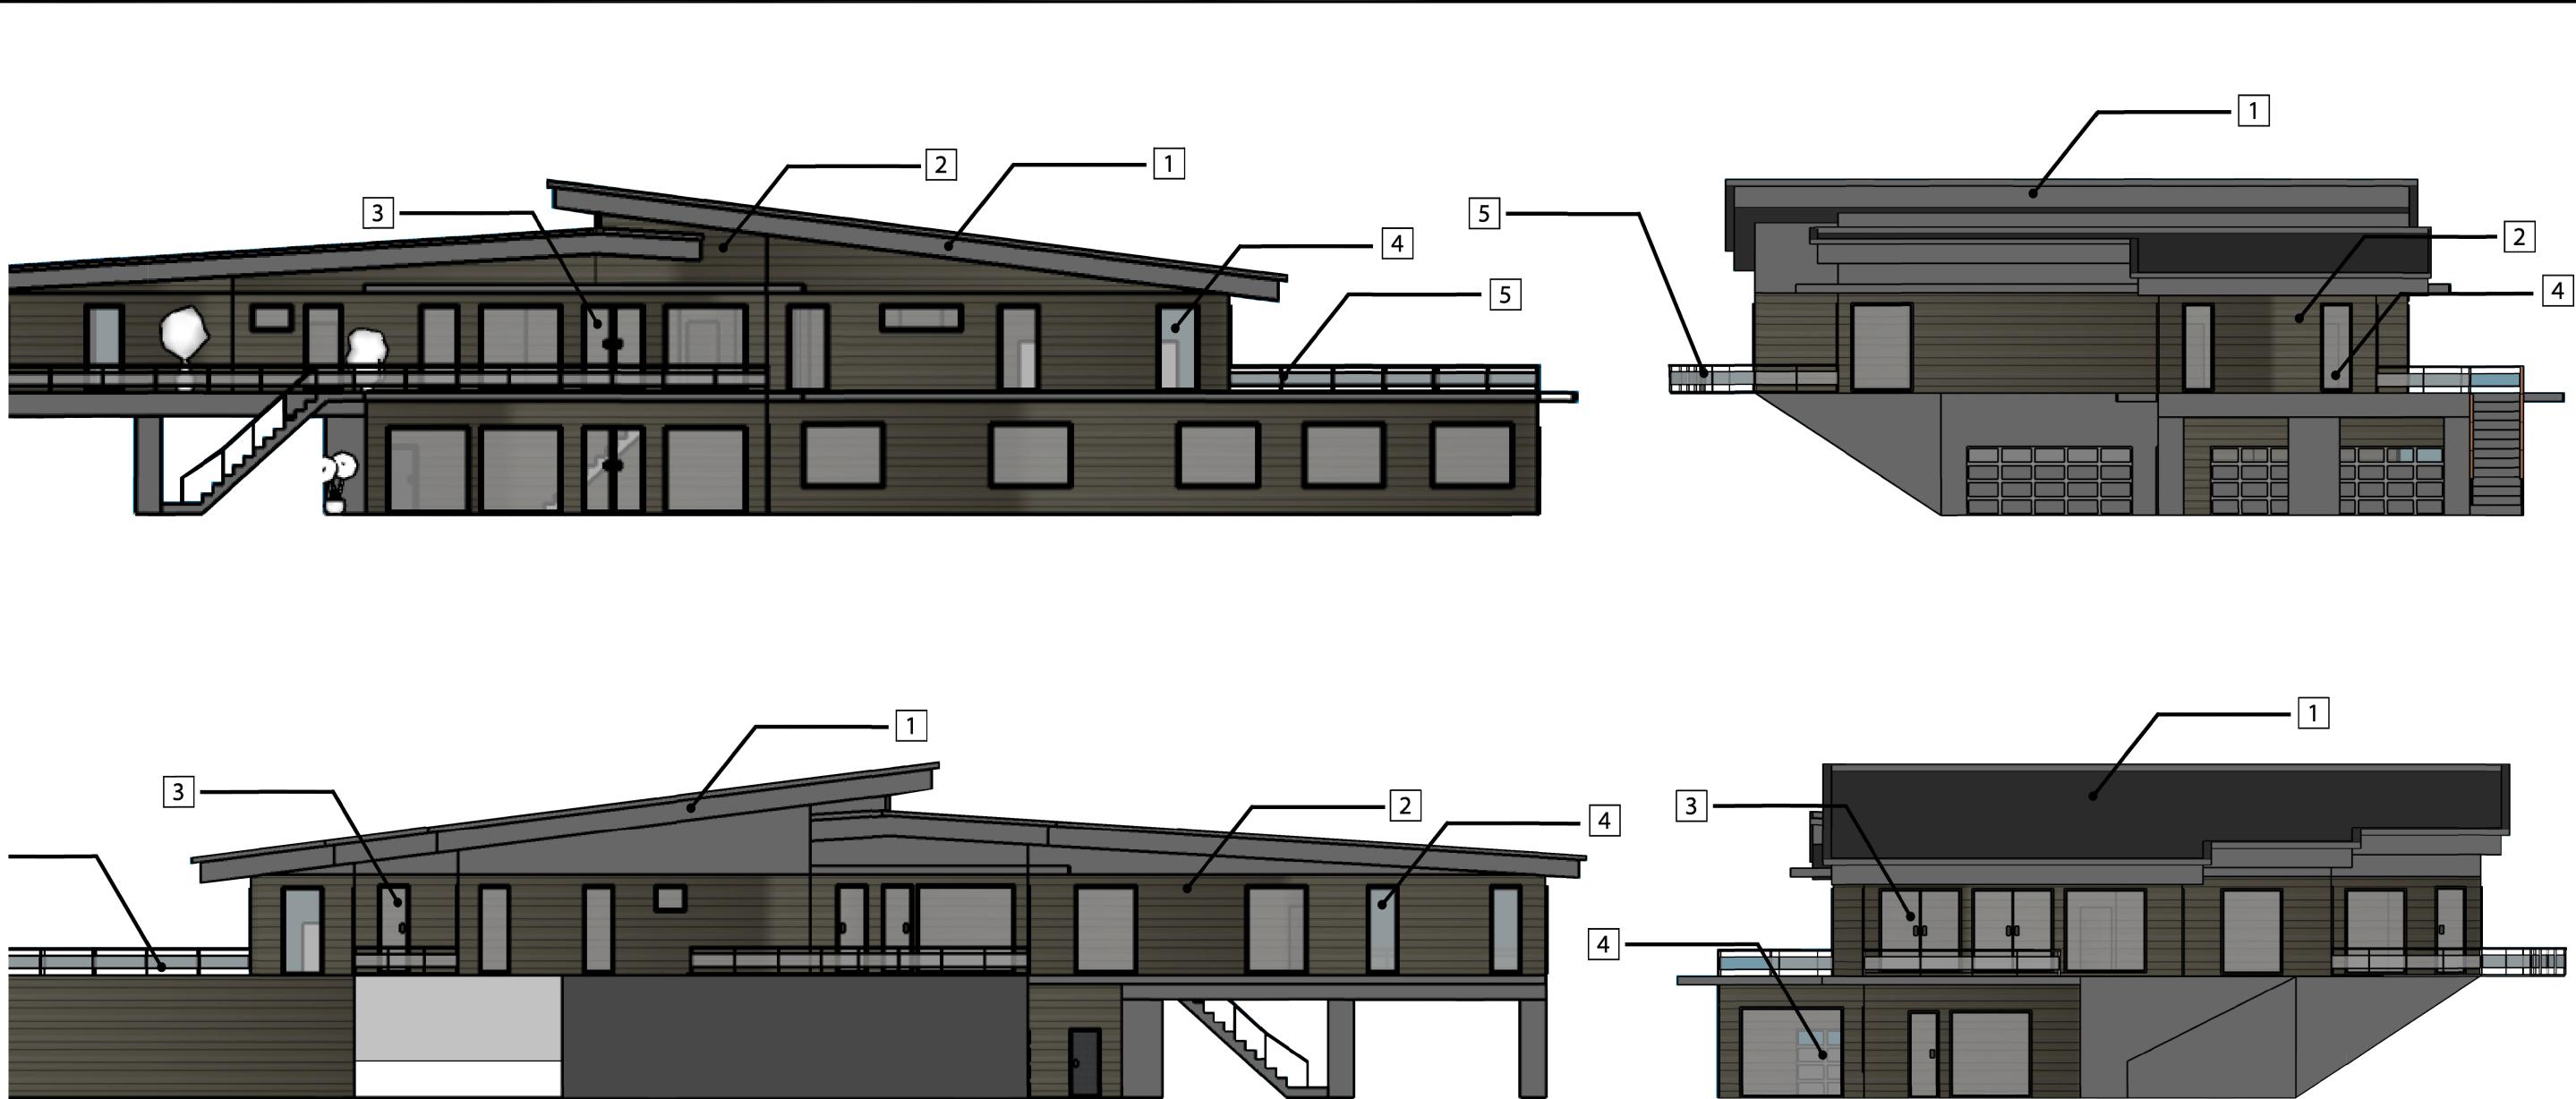

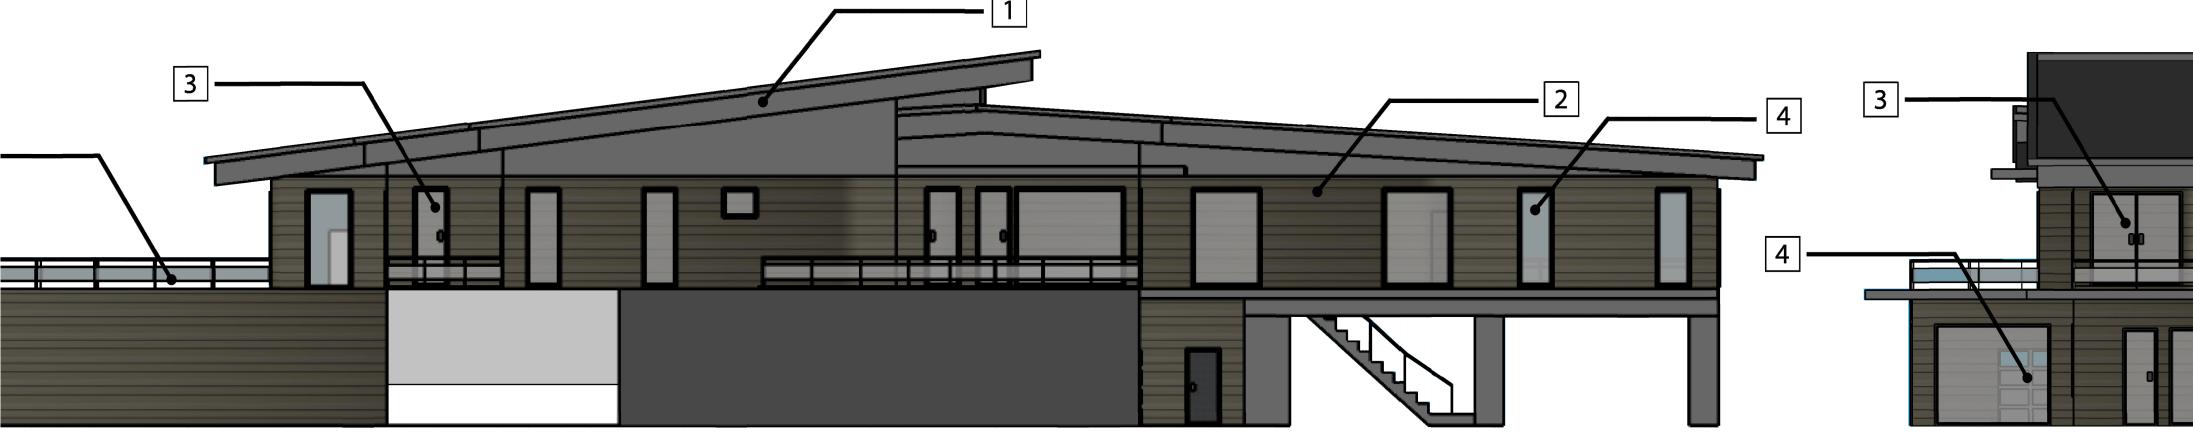



1 407 CARBON KELLY MOORE

2 407 CARBON KELLY MOORE

3 EXTERIOR DOOR BY ANDERSEN




4 EXTERIOR WINDOW 5 EXTERIOR DECK WITH RAILING BY ANDERSEN





#### RESIDENTIAL BUILDING 21631 HICKS RD LOS GATOS, CA 95032

PROPERTY OWNER

ARCHITECT ARCHIT STUDIO 20 EUREKA SQUARE, SUITE 115 PACIFICA, CA 94044 ATTN: MARCO FUNG E: mfung@architstudioarchitecture.com T: 650.270.1754

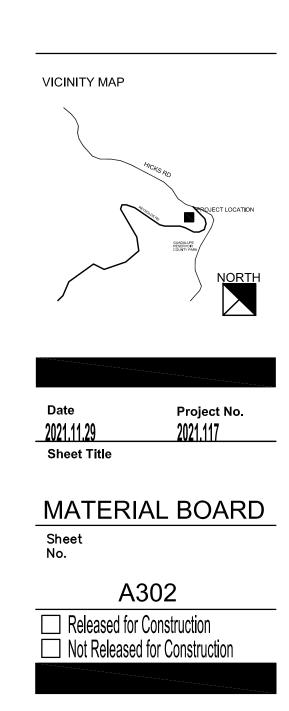

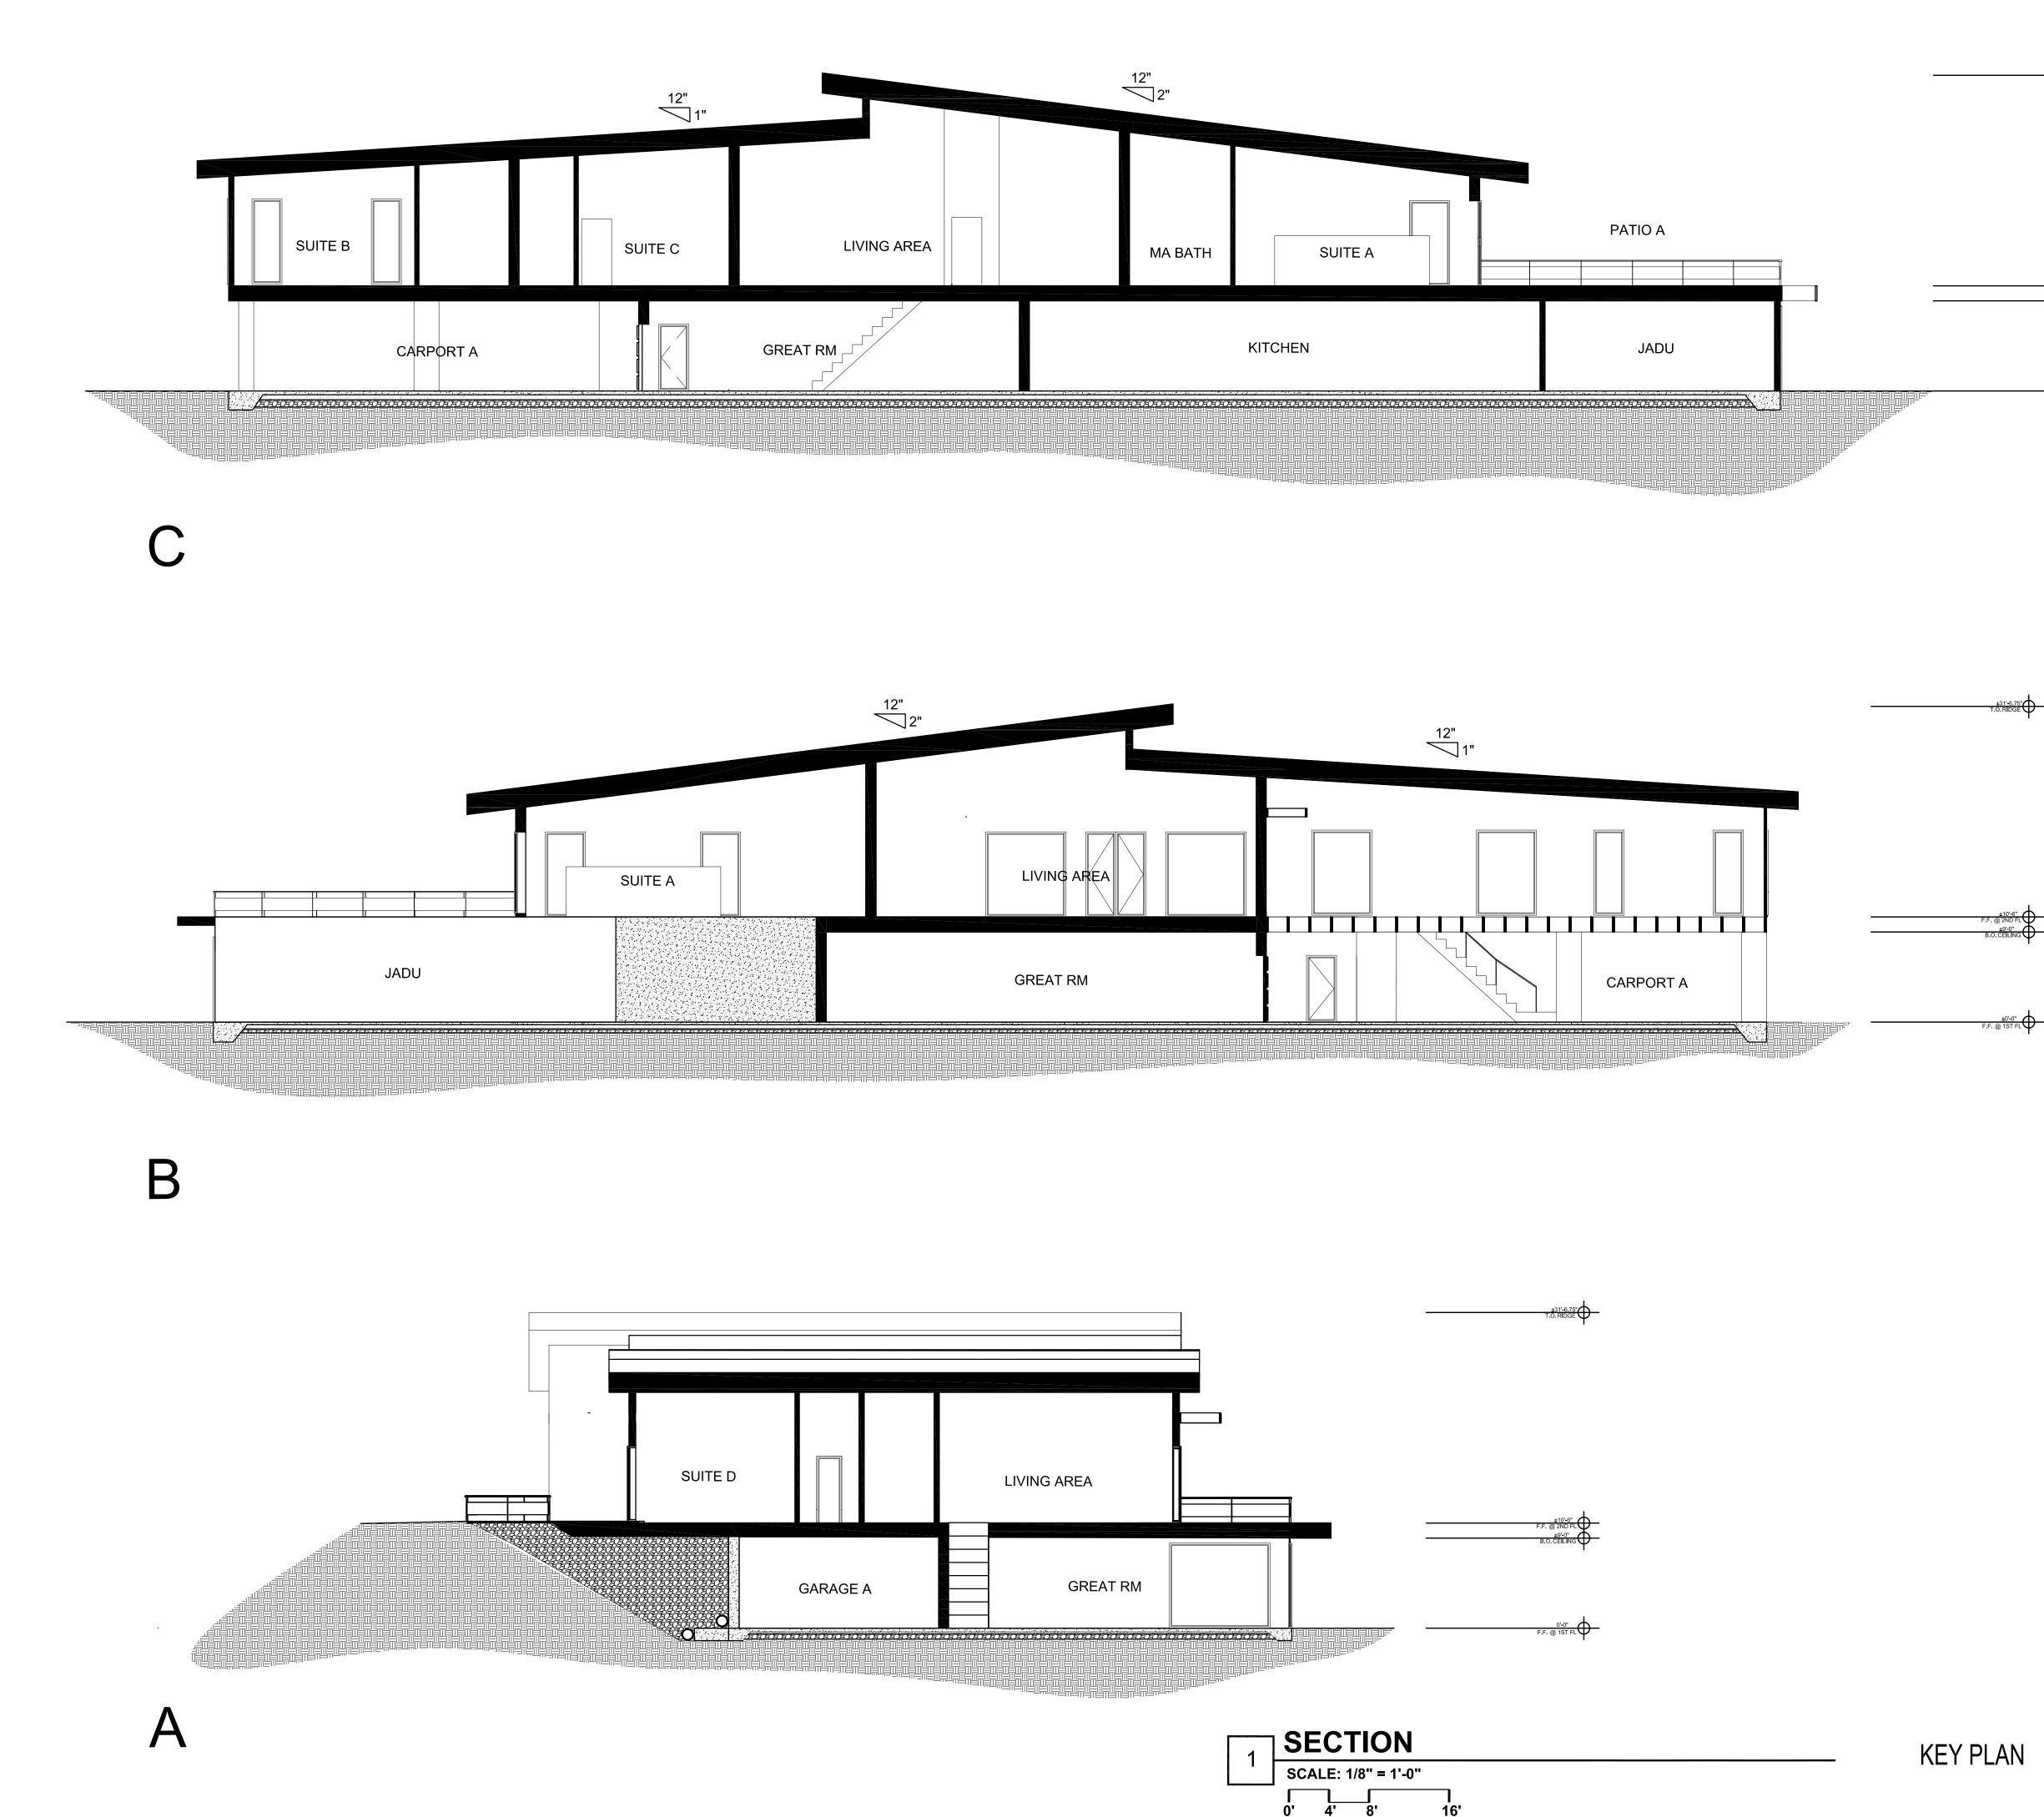


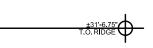


±0'-0"

<u>±0'-0"</u>

В $\leftarrow$ 

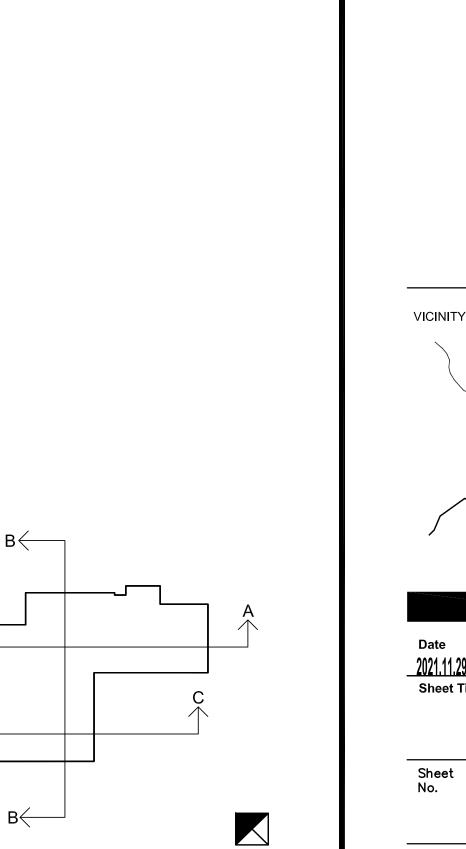

.: ₩ MARCO CHAM-YIN FUNG C-32363 NOV 30 2021 RENEWAL DATE 80 Eureka Square, Suite 115, Pacifica, CA 94044 t.650.270.1754 e-mail: mfung@architstudioarchitecture.com Print Record NEW RESIDENTIAL BUILDING 21631 HICKS RD LOS GATOS, CA 95032 PROPERTY OWNER ARCHITECT ARCHIT STUDIO 20 EUREKA SQUARE, SUITE 115 PACIFICA, CA 94044 ATTN: MARCO FUNG E: mfung@architstudioarchitecture.com T: 650.270.1754

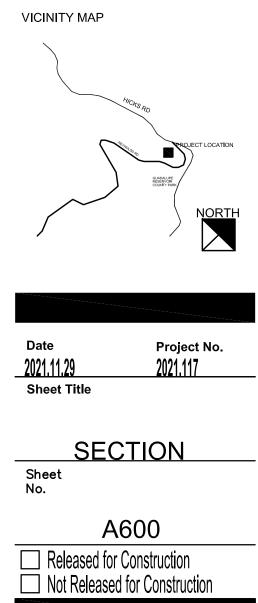






#### NEW RESIDENTIAL BUILDING


21631 HICKS RD LDS GATDS, CA 95032 PROPERTY OWNER


ARCHITECT ARCHIT STUDIO 20 EUREKA SQUARE, SUITE 115 PACIFICA, CA 94044 ATTN: MARCO FUNG E: mfung@architstudioarchitecture.com T: 650.270.1754

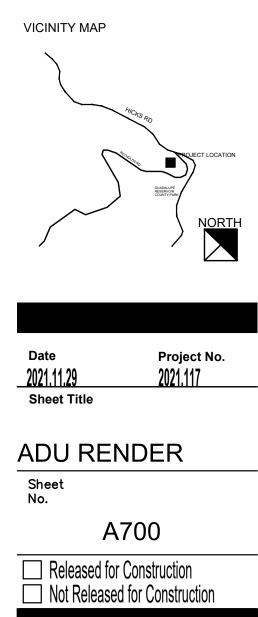


KEYPLAN


 $\searrow$ 

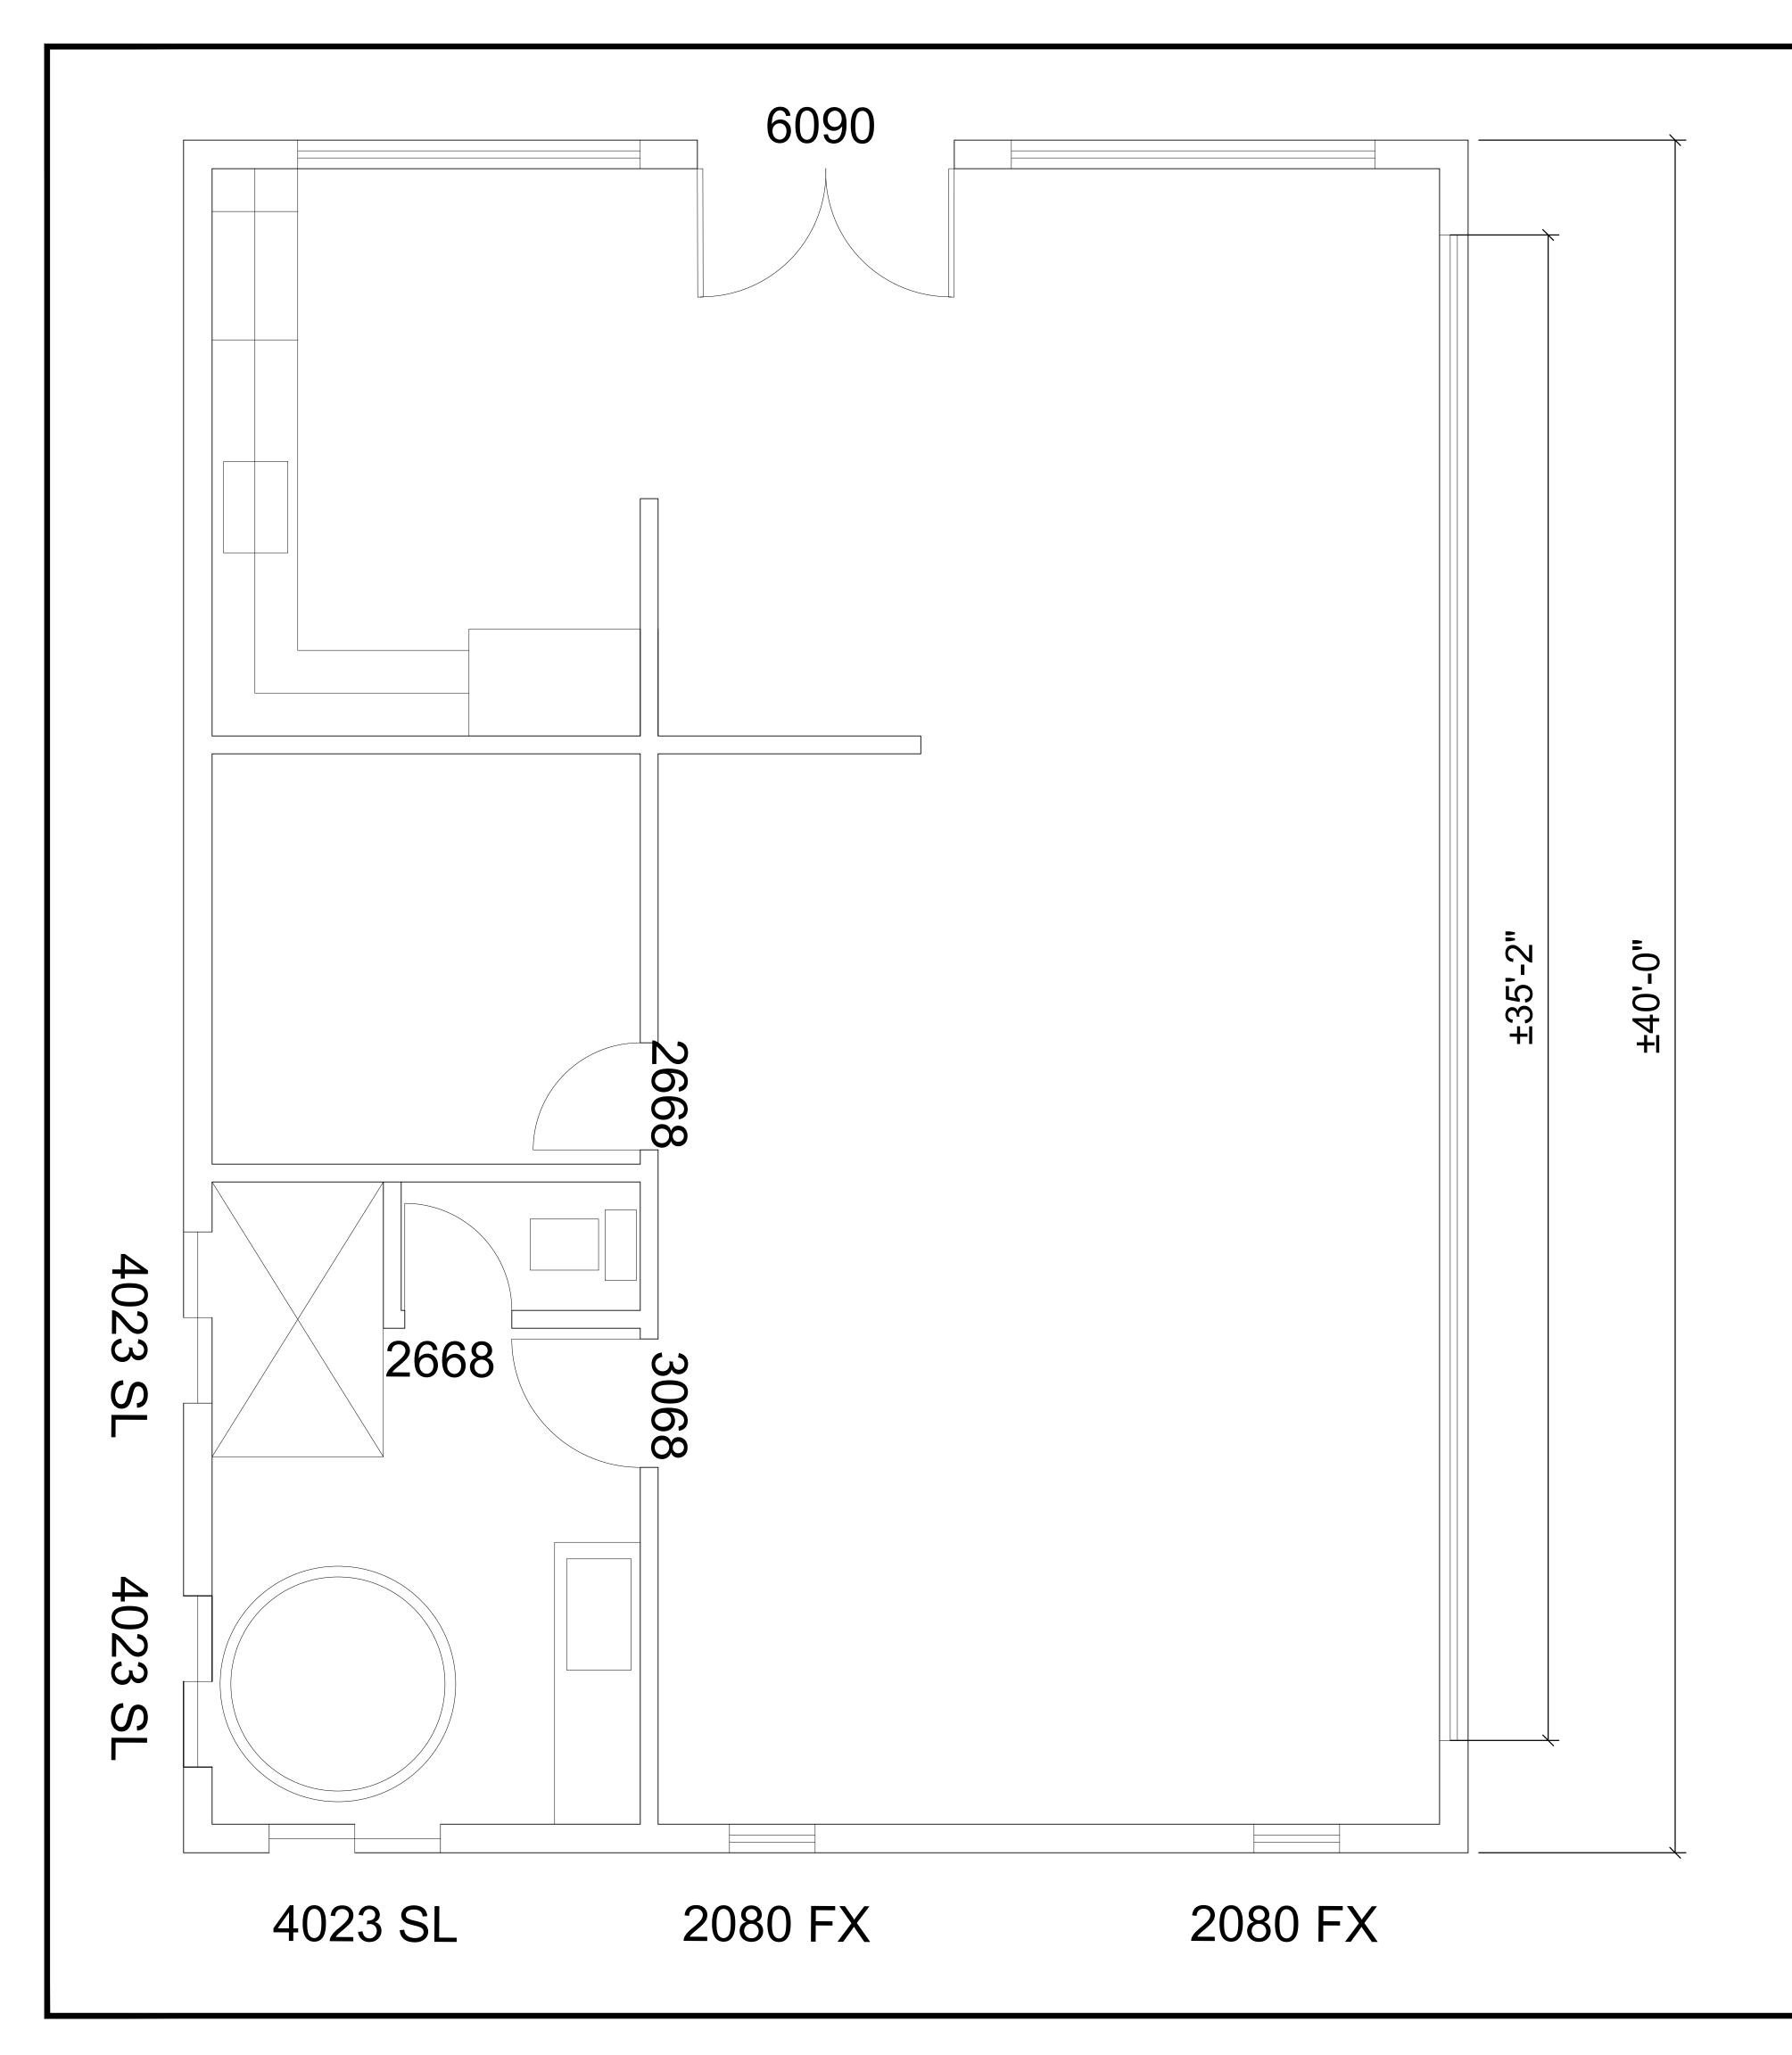

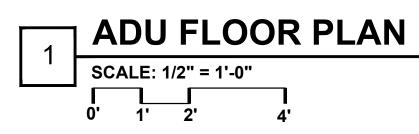


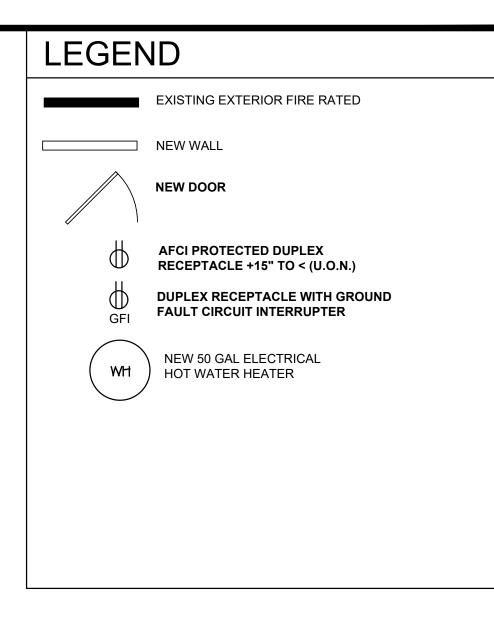




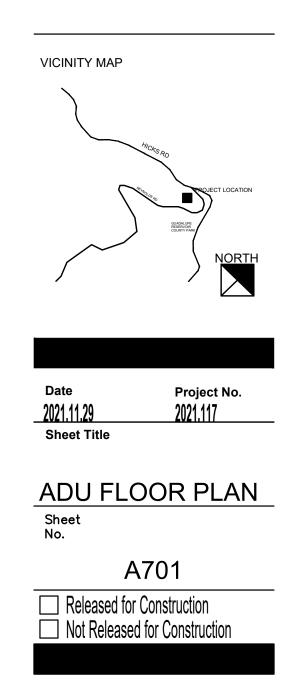




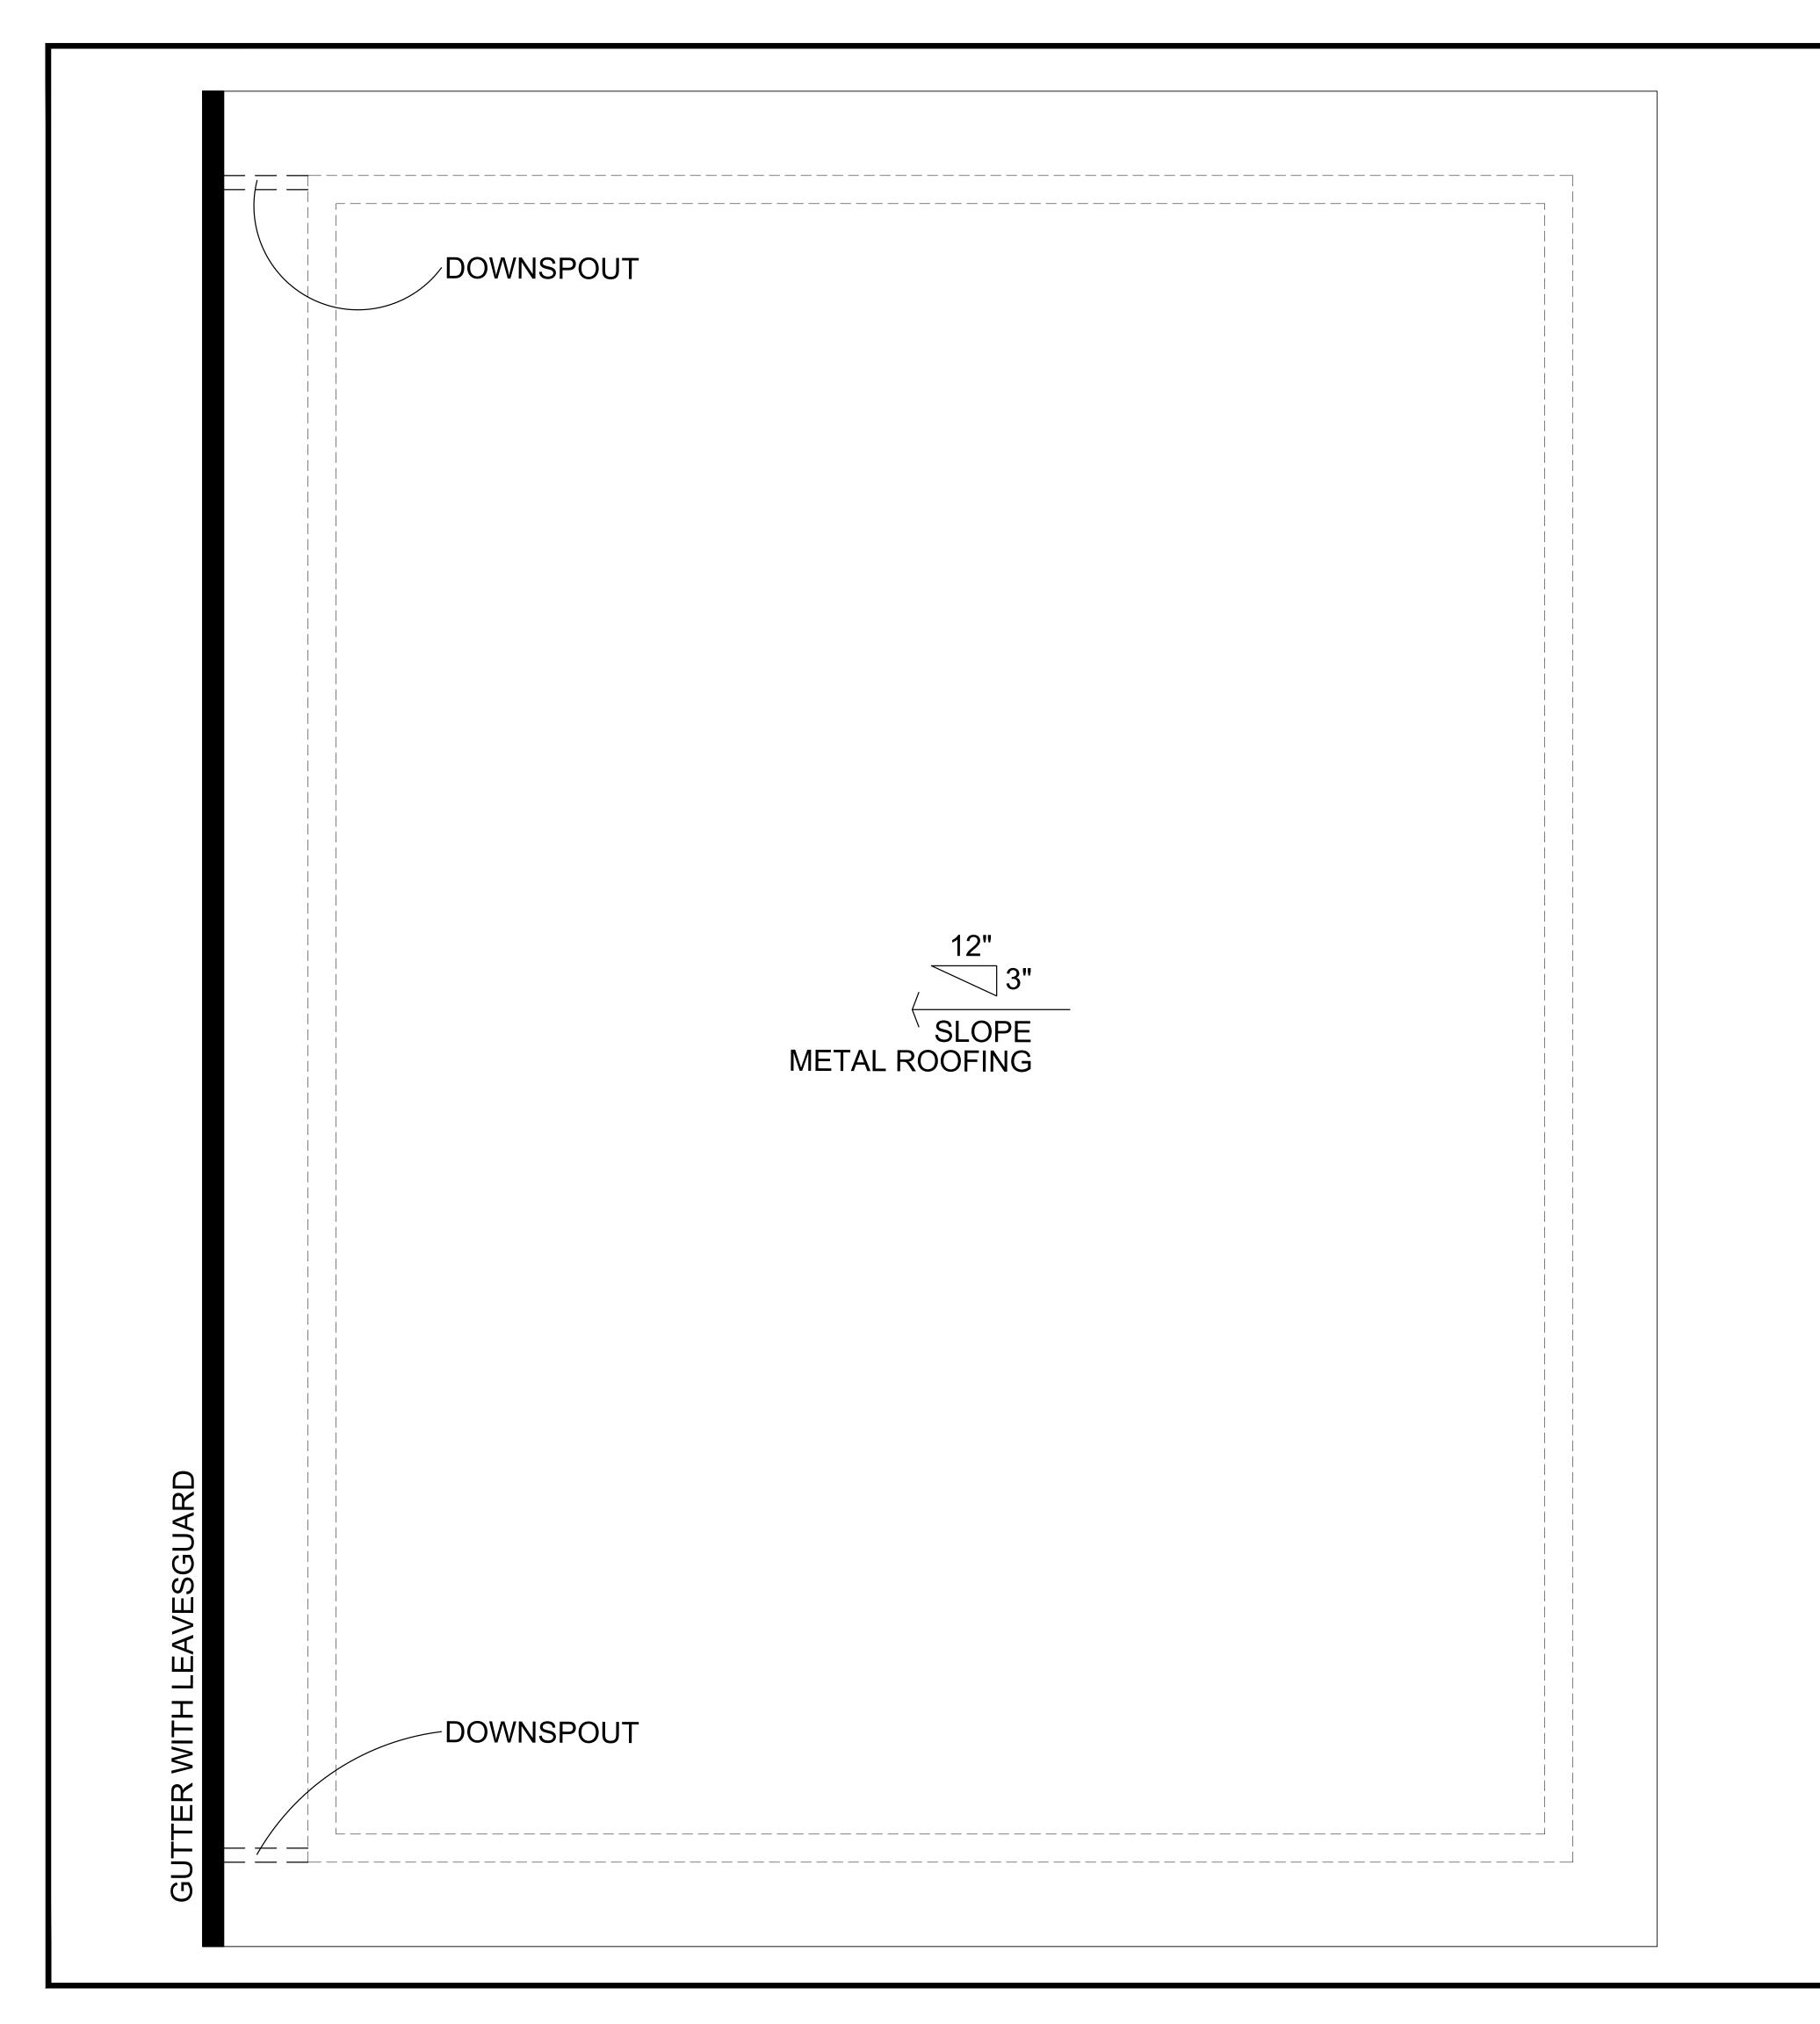

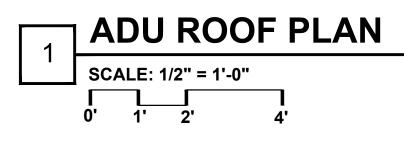


	A R C H I T S T U D I O ARCHITECTURE PLANNING INTERIOR 80 EUREKA SQUARE, SUITE 115, PACIFICA, CA 94044 T: 650.270.1754 E: mfung@architstudioarchitecture.com
80 Eureka S Pacific t.650	D ARCH MARCO HAM-YIN FUNG -32363 V 30 2021 RENEWAL DATE CALL Square, Suite 115, ra, CA 94044 0.270.1754
e-mail: mfung@arc	chitstudioarchitecture.com
PACIFICA, CA 9 ATTN: MARCO	RD CA 95032 /NER O UARE, SUITE 115 4044 FUNG tstudioarchitecture.com
	MCKS RD DUECT LOCATION
	NORTH
Date 2021.11.29	Project No. 2021.117
Sheet Title	
	A702
	or Construction ed for Construction



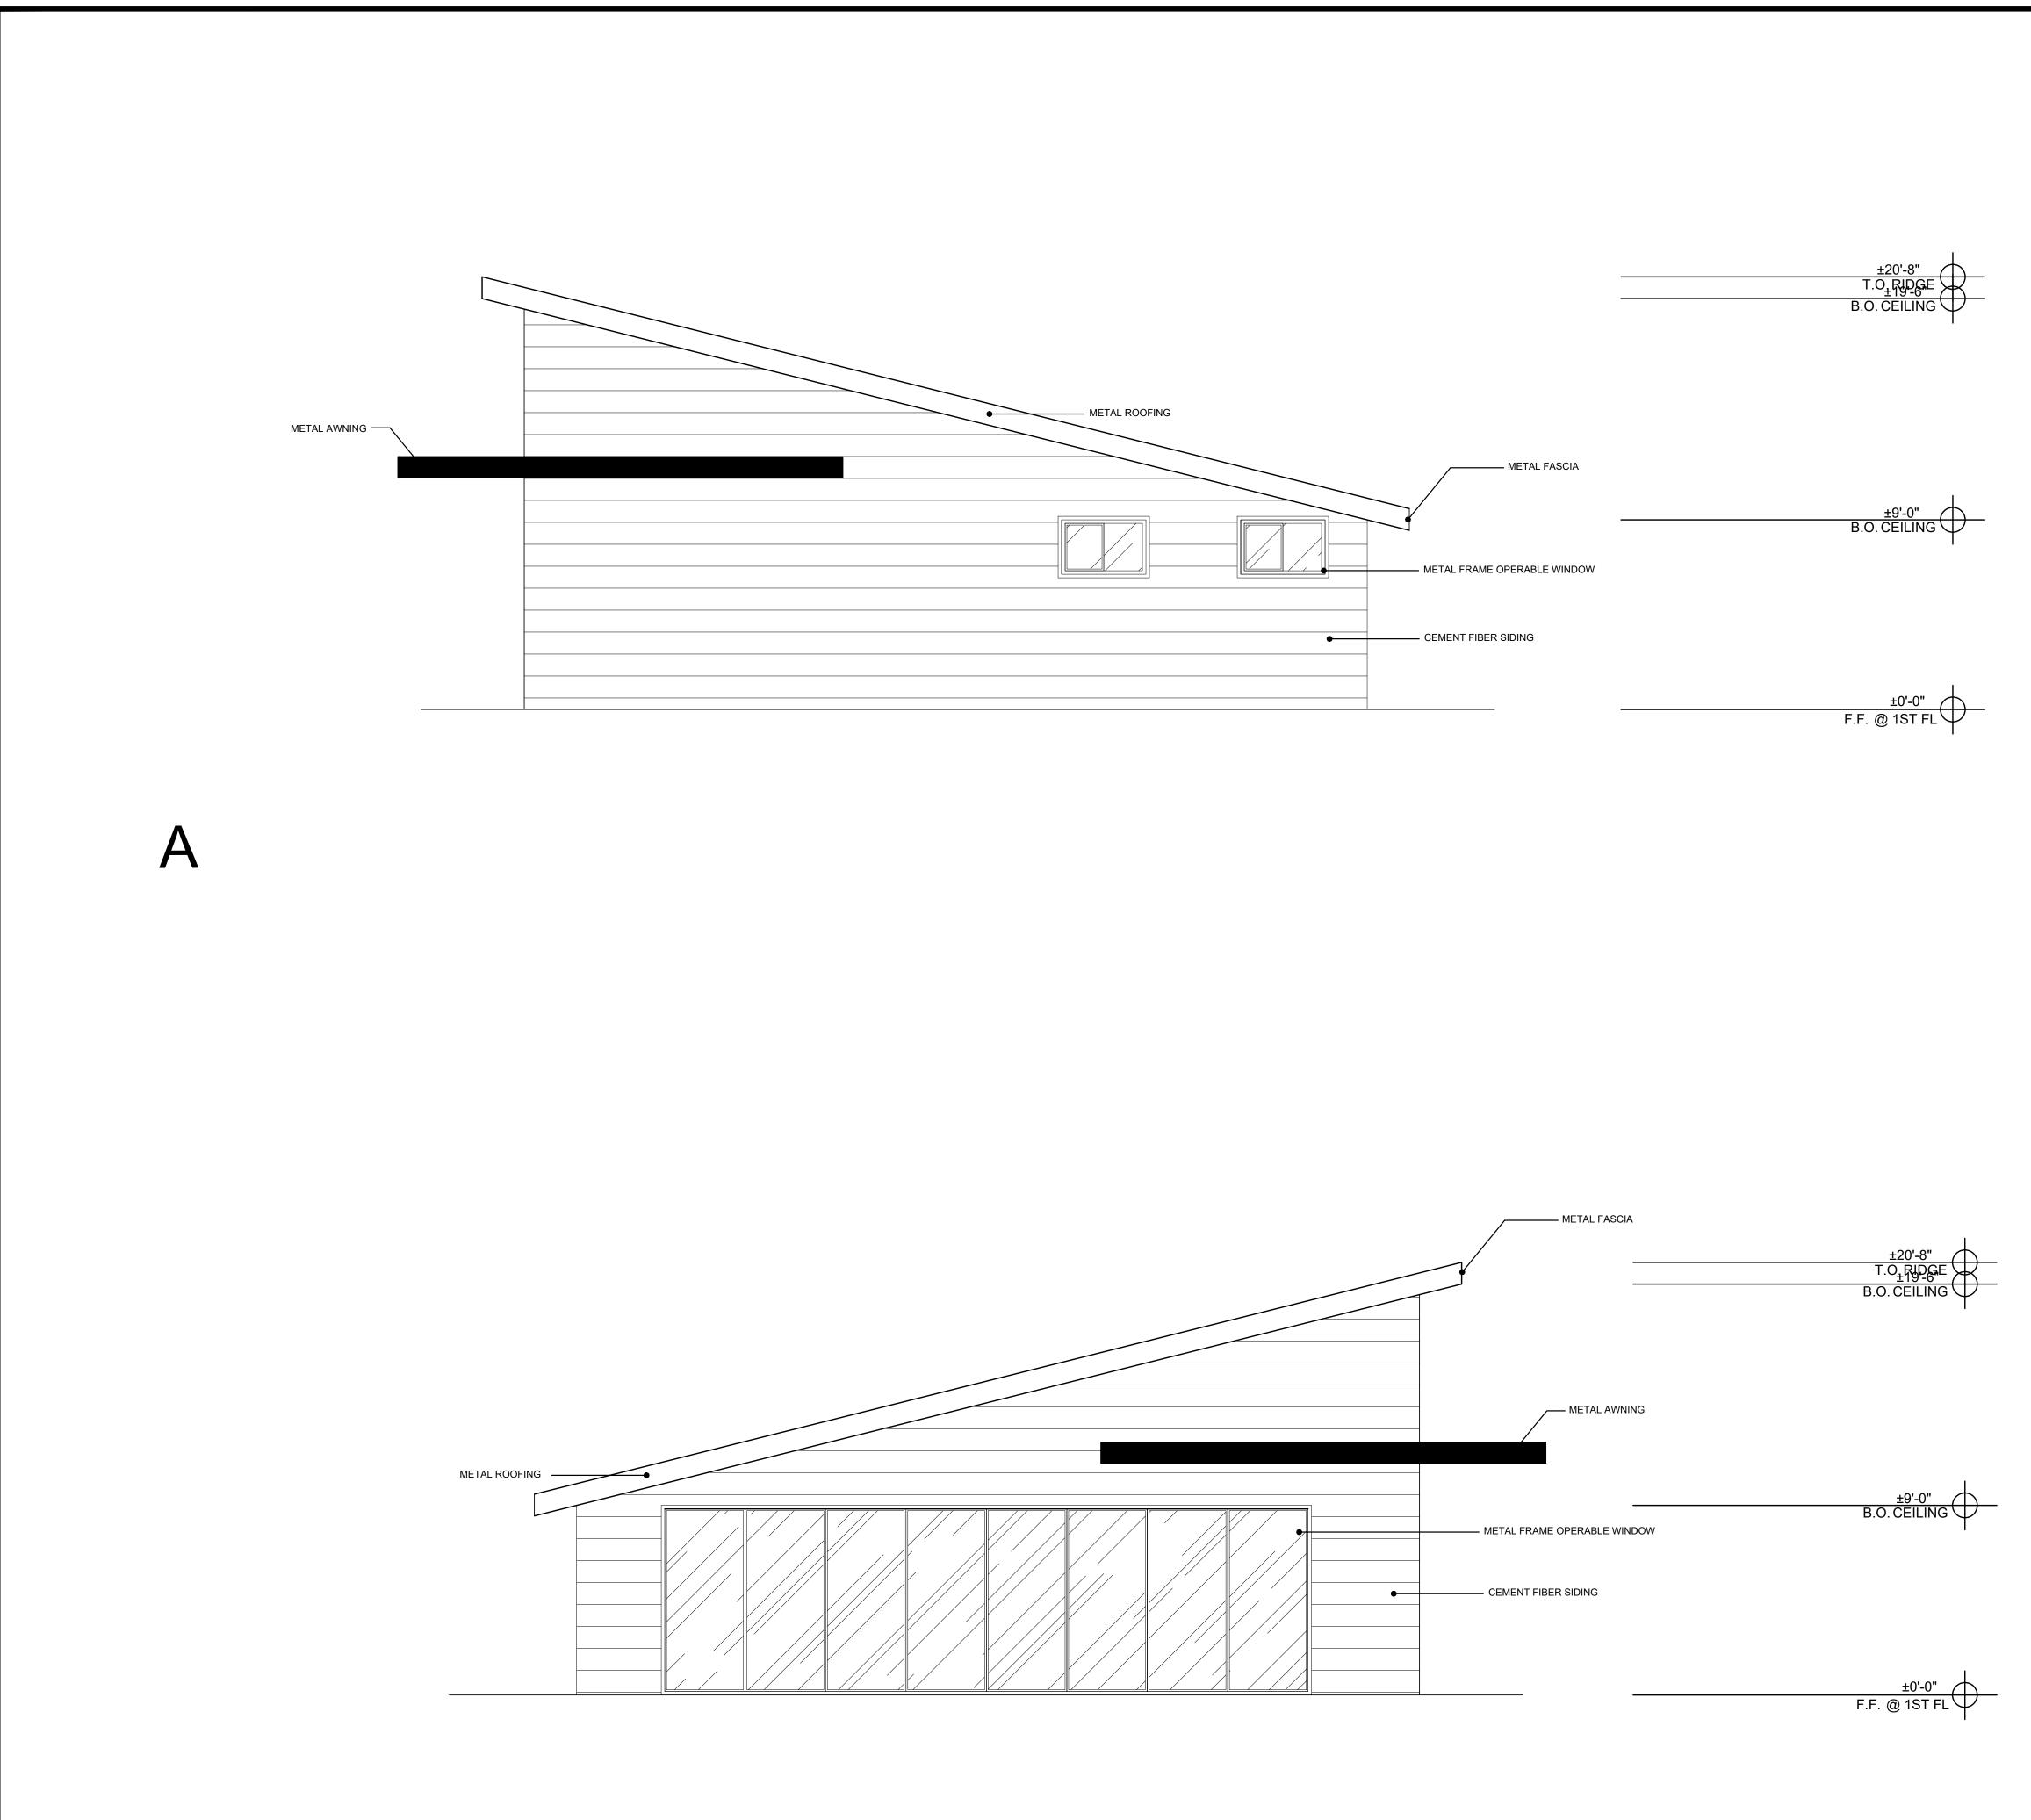

Β

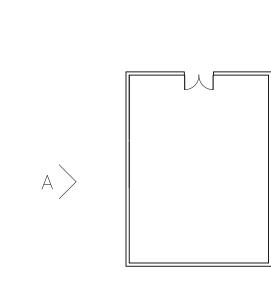

# КВ

## KEYPLAN

± 80 MARC CHAM-YIN FUNG C-32363 NOV 30 2021 RENEWAL DATE


V 80 Eureka Square, Suite 115, Pacifica, CA 94044 t.650.270.1754 e-mail: mfung@architstudioarchitecture.com

Print Record

#### NEW RESIDENTIAL BUILDING


21631 HICKS RD LDS GATDS, CA 95032 PROPERTY OWNER


ARCHITECT ARCHIT STUDIO 20 EUREKA SQUARE, SUITE 115 PACIFICA, CA 94044 ATTN: MARCO FUNG E: mfung@architstudioarchitecture.com T: 650.270.1754

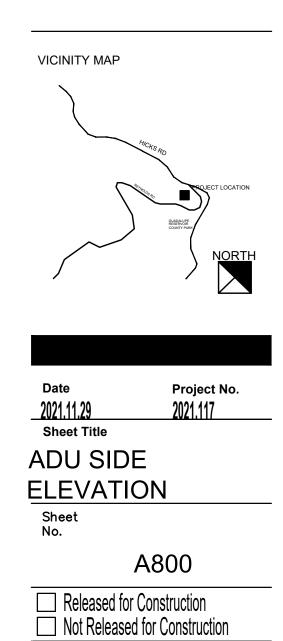

## **ADU SIDE ELEVATION**

SCALE: 1/4" = 1'-0" 0' 2' 4' 8'

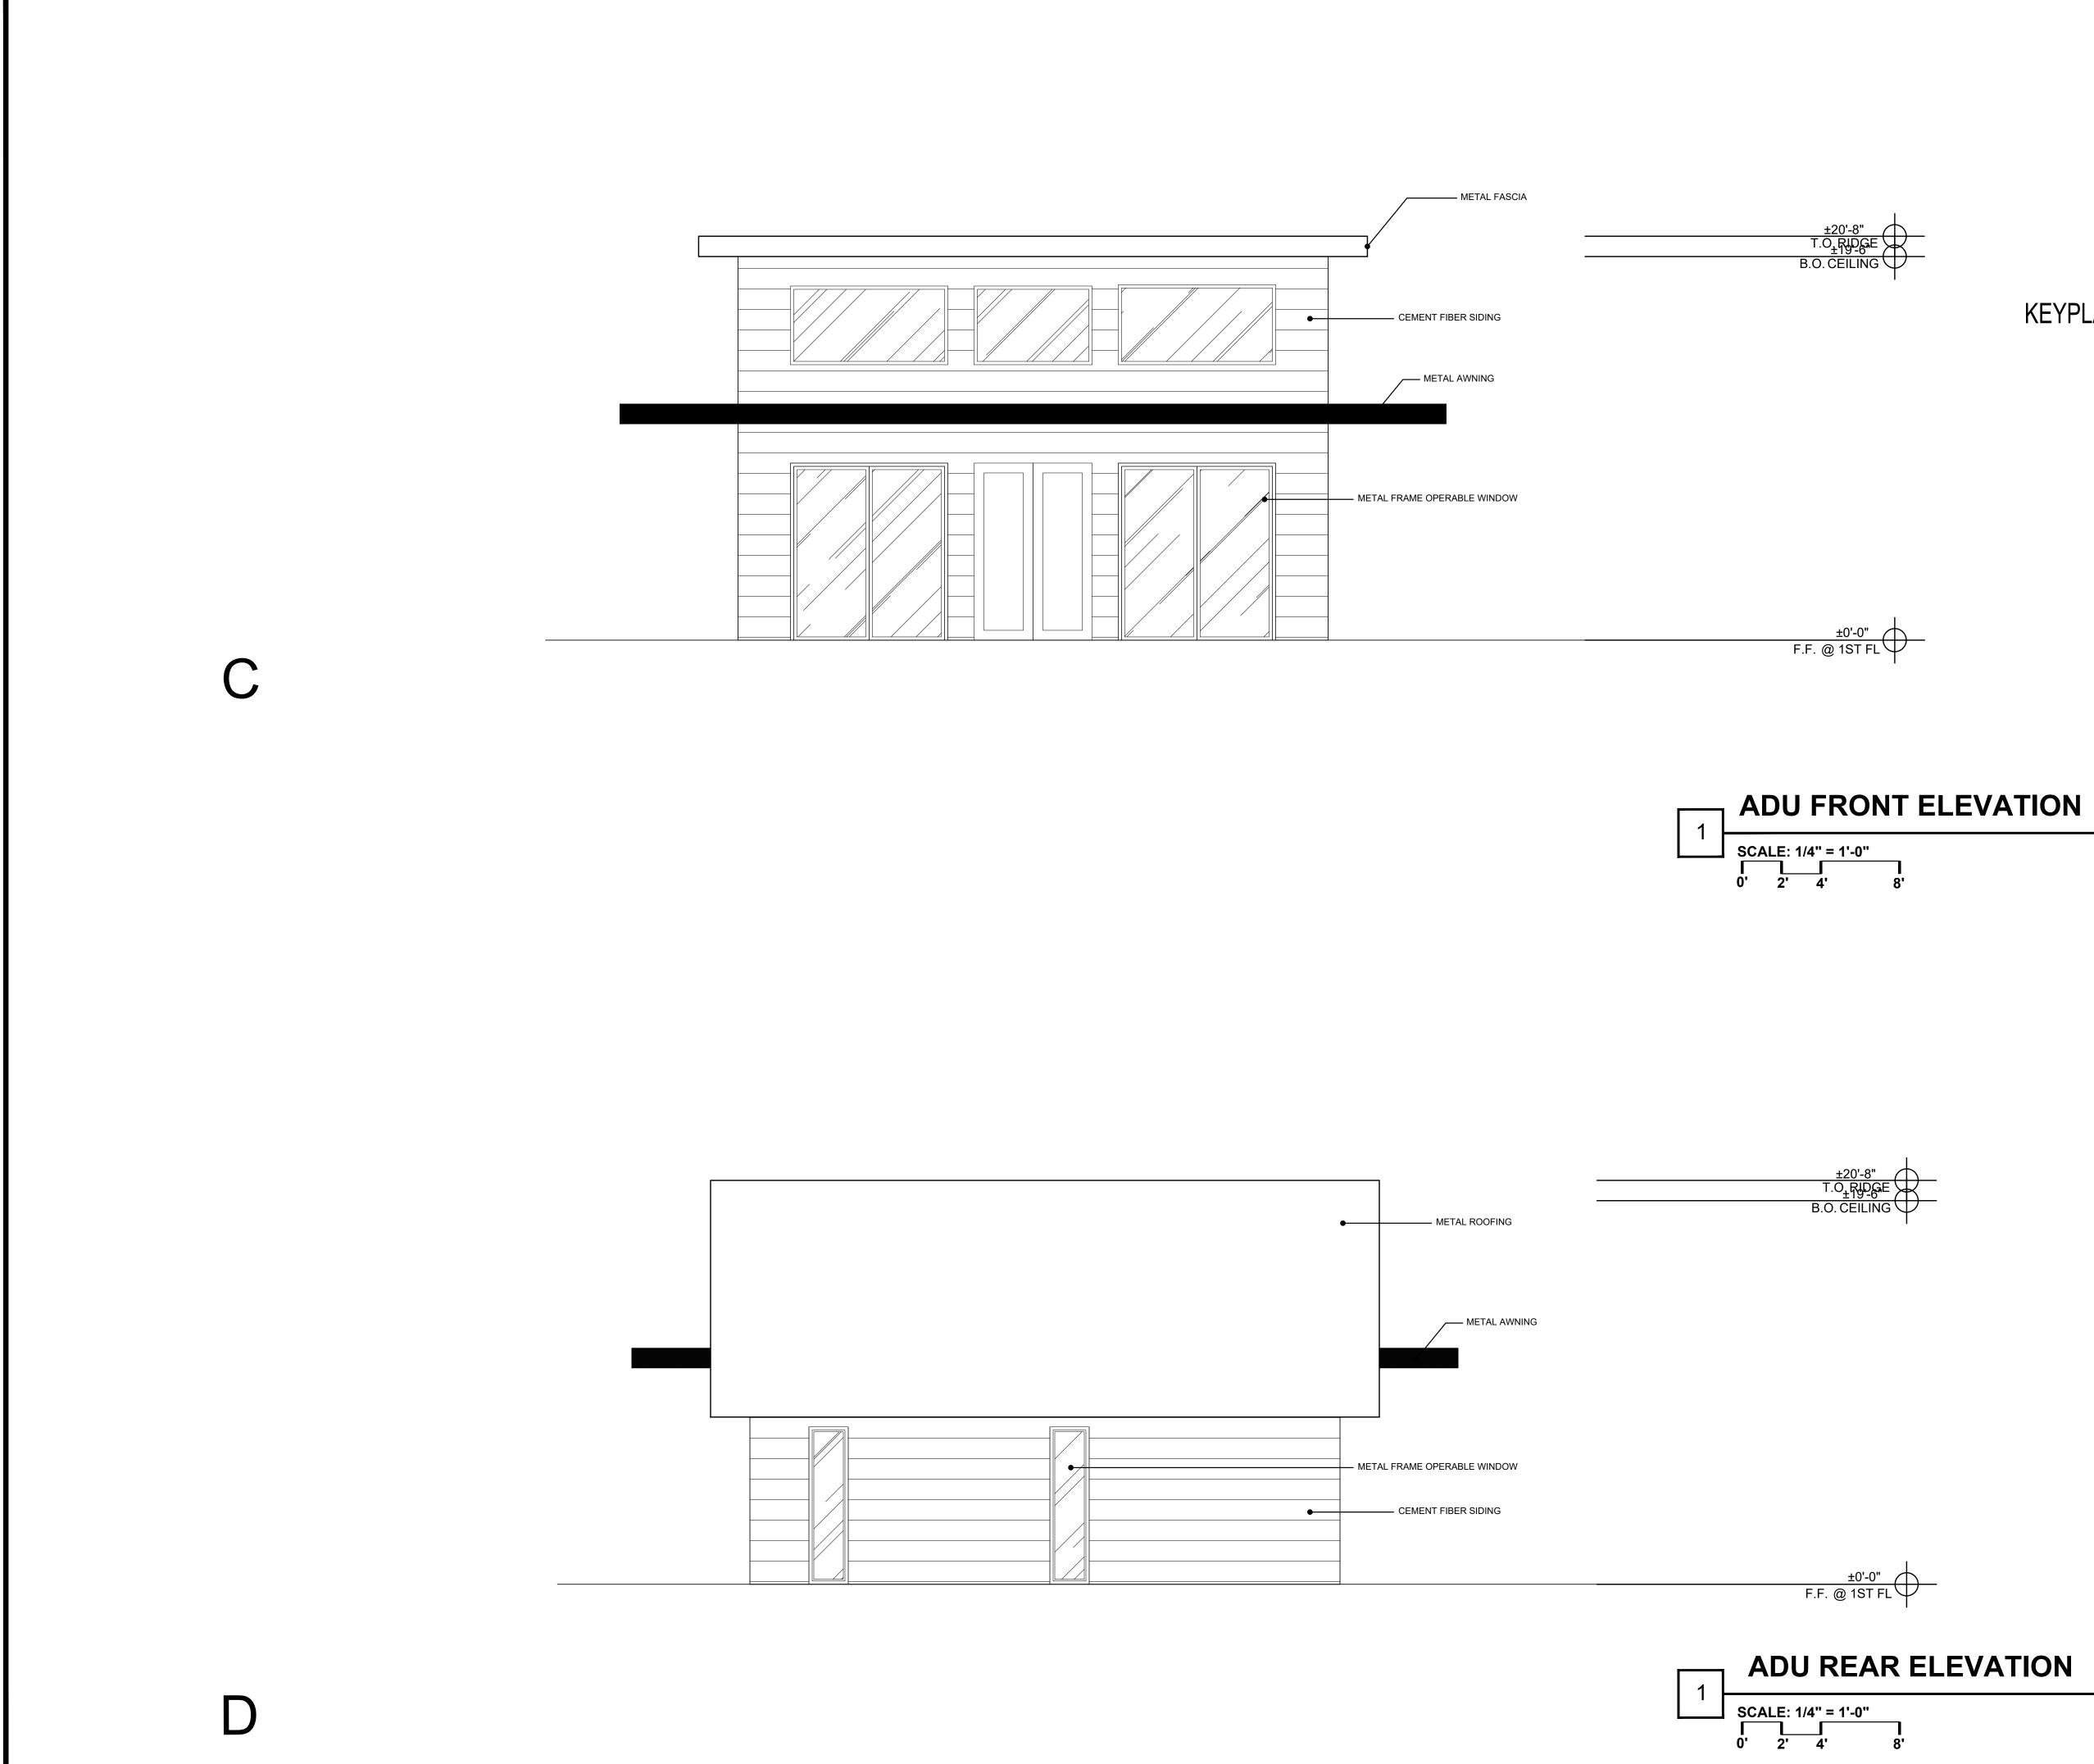

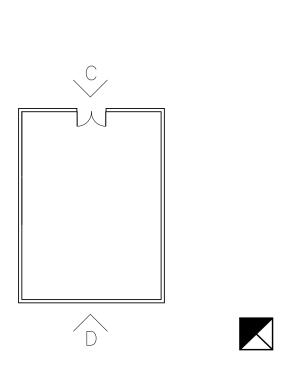

#### KEYPLAN

A R C H I T S T U D I ARCHITECTURE PLANNING INTERIOR B0 EUREKA SQUARE, SUITE 115, PACIFICA, CA 94044 T: 650.270.1754 E: mfung@architstudioarchitecture.com
T S PLANN PLANN Planchitst
30 E
MARCO CHAM-YIN FUNG C-32363 NOV 30 2021 RENEWAL DATE
80 Eureka Square, Suite 115, Pacifica, CA 94044 t.650.270.1754 e-mail: mfung@architstudioarchitecture.com
Print Record
NEW RESIDENTIAL
BUILDING 21631 HICKS RD LDS GATDS, CA 95032
PROPERTY OWNER
ARCHITECT ARCHIT STUDIO 20 EUREKA SQUARE, SUITE 115 PACIFICA, CA 94044 ATTN: MARCO FUNG E: mfung@architstudioarchitecture.com T: 650.270.1754
HICKSRD
Date Project No. 2021.11.29 2021.117
Sheet Title ADU FRONT
ELEVATION
No. A801
Released for Construction
Not Released for Construction

