

HOME BUILDERS

DESIGN BUILD REMODEL

3466 EDWARD AVENUE SANTA CLARA, CA 95054 PHONE: (408) 248-8000 FAX: (408) 625-7652 VALLEYHOMEBUILDERS.COM



MEYER RESIDENCE


15911 WEST ROAD LOS GATOS, CA 95030

	04/12/24	RESUBMITTAL
	01/09/23	RESUBMITTAL
	01/10/22	SPECIAL PERMIT APPLICATION
MARK	DATE	DESCRIPTION

PROJECT NO:	#PIn
DATE:	01/10/22
DRAWN BY: #CAD	
COPYRIGHT	Full Name


SHEET TITLE

PROJECT DATA PROPOSED SITE & ROOF PLAN

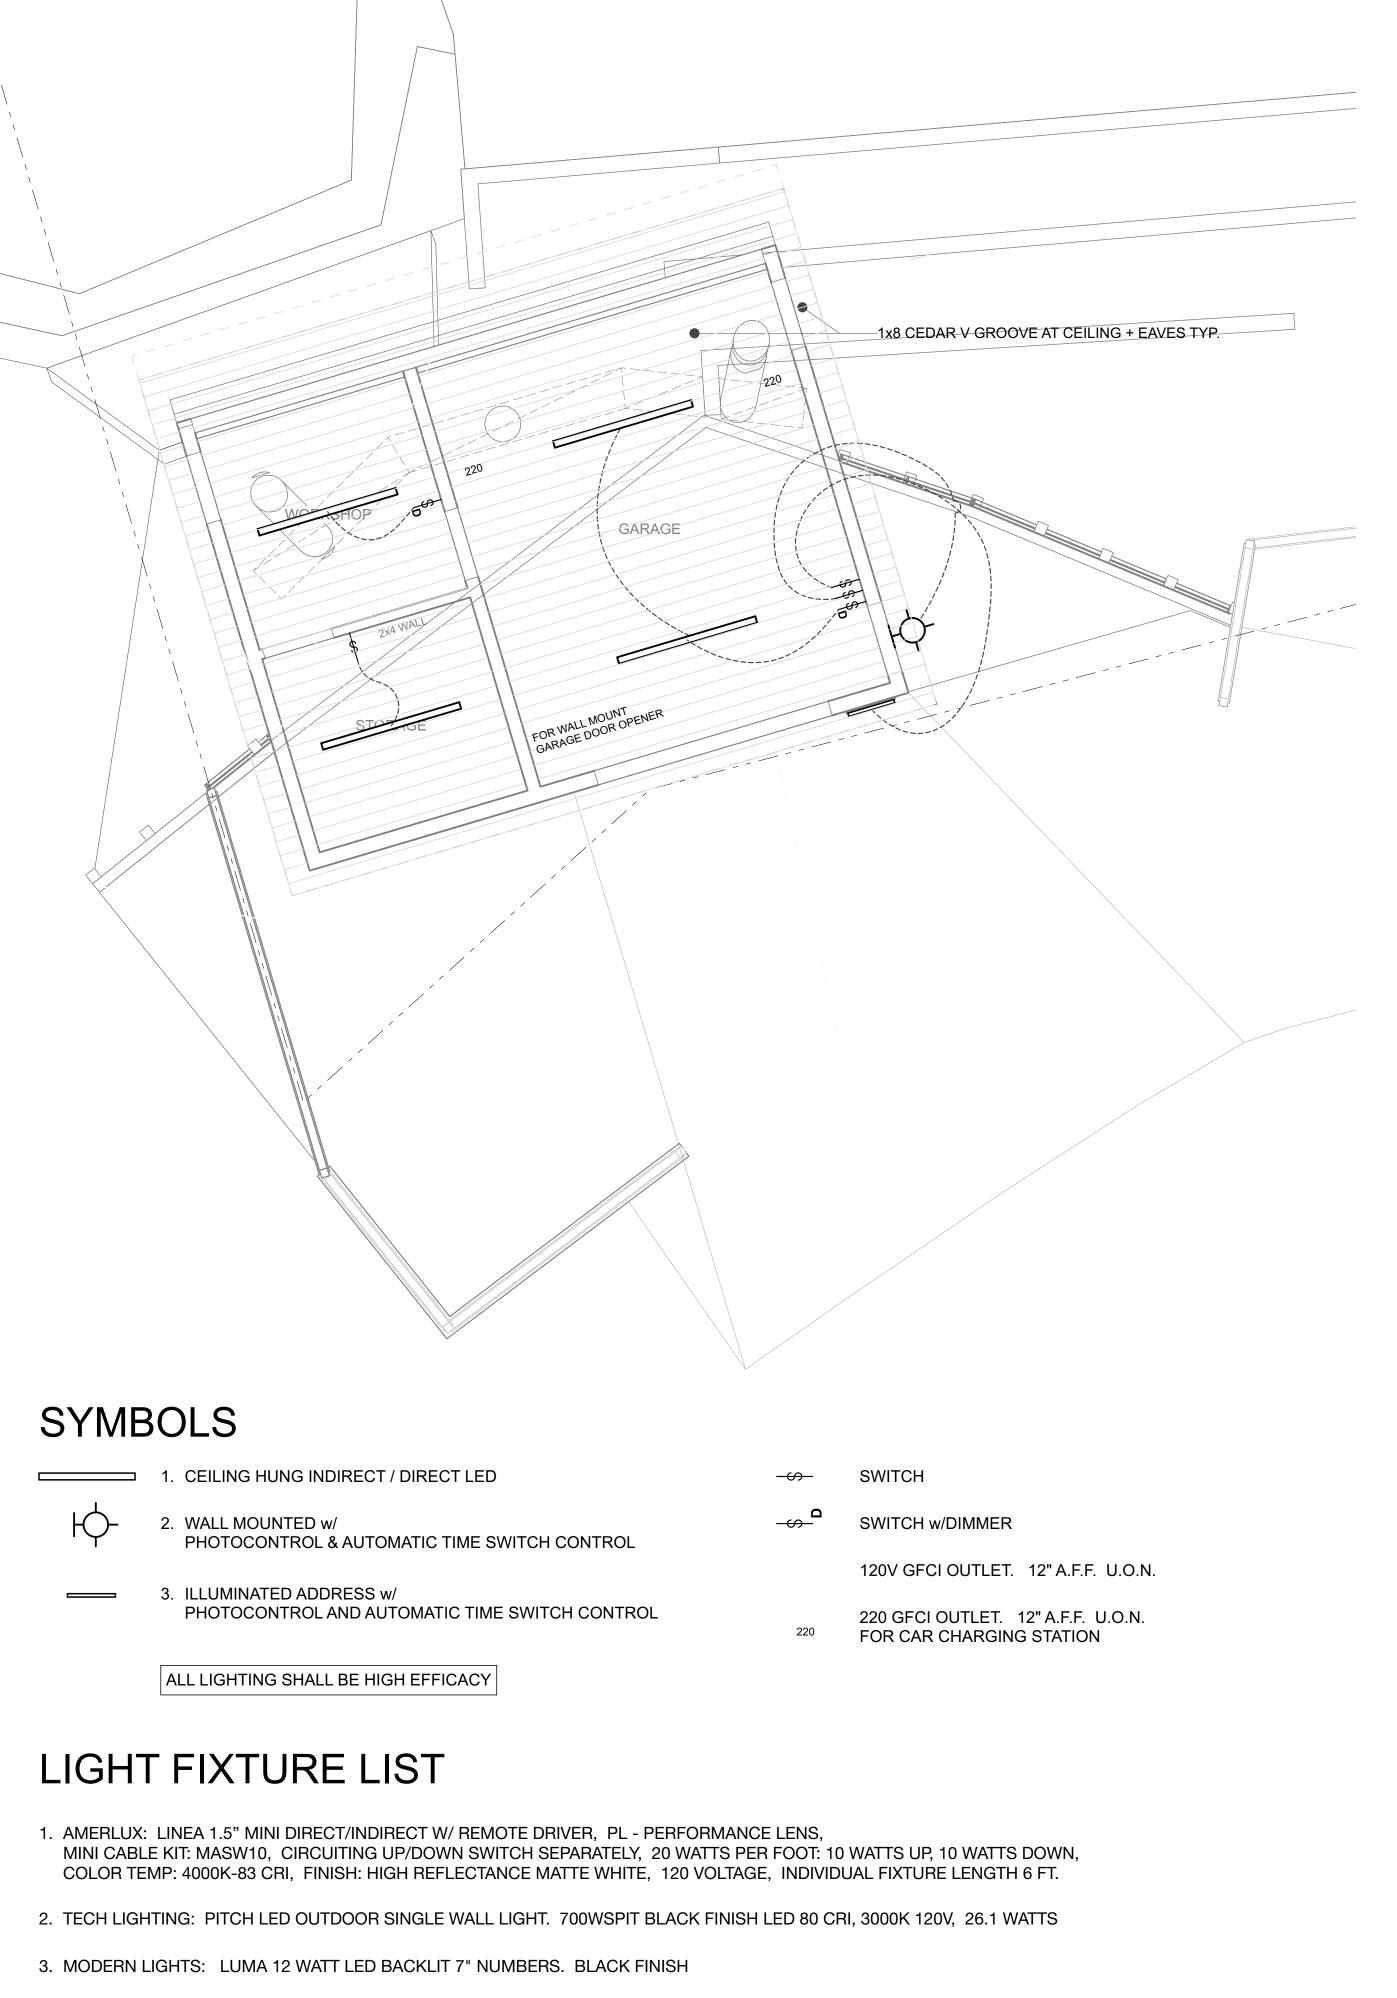

RCP w/ ELECTRICAL & LIGHTING LAYOUT

SCALE: 1/4" = 1'-0"

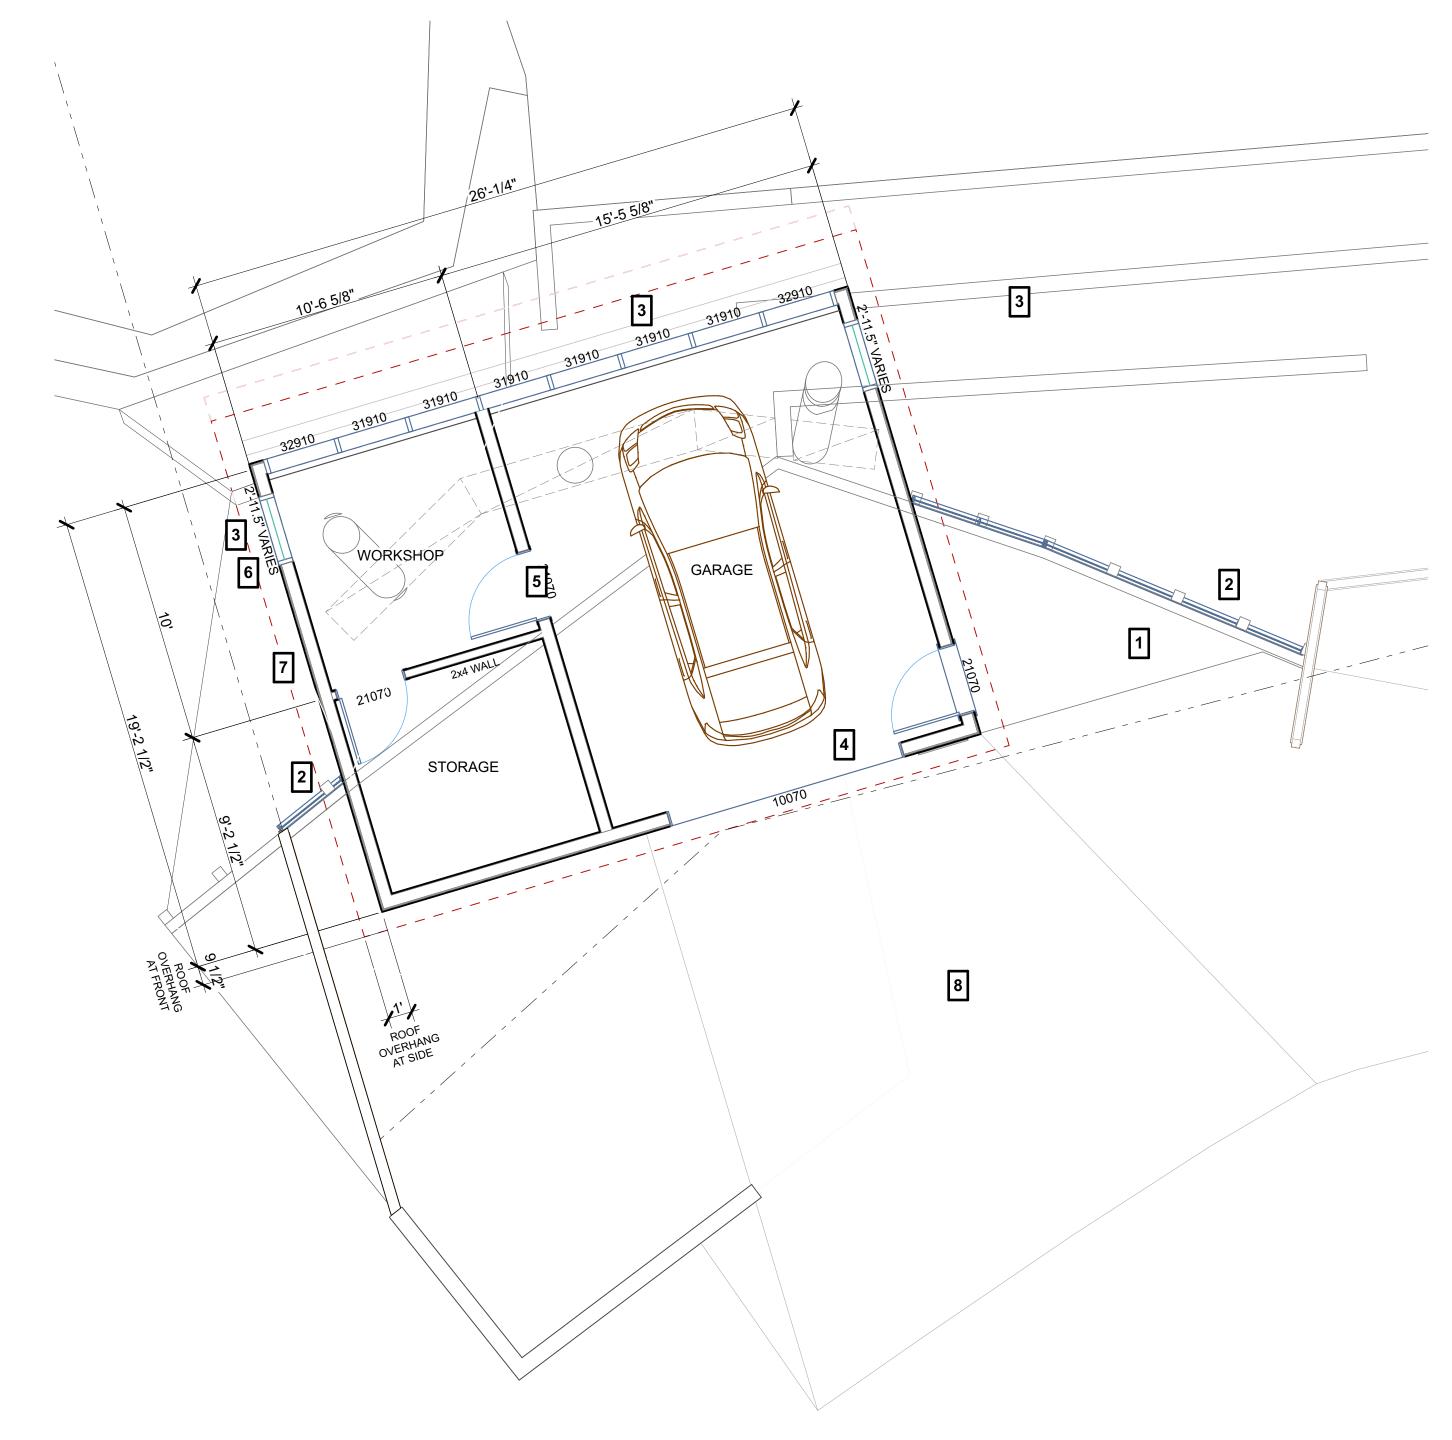

KEYED NOTES

- 1 LANDING: RISER MAXIMUM 7-3/4". RUN MINIMUM 36" 36" MIN WIDTH
- 1 SEE EXISTING PLAN / SHT A-2 FOR NOTES NOT SHOWN.

GENERAL NOTES

- - 2 GUARDRAIL: TOP OF GUARDRAIL +42" ABV FIN FL. 4" MAX SPACING BETWEEN HORIZONTAL BARS
 - ANODIZED ALUMINUM STOREFRONT WINDOW w/ TEMPERED GLAZING. SEE ELEVATION FOR OPERATION
 - OVERHEAD ANODIZED ALUMINUM GARAGE DOOR
 - 20 MINUTE FIRE RATED DOOR. SELF CLOSING AND SELF LATCHING
 - 45 MINUTE FIRE PROTECTION RATED WINDOW ASSEMBLY w/OH-45 FIRE RATED GLAZING MARKINGS THIS WINDOW.
 - 1-HR FIRE RATED THIS WALL
 - (N) DRIVEWAY APPROACH UNDER SEPARATE ENCROACHMENT PERMIT

LEGEND

(N) INTERIOR WALLS: 2X6 STUD WALLS AT 16" O.C. w/ 5/8" TYPE 'X' GYP BD EACH SIDE. U.O.N.

(N) EXTERIOR WALLS: 2X6 STUD WALLS AT 16" O.C. w/ JAMES HARDIE 1x8 ARTISAN SMOOTH FINISH FIBER CEMENT 5/8" LAP SIDING o/ W.P. MEMBRANE o/ 1/2" PLYWOOD. 5/8" TYPE 'X' GYP. BD. AT INTERIOR SIDE.

AT 1-HR WALL: PROVIDE 5/8" TYPE 'X' GYP BD UNDER W.P. MEMBRANE

SCALE: 1/4" = 1'-0"



COUNTY APPROVAL STAMP AREA



DESIGN BUILD REMODEL

3466 EDWARD AVENUE SANTA CLARA, CA 95054 PHONE: (408) 248-8000 FAX: (408) 625-7652 VALLEYHOMEBUILDERS.COM



MEYER RESIDENCE

NEW GARAGE

15911 WEST ROAD LOS GATOS, CA 95030


	04/12/24	RESUBMITTAL
	01/09/23	RESUBMITTAL
	01/10/22	SPECIAL PERMITAPPLICATION
MARK	DATE	DESCRIPTION

PROJECT NO: 01/10/22 DRAWN BY: #CAD Technician

SHEET TITLE

PROPOSED GARAGE PLAN RCP w/ ELEC & LTG LAYOUT

PROPOSED GARAGE PLAN

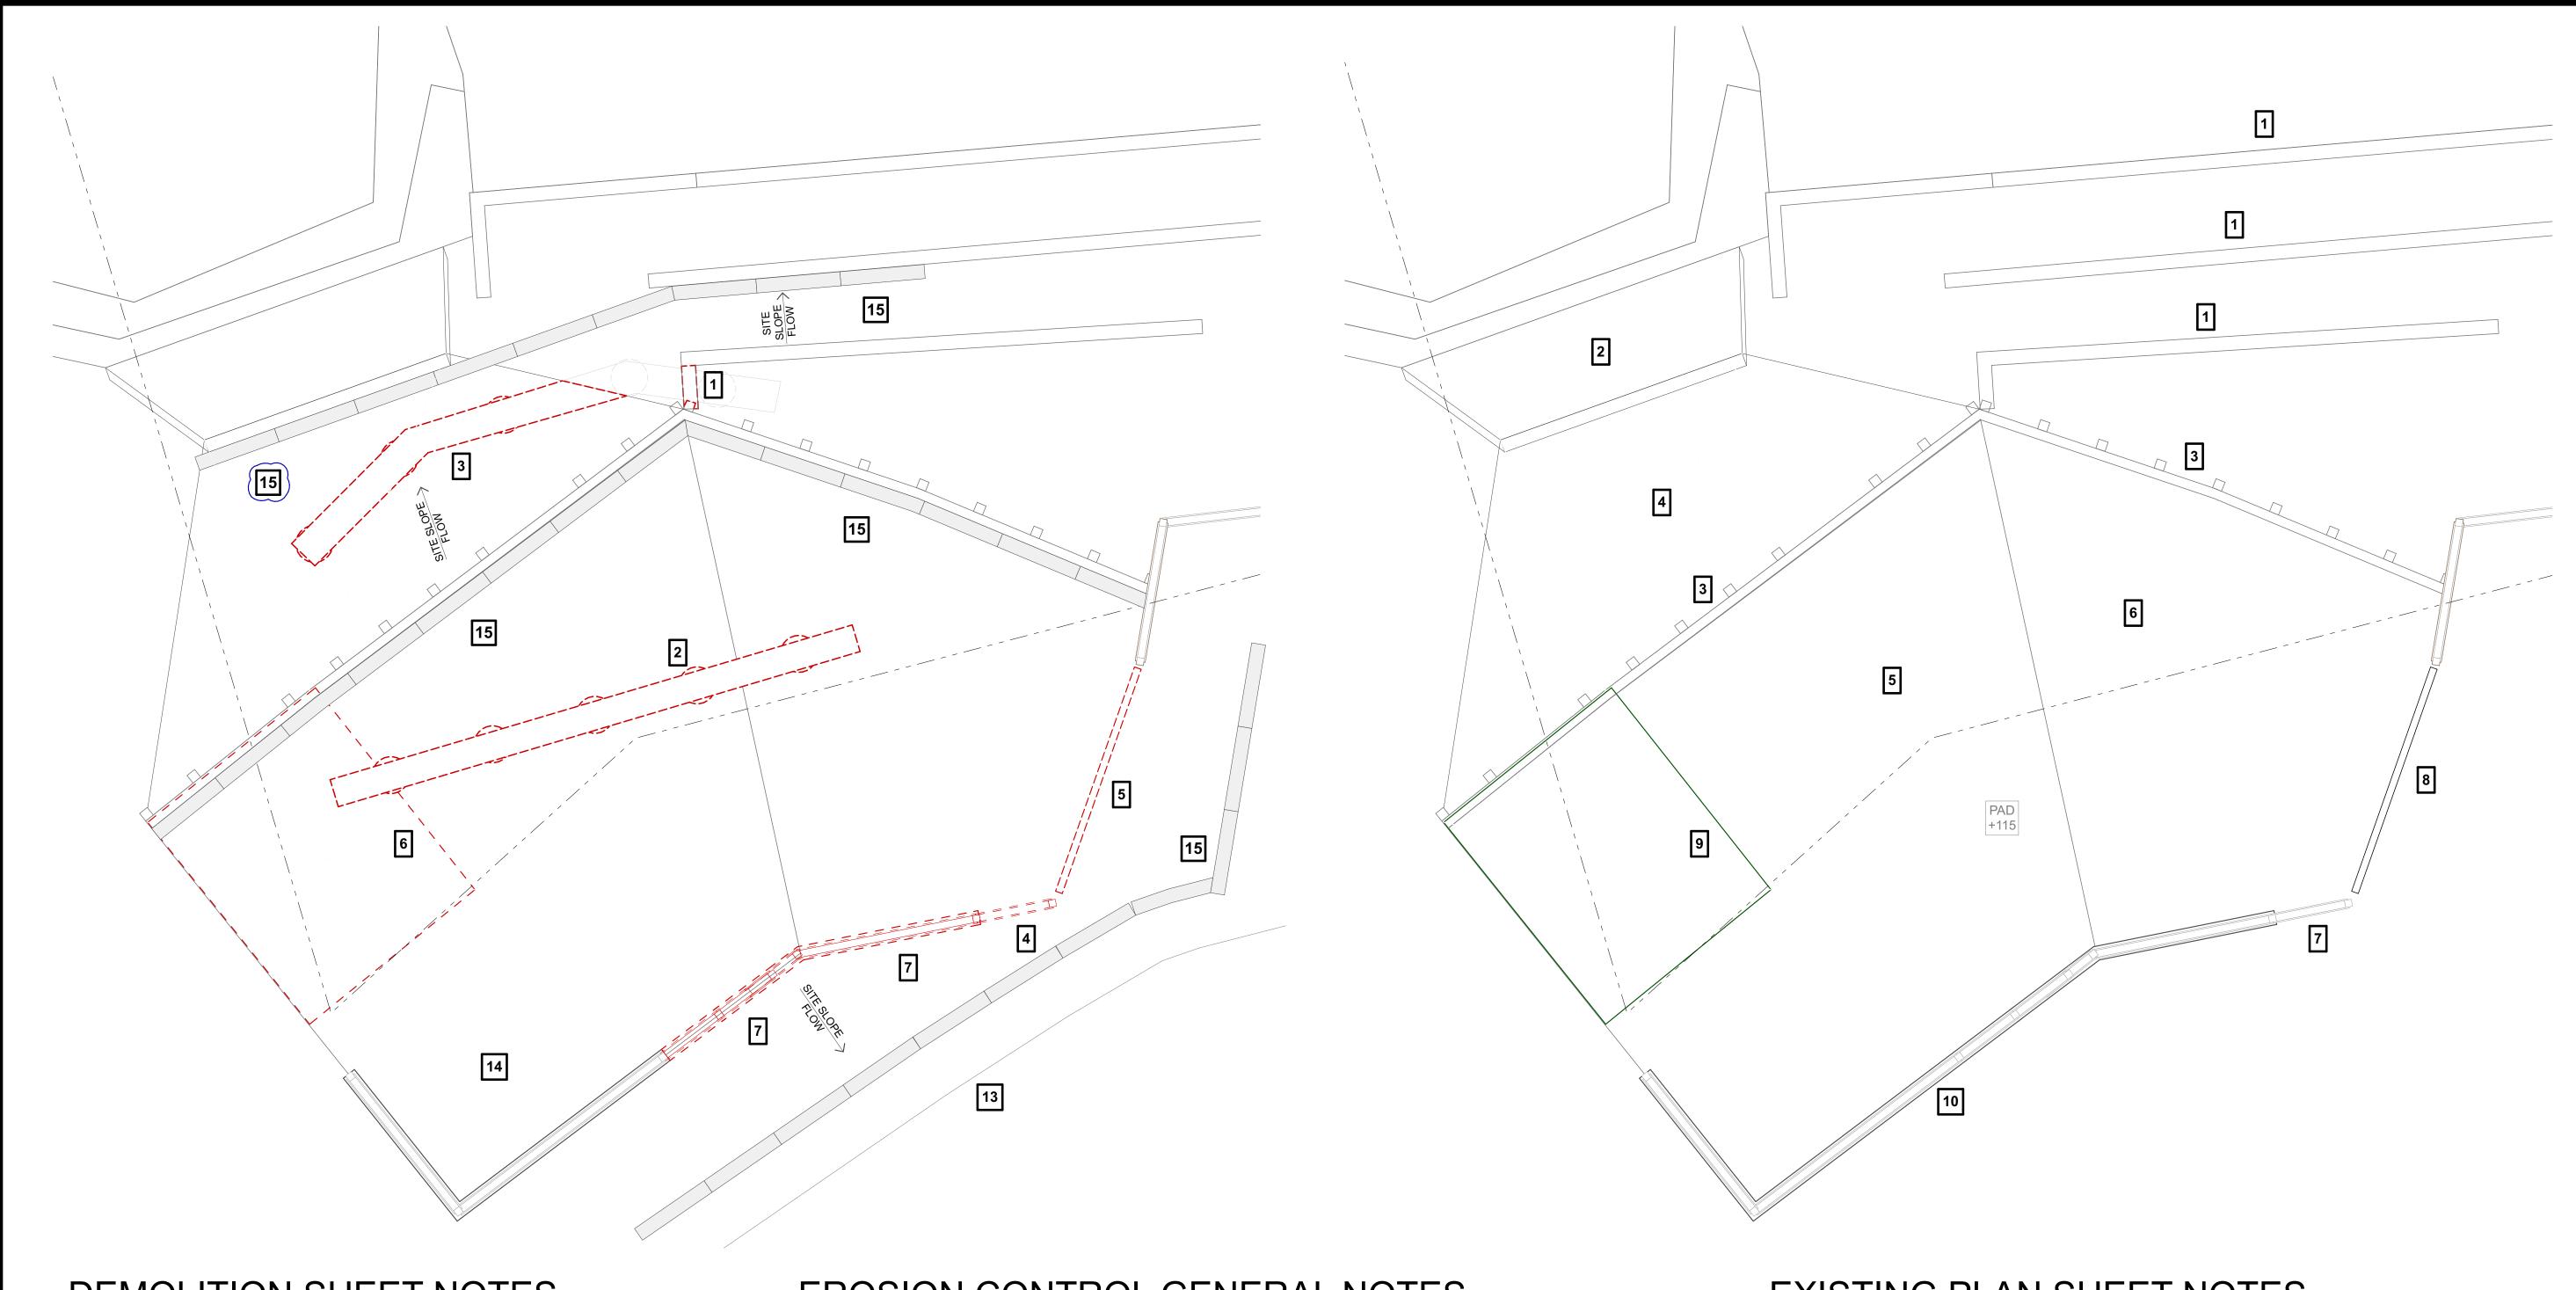

EXISTING PLAN SHEET NOTES

- 1 (E) CMU RETAINING WALL
- 2 (E) TIEBACK CMU WALL
- (E) TIEBACK P.T. WOOD WALL
- 4 (E) CONCRETE DRAINAGE APRON
- (E) CONCRETE PARKING PAD
- 6 (E) ASPHALT PARKING PAD
- (F) FENCE
- (E) AUTOGATE
- 9 (E) SHED
- (E) CMITWALL

COUNTY APPROVAL STAMP AREA

DEMOLITION SHEET NOTES

- REMOVE PORTION OF CMU RETAINING WALL SHOWN DASHED
- 2 SAWCUT & REMOVE PORTION OF PARKING PAD SHOWN DASHED
- 3 SAWCUT & REMOVE PORTION OF CONCRETE DRAINAGE APRON SHOWN DASHED
- 4 REMOVE FENCE SHOWN DASHED
- 5 REMOVE AUTOGATE
- REMOVE SHED
- 7 REMOVE PORTION OF CMU WALL SHOWN DASHED

LEGEND

ITEM TO REMOVE SHOWN RED & DASHED

EROSION CONTROL GENERAL NOTES

- ALL EROSION CONTROL MEASURES SHALL BE ONSITE AND READILY ACCESSIBLE PRIOR TO THE START OF CONSTRUCTION.
- 9 SWEEP OR SCRAPE UP SOILS TRACKED ONTO THE ROAD AT THE END OF EACH DAY. DO NOT HOSE INTO THE STREET, GUTTER, OR STORM DRAIN.
- REVEGETATE DISTURBED AREAS. EXPOSED BARE DIRT SHALL BE COVERED WITH MULCH, JUT NETTING OR OTHER EROSION CONTROL BLANKET.
- 11 REFER TO SHT. C-5 FOR ADDITIONAL INFORMATION.
- THE SITE SHALL BE MONITORED BY THE CONTRACTOR AFTER RAIN EVENT TO VERIFY EROSION CONTROL MEASURES ARE FUNCTIONING.

EROSION CONTROL SHEET NOTES

- 13 EDGE OF PAVEMENT.
- 14 MATERIAL STORAGE.
- LOCATION OF STRAW ROLLS TO CONTROL EROSION. REF DET 1 / C-4.2.

DEMOLITION & EROSION CONTROL PLAN

SCALE: 1/4" = 1'-0"

EXISTING PLAN

SCALE: 1/4" = 1'-0"



DESIGN BUILD REMODEL

3466 EDWARD AVENUE SANTA CLARA, CA 95054 PHONE: (408) 248-8000 FAX: (408) 625-7652 VALLEYHOMEBUILDERS.COM



MEYER RESIDENCE

NEW GARAGE

15911 WEST ROAD LOS GATOS, CA 95030

	04/12/24	RESUBMITTAL
	01/09/23	RESUBMITTAL
	01/10/22	SPECIAL PERMI APPLICATION
MARK	DATE	DESCRIPTION

PROJECT NO: #PIn

DATE: 01/10/22


DRAWN BY: #CAD Technician

COPYRIGHT Full Name

SHEET TITLE

EXISTING PLAN
DEMOLITION &
EROSION
CONTROL PLAN

A-2

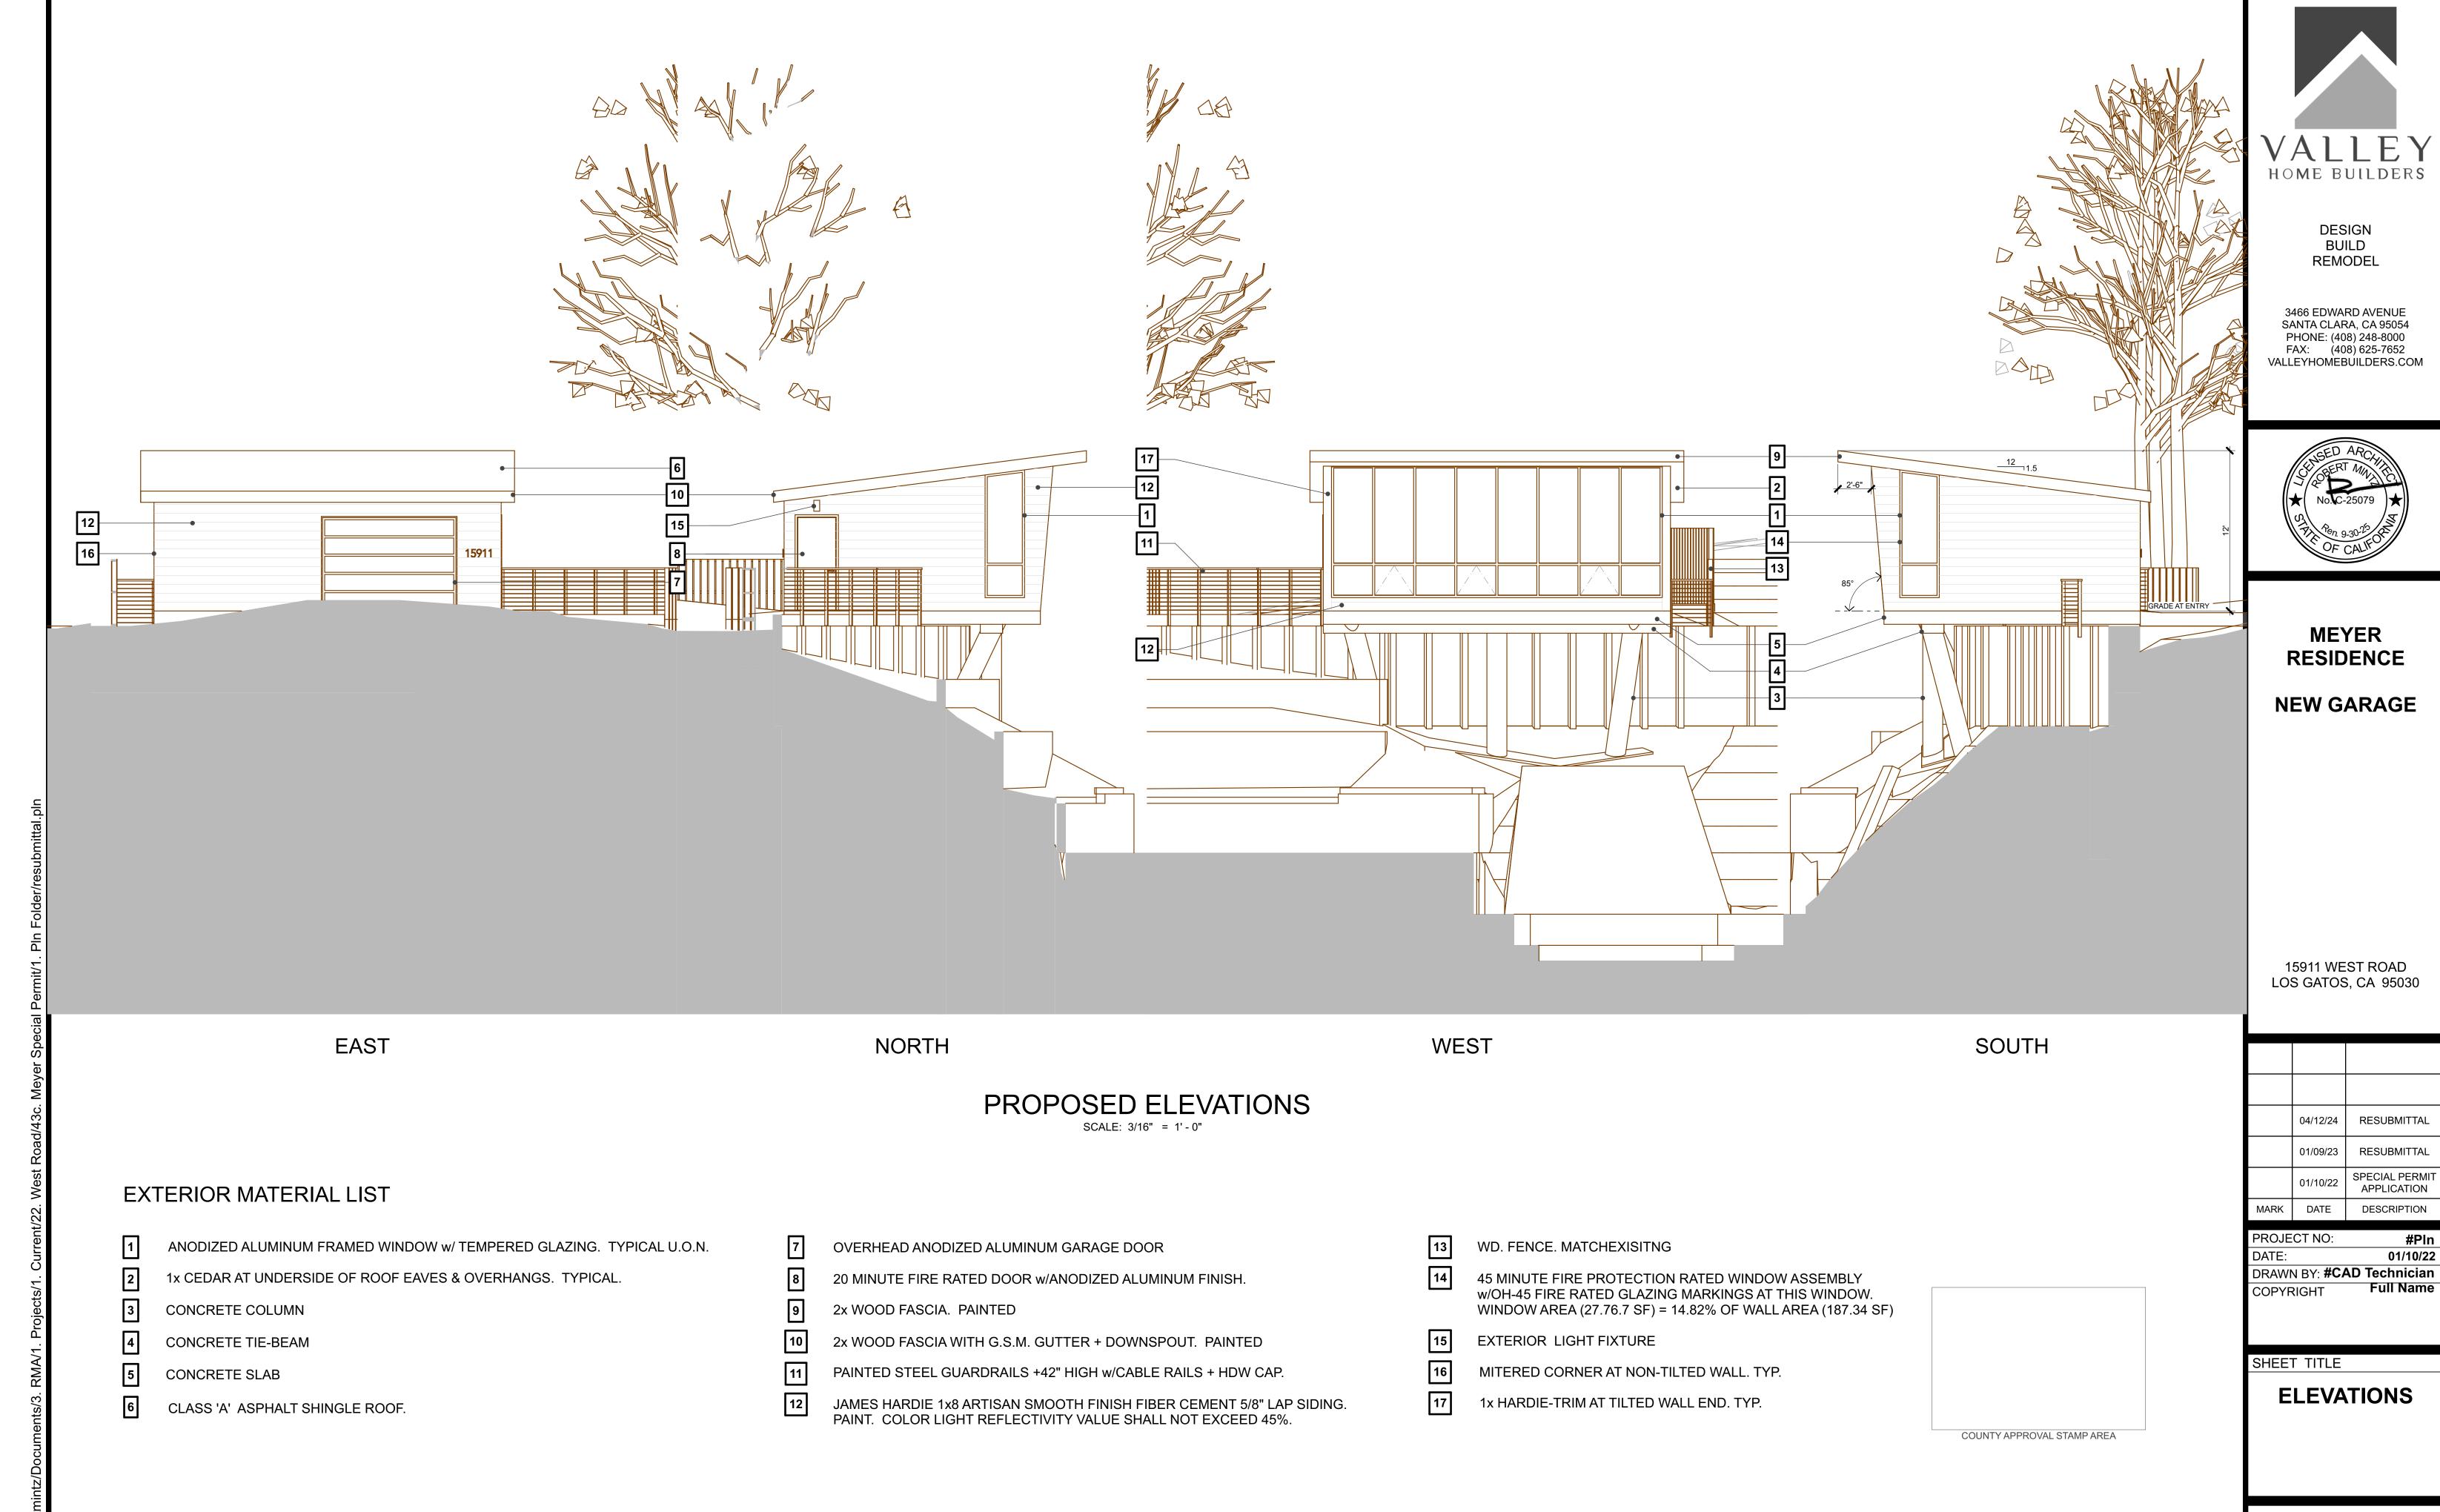

A-3

SHEET NOTES

- 1 (E) CMU RETAINING WALL
- 2 (E) TIEBACK CMU WALL
- (E) TIEBACK P.T. WOOD WALL
- (E) CONCRETE DRAINAGE APRON
- TRENCH DOWN ALONG GRADE BEAM PATH TO LOCATE TIE-BACK LOCATIONS BEFORE DRILLING ADJUST LOCATION OF PIERS TO AVOID CONTACTING (E) TIEBACKS DRILLING OPERATIONS TO BE OBSERVED & APPROVED BY GEOTECHNICAL ENGINEER.
- CLASS 'A' MODIFIED BITUMEN ROOFING o/1/2" PLYWD. TYP..
- PROVIDE ONE LAYER OF 72LB MINERAL SURFACED NON PERFORATED CAP SHEET COMPLYING WITH ASTM D3909 INSTALLED OVER THE COMBUSTIBLE DECKING FOR MINIMUM OF 36" FROM EAVES.
- AIR-IMPERMEABLE INSULATION AT RAFTER CAVITIES
- 1x8 CEDAR V-GROOVE AT CEILING EAVES.
- UP/ DOWN LED STRIP

- 2x STUD WALL. SEE PLAN FOR ASSEMBLY
- ANODIZED ALUMINUM STOREFRONT WINDOW w/ TEMPERED GLAZING
- (N) DRIVEWAY APPROACH BEYOND UNDER SEPARATE ENCROACHMENT PERMIT ENC20-0959

HOME BUILDERS DESIGN BUILD REMODEL

3466 EDWARD AVENUE SANTA CLARA, CA 95054 PHONE: (408) 248-8000 FAX: (408) 625-7652 VALLEYHOMEBUILDERS.COM



MEYER RESIDENCE

NEW GARAGE

15911 WEST ROAD LOS GATOS, CA 95030

	04/12/24	RESUBMITTA
	01/09/23	RESUBMITTA
	01/10/22	SPECIAL PERI APPLICATIO
MARK	DATE	DESCRIPTIO


PROJECT NO:	#PIn
DATE:	01/10/22
DRAWN BY: #CAD	
COPYRIGHT	Full Name

SHEET TITLE


COUNTY APPROVAL STAMP AREA


SECTION



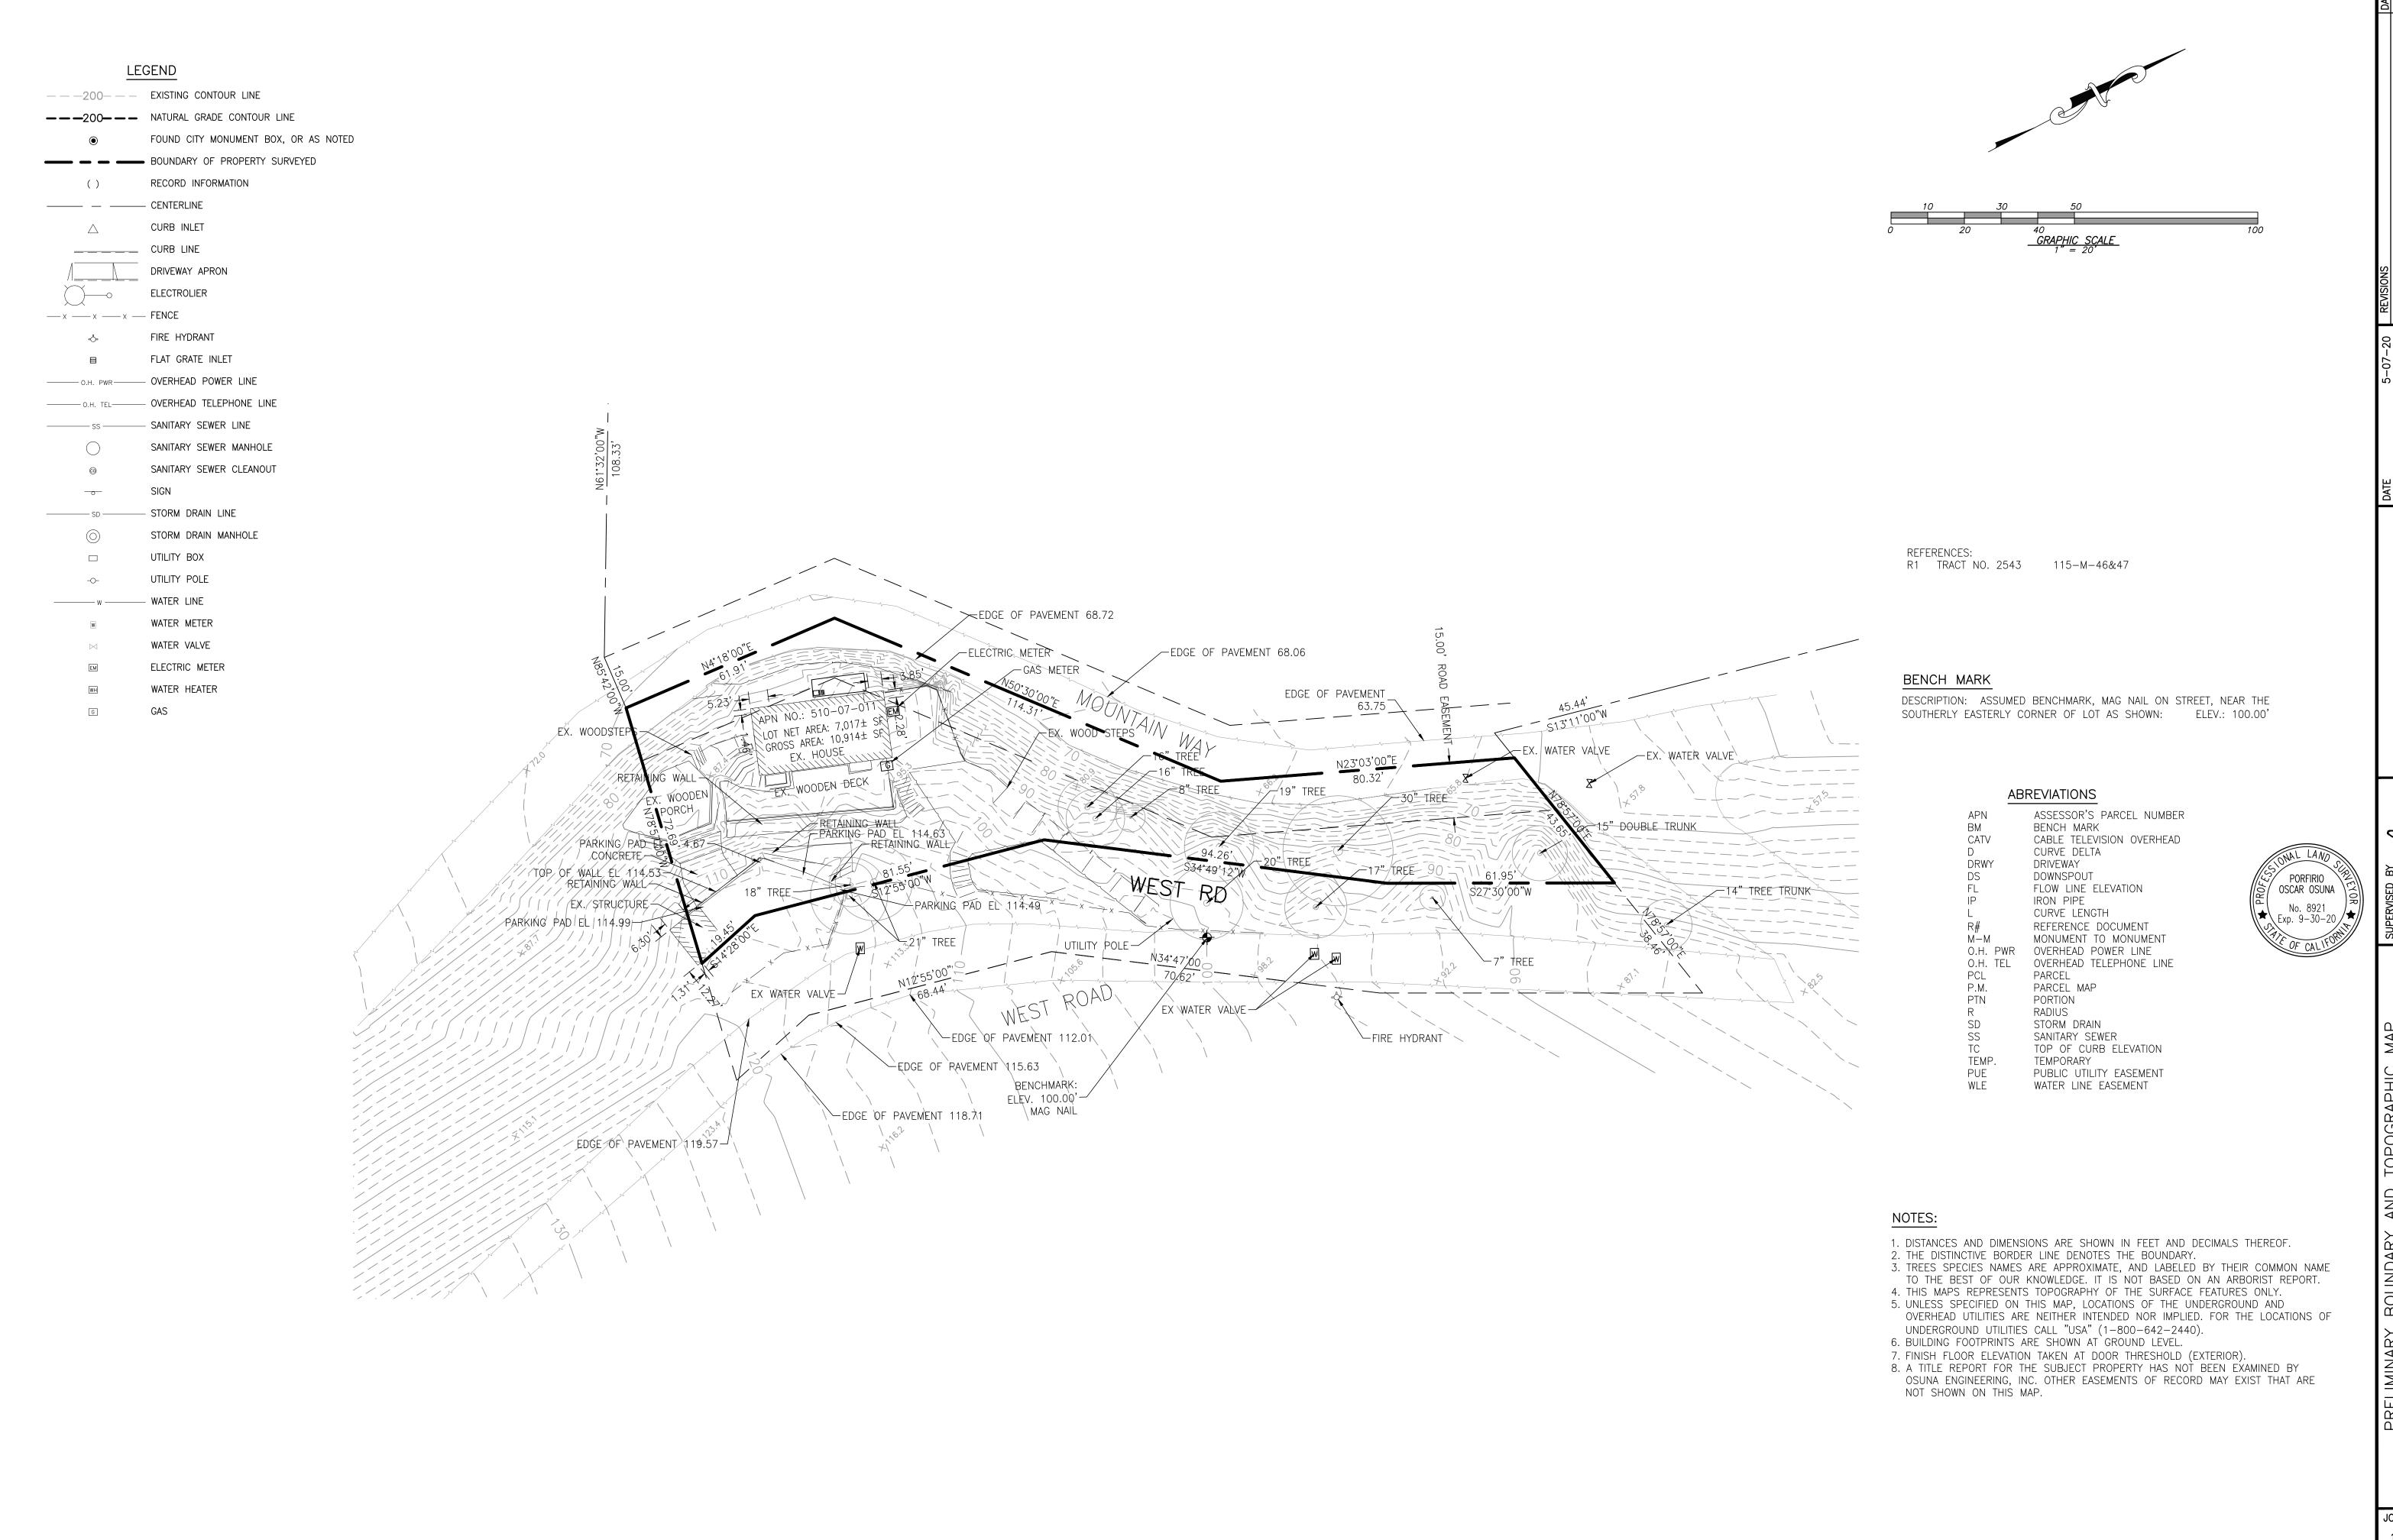

SHEET

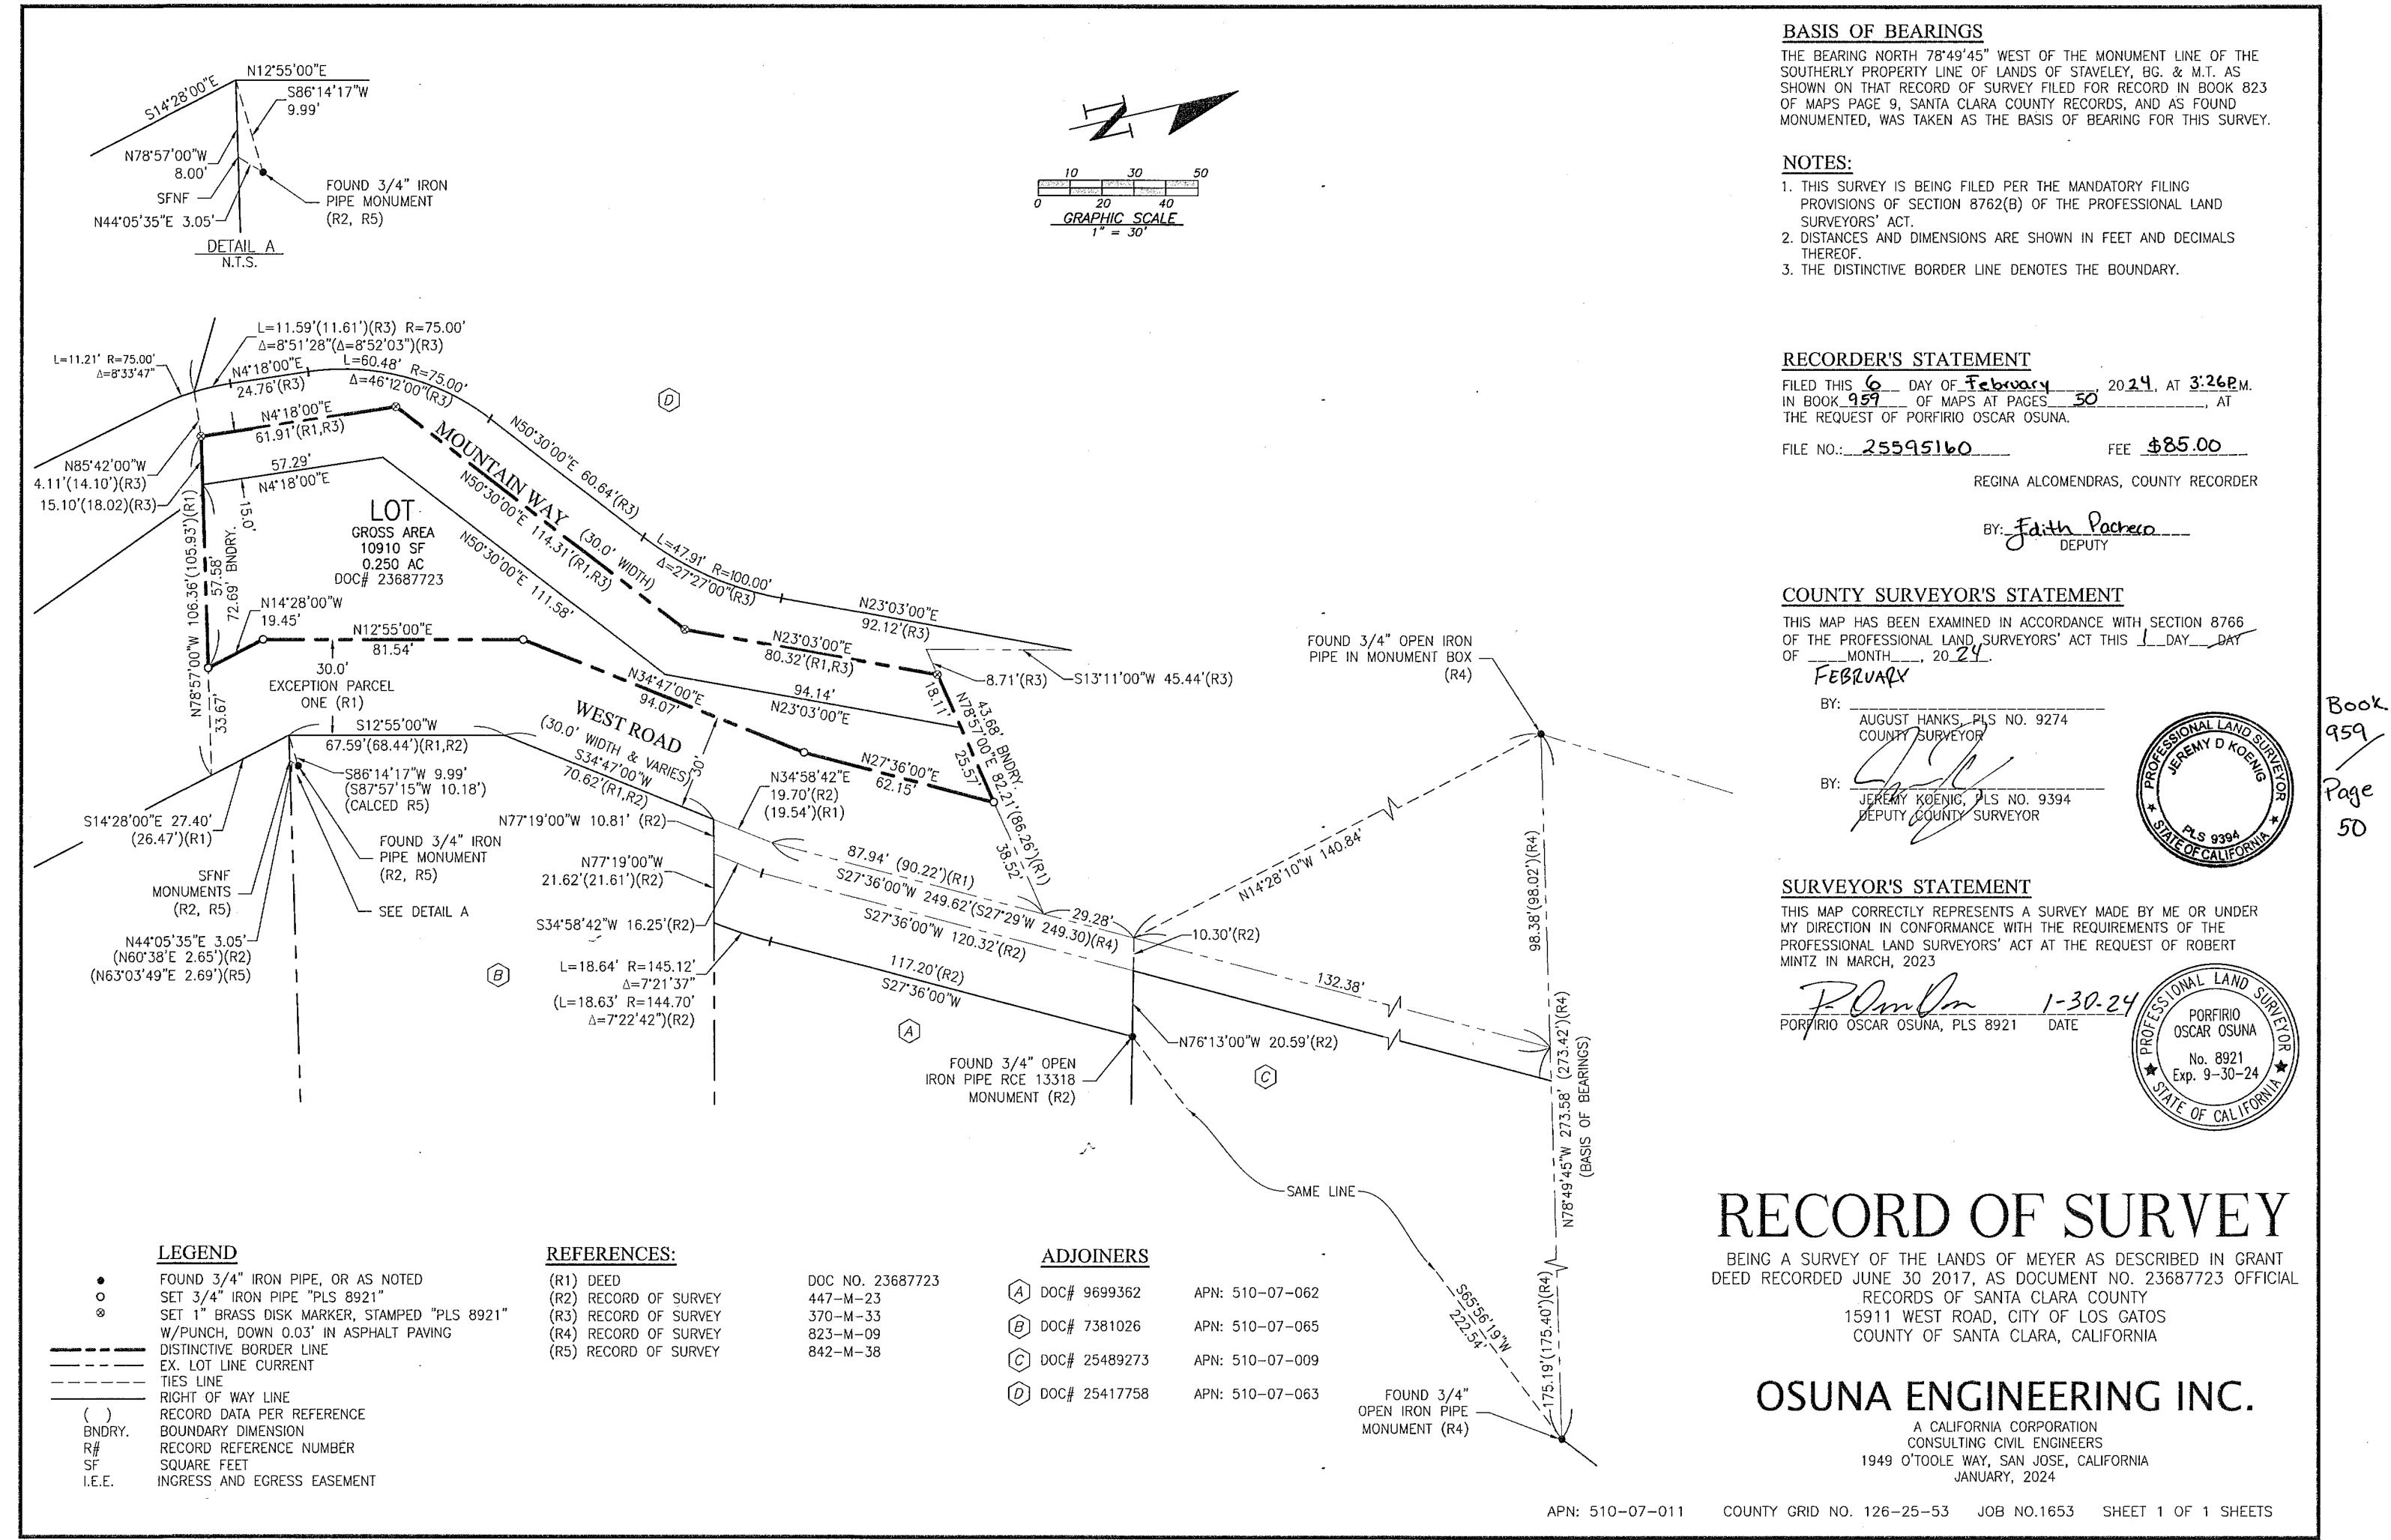


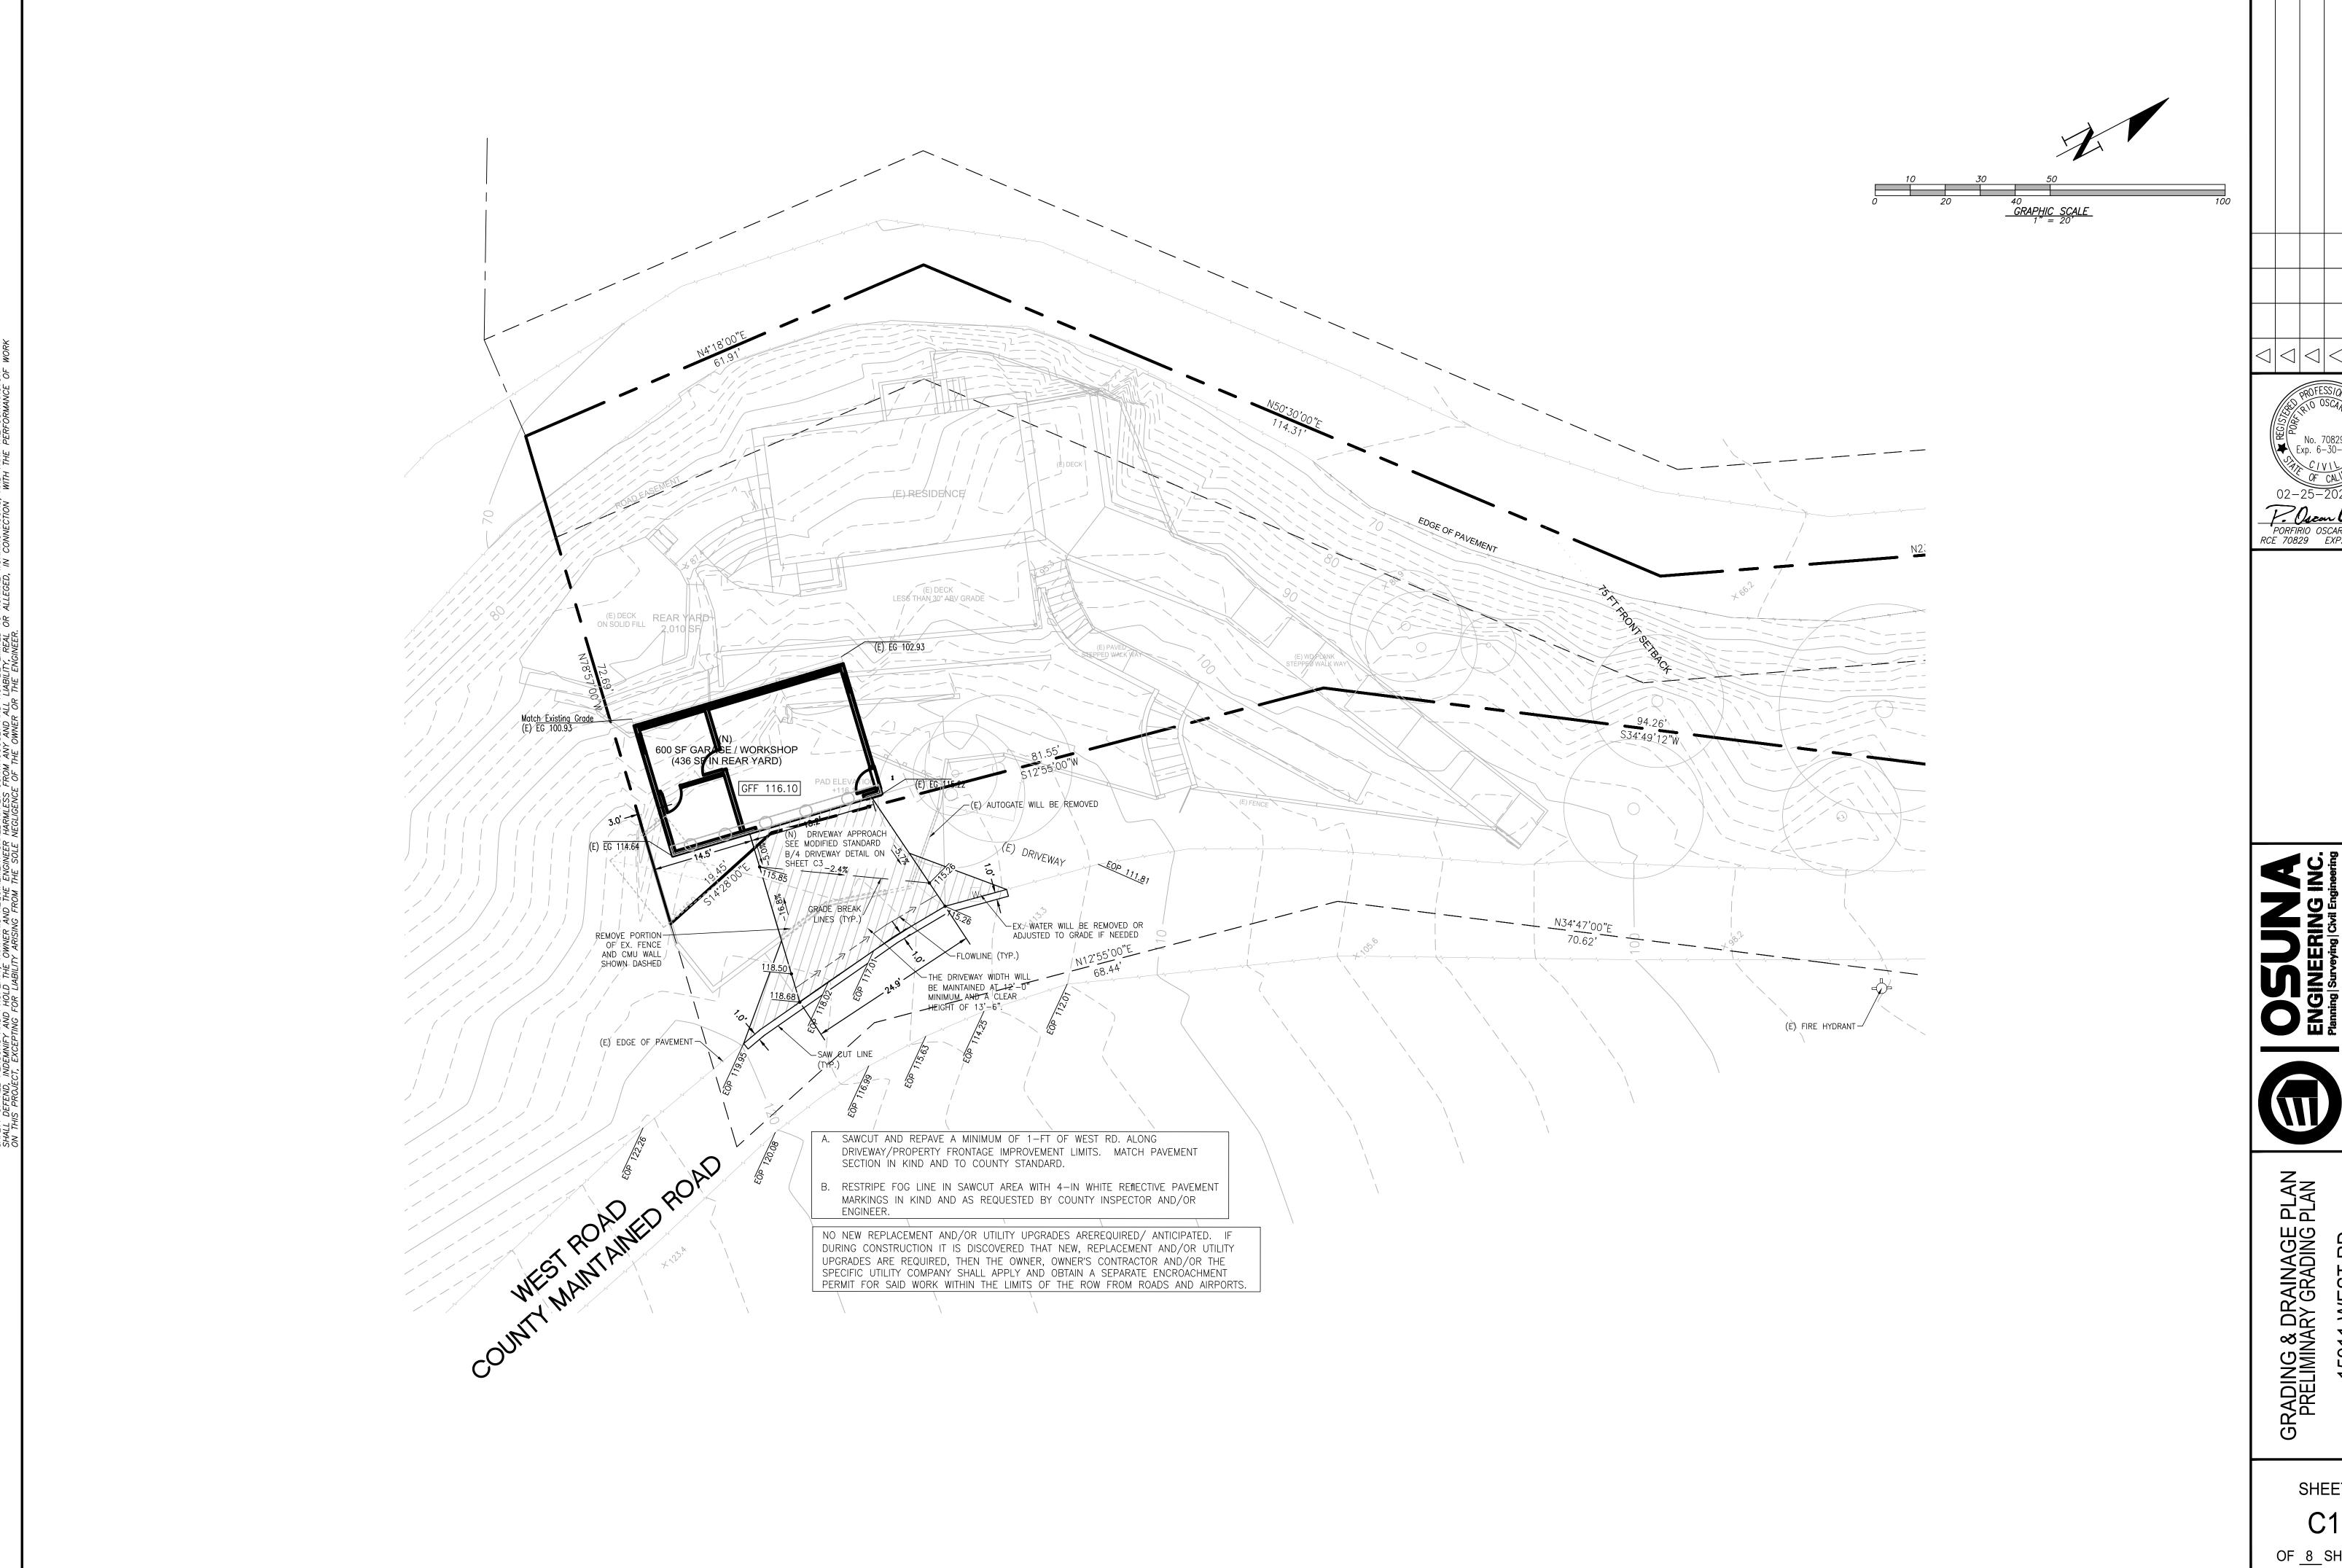


PORFIRIO OSCAR OSUNA RCE 70829 EXP. 6-30-23

SHEET

OF 8 SHEETS

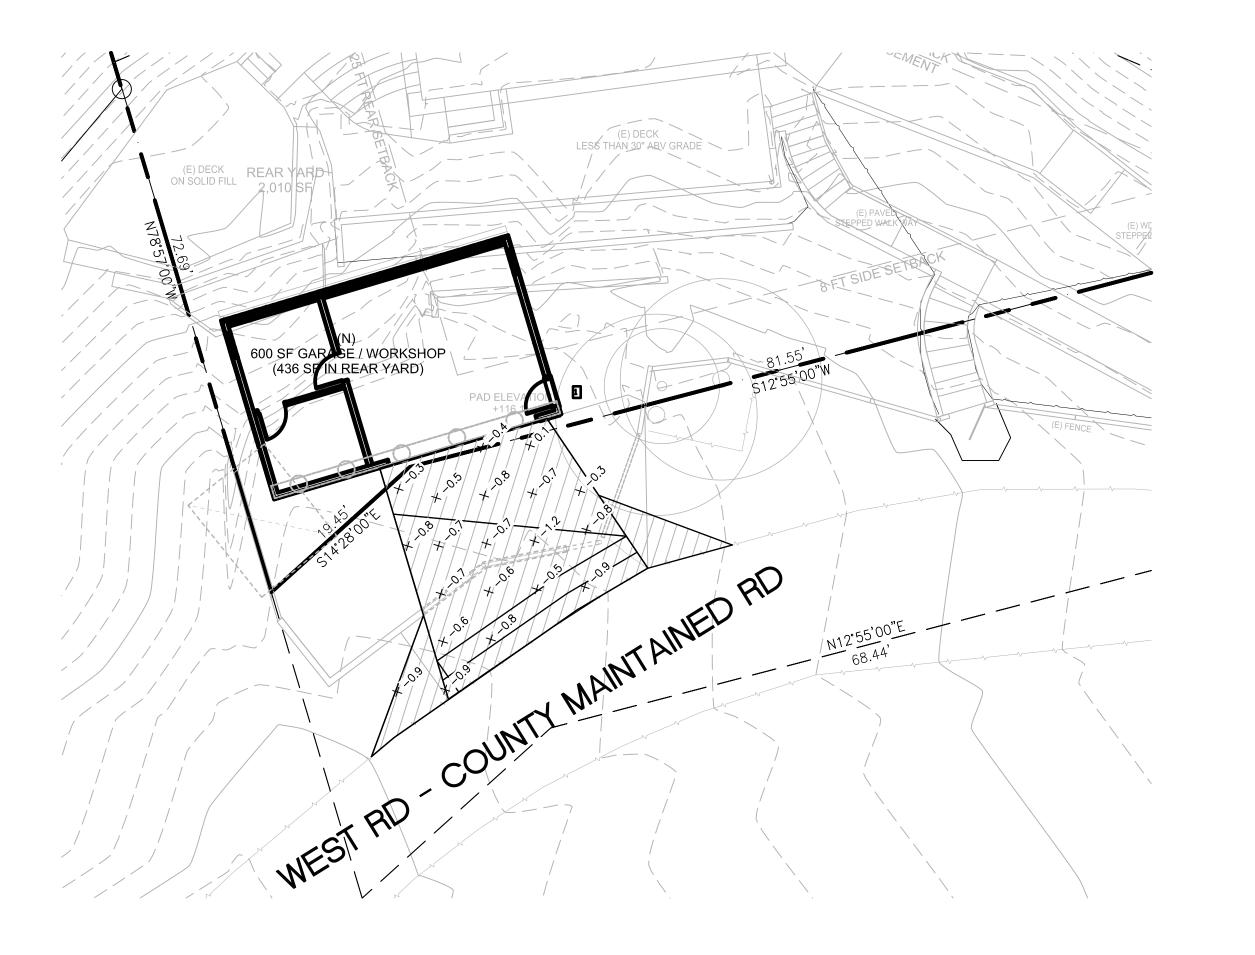

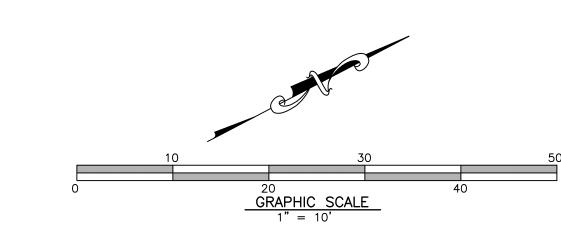

		EARTH\	NORK Q	UANTITIES				
DESCRIPTION		EARTH	EARTHWORK QUANTITIES ALL		EARTHWORK QUANTITIES EXCLUDING EXEMPT		MAXIMUM DEPTHS	
		CUT (-)	FILL (+)	EXEMPT?	CUT (-)	FILL (+)	CUT (-)	FILL (+)
		CY	CY	YES/NO	CY	CY	FT	FT
BUILDING EXEMPT	GARAGE PAD	0	0	YES			0.0	0.0
SITE WORK	DRIVEWAY APPROACH	12	0	NO	12	0	-1.2	0.0
	TOTALS:	12	0		12	0	<- EXEMP	TOTALS
TOTAL NET IMPORT: IMPORT (+) / EXPORT (-)		-:	12	CUBIC YARDS (IN-PLACE)	-:	12	CUBIC (IN-P	YARDS LACE)

2/25/2021

EARTHWORK 2-25-21.html

OSUNA ENGINEERING INC

6920 SANTA TERSA BLVD

Suite #206

SAN JOSE, CA 01234

Surface Report	Client: Client Company
Project Name: \\nas\\NAS\\OE TEAM\\PROJECTS\\Job 1653- 15911 West Rd Los Gatos, CA- Robert Mintz\\Drawings\\1653 Earthwork-Cut & Fill.dwg	
Report Date: 2/25/2021 2:05:14 PM	Prepared by:

Linear Units: foot	Area Units: squareFoot	Volume Units: cubic Yard	
Surface: 1653 Driveway	VOL		
Description: Description			
Area 2D: 499.021	Area 3D: 5	3.298	
Elevation Max: 0.309	Elevation N	Min: -1.469	
Number of Points: 81	Number of	Triangles: 129	
Number of Points: 81 Volume Surface: 1653 I	Number of		
Description: Description Volume Cut: 12.268	Volume Fill: 0.	098 Volume Total: -12.169	
Compare Surface: 1653	FG.	1010111	



PORFIRIO OSCAR OSUNA RCE 70829 EXP. 6-30-21

GRADING & DRAINAGE PLAN PRELIMINARY GRADING PLAN

SHEET

OF 8 SHEETS