### **Project Team**

Architectural Design: PMCKM - Paz de Moura Castro King Mueckenheim

Project Team Members: Maria Paz De Moura Castro King Arquiteta CAU (Brazil) Mark Mueckenheim Architekt AKNW (Germany) Hannah Moon Licensed Architect NCARB (US) Rachel Yi-hsien Wang

8.5"

Project Contact: contact@pmckm.com +1 (415) 316 9029 +1 (415) 215 8410

### **Client/Owner**

Stacey and Joao Tang

### **Construction Type**

Type VA

### **Drawing List**

A0.0 TITLE SHEET A0.1 PERMIT DATA A0.2 ABBREVIATIC A0.3 NOTES & LEC A0.4 EXISTING CO
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A3.1 EXTERIOR EL A3.2 EXTERIOR EL
A4.1 CROSS SECT

A4.1 CROSS SECTIONS A-A & B-B A4.2 LONGITUDINAL SECTIONS C-C & D-D

### / DRAWING LIST 4 ONS GEND ONDITIONS (PHOTOS)


16.5"

Ρ ACCESS MAP MAP TE PLAN SITE PLAN E PLAN \_AN WALL PLAN

OOR PLAN OOR PLAN

LEVATIONS WEST & EAST LEVATIONS NORTH & SOUTH

### Site Location Map

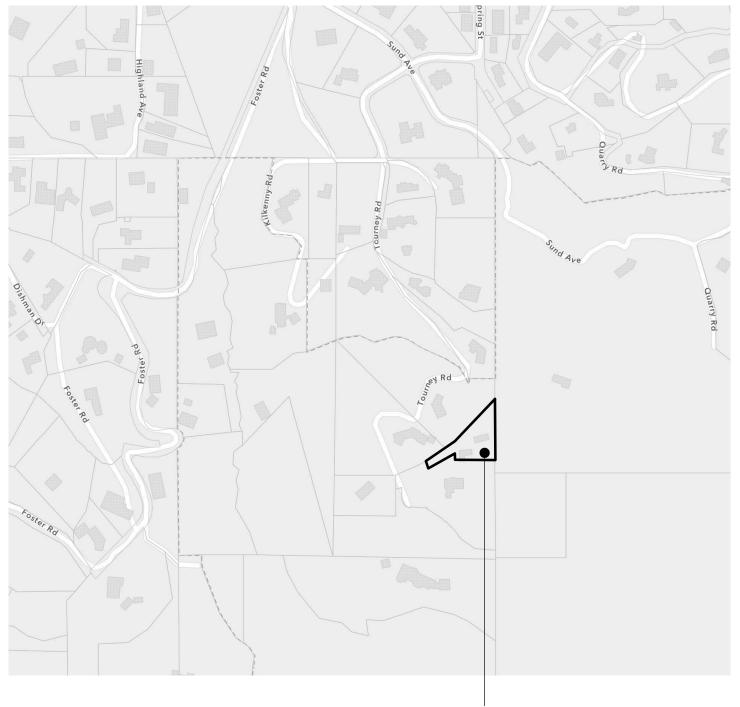



### **PROJECT LOCATION** 17800 TOURNEY RD

24.5"

11"

### Project: 17800 Tourney Road - Los Gatos Clients: Stacey and Joao Tang

SCALE: AS NOTED

DRAWN BY: RW

DATE: 11130121

MOON

C-38791

06/30/23

# PACKER Paz de Moura Castro King Mückenheim

30.25"

22"

\_\_\_\_\_22"

Maria Paz de Moura Castro Arquiteto (Brazil) A57642-5 International Associate AIA (US) #39269768 Mark Mueckenheim Architekt AKNW (Germany & EU) #A34968 International Associate AIA (US) #39241078 California Architect of Record: Hannah Moon Licensed Architect - C38791

Phone: 1 (415) 316 9029 contact@pmckm.com www.pmckm.com

ISSUE DATE DESC

HANNAH M

INSTRUCTIONS WHEN PLAN IS FOLDED: 1.) flip the flaps on the back of the plan forward

> so that the plan looks like this 3.) pull the plan to the right to unfold it

**Title Sheet** 

(accordion style) 2.)

-> repeat in reverse to



### **Project Scope:**

THE SCOPE OF WORK UNDER THIS PERMIT INCLUDES: (1) REFINISH OF (E) POOL AREA; (2) DEMOLITION OF (E) SINGLE FAMILY DWELLING AND ACCESSORY STRUCTURE; & (3) CONSTRUCTION OF (N) SINGLE FAMILY DWELLING AND GARAGE.

8.5"

### **Project Data (Legal):**

Location: 17800 Tourney Road, Los Gatos, CA 95030 APN: 537-04-062 or 537-04-037 County: Santa Clara County Zoning: R1E-5s-d1

Building Type: Single Family Residence Effective Year: 2022-2024

<b>Building:</b>		<b>Existing:</b>	<b>Proposed:</b>
Lot Area:		26133 SF	No change
Building Size:		3781 SF	7485 SF
Garage:		413 SF	1679 SF
Total:		4194 SF	9164 SF
Pool:		355 SF	No change
Spa:		218 SF	No change
<b>Building Setbacks:</b>	<b>Allowed</b>	<b>Existing:</b>	<b>Proposed:</b>
Front:	25'-0"	7'-7"	25'-0"
Rear:	25'-0"	24'-0"	25'-1"
Right Side:	5'-0"	63'-5"'	6'-0"
Left Side:	5'-0"	28'-6"	11'-3"

### Building Height: Allowed:

Proposed:

### Lot Coverage:

Allowed: Proposed: Proposed Footprir

### Floor Area Ratio:

Allowed: Proposed:

Number of Bedroo Number of Full Ba Number of Half Ba Number of Kitcher Number of Half Ki Number of Firepla

Land Use: Hillside Residential Plan Area Lot: 62

Los Gatos Hillside Specific Plan Area: IN State Response Area: SRA (100%) Wildland Urban Interface: IN - Very High (100%) Fire Protection District: Santa Clara County Central Fire Protection District

35'-0" above final grade 34'-1" above final grade
No limit
27.9%
7302 SF

nt:		

Nol	imit
0.3	51

Existing:	Proposed:

oms:	-	5
athrooms:	-	6
athrooms:	-	2
ens:	-	2
itchens/Bars:	-	1
aces:	-	2

Historic Parcel: No FEMA Flood Zone: D (100%) Watershed: San Francisco Bay Rain isohyet: 29 inches, 32 inches Nearest named creek: Limeklin Canyon (2886 feet) Nearest named lake: Lexington Reservoir (2886 feet) Geohazard: County landslide hazard zone Geohazard: State seismic hazard zone (earthquake induced landslides)

### **APPLICABLE BUILDING CODES:**

ALL WORK NOTED SHALL BE IN FULL ACCORD AND COMPLY WITH THE LATEST RULES, REGULATIONS, ORDINANCES, CODES AND STANDARDS LISTED BELOW AND ANY AND ALL LOCAL CODES AND ORDINANCES CURRENTLY IN EFFECT IN THE COUNTY OF SANTA CLARA

2019 CALIFORNIA BUILDING CODE (CBC)
2019 CALIFORNIA RESIDENTIAL CODE (CRC)
2019 CALIFORNIA GREEN BUILDING CODE (CGBC)
2019 CALIFORNIA PLUMBING CODES (CPC)
2019 CALIFORNIA MECHANICAL CODE (CMC)
2019 CALIFORNIA ELECTRICAL CODE (CEC)
2019 CALIFORNIA ENERGY CODE
2019 CALIFORNIA ENERGY EFFICIENCY STANDARDS
2019 CALIFORNIA FIRE CODE W/ COUNTY OF
SANTA CLARA AMENDMENTS

24.5"

### 11"

22"

### Project: 17800 Tourney Road - Los Gatos

Clients: Stacey and Joao Tang

30.25"

\_\_\_\_\_22"

### PAZ de Moura Castro King Mückenheim

Maria Paz de Moura Castro Arquiteto (Brazil) A57642-5 International Associate AIA (US) #39269768 Mark Mueckenheim Architekt AKNW (Germany & EU) #A34968 International Associate AIA (US) #39241078 California Architect of Record: Hannah Moon Licensed Architect - C38791 Phone: 1 (415) 316 9029

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> 2.) so that the plan looks like this 3.)

plan forward

pull the plan to

the right to unfold it -> repeat in reverse to f

Permit Data



SCALE: AS NOTED

**DRAWN BY: RW** 

DATE: 11|30|21

HANNAH M MOON

C-38791

(accordion style)

### **General Notes and Conditions:**

1. Notify architectural designer promptly if any conditions conflict with construction documents.

8.5"

2. Field verify all existing conditions and dimensions prior to fabrication/ construction.

3. Notify architectural designer of any discrepancies between documents, including discrepancies between engineering documents and construction documents.


4. Provisions shall be made for the undergrounding of all utilities serving the property, including but not limited to electrical, telephone, and cable television, by the installation of appropriately sized underground conduits extending from the street property, as per BBC 705A.1.

5. All persons working at this site must implement applicable portions of the State Storm Water Best Management Practices Manual for Construction to the maximum extent practicable to prevent erosion and sediment from entering into the storm drain system. Failure to utilize adequate controls is a violation of BMC 17.20. A copy of the manual is available upon request at the Permit Service Center and available online at www.cabmphandbooks.com.

6. Approval of this permit for work in the public right-of-way or easement does not relieve the applicant of the responsibility of obtaining permission to enter neighboring property or properties in the course of this work if necessary. It shall not be construed as a license to alter or adversely impact any facilities located in these easements which are privately owned. Full restitution and restoration shall be the responsibility of the permittee. Permittee shall notify property owner of intentions 72 hrs prior to entering the property.

7. This is a permit set of design drawing not intended for the actual construction.

### **Project Symbols:**

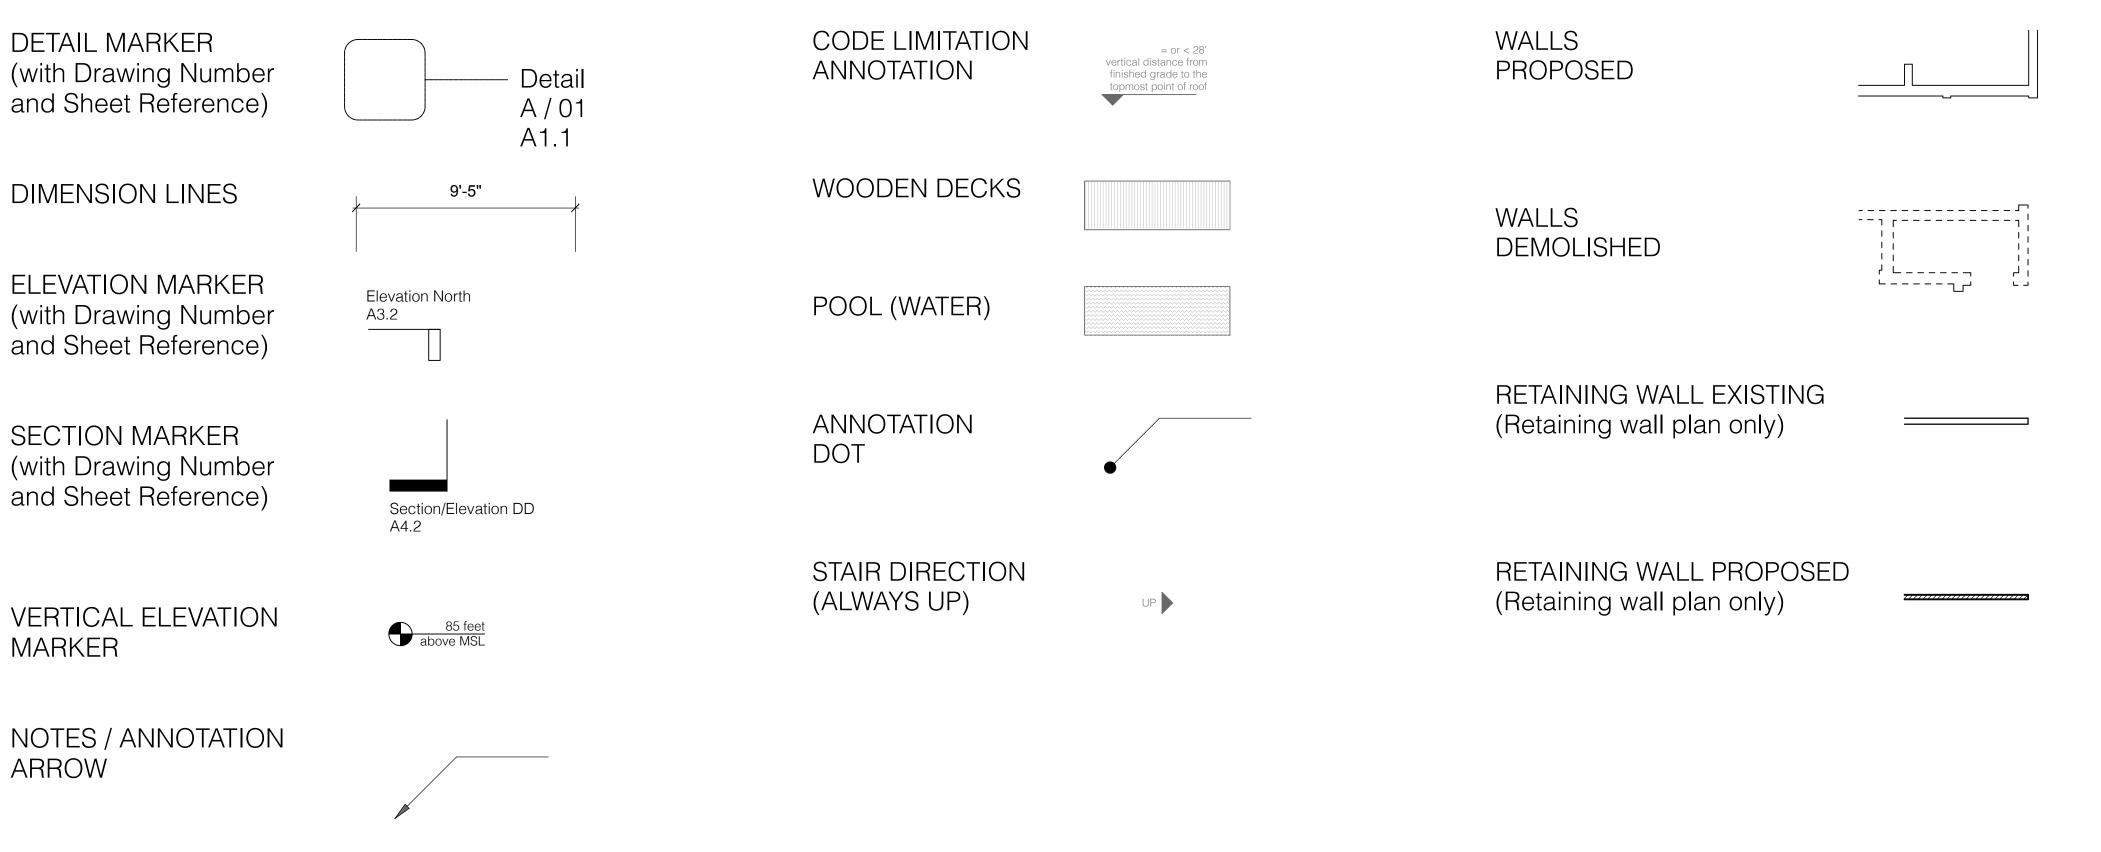

### **Dimensioning Conventions:**

16.5"

1. Dimensions as noted in the plans shall take precedence over scaled dimensions.

24.5"

2. Dimensions are from grid line to face of concrete or stud on plans and face of finish on all other rawings, unless otherwise noted. any errors, ommissions, or ambiguities in the plans are to be reported to the architectural designer before proceeding with the work. see enlarged plans, for additional dimensions & information.

3. Details shall govern over plans and elevations. large scale plans govern over small scale plans. large scale details shall govern over small scale details. if unable to locate the dimensions for any item of work, consult the architect prior to construction.

4. All dimensions on elevations are indicated from finish floor elevation to fixture and/or finish wall unless otherwise noted.

5. All heights are dimensioned from the top of plywood or slab, unless noted "a.f.f."

6. Dimensions are not adjustable, unless noted (+/-), without architect's written approval.

7. Except where specifically noted to the contrary, all dimensions shown on the architectural drawings conform to the following conventions: - structural or dimensional grid lines - centerline of steel - centerline of door, window, or cased opening.

8. Where walls and / or partitions of unequal thickness abut, align exposed faces, unless otherwise noted.

# TI' Project: **17800 Tourney Road - Los Gatos** Clients: Stacey and Joao Tang **PROJECT: ITRANCE**

30.25"

22"

36" & 24"

MARKER **PMCKM** Maria Paz de Moura Castro Arquiteto (Brazil) A57642-5 International Associate AIA (US) #39269768 **SCALE: AS NOTED SLIDING POCKET** Mark Mueckenheim Architekt AKNW (Germany & EU) #A34968 **DRAWN BY: RW** DOOR International Associate AIA (US) #39241078 California Architect of Record: DATE: 11130121 Hannah Moon Licensed Architect - C38791 Phone: 1 (415) 316 9029 contact@pmckm.com www.pmckm.com DOOR (SWINGING) ISSUE DATE DESC Ĺ HANNAH N MOON SLIDING GLASS DOOR INSTRUCTIONS WHEN PLAN IS FOLDED: 1.) flip the flaps on the back of the plan forward SHOWER WITH (accordion style 2.) FLOOR DRAIN so that the plan looks like this pull the plan to the right to unfold it -> repeat in reverse to Notes & **A0.2** Legend

30 25"

### Abbreviations:

ACT BLDG BLKG	Acoustical Ceiling Tile Building Blocking
BOS BOT	Bottom of Steel Bottom
BRG	Bearing
CAB CEIL	Cabinet Ceiling
CG	Corner Guard
CJ	Control/Construction Joint
CL CLR	
CLK	Clear/Clearance Cross Laminated Timber
CMU	Concrete Masonry Unit
COL	Column
CONC CONST	Concrete Construction
CONT	Continuous
COORD	Coordinate/Coordination
CPT CSWK	Carpet Casework
CP	Centerpoint
CT	Ceramic Tile
DEMO DF	Demolition Drinking Fountain
DIA	Diameter
DIAG	Diagonal
	Dimension
DISP DN	Dispenser Down
DR	Door
DTL	Detail Drawing (Drawinga
DWG(S) EXIST	Drawing/Drawings Existing
EIFS	Exterior Insulation & Finish
EL	Elevation
ELEC ELEV	Electric/Electrical Elevator
EPDM	Elastomeric Membrane
EQ	Equal
EQUIP EXP	Equipment Exposed/Expansion
EJ	Expansion Joint
EXT	Exterior
FAST FD	Fasten/Fastener Floor Drain
FE	Fire Extinguisher
FEC	Fire Extinguisher Cabinet
FF FIN	Finish Floor Finish
FIXT	Fixture
FL/FLR	Floor Floor
FOS FR	Face of Stud Frame(s), (ing)
FRP	Fiber Reinforced Polyester
FTG	Footing
FTC FUR	Floor to Ceiling Furr(ed), (ing)
FXGL	Fixed Glazing
GA	Guage
GALV GBB	Galvanized Gypsum Backing Board
GC	General Contractor
GEN	General

GFRC GGB GL GLDR GWB GYP ΗB HC ΗM HOR ΗT HTG HVAC HDW ID INCL INSUL INT INV JAN JT KIT KO LAV LH MANF MATL MAX MECH MED MEMBR MEZZ MTL MIN MIR MISC MO MTD MULL Ν NE NIC NO,# NOM NTS NW OC OD OF/CI OF/OI OFRD OFS OH OPDRFC OPNG OPP OPWFT PERM PERP ΡL PLYWD PNL PR PREFAB

8.5"

Glass Fiber Gypsum Gr Glass/Glazi Glass Door Gypsum Wa Gypsum Hose Bibb Hollow Core Hollow Met Horizontal Height Heating Heating/Ver Hardwood Inside Diar Include(ed) Insulation Interior Invert Janitor Joint Kitchen/Kito Knockout Lavatory Left Hand Manufactur Material(s) Maximum Mechanical Medium Membrane Mezzanine Metal Minimum Mirror(ed) Miscellane Masonry O Mounted Mullion New Northeast Not in Cont Number Nominal Not to Scale Northwest On Center( Outside Dia Owner Furr Owner Furr Overflow Ro Overflow So Overhead Operating Opening Opposite Operable V Permanent Perpendicu Property Li Plywood Panel Pair Prefabricate(d)

er Reinforced Concrete	PREFIN	Prefinish(ed)
Greenboard	PRKG	Parking
zing	PROP	Property
or (swinging)	PT	Paint(ed)
Vallboard	QT	Quarry Tile
	QTY	Quantity
)	R	Riser
ore, Hose Cabinet	RAD/(R)	Radius(ed)
etal	RB	Rubber
	RCP	Reflected Ceiling Plan
	RD	Roof Drain
	REC	Recessed
entilation/AC	RECPT	Receptical
	REF	Reference/Refrigerator
meter	REINF	Reinforce(d), (ing)
d), (ing)	REQD REV	Required
	RH	Reverse Right Hand
	RM	Room
	RO	Rough Opening
	RT	Resilient Tile
itchenette	RVS	Roof Vent
	SC	Solid Core, Sealed Concrete
	SCH	Schedule
	SLDRFT	Sliding Door Floor to Ceiling
ure(r)	SE	Southeast
)	SECT	Section
	SHT	Sheet
al	SHTG	Sheathing
	SIM	Similar
Э	SPEC(S)	Specification(s)
9	SPKLR	Sprinkler
	SQ	Square
	SS	Stainless Steel
	STD	Standard
eous	STL	Steel
Opening	STOR	Storage
	STRUCT SURF	Structural
	SUSP	Surface Suspend(ed)
	SW	Southwest
ntract	SYS	System(s)
	T&G	Tongue and Groove
	T	Tread, Thermostat
ale	TI	Tenant Improvement(s)
	TAN	Tangent
r(s)	TBD	To Be Determined
iameter	TEL	Telephone
rnished/ Contractor	TEMP	Temperature/Temporary
rnished/ Owner Installed	THRU	Through
Roof Drain	ТОВ	Top of Beam
Scupper	TOC	Top of Curb/Coping/Concrete
	TOF	Top of Floor
Door Floor to Ceiling	TOFW	Top of Foundation Wall
	TOP	Top of Parapet
	TOS	Top of Steel
Window Floor to Ceiling	TOW	Top of Wall
nt La c	TP	Toilet Partition
cular	TYP	Typical
line		Unfinished
	UNO	Unless Noted Otherwise
	V VB	Vinyl Vinyl Baso
ate(d)	VB VCT	Vinyl Base Vinyl Composition Tile
	V U I	

16.5"

VERT
VEST
VIF
VNR
VT
VWC
W/
W/O
WC
WD
WDW
WH
W.H.
WFF

24.5"

Vertical 22" Vestibule Verify in Field Veneer Vinyl Tile Vinyl Wall Covering With Without Water Closet Wood Window Wall Hung Water Heater Welded Wire Fabric

30.25"

11"

11"

SCALE: AS NOTED

DRAWN BY: RW

DATE: 11130121

HANNAH M

MOON

C-38791

06/30/23

(accordion style)

36" & 24"

22"

### Project: 17800 Tourney Road - Los Gatos Clients:

Stacey and Joao Tang

### PAZ de Moura Castro King Mückenheim

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ISSUE DATE DESC

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plan forward

2.) 3.) pull the plan to the right to unfold it

-> repeat in reverse to fold back

Abbreviations **A0.3** 



8:5"

View towards the East



View towards the South



8.5"

View towards the North



16.5"

View towards the West



24.5"



Partially demolished area of House's South part


16.5"




Partially demolished area of House's South part

Pool Area


30.25

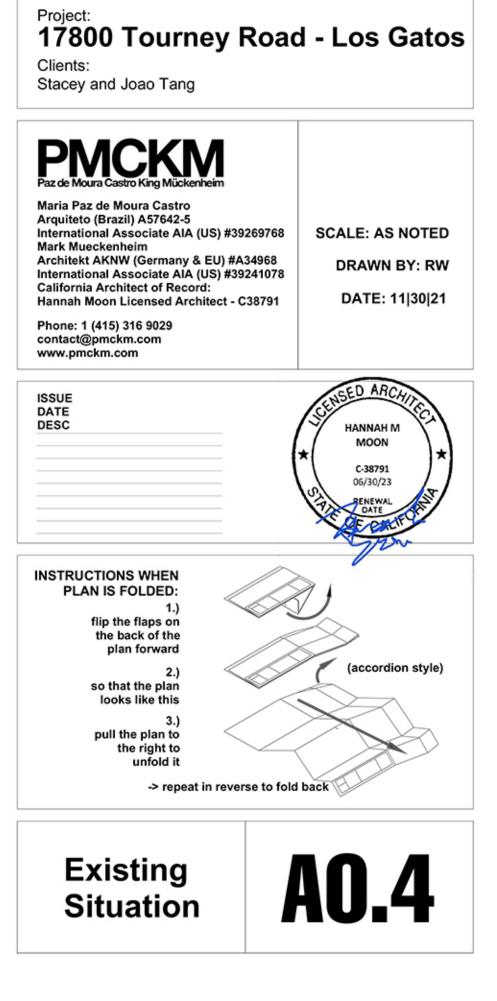

36" & 24

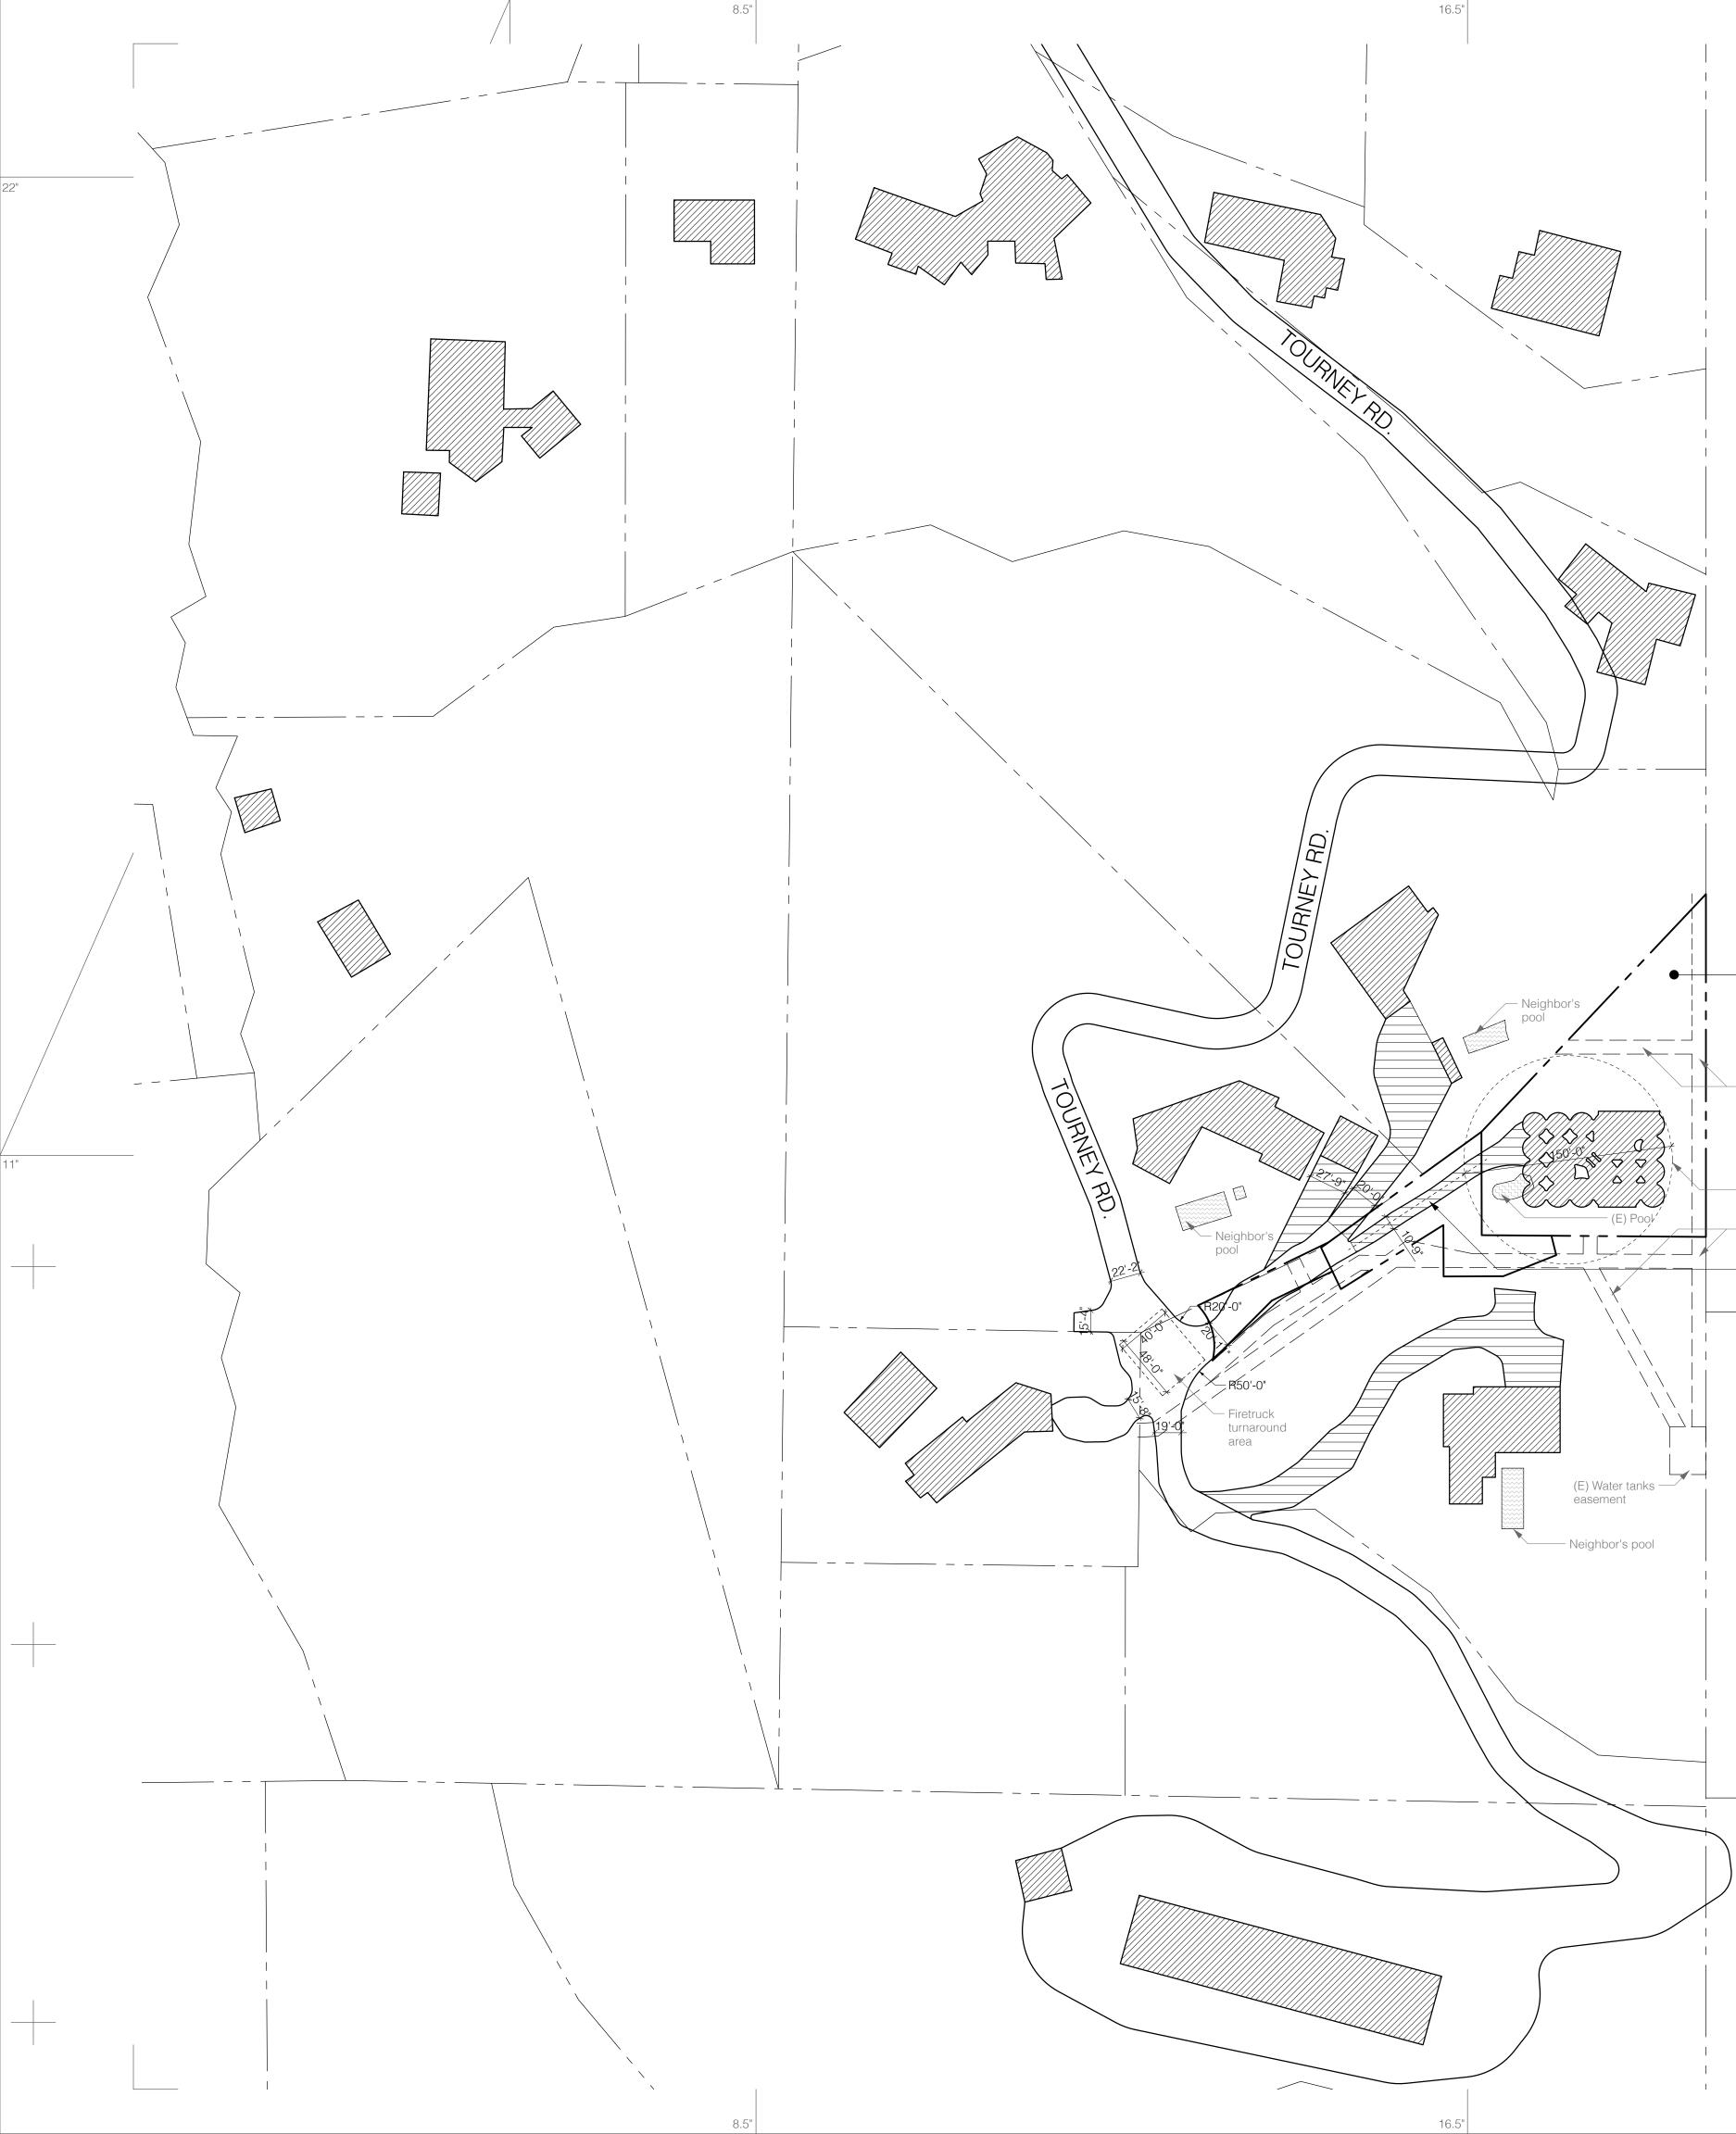

# LOS GATOS

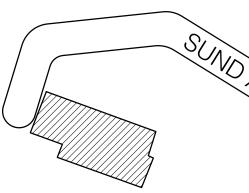

24.5"

-ND AVE

## 17800 TOURNEY RD APN 537-04-062

— (E) 10' Water line easement

 The proposed house is within 150' from the centerline of the roadway (E) 10' Water line easement

Access driveway width: 10'-9" Surface: concrete pavement Vertical clearance: no limit Load-bearing capacity: no limit Percent grade: 21.5% Bridges: none

No visible fire hydrants within 500 feet. Refer to A1.2 for existing fire water access.

AVE

11"

30.25"

22"

36" & 24"

22"

Project: **17800 Tourney Road - Los Gatos** Clients: Stacey and Joao Tang

PAZ de Moura Castro King Mückenheim

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-> repeat in reverse to fold back



SCALE: 1/64"=1'-0"

DRAWN BY: RW


DATE: 11130121

HANNAH N MOON


> C-38791 06/30/2

(accordion style)

30.2

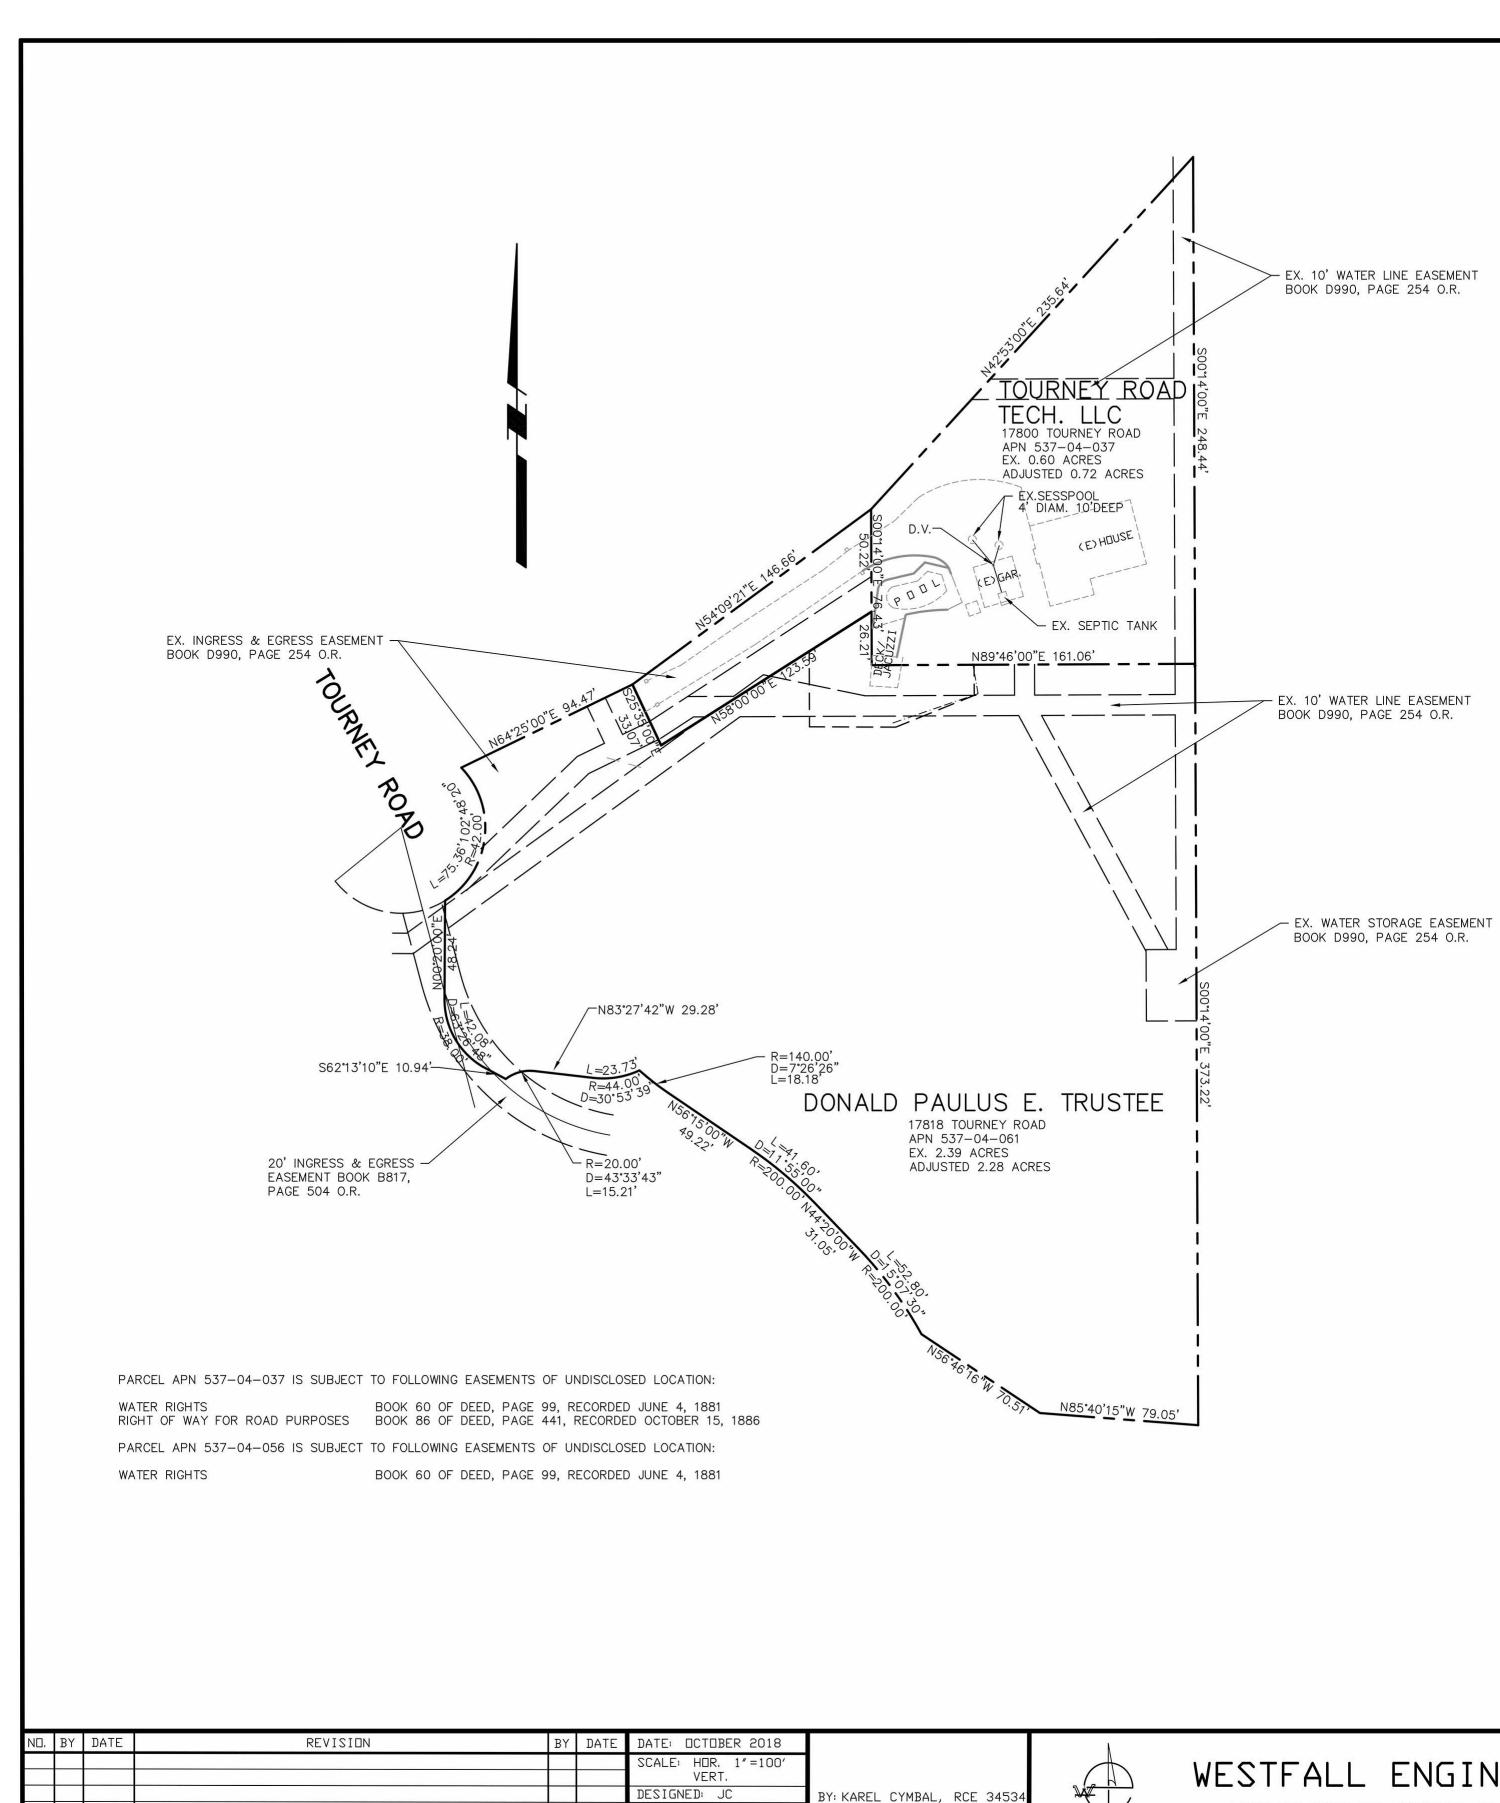

CHECKED: KC PRDJ.ENGR: J

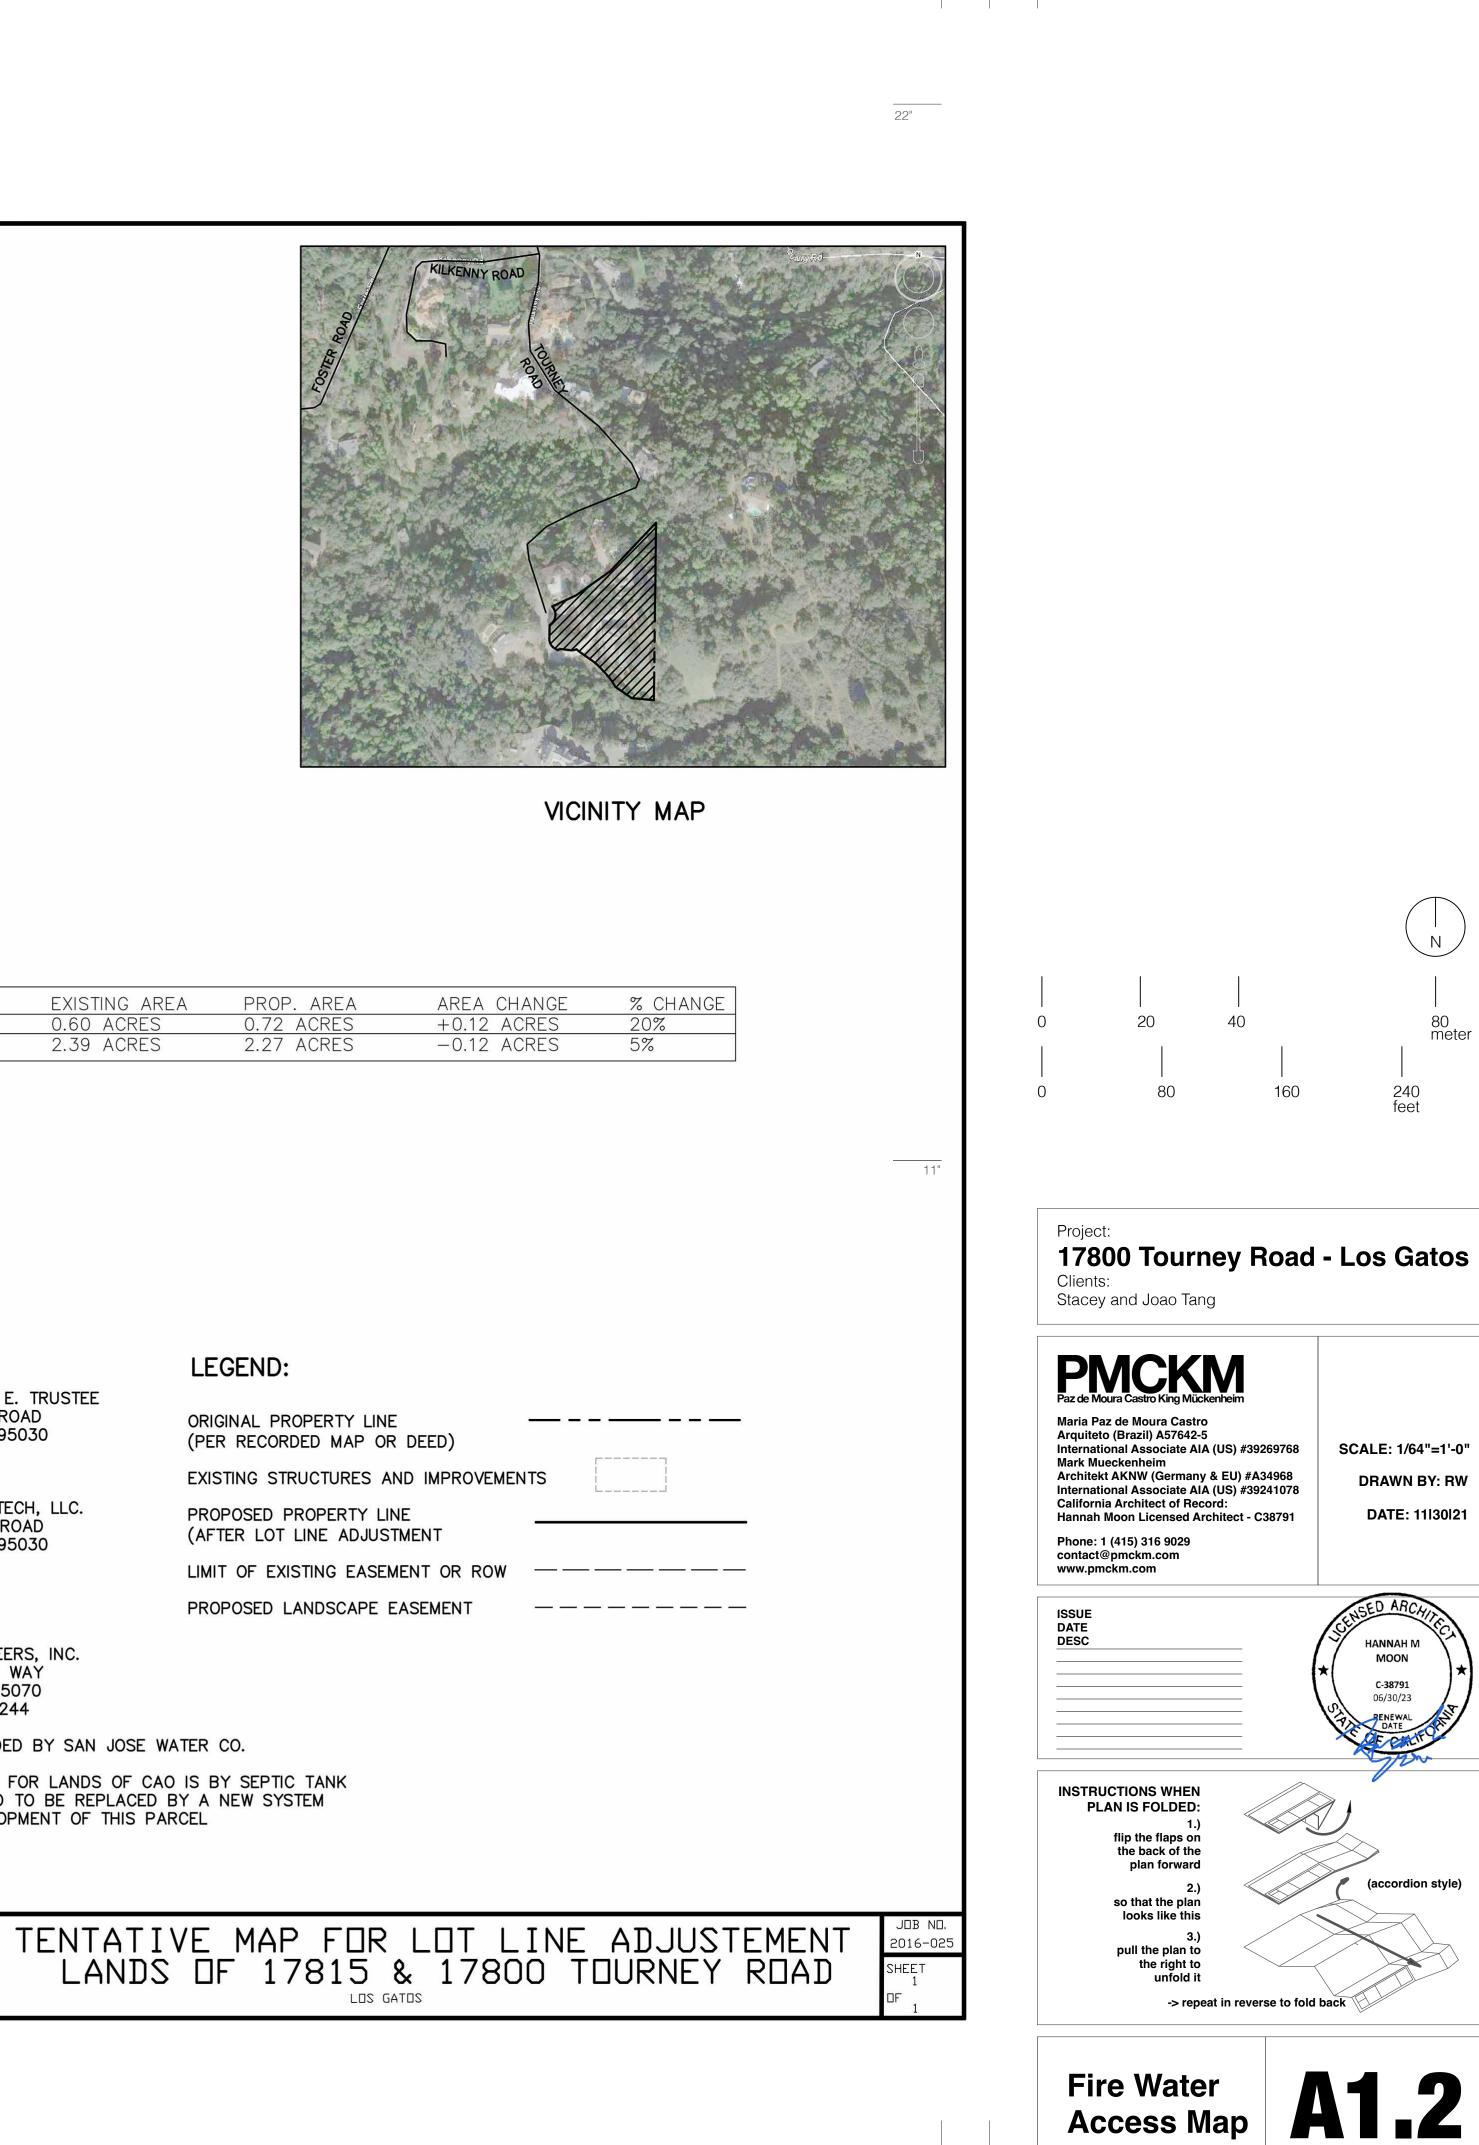

30.25"

	EXISTING AREA	PROP. AREA	AREA
537-04-037	0.60 ACRES	0.72 ACRES	+0.12
537-04-061	2.39 ACRES	2.27 ACRES	-0.12

OWNERS:

DONALD PAULUS E. TRUSTEE 17818 TOURNEY ROAD LOS GATOS, CA 95030 TEL. EMAIL:

TOURNEY ROAD TECH, LLC. 17800 TOURNEY ROAD LOS GATOS, CA 95030

ENGINEER:

WESTFALL ENGINEERS, INC. 14583 BIG BASIN WAY SARATOGA, CA 95070 TEL. 408-867-0244

WATER IS PROVIDED BY SAN JOSE WATER CO.

SANITARY SEWER FOR LANDS OF CAO IS BY SEPTIC TANK AND LEACH FIELD TO BE REPLACED BY A NEW SYSTEM DURING REDEVELOPMENT OF THIS PARCEL

BY: KAREL CYMBAL, RCE 34534


DATE:

WESTFALL ENGINEERS, INC. 14583 BIG BASIN WAY, SARATOGA, CA 95070 (408)867-0244

16.5"

24.5"


36" & 24"

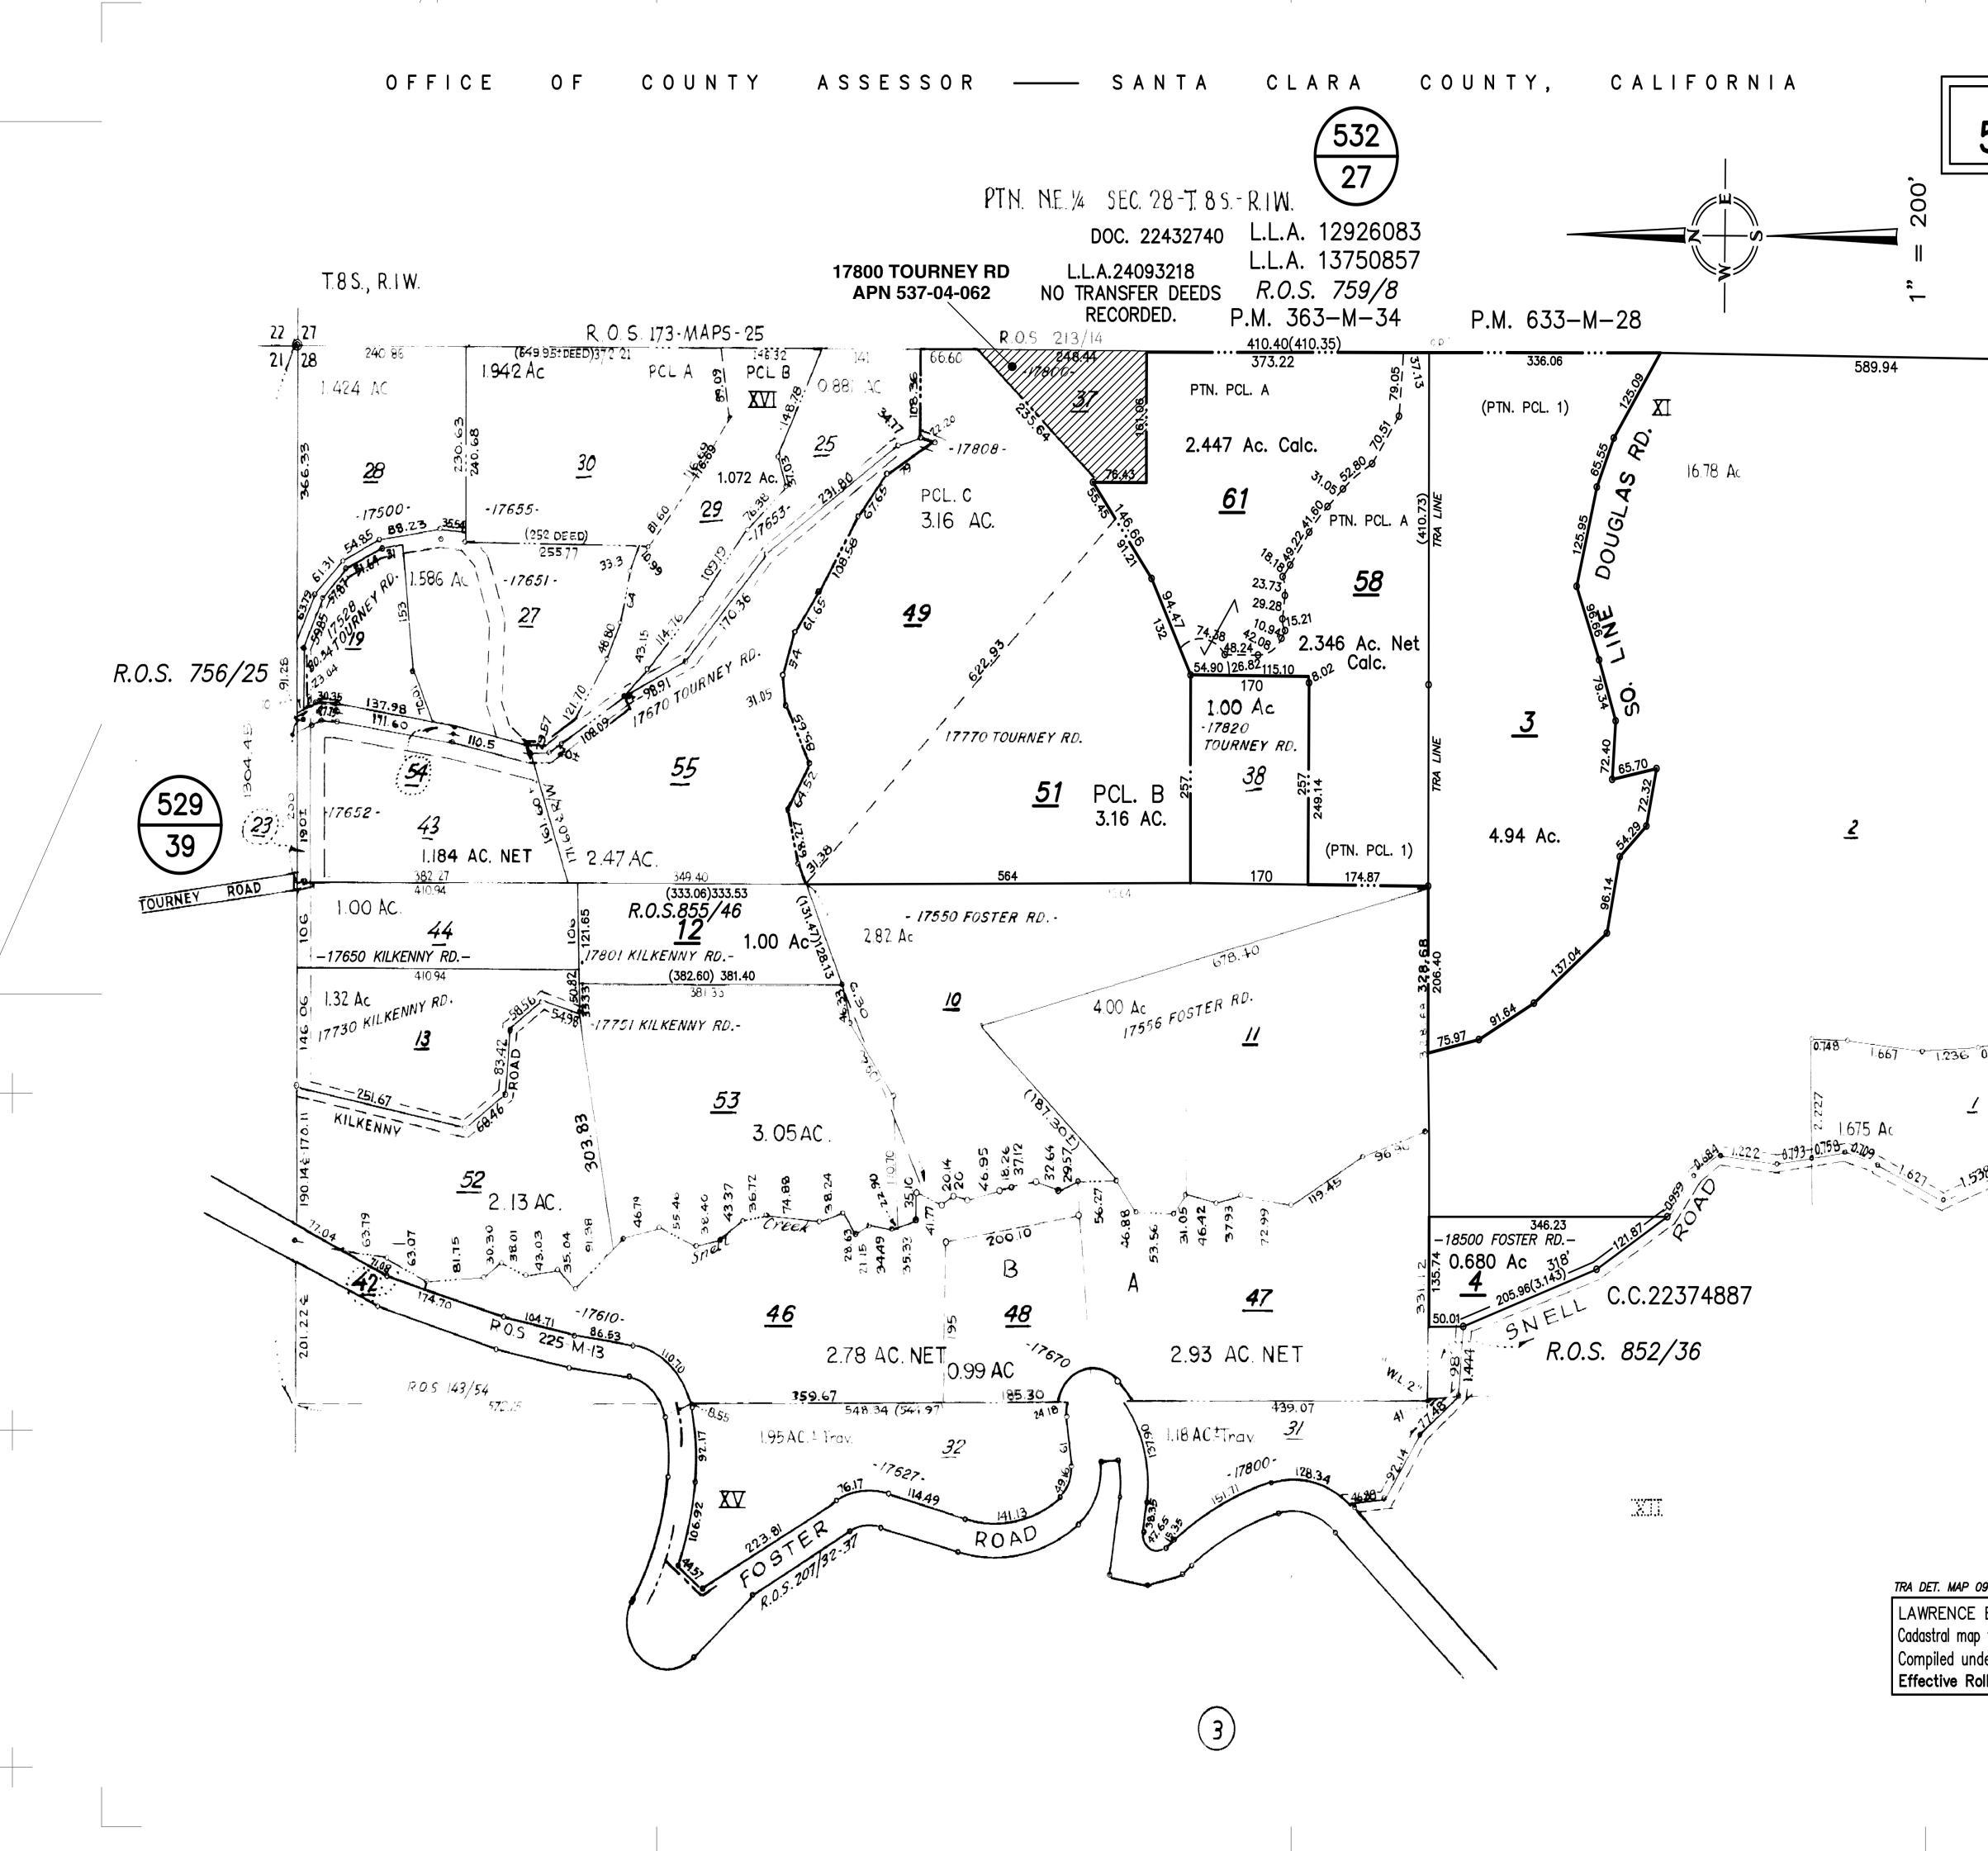

16.5"

24.5"

	30.25"		36" & 24
воок расе 537 <b>4</b>	22"		22
1/4 SEC.COR.			
-/+ 006			
5			
0.587	11"	Project: <b>17800 Tourney Road</b> Clients: Stacey and Joao Tang	- Los Gatos
538 0-1.10 1.292		Paz de Moura Castro King Mückenheim Maria Paz de Moura Castro Arquiteto (Brazil) A57642-5 International Associate AIA (US) #39269768 Mark Mueckenheim Architekt AKNW (Germany & EU) #A34968 International Associate AIA (US) #39241078 California Architect of Record: Hannah Moon Licensed Architect - C38791 Phone: 1 (415) 316 9029 contact@pmckm.com www.pmckm.com	SCALE: AS NOTED DRAWN BY: RW DATE: 11130121
		ISSUE DATE DESC	HANNAH M MOON C-38791 06/30/23 PENEWAL DATE
e <i>ogg</i> E E. STONE — ASSESSOR ap for assessment purposes only. Inder R. & T. Code, Sec. 327. Roll Year 2020—2021		INSTRUCTIONS WHEN PLAN IS FOLDED: 1.) flip the flaps on the back of the plan forward 2.) so that the plan looks like this 3.) pull the plan to the right to unfold it -> repeat in reverse to fold	(accordion style)
		Parcel Map	1.3

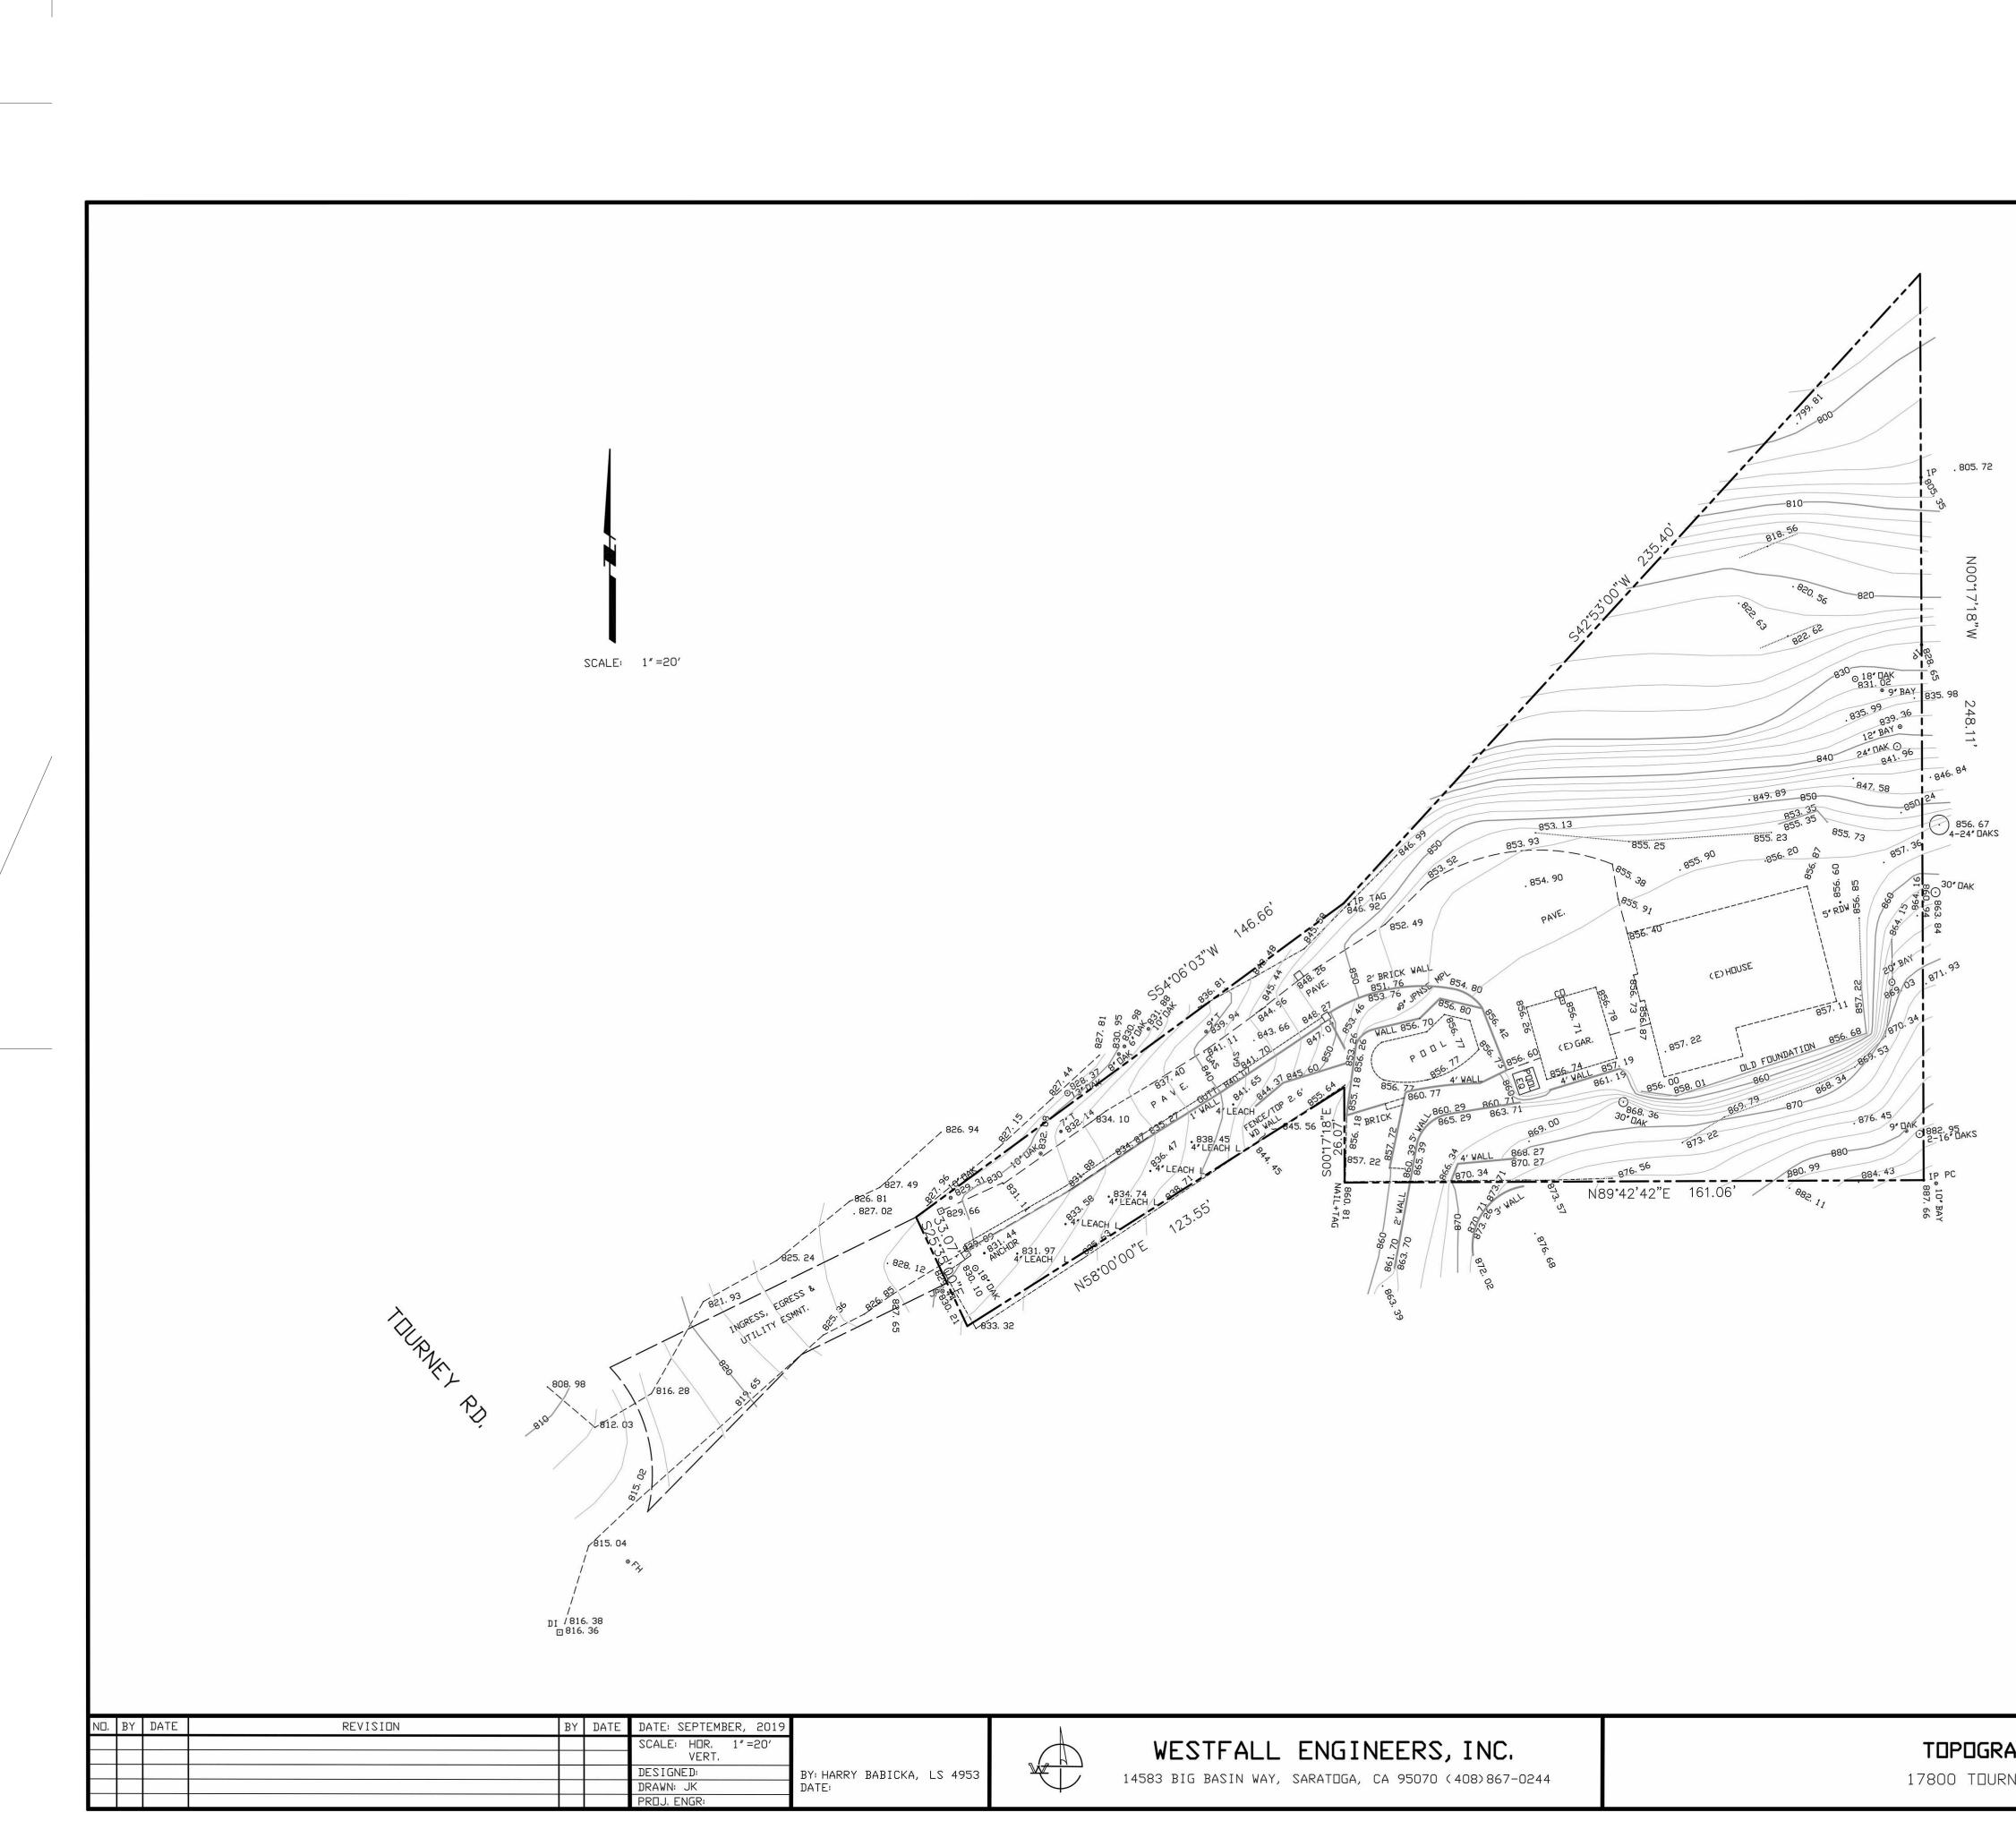

22"

	WESTFALL ENGINEERS, INC.	TOPOGRAPHIC
	14583 BIG BASIN WAY, SARATOGA, CA 95070 (408)867-0244	17800 TOURNEY ROA

16.5"

24.5"

	22"		
	11"	Project: <b>17800 Tourney Road</b> Clients: Stacey and Joao Tang	- Los Gatos
LEGEND BOUNDARY EASEMENT IMPROVEMENTS CONTOUR MAJOR BOUNDARY MAJOR BOUNDARY MAJOR BOUNDARY MAJOR BOUNDARY MAJOR BOUNDARY MAJOR		Paz de Moura Castro King Mückenheim Maria Paz de Moura Castro Arquiteto (Brazil) A57642-5 International Associate AIA (US) #39269768 Mark Mueckenheim Architekt AKNW (Germany & EU) #A34968 International Associate AIA (US) #39241078 California Architect of Record: Hannah Moon Licensed Architect - C38791 Phone: 1 (415) 316 9029 contact@pmckm.com www.pmckm.com	SCALE: AS NOTED DRAWN BY: RW DATE: 11130121
COUNTOUR MINOR FENCE RETAINING WALL EDGE OF PAVEMENT SPOT ELEVATION . 853. 46 UTILITY BOX GRADE BREAK BENCH MARK: TOWN OF LOS GATOS BENCH MARK "LG40". BRASS DISK IN		ISSUE DATE DESC	KINSED ARCHINC HANNAH M MOON C-38791 06/30/23 BENEWAL DATE DATE
MONUMENT WELL AT INTERSECTION OF SUND AVENUE AND TOURNEY LOOP. ELEV. = 526.90' SURVEY AD, LOS GATOS	JOB NO. 2016-025 SHEET 1 OF 1	INSTRUCTIONS WHEN PLAN IS FOLDED: 1.) flip the flaps on the back of the plan forward 2.) so that the plan looks like this 3.) pull the plan to the right to unfold it -> repeat in reverse to fold	(accordion style)

30.25"


30 25

Surveyor Map

**A1.4** 

36" & 24"

22"

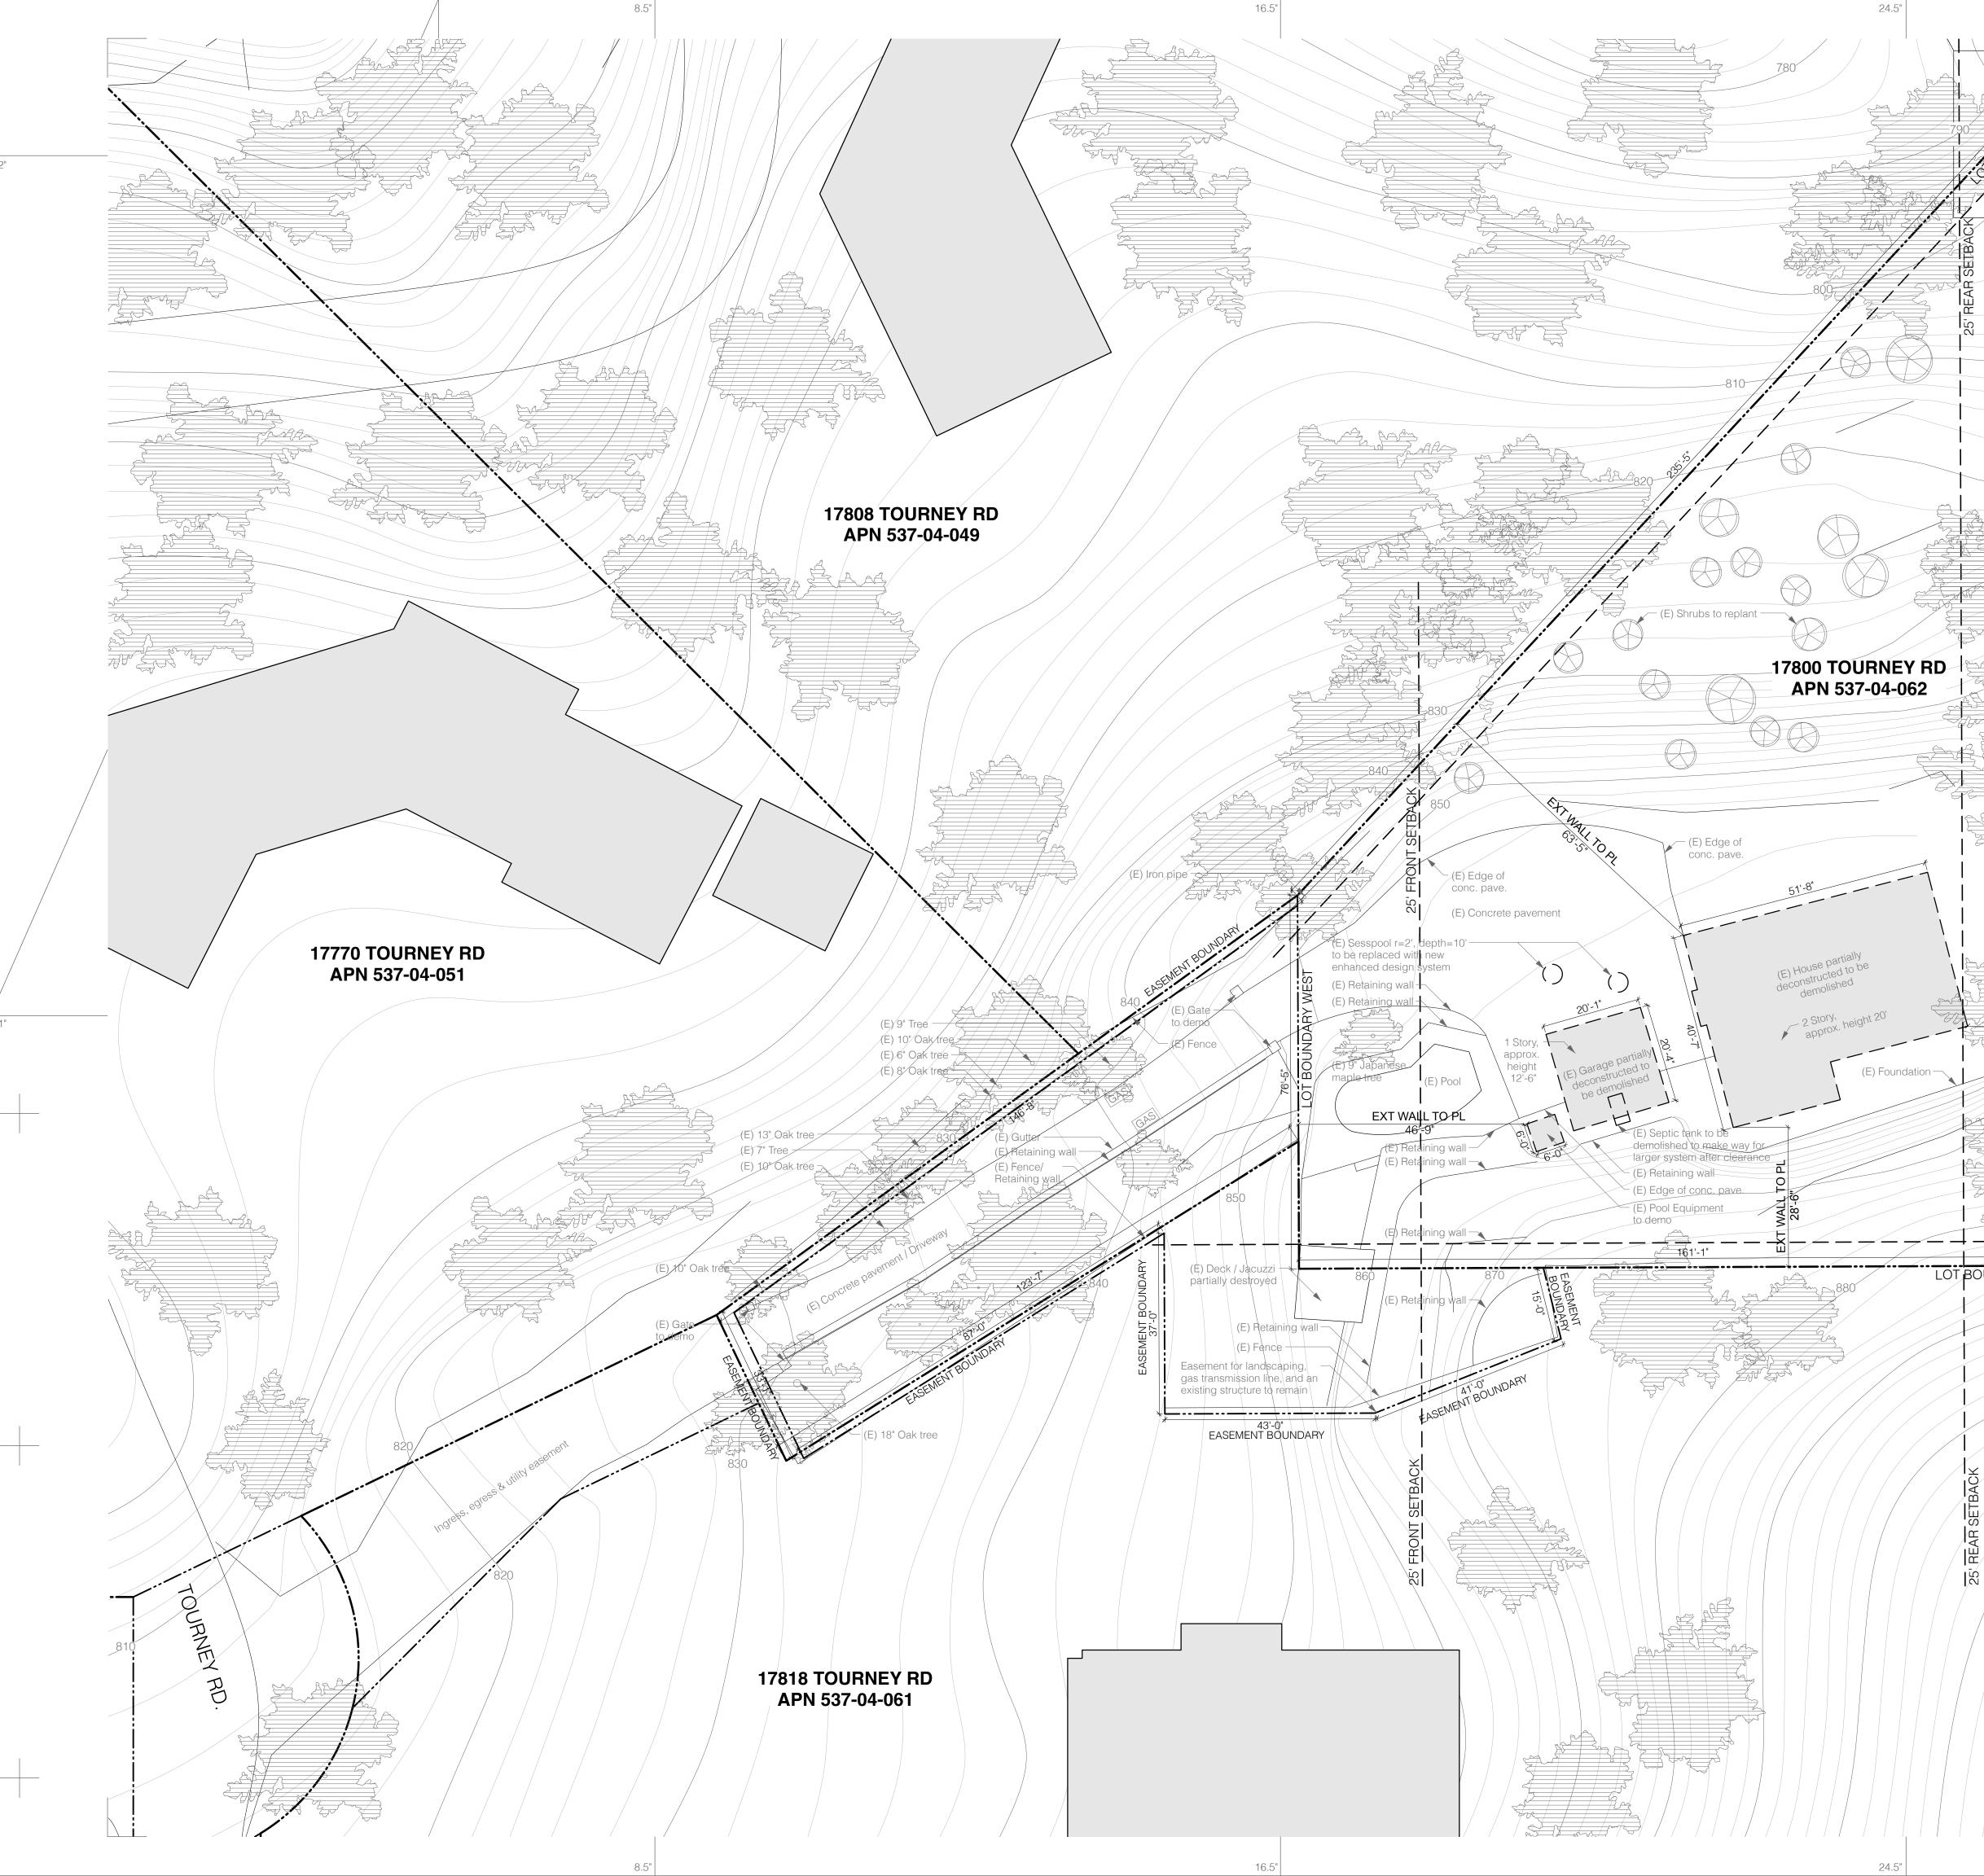



E) Irøn pipe


30.25"


### Existing Drainage Surface:

Pervious Surface (square feet):
Impervious Surface (square feet):

18189 (69.6%) 7944 (30.4%)

36" & 24"

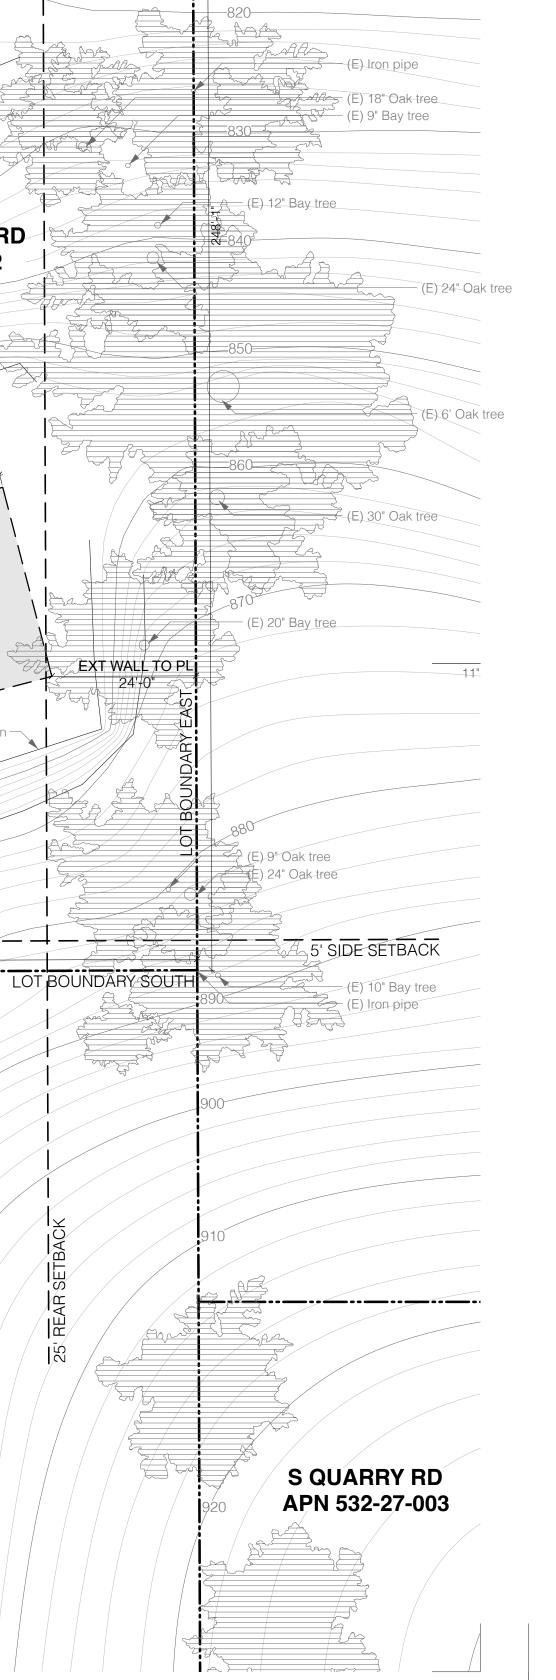

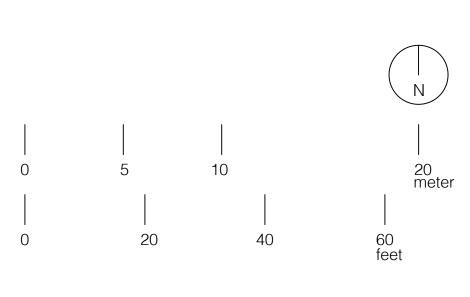

Project: **17800 Tourney Road - Los Gatos** Clients: Stacey and Joao Tang

Stacey and Joao Tang

Paz de Moura Castro King Mückenheim Maria Paz de Moura Castro Arquiteto (Brazil) A57642-5 International Associate AIA (US) #39269768 Mark Mueckenheim Architekt AKNW (Germany & EU) #A34968 International Associate AIA (US) #39241078 California Architect of Record: Hannah Moon Licensed Architect - C38791

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plan forward 2.) so that the plan looks like this 3.) pull the plan to the right to unfold it

WHEN LDED: 1.) laps on k of the forward 2.) he plan ike this 3.) plan to right to infold it -> repeat in reverse to fold back

Existing Site Plan

30.25"



SCALE: 1/16"=1'-0"


DRAWN BY: RW

DATE: 11130121

HANNAH M


**C-38791** 06/30/23

MOON

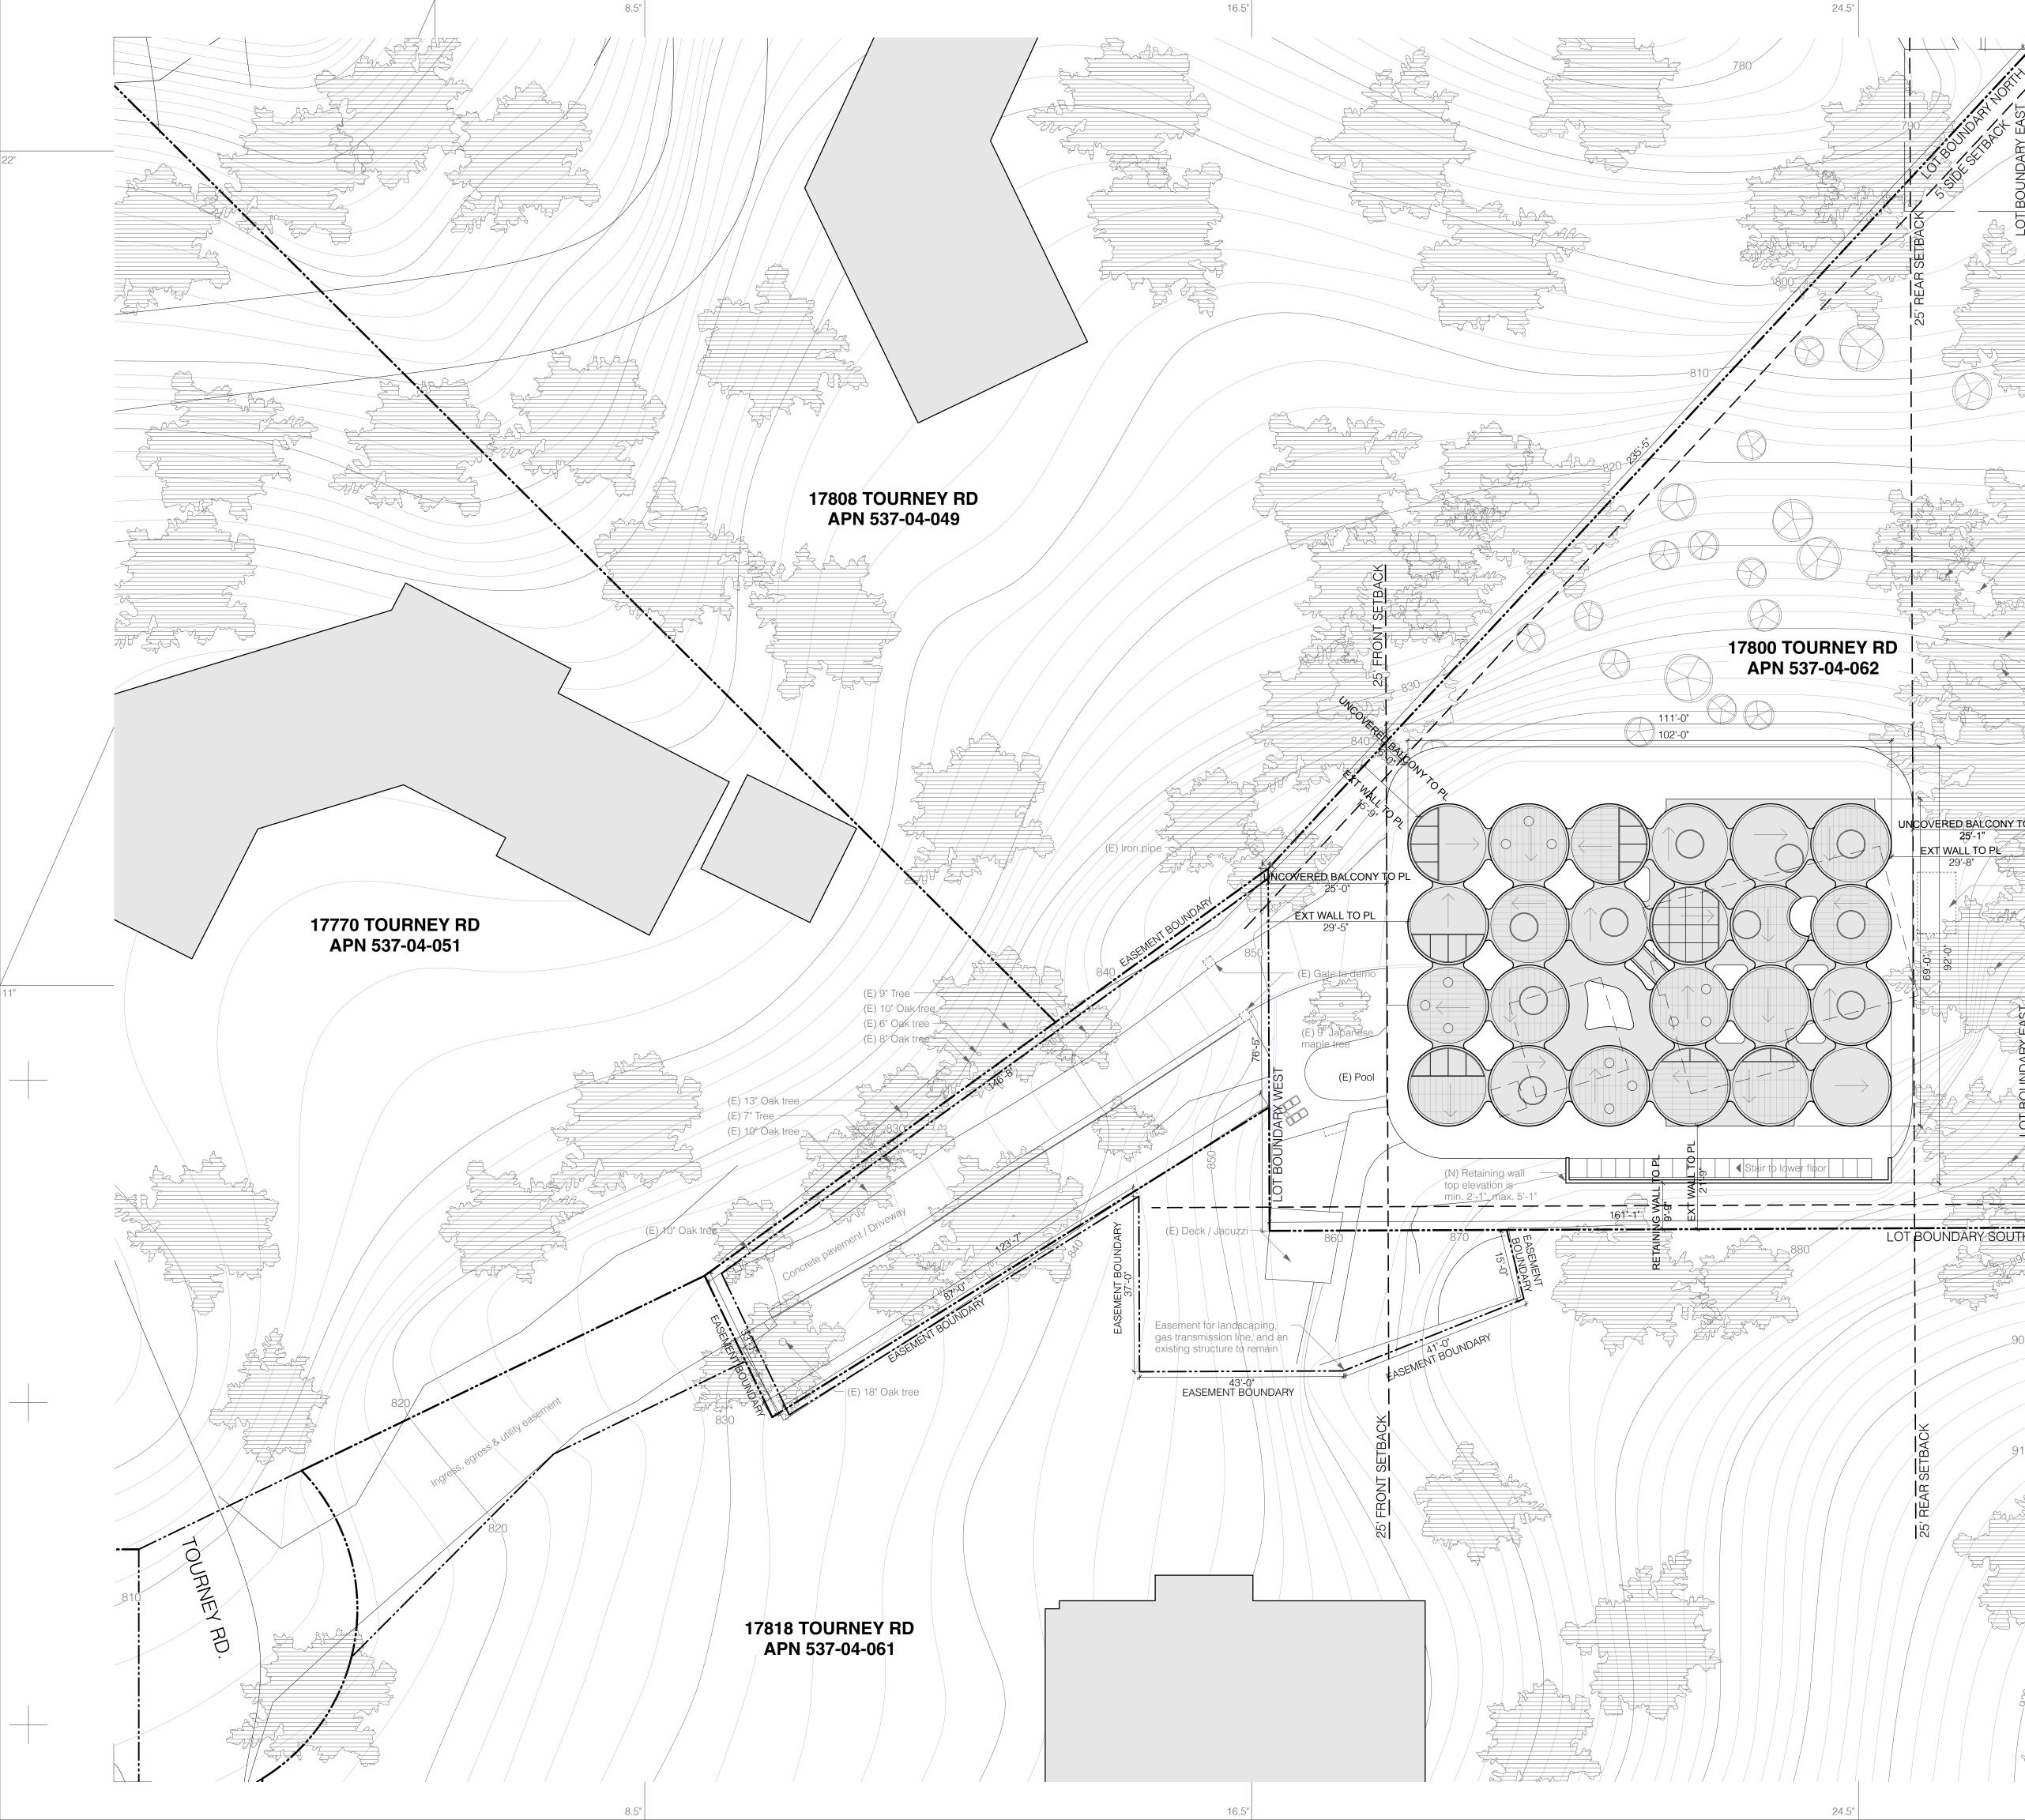

### 16870 QUARRY RD APN 532-27-007

30.25"

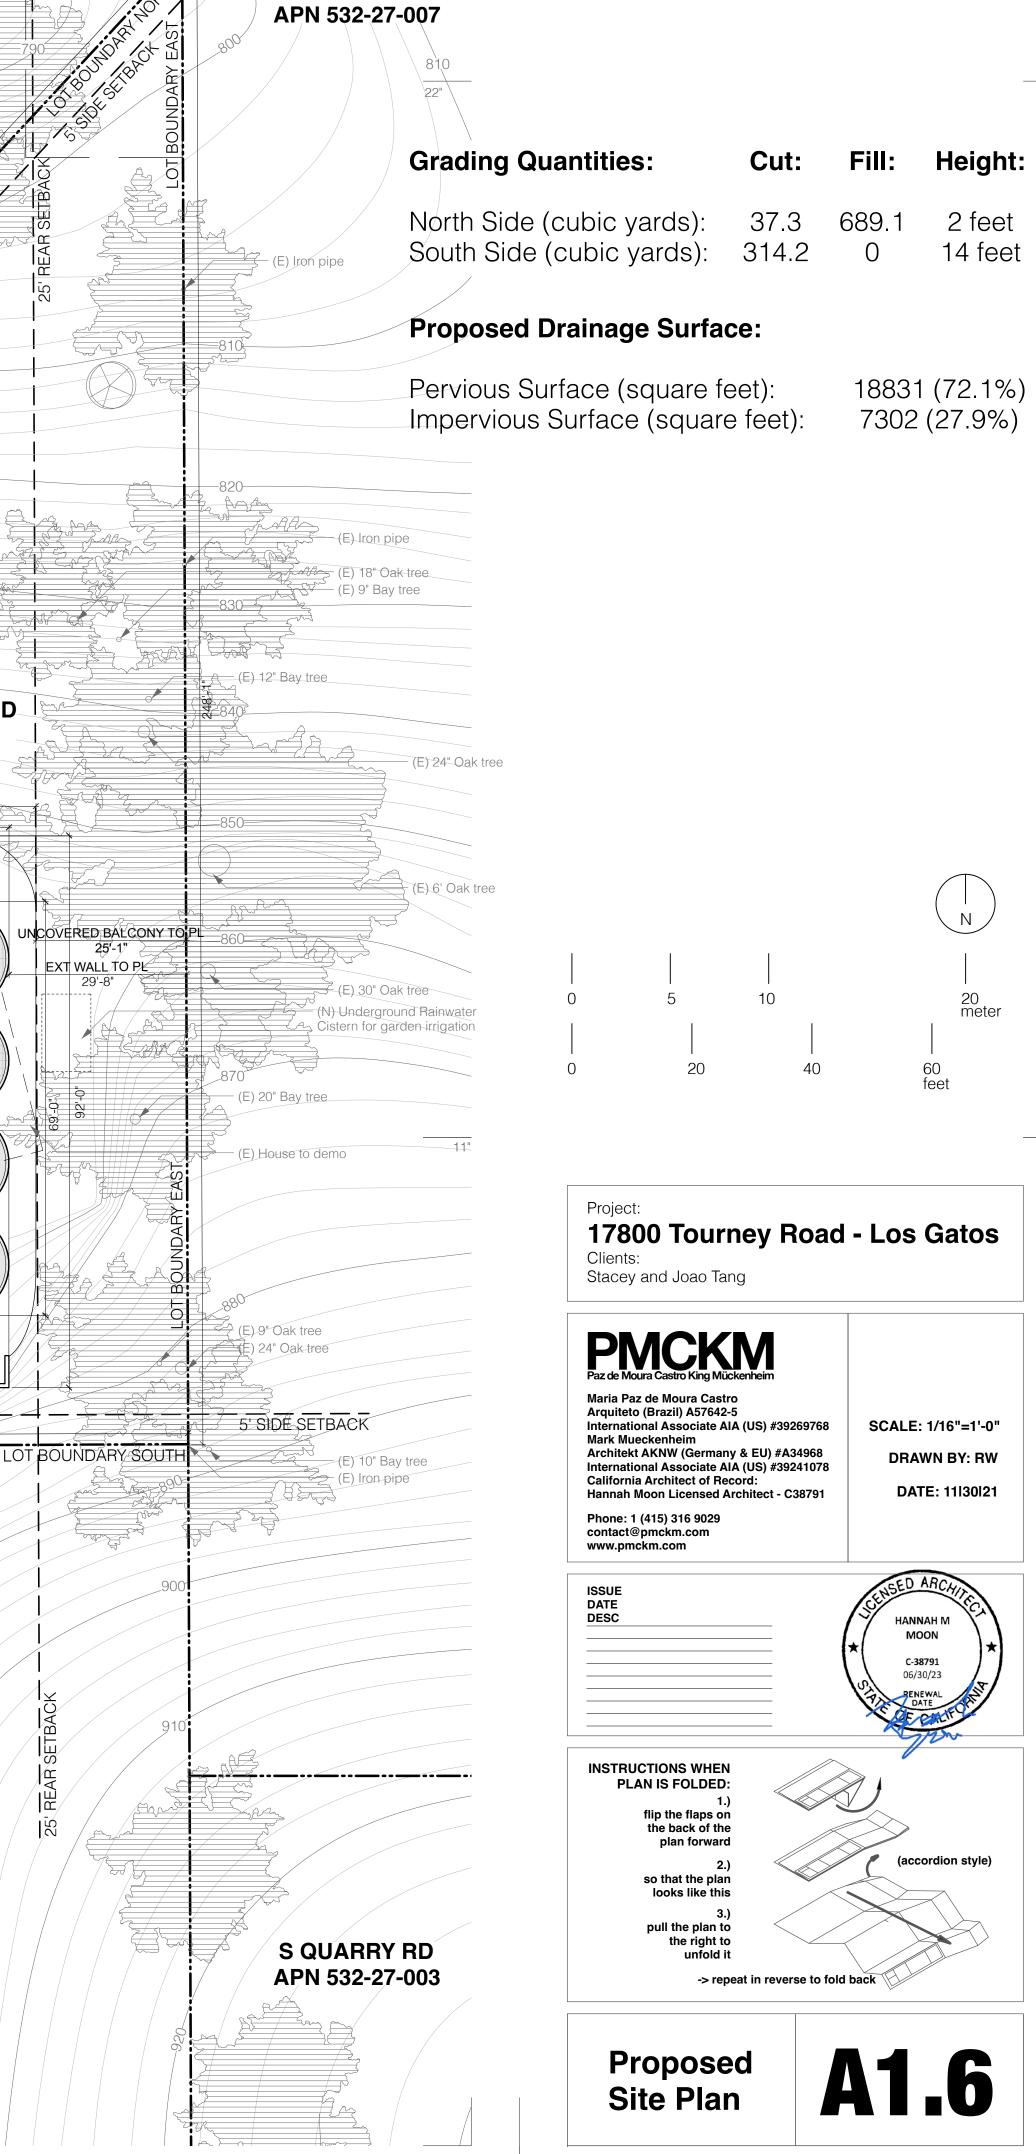

30.25"

36" & 24"

### **Total Tree Quantities:**

Trees to be removed: Trees to be relocated: 0

Proposed general ground cover: (E) Native area wild grasses Alternatives: Poa Secunda, Elymus Condensatus, Carex Spissa, Juncus Patens. Ground surface is underlain by geocell slope stabilization system.

(N) Scattered local drought resistant shrubs such as: Muhlenbergia rigens, Bougainvillea, or Caesalpinia pulcherrima

/(N) Elfin Thyme/Thymus serpyllum-or similar local drought resistant ground cover

(N) Underground Rainwater Cistern forgarden irrigation

Reflective pool with stepping stones-Concrete deck flush with the driveway

(N) Outdoor Kitchen-(N) Driveway permeable pavers-(N) California Fan Palm tree or similar-

local drought resistant tree (N) Wood deck-(E) Japanese Maple Tree -


(E) Pool change tiles (E) Gate to demo-

(E) Gutter

(E) Step to demo-(N) Retaining wall-

(N) Scattered local drought resistantshrubs such as: Muhlenbergia rigens, Bougainvillea, or Caesalpinia pulcherrima

(E) Jecuzzi to demo

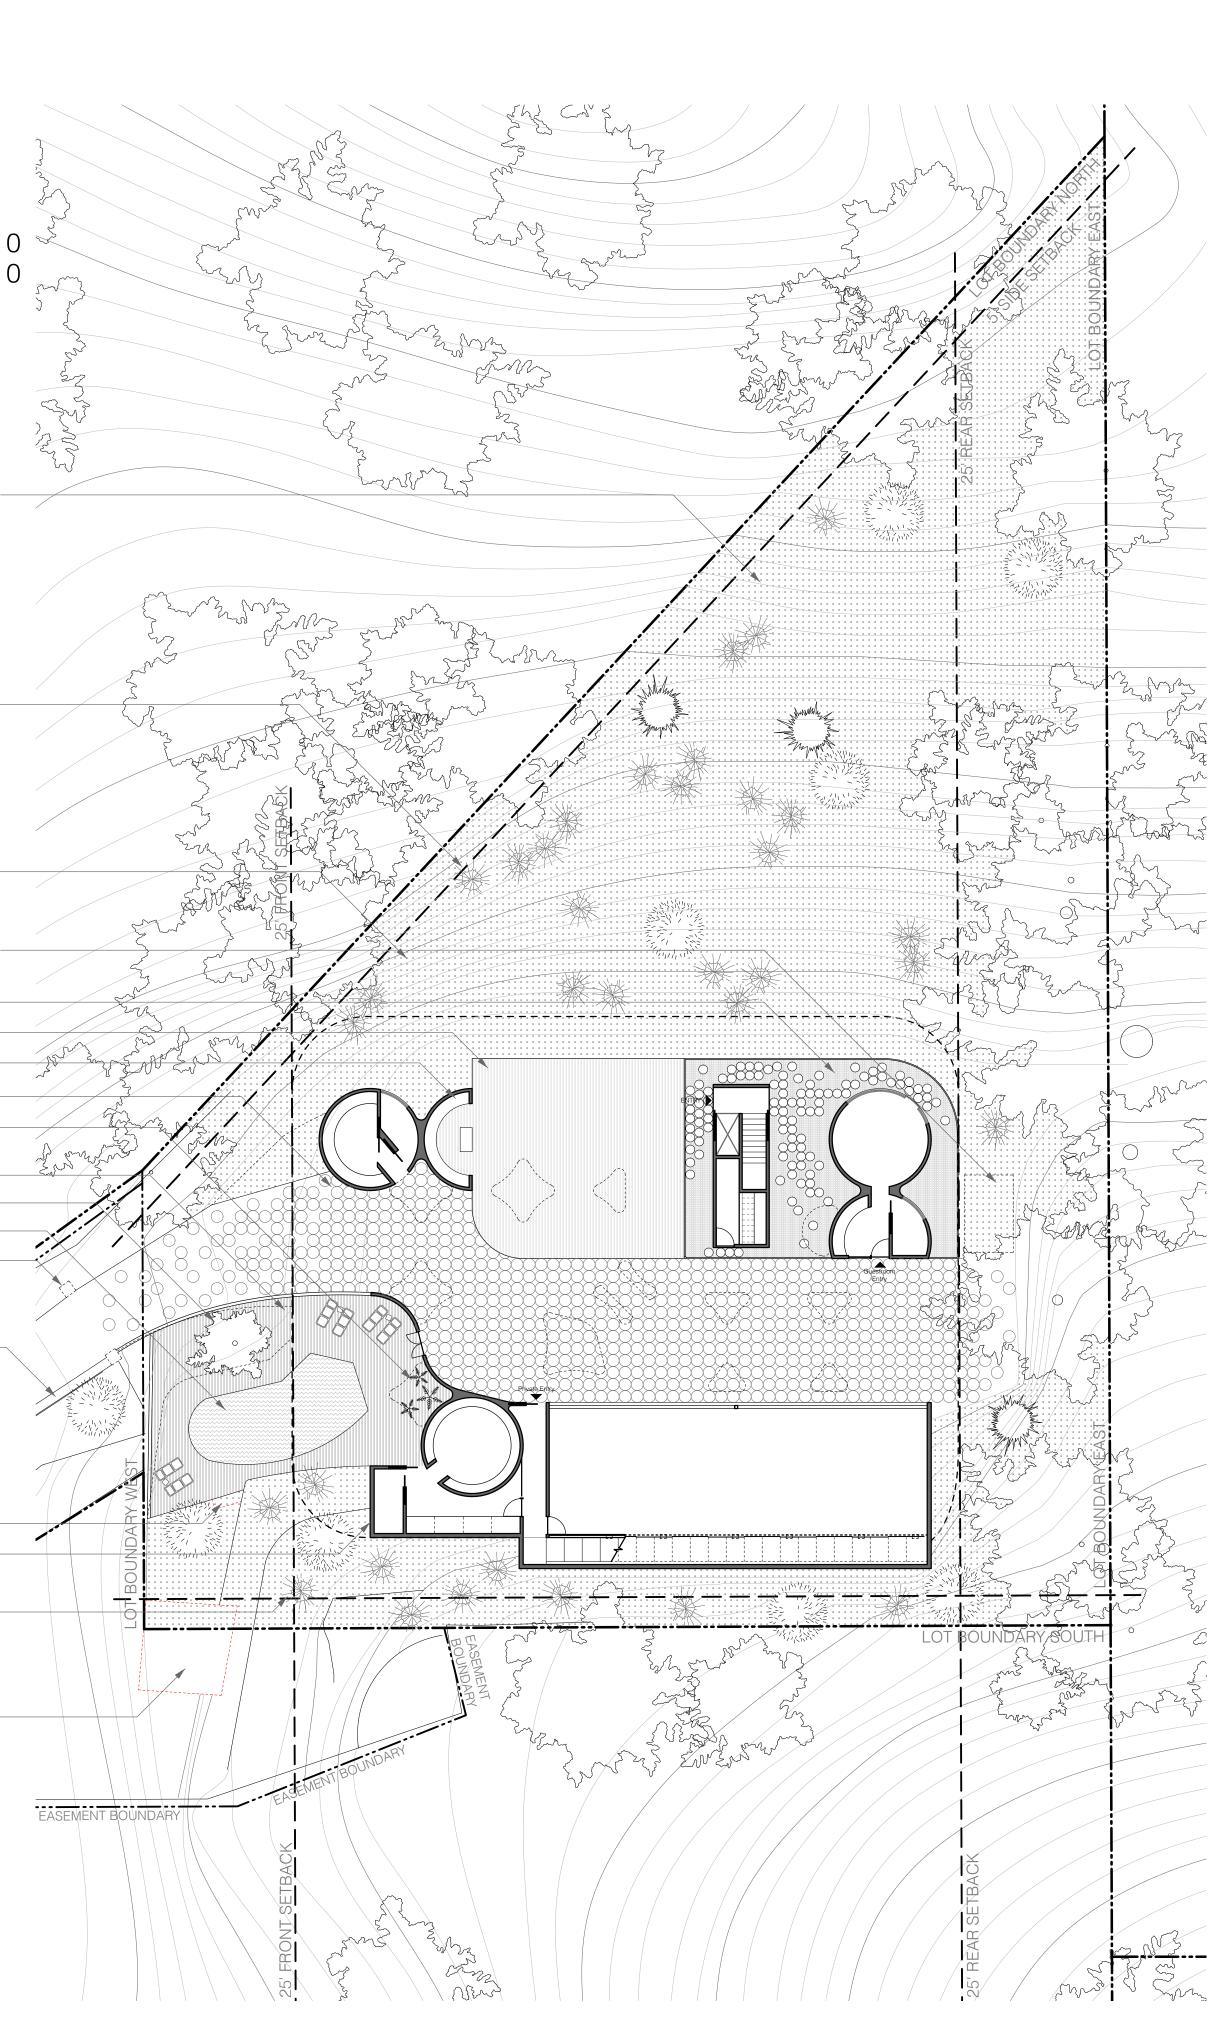

8.5"



### Muhlenbergia rigens

16.5"

Muhlenbergia rigens (Deergrass) is one of the most beautiful and probably the easiest to grow of all the native California bunchgrasses, typically reaching mature size in one or two years. It prefers sandy or gravelly soils, but does OK in almost any soil as long as it's well drained. It can handle fairly frequent summer water (up to 1x per week), but once mature, it really doesn't need any supplementary water. It prefers full sun or partial shade, but handles full shade reasonably well - it just grows more slowly.



Elfin Thyme/Thymus serpyllum

Primarily used as a ground cover, Thymus serpyllum 'Elfin (Creeping Thyme) is a dwarf, aromatic sub-shrub forming a tight cushion of tiny, rounded, grey-green leaves. This plant is poor soil, salt and drought tolerant.



Driveway Permeable Pavers

24-inch round concrete or similar pavestones with permeable paving in between. The dry-cast concrete stone offers durability and requires minimal base construction.



24.5"







30.25"

### Caesalpinia pulcherrima

Caesalpinia pulcherrima, also known as the Red Bird of Paradise, does well from the desert to the coast. Cold winter temperatures are the limiting factor. Poinciana is very drought tolerant and will do well with infrequent deep soakings. Caesalpinia pulcherrima will grow to 5-20 feet depending on growing conditions. The flowers attract butterflies such as the California Dogface Butterfly and Cloudless Sulfur.




### Bougainvillea 'California Gold'

One of the Bougainvillea varieties, 'California Gold' thrives in full sun or light shade, in acidic, well-drained soils. Bougainvillea tolerate hot, dry locations fairly well, but \_\_\_\_\_\_ dislike constantly wet soils.

### California Fan Palm

Also known as the Desert Fan Palm, the California Fan Palm (Washingtonia filifera) is perfect for dry climates. It needs a spot with full sun, but it will tolerate a variety of soils and salt along the ocean coast. As a desert palm, this grand tree will thrive in any dry to semi-dry climate, and even at elevations up to 4,000 feet.

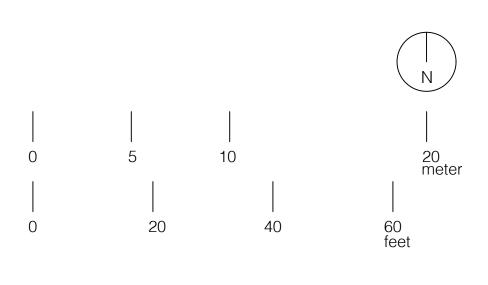

36" & 24"

### Project: 17800 Tourney Road - Los Gatos Clients:

Stacey and Joao Tang

### PACKEN Paz de Moura Castro King Mückenheim

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INSTRUCTIONS WHEN PLAN IS FOLDED: 1.) flip the flaps on the back of the plan forward

> so that the plan looks like this 3.) pull the plan to

the right to unfold it

(accordion style)

-> repeat in reverse to





SCALE: 1/16"=1'-0"


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DATE: 11|30|21

HANNAH N


C-38791

MOON



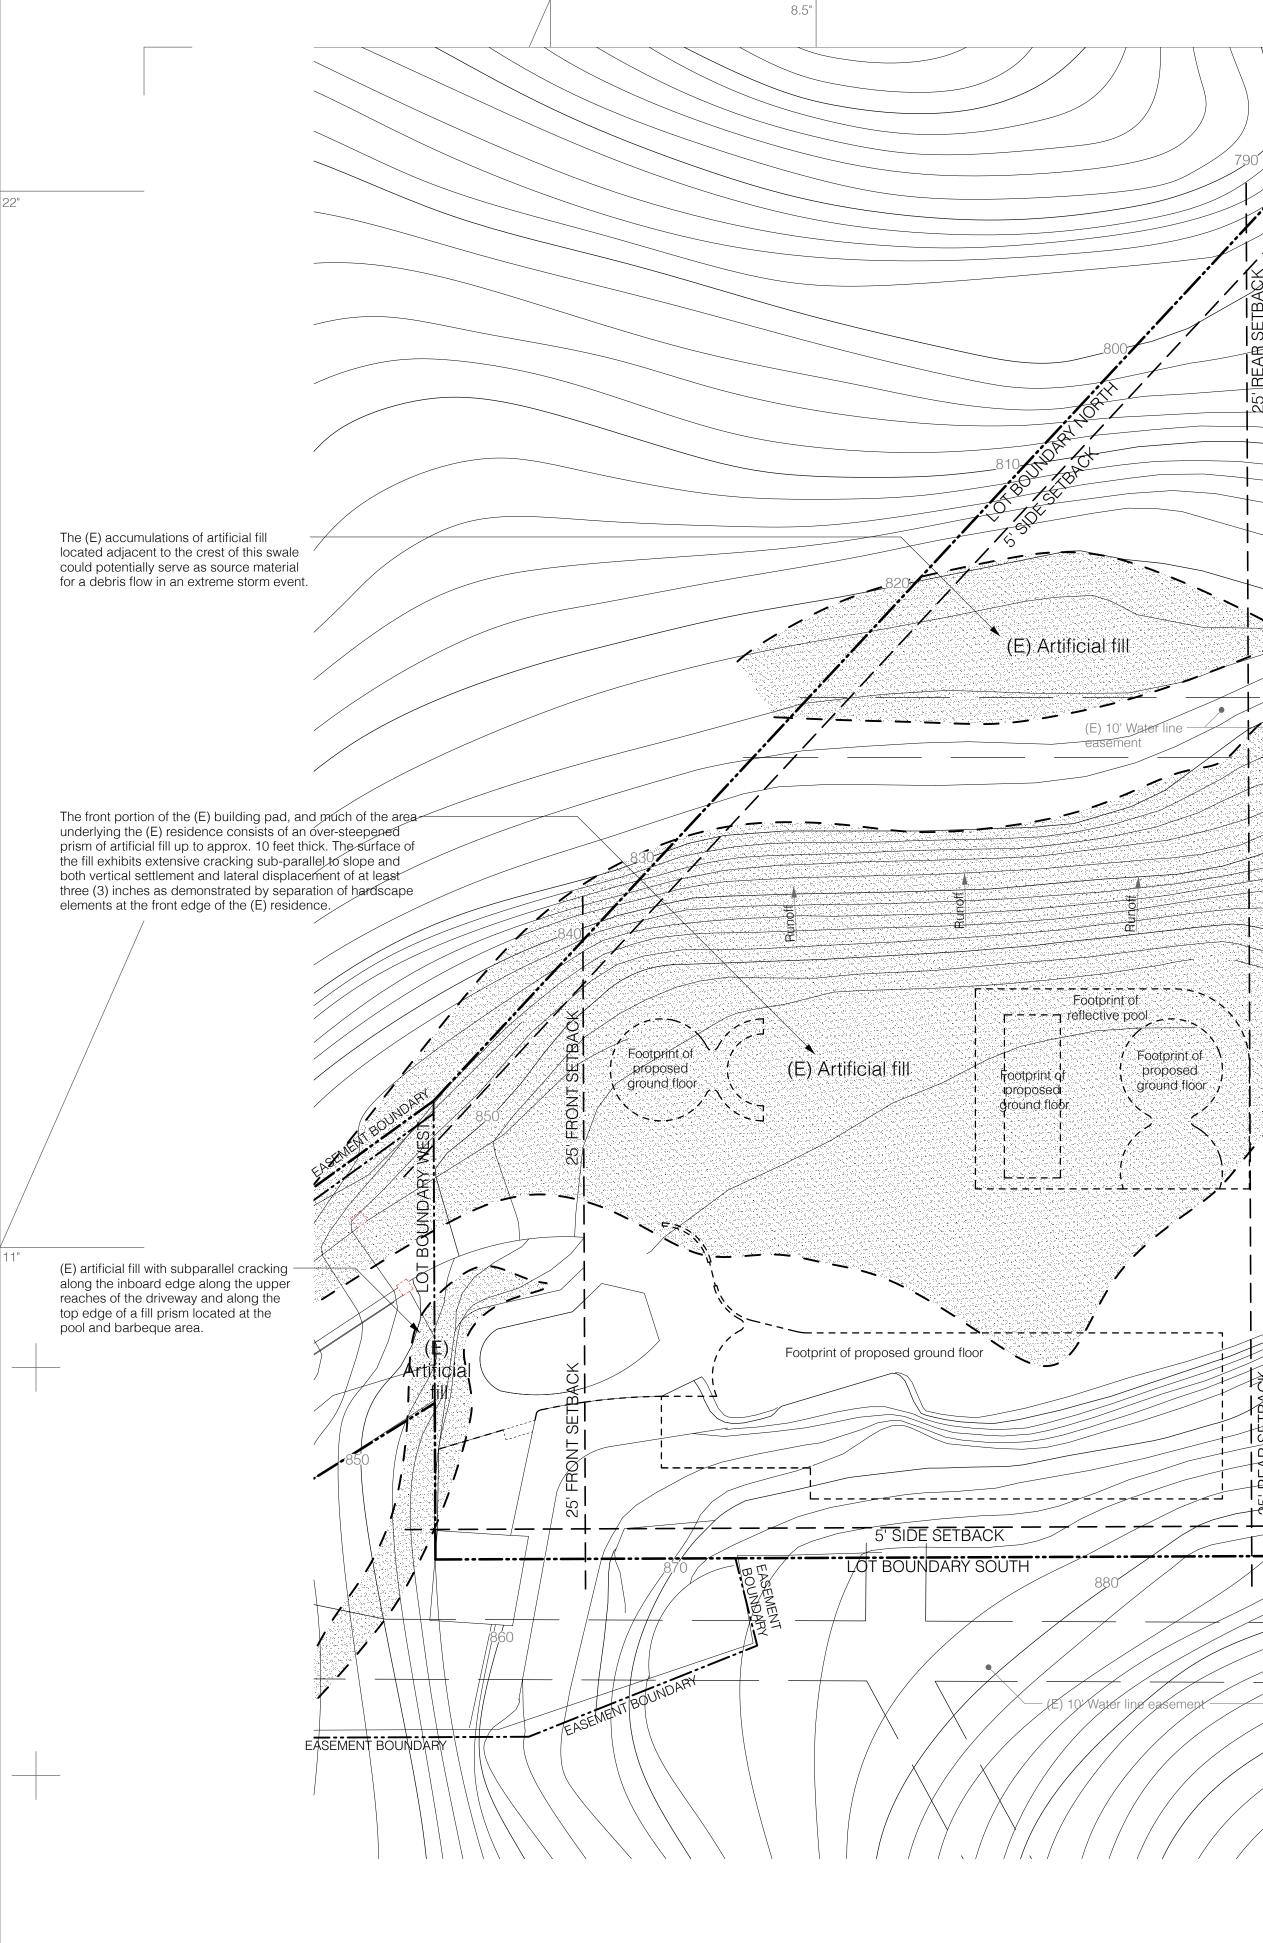



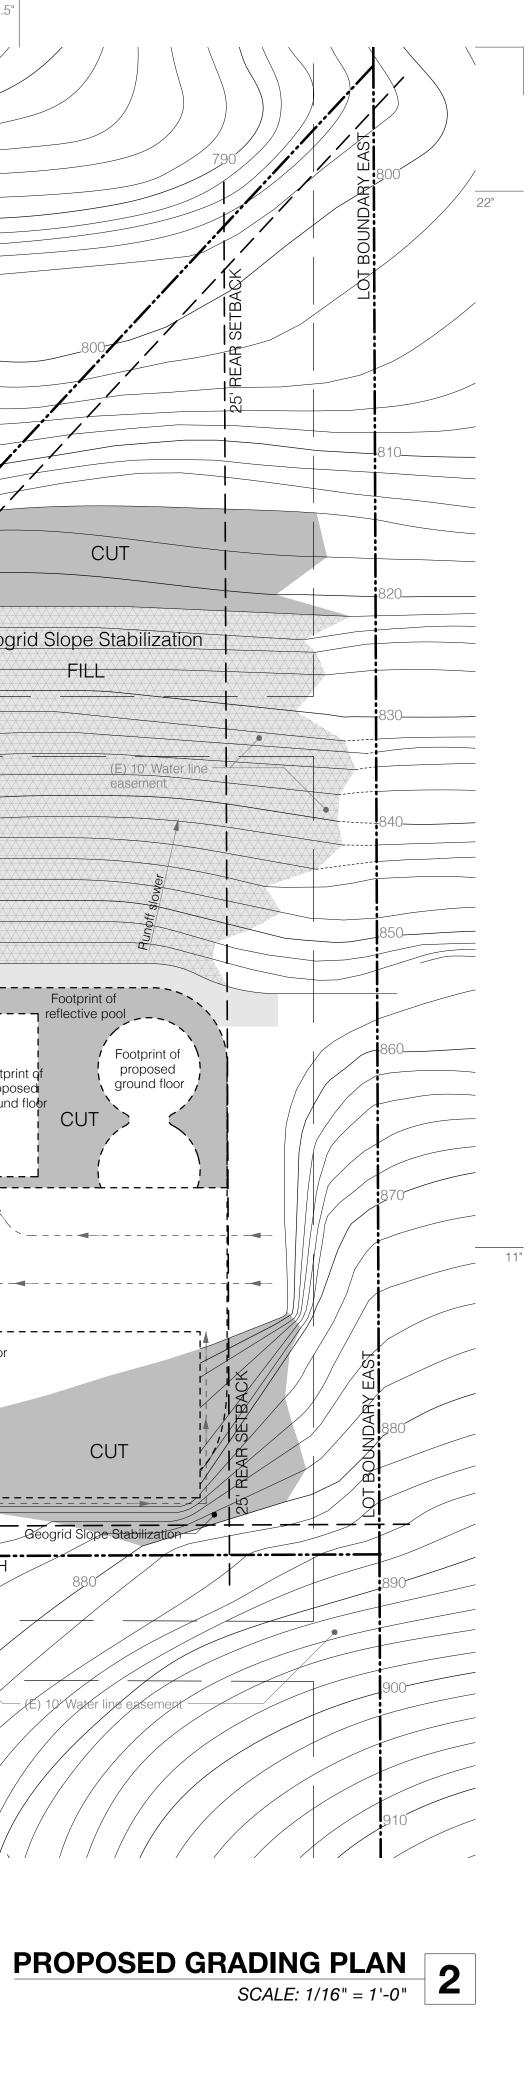

### Grading Quantities:

North Side (cubic yards): South Side (cubic yards):

37.3

314.2

689.1

0

2 feet


14 feet


30.25



# 20 meter

36" & 24"

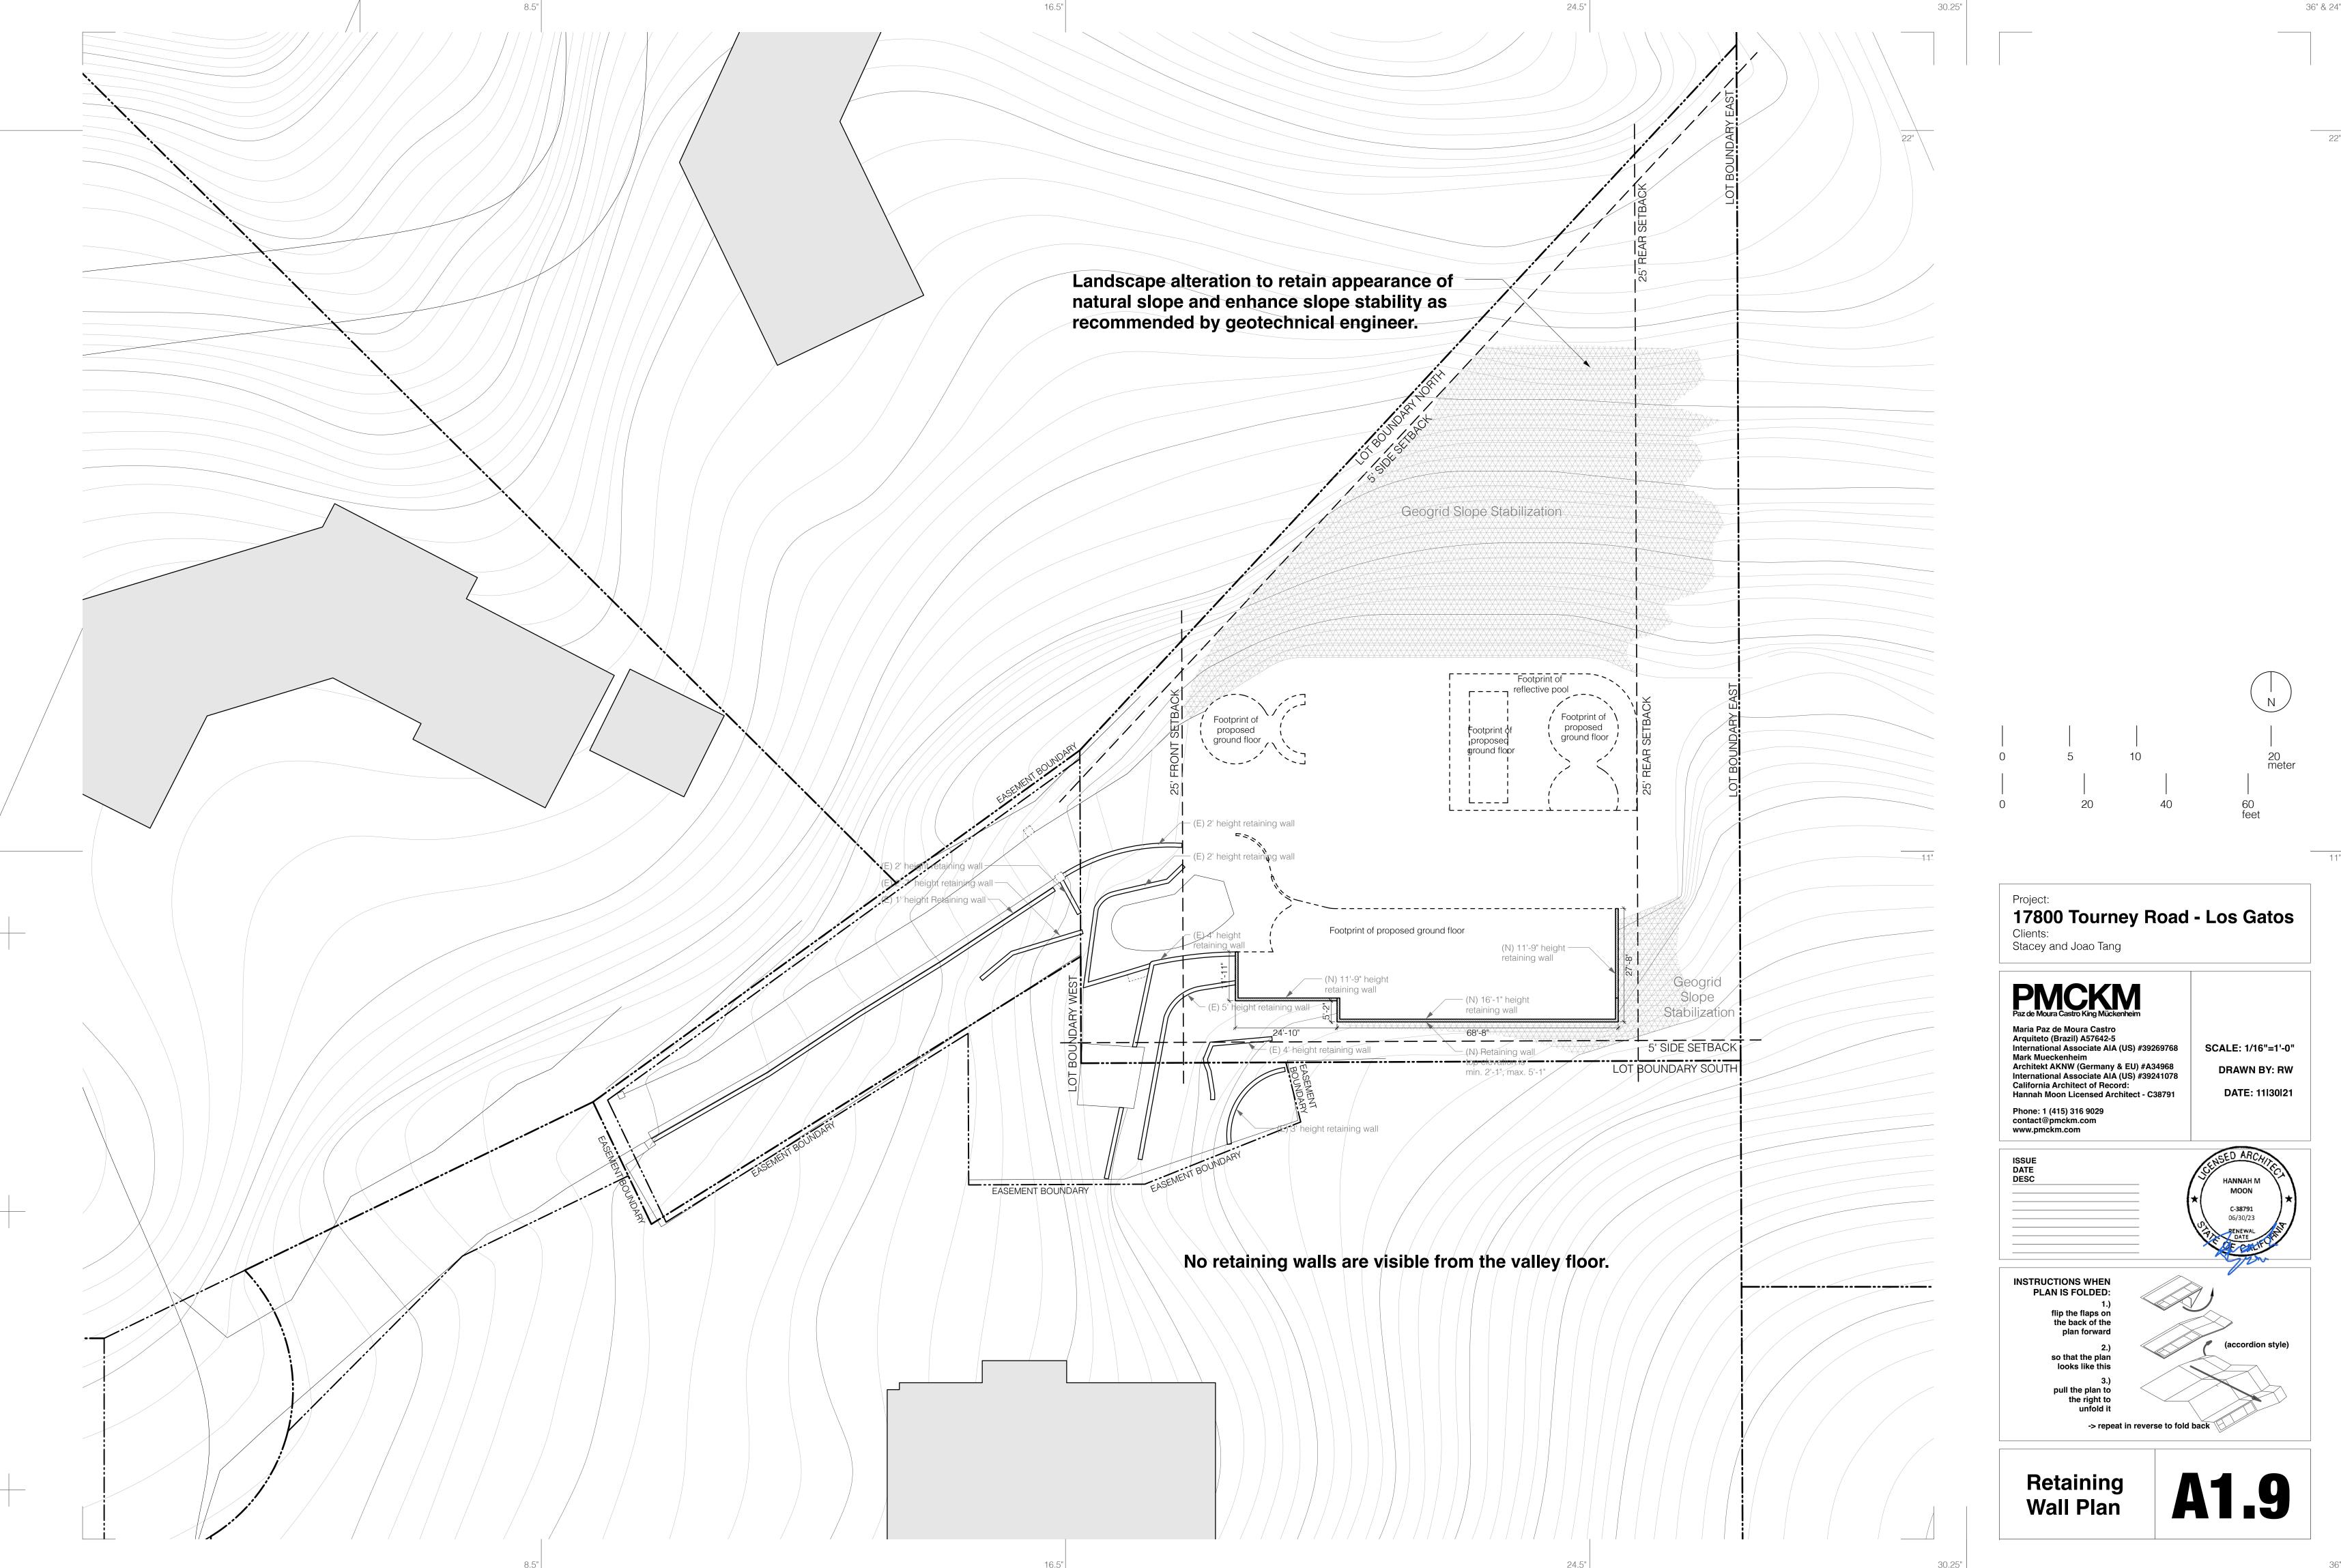

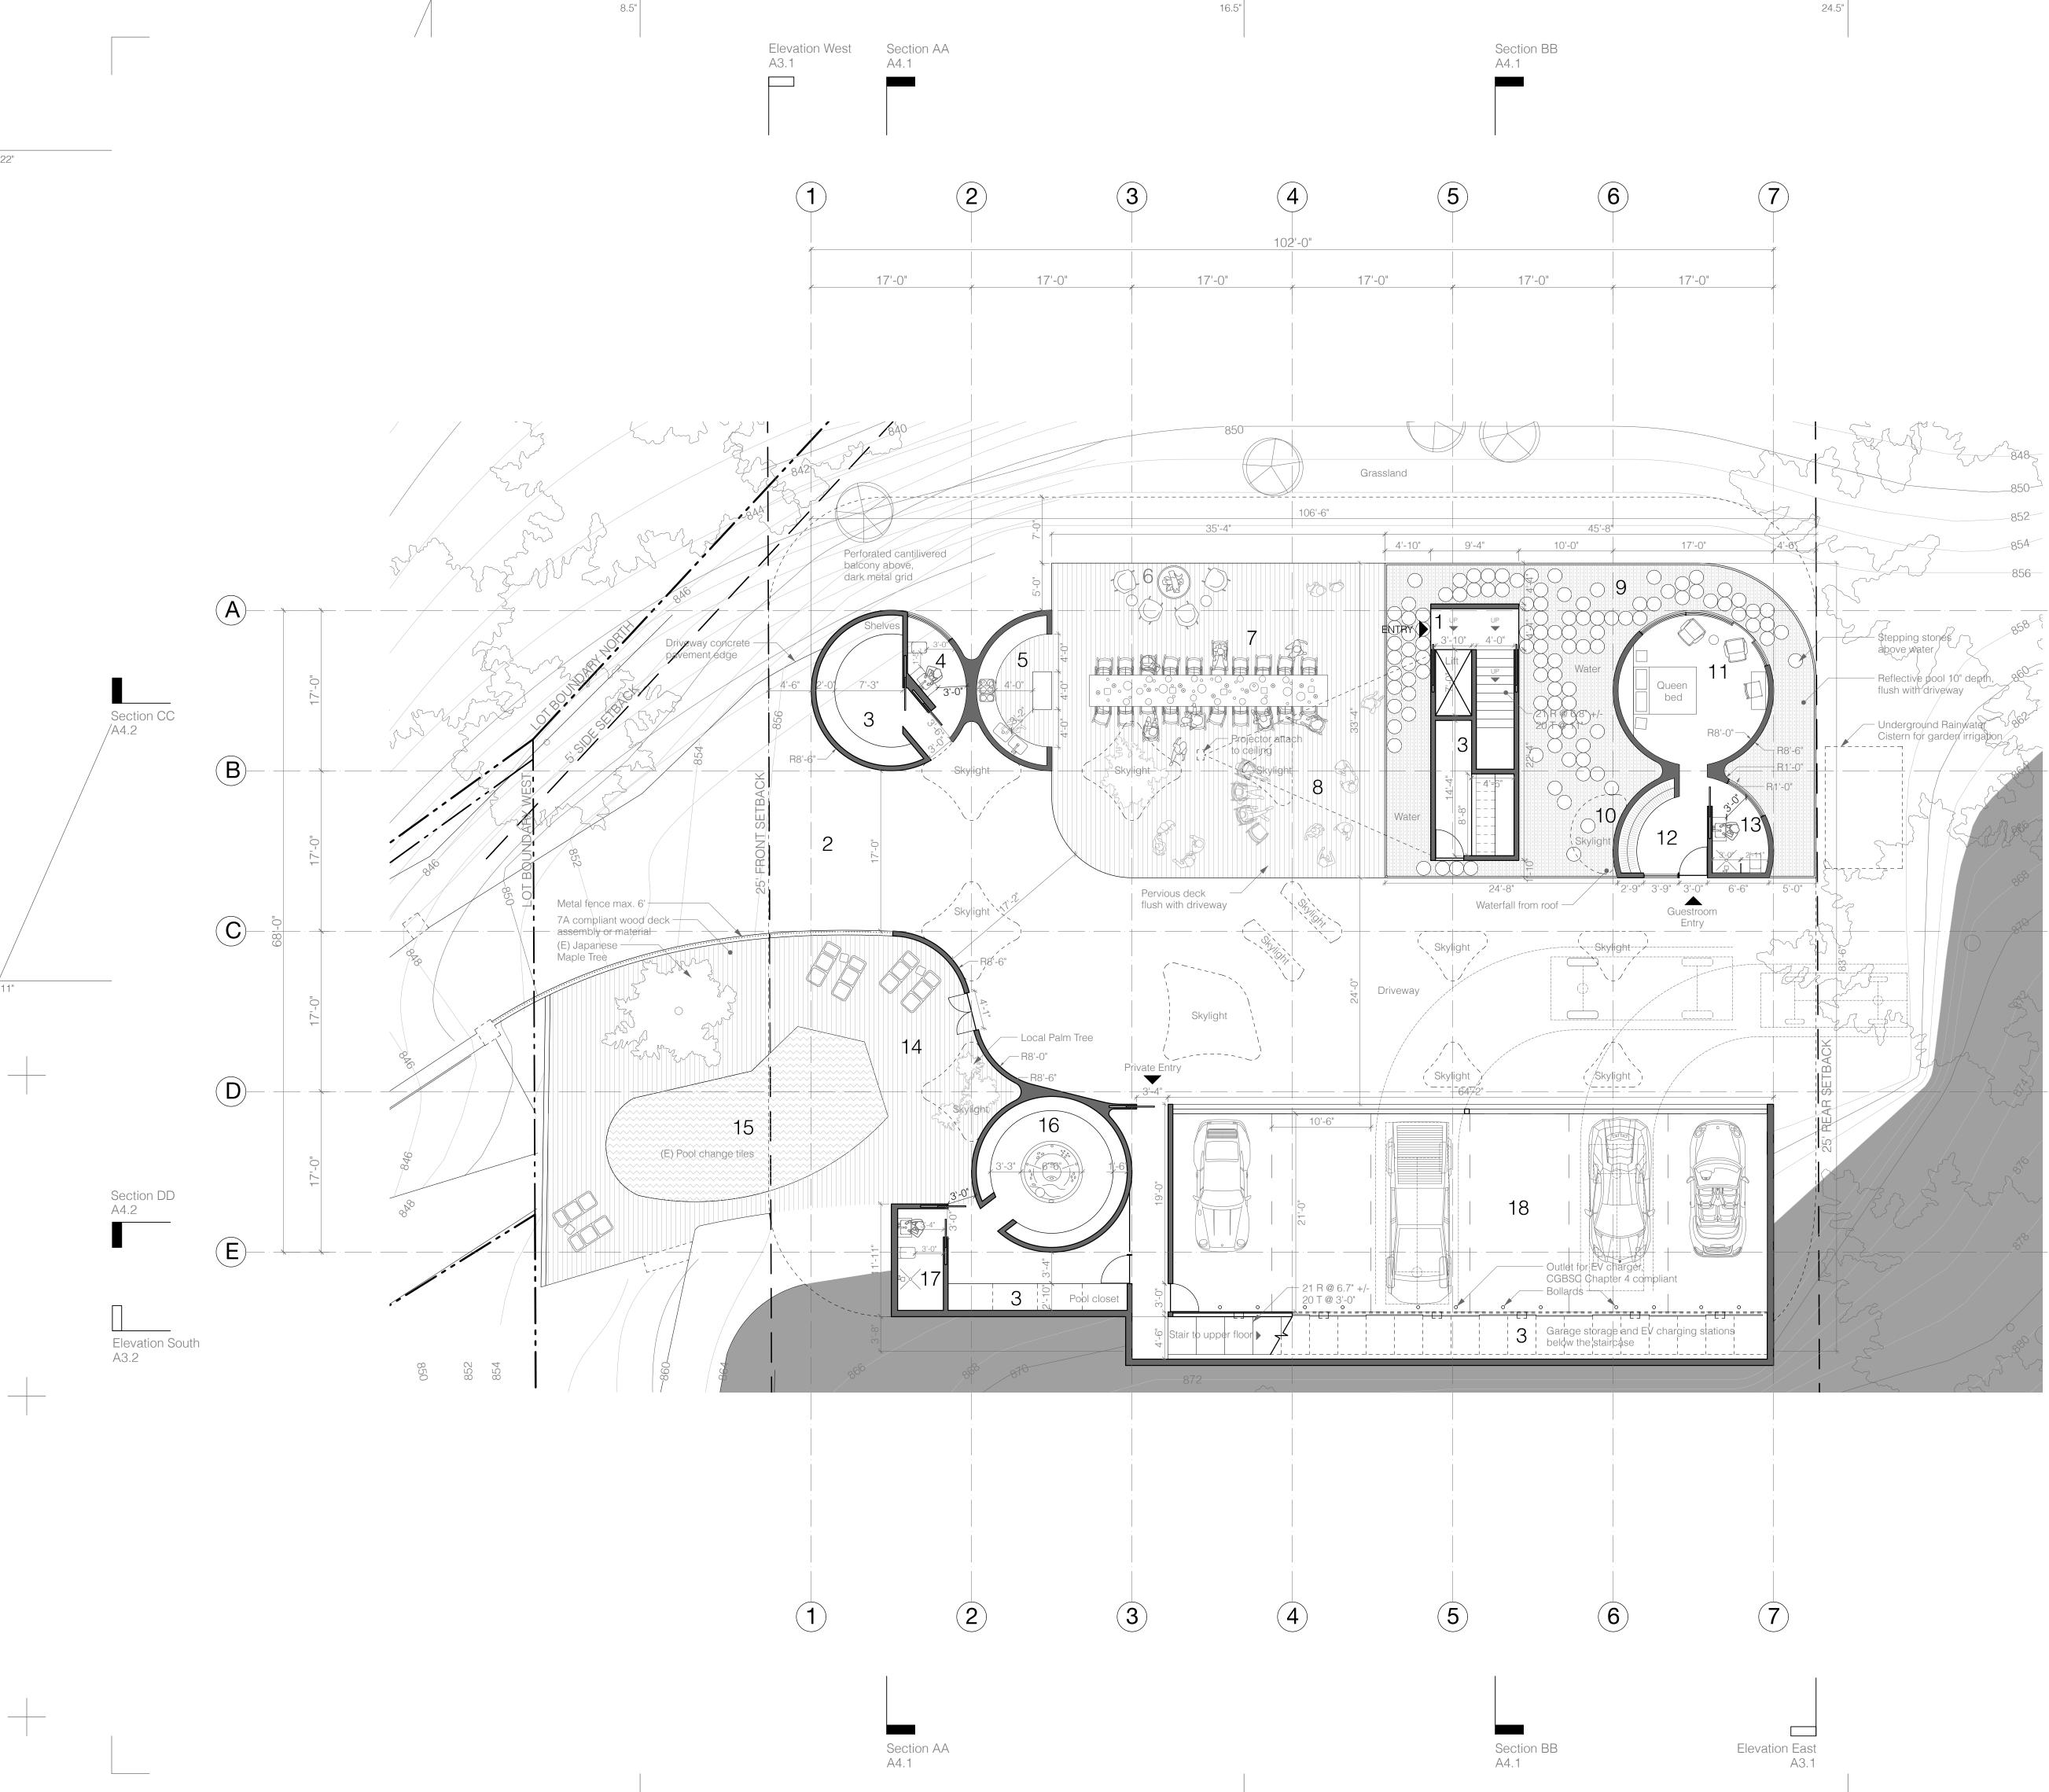

36" & 24" 30.25" Entry Lobby Car Entrance Storage 22" Half Bathroom Outdoor Kitchen Outdoor Fire Pit Outdoor Dining Outdoor Theater **Reflective Pool** Q Water Fall 10 Bedroom 11 Closet 12 Bathroom 13 Deck 14 Existing Pool 15 Float Pool 16 Pool Shower Room 17 A3.2 6 Car Garage 18 Living Room 19 Fire Place 20 Wet Bar 21 Kitchen 22 Dining 23 24 Laundry Office 25 Exercise Room 26 Family/TV Room 27 Section CC A4.2 Uncovered Balcony 28 2,5 meter 11" Project: 17800 Tourney Road - Los Gatos Clients: Stacey and Joao Tang PAZ de Moura Castro King Mückenheim Maria Paz de Moura Castro Arquiteto (Brazil) A57642-5 International Associate AIA (US) #39269768 SCALE: 1/8"=1'-0" A4.2 Mark Mueckenheim Architekt AKNW (Germany & EU) #A34968 DRAWN BY: RW International Associate AIA (US) #39241078 California Architect of Record: DATE: 11|30|21 Hannah Moon Licensed Architect - C38791 Phone: 1 (415) 316 9029 contact@pmckm.com www.pmckm.com ISSUE DATE DESC HANNAH N MOON C-38791 06/30/23 INSTRUCTIONS WHEN PLAN IS FOLDED: 1.) flip the flaps on the back of the plan forward (accordion style) 2.) so that the plan looks like this 3.) pull the plan to the right to unfold it -> repeat in reverse to fold back Proposed **A2.1** Ground Floor Plan


















30.25

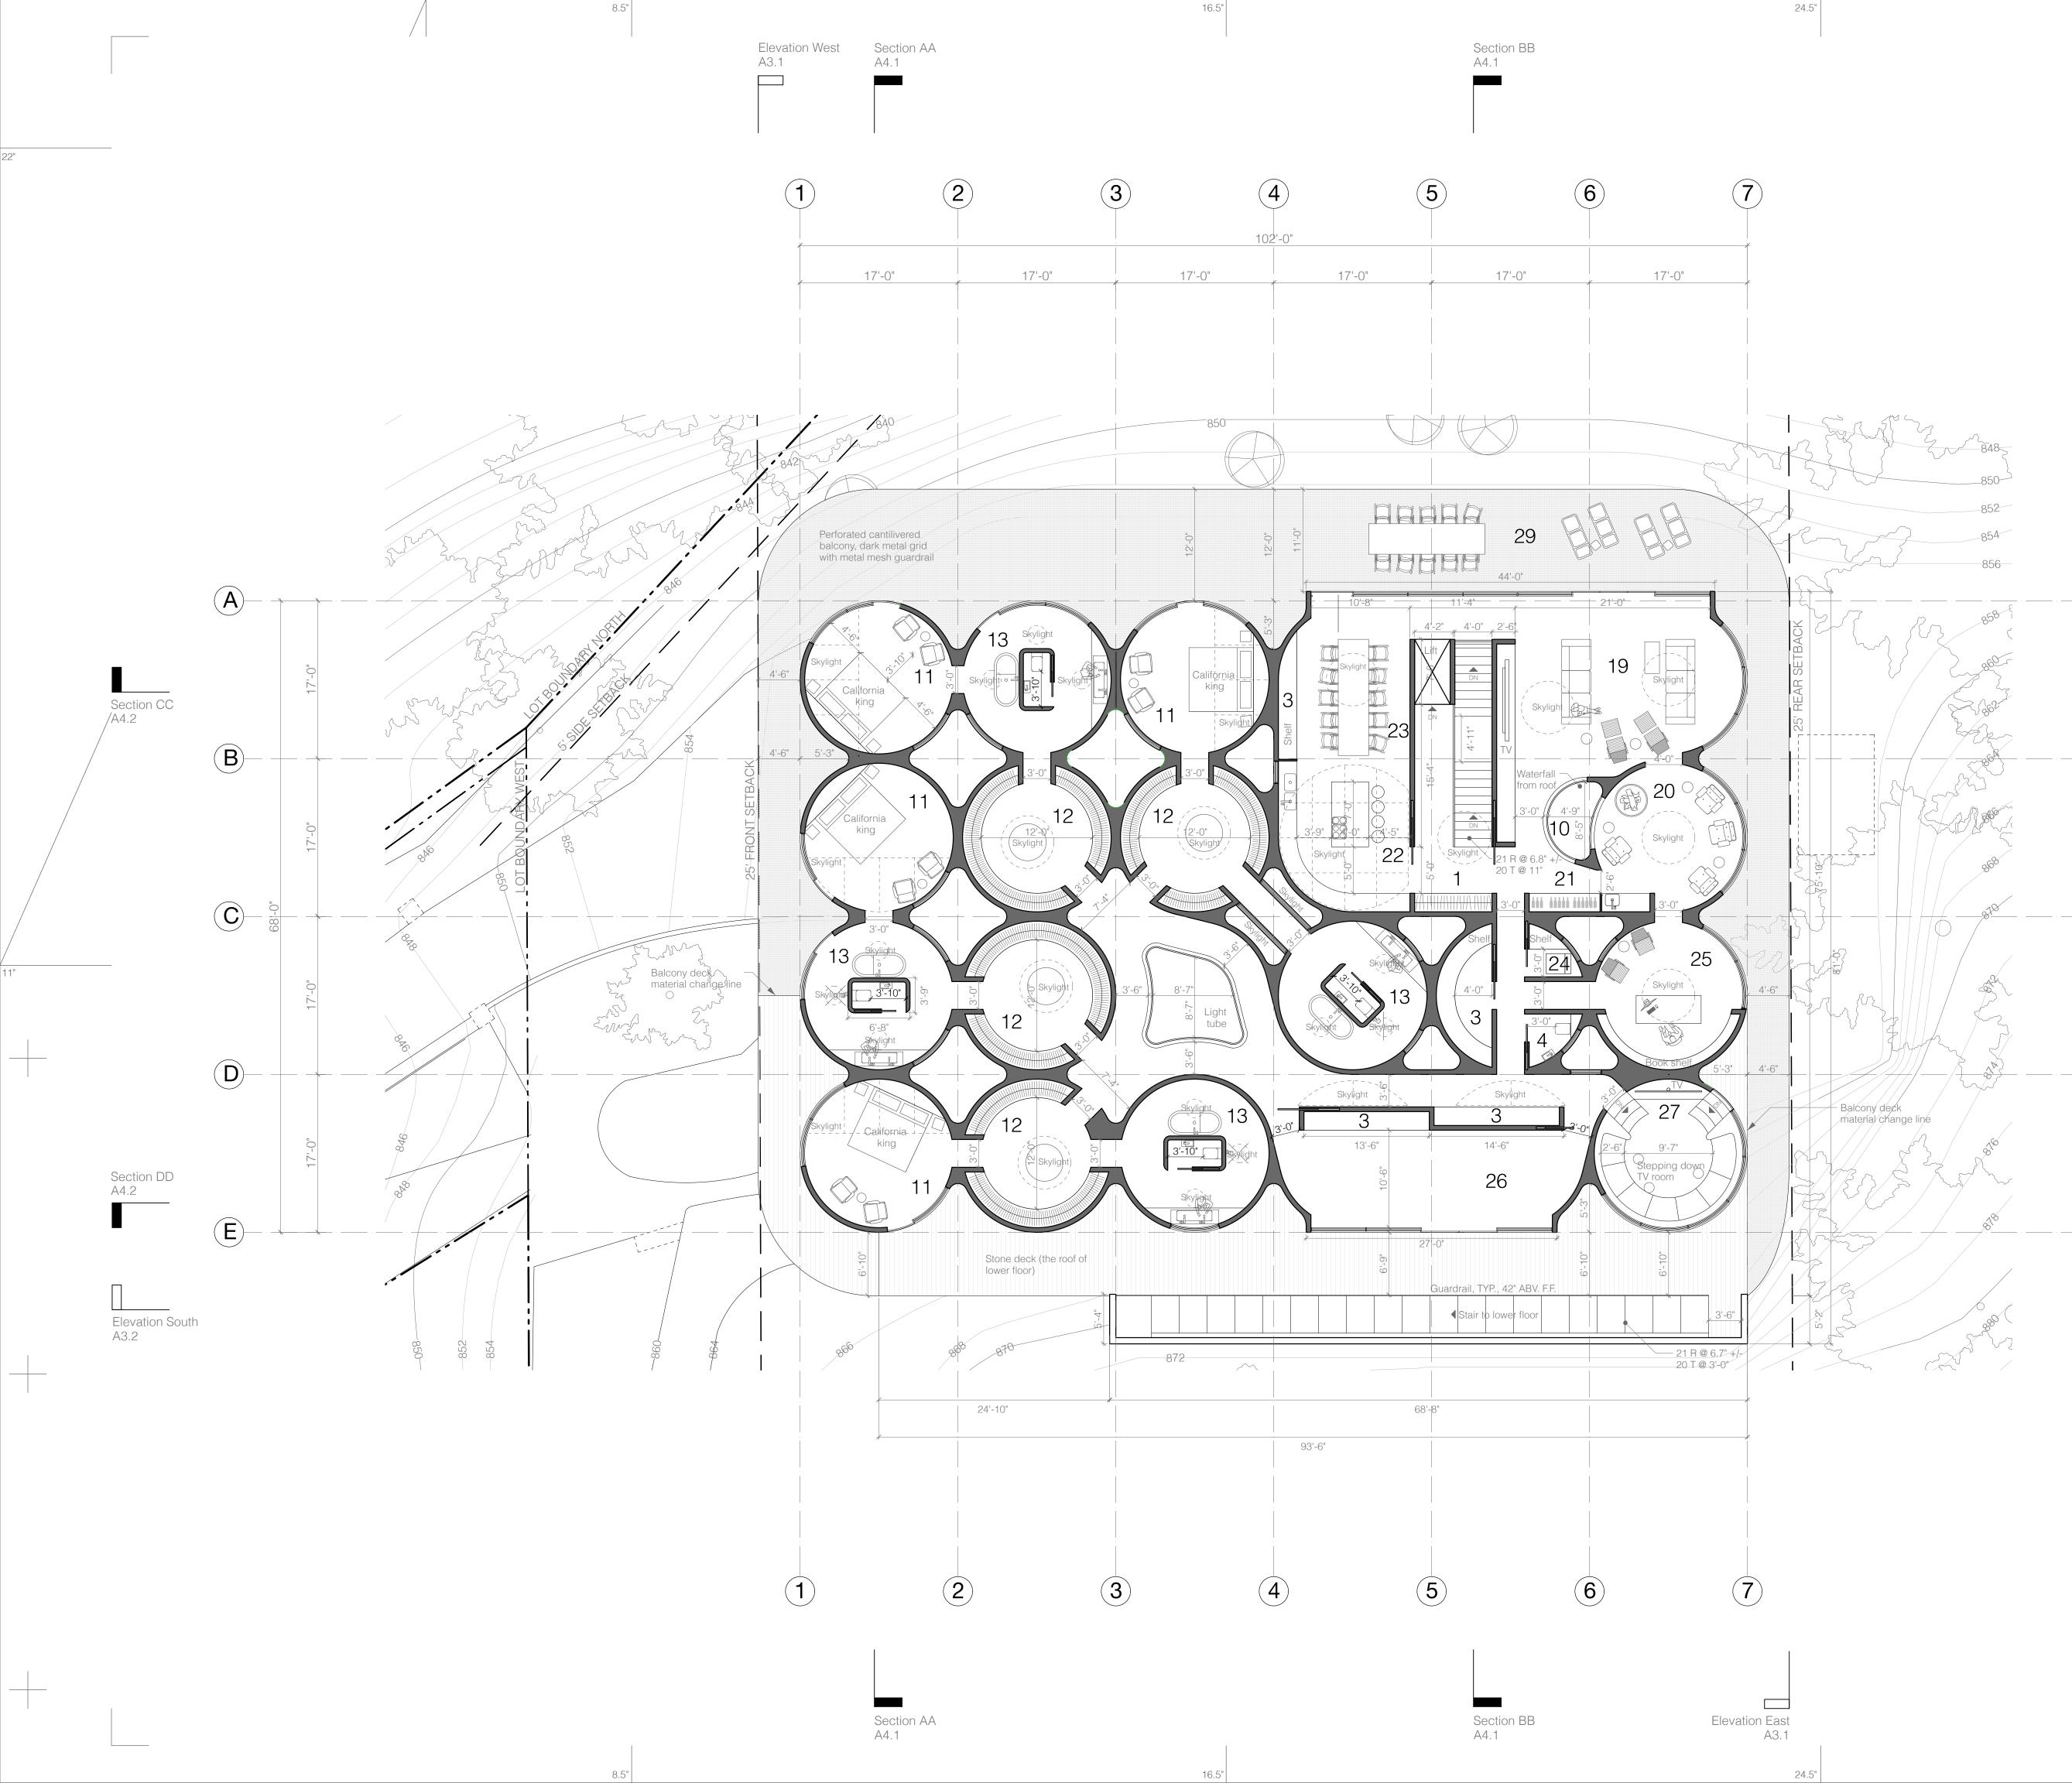

36" & 24" 30.25" Entry Lobby Car Entrance Storage 22" Half Bathroom Outdoor Kitchen Outdoor Fire Pit Outdoor Dining Outdoor Theater **Reflective Pool** 9 Water Fall 10 Bedroom 11 Closet 12 Bathroom 13 Deck 14 Existing Pool 15 Float Pool 16 Pool Shower Room 17 A3.2 6 Car Garage 18 Living Room 19 Fire Place 20 Wet Bar 21 22 Kitchen Dining 23 24 Laundry Office 25 Exercise Room 26 Family/TV Room 27 Uncovered Balcony 28 2,5 10 meter 11" Project: 17800 Tourney Road - Los Gatos Clients: Stacey and Joao Tang PAZ de Moura Castro King Mückenheim Maria Paz de Moura Castro Arquiteto (Brazil) A57642-5 International Associate AIA (US) #39269768 SCALE: 1/8"=1'-0" A4.2 Mark Mueckenheim Architekt AKNW (Germany & EU) #A34968 DRAWN BY: RW International Associate AIA (US) #39241078 California Architect of Record: DATE: 11130121 Hannah Moon Licensed Architect - C38791 Phone: 1 (415) 316 9029 contact@pmckm.com www.pmckm.com ISSUE DATE DESC HANNAH N MOON C-38791 06/30/23 INSTRUCTIONS WHEN PLAN IS FOLDED: 1.) flip the flaps on the back of the plan forward (accordion style) 2.) so that the plan looks like this 3.) pull the plan to the right to unfold it -> repeat in reverse to fold back Proposed **A2.2** Second Floor Plan


22"






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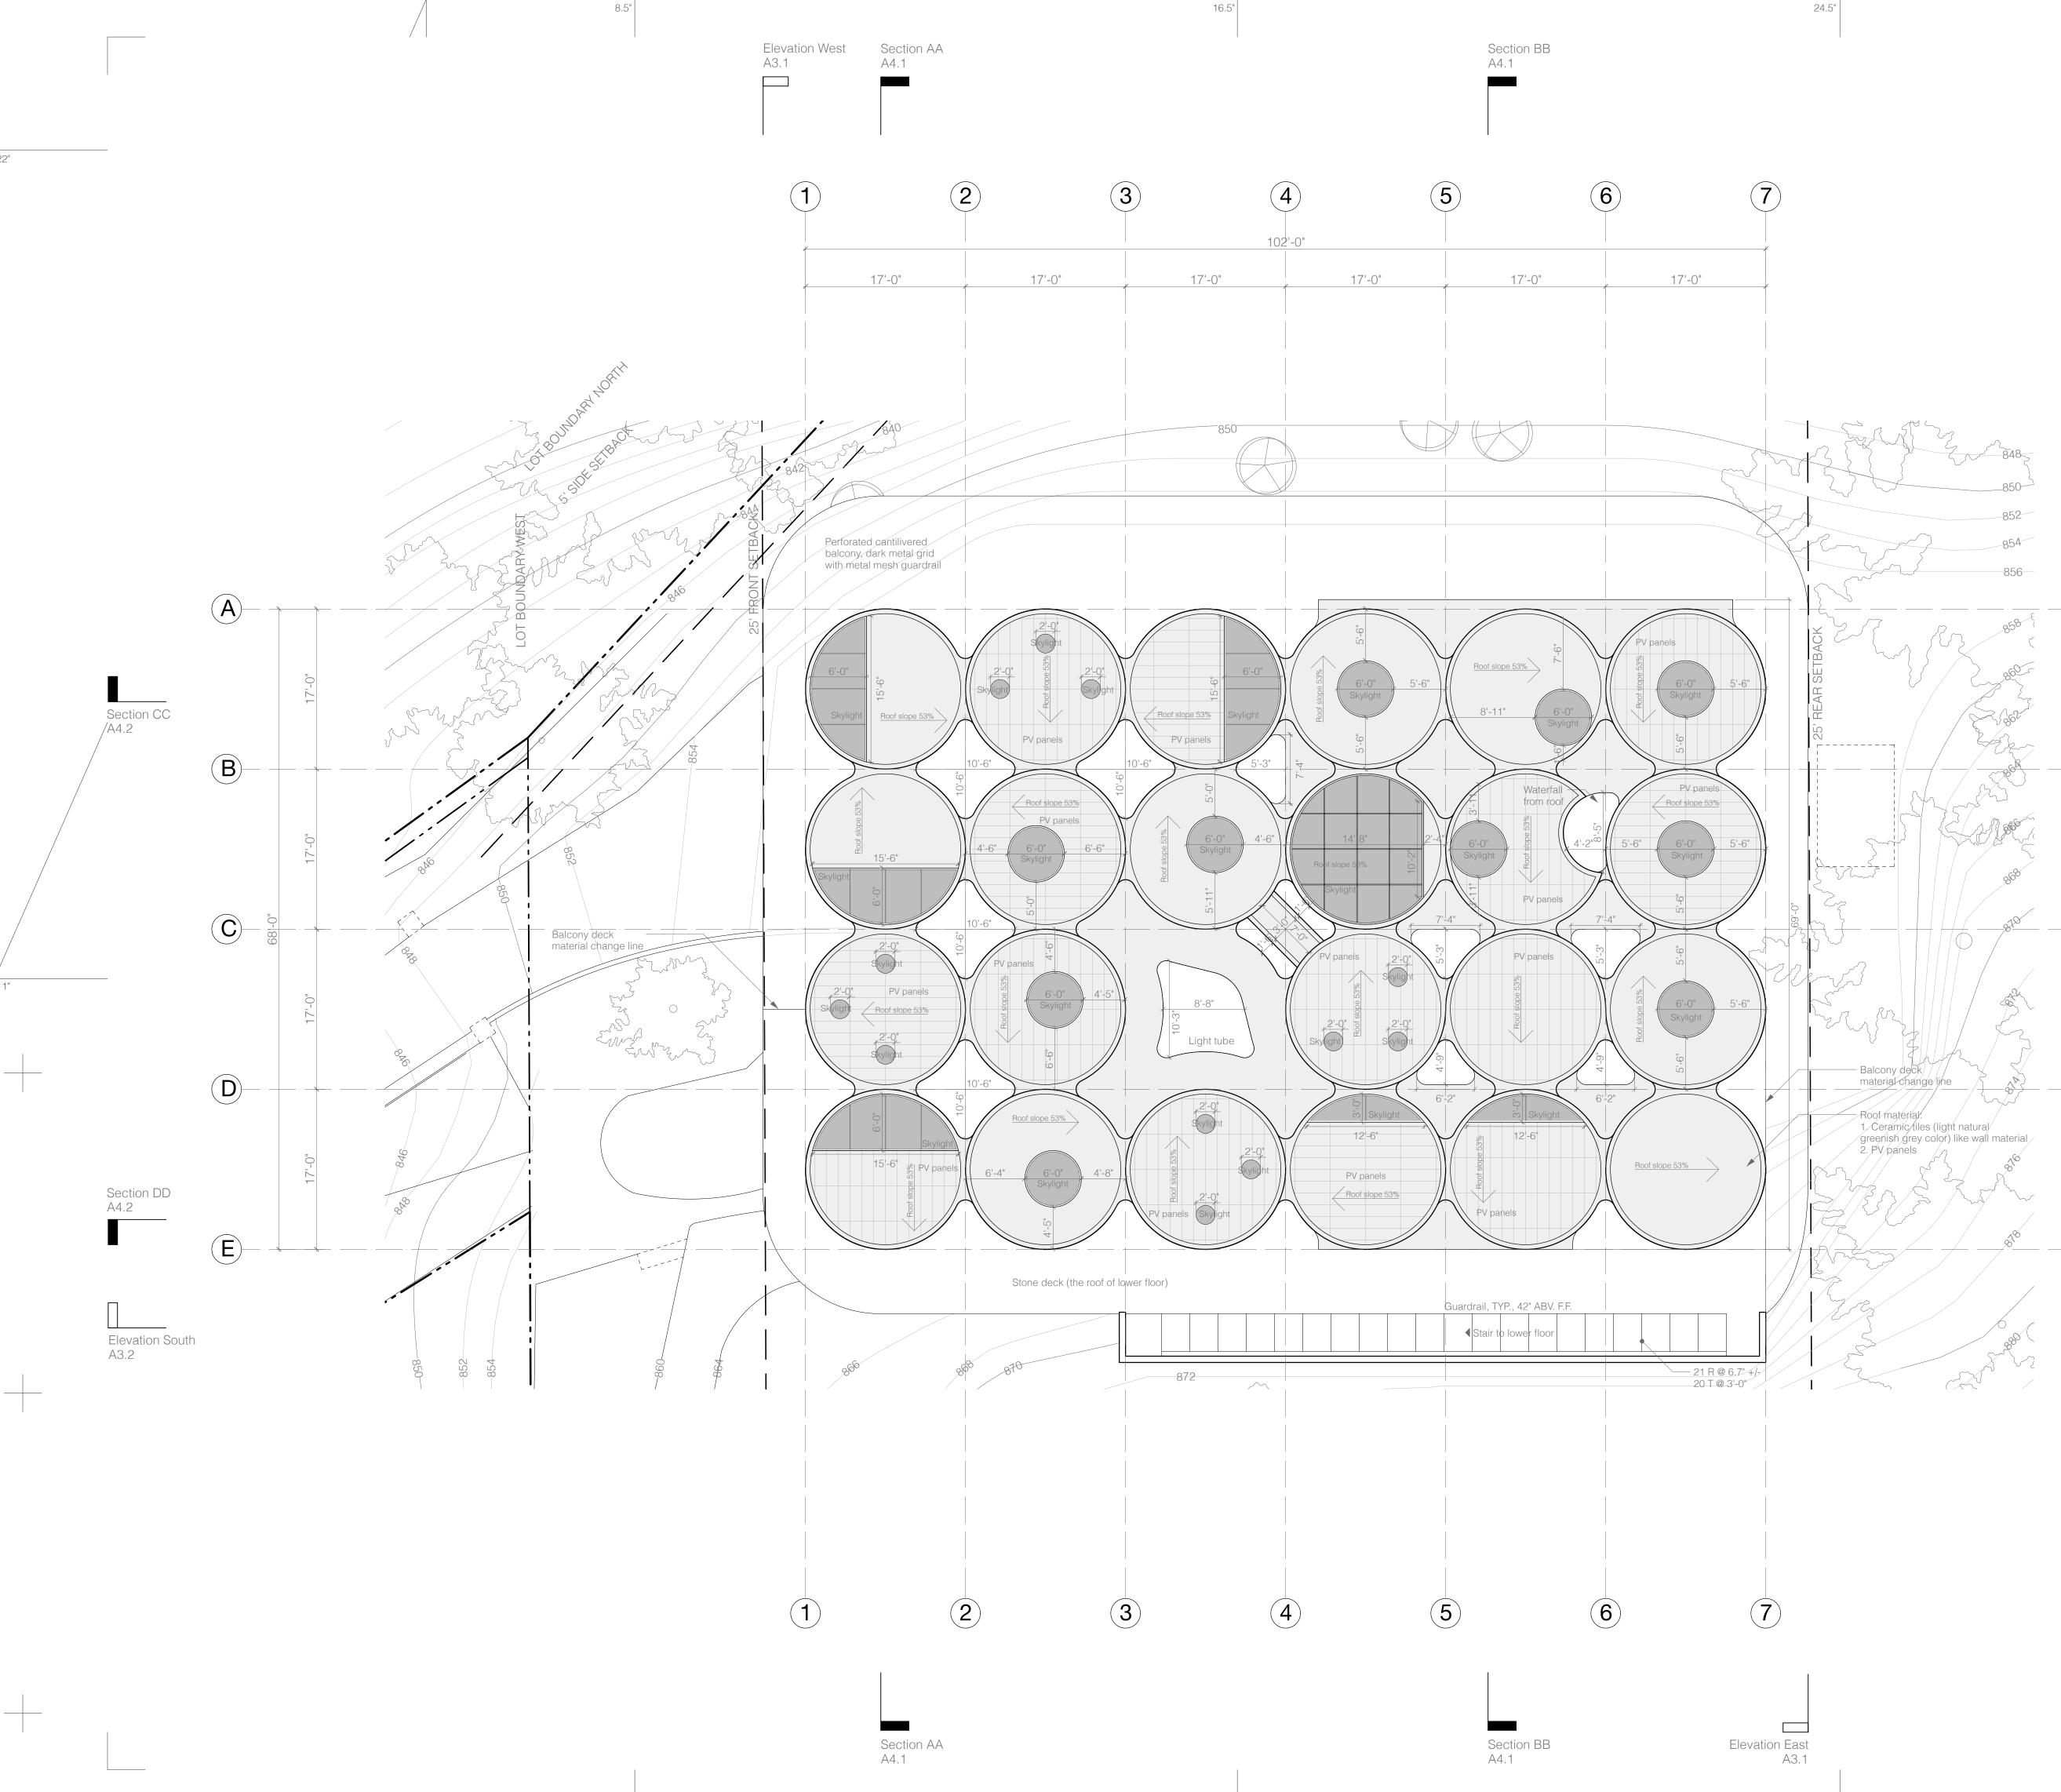




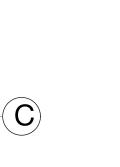





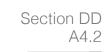

24.5"

Chapter 9 of the 2019 California Fire Code is adopted with the following amendments:


36" & 24"

(a) A new section, Section R902.1.4.1 (Roofing coverings within the Wildland-Urban Interface Fire Area), is added to read as follows:

1. Roof covering shall be fire-retardant Class A minimum. Where space between covering and decking exists, covering shall be installed over 72-lb (32.5 kg) min. mineral-surfaced non-perforated cap sheet complying with ASTM D3909 over combustible decking material.


2. Valley flashing shall be 0.019-in (0.48mm) min. No. 26 ga galv sheet corrosion-resistant metal over 72-lb (32.4 kg) minimum mineral-surfaced nonperforated cap sheet complying with ASTM D3909 a minimum of 3-ft wide and running full length of valley.


3. Install roofing per manufacturer's installation instructions.

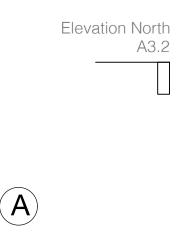

30.25"

22"

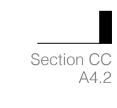


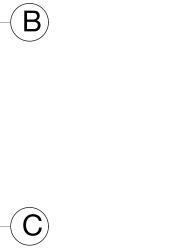

11"

Section DD A4.2 \_\_\_\_\_



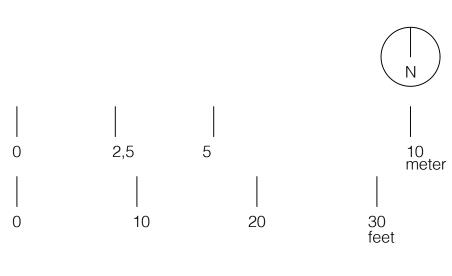

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Proposed Roof Plan

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-> repeat in reverse to fold back



SCALE: 1/8"=1'-0"

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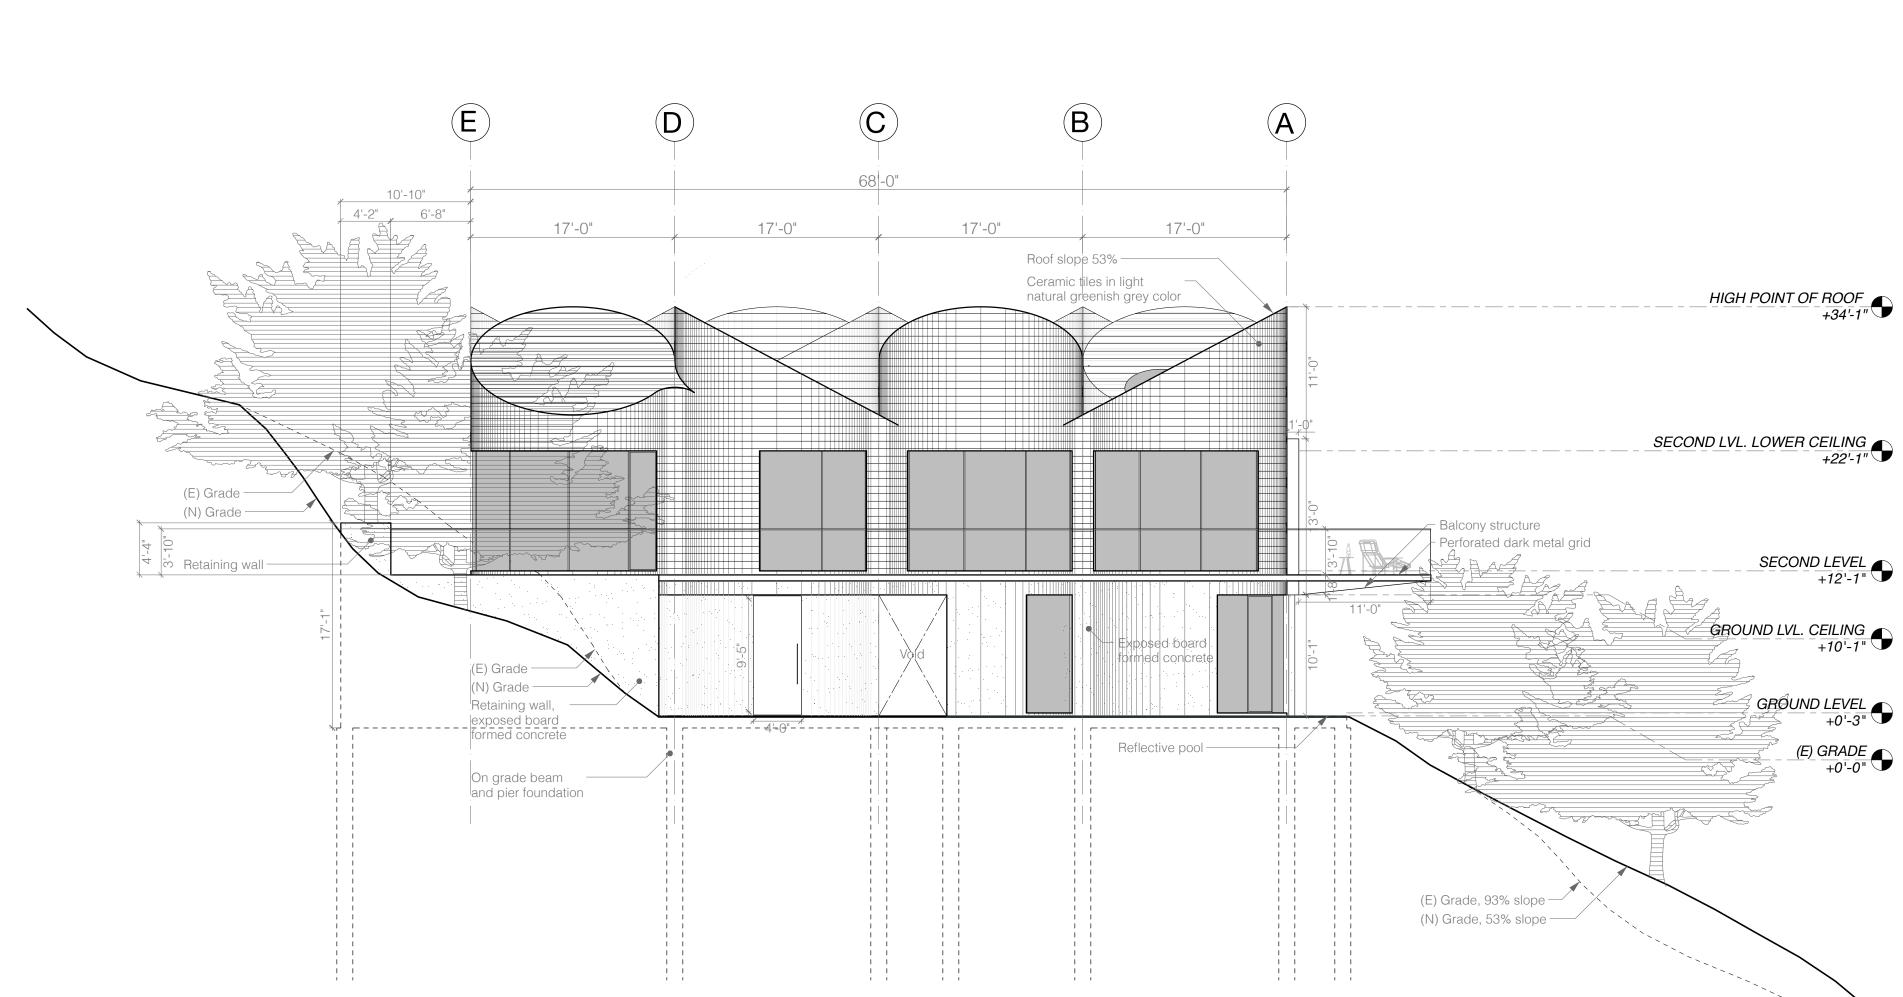
DATE: 11130121

HANNAH M


MOON

C-38791 06/30/23

(accordion style)



8.5"

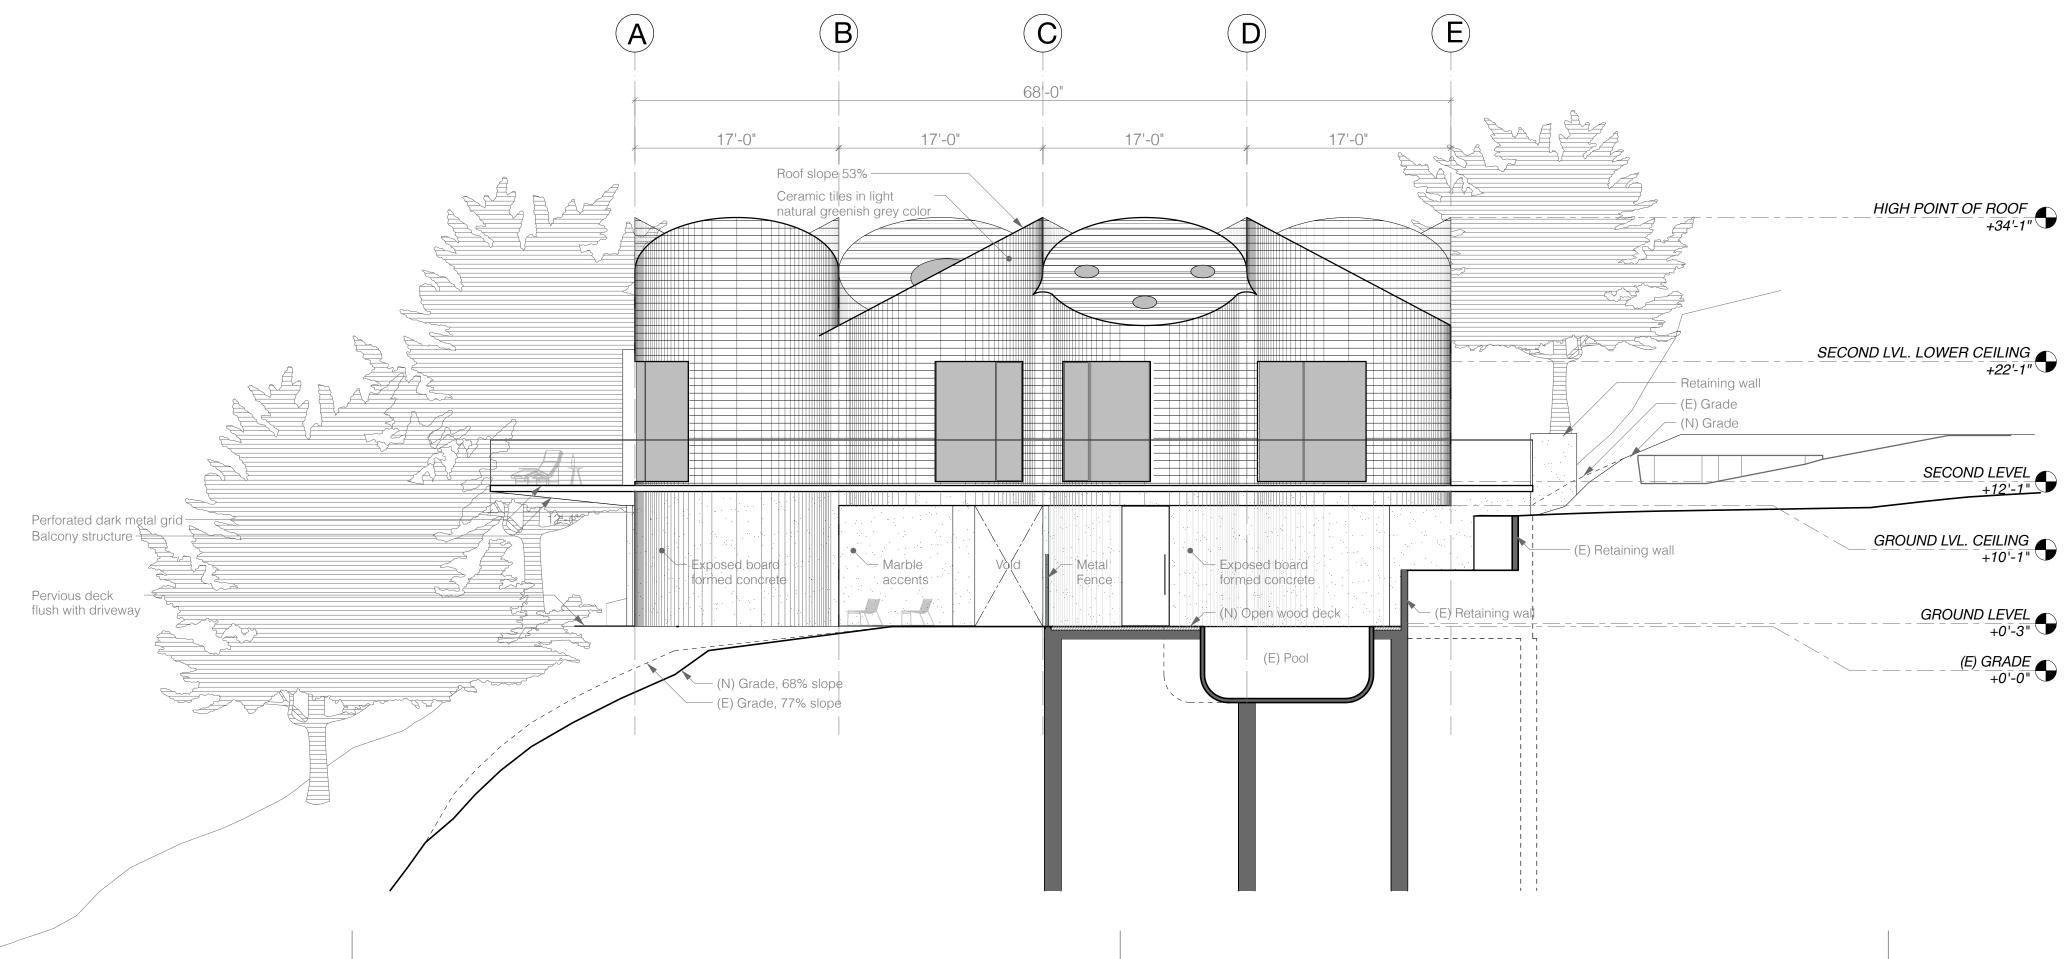

16.5"

24.5

HIGH POINT OF ROOF +34'-1"

24.5"

SECOND LEVEL +12'-1"

# GRÔUND LEVEL +0'-3"

(E) GRADE +0'-0"

1

# HIGH POINT OF ROOF +34'-1"

# SECOND LEVEL +12'-1"

GROUND LVL. CEILING +10<sup>-</sup>-1"

GROUND LEVEL +0'-3" (E) GRADE +0'-0"

# 10 meter

36" & 24"

22"

11"

30.25"

22"

## Project: 17800 Tourney Road - Los Gatos Clients: Stacey and Joao Tang

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West & East Elevations



SCALE: 1/8"=1'-0"

DRAWN BY: RW

DATE: 11130121

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HANNAH M


MOON

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(accordion style)






<u>SECOND LEVEL</u> +12'-1"

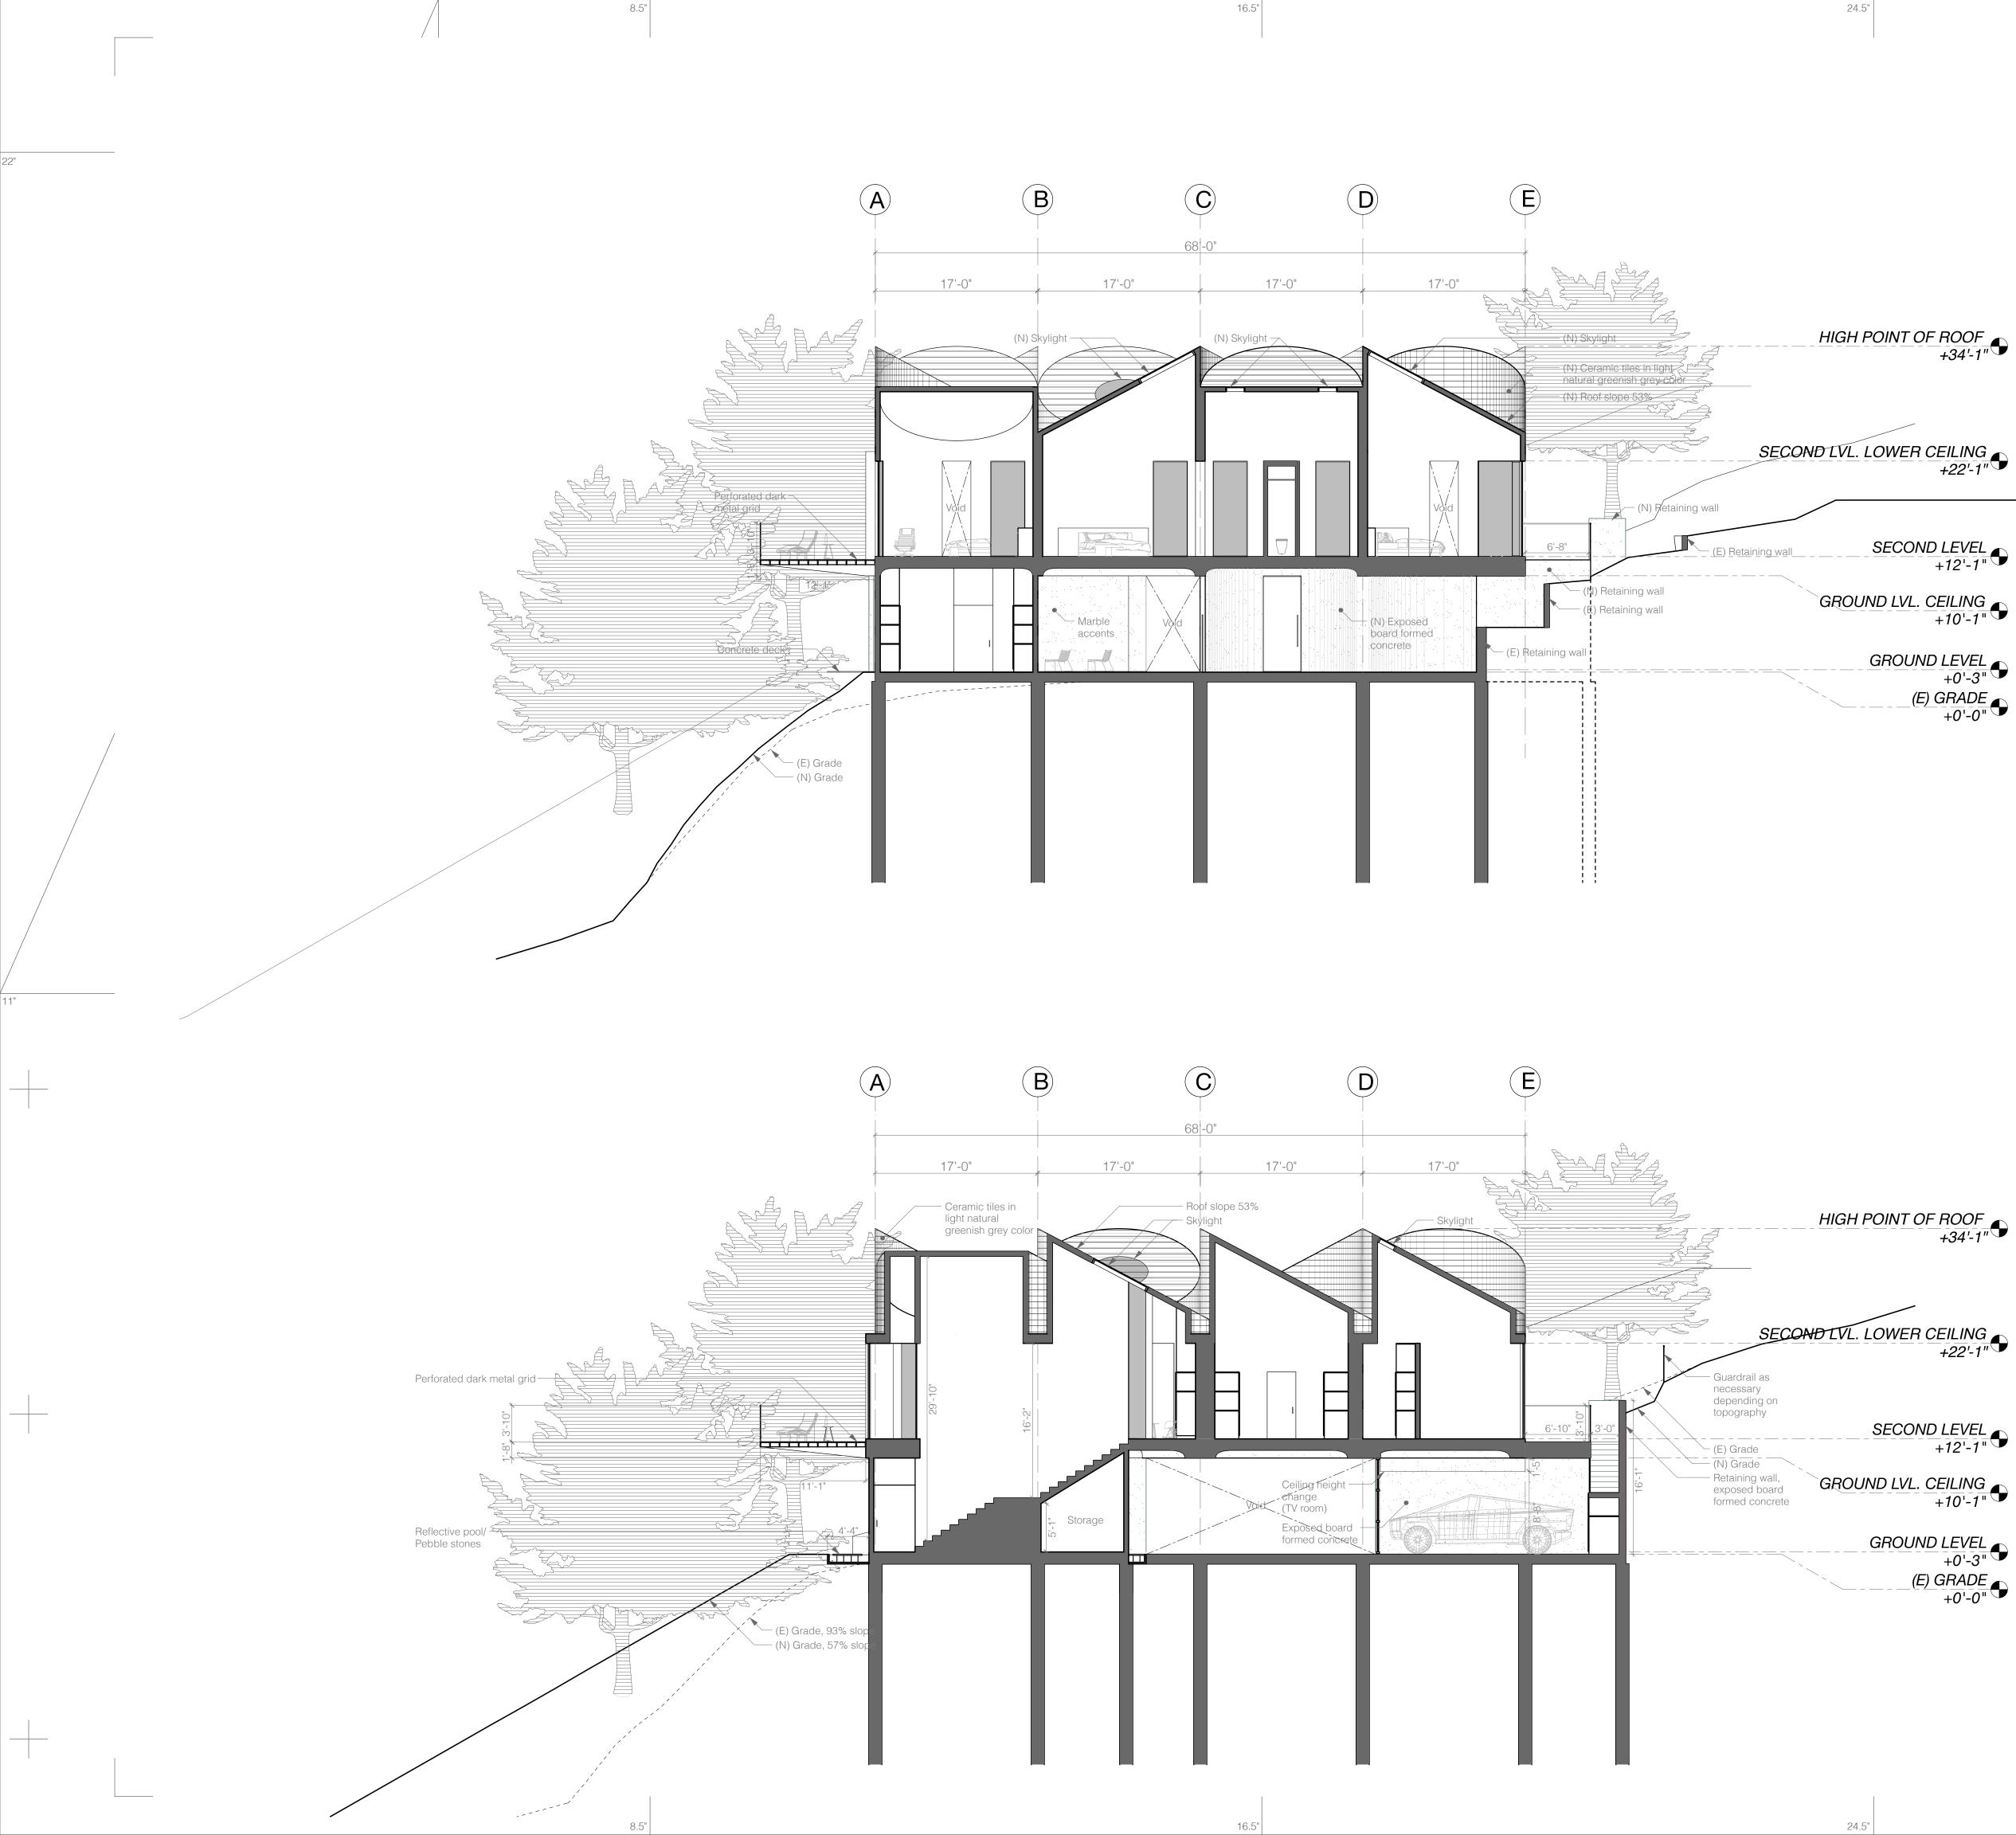GROUND LEVEL +0'-3" (E) GRADE +0'-0"

+22'-1'

<u>SECOND LEVEL</u> +12'-1"

GROUND LEVEL +0'-3" (E) GRADE +0'-0"

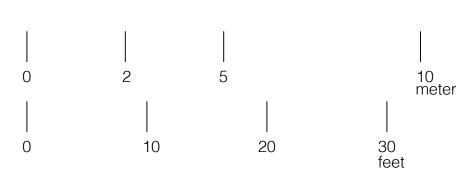

36" & 24"

22"

Project: 17800 Tourney Road - Los Gatos

Clients: Stacey and Joao Tang

30.25"

22"

11"

PAZ de Moura Castro King Mückenheim

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HANNAH M MOON C-38791 06/30/23

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(accordion style)

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Cross Building Sections



