

ABBREVIATIONS				
&	AND			
@	ANGLE AT			
Ø	CENTERLINE DIAMETER			
<e></e>	EXISTING			
<f></f>	FUTURE			
1-HR	1-HOUR			
2-HR	2-HOUR			
AB	ANCHOR BOLT			
AC	ASPHALT CONCRETE			
ACC	ACCESSIBLE			
ADA	AMERICANS WITH DISABILITIES ACT			
ADD'L	ADDITIONAL			
ADJ	ADJACENT			
AFF AFS	ABOVE FINISH FLOOR AUTOMATIC FIRE SPRINKLERS ALUMINUM			
ALUM ARCH ATT	ACCHITECT/ARCHITECTURAL ATTENUATION			
BLDG	BUILDING			
BO	BOTTOM OF			
CBC	CALIFORNIA BUILDING CODE			
CC	CENTER TO CENTER			
CEC	CALIFORNIA ELECTRICAL CODE			
CFC	CALIFORNIA FIRE CODE			
CFS	CHANNEL FRAMING SYSTEM			
CG	CORNER GUARD			
CH	COAT HOOK			
CK	CARD KEY			
CLG	CEILING			
CLR	CLEAR			
CMC	CALIFORNIA MECHANICAL CODE			
CMU	CONCRETE MASONRY UNIT			
COL	COLUMN			
CONF	CONFERENCE CONCRETE			
CONT	CONTINUOUS CORRIDOR			
CPC	CALIFORNIA PLUMBING CODE			
CSK	COUNTERSUNK			
D	DRAIN			
DEMO	DEMOLISH/DEMOLITION			
DIA	DIAMETER			
DIM	DIMENSION			
DWG	DRAWING			
EEWS	EMERGENCY EYEWASH & SHOWER			
EIFS	EXTERIOR INSULATION & FINISH SYSTEM			
EL	ELEVATION			
ELEC	ELECTRIC/ELECTRICAL			
ELEV EPB	ELECTRIC/ELECTRIC/AL ELEVATOR or ELEVATION ELECTRIC PANEL BOARD			
EQ	EQUAL			
EWC	ELECTRICAL WATER COOLER			
EXT	EXTERIOR			
FAR	FLOOR AREA RATIO			
FB	FLAT BAR			
FE	FIRE EXTINGUISHER			
FEC	FIRE EXTINGUISHER CABINET			
FHC	FIRE HOSE CABINET			
FLR	FLOOR			
FOC	FACE OF CONCRETE			
FOF	FACE OF FINISH			
FOM	FACE OF MASONRY			
FOS FR	FACE OF STUD FIRE RATING/RATED FIBERGLASS REINFORCED PLASTIC			
FRP FS FT	FIRE SPRINKLER FOOT			
FURN	FURNITURE			
FVC	FIRE VALVE CABINET			
GA	GAUGE			
GALV	GALVANIZED			
GB	GRAB BAR			
GBDW	GYPSUM BOARD DRYWALL			
GFRC	GLASS FIBER REINFORCED CONCRETE			
GL	GLASS OR GLAZING			
GSM	GALVANIZED SHEET METAL			
HD	HAND DRIER			
HM	HOLLOW METAL			
HP	HIGH POINT			
HR	HOUR			
HSS	HOLLOW STRUCTURAL SECTION			
HT	HEIGHT			
HVAC	HEATING, VENTILATION, AIR CONDITIONING			
INT	INTERIOR			
JAN	JANITOR			
LAV	LAVATORY			
LP	LOW POINT			
LSD	LIQUID SOAP DISPENSER			
M <e></e>	MATCH EXISTING			
MAX	MAXIMUM			
MB	MACHINE BOLT			
MFR	MANUFACTURER			
MIN	MINIMUM			
MISC	MISCELLANEOUS			
MPU	MULTI-PURPOSE UNIT			
N/R	NON-RATED			
NIC	NOT IN CONTRACT			
NTS	NOT TO SCALE			
OC	ON CENTER			
OCC	OCCUPANT(S)			
OD	OVERFLOW DRAIN			
OPP	OPPOSITE			
PL	PLATE			
PLAM	PLASTIC LAMINATE			
PLAS	PLASTER			
PLWD	PLYWOOD			
PT	POINT			
PTD	PAPER TOWEL DISPENSER			
RCP	REFLECTED CEILING PLAN			
RD	ROOF DRAIN			
REF	REFRIGERATOR			
REFL	REFLECTED			
REQD	REQUIRED			
RF	RESILIENT FLOORING			
RM	ROOM			
RWL	RAIN WATER LEADER			
SC	SEALED CONCRETE			
SD	STORM DRAIN OR SOAP DISPENSER			
SEC	SECTION			
SF	SQUARE FEET			
SIM	SIMILAR			
SSM	SHEET METAL SCREW			
SND	SANITARY NAPKIN DISPENSER			
SNR	SANITARY NAPKIN RECEPTACLE			
SOG	SLAB ON GRADE			
SPEC	SPECIFICATION			
SS	STAINLESS STEEL			
STC	SOUND TRANSMISSION CLASS			
STOR	STORAGE			
STSM	SELF TAPPING SHEET METAL			
T&B	TOP AND BOTTOM			
TI	TENANT IMPROVEMENTS			
TO	TOP OF			
TOS	TOP OF SLAB or TOP OF STEEL			
TP	TOILET PAPER			
TS	TUBE STEEL			
TSC	TOILET SEAT COVER			
TYP	TYPICAL			
UON	UNLESS OTHERWISE NOTED			
VIF	VERIFY IN FIELD			
VIF W/ W/O	WITH WITHOUT			
WC	WATER CLOSET			
WH	WATER HEATER			
WR	WATER RESISTANCE or WASTE RECEPTACLE			
WP	WATERPROOF			
WWF	WELDED WIRE FABRIC			
XFMR	TRANSFORMER			

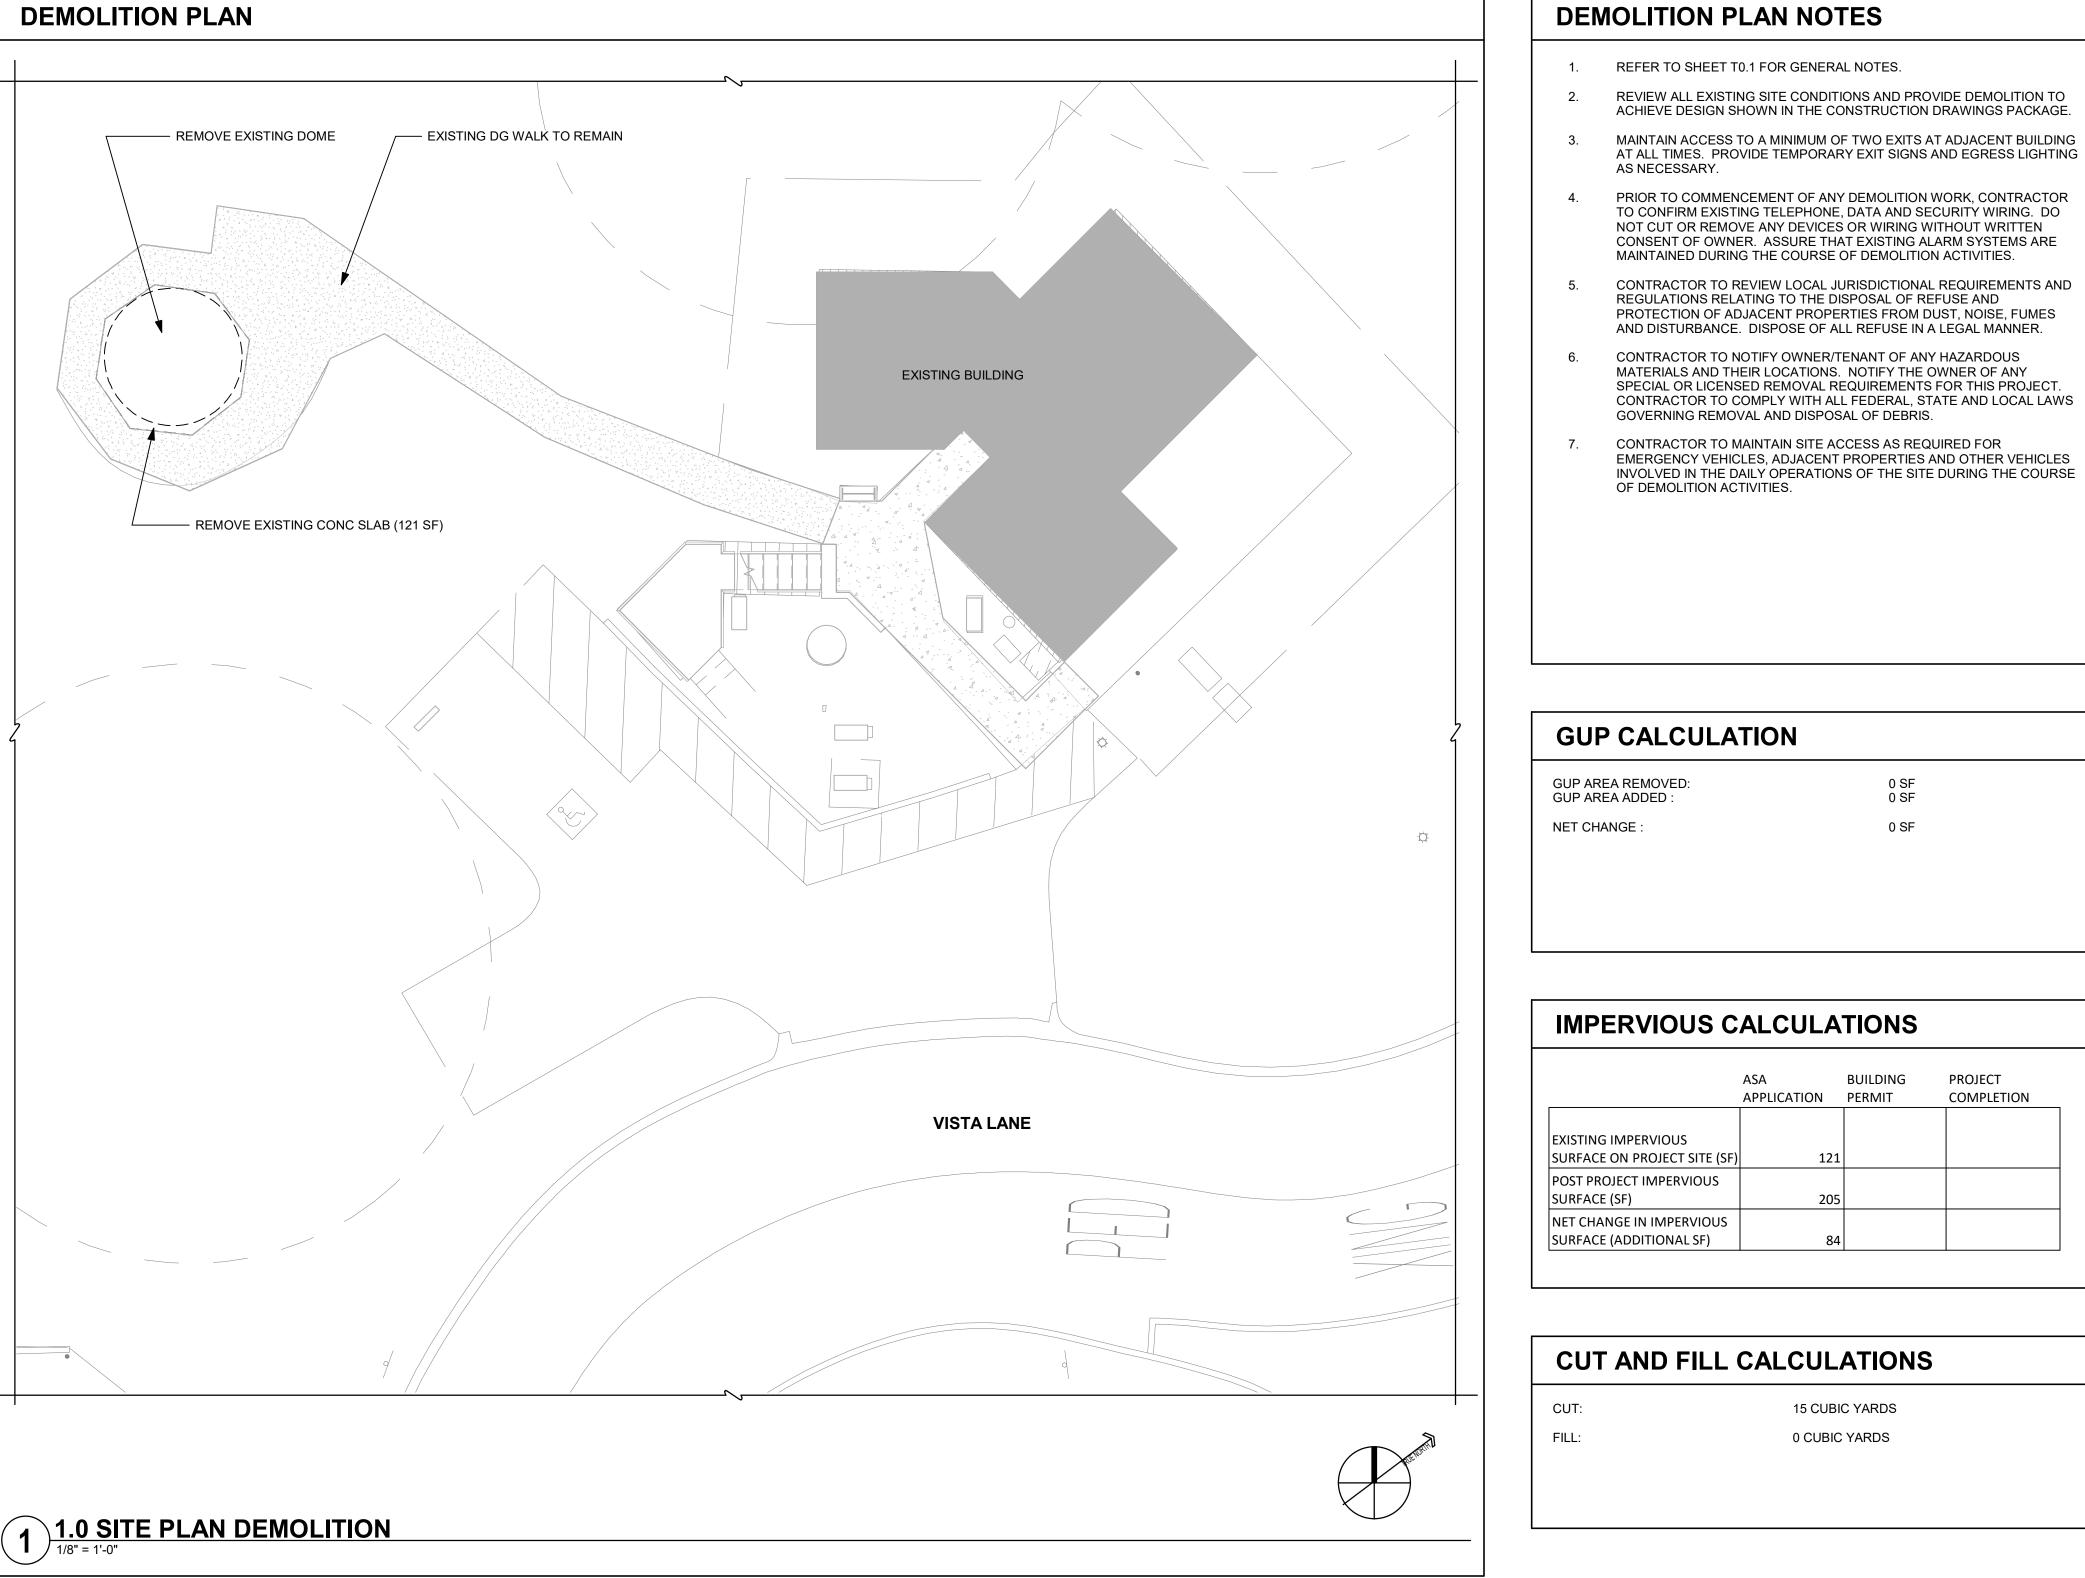

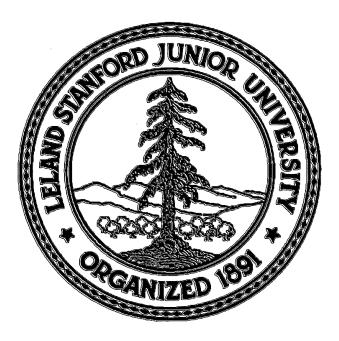

STANFORD UNIVERSITY

OBSERVATORY DOME REPLACEMENT BUILDING 12-070 44 VISTA LANE STANFORD, CA 94305

- REFER TO SHEET T0.1 FOR GENERAL NOTES.
- REVIEW ALL EXISTING SITE CONDITIONS AND PROVIDE DEMOLITION TO ACHIEVE DESIGN SHOWN IN THE CONSTRUCTION DRAWINGS PACKAGE. MAINTAIN ACCESS TO A MINIMUM OF TWO EXITS AT ADJACENT BUILDING
- PRIOR TO COMMENCEMENT OF ANY DEMOLITION WORK, CONTRACTOR TO CONFIRM EXISTING TELEPHONE, DATA AND SECURITY WIRING. DO NOT CUT OR REMOVE ANY DEVICES OR WIRING WITHOUT WRITTEN CONSENT OF OWNER. ASSURE THAT EXISTING ALARM SYSTEMS ARE
- CONTRACTOR TO REVIEW LOCAL JURISDICTIONAL REQUIREMENTS AND REGULATIONS RELATING TO THE DISPOSAL OF REFUSE AND PROTECTION OF ADJACENT PROPERTIES FROM DUST, NOISE, FUMES AND DISTURBANCE. DISPOSE OF ALL REFUSE IN A LEGAL MANNER.
- CONTRACTOR TO NOTIFY OWNER/TENANT OF ANY HAZARDOUS MATERIALS AND THEIR LOCATIONS. NOTIFY THE OWNER OF ANY SPECIAL OR LICENSED REMOVAL REQUIREMENTS FOR THIS PROJECT. CONTRACTOR TO COMPLY WITH ALL FEDERAL, STATE AND LOCAL LAWS GOVERNING REMOVAL AND DISPOSAL OF DEBRIS.
- CONTRACTOR TO MAINTAIN SITE ACCESS AS REQUIRED FOR EMERGENCY VEHICLES, ADJACENT PROPERTIES AND OTHER VEHICLES INVOLVED IN THE DAILY OPERATIONS OF THE SITE DURING THE COURSE

GENERAL NOTES

- VERIFY EXISTING CONDITIONS ON-SITE & REVIEW MODIFICATIONS REQUIRED TO SUIT EXISTING CONDITIONS PRIOR TO FABRICATIONS & INSTALLATION OF WORK. NOTIFY ARCHITECT OF ANY DISCREPANCIES FOUND.
- "TYP" REPEAT WHEREVER THIS CONDITION OCCURS. 2 "SIM" - REPEAT & MODIFY AS REQUIRED TO SUIT CONDITION. 3.
- DO NOT SCALE DRAWINGS. ANY DIMENSIONAL INFORMATION REQUIRED WHICH IS NOT 4. INDICATED ON DRAWING DIMENSION STRINGS SHALL BE OBTAINED FROM THE ARCHITECT.
- PRESERVE AND MAINTAIN EXISTING EXITS DURING DEMOLITION AND CONSTRUCTION PHASES TO 5.
- COMPLY WITH 2019 CBC SECTION 3310.2. DATUM ELEVATION 0'-0" IS GIVEN AS BENCHMARK TO TOP OF CONCRETE SLAB. 6
- CONSTRUCTION WASTE MANAGEMENT SHALL RECYCLE AND / OR SALVAGE FOR REUSE A 7. MINIMUM OF 65% PER 2019 CGBC 5.408.1.

PROJECT DESCRIPTION

THE SCOPE OF WORK INCLUDES THE FOLLOWING:

- REMOVE AN EXISTING OBSERVATORY DOME AND ITS FOUNDATION
- INSTALL A NEW OBSERVATORY DOME AND NEW • FOUNDATION
- VERIFY THAT THE OBSERVATORY DOME IS ACCESSIBLE • FROM THE ACCESSIBLE PARKING SPACE.

0 SF 0 SF 0 SF

IMPERVIOUS CALCULATIONS ASA BUILDING PROJECT APPLICATION PERMIT COMPLETION

(SF)	121	
;		
	205	
JS		
	84	

CUT AND FILL CALCULATIONS

15 CUBIC YARDS 0 CUBIC YARDS

PLUMBING CODE: ENERGY CODE: GREEN CODE: SPRINKLERED: PARKING:

PROJECT DATA

DEVELOPMENT DISTRICT:

LAND USE DESIGNATION:

NEW BUILDING AREA:

CONSTRUCTION TYPE:

APN:

PARCEL SIZE:

ZONING:

STORIES:

OCCUPANCY:

FIRE CODE:

BUILDING CODE:

MECHANICAL CODE:

ELECTRICAL CODE

LATHROP / FOOTHILL DEVELOPMENT ACADEMIC / SPECIAL CONSERVATION AREA A1/SCA 205 SF

2019 CBC 2019 CFC 2019 CMC 2019 CEC 2019 CPC 2019 CA ENERGY CODE 2019 CAL GREEN BLDG CODE FULLY SPRINKLERED EXISTING NO CHANGE

142-12-009

302.6 ACRES


DRAWING INDEX

TITLE T0.1 TITLE SHEET


GENERAL G0.1 GUP INFORMATION MAPS


ARCHITECTURAL

A0.1 SITE PLAN

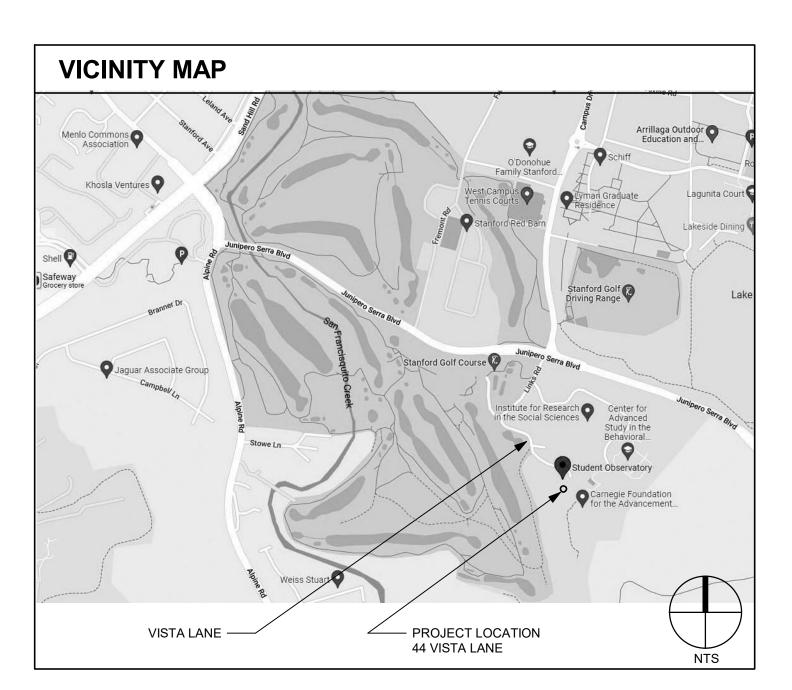


APPROVAL STAMPS					

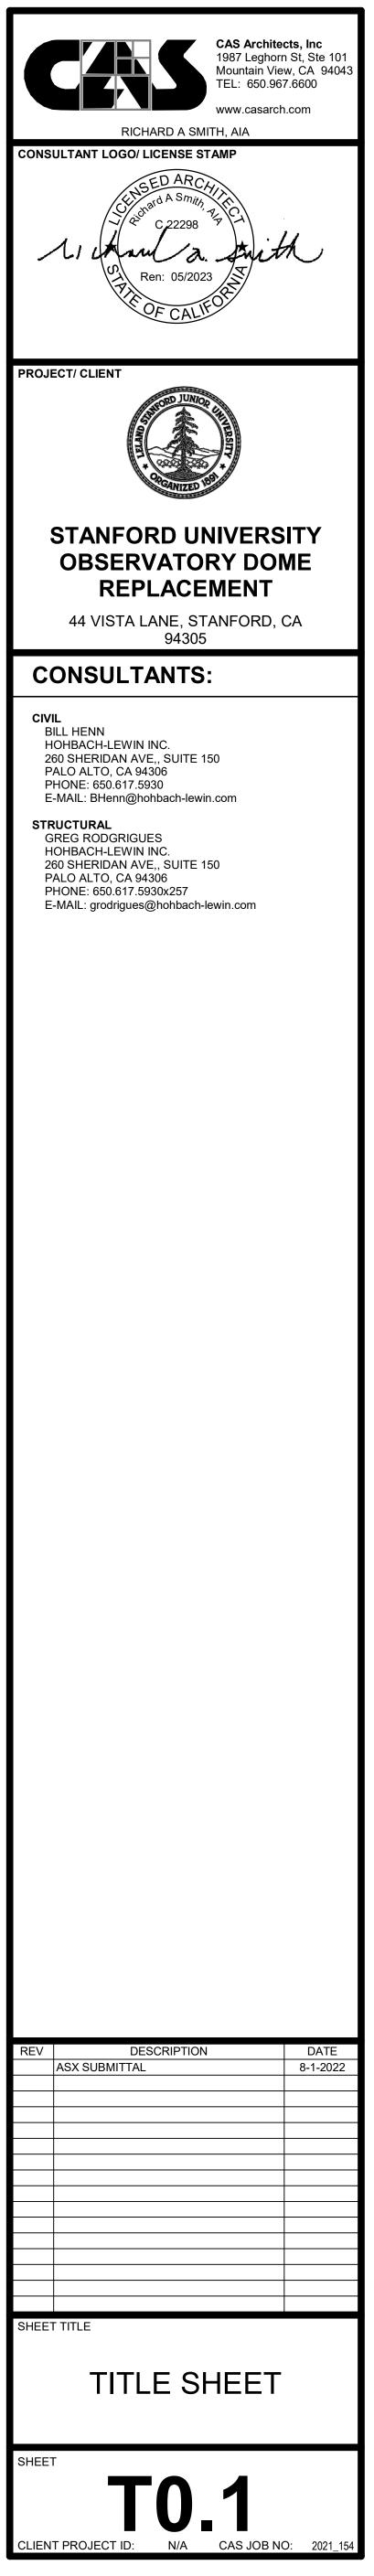

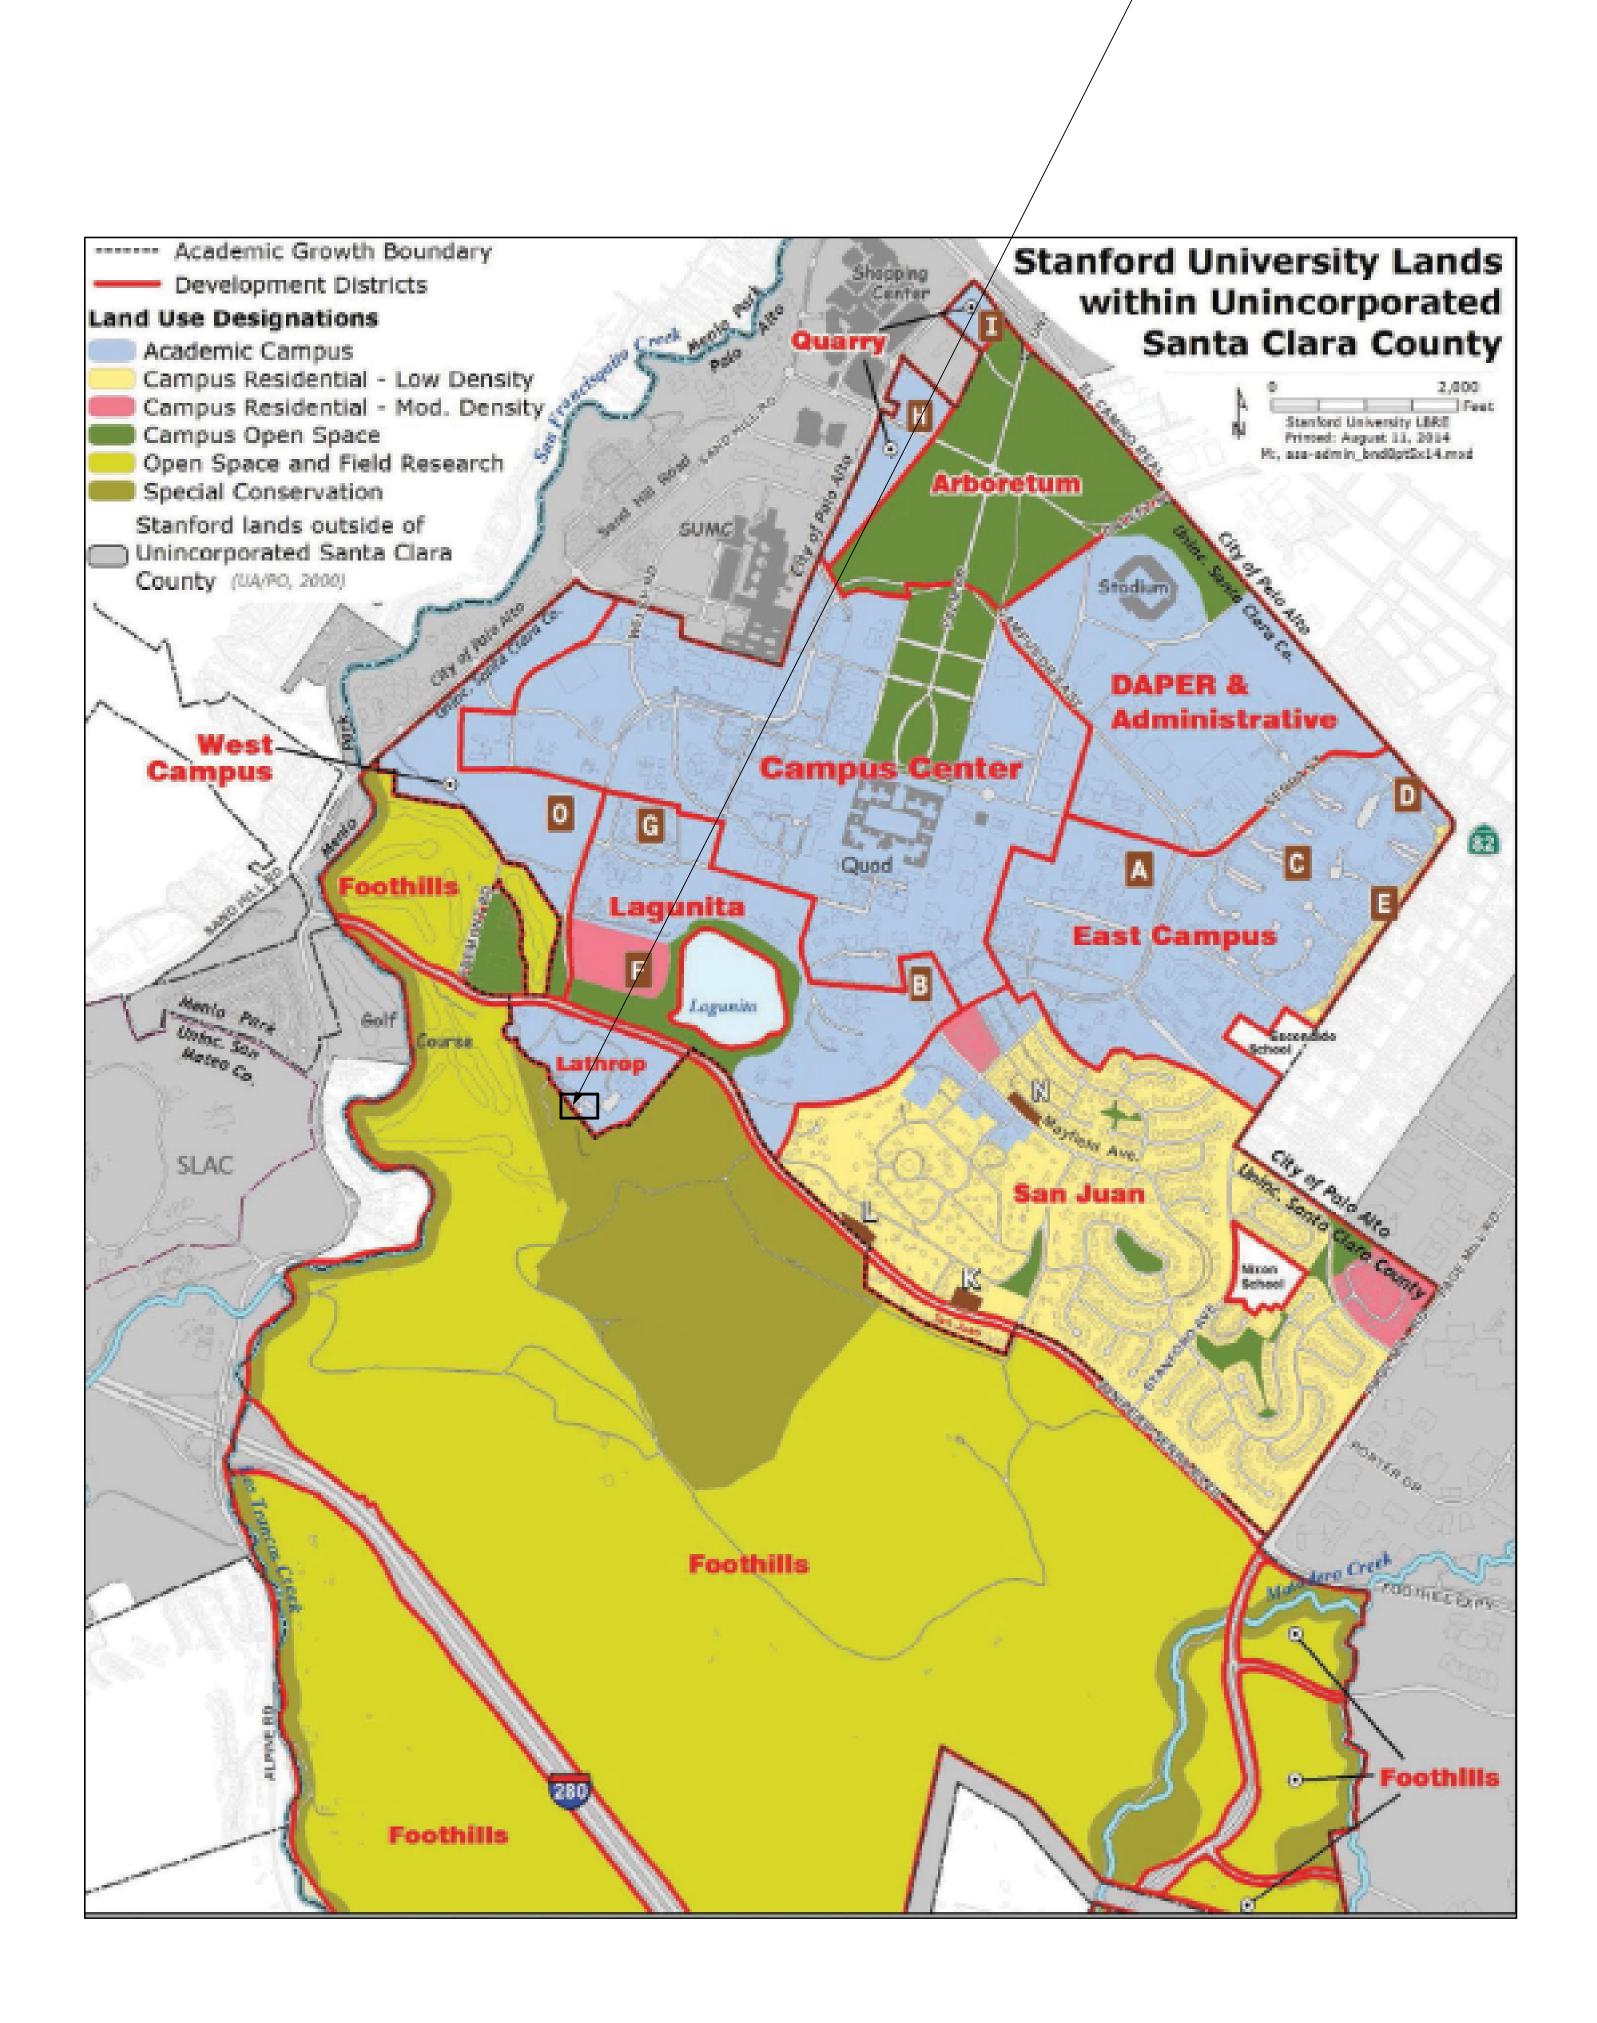

PROJECT SITE

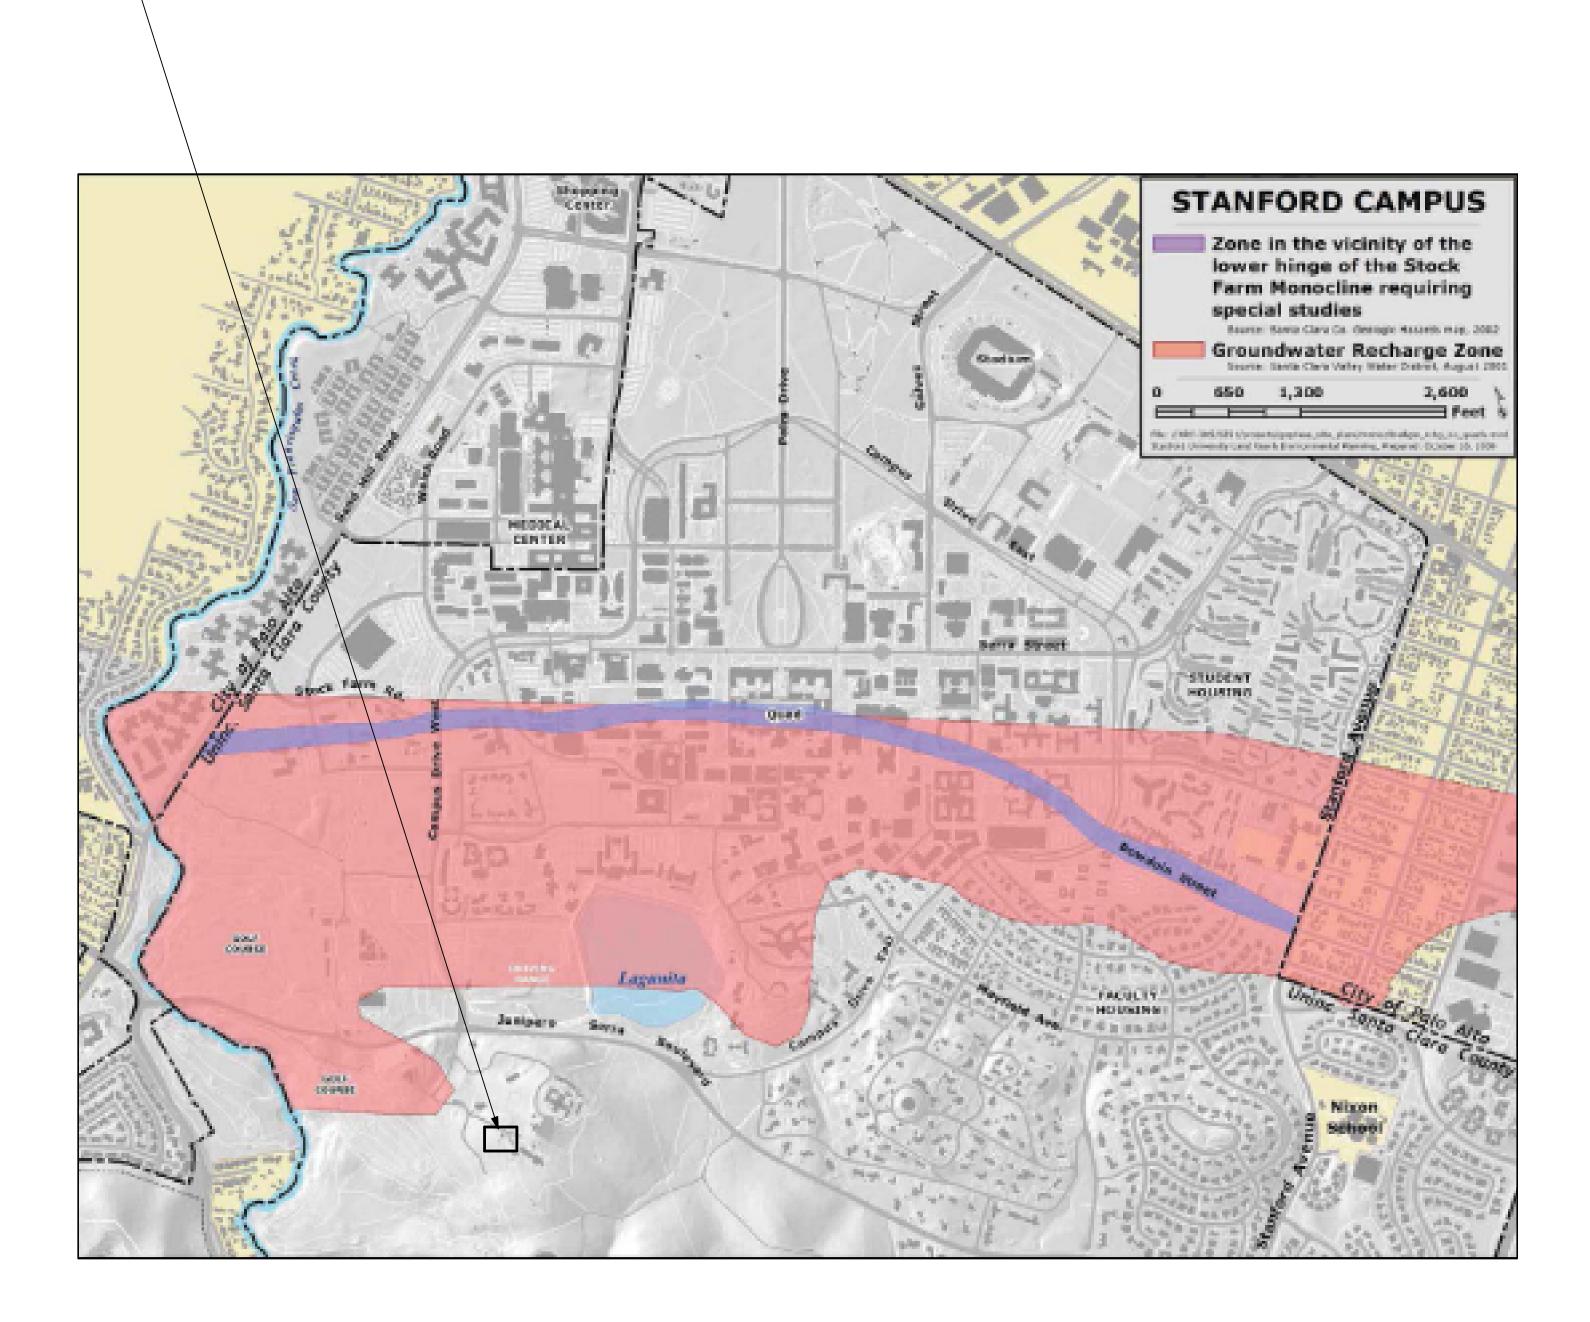






CAS Architects, Inc 1987 Leghorn St, Ste 101 Mountain View, CA 94043 TEL: 650.967.6600 www.casarch.com RICHARD A SMITH, AIA CONSULTANT LOGO/ LICENSE STAMP **PROJECT/ CLIENT** STANFORD UNIVERSITY **OBSERVATORY DOME** REPLACEMENT 44 VISTA LANE, STANFORD, CA 94305 DESCRIPTION ASX SUBMITTAL 8-1-202 SHEET TITLE **GUP INFORMATION** MAPS SHEET Gn


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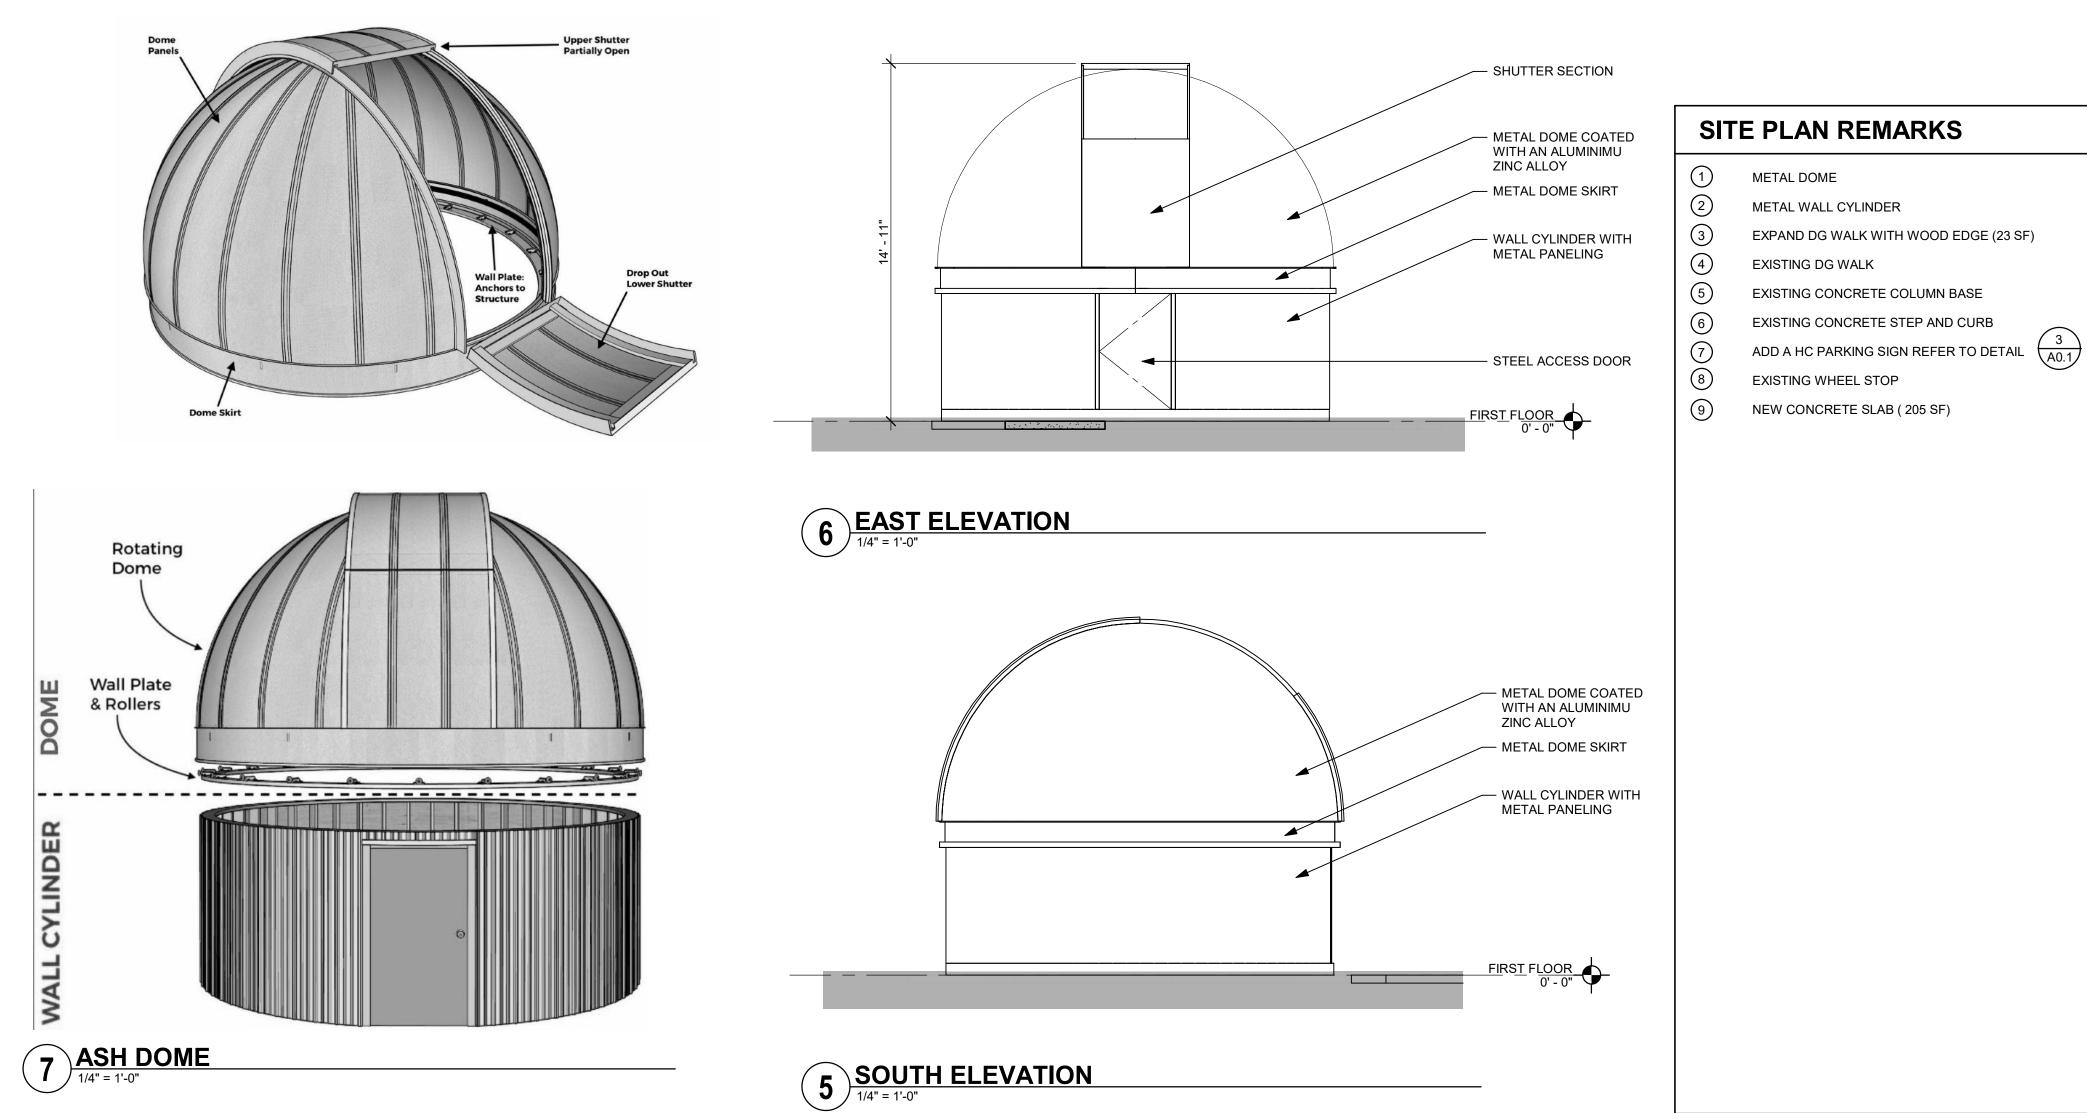
3 HC PARKING SIGN

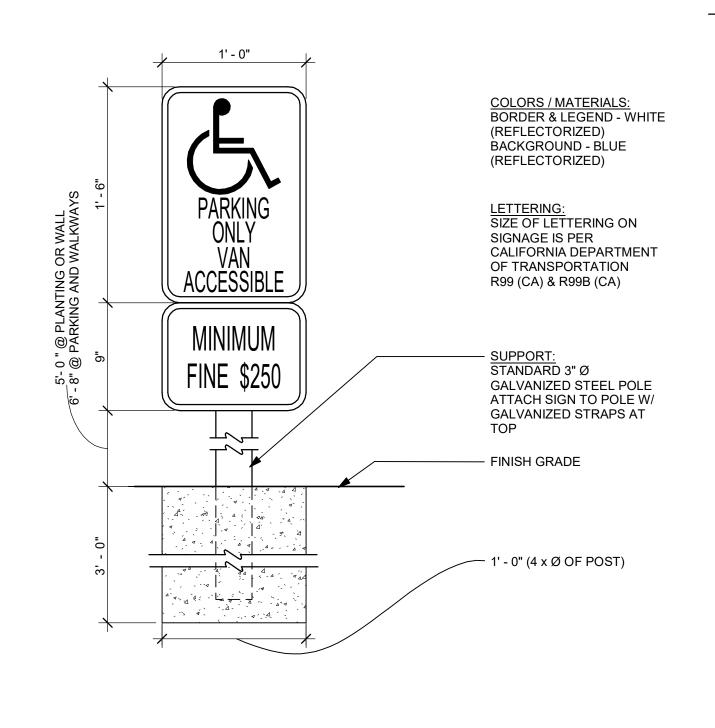

4 HC PARKING PHOTO



1) 1.0 SITE PLAN 1/8" = 1'-0"

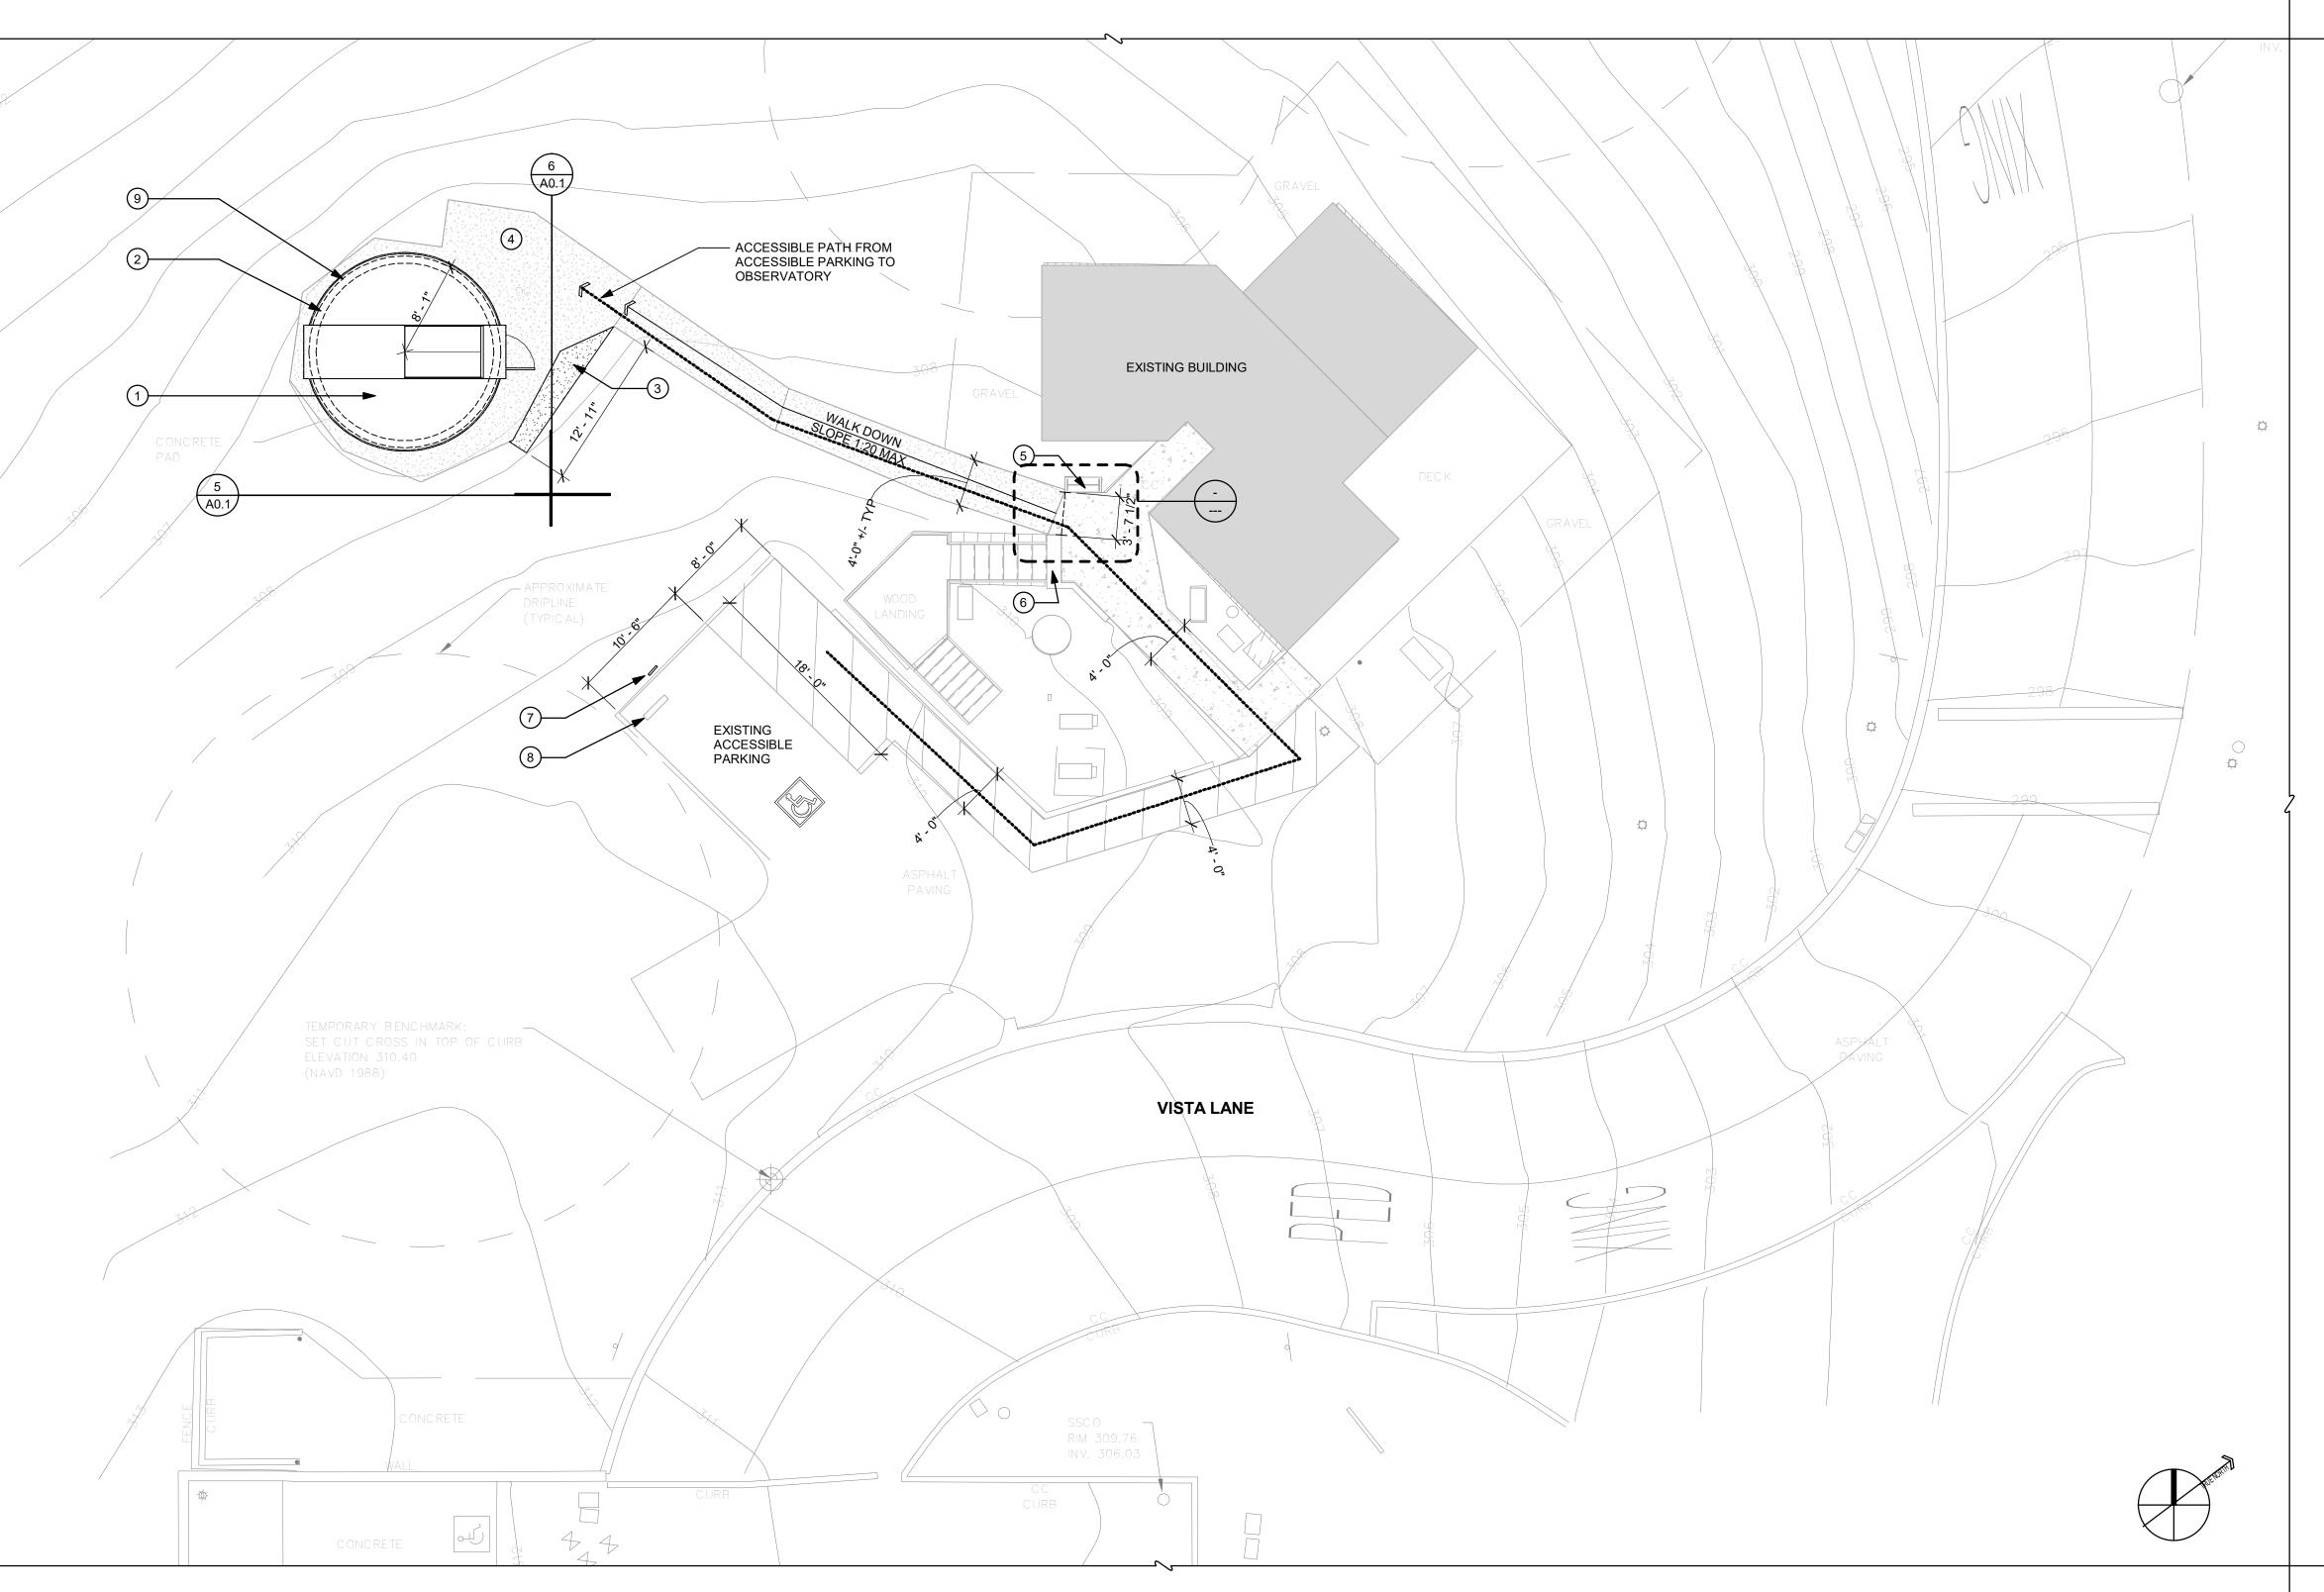

- EXPAND DG WALK WITH WOOD EDGE (23 SF)

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SHEET

CLIENT PROJECT ID: N/A CAS JOB NO: 2021 154