

PARMAR RESIDENCE

HAYES LANE
SAN MARTIN, CA
(APN 779-44-014)

AGD
ARCHITECTURE | DESIGN

ANDREW GOODWIN DESIGNS
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2019 CALIFORNIA BUILDING CODE, VOLS 1 & 2 (2015 IBC)
2019 CALIFORNIA ELECTRICAL CODE (2015 NEC)
2019 CALIFORNIA MECHANICAL CODE (2015 UMC)
2019 CALIFORNIA PLUMBING CODE (2015 UPC)
2019 CALIFORNIA ENERGY CODE
2019 CALIFORNIA FIRE CODE (2015 IFC)
2019 CALIFORNIA GREEN BUILDING CODE (2015 IBC)
2019 CALIFORNIA REFERENCE STANDARDS CODE
2019 CALIFORNIA RESIDENTIAL CODE (2015 IRC)

11 APPLICABLE CODES

SHEET INDEX			
Sheet Number	Sheet Name	Current Rev	Current Rev Date
G 0.0	TITLE SHEET		
A 1.0	SITE PLAN		
A 2.1	MAIN RESIDENCE - FLOOR PLAN		
A 2.2	MAIN RESIDENCE - ROOF PLAN		
A 3.1	MAIN RESIDENCE - ELEVATIONS		
A 4.1	MAIN RESIDENCE - SECTIONS		
AA 2.1	ADU - FLOOR PLAN		
AA 2.2	ADU - ROOF PLAN		
AA 3.1	ADU - ELEVATIONS		
AA 4.1	ADU - SECTIONS		
AB 2.1	BARN - FLOOR PLAN		
AB 3.1	BARN - ELEVATIONS		
AB 3.2	BARN - ELEVATIONS		
AB 4.1	BARN - SECTIONS		

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REVISIONS

REV # | REV DATE | REV DESCRIPTION

SEAL

NOT FOR CONSTRUCTION

PROJECT

PARMAR RESIDENCE

HAYES LANE
SAN MARTIN, CA 95046

APN#:779-44-014

CLIENT

ABISHEK PARMAR

13 PROJECT DIRECTORY

PARCEL INFORMATION

ADDRESS: HAYES LANE
APN: 779-44-014
LAND USE: R
ZONING: HS-d1
OCCUPANCY: R-1
PARCEL AREA: 20 ACRES

MAX LOT COVERAGE: 0%
SETBACKS: 30' FRONT, 30' REAR, 30' SIDE
ALLOWED STORIES: 3 (35' MAX.)

CONSTRUCTION TYPE: V-A

TOTAL SF: MAIN RESIDENCE: 4,294 SF
GARAGE: 973 SF
PATIO: 848 SF

ADU SF: 1,199 SF
SPORTS BARN SF: 2,412 SF


LOT COVERAGE: 2%
STORIES: MAIN RESIDENCE: 1
ADU: 1
SPORTS BARN: 1

BLDG HEIGHT: MAIN RESIDENCE: 15'-6" MAX.
ADU: 13'-0" MAX.
SPORTS BARN: 31'-0" MAX.

PARKING: 3-CAR GARAGE

14 PROJECT INFORMATION

AB	ANCHOR BOLT	FLX	FLEXIBLE	QC	QUALITY CONTROL
ABV	ABOVE	FND	FOUNDATION	QT	QUARRY TILE
AC	ACCESSIBLE	FOC	FACE OF CONCRETE	QTY	QUANTITY
ACC	ACCESSIBLE	FOF	FACE OF FINISH		
A/C	AIR CONDITIONING	FOM	FACE OF MASONRY	R	RISER
ACOUS	ACOUSTICAL	FOS	FACE OF STUDS	RA	RADIUS
ADD	ADDENDUM	FR	FRAME (D), (ING)	RAF	RAISED ACCESS FLOOR
ADJ	ADJUSTABLE/ADJACENT	FTG	FOOTING	RCF	REFLECTED CEILING PLAN
AFR	ABOVE FINISHED FLOOR	FURR	FURRED (ING)	RCPT	RECEPTACLE
AGG	AGGREGATE	FUT	FUTURE	RD	ROOF DRAIN
AHU	AIR HANDLING UNIT	FWC	FABRIC WALL COVERING	RDWD	REDWOOD
AIB	AIR INFILTRATION BARRIER			REF	REFERENCE
ALT	ALTERNATE	GA	GAGE, GAUGE	REFR	REFRIGERATOR
ALUM	ALUMINUM	GB	GYPNUM BOARD	RENF	REINFORCE (D), (ING)
ANOD	ANODIZED	GC	GENERAL CONTRACTOR	REM	REMOVE (ABLE)
APC	ACOUSTIC PANEL CEILING	GD	GRADE, GRADING	REQD	REQUIRED
APPROX	APPROXIMATE	GEN	GENERATOR	RES	RESILIENT
APVD	APPROVED	GI	GALVANIZED IRON	RET	RETURN
ARCH	ARCHITECT (URAL)	GKT	GASKET(ED)	REV	REVISION (S), REVISED
		GL	GLASS, GLAZING	RFG	ROOFING
		GLV	GALVANIZED	REL	REFLECT (ED), (IVE), (OR)
BB	BOTTOM OF BEAM	GRG	GLASS REINFORCED GYPSUM	RFM	RECESSED FLOOR MAT
BD	BOARD	GVL	GRAVEL	RH	RIGHT HAND
BEL	BELOW	GYP	GYPSUM	RL	RIDGE LINE
BITUM	BITUMINOUS			RLF	RELIEF
BLDG	BUILDING	H	HIGH	RM	ROOM
BLK	BLOCK	HBB	HOSE BBB	RO	ROUGH OPENING
BLKG	BLOCKING	HB	HOLLOW CORE	ROW	RIGHT OF WAY
BM	BOTTOM	HDB	HARDBOARD	RR	RETURN REGISTER
BRG	BEARING	HDR	HEADER	RWL	RAINWATER LEADER
BRK	BRICK	HDW	HARDWOOD	RWC	RAINWATER CONDUCTOR
BRZ	BRONZE	HDWR	HARDWARE		
BUR	BUILT UP ROOFING	HEX	HEXAGONAL	S	SOUTH
		HM	HOLLOW METAL STEEL	SA	CONTINUOUS SHELF ANGLE
C	CARPET	HOR	HORIZONTAL	SAN	SANITARY
CAB	CABINET	HP	HIGH POINT	SC	SOLID CORE
CB	CATCH BASIN	HS	HOSE STATION	SCI	SCHEDULE
CD	CEILING DIFFUSER	HT	HEIGHT	SD	STORM DRAIN
CEM	CEMENT	HTG	HEATING	SEC	SECTION
CER	CERAMIC	HVAC	HEATING/VENTILATING/	SF	SQUARE FOOT
CF	CUBIC FOOT		AIR CONDITIONING	SFM	STATE FIRE MARSHALL
CFL	COUNTERFLASHING	HW	HOT WATER	SFFA	SQUARE FOOT FREE AREA
CFM	CUBIC FOOT PER MINUTE	ID	INSIDE DIAMETER	SGP	SPANDREL GLASS PANEL
CG	CORNER GUARD	IMP	INSULATED METAL PANEL	SHF	SHELF
CH	CEILING HEIGHT	INCAND	INCANDESCENT	SHLV	SHELVES (ING)
CHAM	CHAMFER	INCL	INCLUDE (D), (ING)	SHT	SHEET
CHBD	CHALKBOARD	INFO	INFORMATION	SHTG	SHEATHING
CI	CAST IRON	INSTR	INSTRUCTIONS	SM	SIMILAR
CJ	CONTRACT JOINT	INSUL	INSULATE (D), (ION)	SKL	SKYLIGHT
CL	CENTER LINE	INT	INTERIOR	SLV	SLEEVE
CLG	CEILING	INV	INVERT	SP	SHELF & POLE
CLGJ	CEILING JOIST			SO	STOREFRONT OPENING
CLR	CLEAR	JC	JANITORS CLOSET	SPR	SINGLE-PLY ROOFING
CT	CERAMIC (TILE)	JST	JOIST	SPRC	SPECIFICATION(S)
CMU	CONCRETE MASONRY UNIT	JT	JOINT	SQ	SQUARE
CNTR	COUNTER			SR	SUPPLY REGISTER
CO	CLEAN OUT	KO	KNOCKOUT	SS	STAINLESS STEEL
COL	COLUMN			STD	STANDARD
COMB	COMBINATION			STL	STEEL
COMP	COMPOSITION (COMPOSITE)	LAD	LADDER	STN	STONE
CONC	CONCRETE	LAM	LAMINATED	STO	STORAGE
CONT	CONTINUOUS OR CONTINUE	LAV	LAVATORY	STRT	STRUCTURE (AL)
CONST	CONSTRUCTION	LB	LAC BOLT	STW	STORM WATER
CORR	CORRUGATED	LBL	LABEL	SUBSTA	SUBSTATION
COTE	CLEAN OUT THRU FLOOR	LH	LEFT HAND	SV	SHEET VINYL
COTE	CLEAN OUT TO GRADE	LNTL	LINTEL	SYS	SYSTEM
COTW	CLEAN OUT THRU WALL	LP	LOW POINT		
CR	CURB RETURN	LTG	LIGHTING		
CRTNW	CURTAIN WALL	LVR	LOUVER		
CSK	COUNTERSINK			T	TREAD
CSMT	CASEMENT	MAS	MASONRY	TB	TOWEL BAR
CTSK	COUNTERSUNK SCREW	MATL	MATERIAL	TBB	TOP & BOTTOM
CTR	CENTER	MAX	MAXIMUM	TELE	TELEPHONE
CVT	CONDUCTIVE VINYL TILE	MB	MACHINE BOLT	TEMP	TEMPERED
CW	COLD WATER	MBR	MODIFIED BITUMEN ROOFING	T&G	TONGUE AND GROOVE
		MC	MEDICINE CABINET	THK	THICKNESS
D	DEPTH	MECH	MECHANICAL	THRU	THROUGH
DBL	DBL	MED	MEDIUM	TJ	TOOL JOINT
DET	DETAIL	MFG	MANUFACTURING	TMBD	TACKBOARD
DF	DRINKING FOUNTAIN	MFR	MANUFACTURE(R)	TO	TOP OF
DIA	DIAMETER	MGS	METAL GRAVEL STOP	TOM	TOP OF MASONRY
DIAG	DIAGONAL	MH	MANHOLE	TOR	TOP OF BEAM
DM	DIMENSION	MIN	MINIMUM	TOS	TOP OF STEEL, SLAB or STRUCTURE
DIV	DIVISION	MIR	MIRROR	TOW	TOP OF WALL
DLD	DEAD LOAD	MISC	MISCELLANEOUS	TP	TOILET PAPER DISPENSER
DN	DOWN	MLD	MOLDING, MOULDING	TPN	TOILET PARTITION
DP	DAMP PROOFING	MMB	MEMBRANE	TS	TOP OF SHEATHING
DPRS	DEPRESSED	MO	MASONRY OPENING	TSS	TOP SET BASE
DR	DOOR	MOD	MODULAR	TSB	TOP OF SLAB
DS	DOWNSPOUT	MT	METAL THRESHOLD	TSLS	TOP OF SLAB
DIS	DISPENSER	MNT	MOUNTED), (ING)	T&T	T-BAR ACOUSTIC TILE
DWG	DRAWING	MTL	METAL	TV	TELEVISION
DWR	DRAWER	MUL	MULLION	TV	TYPICAL
				U	UNIVERSAL
E	ENAMEL	N	NORTH	UON	UNLESS OTHERWISE NOTED
EA	EACH				
EC	ELECTRICAL CONTRACTOR	(N)	NEW	V	VINYL
EDF	ELECTRIC DRINKING FOUNTAIN	NAT	NATURAL	VAR	VARIABLES
EEW	EMERGENCY EYEWASH	NIC	NOT IN CONTRACT	VB	VAPOR BARRIER
EF	ELASTOMERIC FLASHING	NO	NUMBER	VCT	VINYL COMPOSITION TILE
EPS	EXTERIOR INSULATED FIN. SYS.	NOM	NOMINAL	VCTB	VINYL COVERED TACKBOARD
EJ	EXPANSION JOINT	NTS	NOT TO SCALE	VERT	VERTICAL
ELEV	ELEVATION	O'	OVER	VEST	VESTIBULE
ELEC	ELECTRIC (AL)	OA	OVERALL	VGR	VISION GLASS PANEL
EMER	EMERGENCY	OBS	OBSCURE	VNR	VENER
ENAM	ENAMEL	OC	ON CENTER	VNT	VENT
ENCL	ENCLOSE (URE)	OD	OUTSIDE DIAMETER	VO	VENT OVER/OFFSET
EO	EQUAL	OED	OVERFLOW DRAIN	VR	VENT RISER
EQPT	EQUIPMENT	OH	OPPOSITE HAND	VTR	VENT THROUGH ROOF
ER	EXHAUST REGISTER	OPQ	OPENING	VWC	VINYL WALL COVERING
EW	EACH WAY	OPP	OPPOSITE	WI	WITH
EWG	ELECTRIC WATER HEATER	OPT	OPTIONAL	WBL	WOOD BLOCKING
EXH	EXHAUST			WC	WATER CLOSET
EXIST	EXISTING	PBD	PARTICLE BOARD	WD	WOOD
(E)	EXISTING	PCPL	PORTLAND CEMENT PLASTER	WG	WIRED GLASS
EXP	EXPOSED	PERIM	PERIMETER	WHC	WALL HUNG CABINET
EXT	EXTERIOR	PERF	PERFORATED	WI	WINDIGHT IRON
EXTING	EXTINGUISHER	PFB	PREFABRICATED	WK	WORK
FA	FIRE ALARM	PL	PROPERTY LINE	WM	WIRE MESH
FAB	FABRICATION	PLAM	PLASTIC LAMINATE	W/O	WITHOUT
FAC	FACTORY	PLAS	PLASTER	WP	WATERPROOFING
FAS	FASTEN, FASTENER	PLT (P)	PLATE	WR	WEATHER RESISTANT
FBD	FIBERBOARD	PNT	PAINTED	WSCOT	WAINSCOT
FBGL	FIBERGLASS	POC	POINT OF CONNECTION	WST	WASTE
FBLK	FIRE BLOCKING	PR	PAIR	WTHP	WEATHERPROOF
FBO	FURNISHED BY OTHERS	PRCST	PRECAST	WWF	WEDED WIRE FABRIC
FD	FLOOR DRAIN	PROJ	PROJECT		
FEC	FIRE EXTINGUISHER CABINET	PRTD	PRESSURE TREATED	&	AND
FF	FINISHED FLOOR	PT	POINT	@	AT
FG	FIXED GLASS	PTD	PAINTED	C	CENTER LINE
FHC	FIRE HOSE CABINET	PTN	PARTITION	Ø	DIAMETER
FHMS	FLATHEAD MACHINE SCREW	PVA	POLYVINYL ACETATE	⊞	SQUARE FEET
FHWS	FLATHEAD WOOD SCREW	PVC	POLYVINYL CHLORIDE		
FIN	FINISHED				
FJ	FLOOR JOIST				
FLR	FLOORING				
FLSH	FLASHING				
FLUOR	FLUORESCENT				

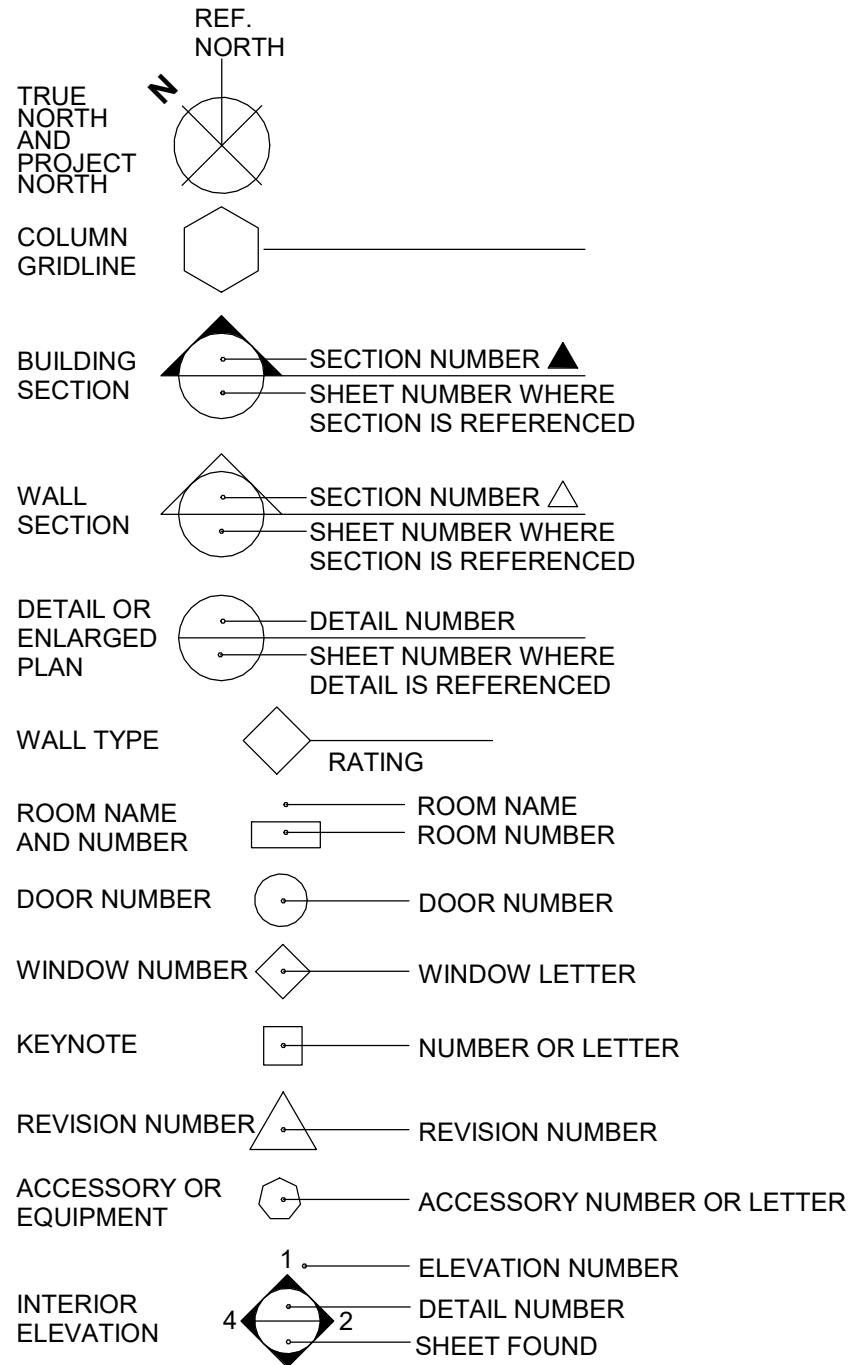


41 SYMBOLS

- DO NOT SCALE PLANS.
- ALL CONSTRUCTION SHALL CONFORM WITH TITLE 24 AND THE 2019 CBC, CMC, CPC, AND 2019 CEC AMENDMENTS AND COUNTY OF SANTA CLARA.
- ALL DIMENSIONS ARE TO BE VERIFIED IN THE FIELD. ANY DISCREPANCIES ARE TO BE IMMEDIATELY BROUGHT TO THE ATTENTION OF THE ARCHITECT. DO NOT PROCEED WITHOUT RESOLVING DISCREPANCIES.
- DIMENSIONS SHOWN SHALL TAKE PRECEDENCE OVER DRAWINGS SCALE OR PROPORTION. LARGER SCALE DRAWINGS TAKE PRECEDENCE OVER SMALLER SCALE DRAWINGS.
- REQUIRED SANITARY FACILITIES SHALL BE PROVIDED ON THE JOB.
- OMISSIONS AND/OR CONFLICTS IN THE DRAWINGS SHALL NOT RELIEVE THE CONTRACTOR FROM COMPLETING WORK WHICH IS NECESSARY TO CARRY OUT THE INTENT OF THE DRAWING AND/OR COMPLETE WORK TO STANDARDS REQUIRED BY CODE.
- THESE NOTES INDICATE CONSTRUCTION FOR PROPOSED RESIDENCE UNLESS OTHERWISE NOTED OR SHOWN. FEATURES OF CONSTRUCTION SHOWN ARE TYPICAL AND SHALL APPLY TO ALL DRAWINGS UNLESS OTHERWISE NOTED OR SHOWN. FEATURES OF CONSTRUCTION SHOWN ARE TYPICAL AND SHALL APPLY GENERALLY THROUGHOUT TO SIMILAR CONDITIONS, UNLESS NOTED OTHERWISE ALL VESTIBULES, CLOSETS, COLUMNS PROJECTIONS, RECESSES, OR OTHER ADJACENT AREAS WITHIN SCHEDULED AREAS SHALL HAVE FINISHES AS SCHEDULED FOR THE RESPECTIVE SPACES IN WHICH THEY OCCUR. ALL OMISSIONS OR CONFLICTS BETWEEN THE VARIOUS ELEMENTS OF THE WORKING DRAWINGS AND/OR GENERAL NOTES SHALL BE BROUGHT TO THE ATTENTION OF THE OWNER BEFORE PROCEEDING WITH ANY WORK SO INVOLVED.
- ALL WORK, AND ALL CONSTRUCTION METHODS AND MATERIALS SHALL COMPLY WITH ALL PROVISIONS OF THE BUILDING CODES AND OTHER RULES, REGULATIONS AND ORDINANCES GOVERNING THE PLACE OF THE BUILDING. BUILDING CODE REQUIREMENTS IN ALL CASES TAKE PRECEDENCE OVER THE DRAWING. IT SHALL BE THE RESPONSIBILITY OF ANYONE SUPPLYING LABOR OR MATERIALS OR BOTH TO BRING TO THE ATTENTION OF THE ARCHITECT ANY DISCREPANCIES OR CONFLICTS BETWEEN THE REQUIREMENTS OF THE CODE AND THE DRAWINGS.
- UNLESS NOTED OTHERWISE, ALL DIMENSIONS ARE TO FACE OF FINISH.
- CONTRACTOR SHALL ARRANGE AND PAY FOR ALL TEMPORARY UTILITY SERVICES AND CONNECTIONS DURING CONSTRUCTION.
- ANY CHANGES IN CONSTRUCTION SHALL BE ACCOMPANIED BY A CHANGE ORDER ISSUED BY THE GENERAL CONTRACTOR AND APPROVED BY THE OWNER.
- THE CONTRACT DRAWINGS AND SPECIFICATIONS REPRESENT THE FINISHED IMPROVEMENTS, UNLESS OTHERWISE SHOWN. THEY DO NOT INDICATE METHOD OF CONSTRUCTION. CONTRACTOR SHALL SUPERVISE AND DIRECT WORK AND SHALL BE SOLELY RESPONSIBLE FOR ALL CONSTRUCTION MEANS, METHODS TECHNIQUES, SEQUENCES AND PROCEDURES. OBSERVATION VISITS TO THE SITE SHALL NOT INCLUDE INSPECTIONS OF THE PROTECTIVE MEASURES OR THE CONSTRUCTION PROCEDURES REQUIRED FOR SAME, WHICH ARE THE SOLE RESPONSIBILITY OF THE CONTRACTOR.
- CONTRACTOR HEREBY GUARANTEES TO THE OWNER THAT ALL MATERIALS, FIXTURES, AND EQUIPMENT FURNISHED TO THE PROJECT ARE NEW UNLESS OTHERWISE SPECIFIED.
- ANYONE SUPPLYING LABOR AND/OR MATERIALS TO THE PROJECT SHALL CAREFULLY EXAMINE ALL SUBSURFACES TO RECEIVE WORK. ANY CONDITIONS DETRIMENTAL TO WORK SHALL BE REPORTED TO THE ARCHITECT/OWNER. COMMENCEMENT OF WORK SHALL IMPLY ACCEPTANCE OF ALL SUBSURFACES.
- ANY MATERIAL STORED AT THE SITE SHALL BE COMPLETELY SUPPORTED FREE OF THE GROUND, COVERED AND OTHERWISE PROTECTED TO AVOID DAMAGE.
- PRIOR TO FINAL INSPECTION, AS A DEFERRED SUBMITTAL ITEM, PROVIDE A FINAL COPY OF BUILDING OPERATION AND MAINTENANCE MANUAL TO BUILDING INSPECTOR. CALGREEN 4.410, 4.504.5.1

OVERALL PROJECT:

CONSTRUCTION OF A NEW SINGLE FAMILY RESIDENCE, ADU AND BARN. SINGLE FAMILY RESIDENCE IS 1-STORY AND CONSISTS OF 3-BEDS, 3-BATH, 2 HALF BATH, AND A 3-CAR GARAGE. ADU IS 1-STORY AND CONSISTS OF 2-BEDS AND 2-BATHS.

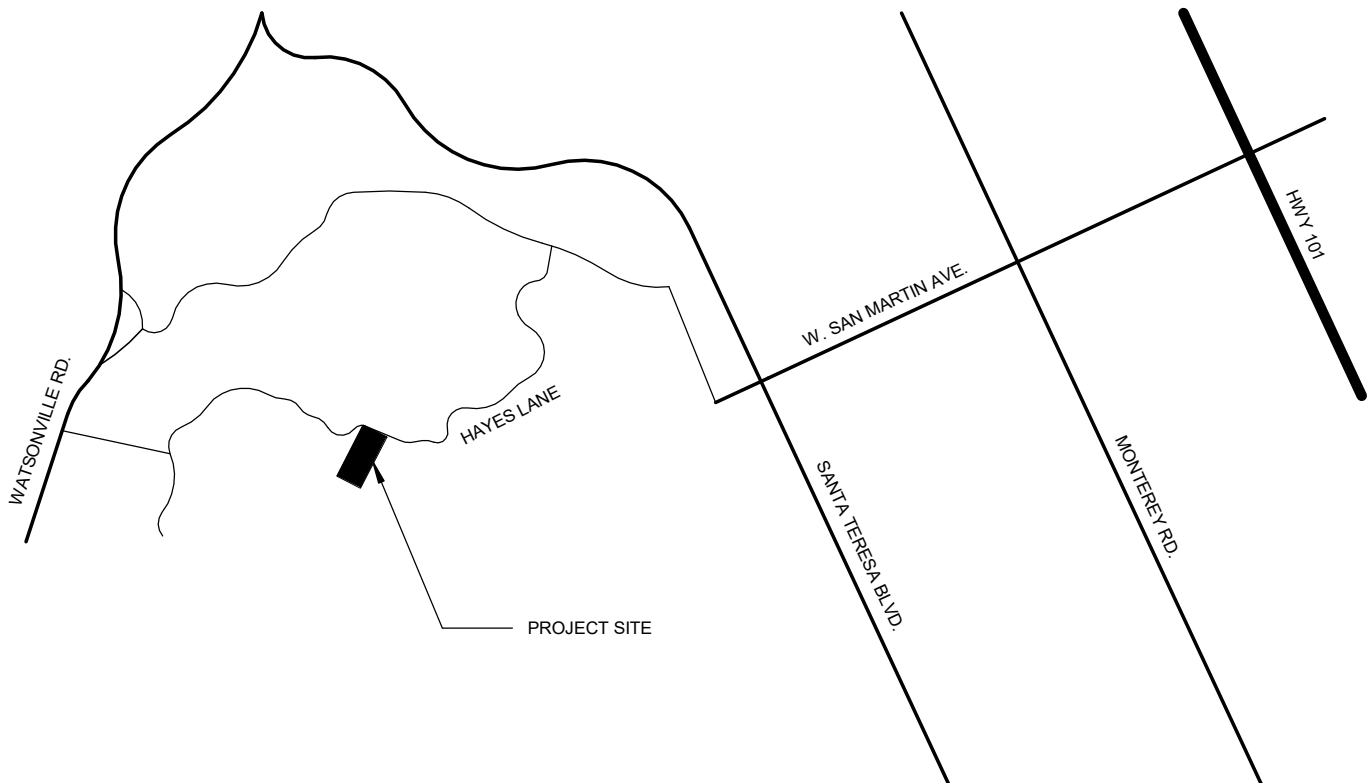

24 VICINITY MAP

N.T.S.



54 ABBREVIATIONS

44 GENERAL NOTES

34 PROJECT DESCRIPTION

24 VICINITY MAP

N.T.S.

14 PROJECT INFORMATION

DATE: 03/10/22

TECHNICIAN: JDM

PROJECT MANAGER: AGD

JOB NUMBER: 597
SHEET NUMBER

G 0.0

AGD

ARCHITECTURE | DESIGN

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REVISIONS

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SEAL

NOT FOR CONSTRUCTION

PROJECT

PARMAR RESIDENCE

HAYES LANE

SAN MARTIN, CA 95046

APN#: 779-44-014

CLIENT

ABISHEK PARMAR

SHEET TITLE

SITE PLAN

DATE:

03/10/22

TECHNICIAN:

JDM

PROJECT MANAGER:


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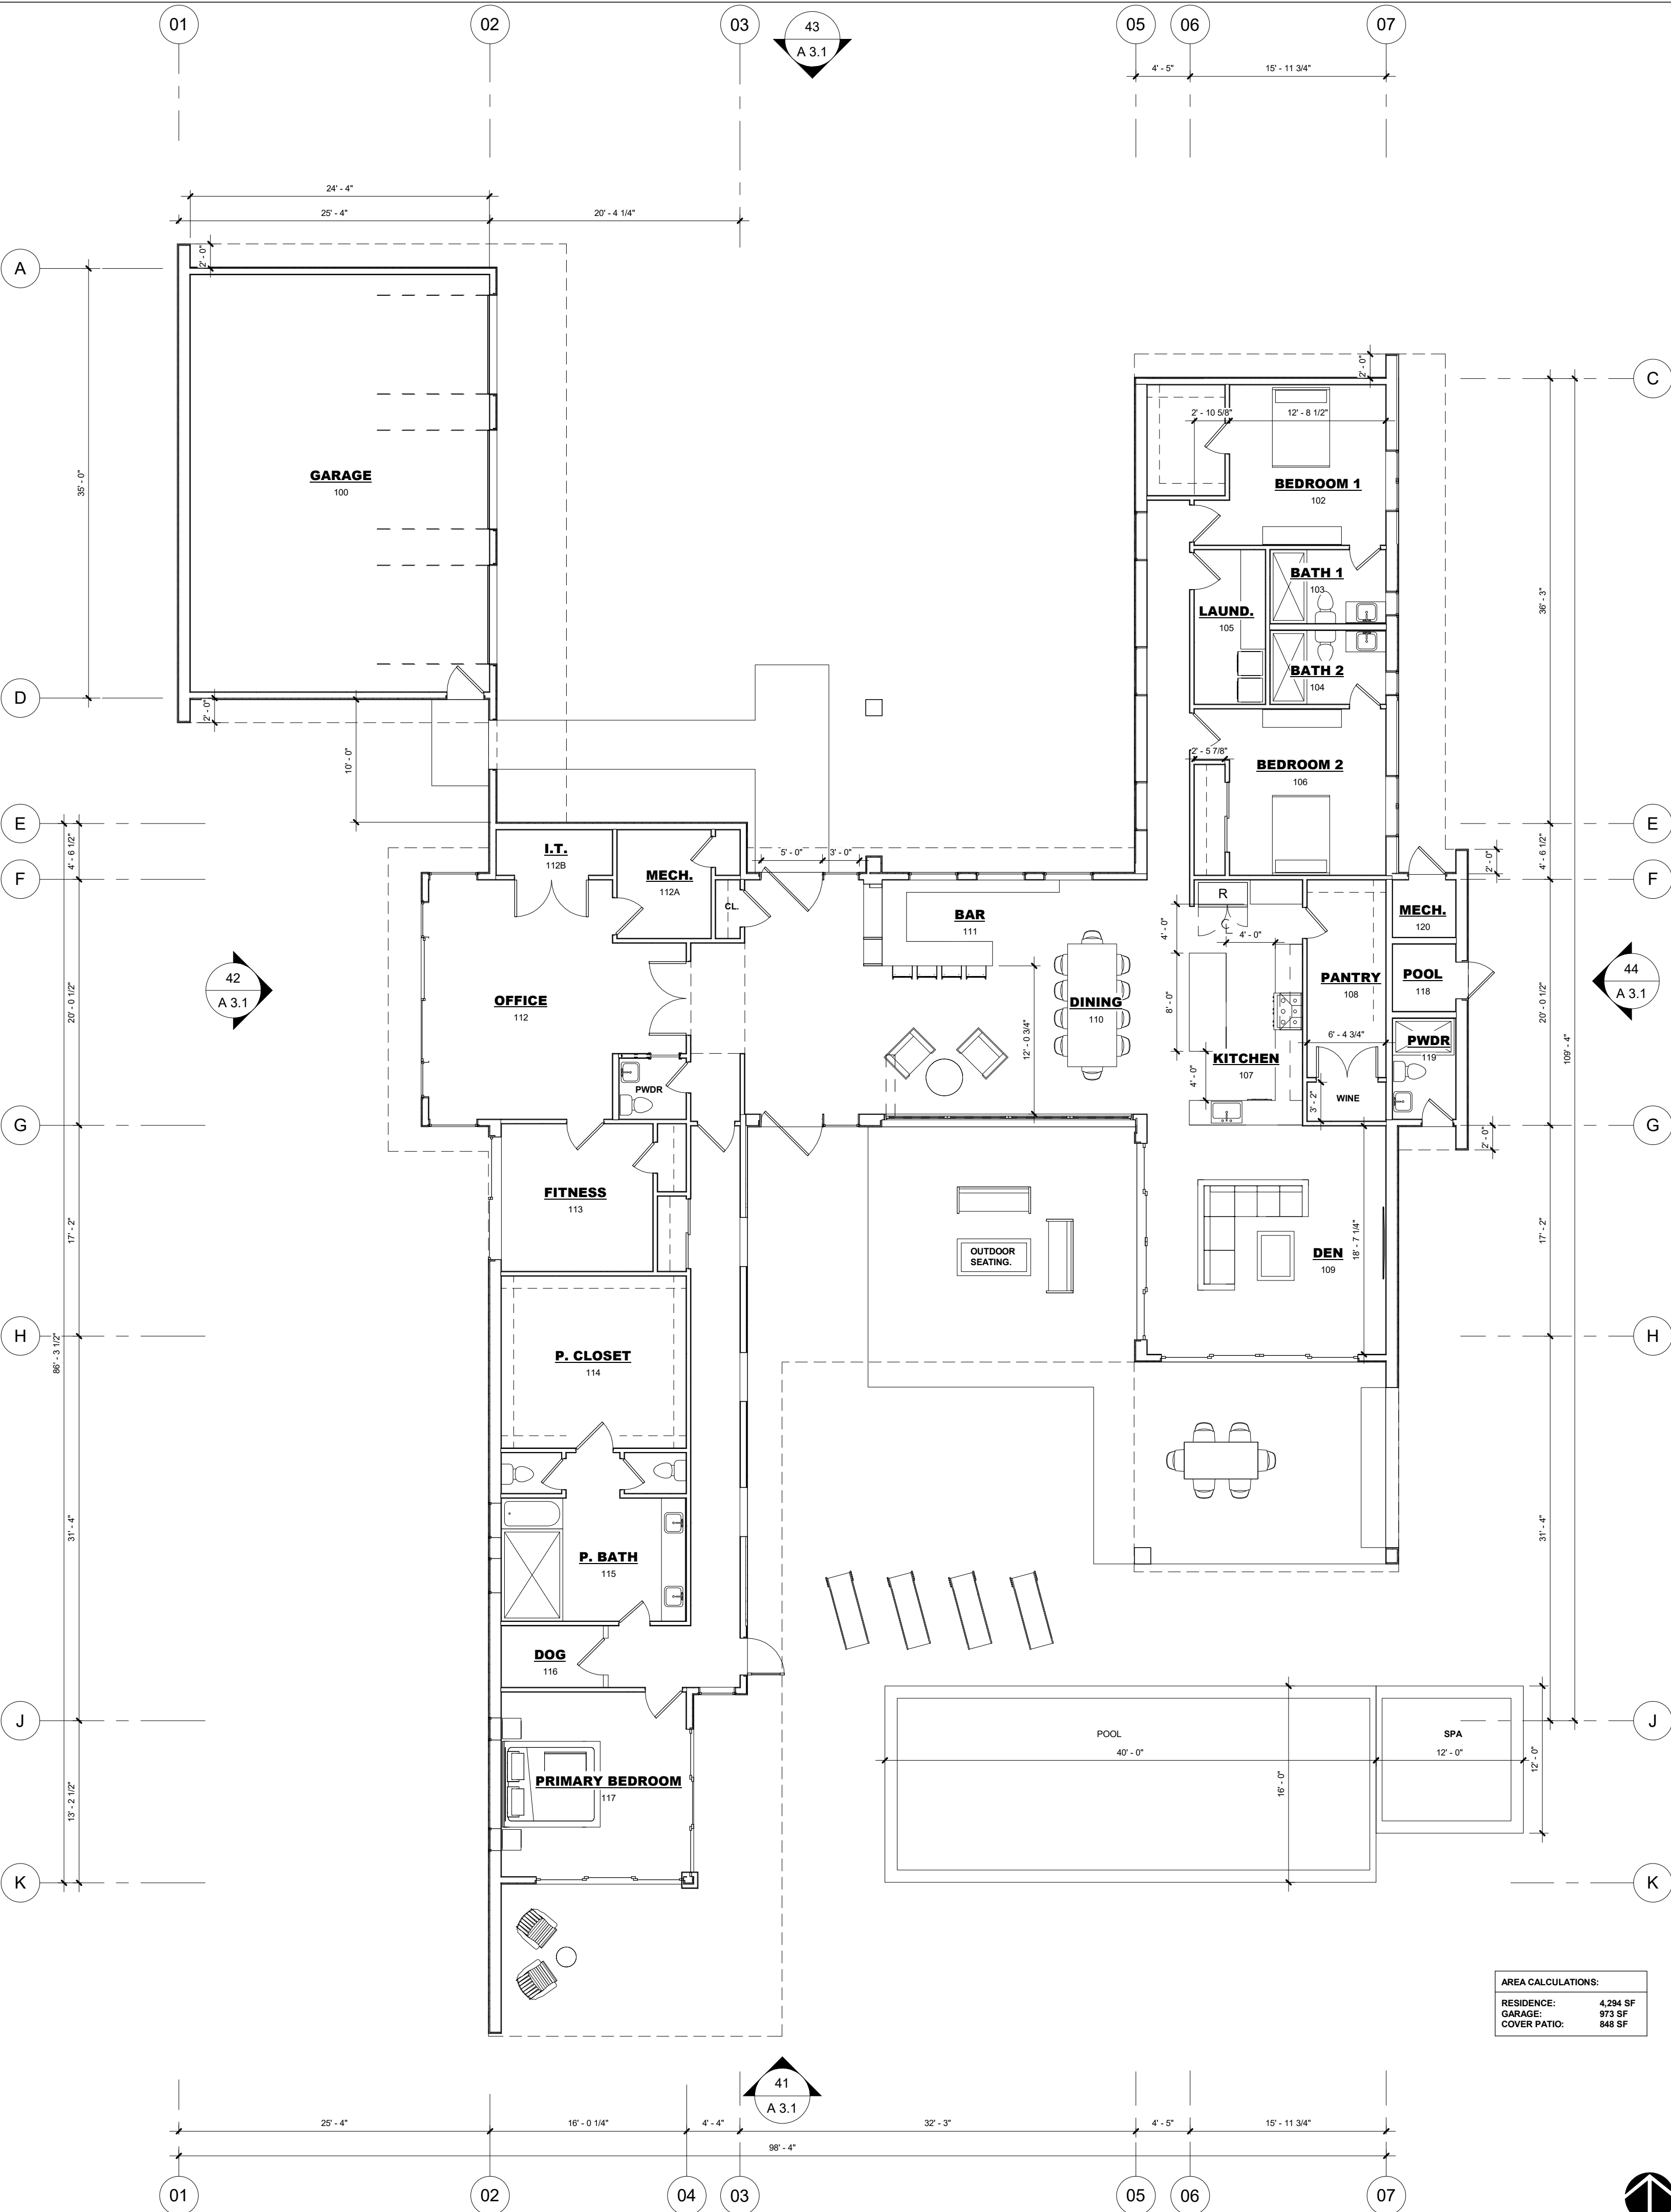
JOB NUMBER:

597

SHEET NUMBER

A 1.0



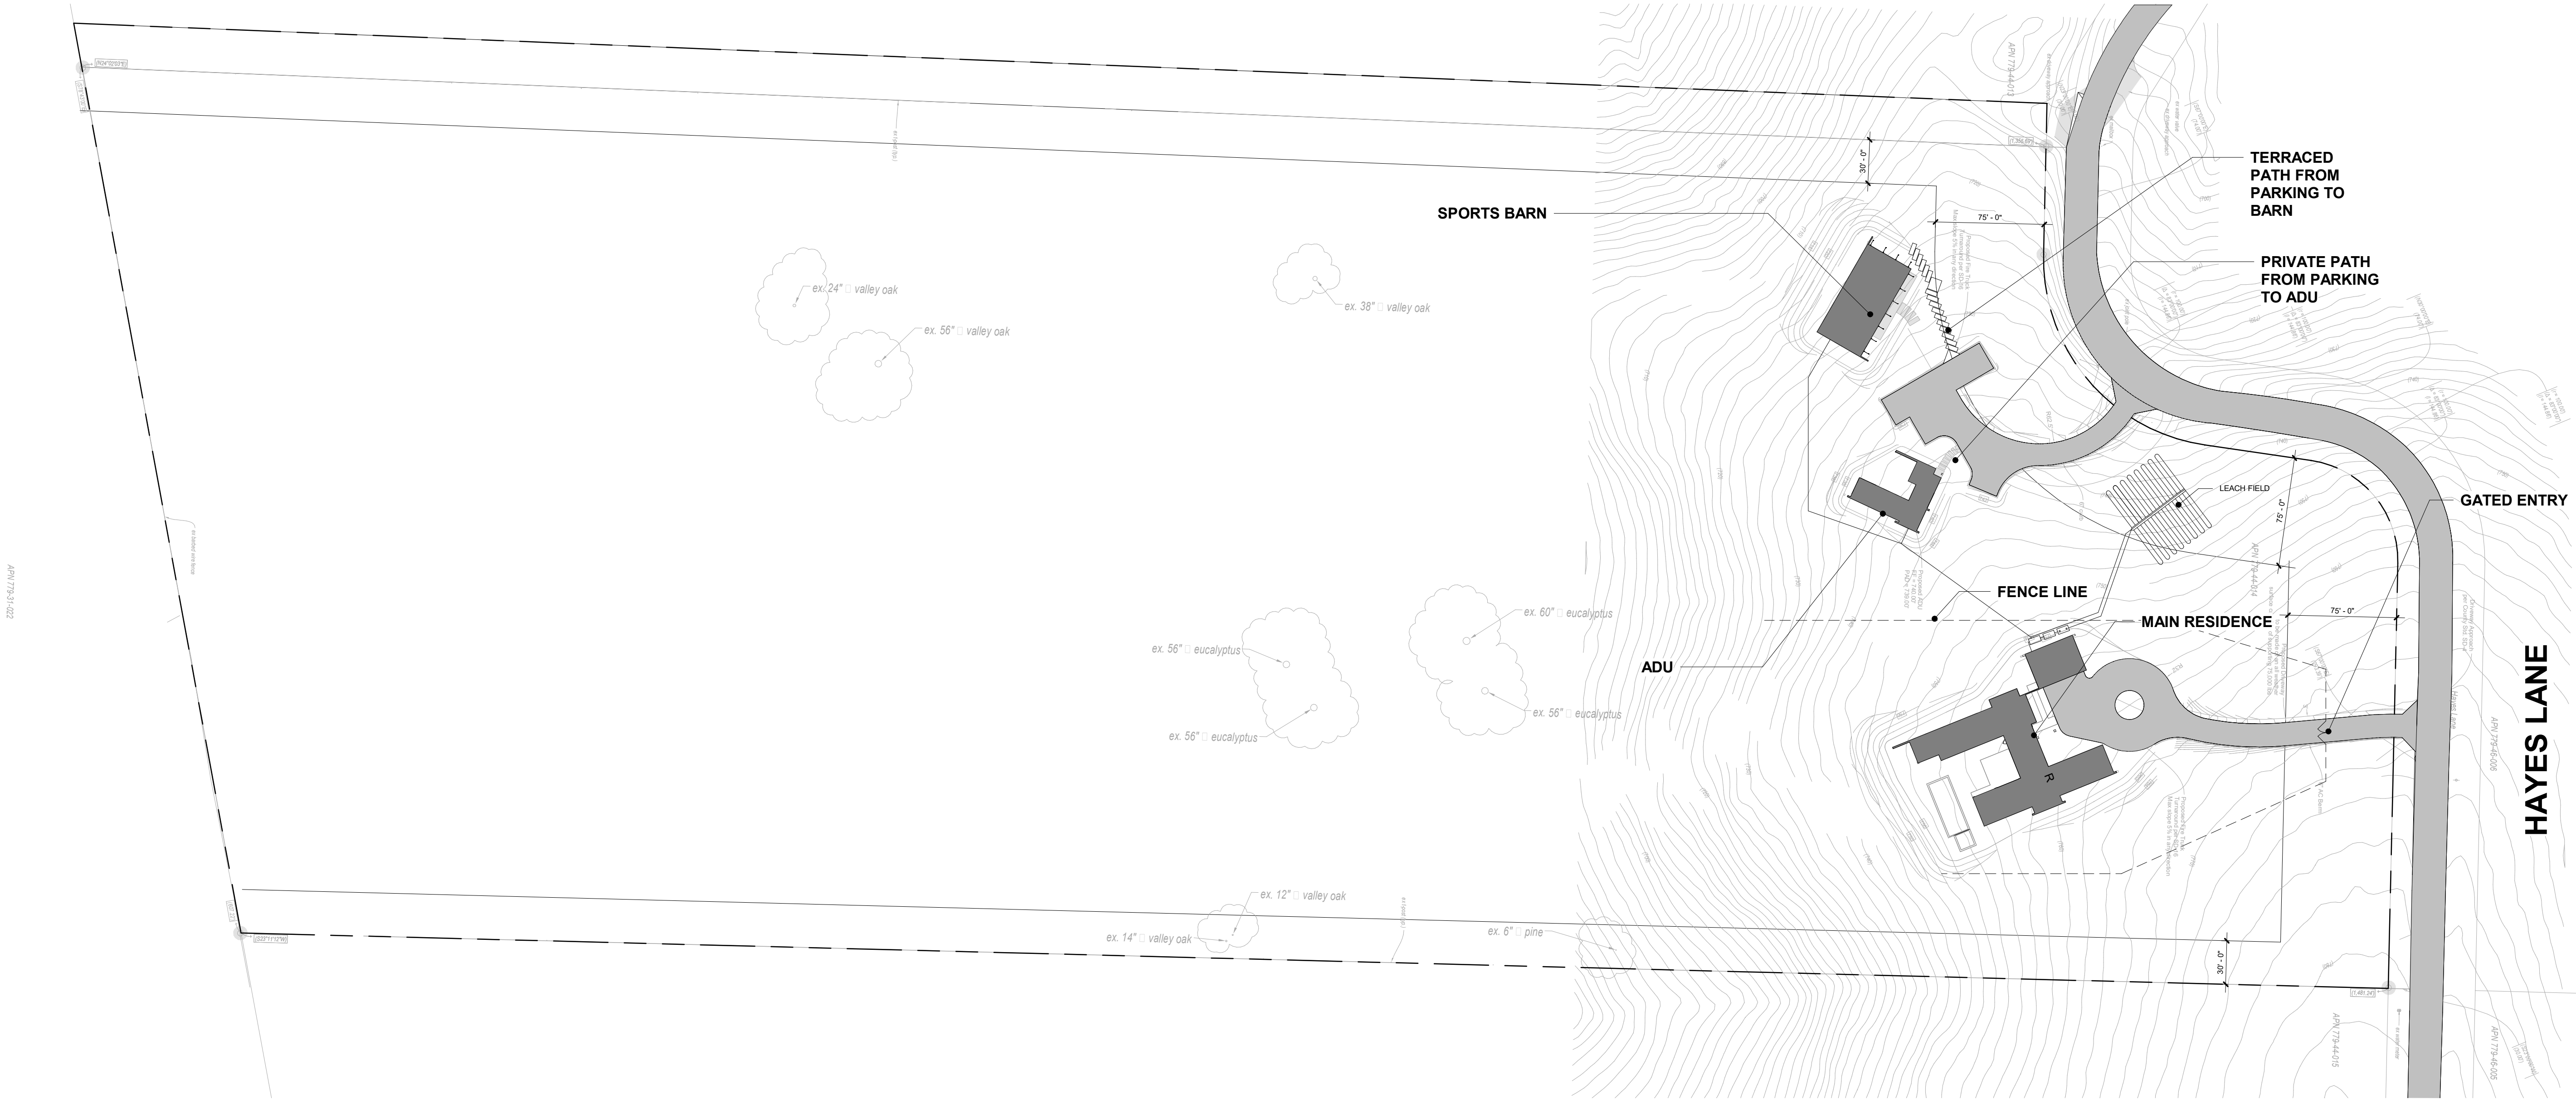

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HAYES LANE
SAN MARTIN, CA 95064

APN#: 779-44-014

ABHISHEK PARMAR

OF PLAN


TE: 00/00/2022

TECHNICIAN: Author

PROJECT MANAGER

B NUMBER: 000
SHEET NUMBER


A 2.3

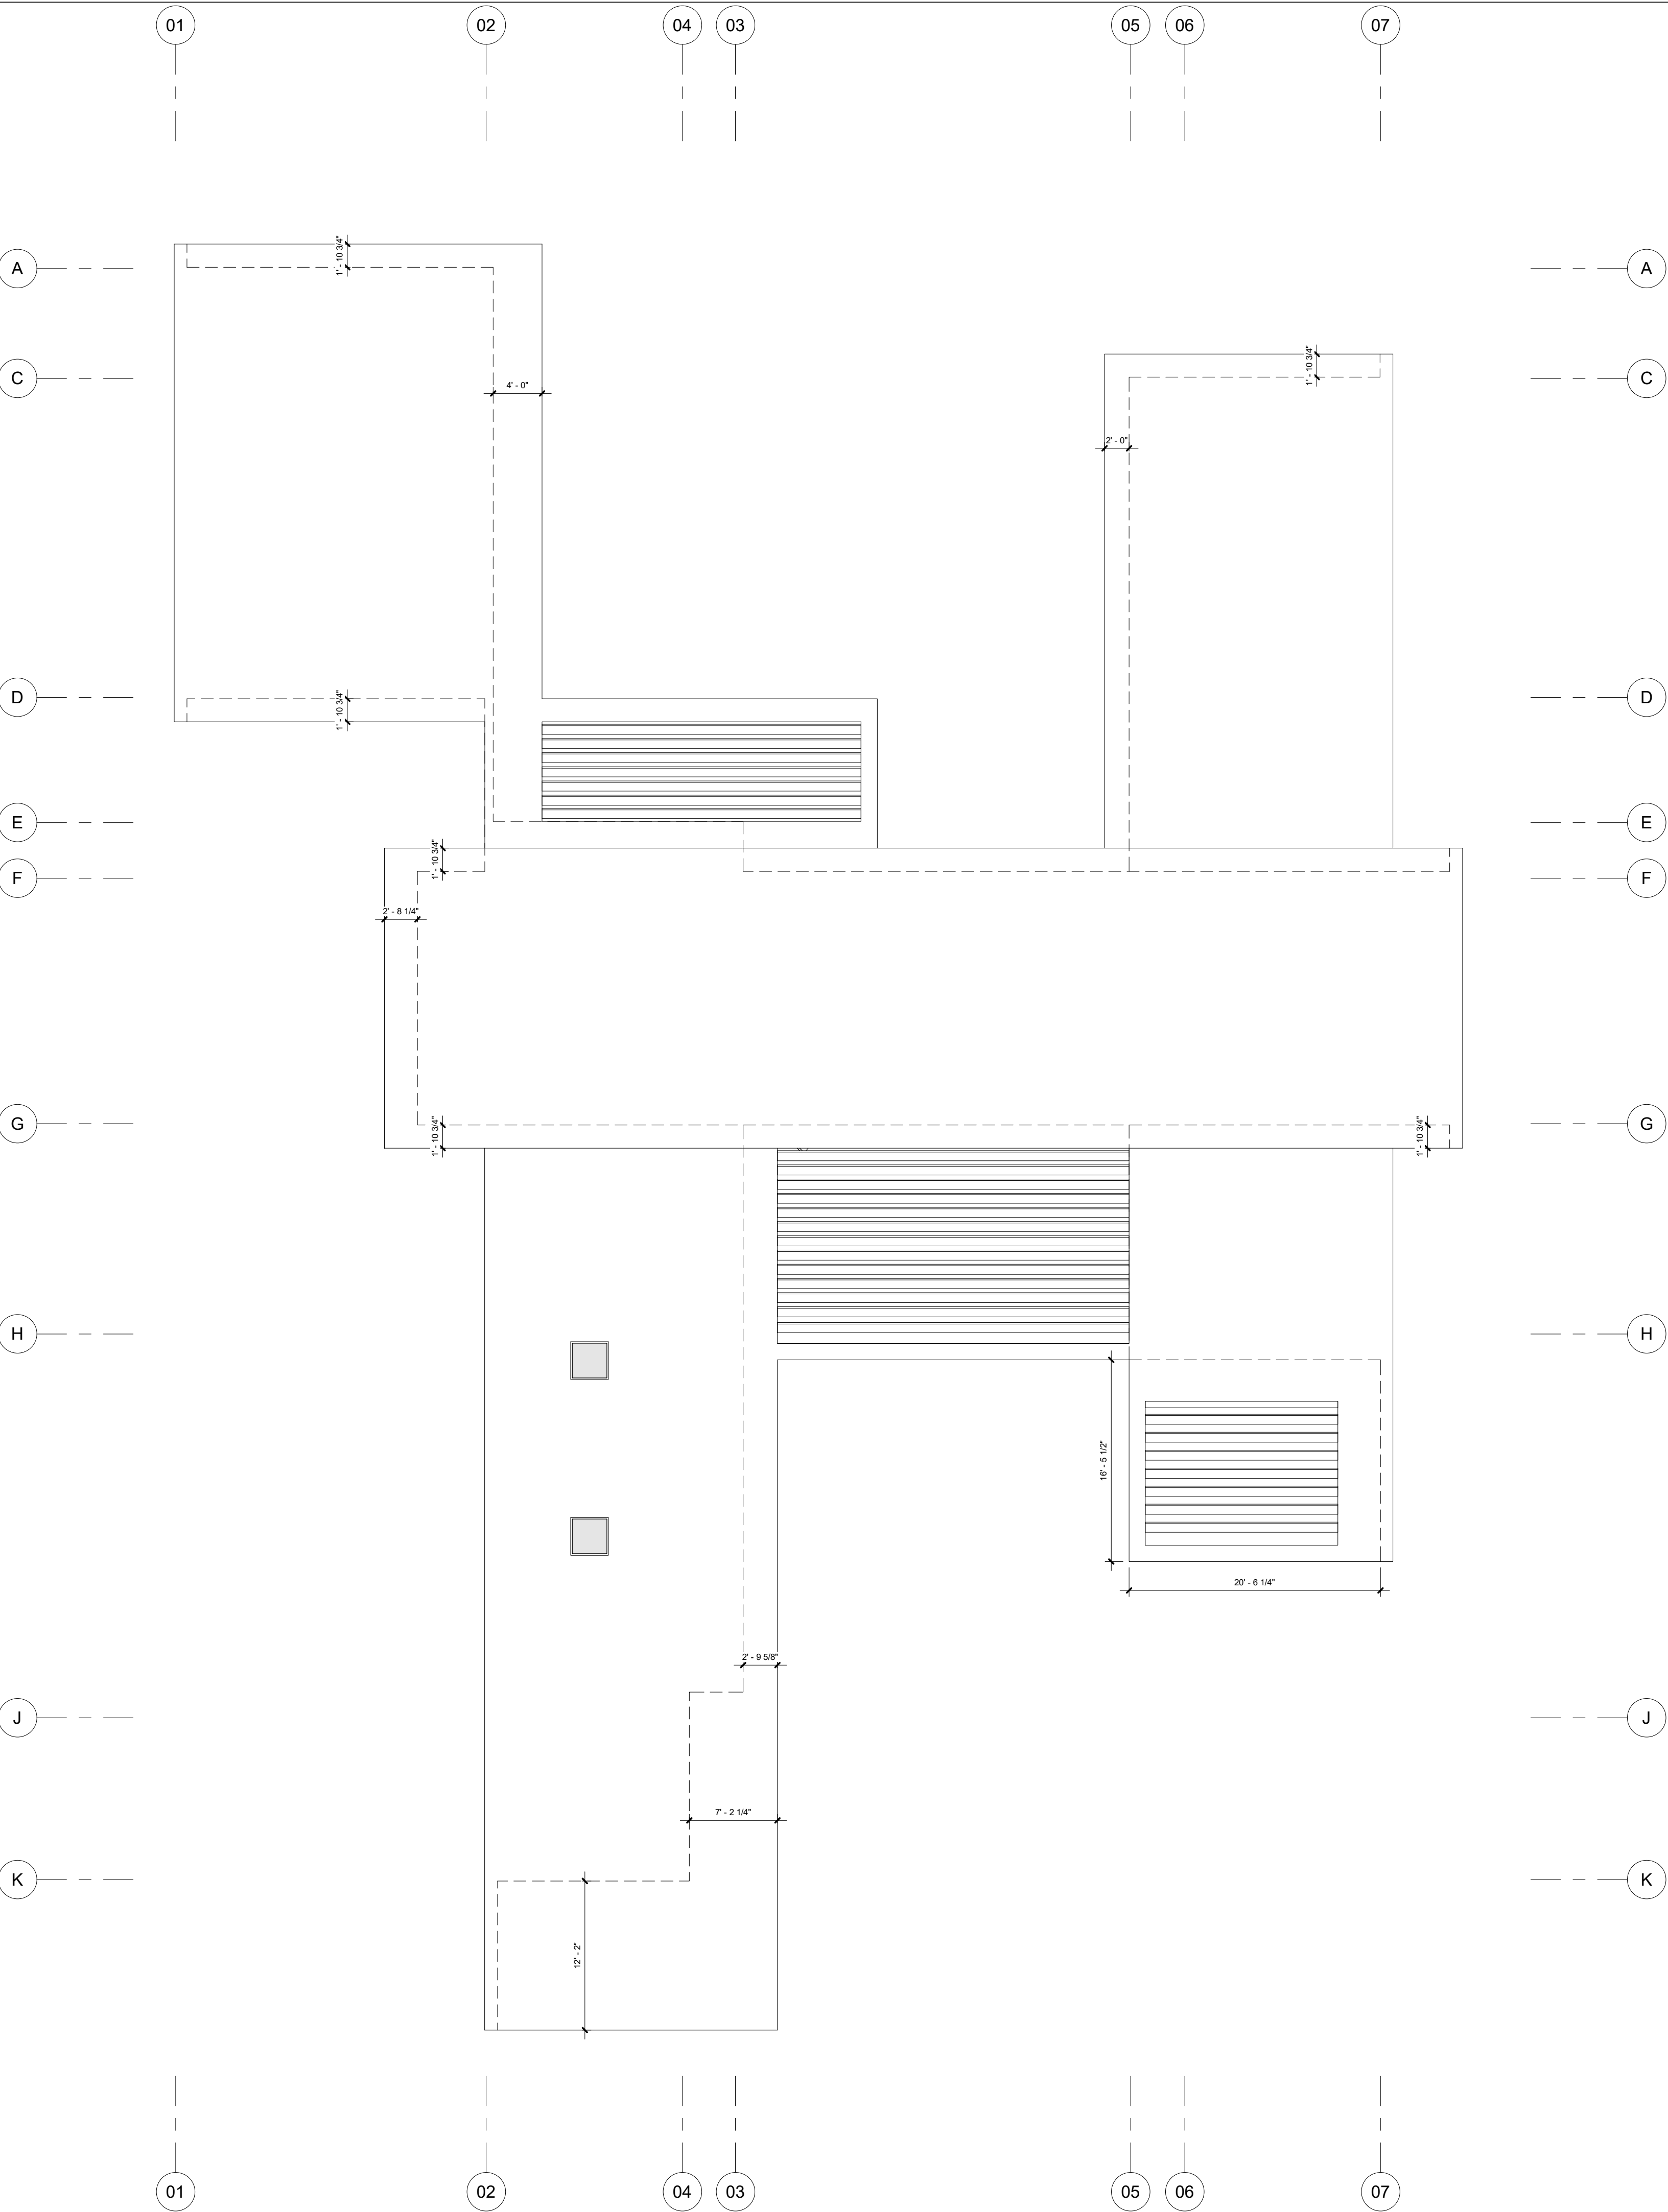


ANNOTATION:

— — — — 1. LINE/OBJECT ABOVE


..... 2. LINE/OBJECT BELOW

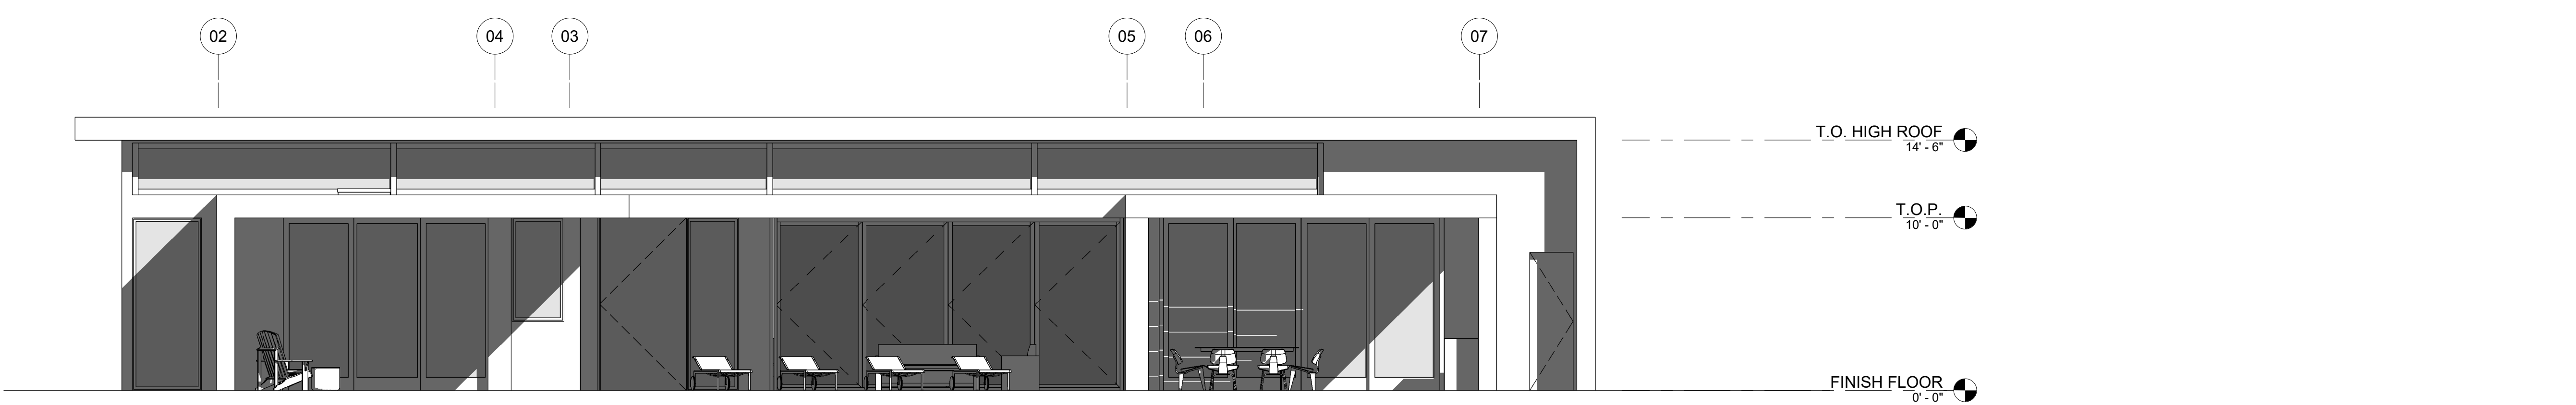


41 REAR ELEVATION
3/16" = 1'-0"

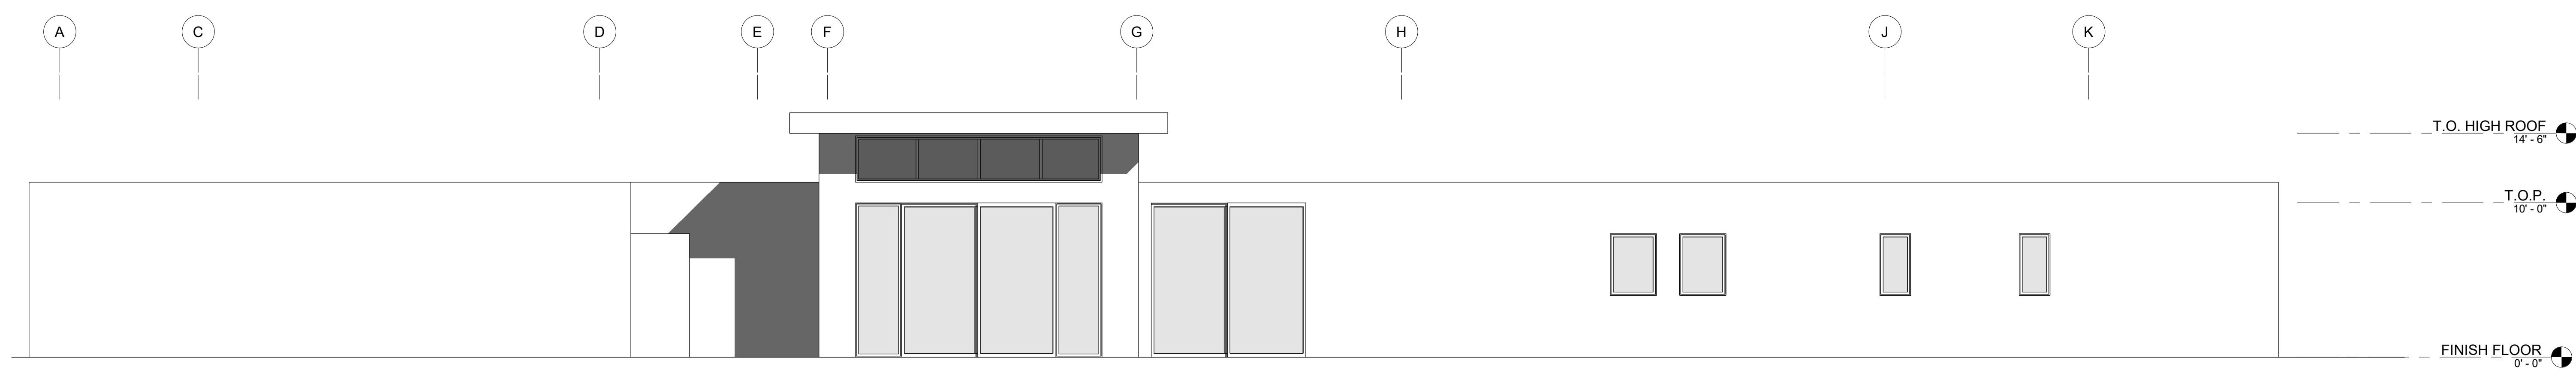

42 EAST ELEVATION
3/16" = 1'-0"

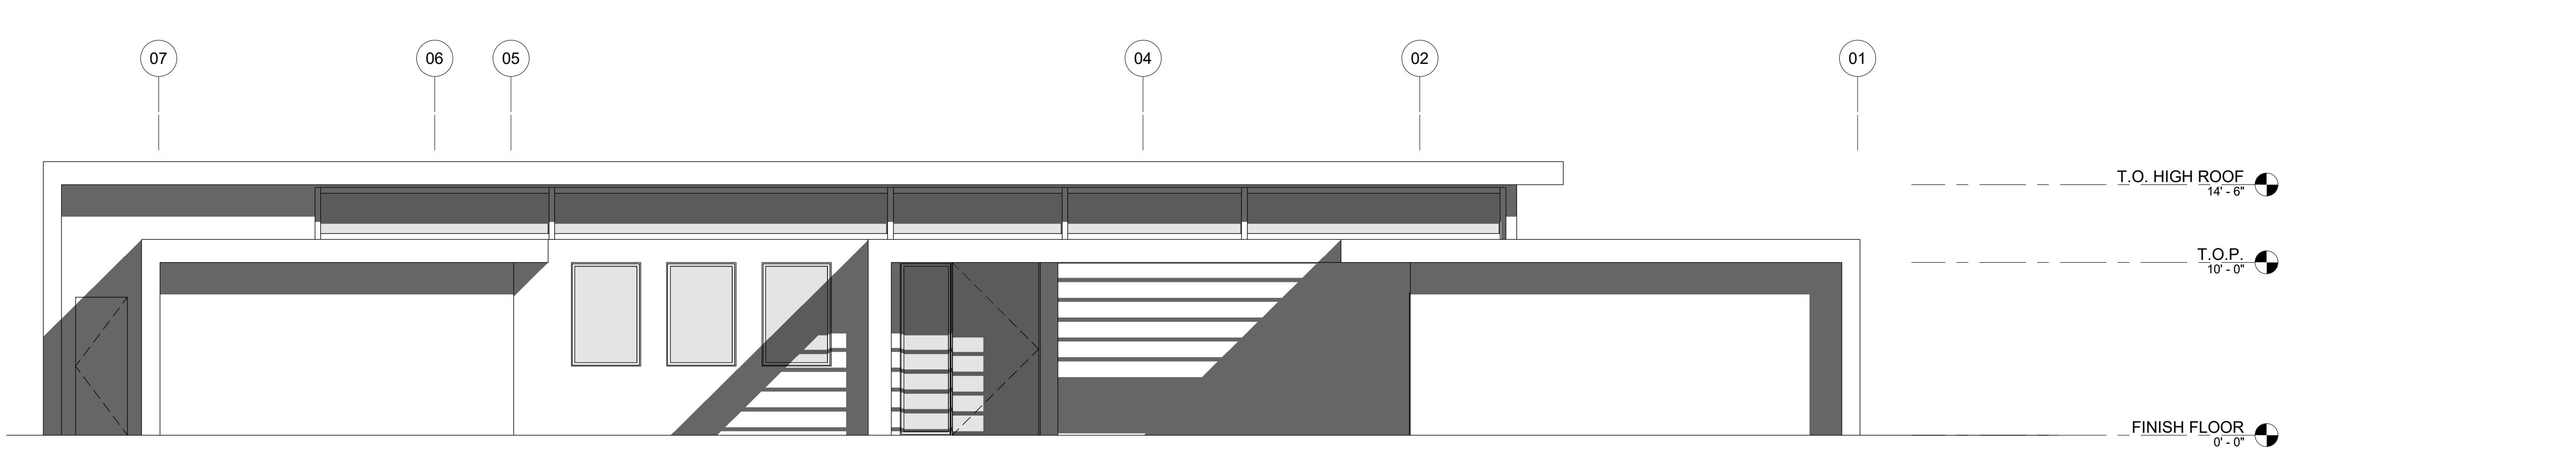

43 FRONT ELEVATION
3/16" = 1'-0"

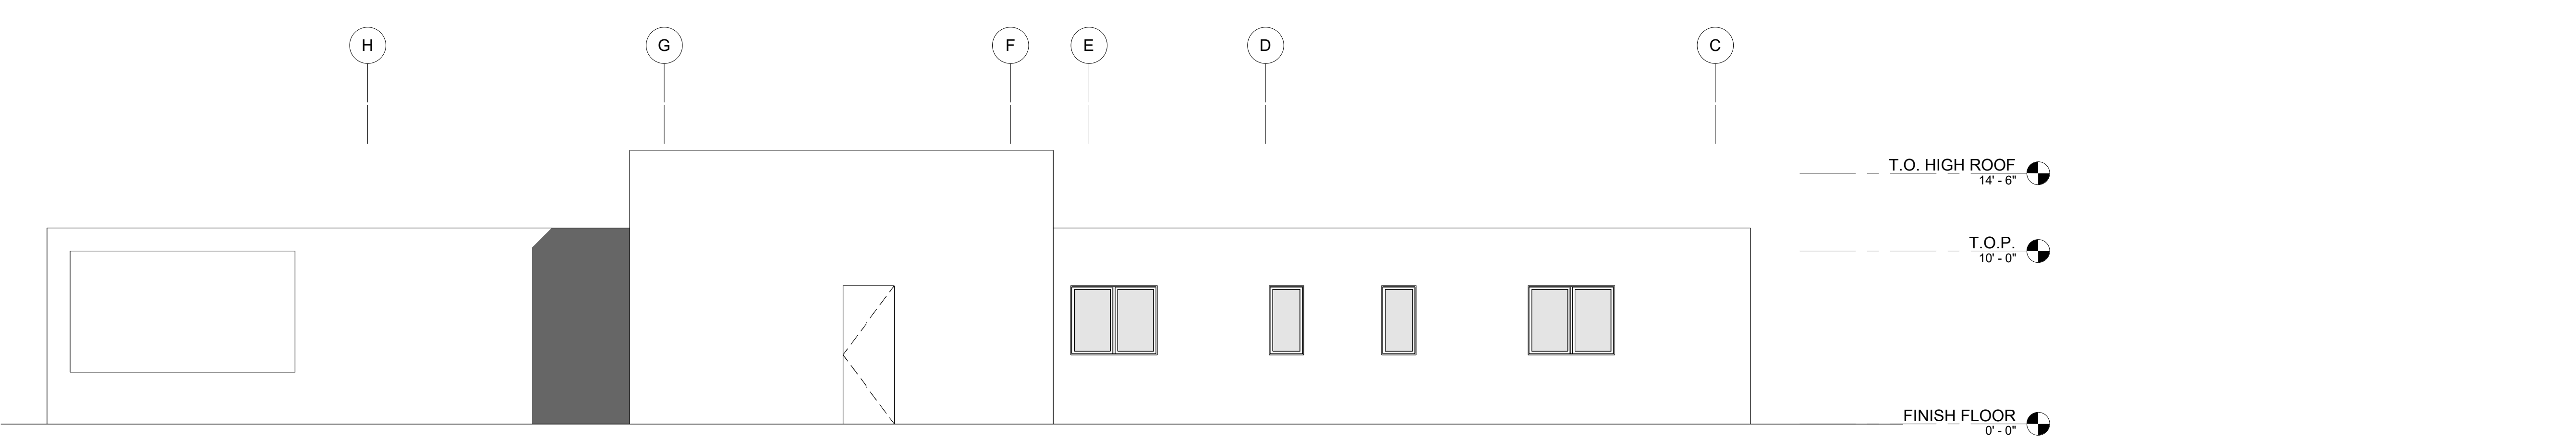

44 WEST ELEVATION
3/16" = 1'-0"

AGD

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APN#: 779-44-014

CLIENT
ABHISHEK PARMAR

SHEET TITLE

ELEVATIONS

DATE:

00/00/2022

TECHNICIAN:

Author

PROJECT MANAGER:


Designer

JOB NUMBER:

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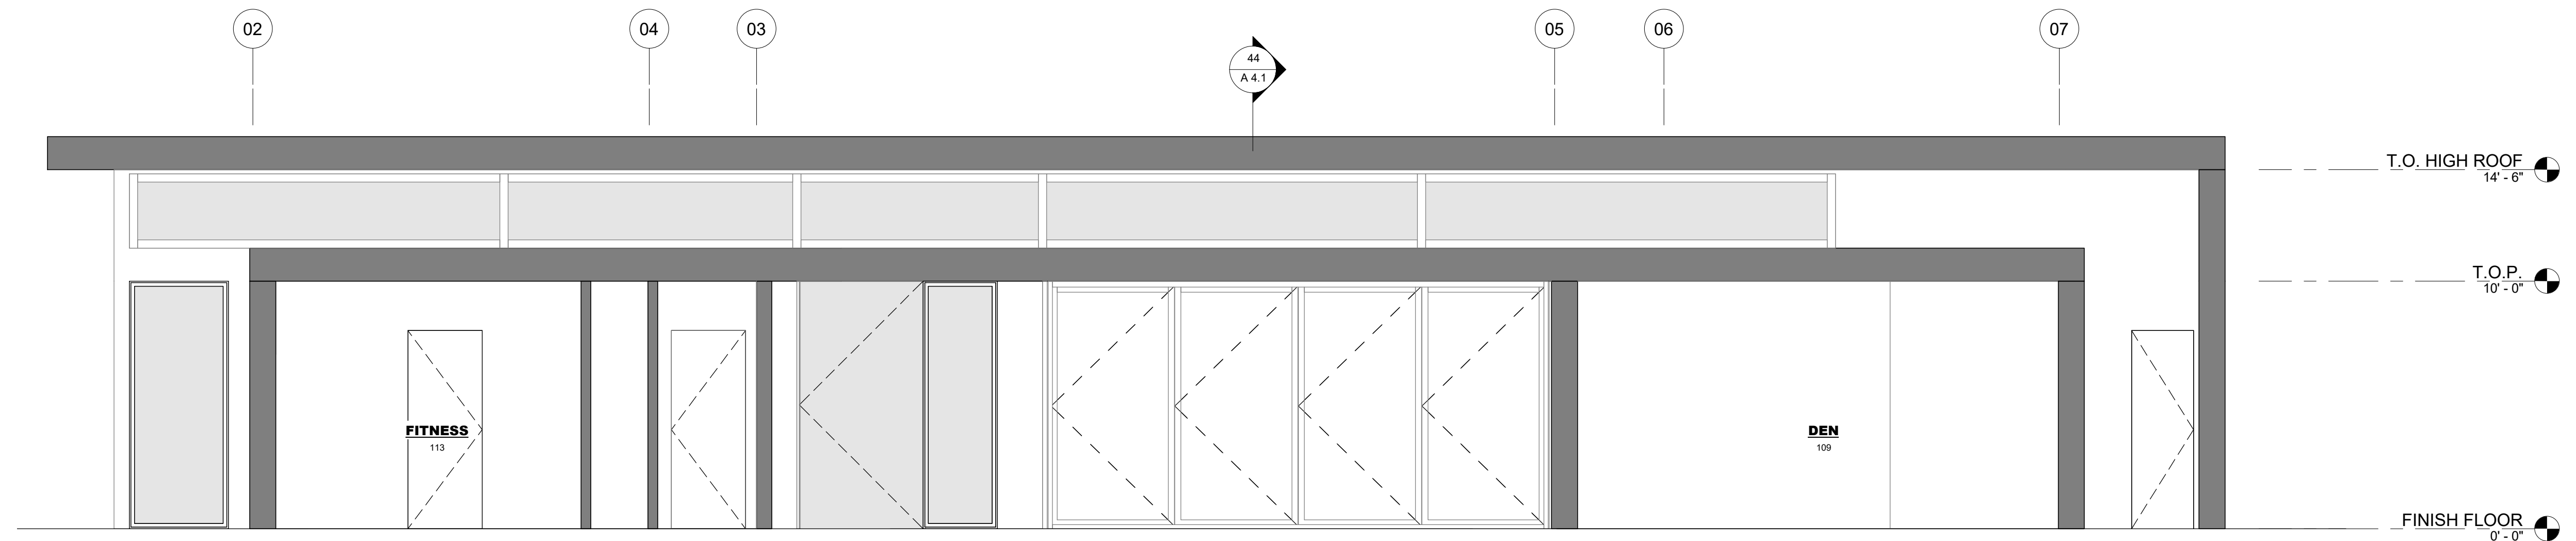
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A 3.1




41 SECTION 2

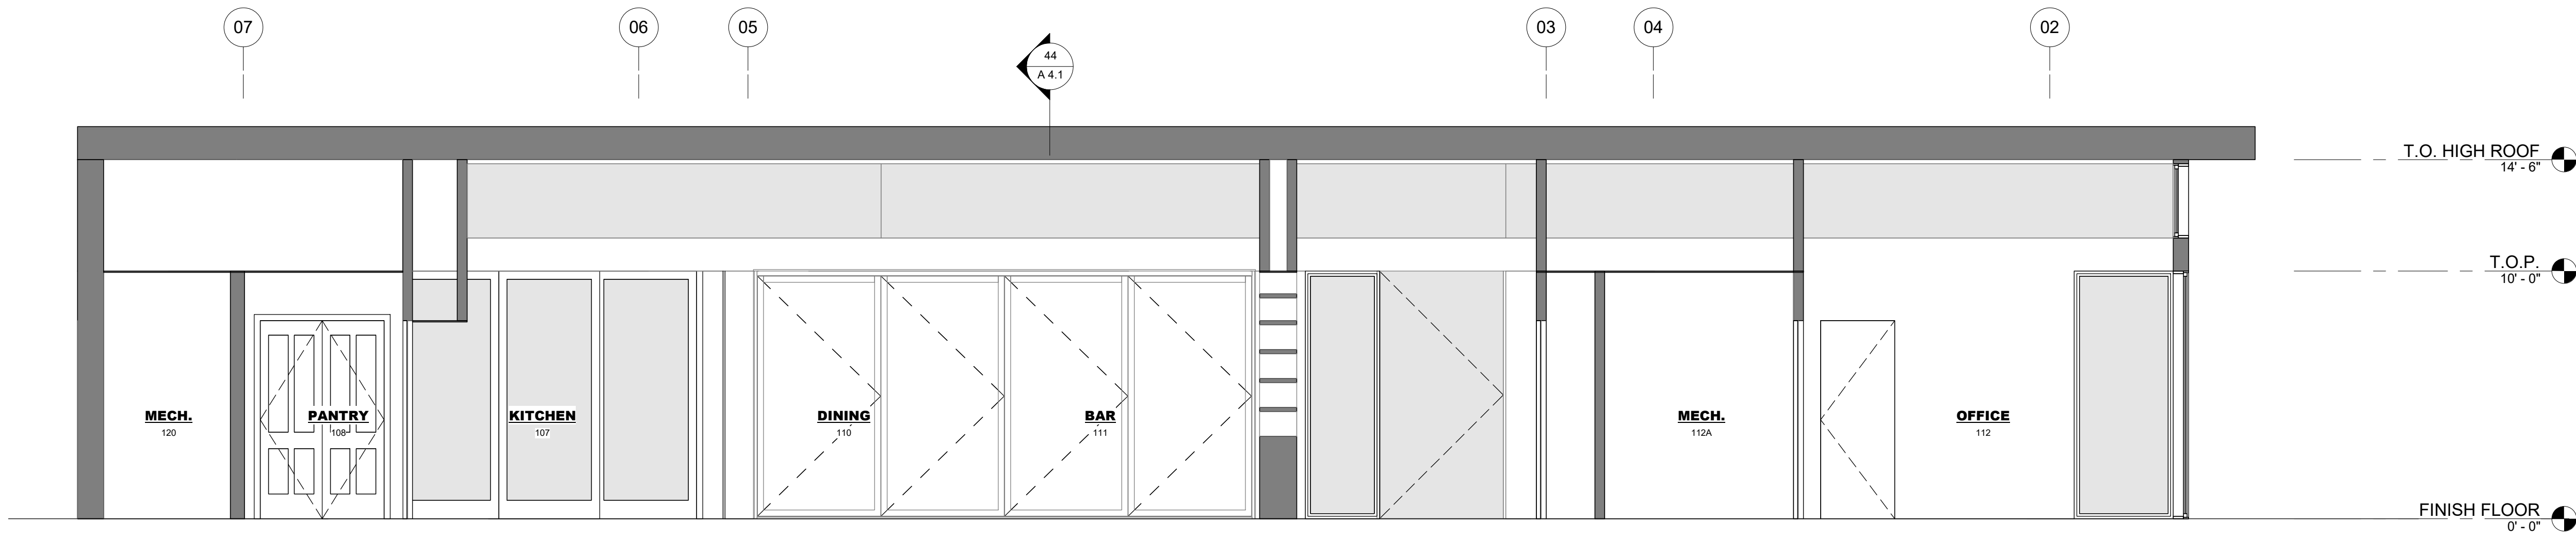1/4" = 1'-0"



43 SECTION 3

1/4" = 1'-0"

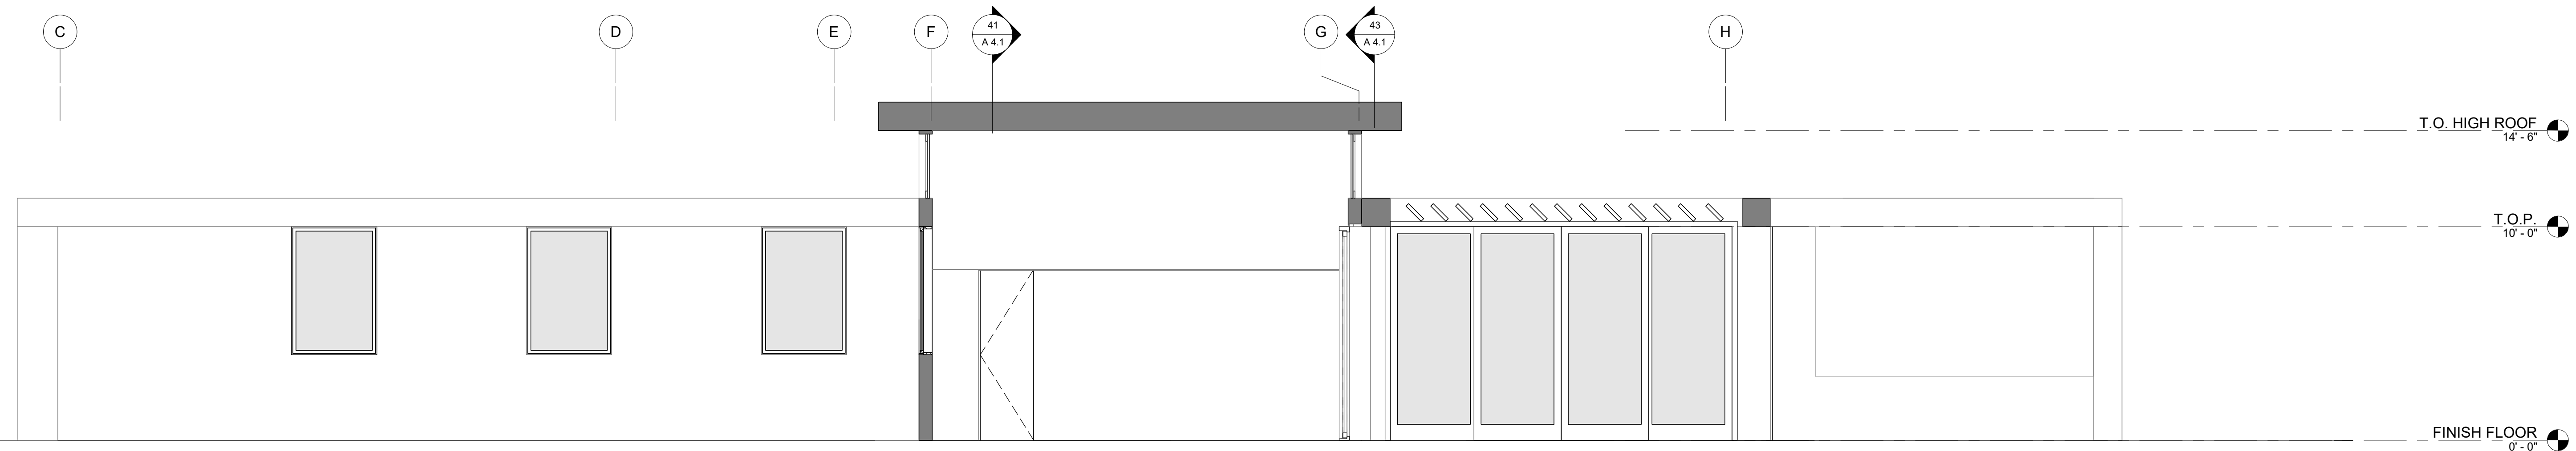

44 SECTION 1

1/4" = 1'-0"

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HAYES LANE
AN MARTIN, CA 95046
APN#: 779-44-014

ABHISHEK PARMAR

FLOOR PLANS_FIRST
FLOOR


DATE: 07/01/2022

TECHNICIAN: SR

PROJECT MANAGER: AGD

JOB NUMBER: 597
SHEET NUMBER

AA 2.1

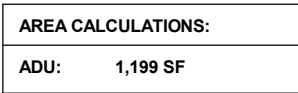

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NOT FOR
CONSTRUCTION

APN#: 779-44-014

ABHISHEK PARMAR

1. FLASHING AND COUNTER FLASHING OF VENTS AND ROOF TO WALL CONNECTIONS ARE TO COMPLY WITH R703.8 AND R903.2 CRC FLASHING AT SLOPE TO FLAT WALL ARE TO RECEIVE STEPPED FLASHING.
2. ROOF COVERINGS IN HIGH FIRE HAZARD SVERITY ZONES AND ALL OTHER AREAS SHALL BE FIRE RETARDANT CLASS B MINIMUM UNLESS PROHIBITED BY THE LOCAL FIRE AGENCY.
3. ROOF SHEATHING SHALL BE INSTALLED WITH RADIANT BARRIER CONTRACTOR TO SUBMIT SHEATHING OR RADIANT BARRIER MATERIAL SPECIFICATIONS PRIOR TO MAIL FOR APPROVAL BY ARCHITECT.

1. LOW SLOPE SINGLE PLY MEMBRANE ROOF OVER RIGID INSULATION OVER 5/8" USG SECUROCK CEMENT ROOF BOARD
2. INTEGRATED TRELLIS

— — — — 1. LINE/OBJECT ABOVE

. 2. LINE/OBJECT BELOW

ROOF PLAN


DATE: 03/10/22


TECHNICIAN: JDM

PROJECT MANAGER: AGD


JOB NUMBER: 597
SHEET NUMBER

AA 2.2

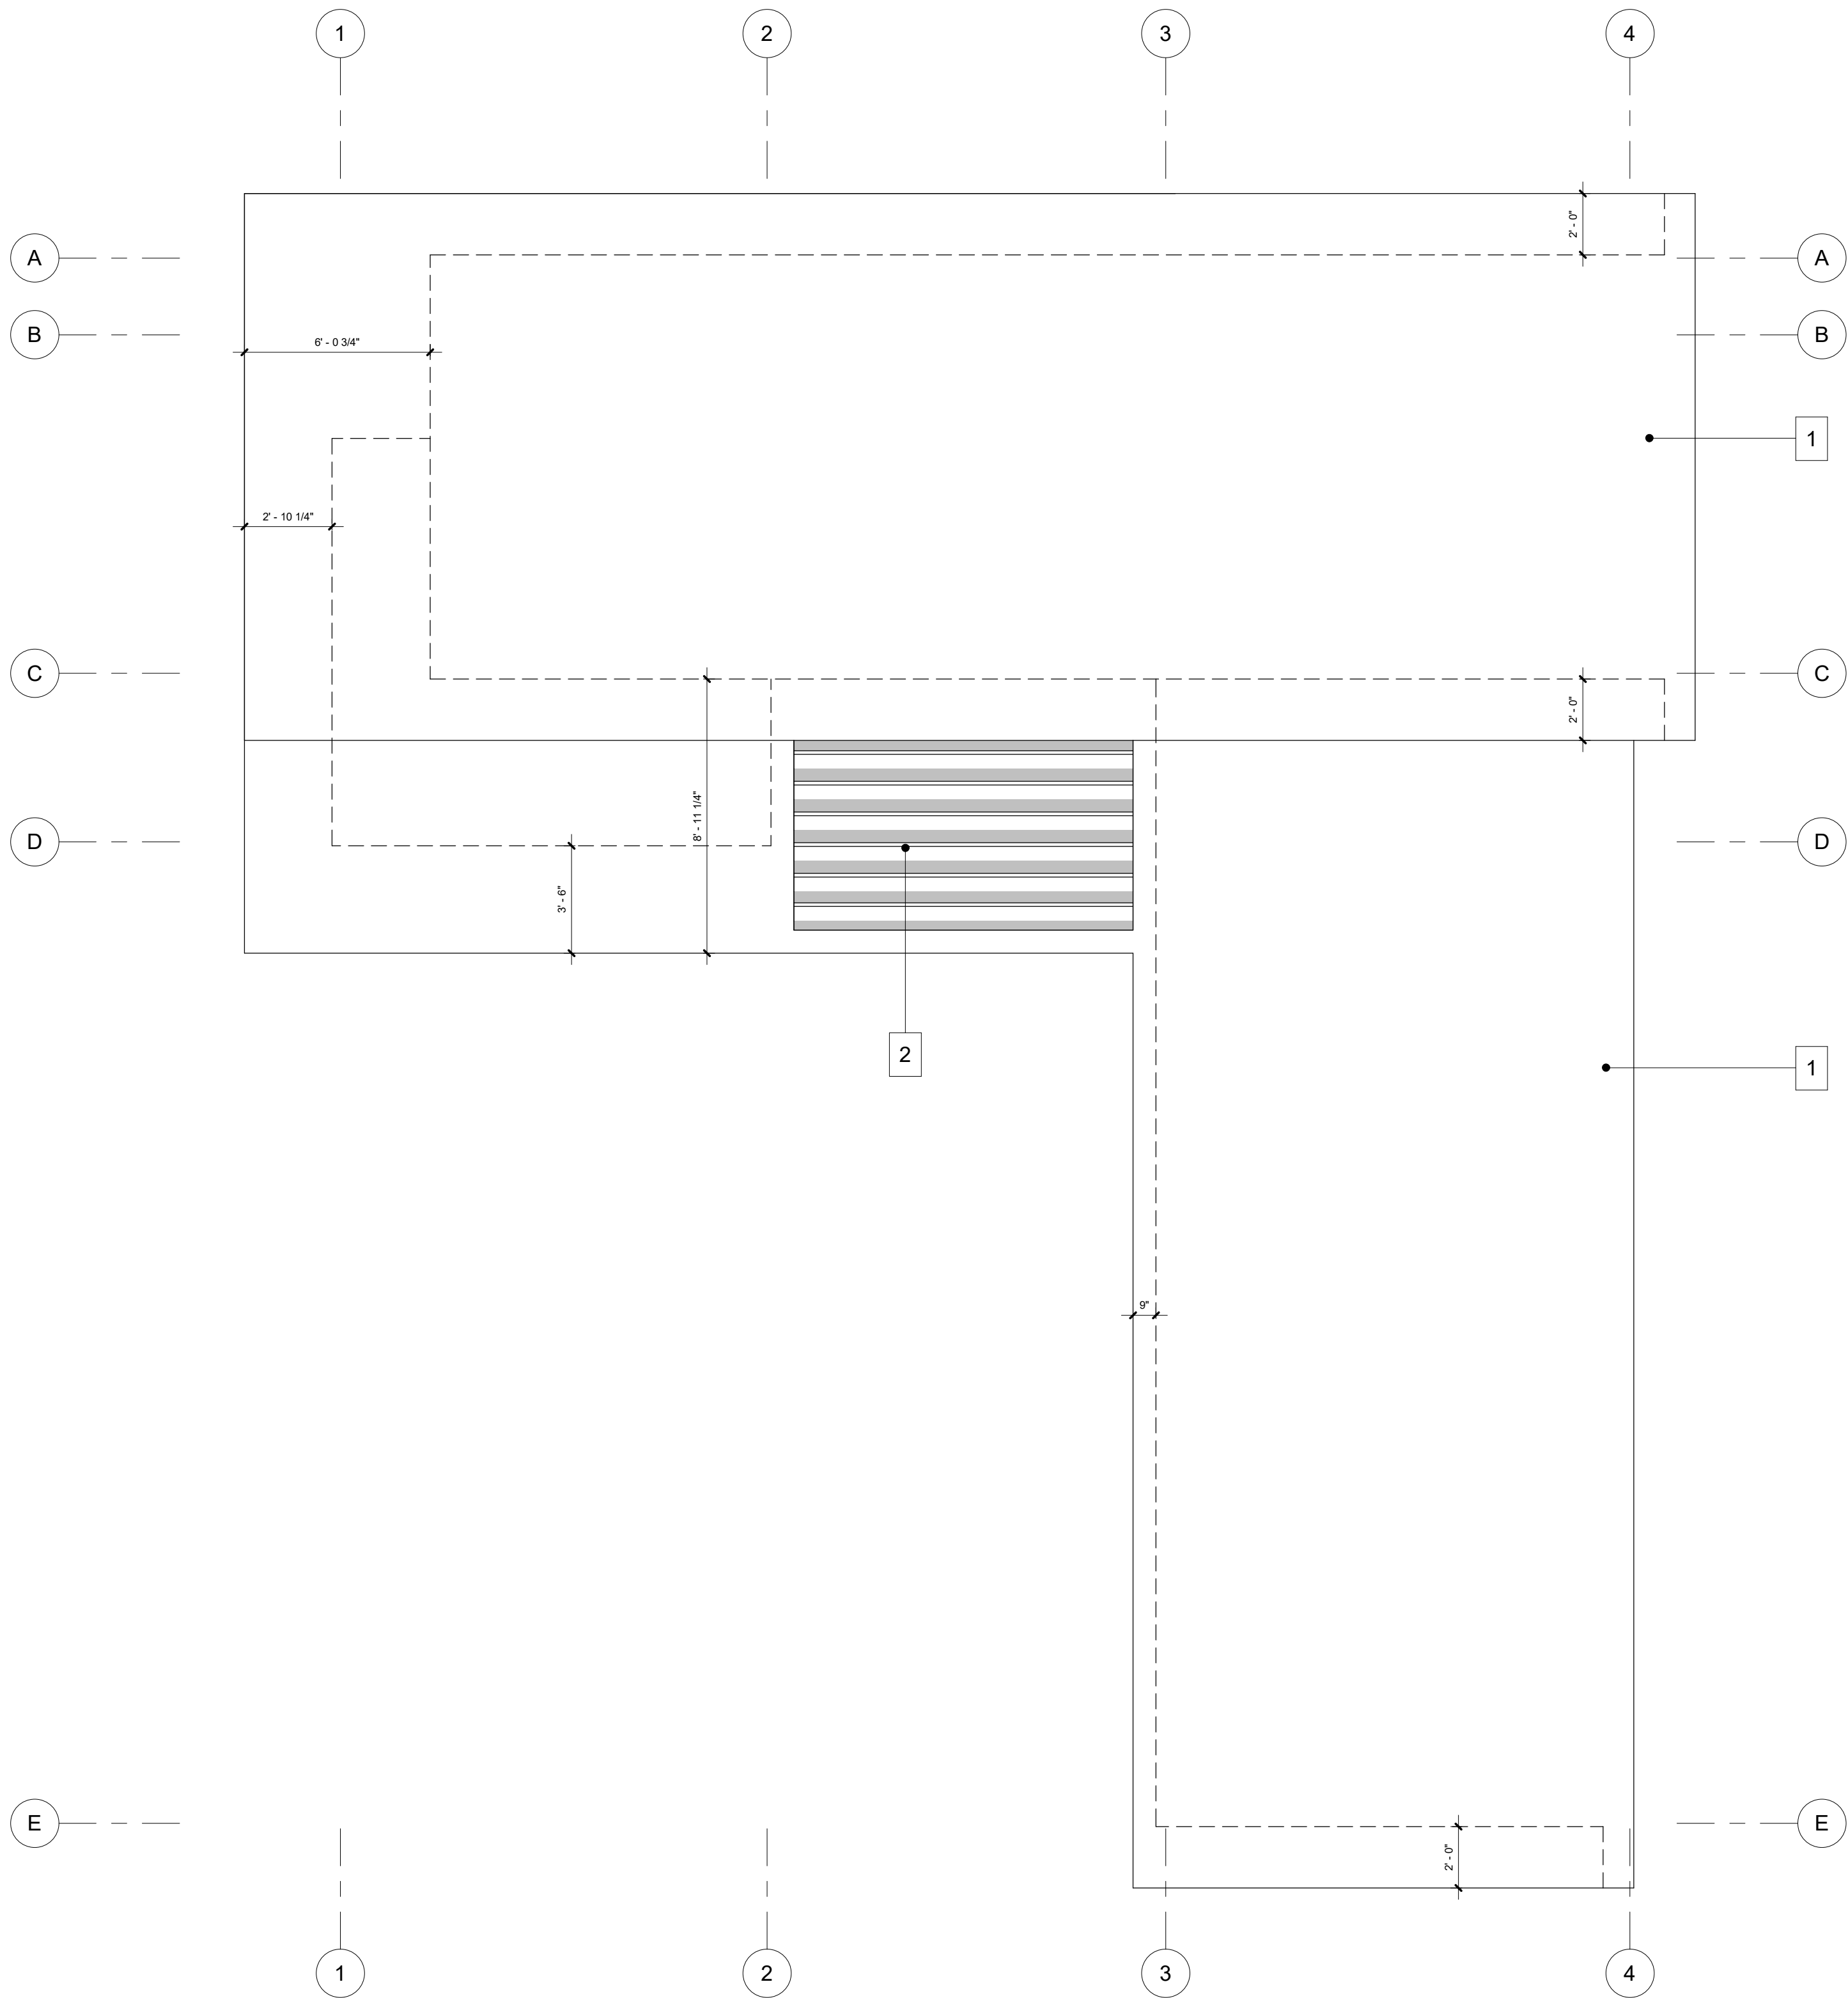


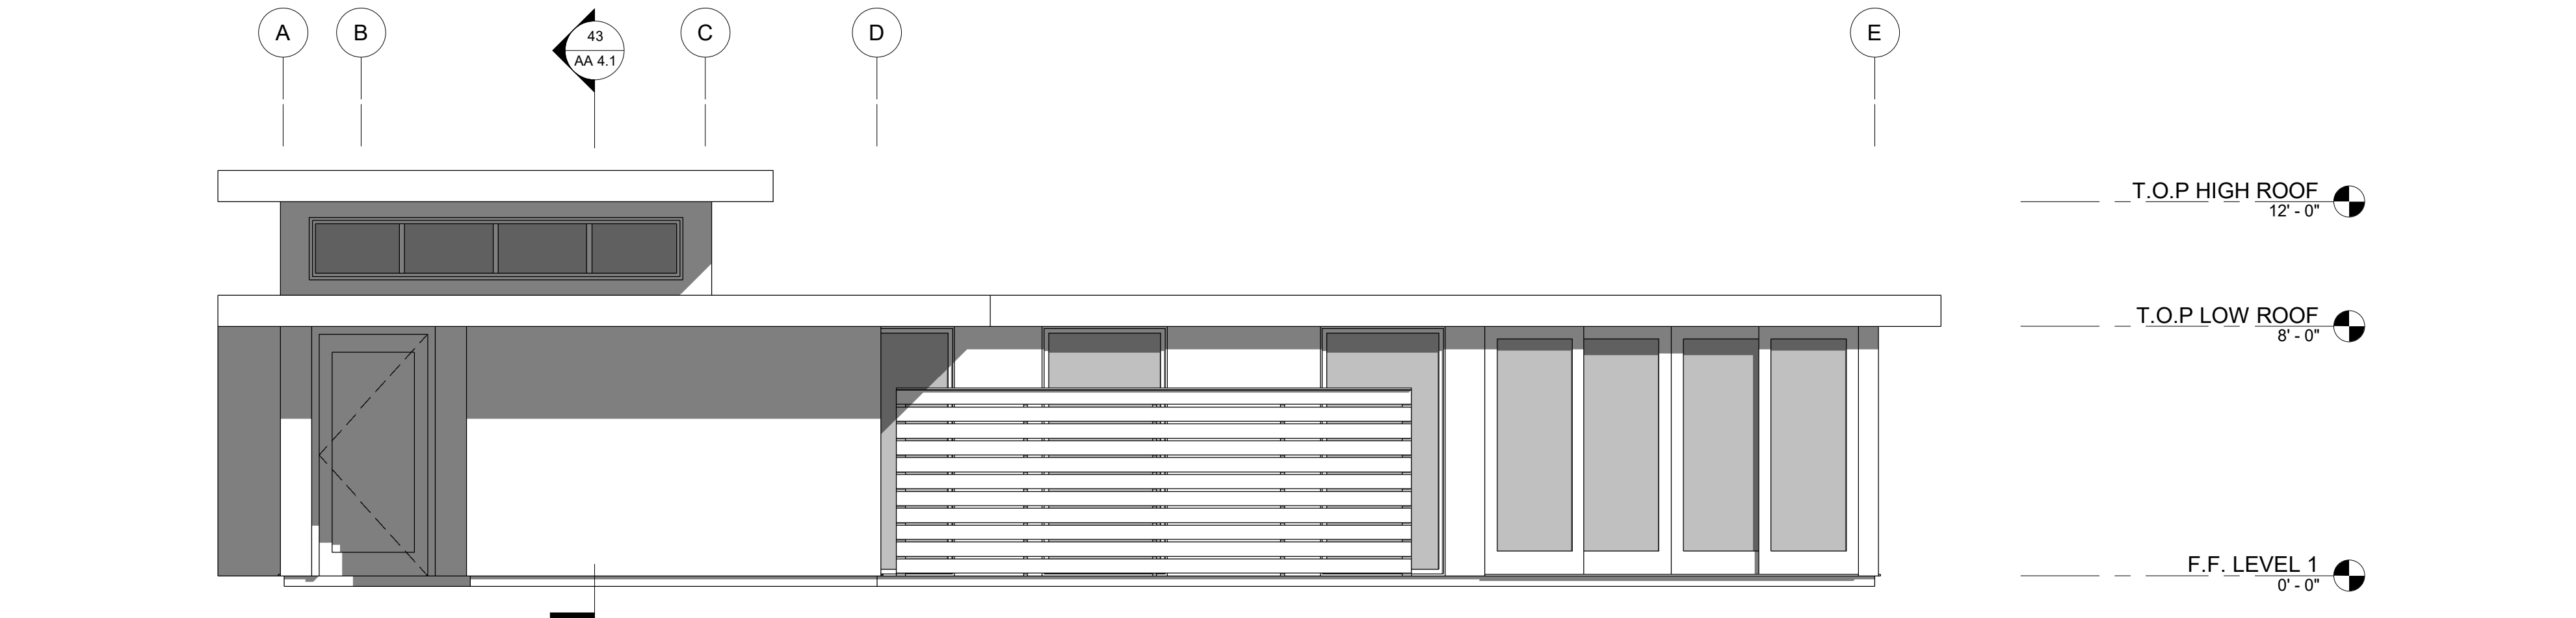


41 EAST ELEVATION
1/4" = 1'-0"

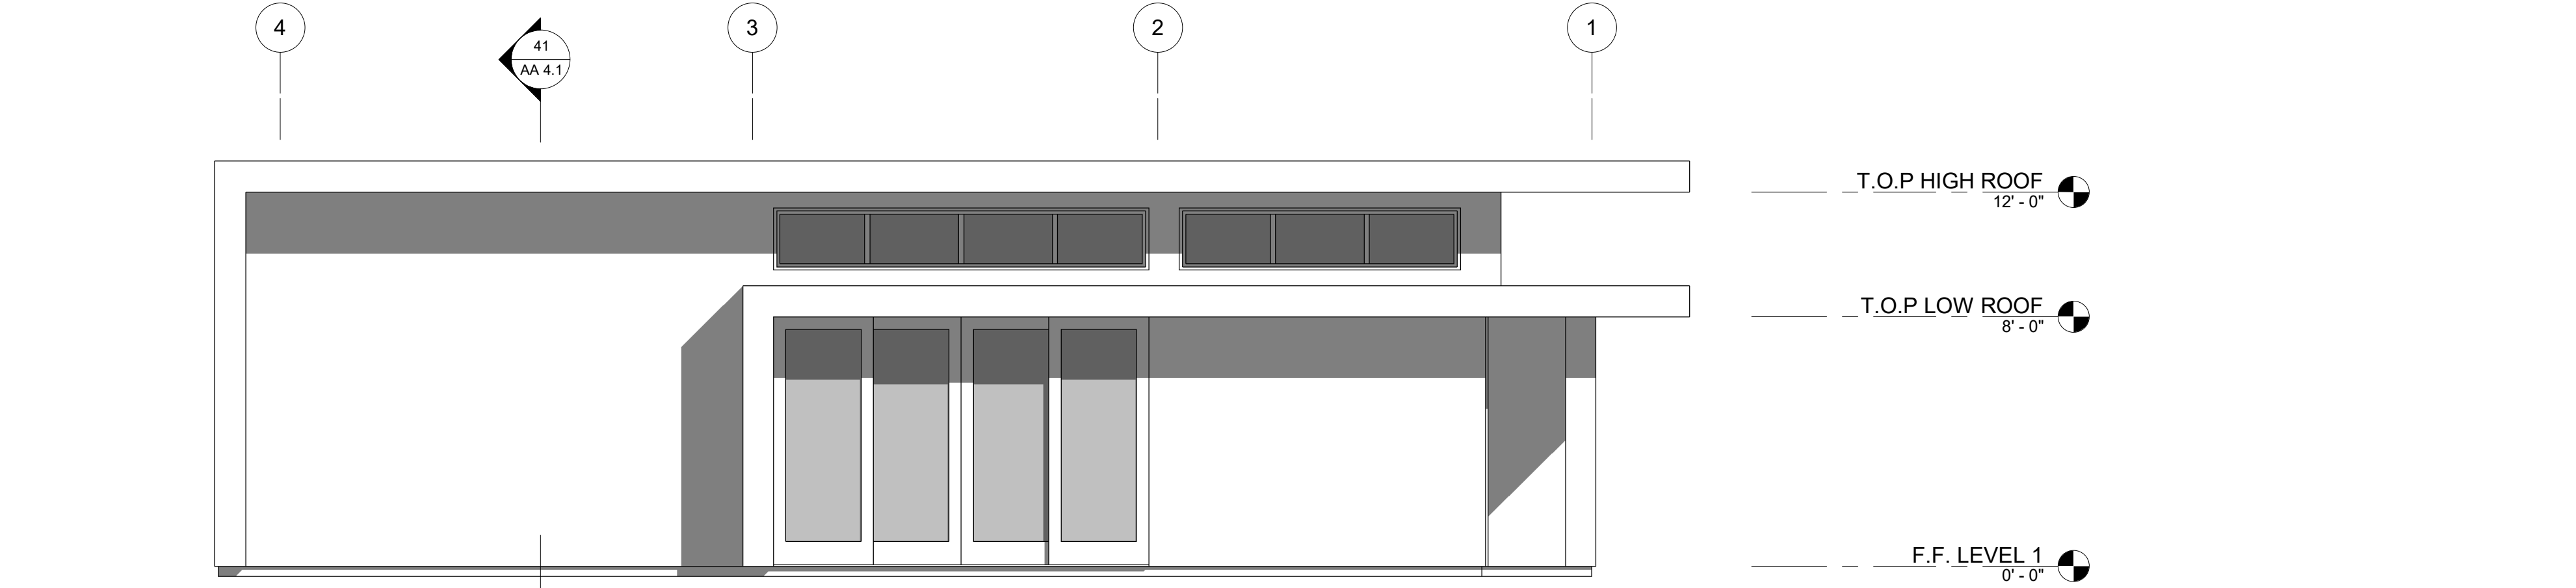

42 NORTH ELEVATION
1/4" = 1'-0"

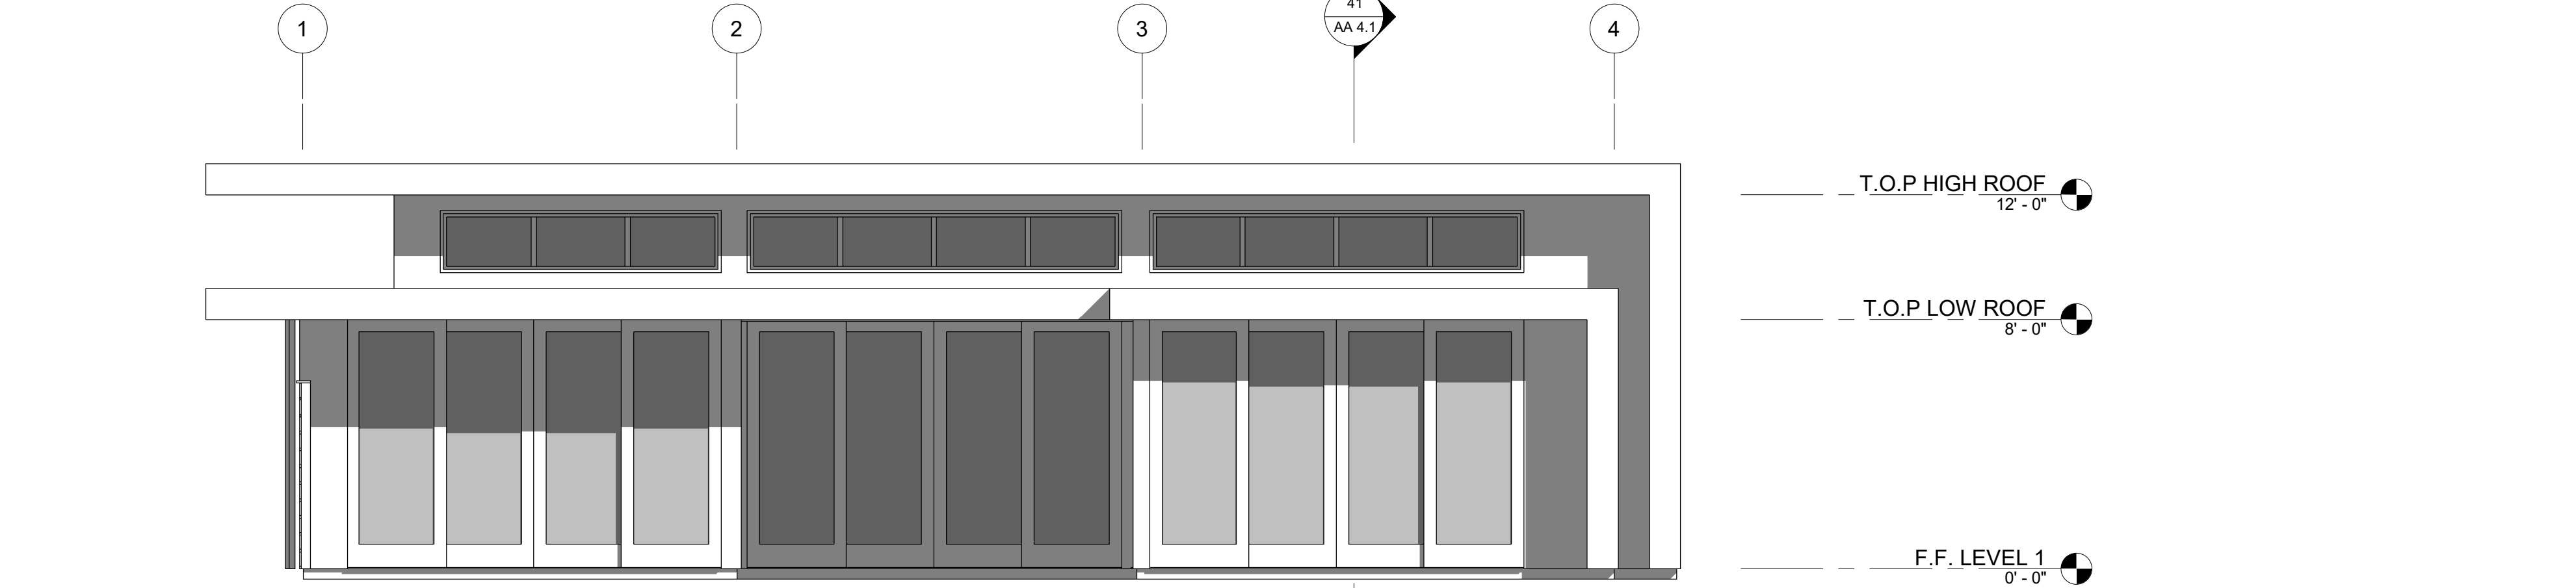

43 SOUTH ELEVATION
1/4" = 1'-0"

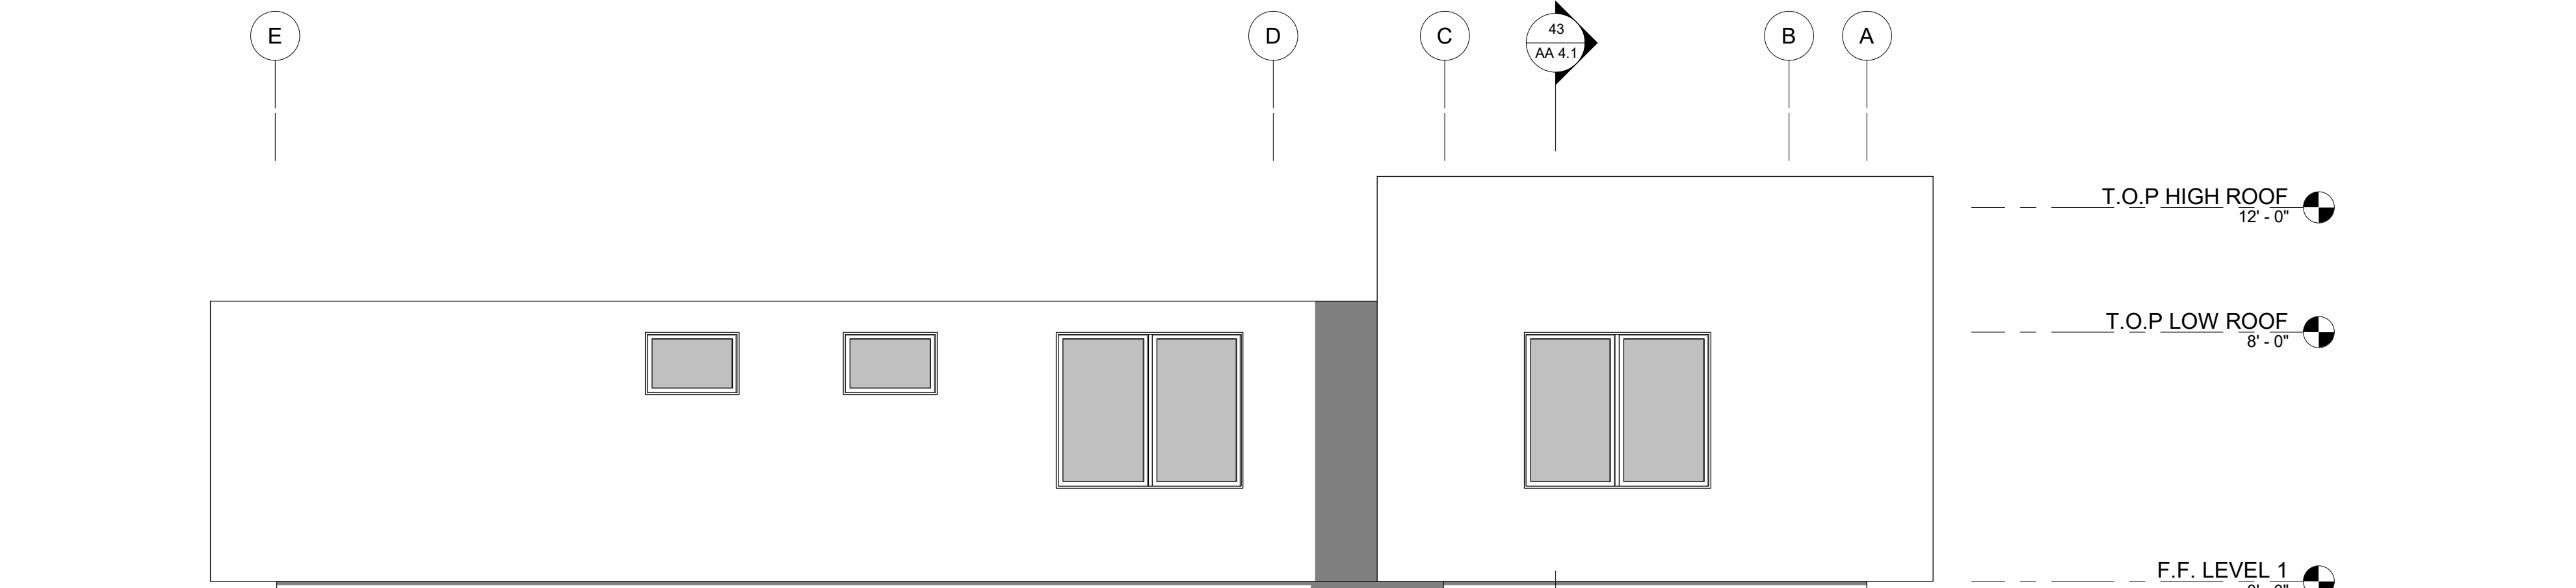


44 WEST ELEVATION
1/4" = 1'-0"

41

SECTION 1


1/4" = 1'-0"

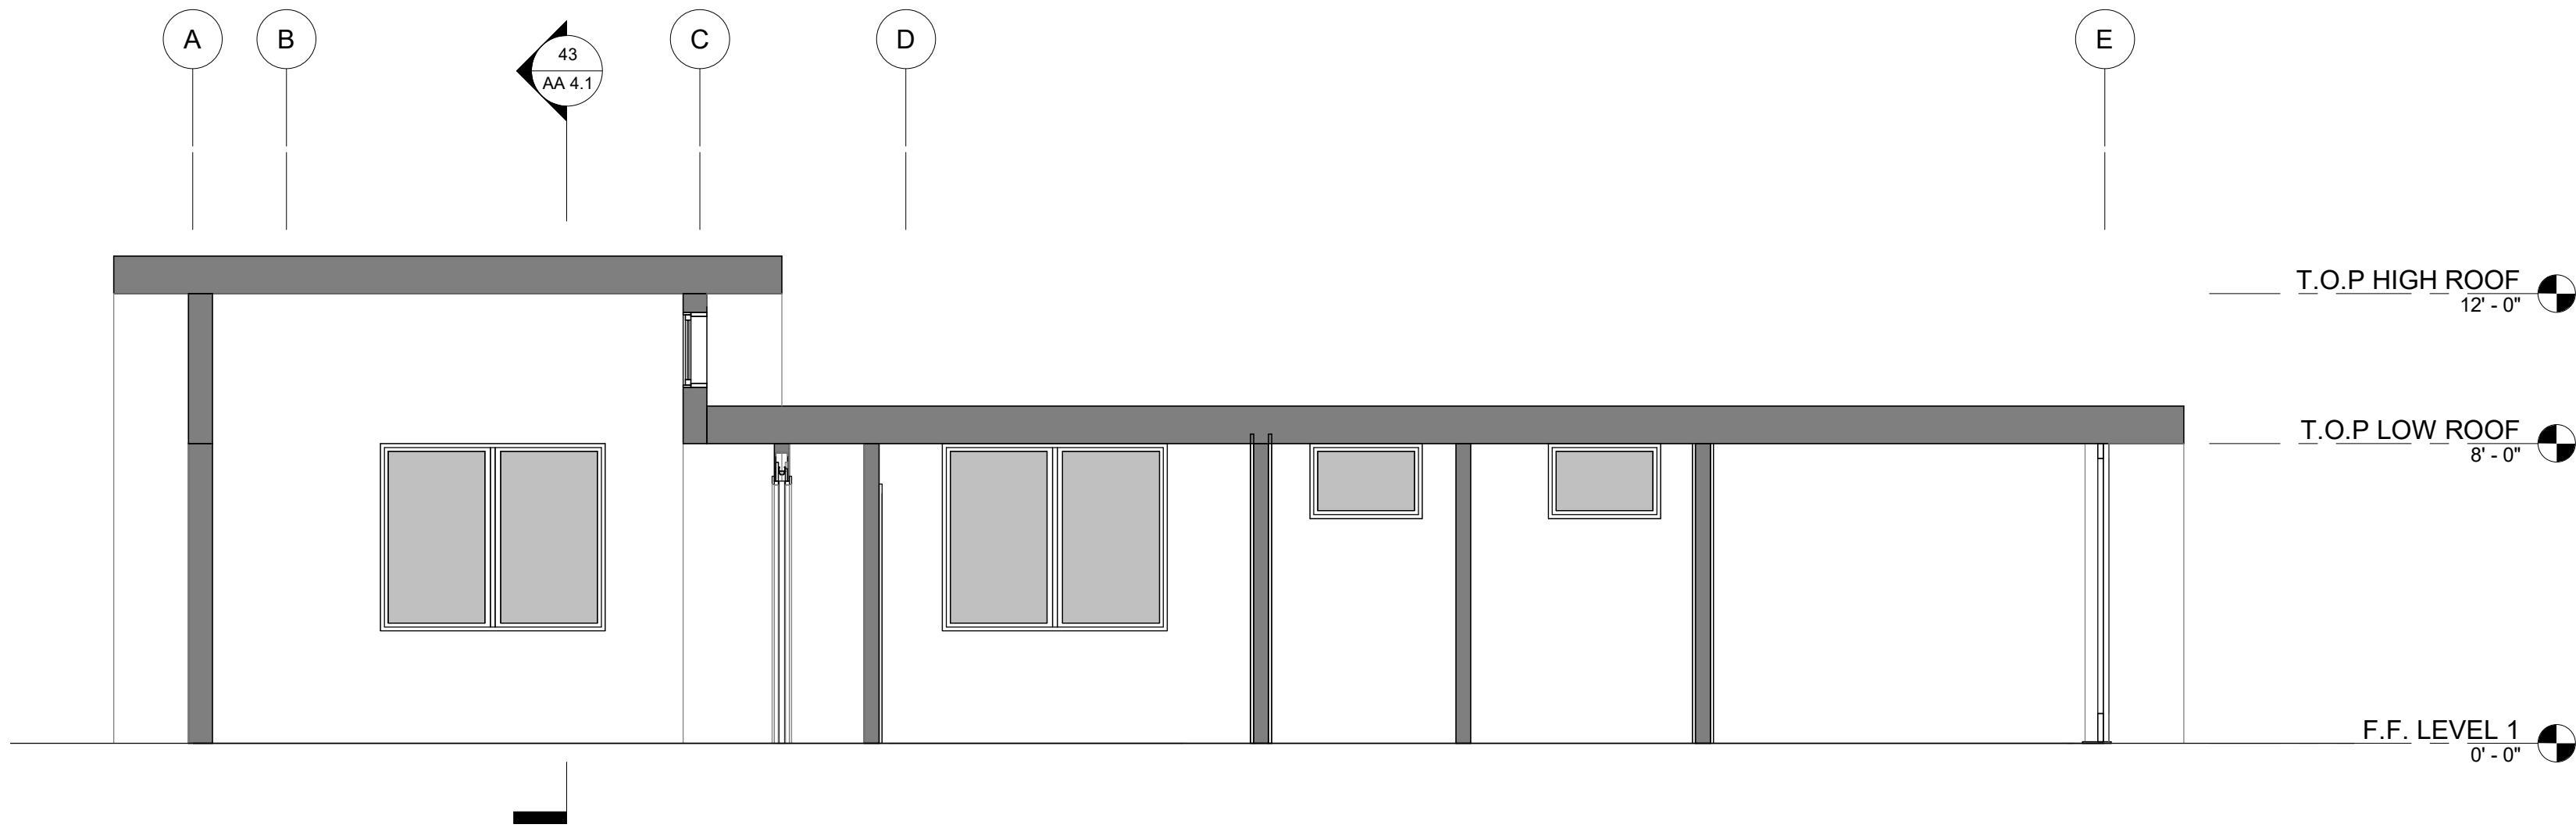

43

SECTION 2

1/4" = 1'-0"

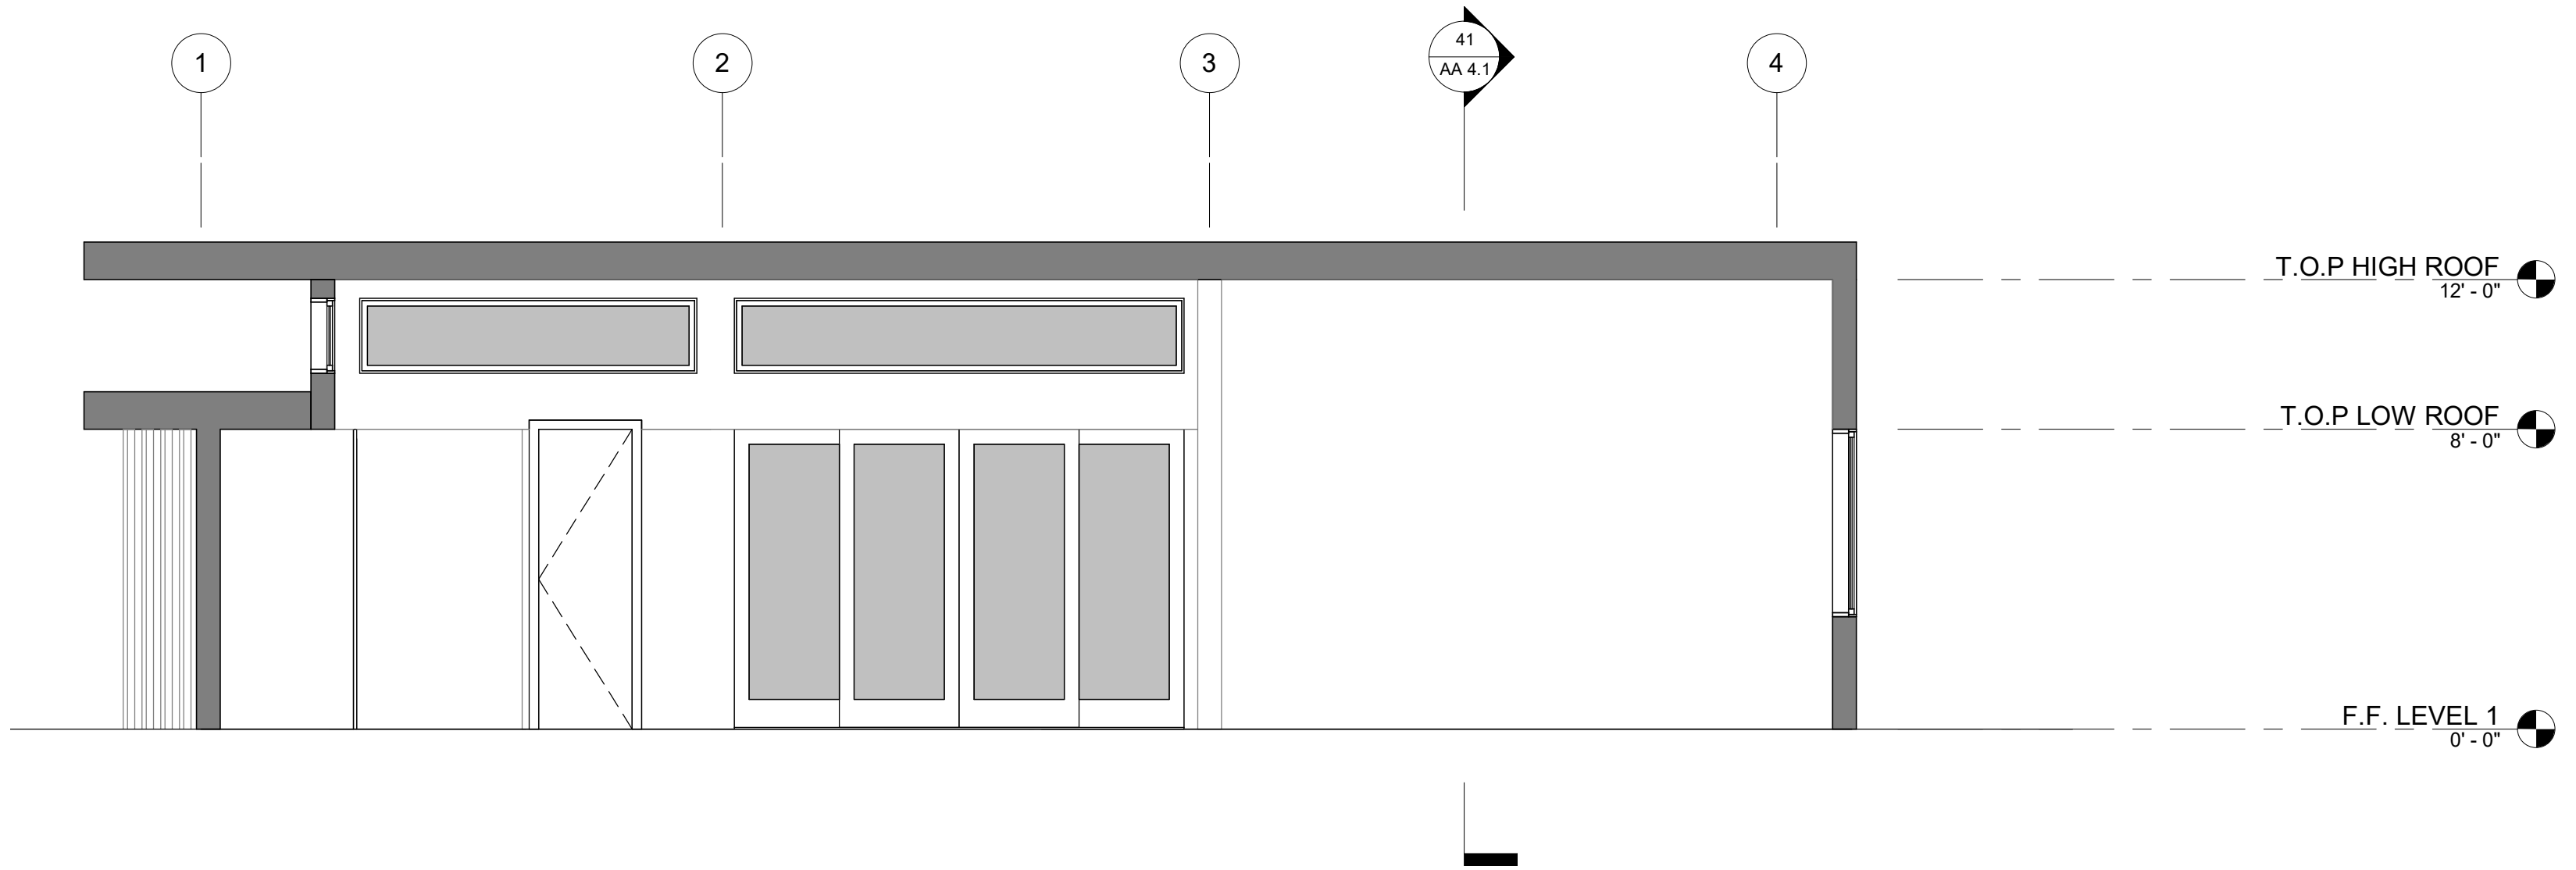

AGD
ARCHITECTURE | DESIGN

ANDREW GOODWIN DESIGNS
2050 PARKER ST
SAN LUIS OBISPO, CA 93401
t: (805) 439-1611
www.andrewgoodwin.us
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REVISIONS

REV # | REV DATE | REV DESCRIPTION

SEAL

NOT FOR
CONSTRUCTION

PROJECT

PARMAR RESIDENCE

HAYES LANE
SAN MARTIN, CA 95046

APN#: 779-44-014

CLIENT

ABHISHEK PARMAR

SHEET TITLE

SECTIONS


DATE: 00/00/2022

TECHNICIAN: Author

PROJECT MANAGER: Designer


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SHEET NUMBER

AA 4.1

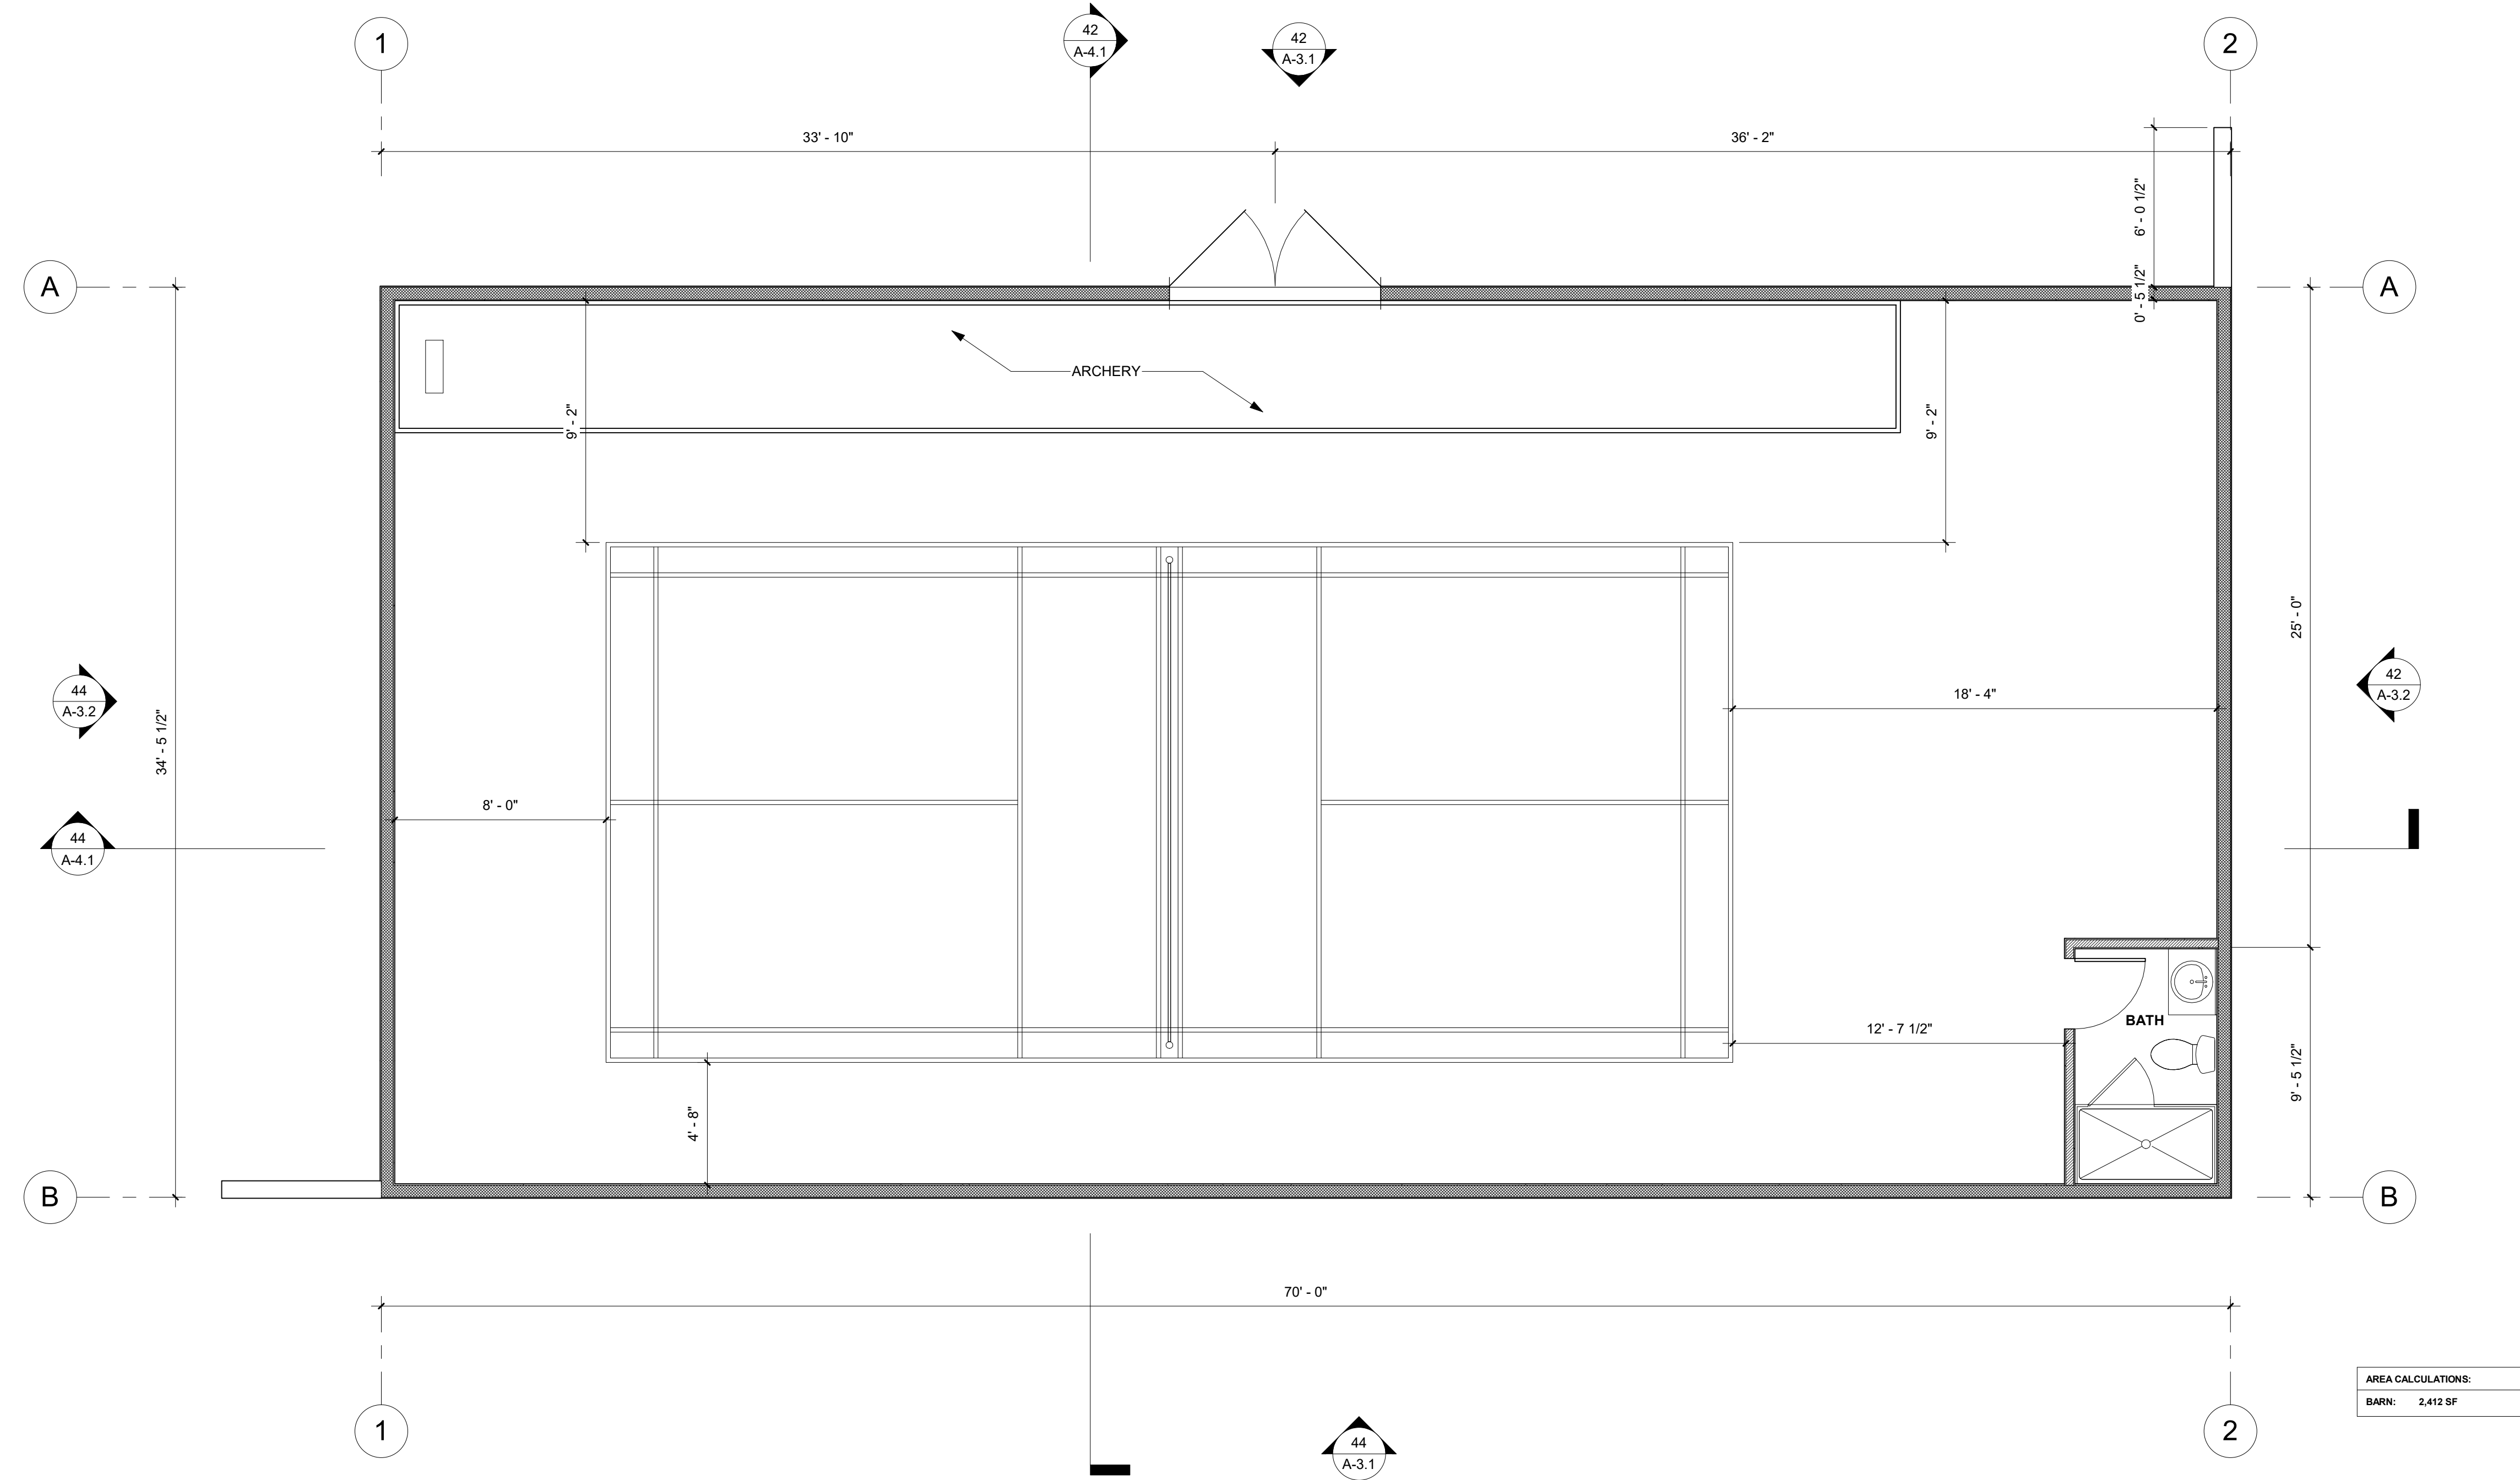


42

NORTH ELEVATION
1/4" = 1'-0"

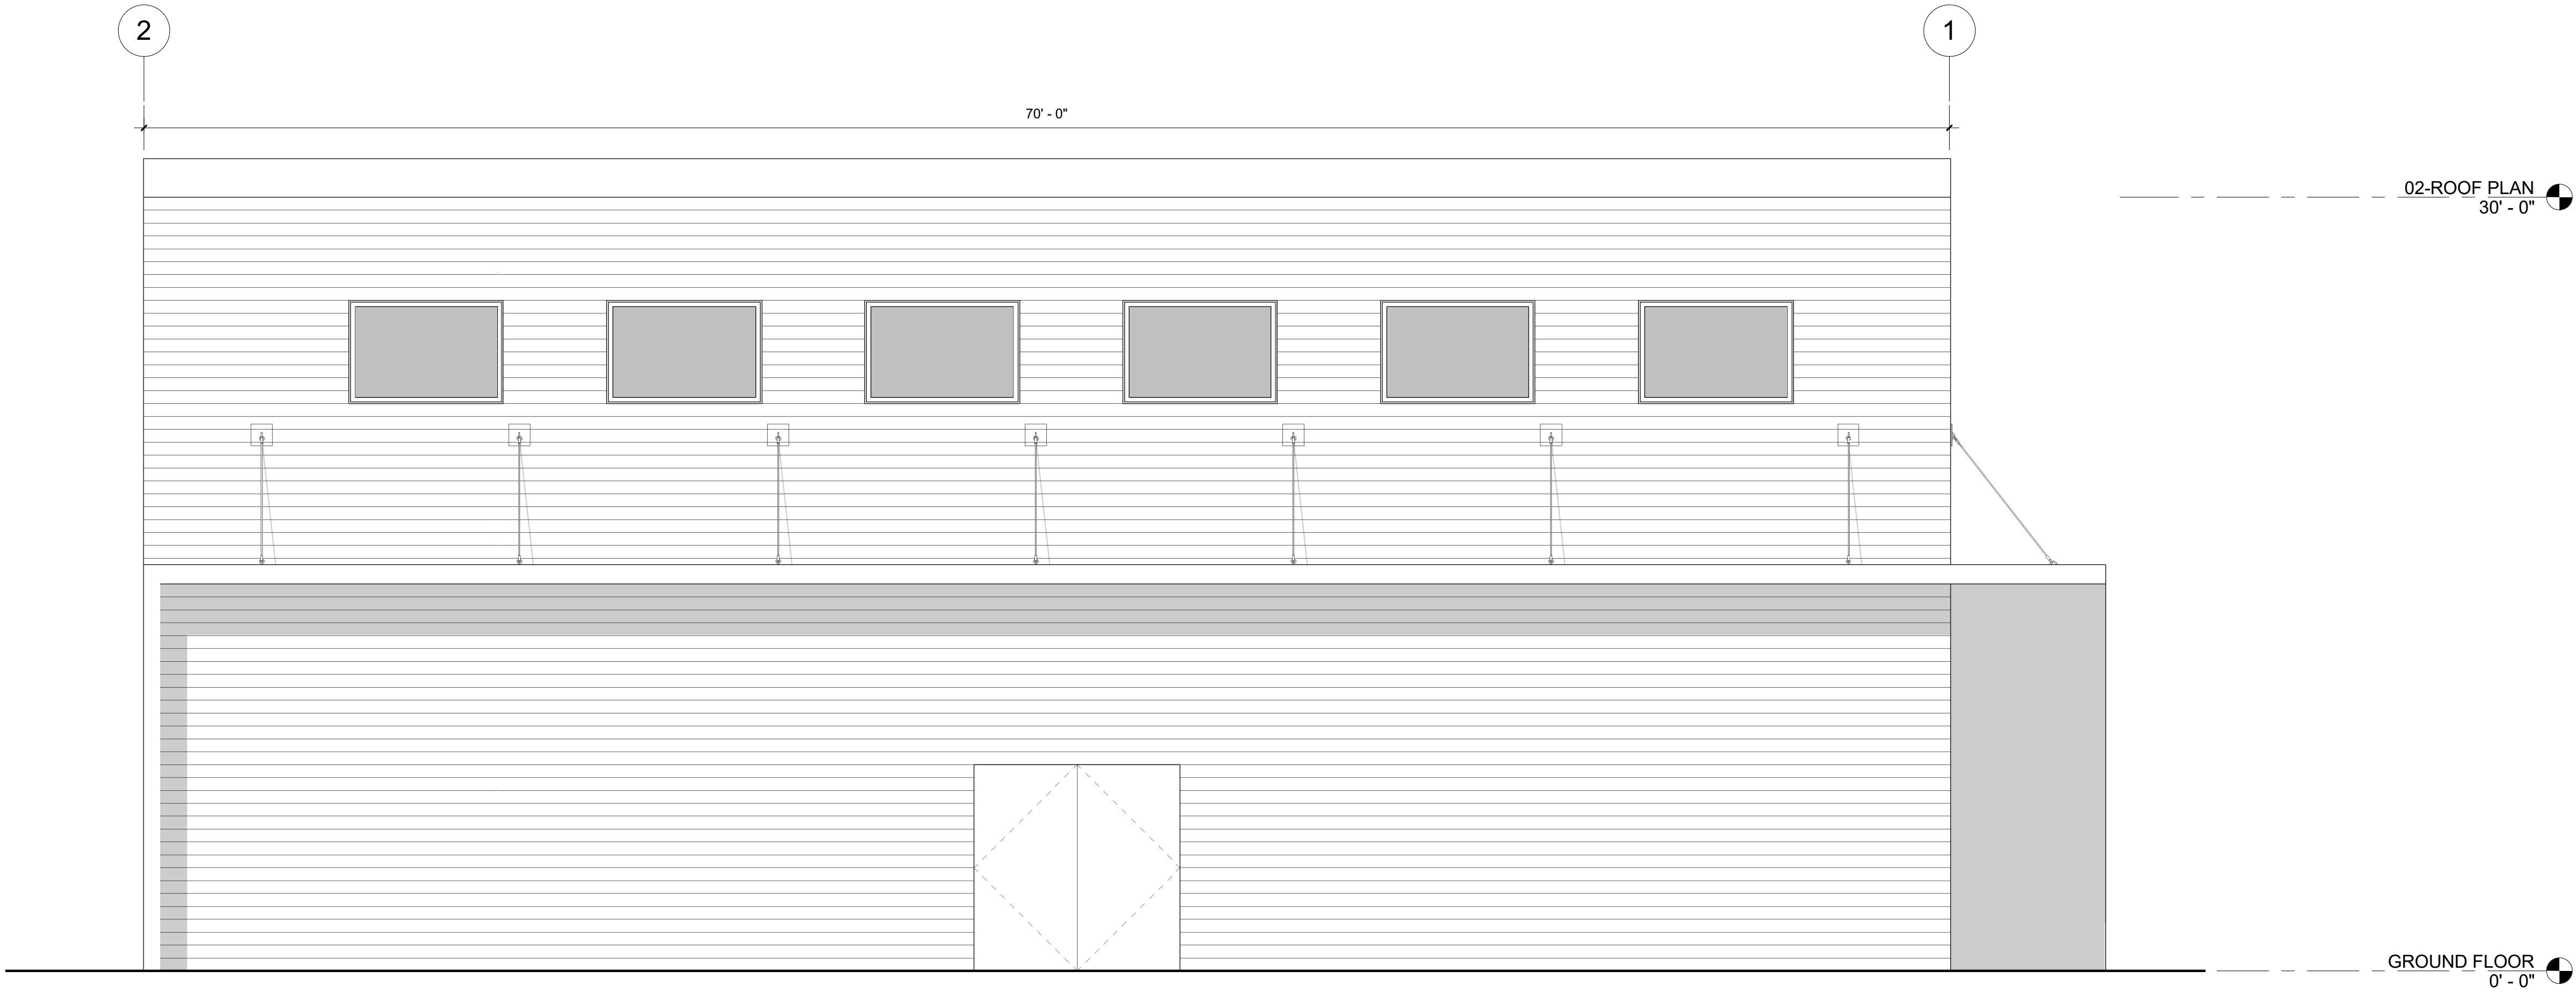

44

SOUTH ELEVATION
1/4" = 1'-0"

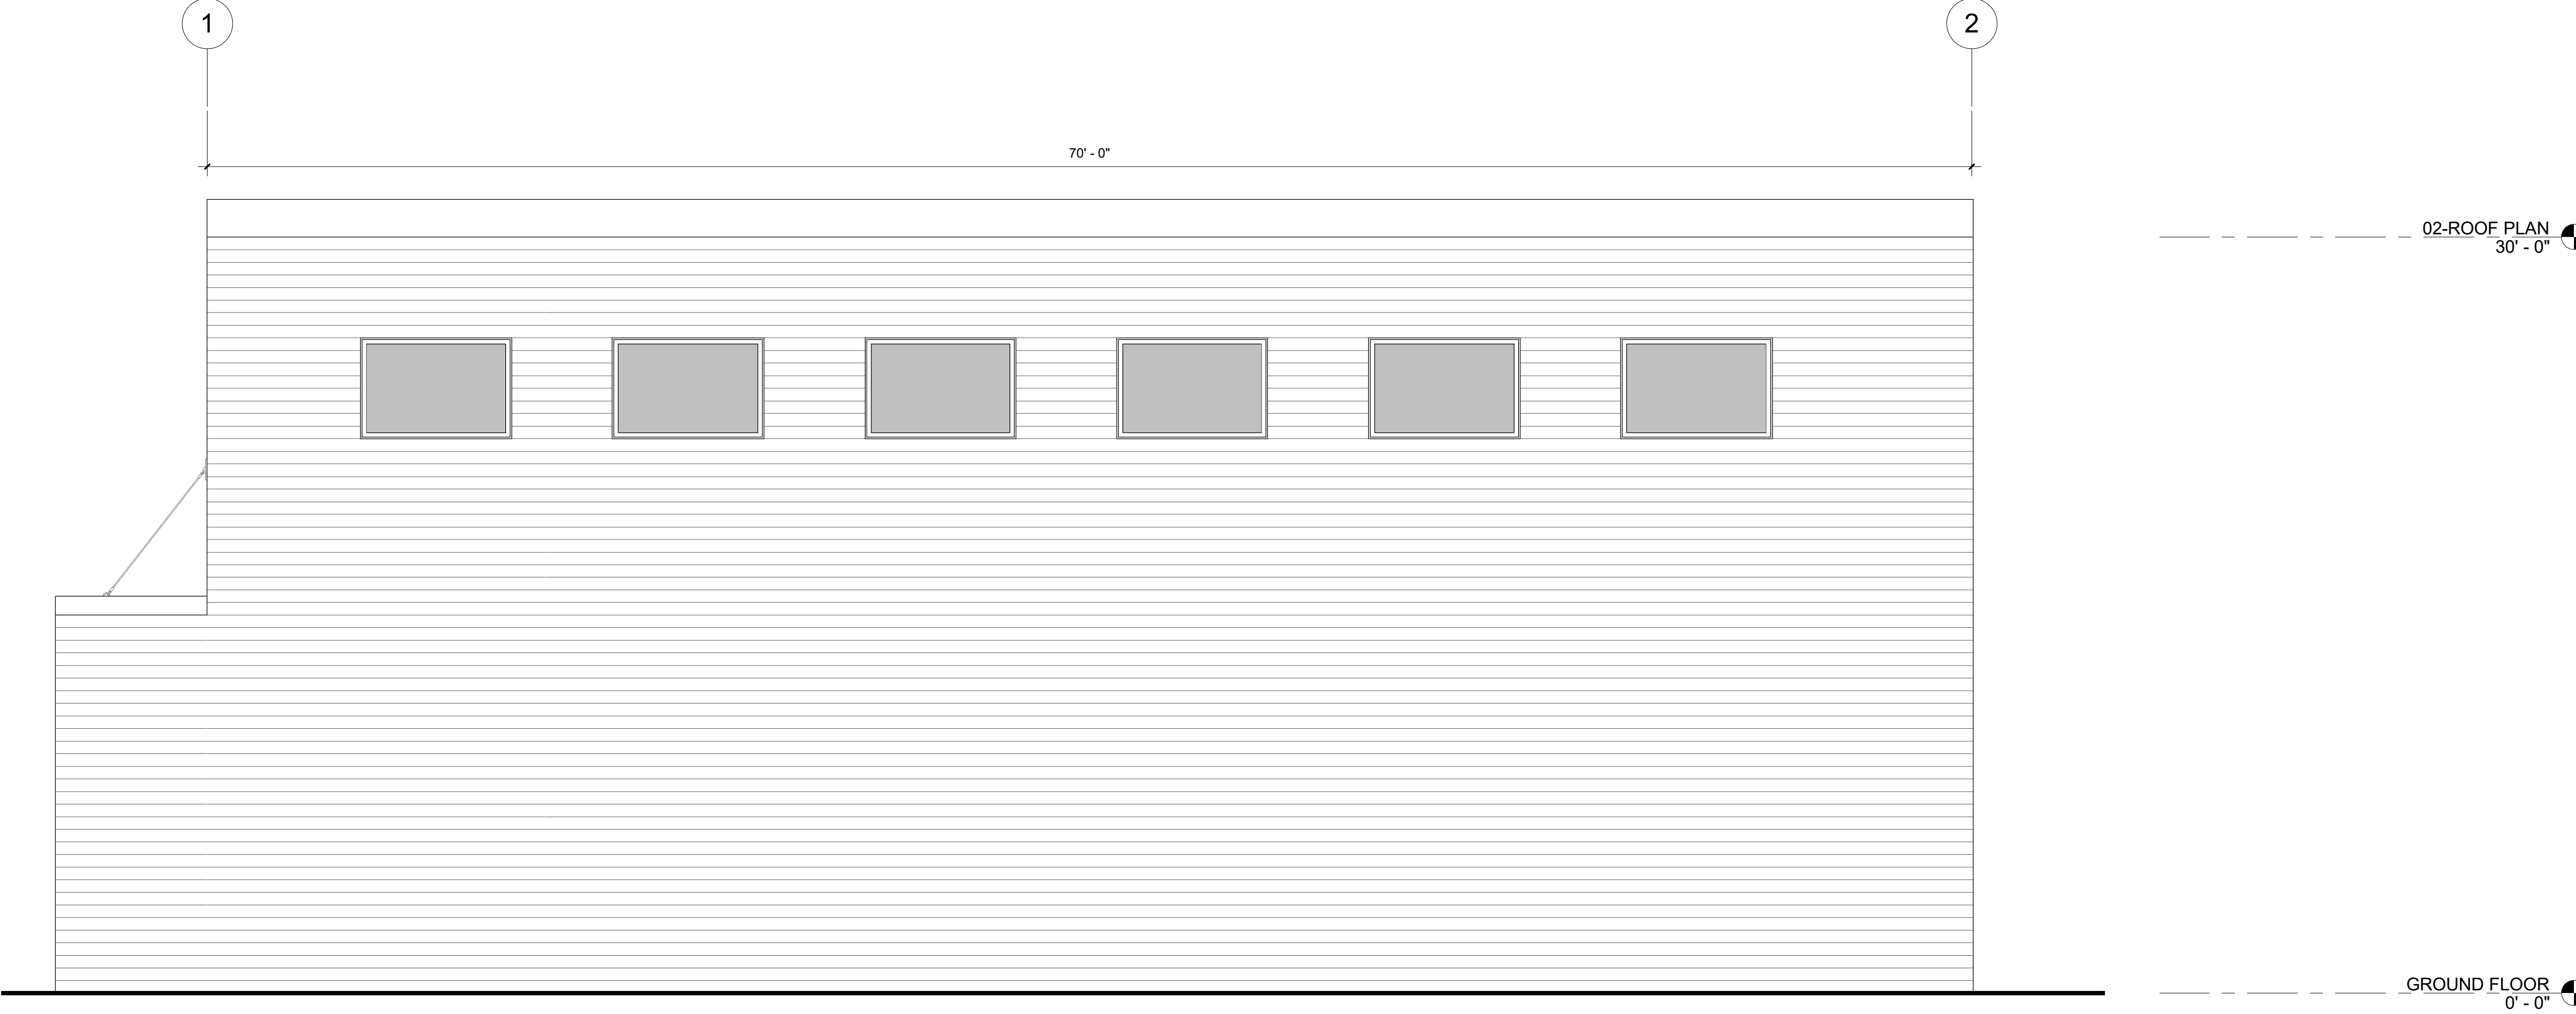

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PROJECT

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APN#: 779-44-014

CLIENT

ABHISHEK PARMAR

SHEET TITLE
EXTERIOR ELEVATIONS

DATE: 05/04/2022

TECHNICIAN:

PROJECT MANAGER:

JOB NUMBER: 597
SHEET NUMBER

AB 3.1

AGD

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PROJECT

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SAN MARTIN, CA 95046

APN#: 779-44-014

CLIENT

ABHISHEK PARMAR

SHEET TITLE

EXTERIOR ELEVATIONS

DATE:

05/04/2022

TECHNICIAN:


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JOB NUMBER:


597

SHEET NUMBER

AB 3.2

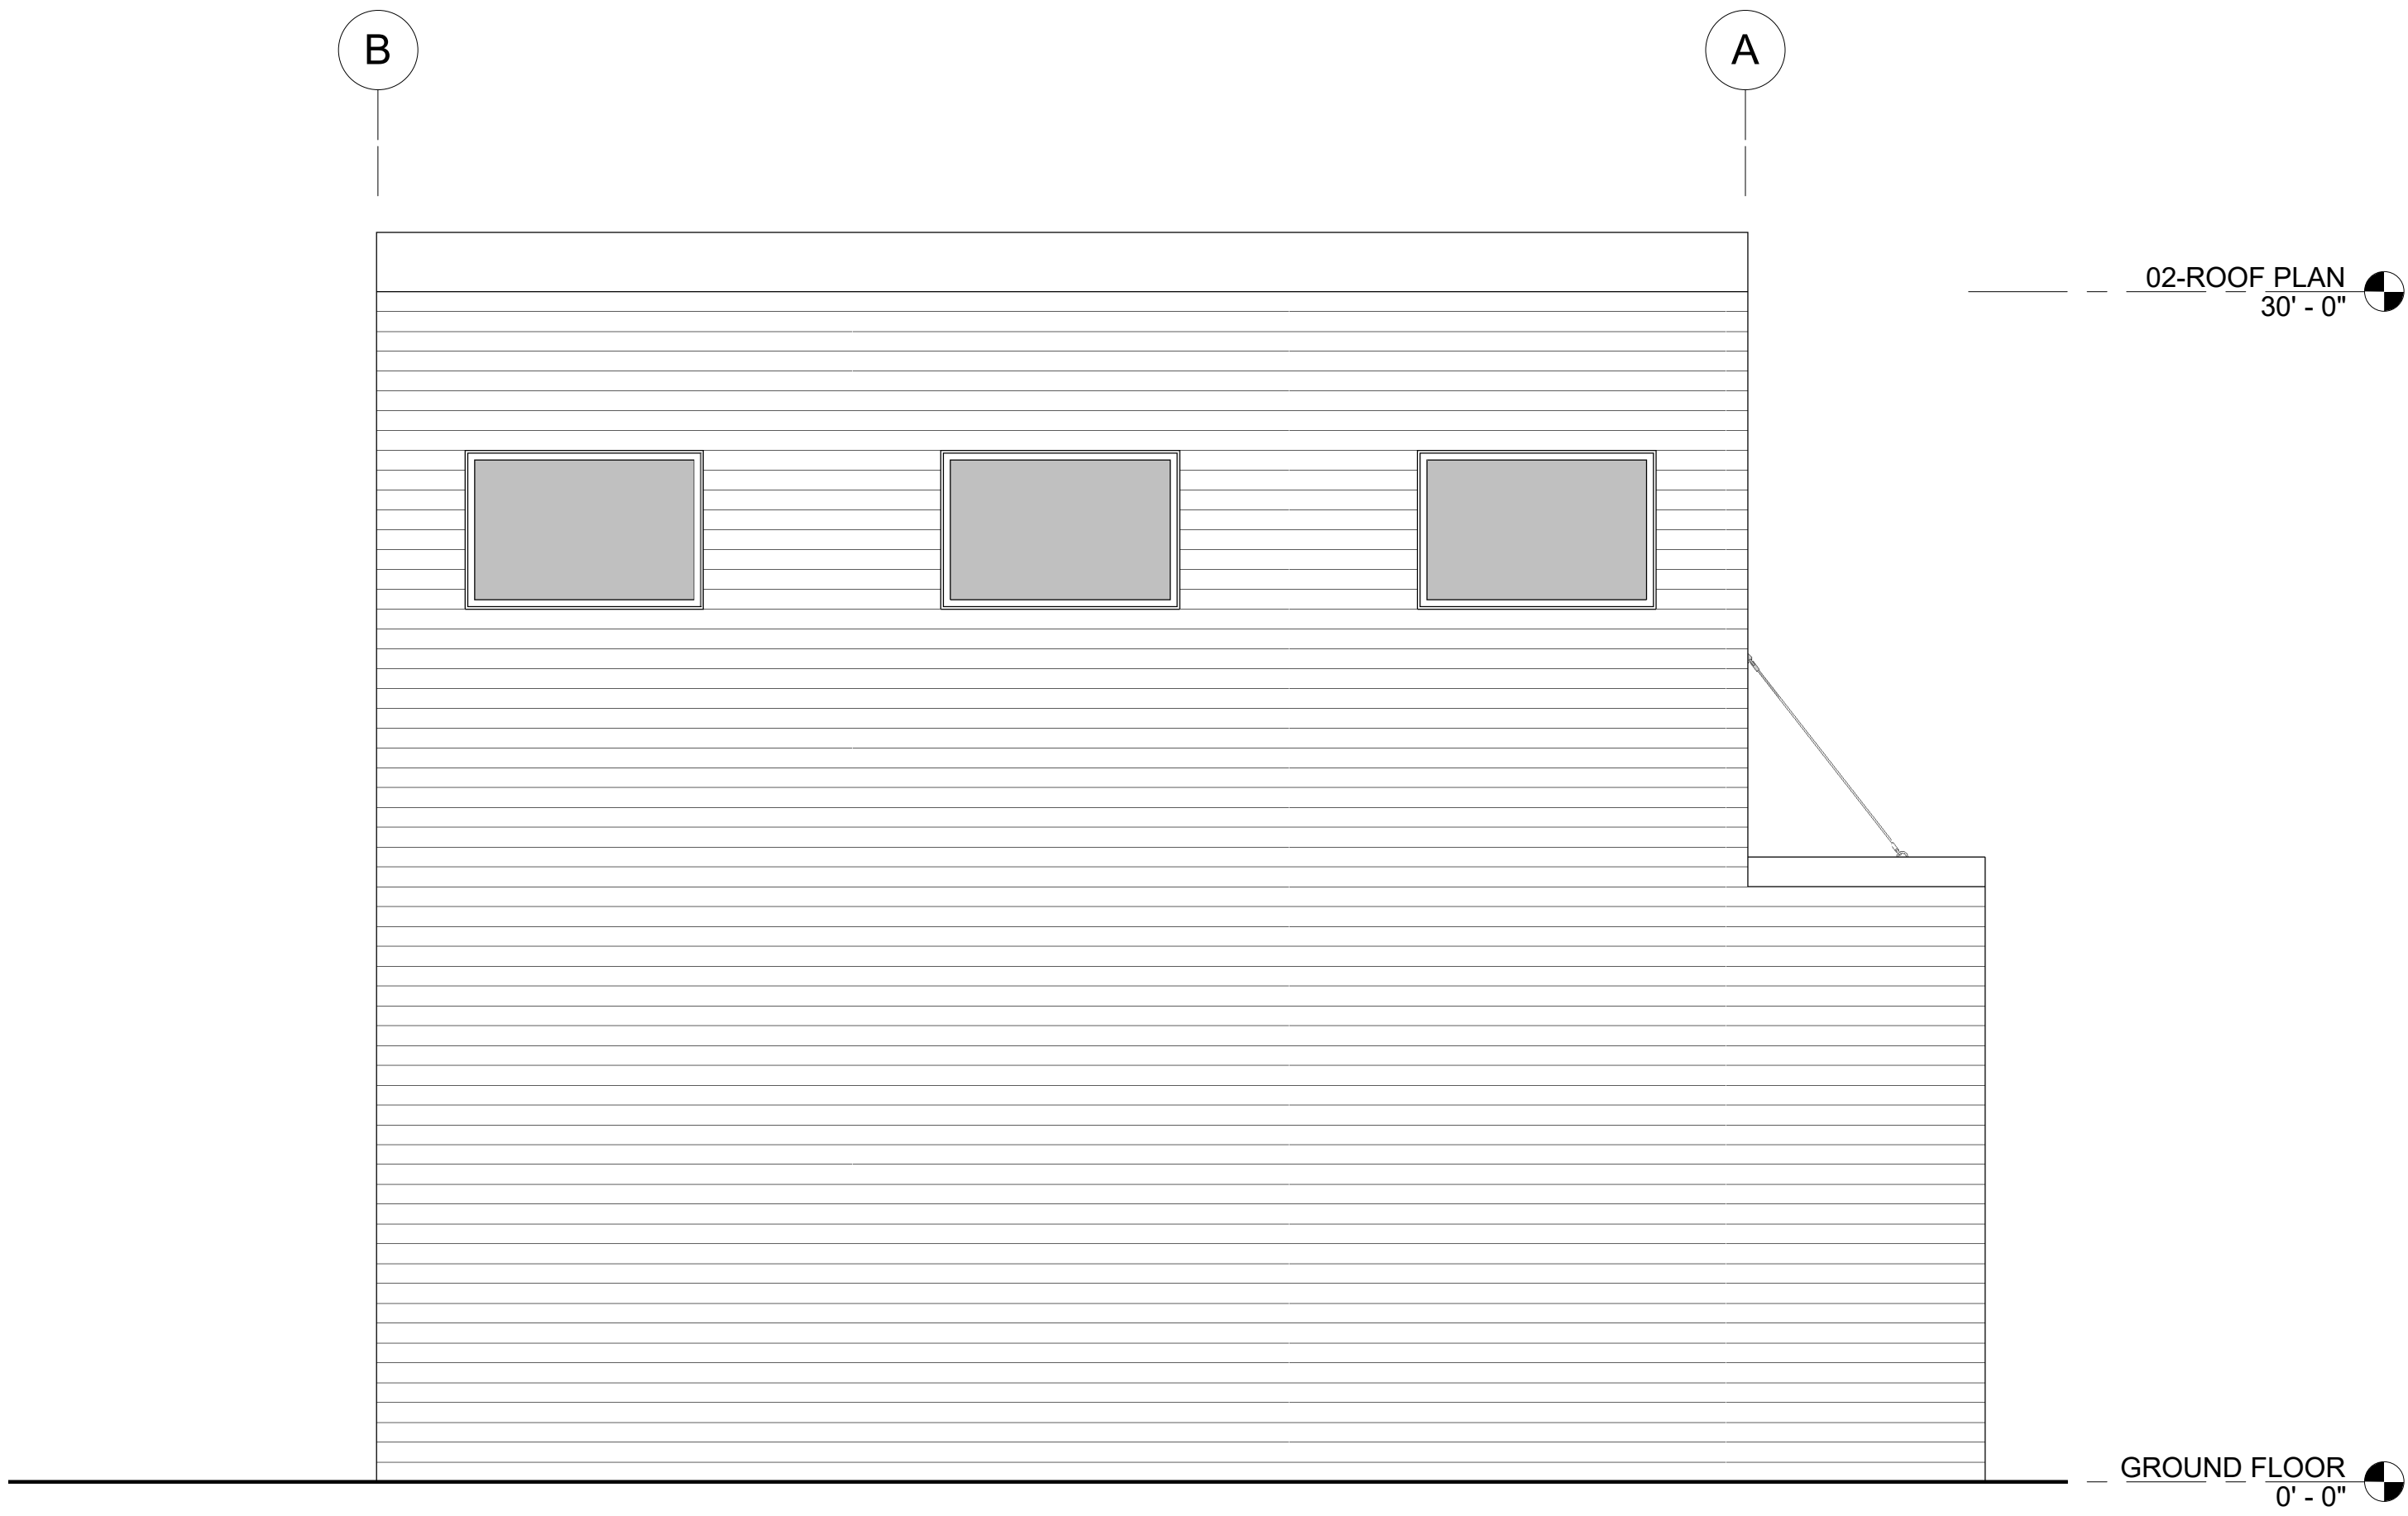

42 EAST ELEVATION
1/4" = 1'-0"

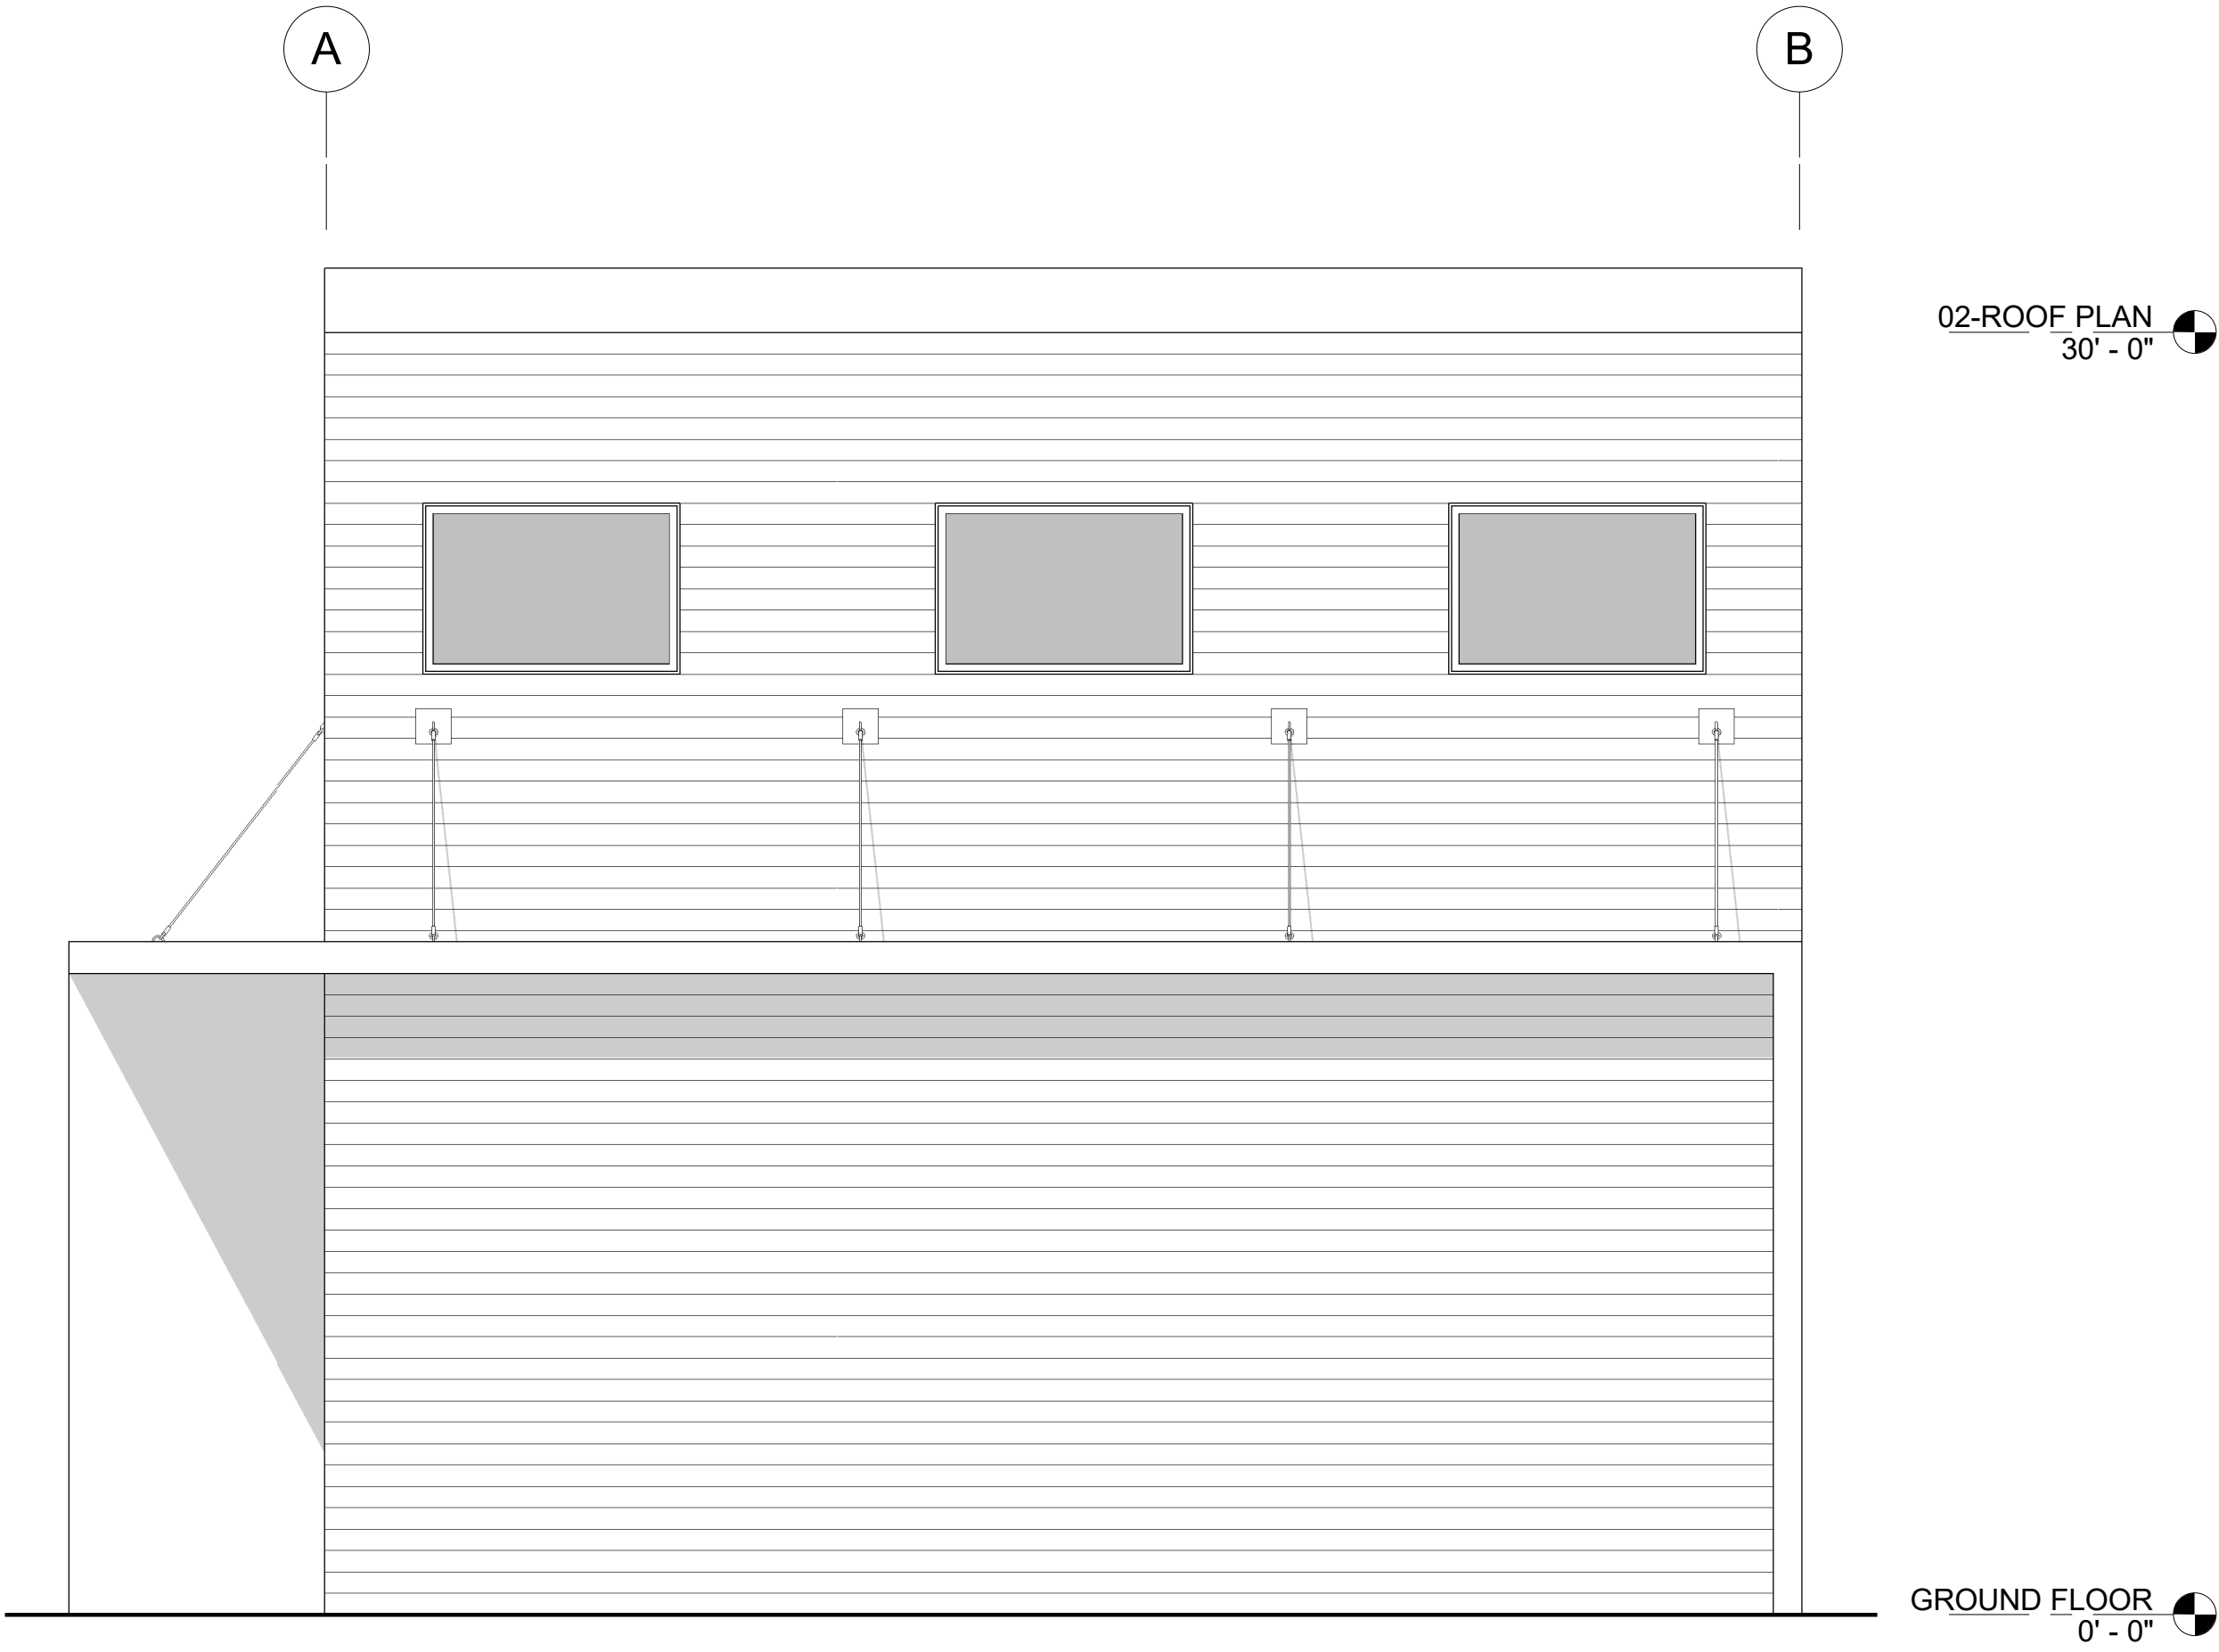

44 WEST ELEVATION
1/4" = 1'-0"

AGD

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REVISIONS

REV #	REV DATE	REV DESCRIPTION
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SEAL

LICENSED ARCHITECT

ANDREW C. GOODWIN

NO. C-34243

REN. 10/31/2021

STATE OF CALIFORNIA

PROJECT

PARMAR RESIDENCE

HAYES LANE
SAN MARTIN, CA 95046
APN#: 779-44-014

CLIENT

ABHISHEK PARMAR

SHEET TITLE

BUILDING SECTIONS

DATE:

05/04/2022

TECHNICIAN:


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JOB NUMBER:

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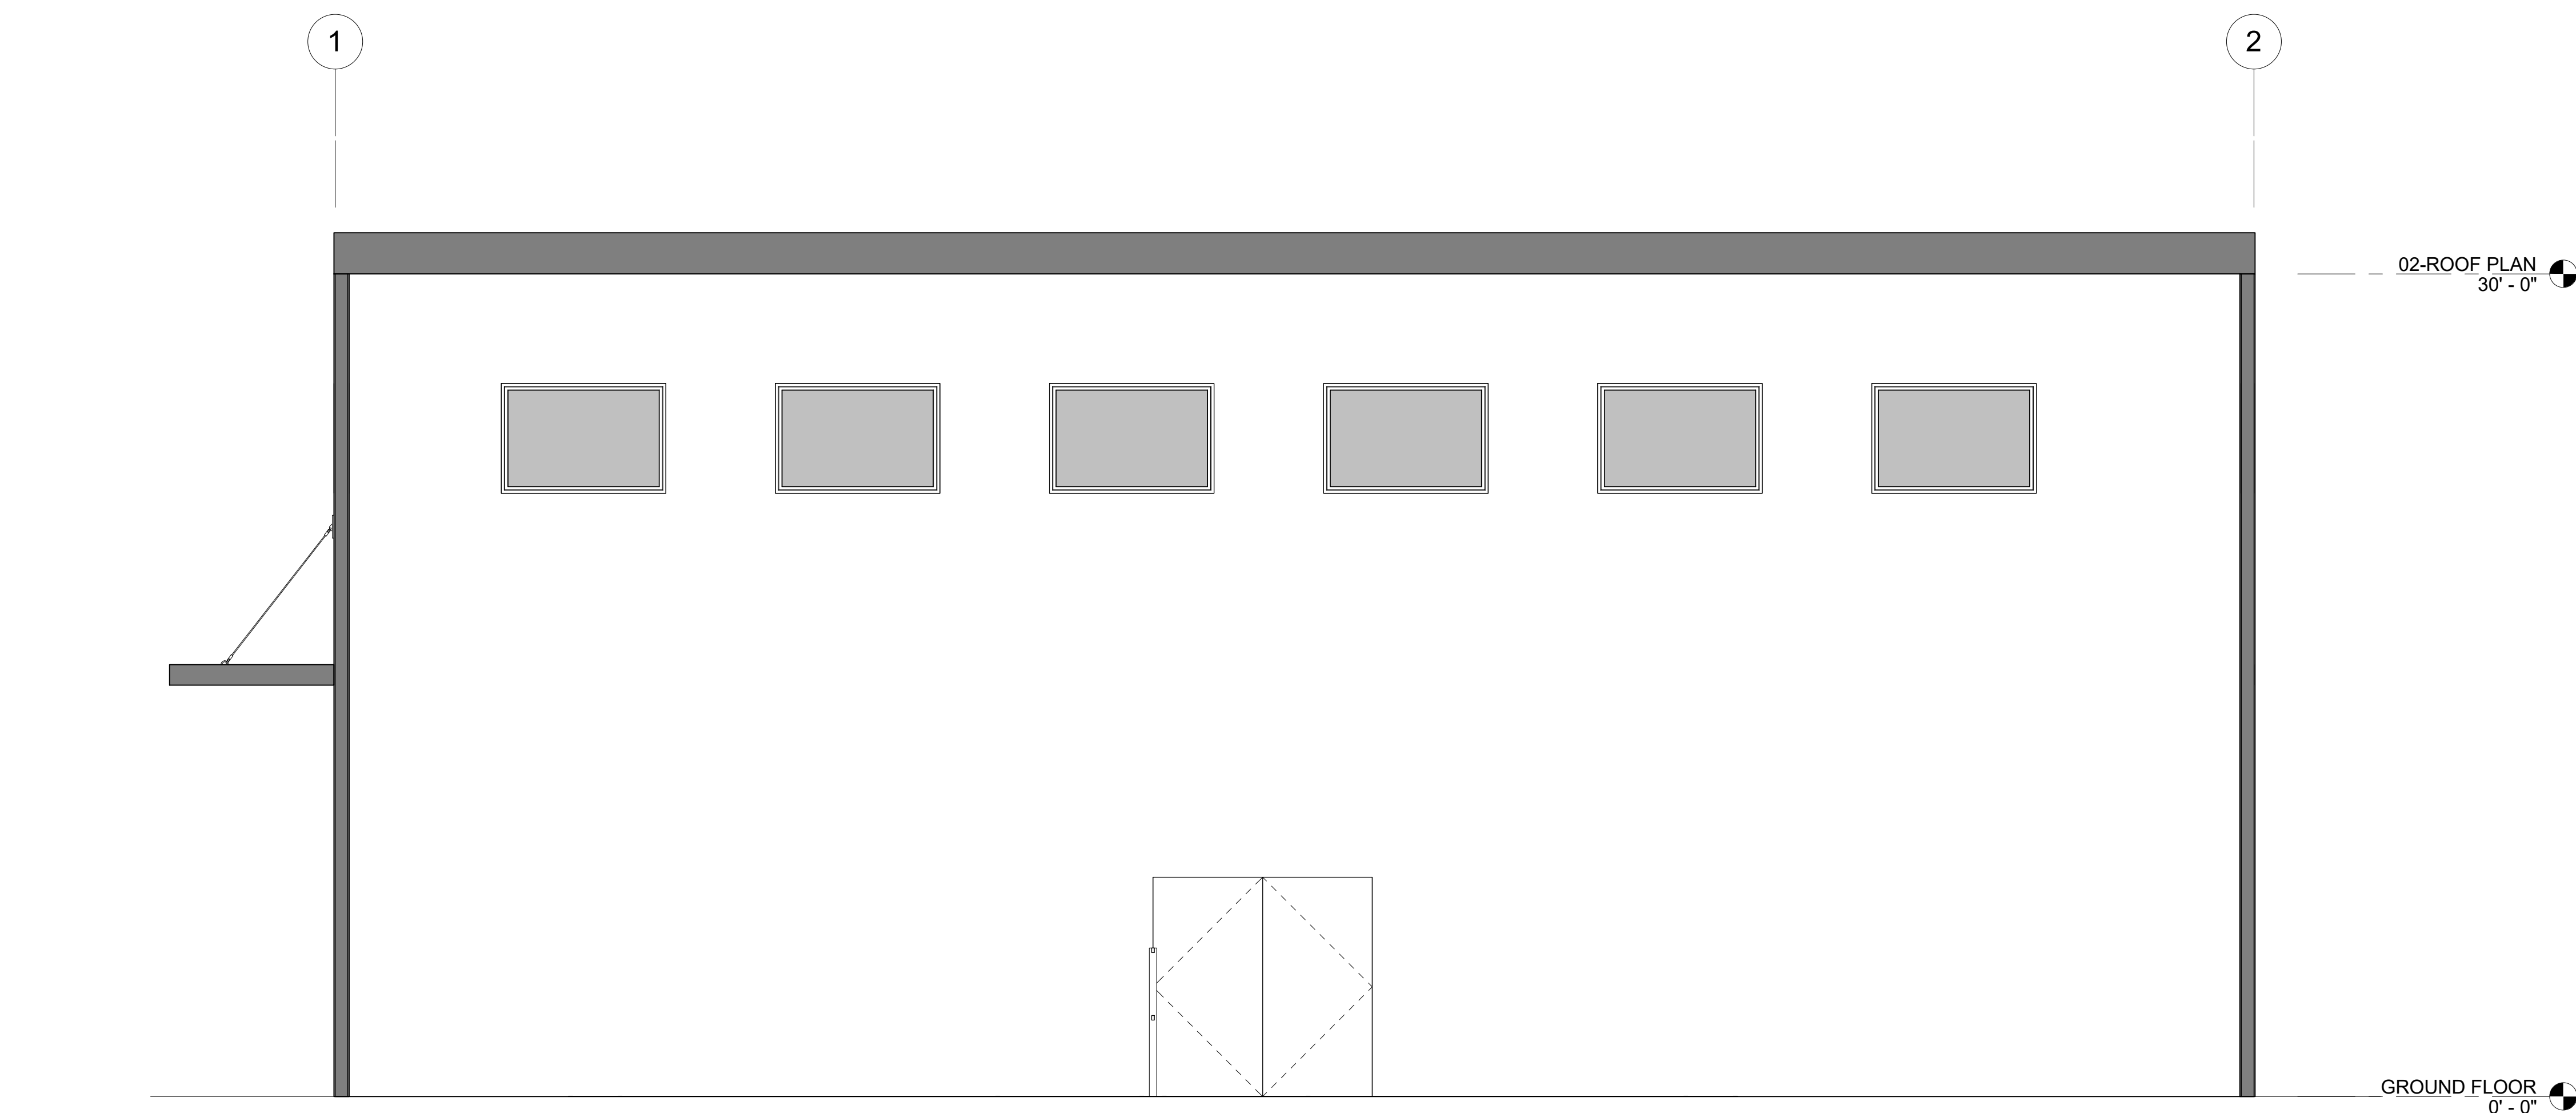
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AB 4.1



42

SECTION 1
1/4" = 1'-0"

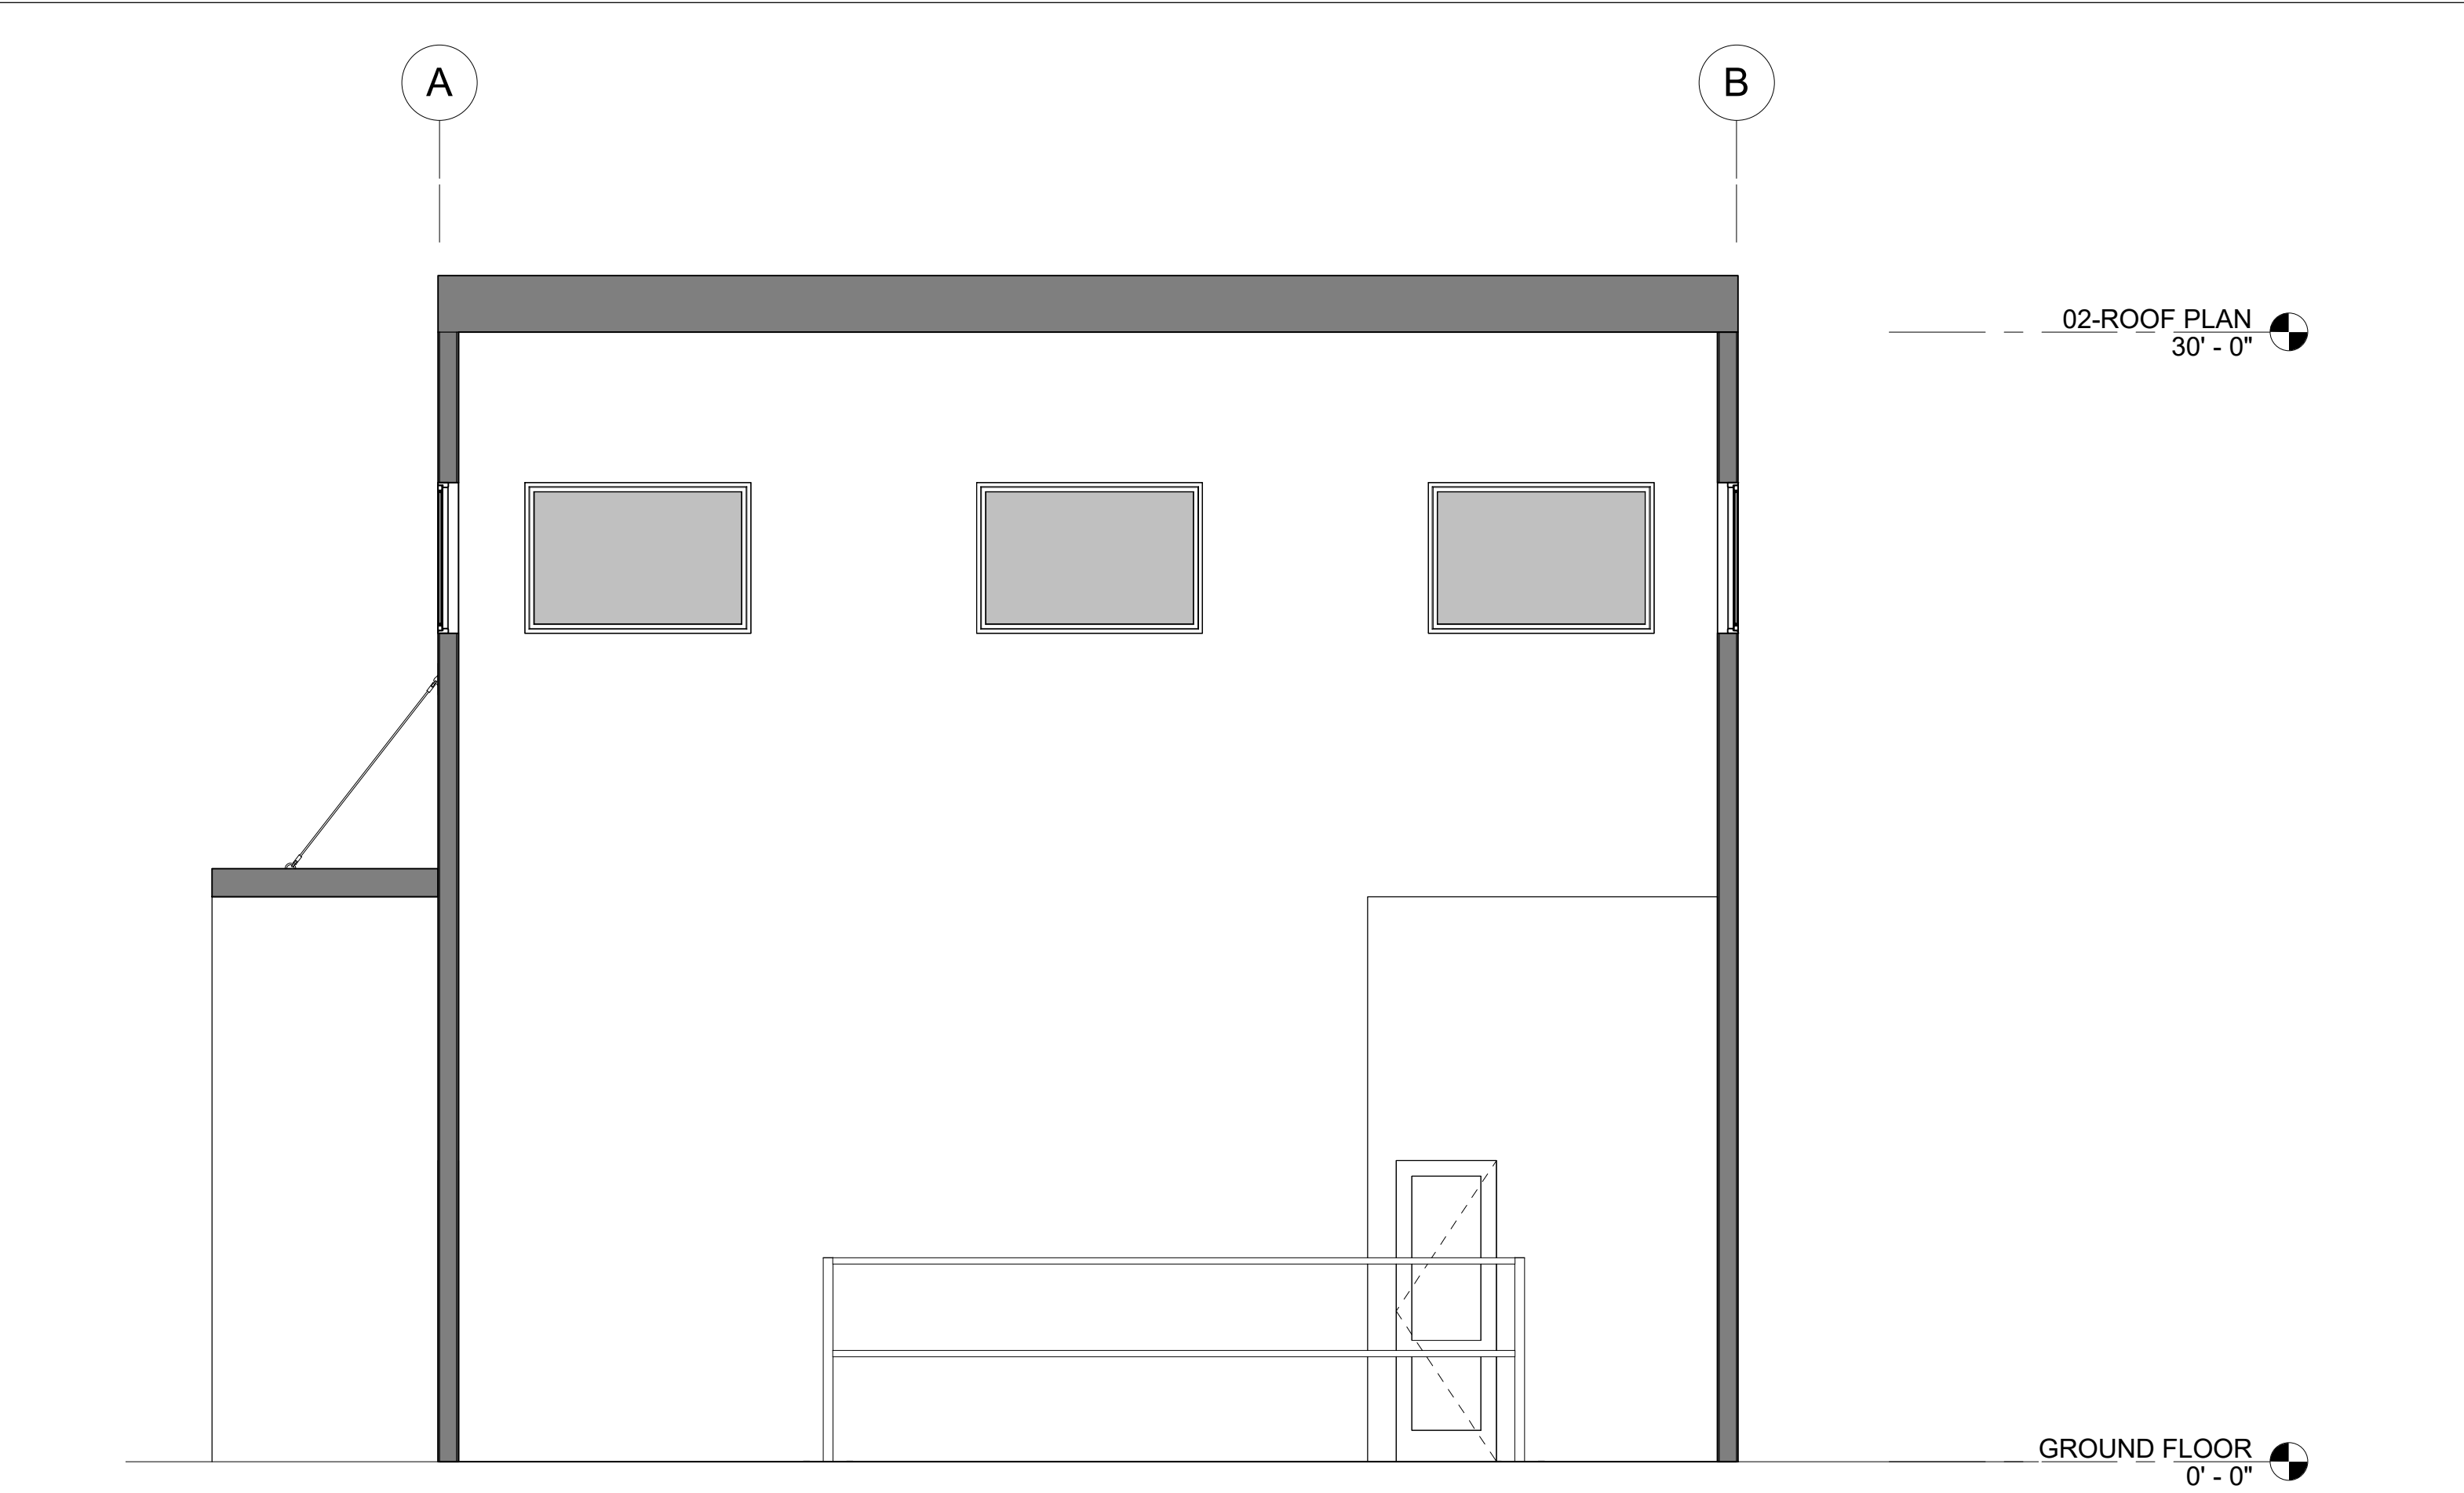

44

SECTION 2
1/4" = 1'-0"