
# GOKULAM, LLC

# SPECIAL PERMIT (PLN22-234)

# SMALL SCALE PERMANENT AGRICULTURAL EMPLOYEE HOUSING APN: 029-34-004

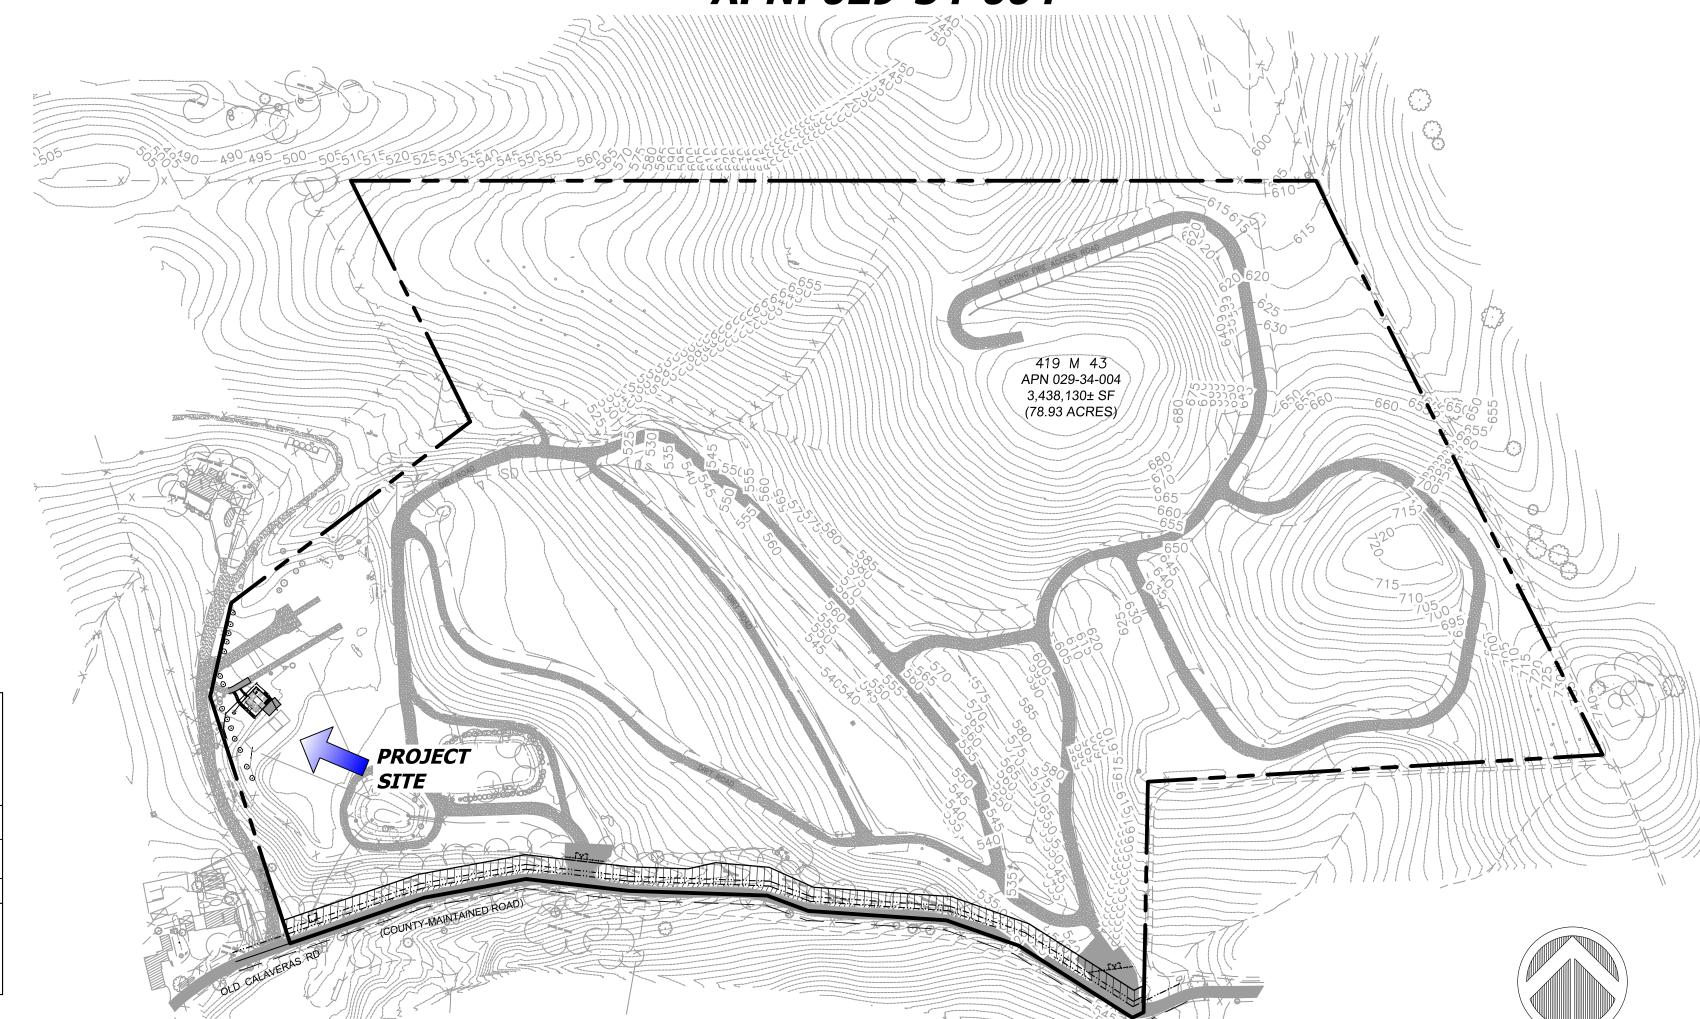

## CIVIL ENGINEER:

C2G/CIVIL CONSULTANTS GROUP, INC 4444 SCOTTS VALLEY DRIVE STE. 6 SCOTTS VALLEY, CA 95066 OFFICE: (831) 438-4420

### **SEPTIC**

LC ENGINEERING 598 E. SANTA CLARA ST., SUITE #270 SAN JOSE, CA 95112 OFFICE: (510) 236-6114 EXT. 211

4444 SCOTTS VALLEY DRIVE STE. 7 SCOTTS VALLEY, CA 95066 OFFICE: (831) 438-4453

OWNER/DEVELOPER:

GOKULAM LLC,

680 E.CALAVERAS BLVD.

MILIPITAS, CA 95035

**SURVEYOR** 

PHONE-(408) 833-9743

EMAIL: gokulam@ihf-usa.org

ALPHA LAND SURVEYS, INC.

# PROJECT EARTHWORK QUANTITIES

NOTE: THE EARTHWORK OUANTITIES SHOWN HEREON ARE EXCLUSIVE OF WALL FOOTINGS, EXISTING PAVEMENT REMOVAL AND OVER EXCAVATION AND RECOMPACTION, UTILITY TRENCH SPOILS & SOIL EXPANSION AND CONTRACTION FACTORS.

DESCRIPTION	CUT (cu.yds)	FILL (cu.yds)	NET (cu.yds)	MAX CUT (ft) HEIGHT	MAX FILL (ft) HEIGHT	IMPERVIOUS AREA (sq.ft)
BLDG + 5' PERIMETER	155	50	105(C)	2.5	3	3205
SITE GRADING & DWY	23	165	142(F)	1.5	2	3203
TOTAL	178	215	37(F)			

### **NET VOLUME = 37 CU.YDS. OF FILL**

THE ABOVE QUANTITIES ARE FOR INFORMATION PURPOSES ONLY. THE CONTRACTOR IS RESPONSIBLE TO PROVIDE THE NECESSARY CUT AND FILL TO ACCOMPLISH FINISH GRADE SHOWN ON THESE PLANS.

### PROJECT DESCRIPTION

PROJECT DESCRIPTION FOR SPECIAL PERMIT AND DESIGN REVIEW APPLICATION FOR SMALL SCALE PERMANENT AGRICULTURAL EMPLOYEE HOUSING (1199 SQFT) FOR APN: 029-34-004 LOCATED AT 2425, OLD CALAVERAS ROAD, MILPITAS, CA 95035.

THIS SMALL SCALE PERMANENT AGRICULTURAL EMPLOYEE HOUSING IS PART OF THE OVERALL PROJECT TO BUILD FACILITIES FOR OUR COMMERCIAL AGRICULTURAL OPERATIONS OF GOKULAM LLC ON THE PROPERTY. AS PART OF PLANNING APPLICATION PLN20-125 WE HAVE RECEIVED GRADING APPROVAL AND DESIGN REVIEW ADMINISTRATIVE APPROVAL FOR THE INFRASTRUCTURES REQUIRED FOR OUR OPERATIONS. THAT APPLICATION ALSO INCLUDED THE APPROVAL FOR A TINY MOBILE HOME TO SERVE AS THE RESIDENCE FOR OUR AGRICULTURAL EMPLOYEES WORKING IN OUR PROPERTY. AFTER A FURTHER DISCUSSION WITH PLANNING MANAGER MICHAEL MEEHAN AND OUR PROJECT PLANNER ROB SALISBURY, WE CAME TO THE CONCLUSION THAT SINCE OUR AGRICULTURAL HOUSING WAS OF PERMANENT NATURE, WE WOULD SUBSTITUTE OUR APPLICATION FOR A TINY MOBILE HOME WITH A SMALL SCALE PERMANENT AGRICULTURAL EMPLOYEE HOUSING. THIS APPLICATION IS MEANT TO GET ENTITLEMENT FOR A 1199 SQFT SMALL SCALE PERMANENT AGRICULTURAL EMPLOYEE HOUSING TO SERVE THIS NEED. WE ARE MAKING USE OF THE TOPOGRAPHY OF THE BUILDING SITE AND THE 1849 SQ.FT CRAWL SPACE CREATED UNDERNEATH THIS BUILDING AS A STORAGE AREA FOR OUR AGRICULTURAL OPERATIONS. THE HEIGHT OF THIS STORAGE AREA IS 6'11" AND THUS WILL NOT BE COUNTED TOWARDS THE GROSS FLOOR AREA OF THE BUILDING.

# THE SCOPE OF THE PROJECT ALREADY APPROVED UNDER PLN20-125 IS AS FOLLOWS:

- DEV23-2302: 1 PREMANUFACTURED METAL LIVESTOCK SHED (1972SQFT)
- DEV23-2307: 1 PREMANUFACTURED METAL AG SHED (1450SQFT)
- DEV23-2308: 1 FEED STORAGE SHED (500SQFT) DEV23-2309: 1 WELL SHED (REGULARIZE)
- DEV23-2310: 1 CARPORT
- DEV23-0115: ONE 202,290-GALLON STEEL TANK FOR FIRE SUPPRESSION AND IRRIGATION DEV22-3196: SHED 1 PREMANUFACTURED METAL LIVESTOCK SHED (500SQFT)
- DEV22-3202: SHED 2 PREMANUFACTURED METAL LIVESTOCK SHED (500SQFT)
- DEV22-3202: SHED 3 PREMANUFACTURED METAL LIVESTOCK SHEDS (500SQFT) DEV22-3206: STORAGE SHED 1 (120SOFT)
- DEV22-3207: STORAGE SHED 1 (120SQFT)

SPECIAL NOTE: AS PER THE DISCUSSION WITH THE ROB SALISBURY, PLANNER PARYA SEIF AND LDE ON 11/20/2023 FOLLOWED BY EMAIL SENT BY PARYA ON 11/30/2023 THE GRADING APPROVAL FOR EARTHWORK ASSOCIATED WITH THE SMALL SCALE PERMANENT AGRICULTURAL EMPLOYEE HOUSING WILL BE APPROVED UNDER PLN20-125MOD1 WHICH IS ALSO BEING PROCESSED SIMULTANEOUSLY.

### GENERAL NOTES

NO CHANGE TO THE GRADING PLAN SHALL BE PERMITTED WITHOUT PRIOR APPROVAL BY THE OWNER OR OWNERS REPRESENTATIVES.

CONTRACTOR SHALL VERIFY LOCATIONS, ELEVATIONS AND INVERTS OF EXISTING UTILITY PRIOR TO COMMENCEMENT OF WORK AND SHALL NOTIFY OWNER OR OWNERS REPRESENTATIVES OF VARIANCE FROM THOSE SHOWN ON THE PLANS.

UNDERGROUND FACILITIES AND UTILITIES HAVE BEEN SHOWN BASED ON RECORD DRAWINGS AND VISIBLE EVIDENCE FOUND IN FIELD. NO WARRANTY IS MADE REGARDING THE COMPLETENESS OR ACCURACY OF SUCH INFORMATION. PRIOR TO CONSTRUCTION, DETERMINE THE EXACT LOCATION OF UNDERGROUND FACILITIES AND UTILITIES, AND PRESERVE SAME FROM DAMAGE. PRIOR TO CONSTRUCTION, VERIFY LOCATION AND ELEVATION OF EXISTING UNDERGROUND UTILITIES AT THE CROSSING POINTS WITH PROPOSED UTILITIES. THE CONTRACTOR SHALL NOTIFY THE OWNER OR OWNERS REPRESENTATIVES IF CONDITIONS DIFFER FROM THOSE SHOWN ON THE DRAWINGS AND SHALL NOT BEGIN CONSTRUCTION UNTIL THE CHANGED CONDITION HAS BEEN EVALUATED. CONTACT

UNDERGROUND SERVICES ALERT (USA) (1-800-227-2600) TWO (2) WEEKS PRIOR TO DIGGING. REPAIR UNDERGROUND UTILITIES DAMAGED BY CONSTRUCTION OPERATIONS. CONTRACTOR SHALL BE RESPONSIBLE FOR ANY AND ALL DAMAGES ASSOCIATED WITH CONTRACTOR'S FAILURE TO EXACTLY LOCATED AND PRESERVE UNDERGROUND FACILITIES AND UTILITIES.

CONTRACTOR SHALL BE RESPONSIBLE FOR ALL COORDINATION WITH THE APPROPRIATE UTILITY COMPANIES AND/OR AGENCIES TO VERIFY THE EXISTENCE AND/OR LOCATION OF ALL UNDERGROUND UTILITIES PRIOR TO COMMENCEMENT OF WORK. AND SHALL NOTIFY U.S.A. @ (800) 227-2600 AT LEAST 48-HOURS IN ADVANCE OF EXCAVATION.

IF ANY INDICATIONS OF ARCHEOLOGICAL REMIANS ARE ENCOUNTERED DURING GRADING ACTIVITIES FOR ANY DEVELOPMENT WITHIN THE PROJECT SITE, ALL WORK SHALL BE HALTED WITHIN 200 FOOT RADIUS OF THE FIND. OWNER SHALL RETAIN A QUALIFIED ARCHEOLOGIST RETAINED TO DETERMINE THE NATURE OF THE DISCOVERY AND RECOMMEND APPROPRATE EVALUATION PROCEDURES.

### ADDITIONAL NOTES

- CONTRACTOR AGREES THAT HE SHALL ASSUME SOLE AND COMPLETE RESPONSIBILITY FOR JOB SITE CONDITIONS DURING THE COURSE OF CONSTRUCTION OF THIS PROJECT, INCLUDING SAFETY OF ALL PERSONS AND PROPERTY; THAT THIS REQUIREMENT SHALL APPLY CONTINUOUSLY AND NOT BE LIMITED TO NORMAL WORKING HOURS; AND THAT THE CONTRACTOR SHALL DEFEND, INDEMNIFY, AND HOLD THE OWNER AND THE ENGINEER HARMLESS FROM ANY AND ALL LIABILITY, REAL OR ALLEGED, IN CONNECTION WITH THE PERFORMANCE OF WORK ON THIS PROJECT, EXCEPTING FOR LIABILITY ARISING FROM THE SOLE NEGLIGENCE OF THE OWNER OR THE ENGINEER.

- THE STANDARD SPECIFICATIONS AND DETAILS, LATEST EDITION, OF THE COUNTY OF SANTA CLARA SHALL GOVERN UNLESS OTHERWISE SPECIFIED

- ALL UTILITIES SHALL BE INSTALLED UNDERGROUND. NEW ELECTRICAL SERVICE SHALL BE INSTALLED UNDERGROUND.

# UNAUTHORIZED CHANGES AND USES

CAUTION: THE ENGINEER PREPARING THESE PLANS WILL NOT BE RESPONSIBLE FOR, OR LIABLE FOR, UNAUTHORIZED CHANGES TO OR USES OF THESE PLANS. ALL CHANGES TO THE PLANS MUST BE IN WRITING AND MUST BE APPROVED BY THE PREPARER OF THE PLANS

## CONTRACTOR RESPONSIBILITY

CONTRACTOR AGREES THAT HE SHOULD ASSUME SOLE AND COMPLETE RESPONSIBILITY FOR JOB SITE CONDITIONS, INCLUDING THE SAFETY OF ALL PERSONS AND PROPERTY, DURING THE COURSE OF CONSTRUCTION OF THIS PROJECT, AND THAT REQUIREMENT SHALL APPLY CONTINUOUSLY AND NOT BE LIMITED DURING WORKING HOURS. THE CONTRACTOR SHALL DEFEND, INDEMNIFY AND HOLD THE OWNER AND THE DESIGN PROFESSIONALS HARMLESS FROM ANY AND ALL LIABILITY, REAL OR ALLEGED, IN CONNECTION WITH THE PERFORMANCE OF WORK ON THIS PROJECT, EXCEPTING FOR LIABILITY ARISING FROM THE SOLE NEGLIGENCE OF THE OWNER OR DESIGN PROFESSIONAL.

### DISCREPANCIES

IF THERE ARE ANY DISCREPANCIES BETWEEN THE CONSTRUCTION DOCUMENTS AND EXISTING CONDITIONS WHICH WILL AFFECT THE WORK, THE CONTRACTOR SHALL BRING SUCH DISCREPANCIES TO THE DESIGN PROFESSIONAL FOR ADJUSTMENT BEFORE PROCEEDING WITH THE WORK. THE CONTRACTOR SHALL BE RESPONSIBLE FOR THE PROPER FITTING OF ALL WORK AND FOR THE COORDINATION OF ALL TRADES, SUBCONTRACTORS, AND PERSONS ENGAGED UPON THIS CONTRACT.

### CONSTRUCTION SURVEYING / STAKING

CONTRACTOR IS RESPONSIBLE TO PROVIDE ALL SURVEYING AND OR STAKING BY A LICENSED SURVEYOR FOR ALL CONSTRUCTION PURPOSES.

LOT SIZE:

2425 OLD CALAVERAS ROAD, MILPITAS, CA 95035 ZONING DESIGNATION: D2 - HS - HILLSIDE 029-34-004

**BUILDING AREA:** 

2249 SQ. FT. (BUILDING AREA TOTAL)

R3 SPRINKLERED:


PROJECT DEMOLITION: EXISTING BUILDING 1, 2, 3, 4, 6 & 7 TO BE

EXISTING BUILDING 5 TO BE REGULARIZED.

# TREE DEMOLITION NOTE

NO EXISTING TREES ARE MARKED FOR DEMOLITION UNDER THIS APPLICATION



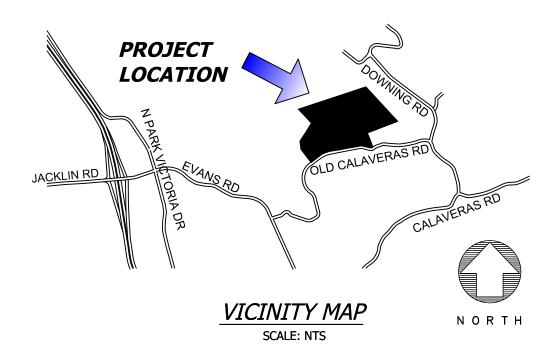

### INDEX OF SHEETS

CIVIL PLANS:

C0.1 - COVER SHEET

C0.2 - GRADING PERMITS PROCESS OVERVIEW

C1.1 - OVERALL PLAN

C1.2 - SIGHT DISTANCE ANALYSIS

C1.3 - SIGHT DISTANCE ANALYSIS

C2.1 - GRADING & DRAINAGE PLAN

C2.2 - SECTIONS

**C3.1 - CONSTRUCTION DETAILS** C4.1 - EROSION CONTROL PLAN

C5.1 - GRADING AND DRAINAGE - FIRE ROAD C6.1 - FIRE ROAD ACCESS PROFILE & SECTION

### ARCHITECTURAL PLANS:

A01 - FLOOR PLAN & AREA CALCULATION

A02 - STORAGE FLOOR PLAN

A03 - ELEVATIONS BW1

A04 - ELEVATIONS BW2

A05 - SECTIONS A06 - VIEWS

APPROVED SEPTIC SYSTEM PLANS:

SS1- SEPTIC SYSTEM SITE PLAN

SS2 - SEPTIC SYSTEM DETAILS

SS3 - SEPTIC SYSTEM CALCULATIONS

H1- TEMPORARY & PERMANENT LAND COVER

### APPLICABLE CODES

ALL CONSTRUCTION SHALL COMPLY WITH ALL LOCAL CODES AND ORDINANCES AND THE CODES LISTED BELOW OR THE MOST CURRENT CODES AND ORDANCENCES AT THE TIME OF SUBMITTAL:

### 2022 CALIFORNIA CODES

1. 2022 CALIFORNIA BUILDING CODE

2. 2022 CALIFORNIA ELECTRICAL CODE

3. 2022 CALIFORNIA MECHANICAL CODE

4. 2022 CALIFORNIA PLUMBING CODE

5. 2022 CALIFORNIA GREEN BUILDING CODE

6. 2022 CALIFORNIA ENERGY CODE

7. 2022 CALIFORNIA RESIDENTIAL CODE

8. 2022 CALIFORNIA FIRE CODE

PROJECT DATA

78.93 ACRES (3,438,191 SQ. FT.)

2249 SQ. FT. OF COVERED AREA

0.00065% OF ENTIRE LOT

TYPE OF CONSTRUCTION: TYPE 1 OCCUPANCY GROUP:


DEMOLISHED (VIOLATION VIO19-00082)

DEMOLITION AND REGULARIZATION TO OCCUR UNDER DEV22-3196, DEV22-3201, DEV22-3202, DEV22-3206, DEV22-3207 & DEV23-0115)



**RESPONSE TO SCC** angle COMMENTS 05.09.23


REVISIONS

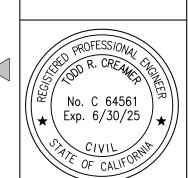



G 5


10/13/2023 **AS SHOWN** 


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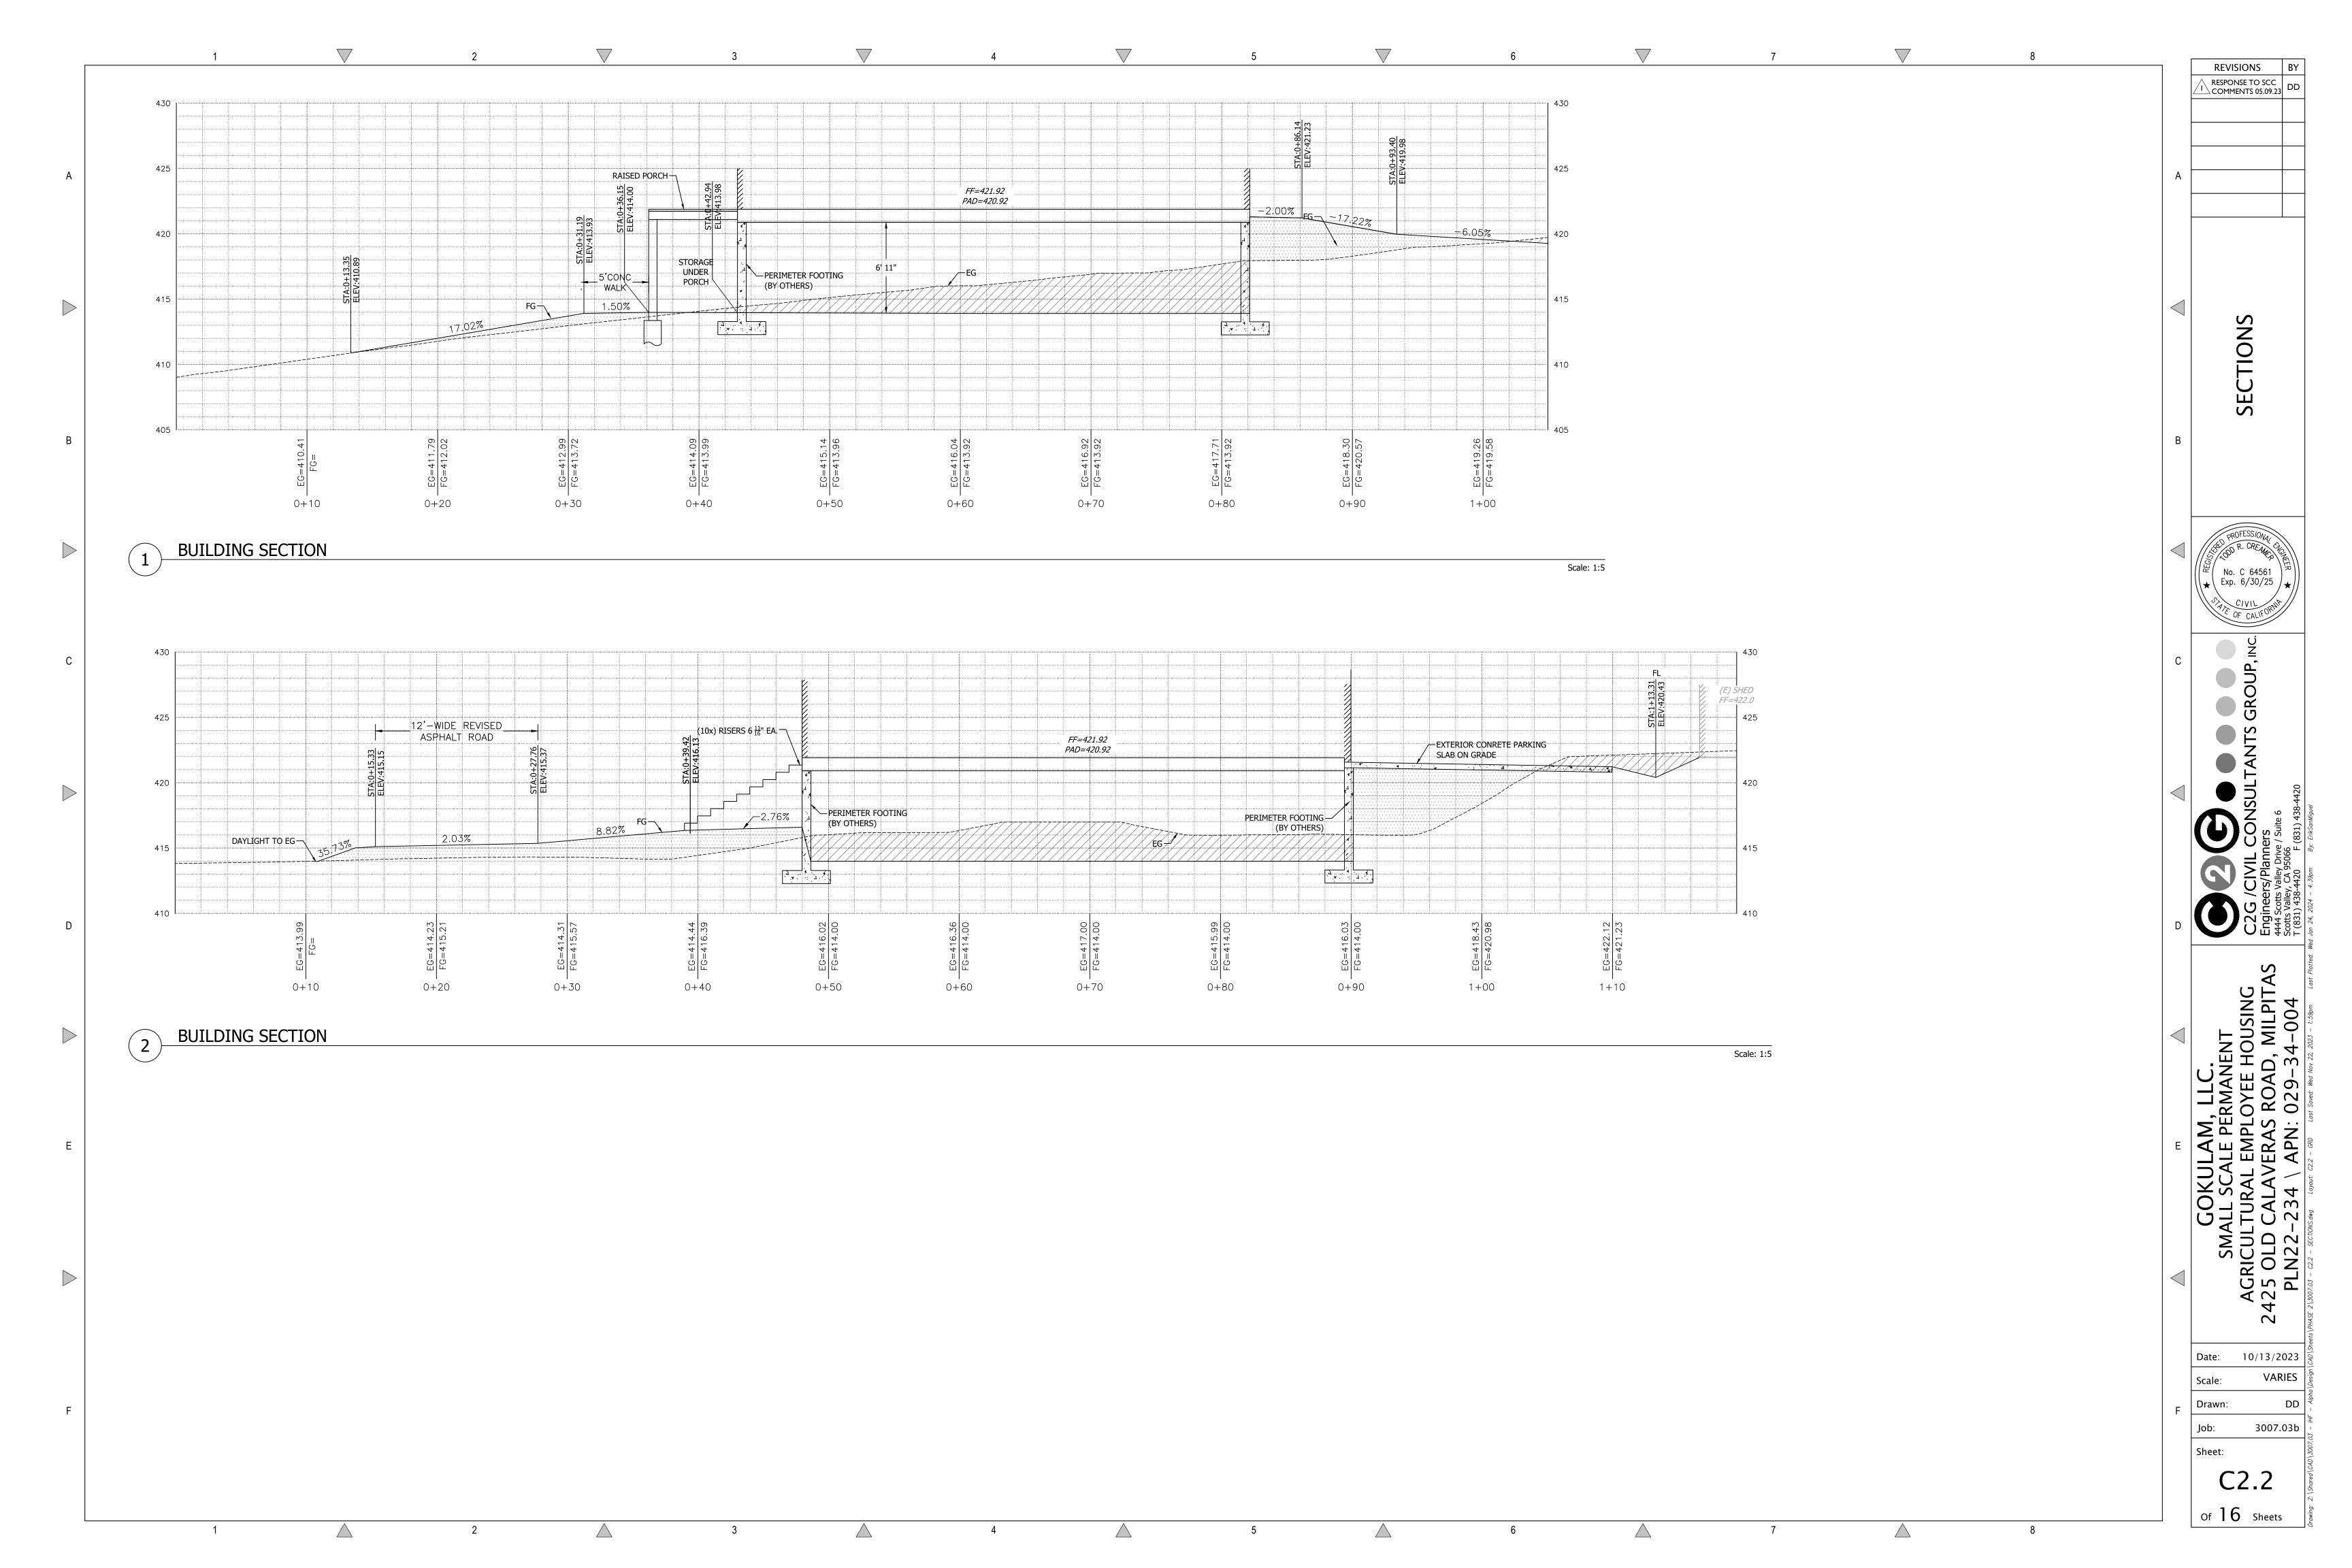


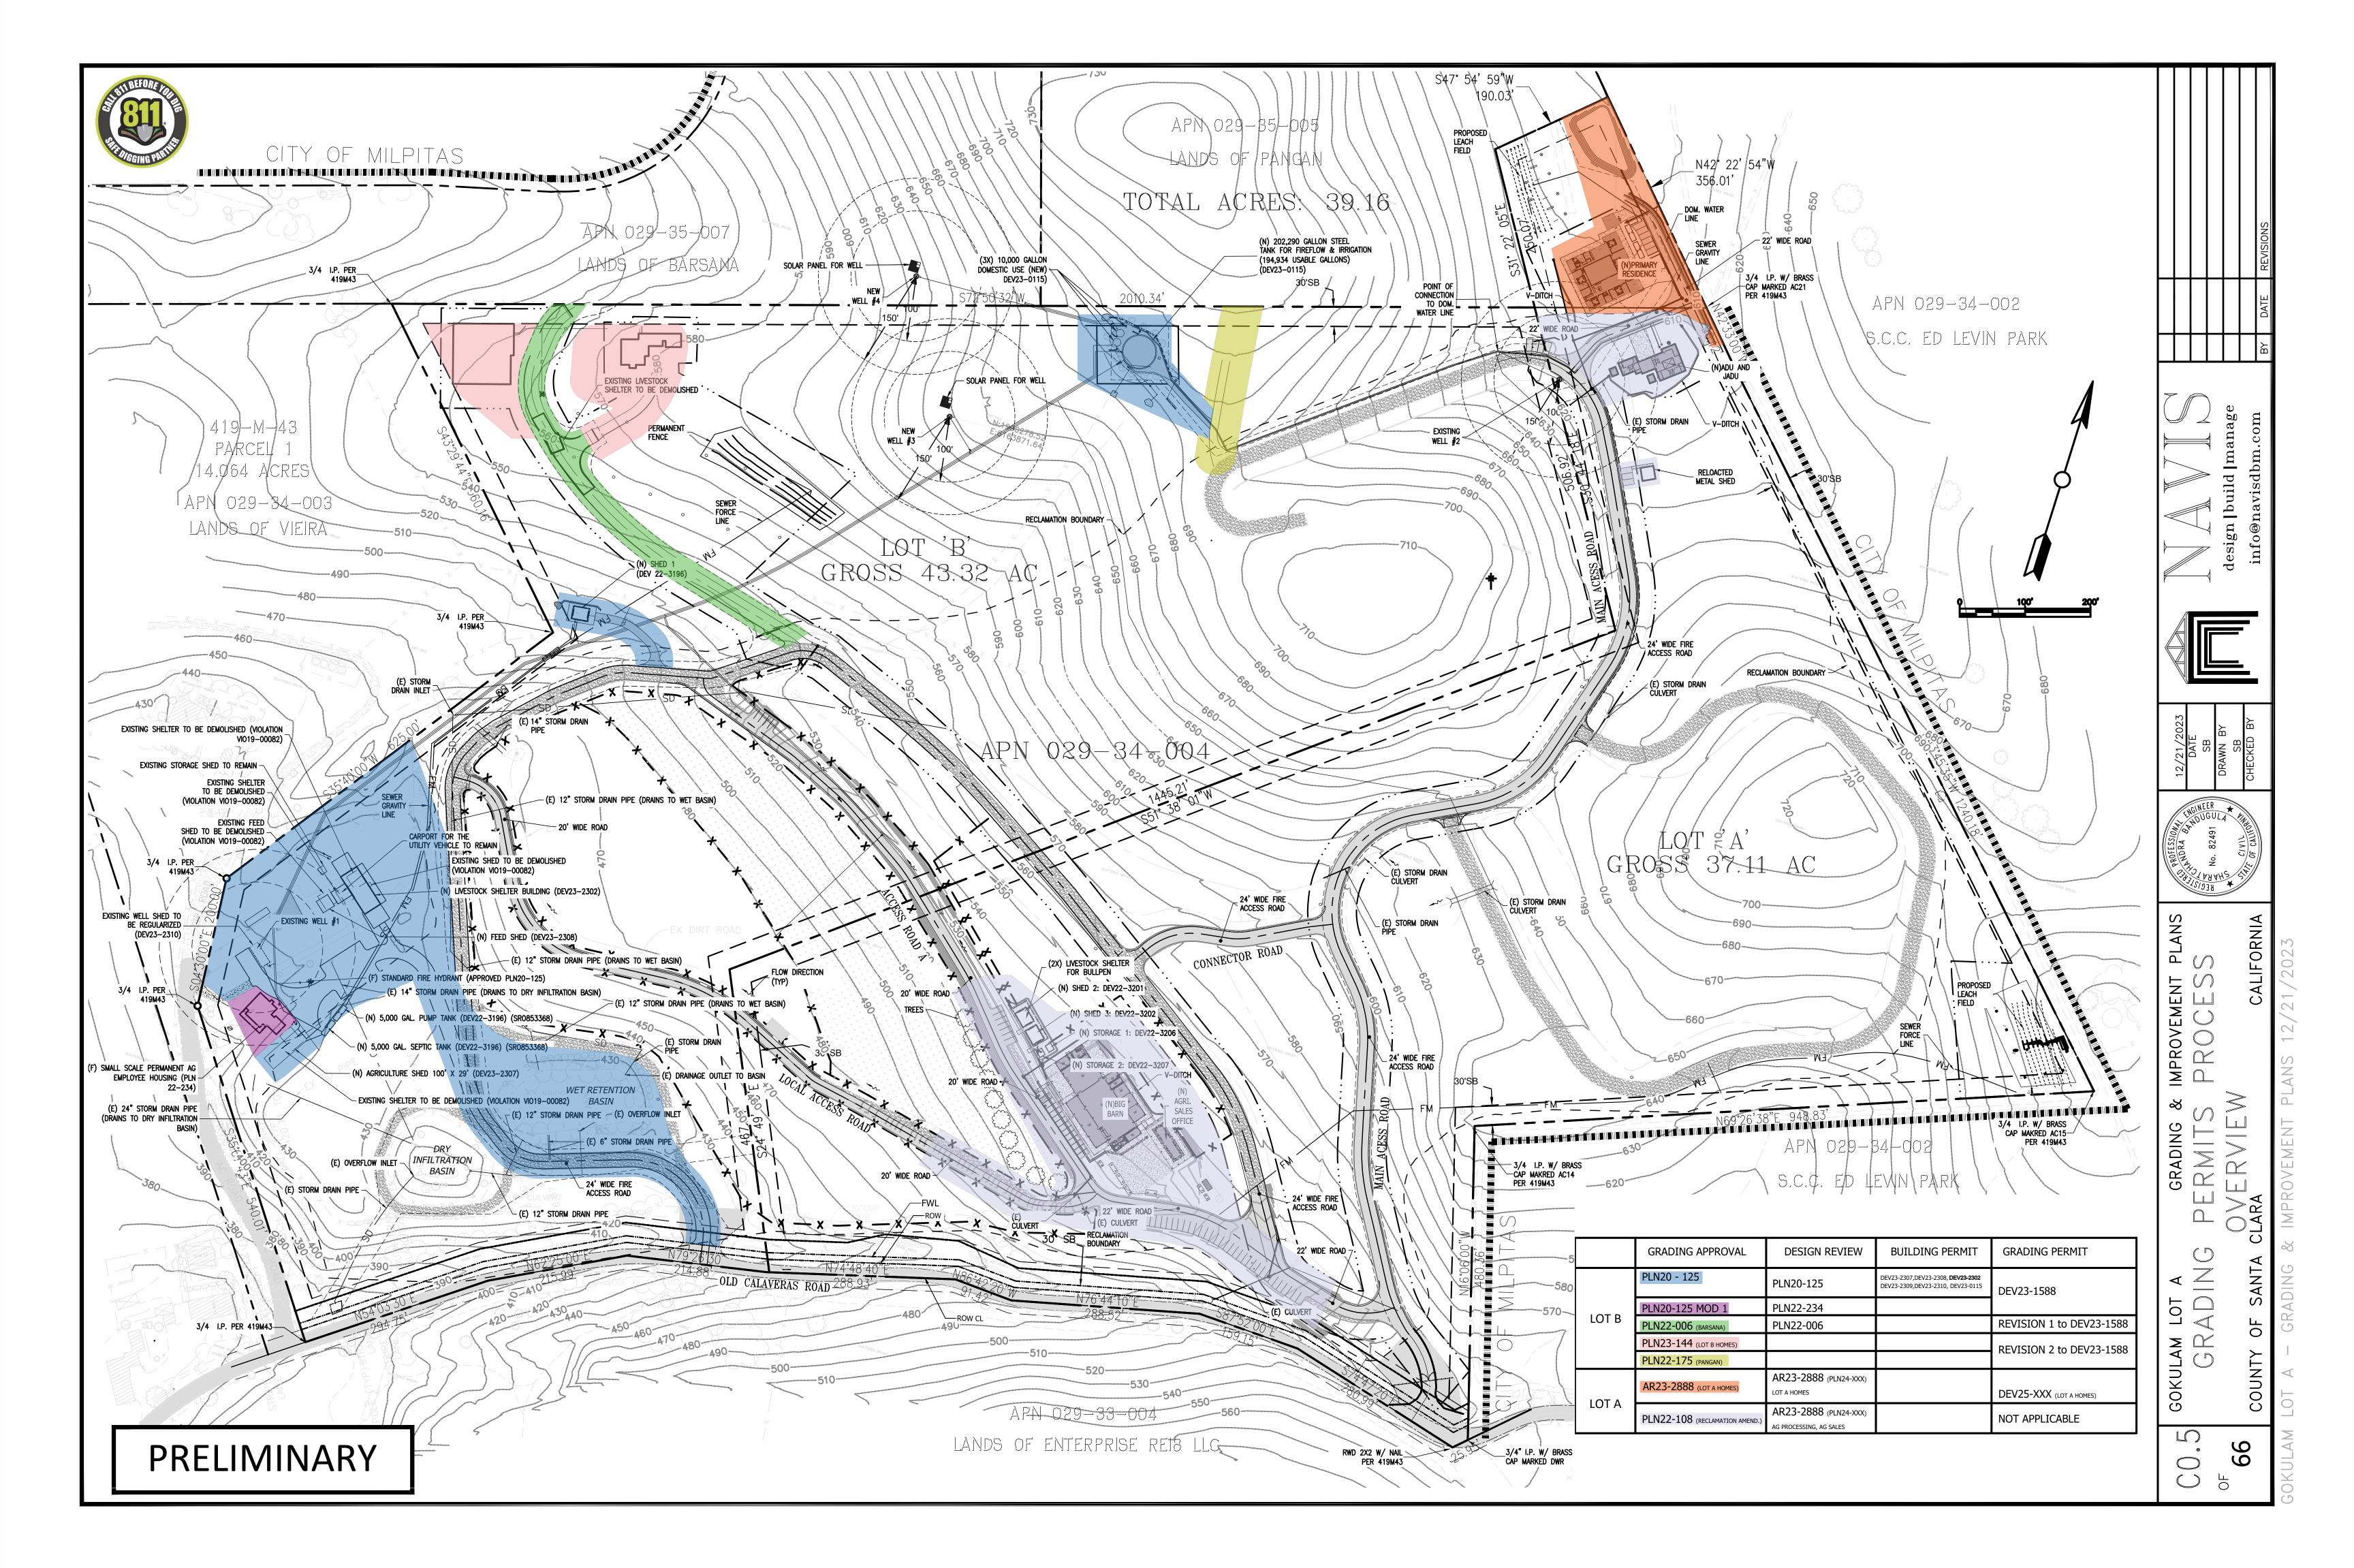


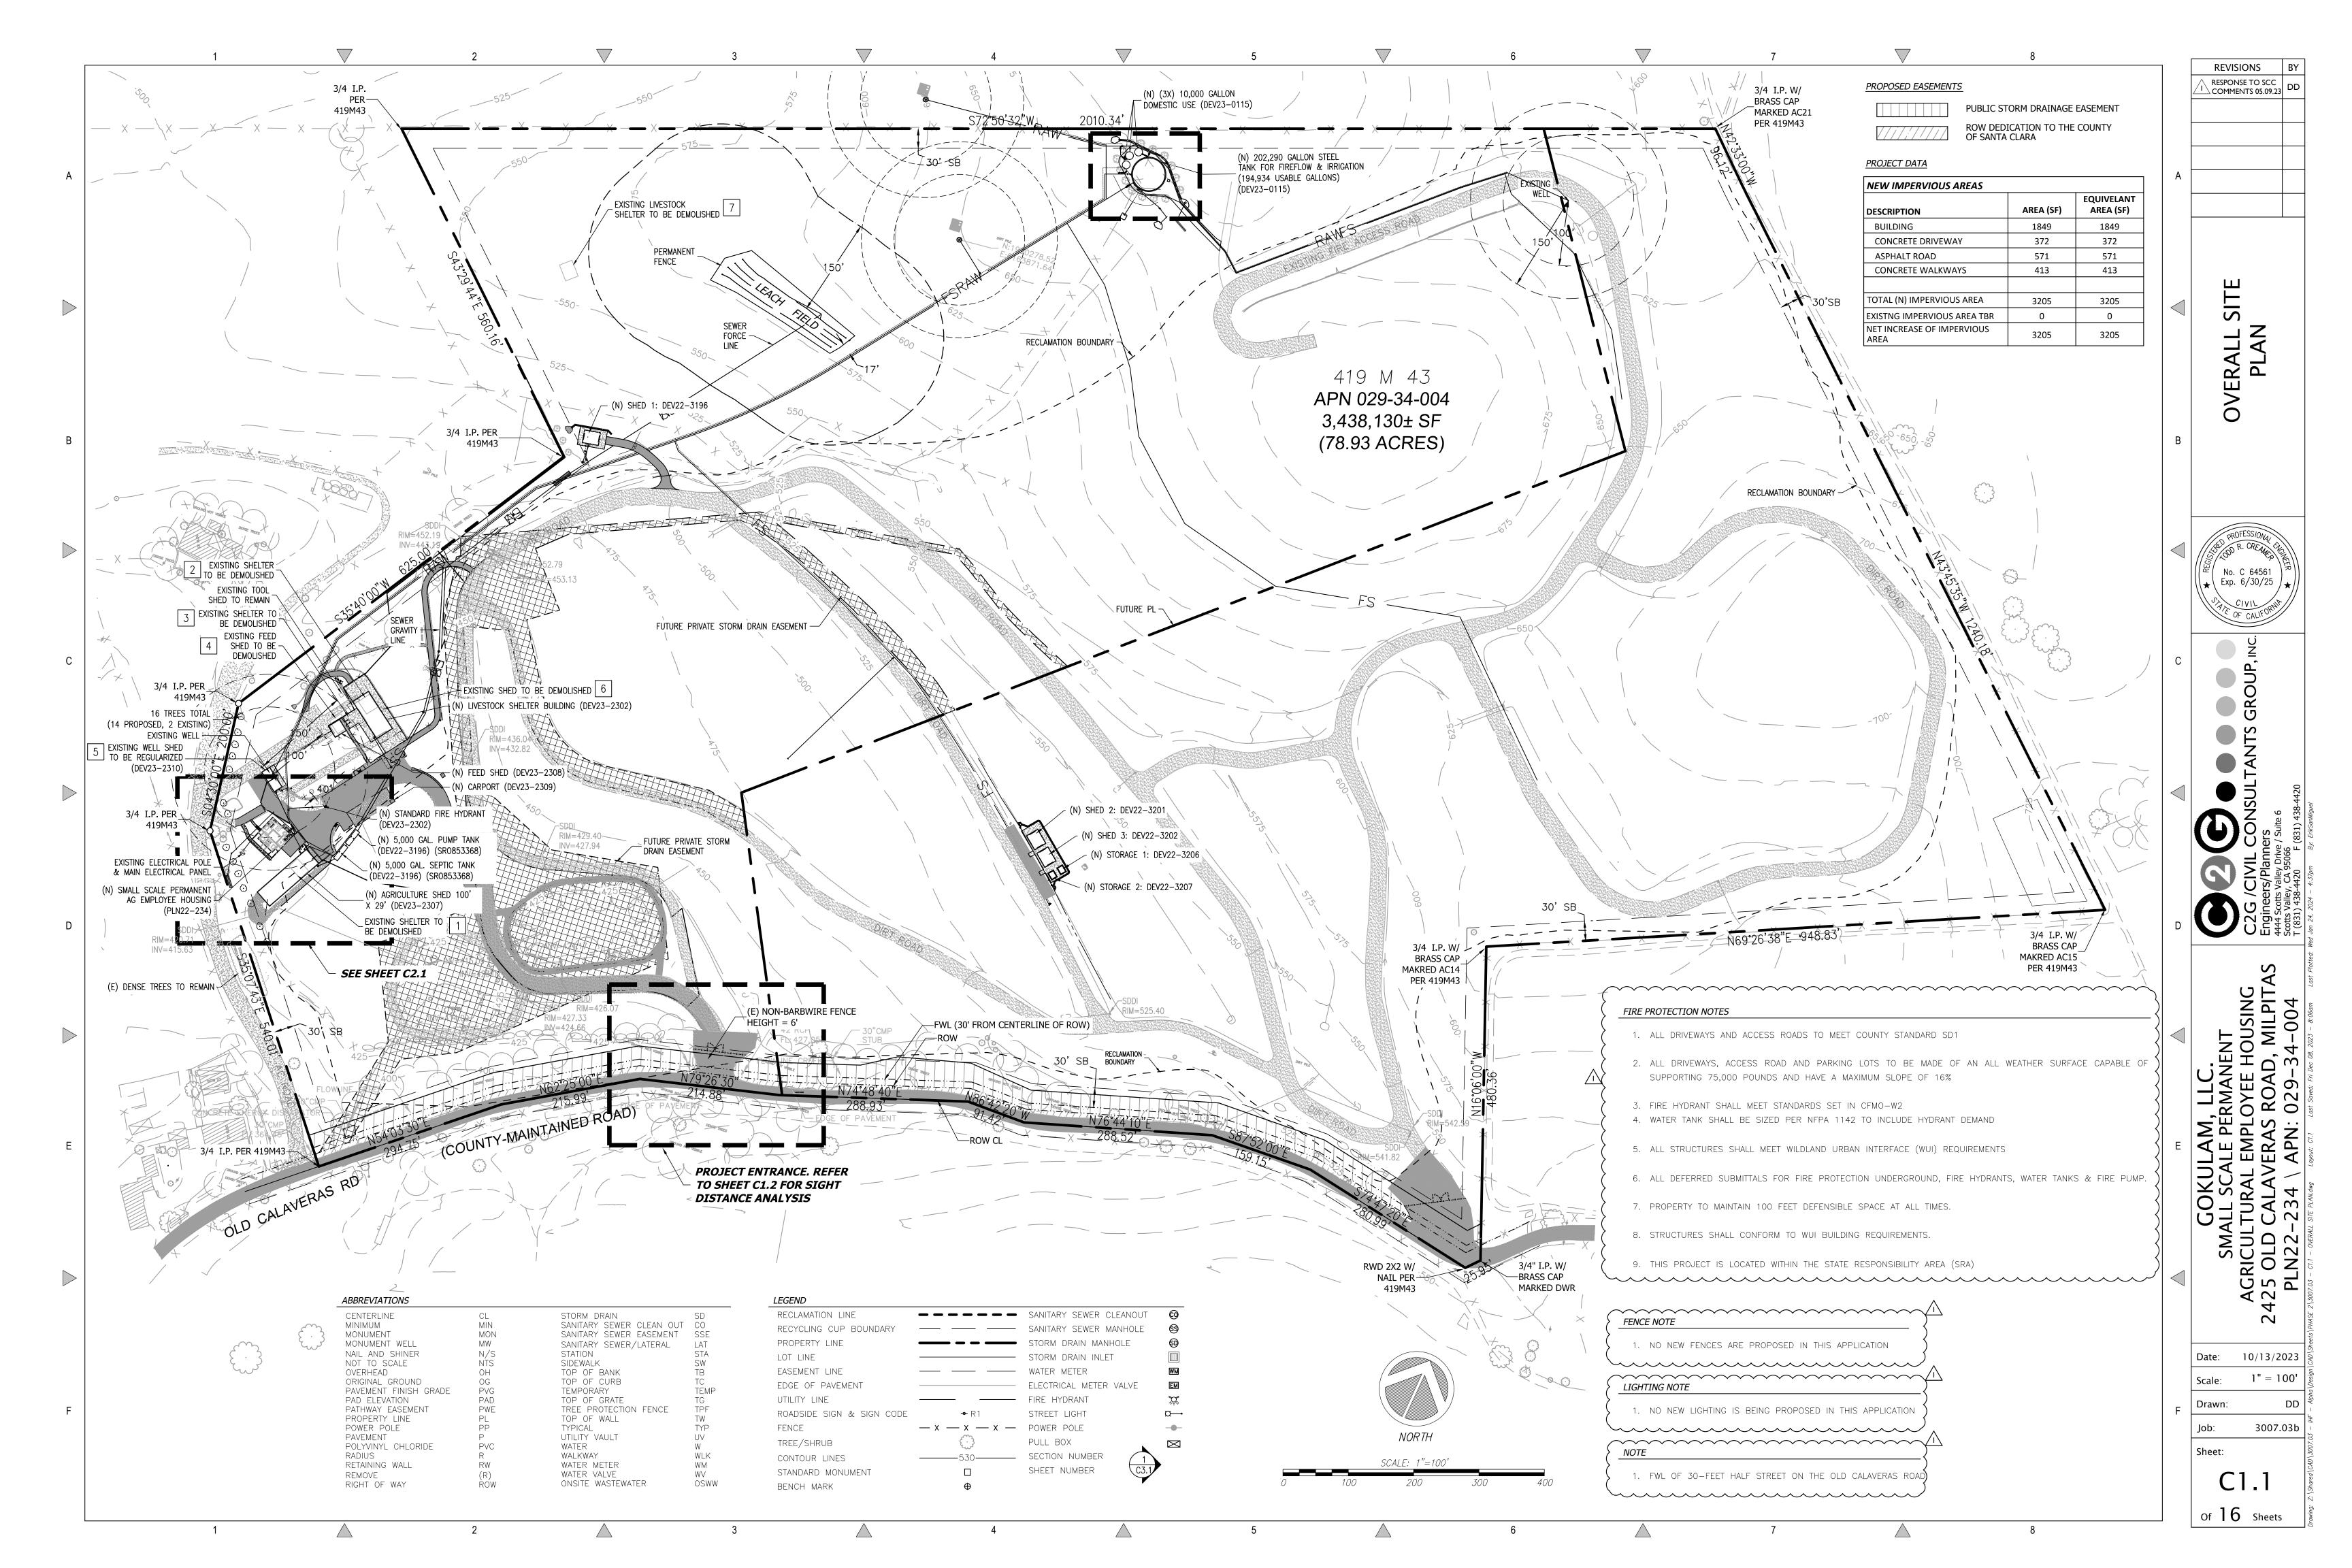


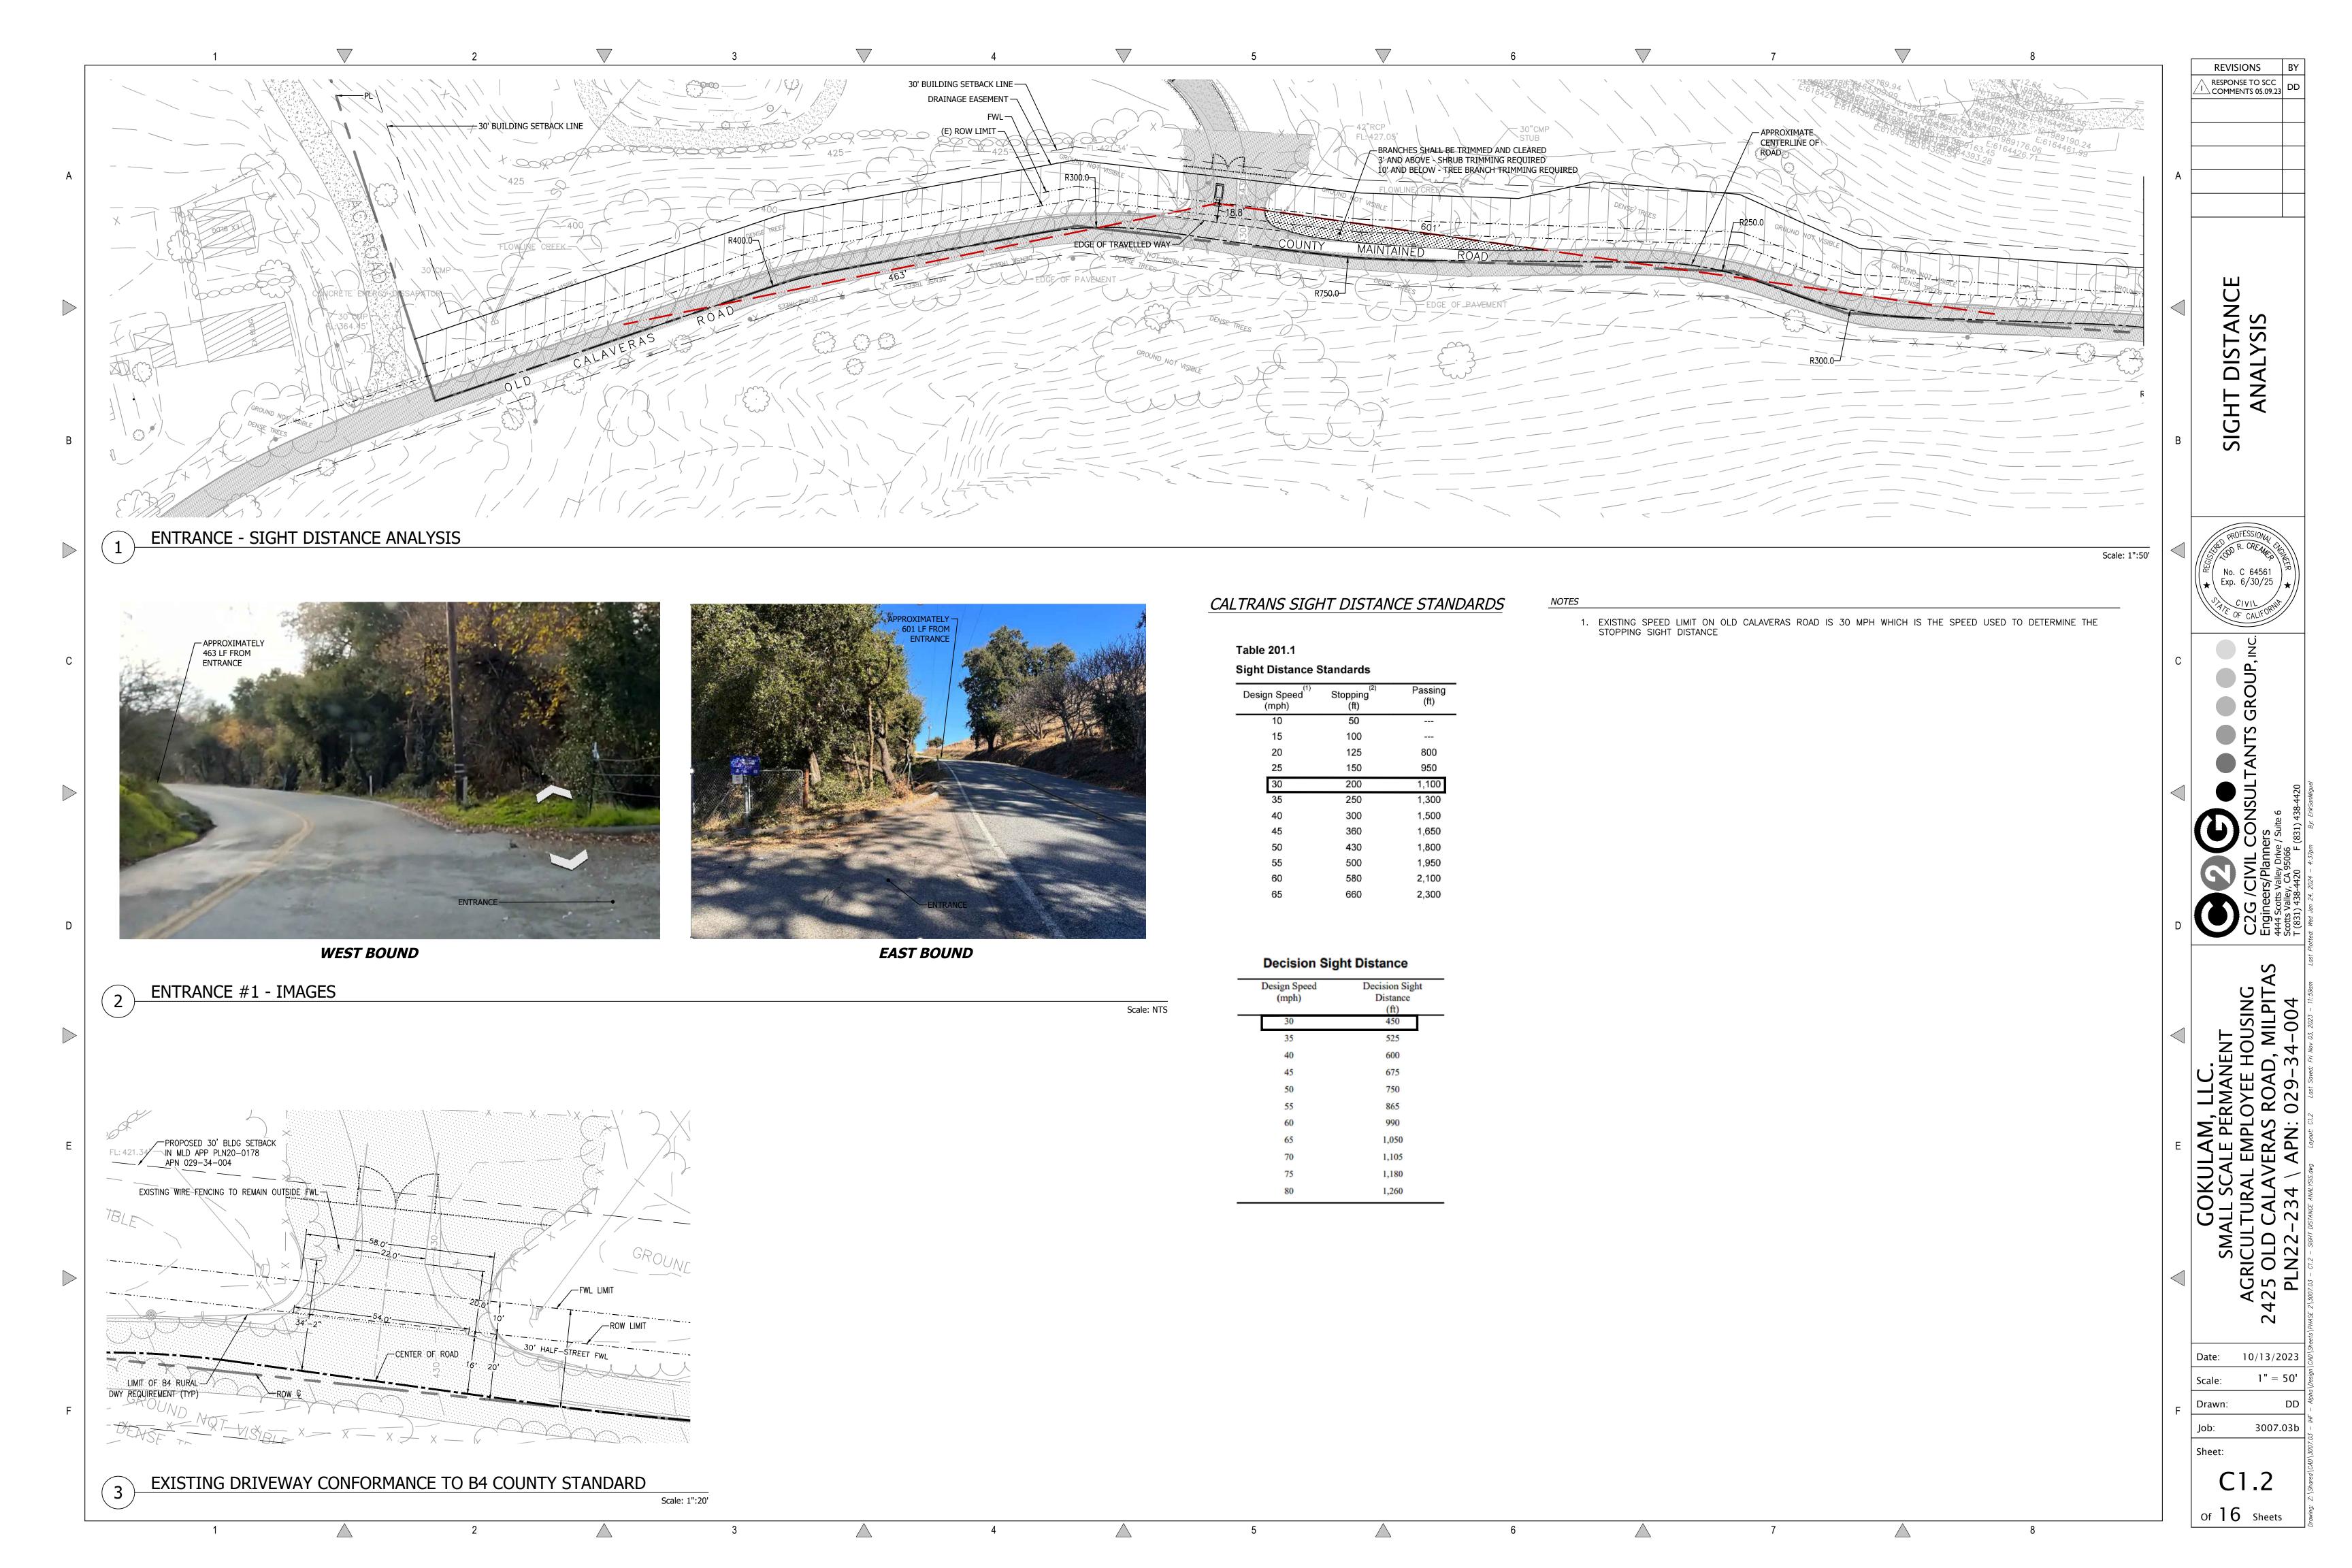

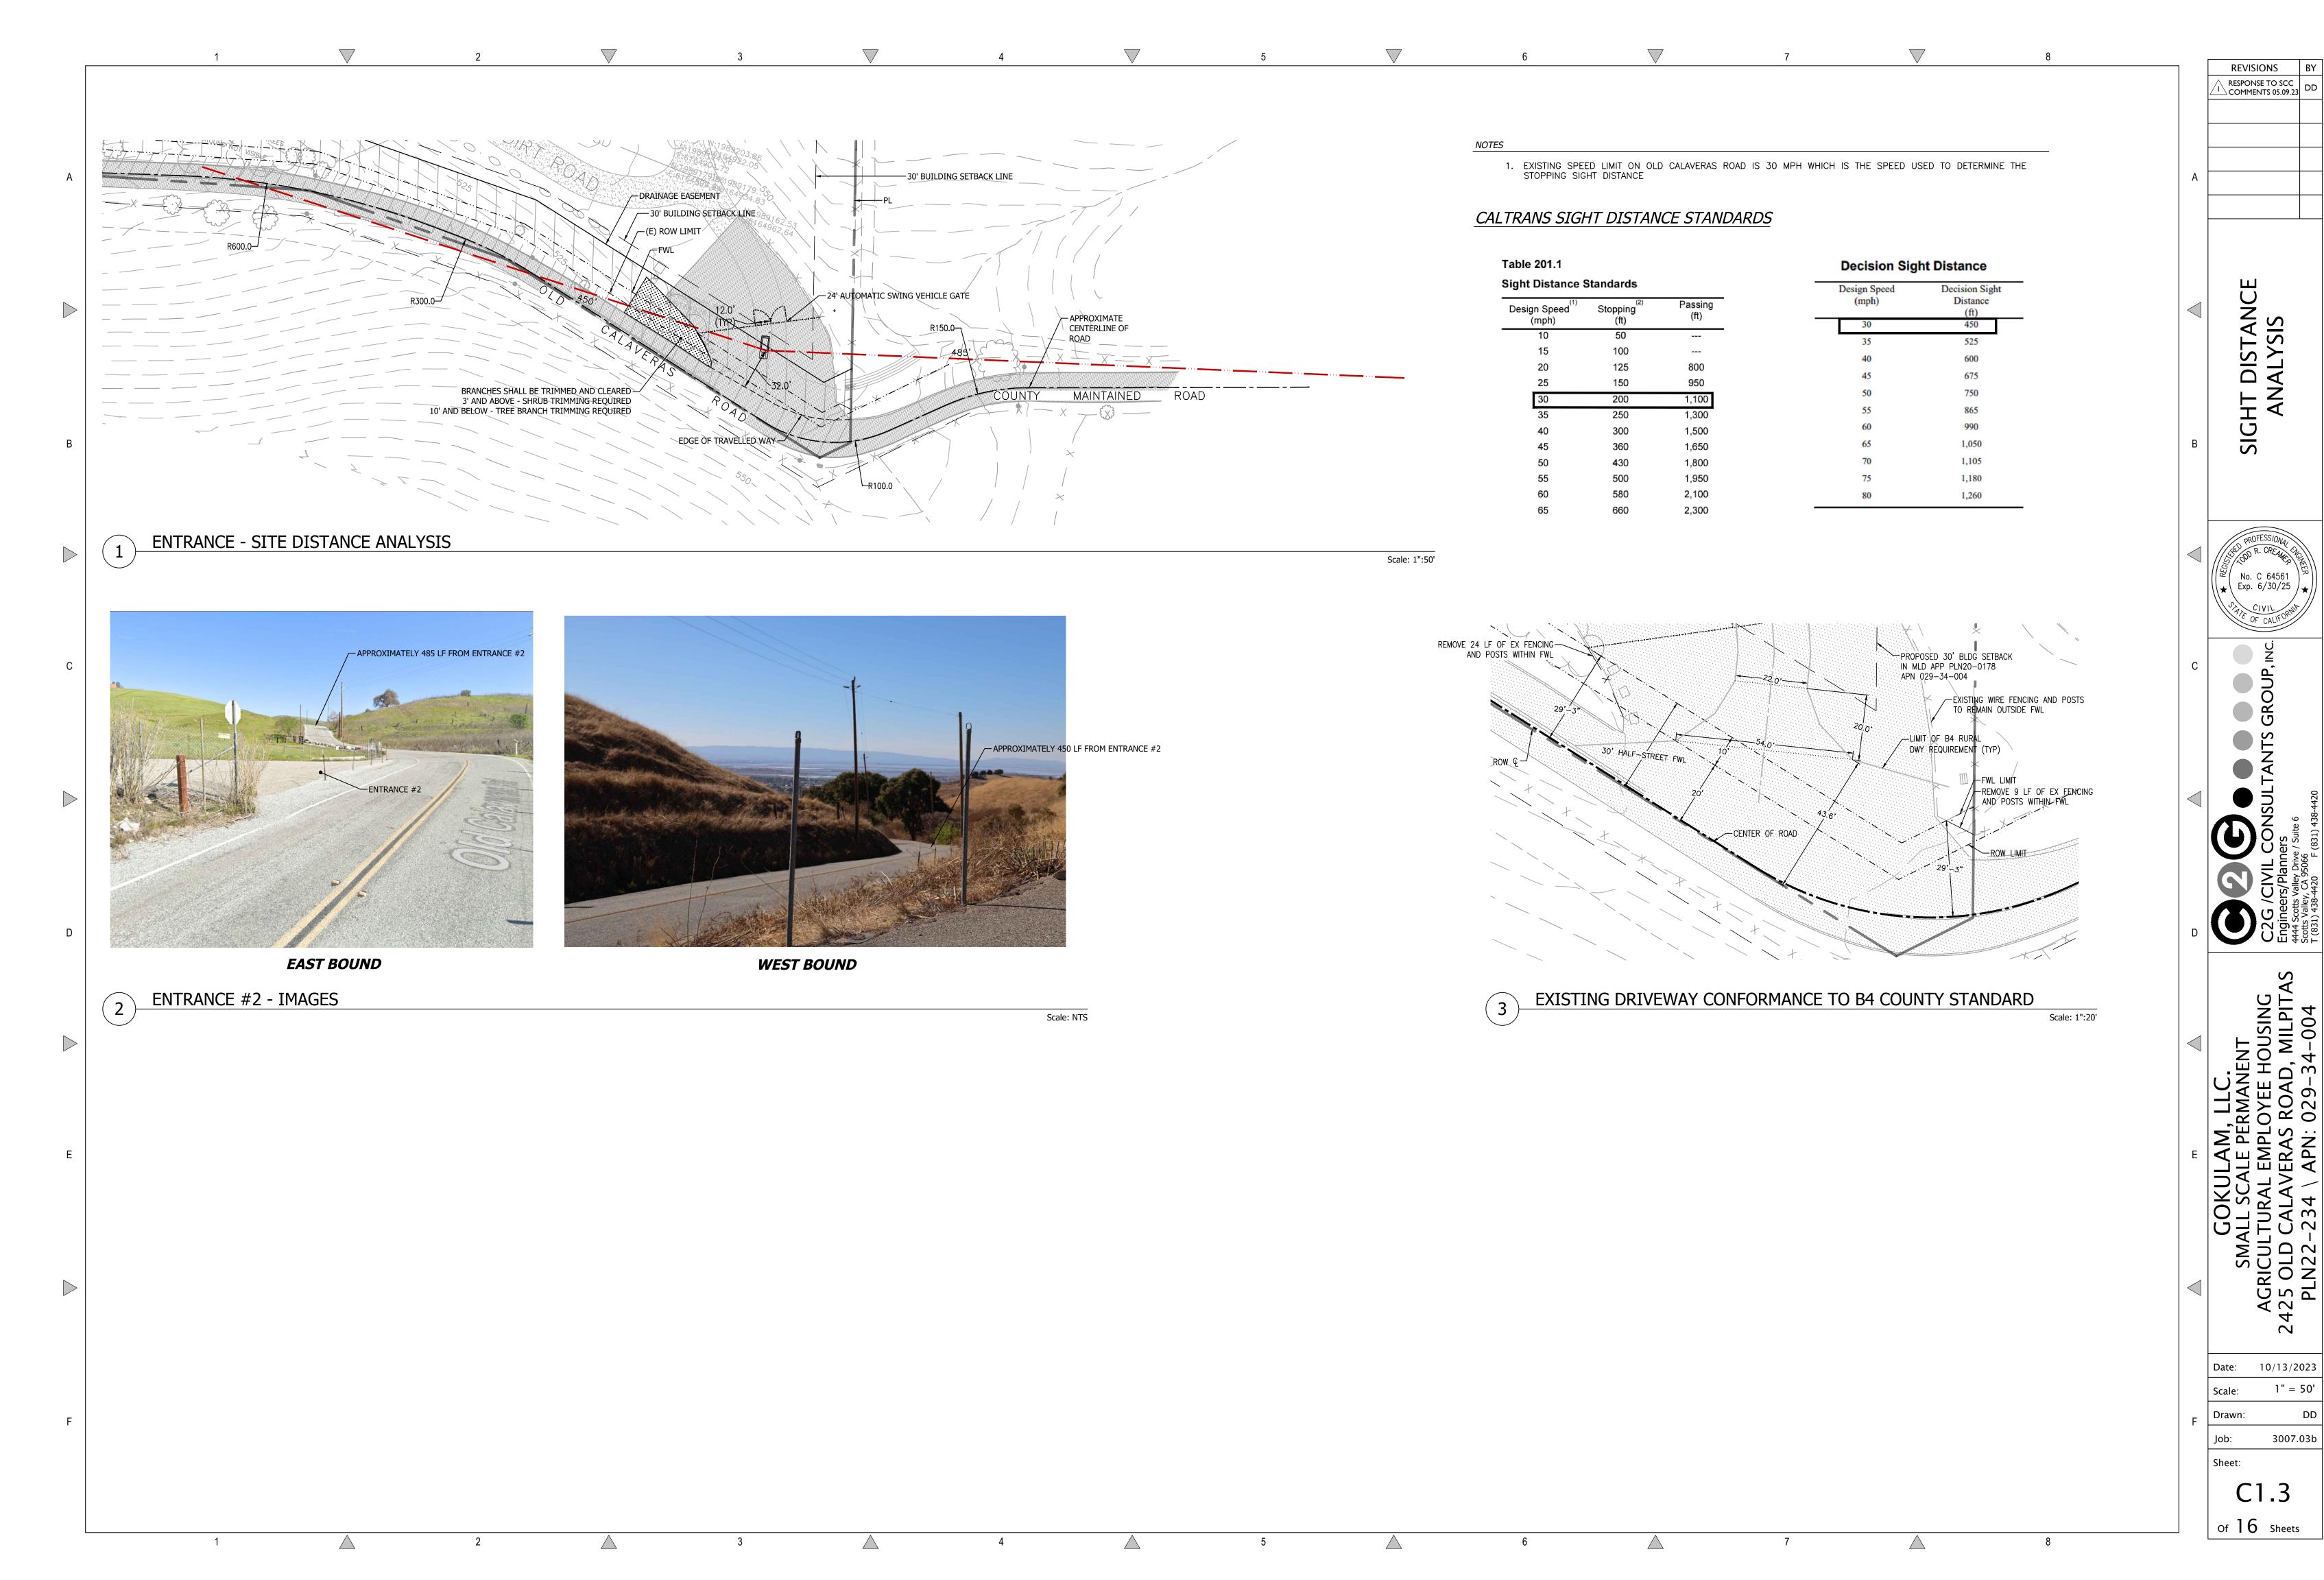

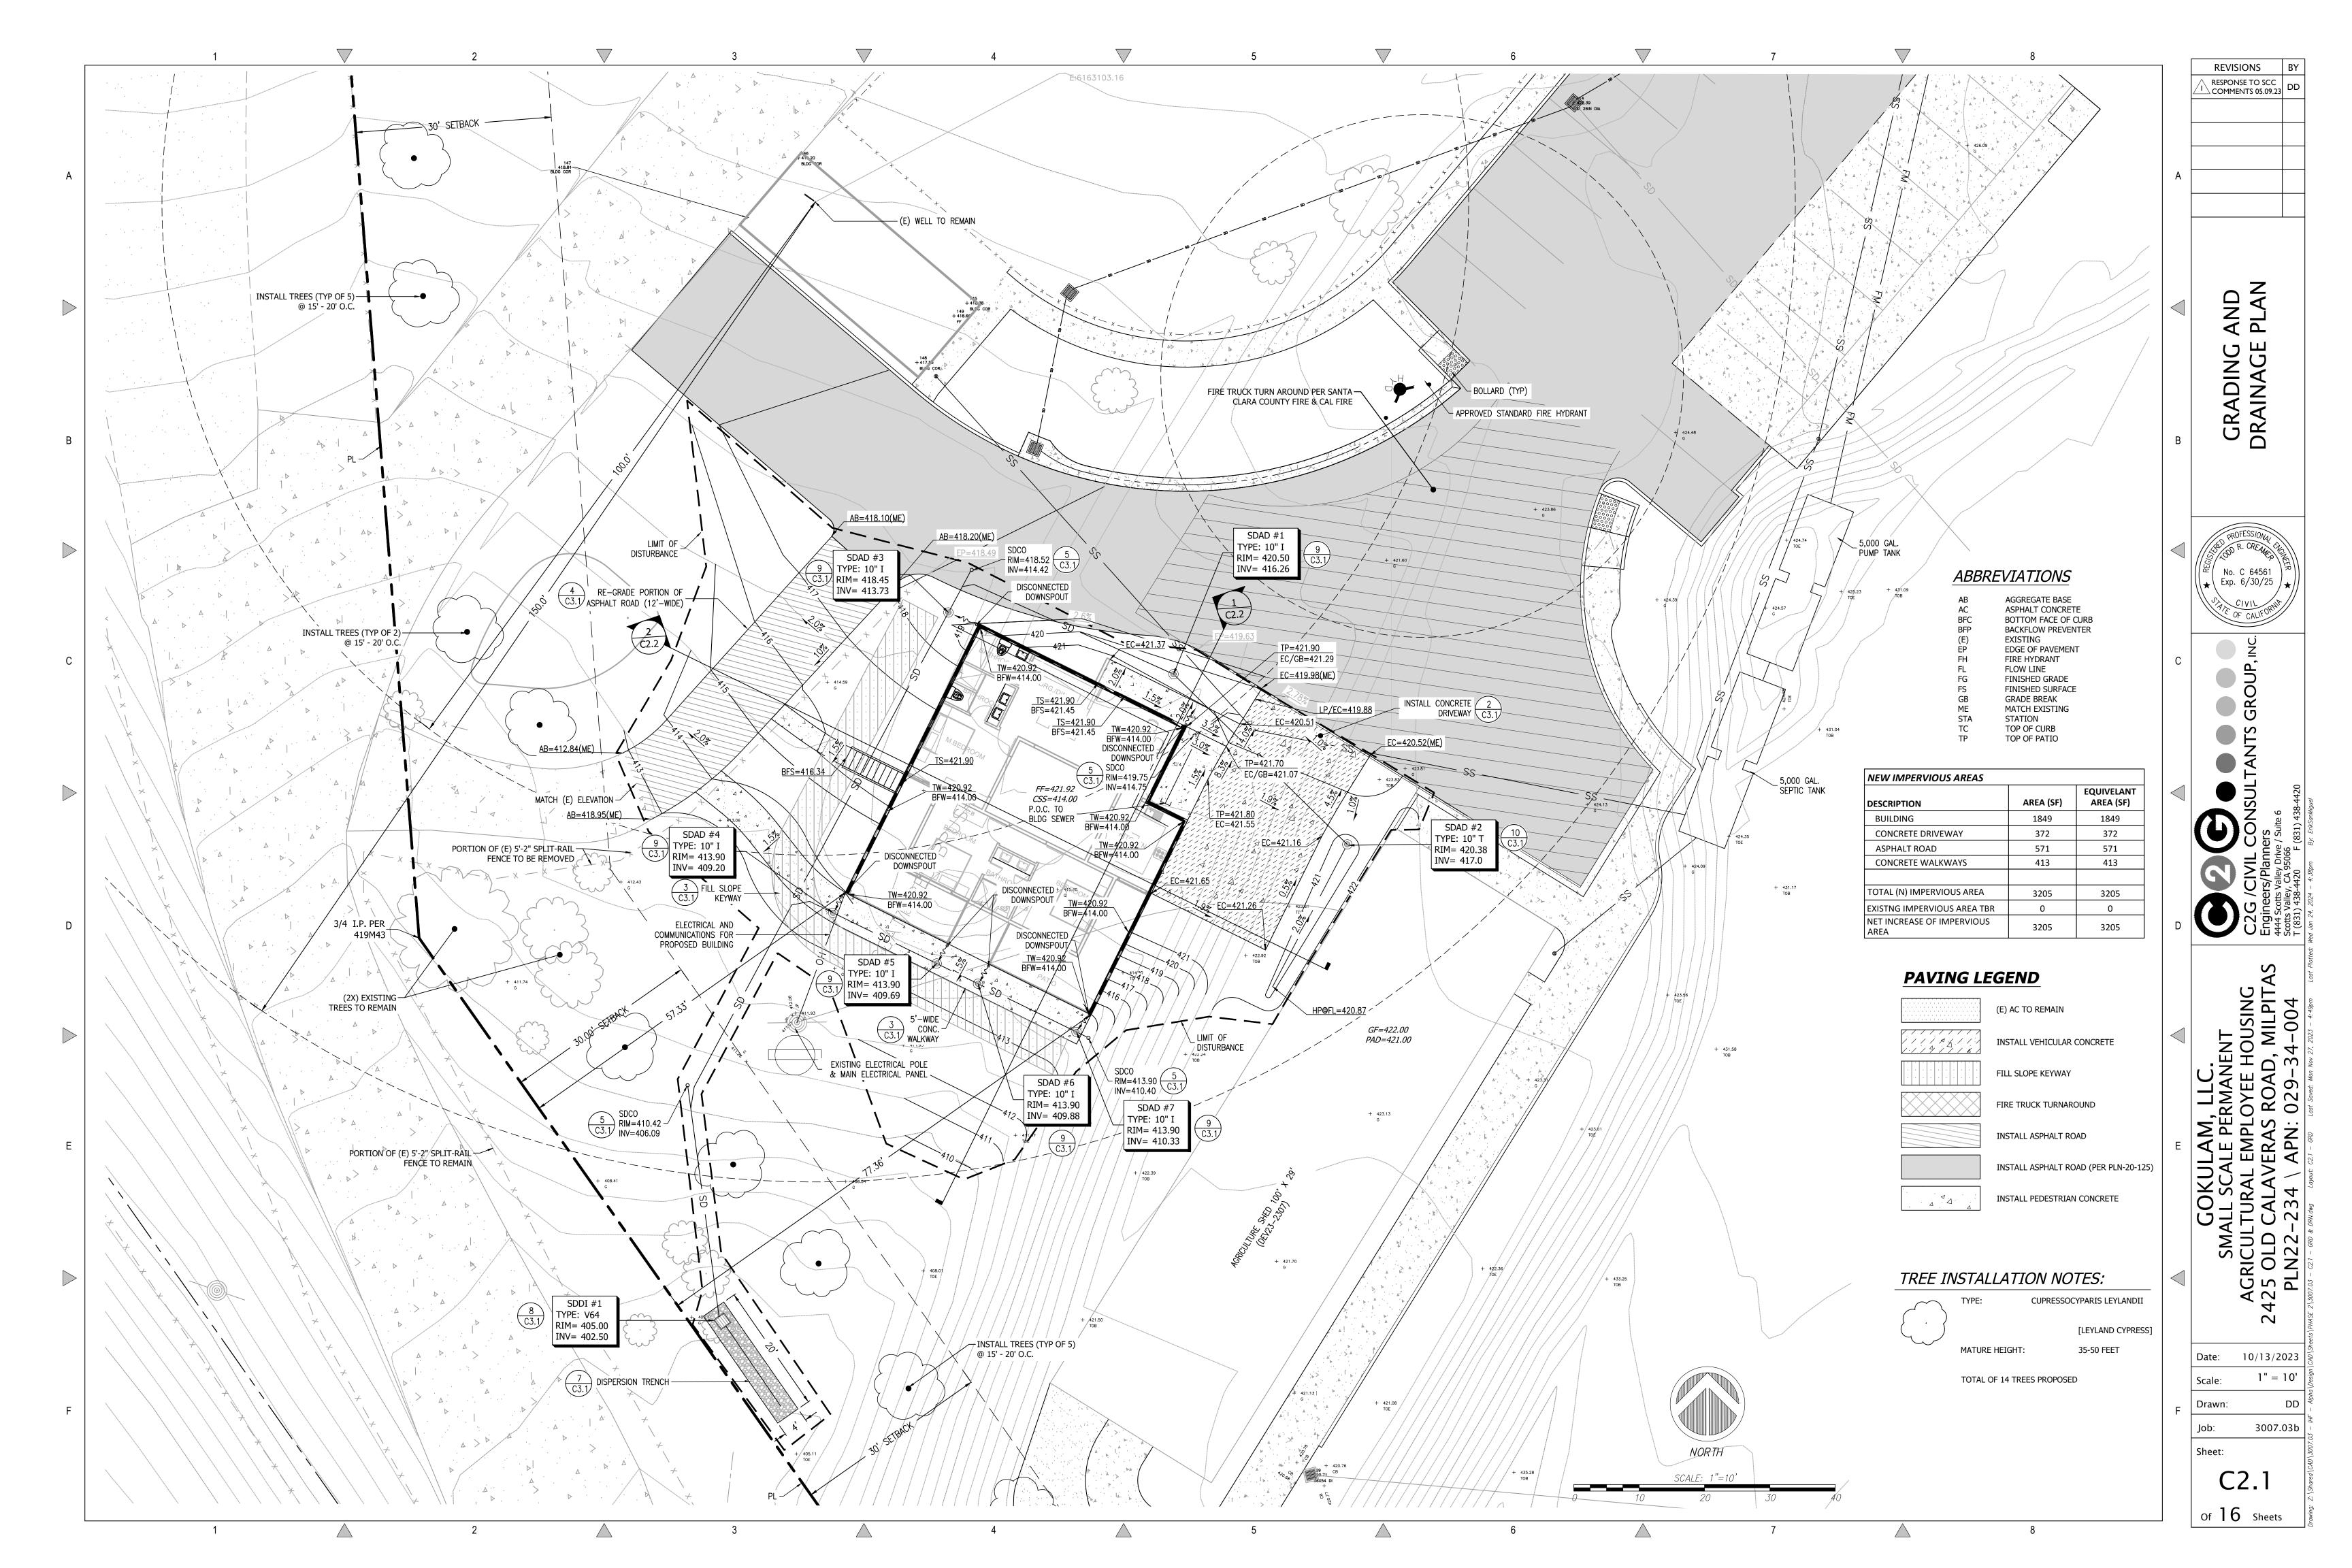

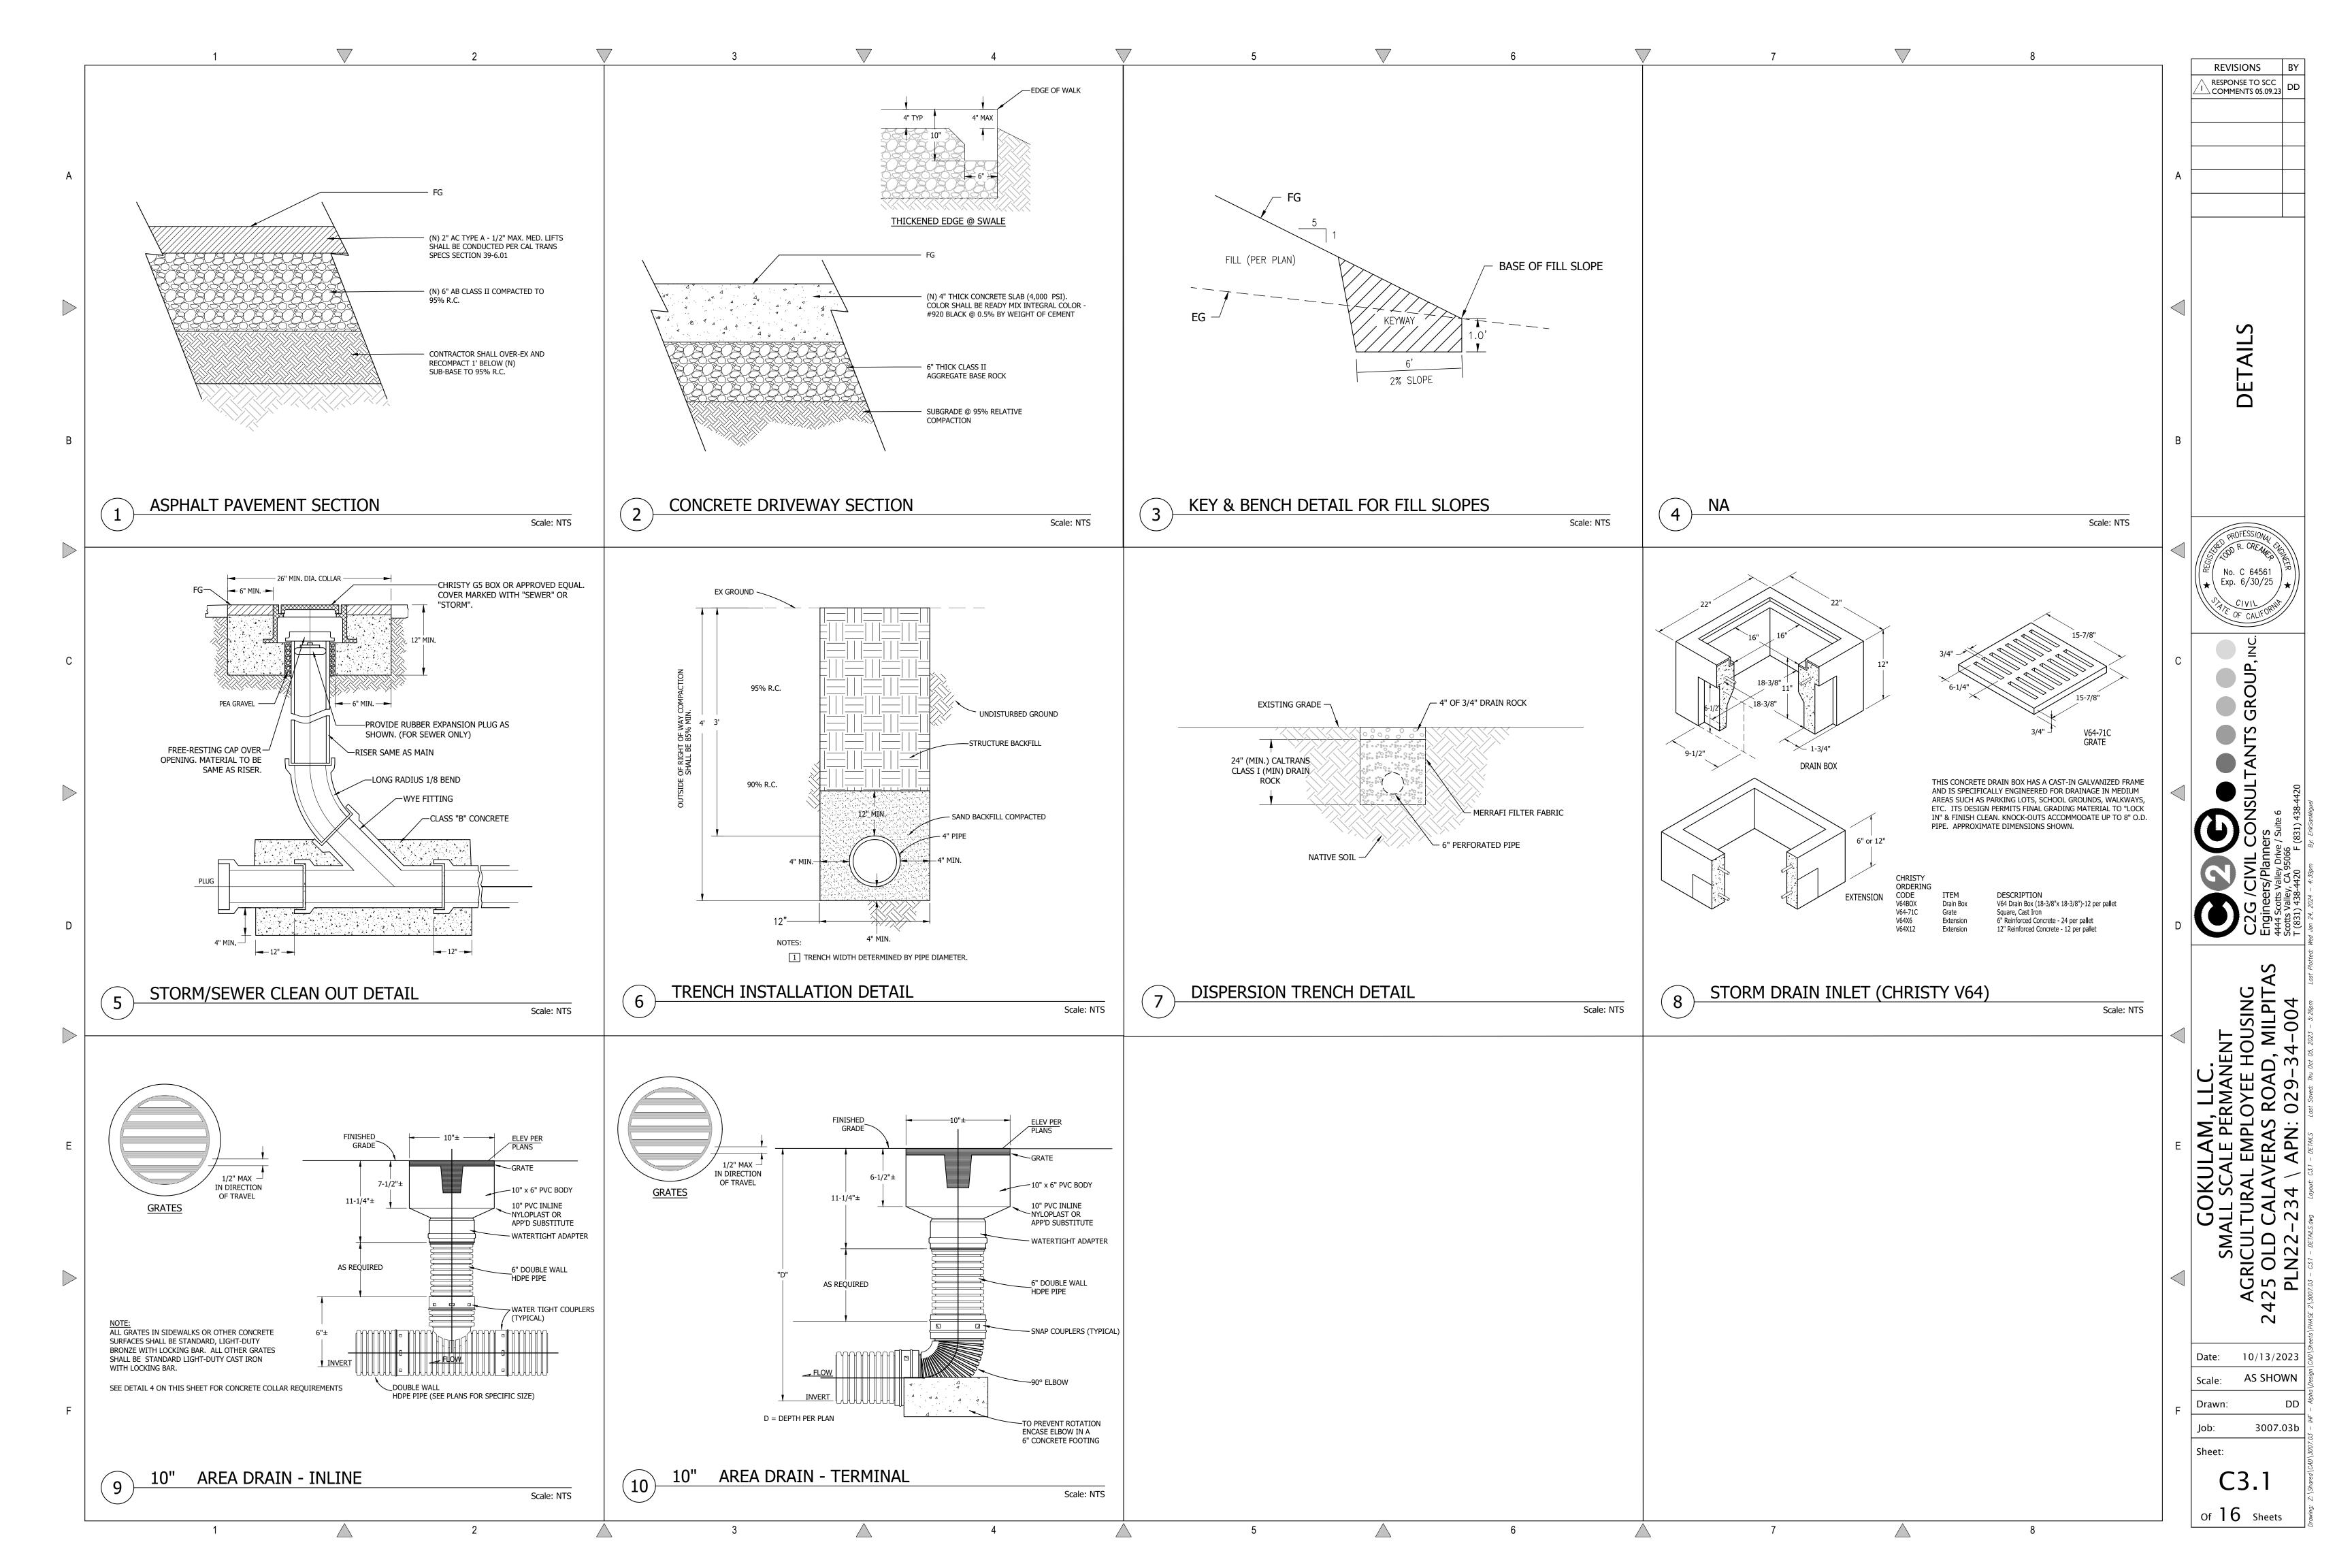

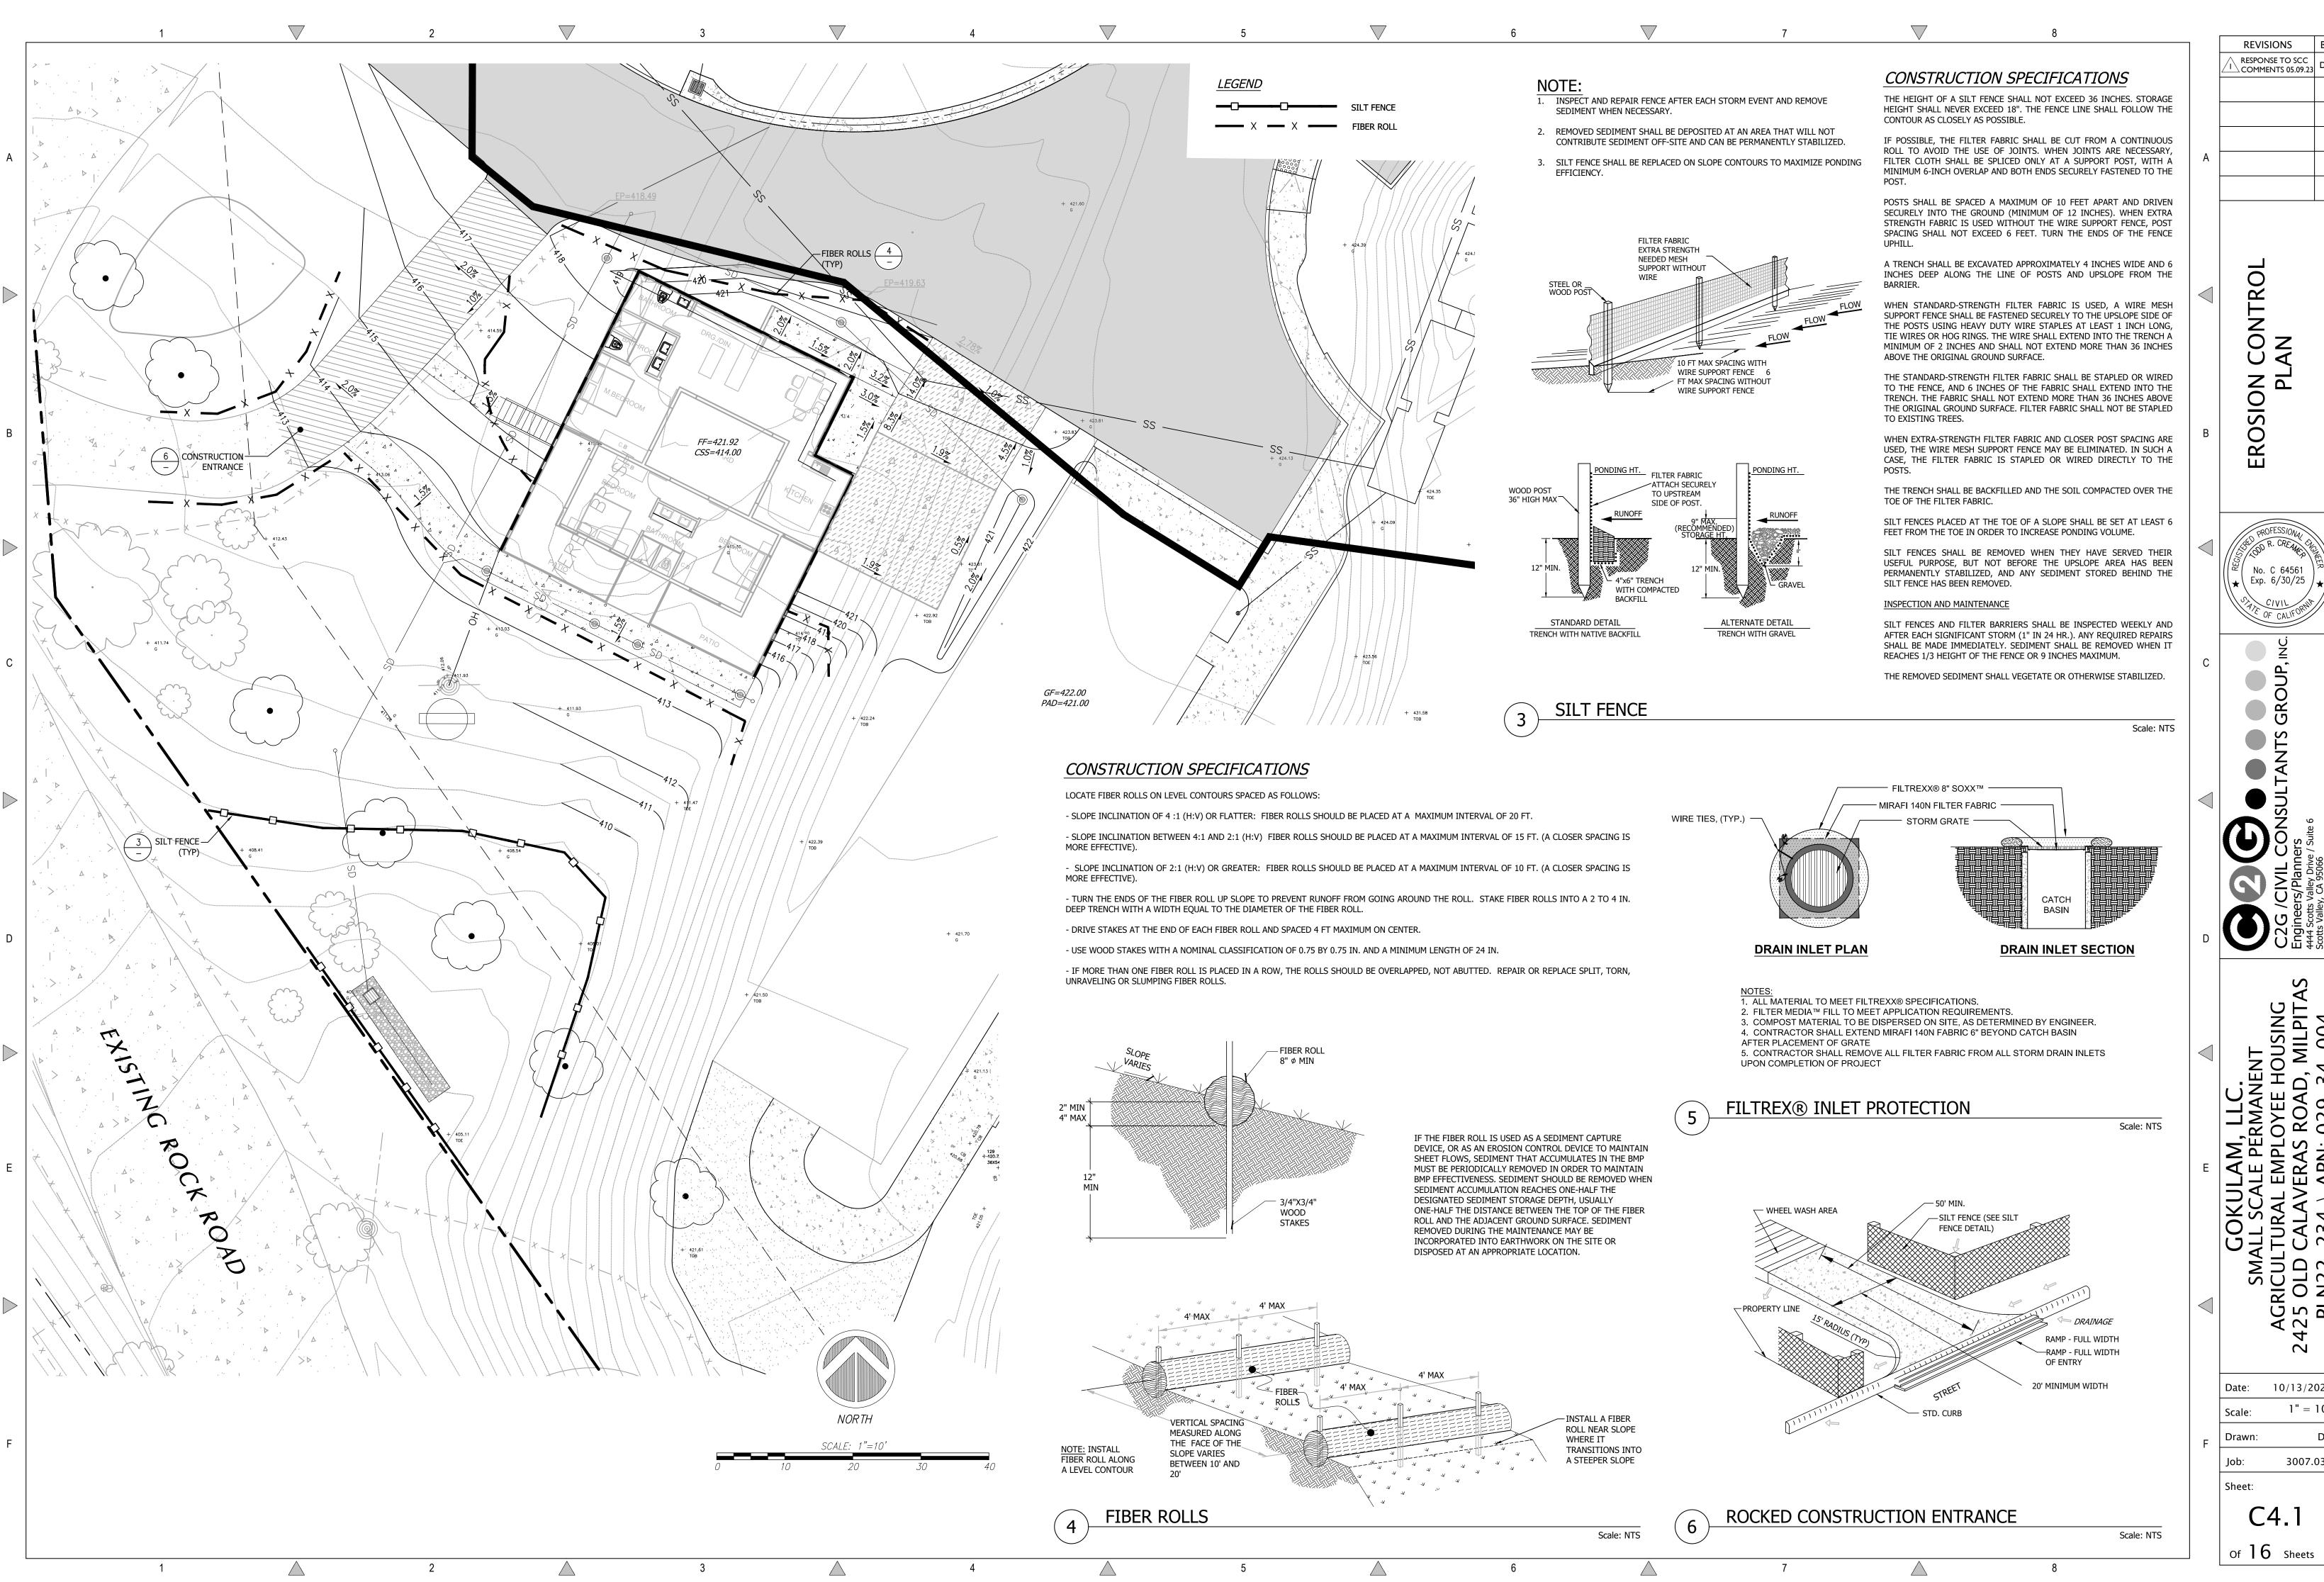


REVISIONS BY RESPONSE TO SCC  $\triangle$  COMMENTS 05.09.23


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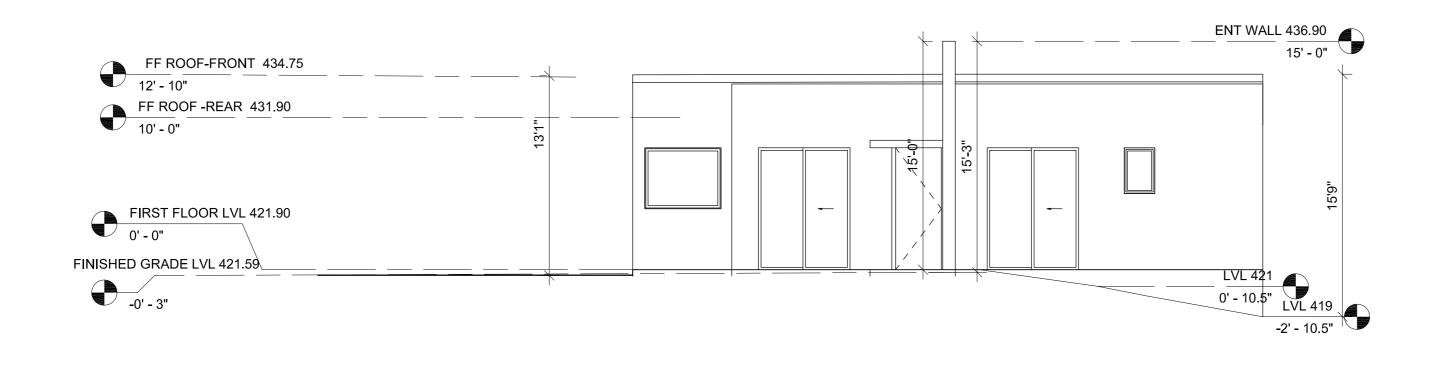
SM/ GRICUL 5 OLD PLN22-10/13/2023 Date: 1" = 10'Scale: Drawn: 3007.03b




GOKULAM	AJAY GOYAL	DRAWN BY:	DATE:	1-22- 2023	LOCATION:	SUBJECT:	DRAWING NO.:	
2425 Old Calaveras Road, MILPITAS, CA 95035	748 BLUE STONE CIRCLE, FOLSOM CA 95630   916-294 - 5337	NEHA	SCALE:	"= 4'0"	APN 029-34-004	GOKULAM Small Scale Permanenet EMPLOYEE HOUSE FLOOR PLAN, AREA CALCULATION	A 01	

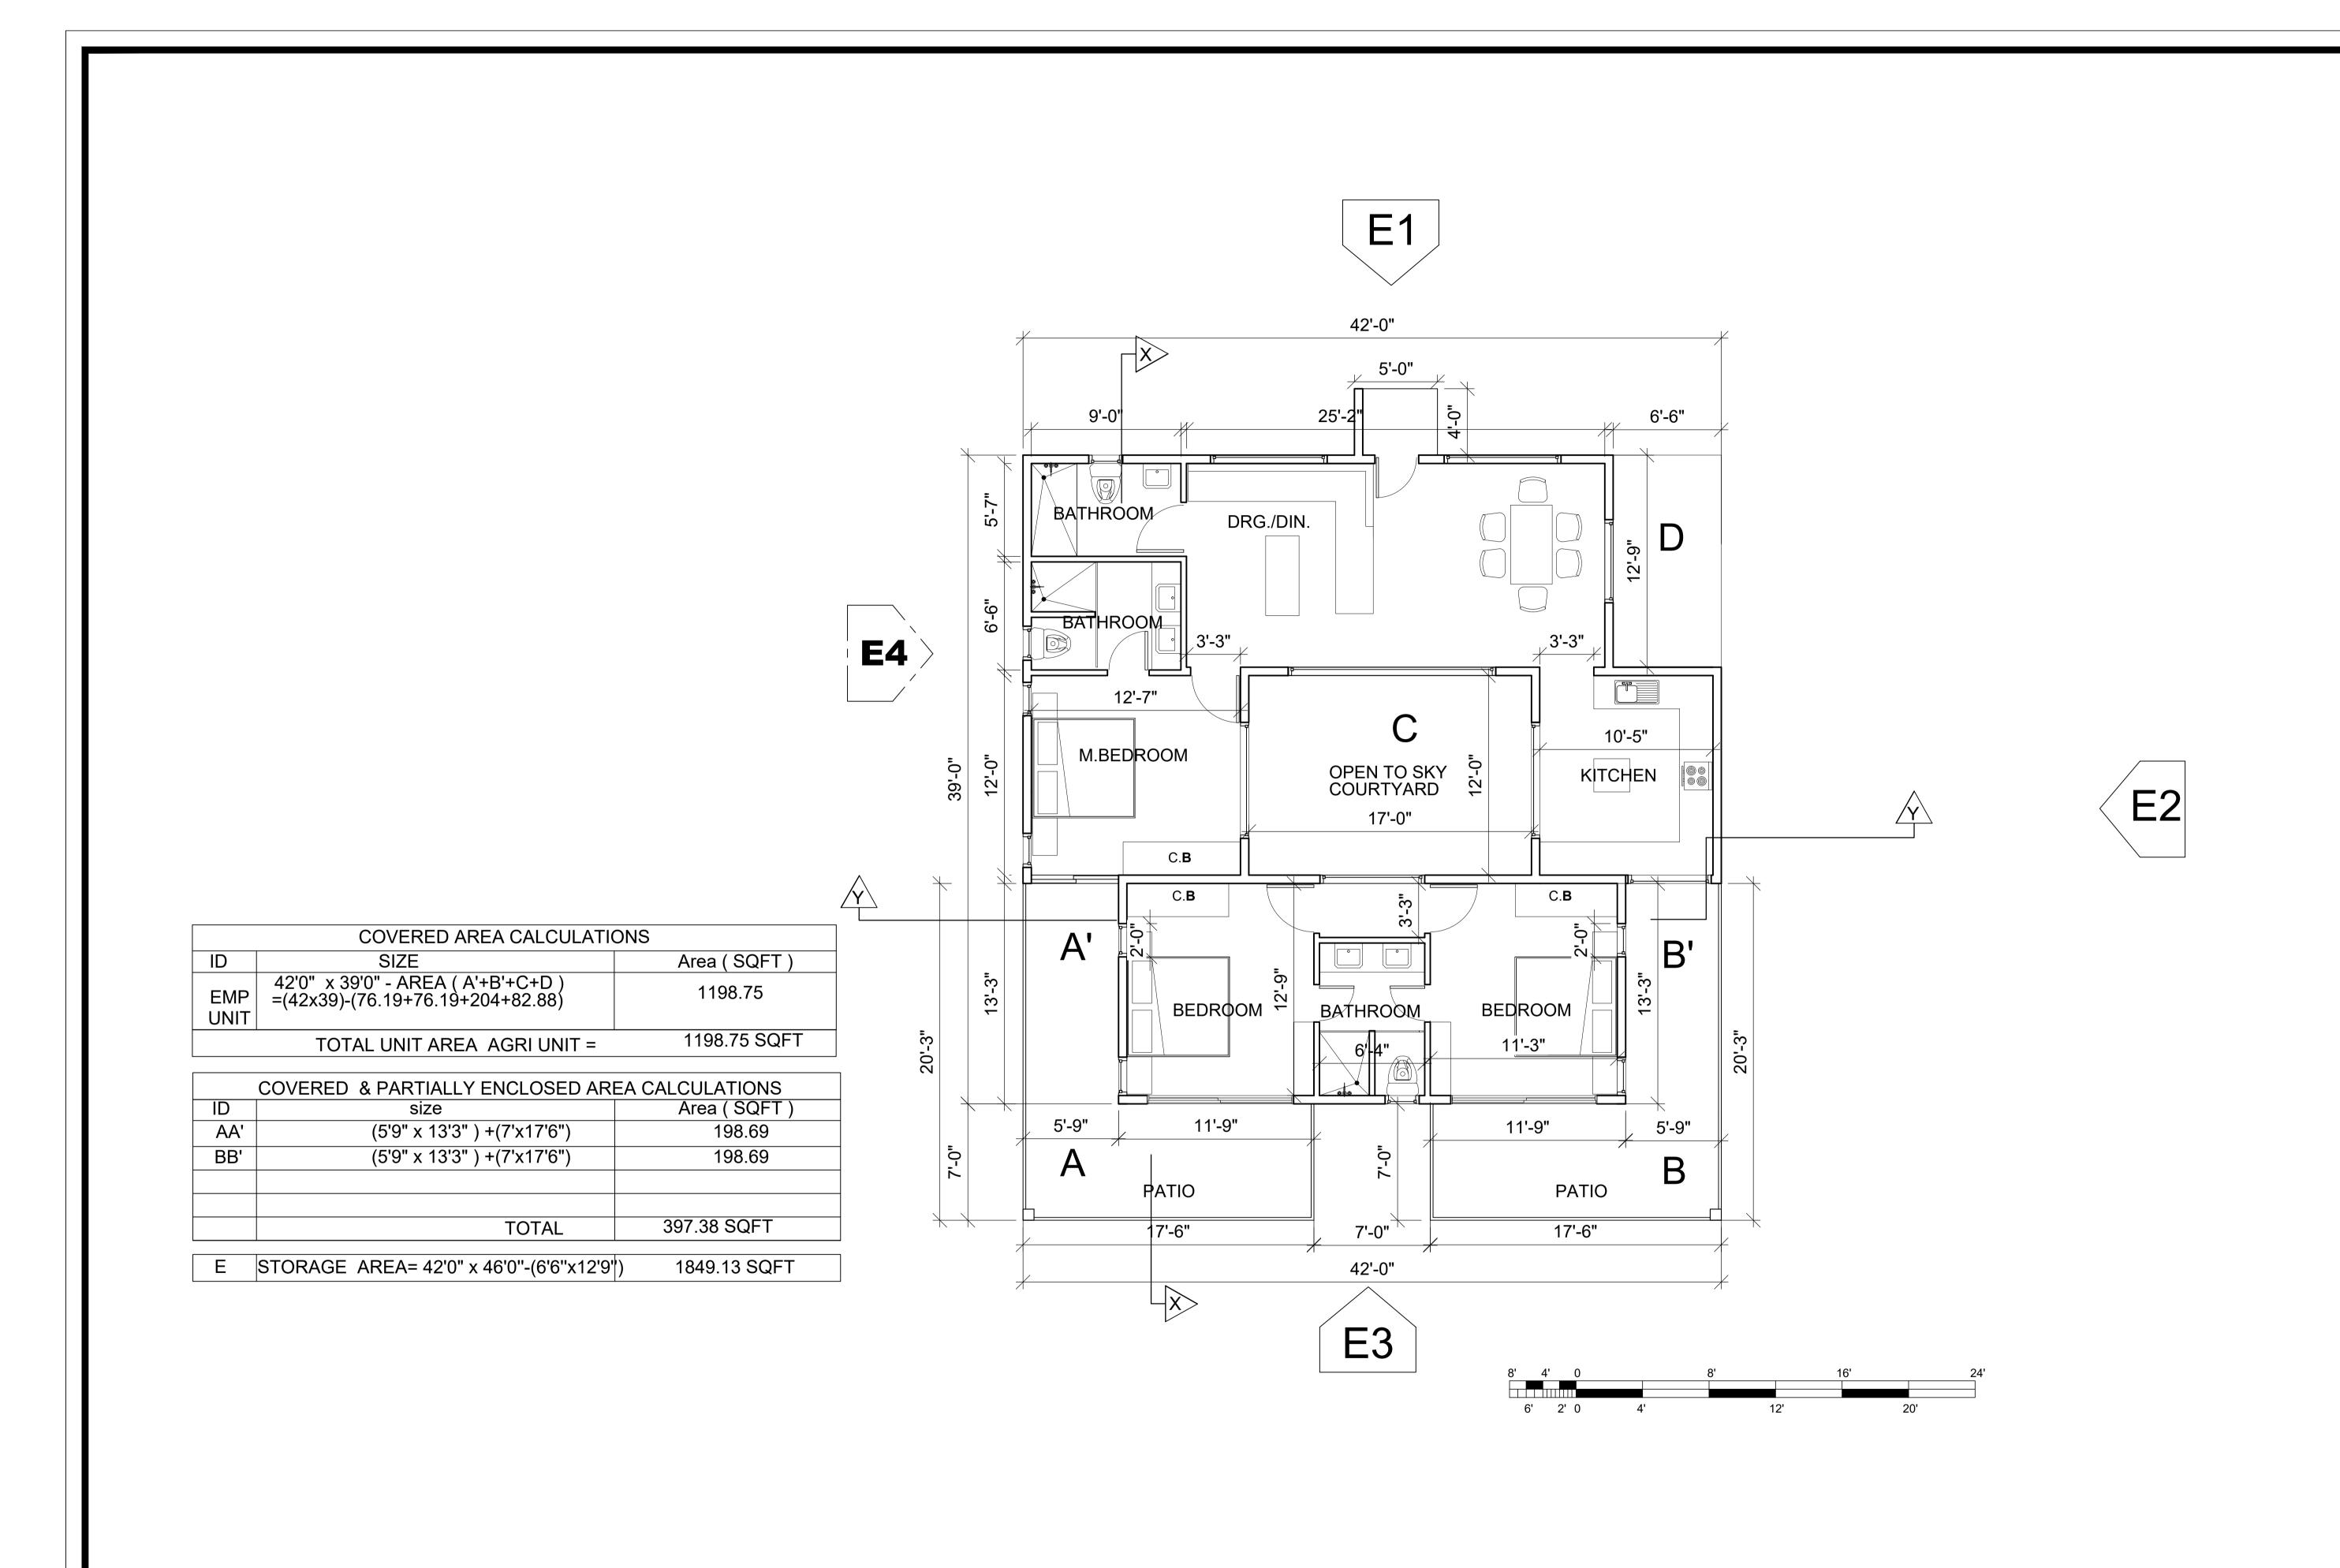

GOKULAM	AJAY GOYAL	DRAWN BY:	DATE: 11-22- 2023	LOCATION:	SUBJECT:	DRAWING NO.:	
2425 Old Calaveras Road, MILPITAS,CA 95035	748 BLUE STONE CIRCLE, FOLSOM CA 95630   916-294 - 5337	NEHA	SCALE:	APN 029-34-004	GOKULAM Small Scale Permanenet EMPLOYEE	Δ 117	
2 120 Old Galavordo Hoda, IIII 11710, 671 00000	7 10 B202 01 0112 011 (022, 1 020011 07 (00000   010 201 0001	146177	1"= 4'0"	AFN 029-04-004	HOUSE STORAGE FLOOR PLAN	A 02	

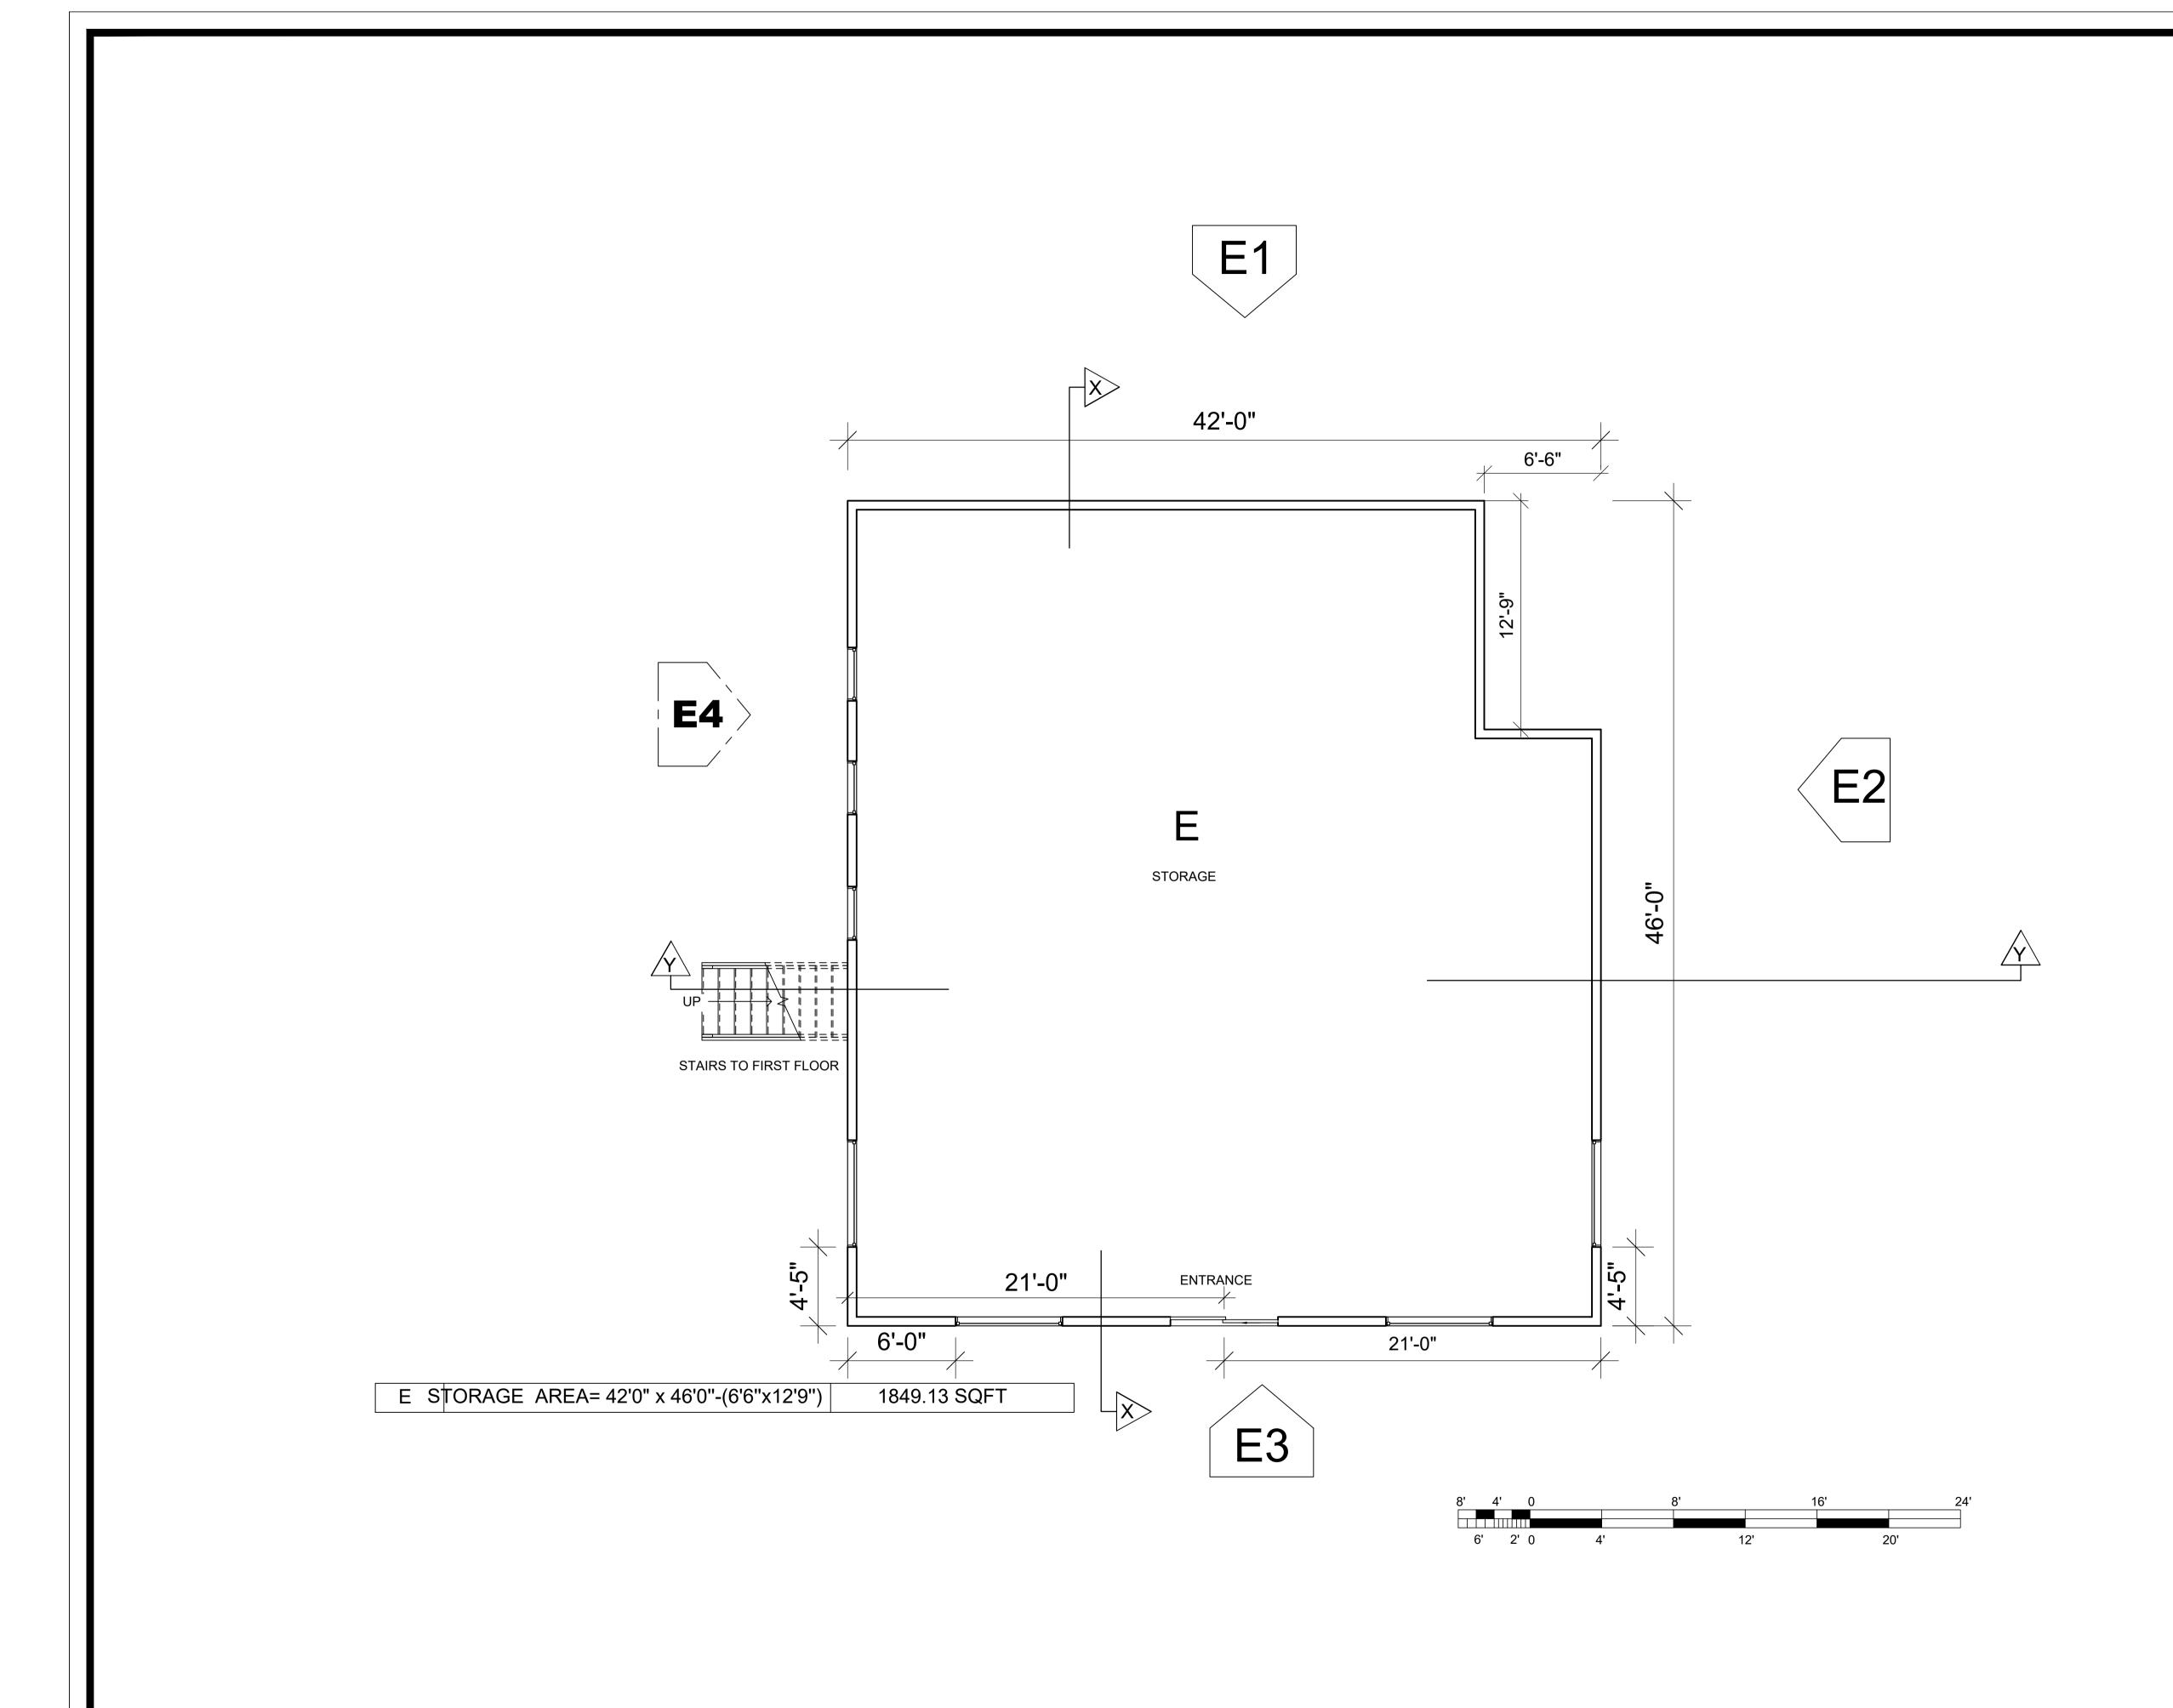

ELEVATION E1

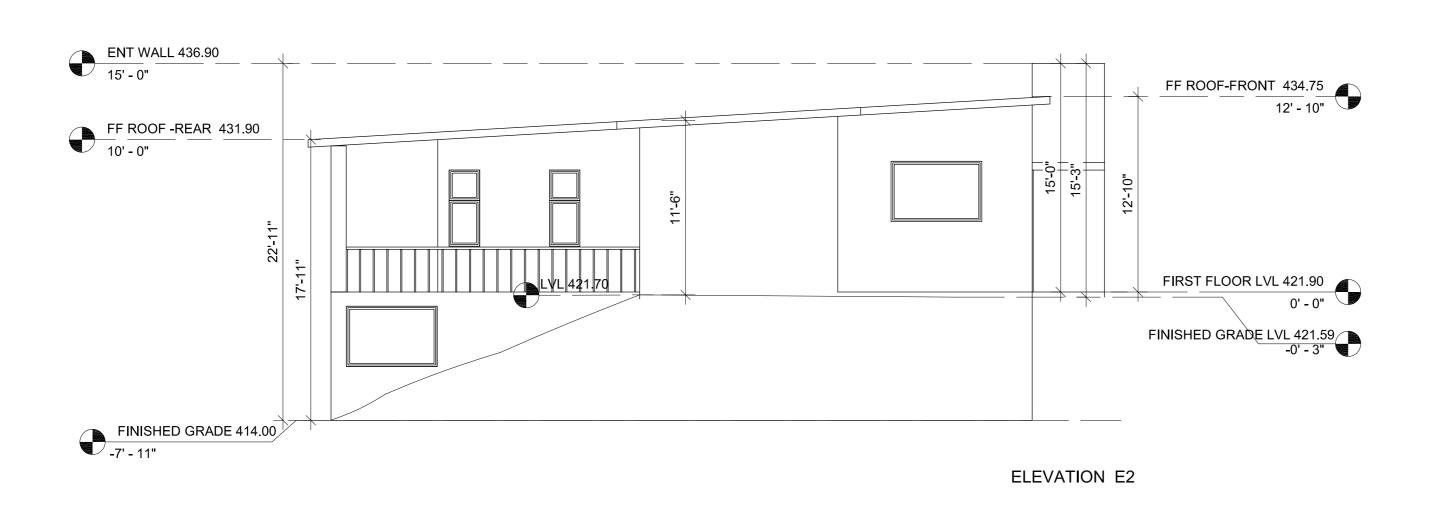

GOKULAM
2425 Old Calaveras Road, MILPITAS,CA 95035

AJAY GOYAL
748 BLUE STONE CIRCLE, FOLSOM CA 95630 | 916-294 - 5337

NEHA

APN 029-34-004

APN 029-34-004


SCALE:
1"= 4'0"

APN 029-34-004


APN 029-34-004

SUBJECT:
GOKULAM Small Scale Permanenet EMPLOYEE HOUSE ELEVATIONS BW 1




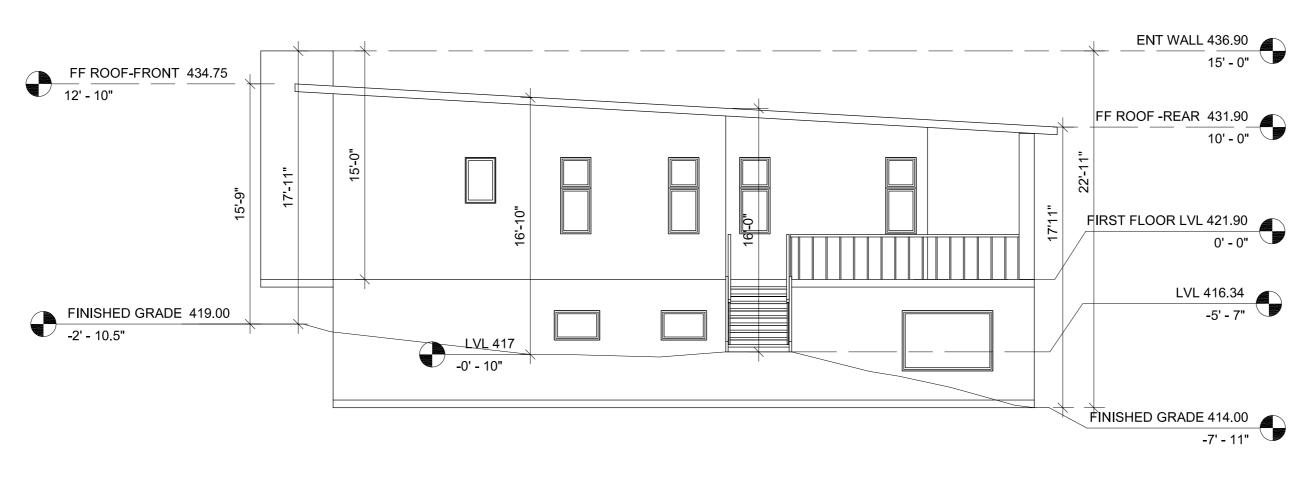


ELEVATION E4

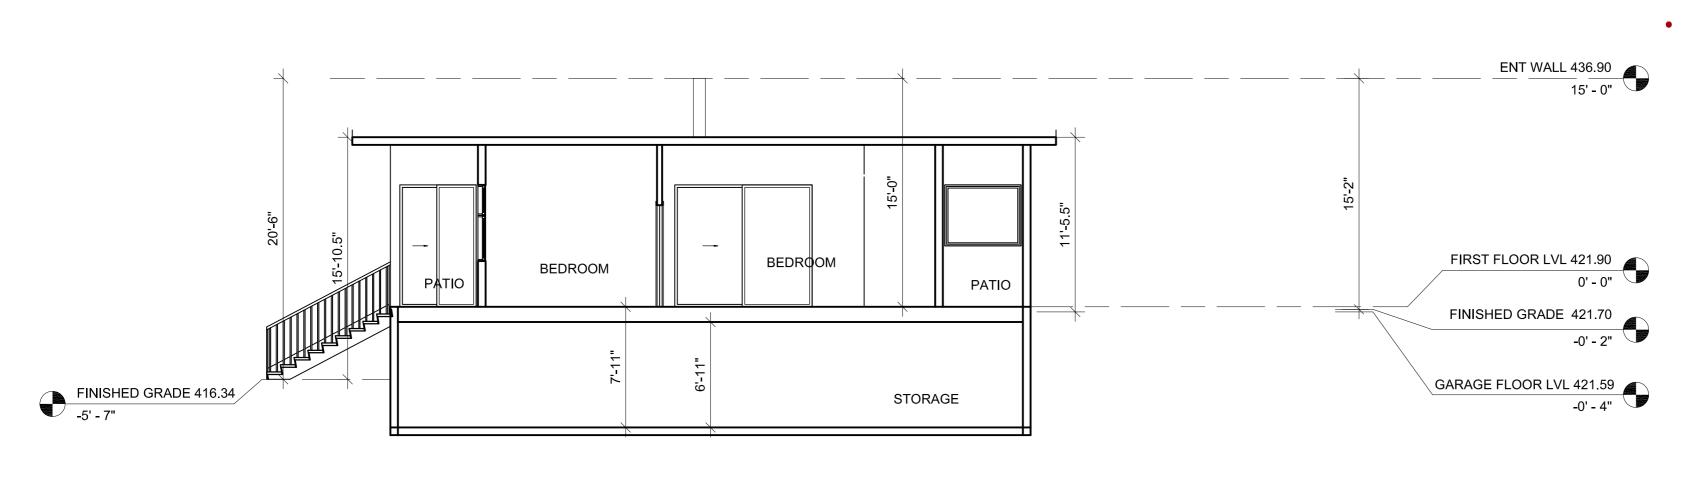




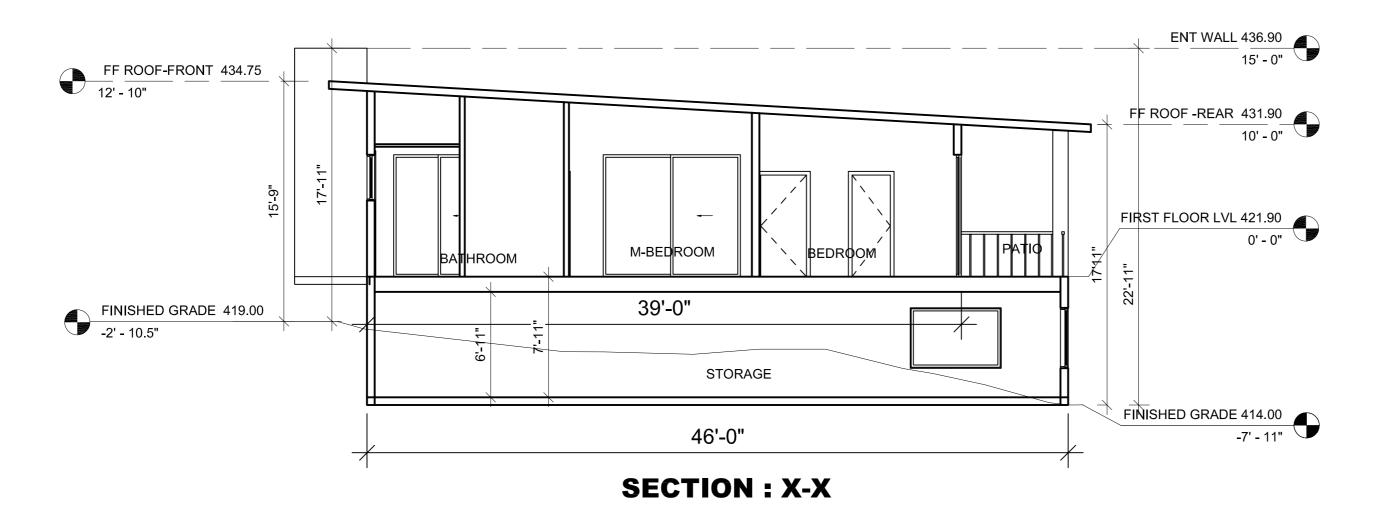

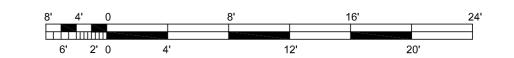

GOKULAM	AJAY GOYAL	DRAWN BY :	DATE:	11 22 2022	LOCATION:	SUBJECT:	DRAWING NO.:	1
2425 Old Calaveras Road, MILPITAS.CA 95035				11-22- 2023	A 50 1 00 0 1 00 1	GOKULAM Small Scale Permanenet EMPLOYEE	4.05	
2425 Old Calaveras Road, MILPITAS, CA 95035	748 BLUE STONE CIRCLE, FOLSOM CA 95630   916-294 - 5337	NEHA	SCALE:	1"=4'0"	APN 029-34-004	HOUSE SECTIONS	A05	1

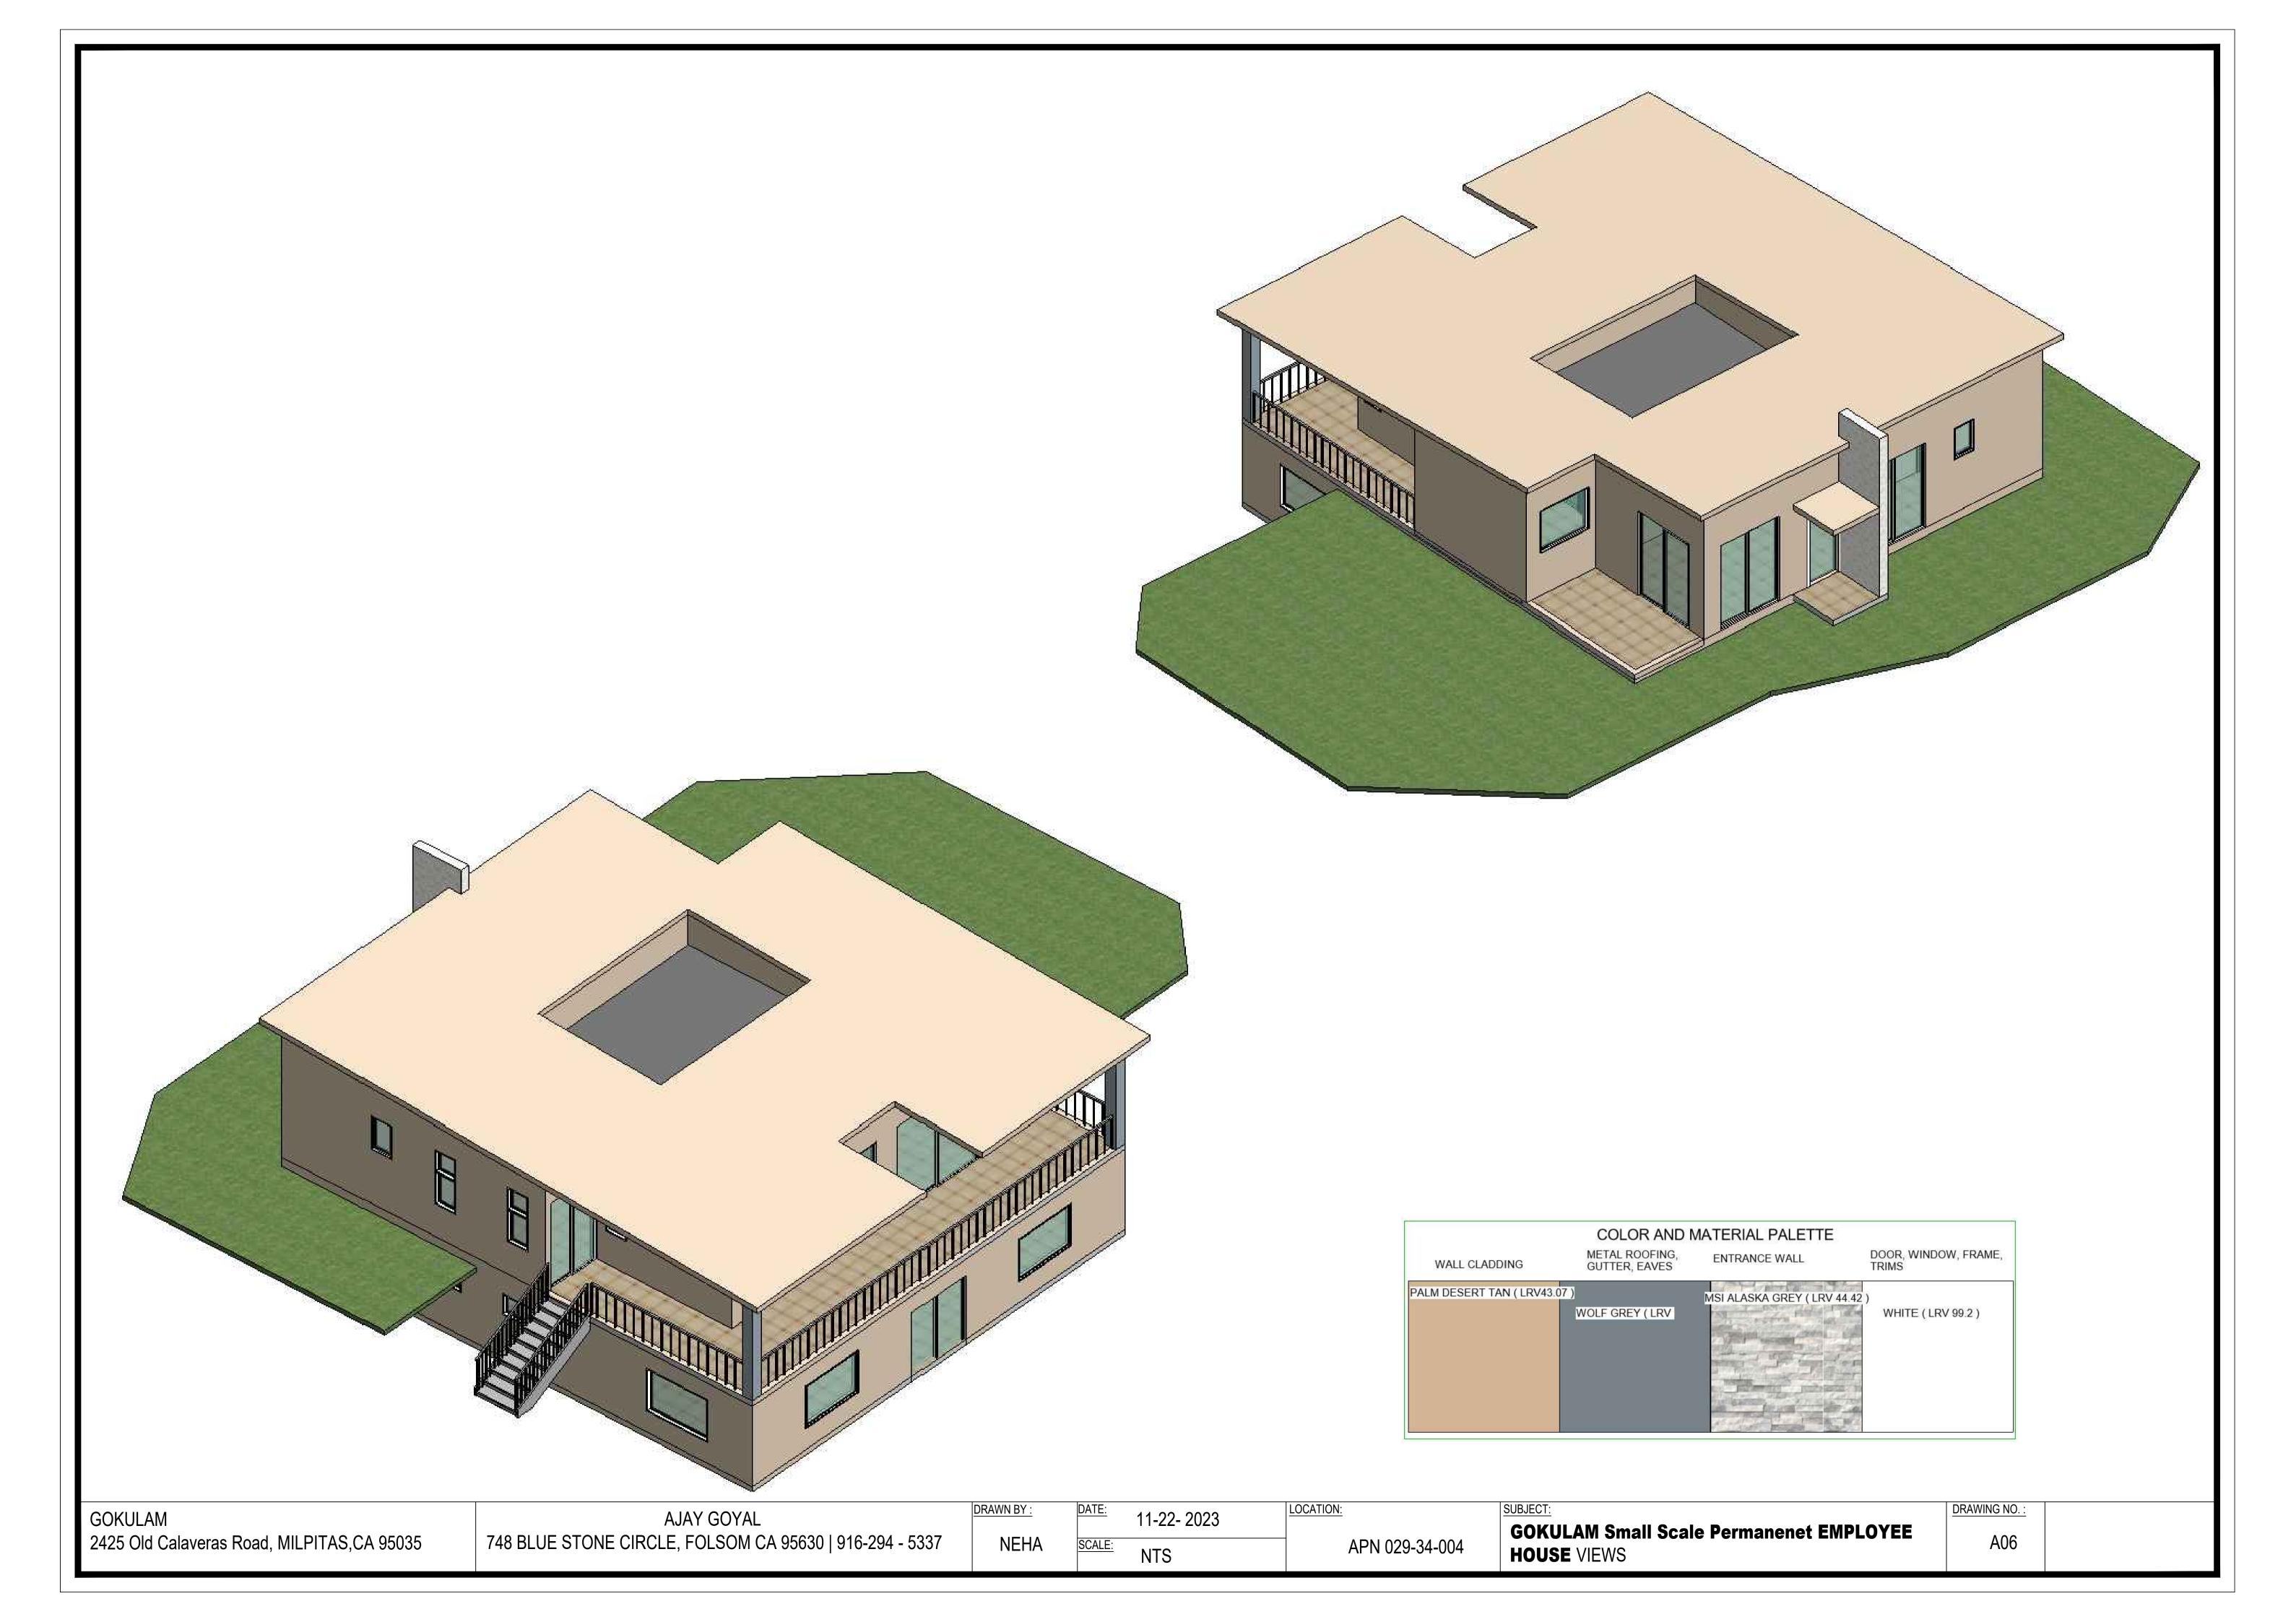

### SEPTIC SYSTEM CONSTRUCTION NOTES

### A. PROJECT REQUIREMENTS

- 1. SYSTEM TO SERVE 13 EMPLOYEES/CUSTOMERS/VOLUNTEERS, A FUTURE 6 BEDROOM HOUSE, A FUTURE 3 BEDROOM ACCESSORY DWELLING UNIT (ADU), A FUTURE 2 BEDROOM JUNIOR ADU, AND A 3 BEDROOM SMALL SCALE PERMANENT AGRICULTURAL HOUSING. INSTALLATION OF SYSTEM TO CONFORM TO SANTA CLARA COUNTY SEWAGE DISPOSAL ORDINANCE. CALL SANTA CLARA COUNTY DEPARTMENT OF ENVIRONMENTAL HEALTH 24 HOURS MIN. PRIOR TO START OF WORK AT (408)—918—3400.
- 2. SEWAGE DISPOSAL SYSTEM CONSISTS OF A 5,000 GALLON SEPTIC TANK WITH 5,000 GALLON PUMP TANK, WATERTIGHT ACCESS RISERS TO GRADE; A BULL-RUN DIVERSION VALVE; AND TWO 486 LF X 486 LF DISPERSAL FIELD OF 24" WIDE BY 12" DEEP DRAINROCK BED WITH INSPECTION RISERS TO GRADE. THE DISPERSAL FIELDS SHALL BE INTERCONNECTED WITH A DIVERSION VALVE. THE VALVE MUST BE CAPABLE OF DIRECTING THE SEPTIC TANK EFFLUENT TO ONE DISPERSAL FIELD AT A TIME.
- 3. GROUND SLOPE OF DISPERSAL FIELD #1 & DISPERSAL FIELD #2 IS APPROXIMATELY 24.5%. DISPERSAL FIELDS SHALL BE INSTALLED LEVEL AND ON CONTOURS AS SHOWN ON PLAN. EXCESS SOIL FROM LEACHFIELD CONSTRUCTION SHALL BE SPREAD ON SITE AT A DEPTH OF 3' MAX OR BE REMOVED OFF—SITE
- 4. THE DIVERSION VALVE SHALL BE OPERATED ANNUALLY TO ROTATE THE USE OF DISPERSAL FIELDS TO EXTEND THE LIFE OF THE SEPTIC SYSTEM.
- 5. MARK CAPS OF ALL BULL RUN VALVES (DV) AND RISERS (R) WITH A PERMANENT MARKER OR LABEL.
- 6. SWIMMING POOLS OR SPAS MUST NOT BE DRAINED OR BACKWASHED INTO THE SEPTIC SYSTEM.
- 7. AVOID PLANTING TREES IN DISPERSAL FIELD OR CLOSE TO SEPTIC TANK.
- 8. GARBAGE DISPOSAL IS NOT RECOMMENDED. IF THEY ARE INSTALLED, THEY SHOULD BE USED SPARINGLY OR NOT AT ALL.
- 9. THE SOLIDS THAT ACCUMULATE IN THE SEPTIC TANK SHOULD BE REMOVED BY PUMPING EVERY 3—5 YEARS TO PREVENT SOLIDS FROM ENTERING AND CLOGGING THE DISPERSAL FIELD.
- 10. ALL WORK TO BE PERFORMED BY AN APPROPRIATELY LICENSED CONTRACTOR.
- 11. PRIOR TO STARTING CONSTRUCTION, CONTRACTOR SHALL CONTACT USA AT 1-800-227-2600 TO LOCATE ALL UNDERGROUND UTILITIES.

ACROSS ALL THE ACTIVITIES CURRENTLY PLANNED ON THE LAND —REARING LIVESTOCK, PRODUCTION AND SALE OF COMPOST, BALES OF ORCHARD GRASS AND CSA BOXES AND RESIDENCES, THE TOTAL NUMBER OF PEOPLE INCLUDING RESIDENTS, EMPLOYEES AND VISITORS WILL NOT EXCEED MORE THAN 25 PEOPLE IN A 60 DAY PERIOD ANNUALLY. PLEASE SEE THE TABLE BELOW FOR A SUMMARY.

OUR APPLICATION AND OWTS DESIGN INCLUDES A 3 BEDROOM SMALL SCALE PERMANENT AGRICULTURAL HOUSING WHOSE RESIDENTS ARE ALSO SHOWN IN THE TABLE BELOW AS RESIDENT EMPLOYEES. THE LIVESTOCK SHELTER AND AGRICULTURAL SHED BOTH INCLUDE A UNISEX BATHROOM THAT WILL CATER TO THE DEMAND MENTIONED BELOW. FOR OUR CSA PROGRAM, ABOUT 2/3RD'S OF THE 90 FAMILIES ARE OUR REGULAR CONGREGATION WHO WILL PICK IT UP FROM OUR TEMPLE WHICH IS ABOUT 1.5 MILES AWAY LOCATED AT 680 E. CALAVERAS BLVD, MILPITAS, CA. CUSTOMER/VOLUNTEER VISITS TO 2425 OLD CALAVERAS RD SITE FOR ALL OUR OPERATIONS WILL BE BY APPOINTMENT ONLY AND WE WILL BE USING THIS APPOINTMENT SYSTEM TO ENSURE THAT THE DAILY LIMITS PROPOSED BELOW ARE

OUR OWTS DESIGN ANTICIPATES A FUTURE PRIMARY RESIDENCE WITH 6 BEDROOMS, A FUTURE ADU WITH 3 BEDROOMS, A JADU WITH TWO BEDROOMS, THUS WE HAVE TWO TABLES FOR PROPOSED CURRENT USE AND ONE FOR FUTURE USE WHERE WE HAVE ADDED A COLUMN TO SHOW FUTURE RESIDENTS FOR THESE UNITS.

### PROPOSED PHASE 2 OCCUPANCY:

Day	Time	Resident Employees of Agricultural Housing	Other Employees	Volunteers /Customers	Total People
Monday to	5am to 1pm	3	2	8	13
Friday	4pm to 9pm	3	2	8	13
Caturday	5am to 1pm	3	2	8	13
Saturday	2pm to 9pm	3	2	8	13
Complete.	5am to 1pm	3	2	8	13
Sunday	2pm to 9pm	3	2	8	13

### FUTURE USE/OCCUPANCY:

Day	Time	Future Residents Primary/ ADU/JADU	Resident Employees Agricultural Housing	Other Employees	Volunteers /Customers	Total People	
Monday to	5am to 1pm	11	3	2	8	24	
Friday	4pm to 9pm	11	3	2	8	24	
6	5am to 1pm	11	3	2	8	24	
Saturday	2pm to 9pm	11	3	2	8	24	
	5am to 1pm	11	3	2	8	24	
Sunday		4.4					

### B. SEPTIC TANK REQUIREMENTS

MEASURABLE DROP IN THE WATER LEVEL.

- MINIMUM CAPACITY. SEPTIC TANKS MUST HAVE A MINIMUM CAPACITY OF FIVE THOUSAND (5,000) GALLONS OR TWICE THE PEAK DAILY WASTEWATER FLOW FOR THE FACILITY SERVED, WHICHEVER IS GREATER. MINIMUM SEPTIC TANK CAPACITY FOR ASSISTED CARE FACILITIES SHALL BE EQUAL TO THREE TIMES THE PEAK DAILY WASTEWATER FLOW.
- 2. TWO COMPARTMENTS. SEPTIC TANKS MUST BE OF TWO—COMPARTMENT CONSTRUCTION, WITH THE FIRST COMPARTMENT EQUAL TO TWO—THIRDS THE TOTAL TANK VOLUME. THE COMPARTMENTS MUST BE SEPARATED BY A BAFFLE OR EQUIVALENT ARRANGEMENT.
- 3. MATERIALS. SEPTIC TANKS MUST BE WATERTIGHT, PROPERLY VENTED AND CONSTRUCTED OF REINFORCED CONCRETE, HEAVYWEIGHT REINFORCED CONCRETE BLOCKS, FIBERGLASS OR OTHER DURABLE, NON—CORRODIBLE MATERIALS AS APPROVED BY THE DIRECTOR. SEPTIC TANKS SHALL BE DESIGNED TO WITHSTAND ANY ANTICIPATED WEIGHT PLACED ABOVE IT. ALL SEPTIC TANKS SHALL BE LISTED AND APPROVED BY IAPMO OR AN ANSI ACCREDITED TESTING ORGANIZATION: EXCEPTION TO THIS REQUIREMENT MAY BE GRANTED WHERE STRUCTURAL DESIGN CALCULATIONS FOR THE SEPTIC TANK ARE PROVIDED BY A CALIFORNIA REGISTERED CIVIL
- 4. ACCESS OPENINGS. ACCESS TO EACH SEPTIC TANK COMPARTMENT MUST BE PROVIDED BY A MANHOLE OPENING AT LEAST TWENTY INCHES IN DIAMETER.
- 5. ACCESS RISERS. A RISER MUST EXTEND FROM EACH MANHOLE OPENING TO OR ABOVE THE SURFACE OF THE GROUND. THE RISER MUST BE OF A SIZE LARGER THAN THE MANHOLE OPENING, BE BOTH GAS— AND WATER—TIGHT, BE CONSTRUCTED OF DURABLE MATERIAL AND EQUIPPED WITH A SECURE COVER.
- 6. EFFLUENT FILTER. THE OUTLET OF THE SEPTIC TANK SHALL BE FITTED WITH AN EFFLUENT FILTER CAPABLE OF SCREENING SOLIDS IN EXCESS THREE—SIXTEENTHS (3/16) OF AN INCH IN DIAMETER AND CONFORMING TO NSF/ANSI STANDARD 46 OR AS OTHERWISE APPROVED BY THE DIRECTOR.
- 7. TANK CONNECTIONS. ALL CONNECTIONS FROM BUILDING TO SEPTIC TANK MUST CONFORM TO CONSTRUCTION STANDARDS AS REQUIRED BY THE COUNTY BUILDING OFFICIAL.
- 8. WATER-TIGHTNESS TESTING. ALL NEW SEPTIC TANK INSTALLATIONS AND MODIFICATIONS TO EXISTING SEPTIC TANKS SHALL UNDERGO WATER-TIGHTNESS TESTING AS FOLLOWS:

  A) NEW TANKS. FOR NEW TANK INSTALLATIONS, THE TESTING SHALL BE DONE WITH THE RISERS IN PLACE AND THE INLET AND OUTLET PIPES PLUGGED. THE TANK SHALL BE FILLED WITH WATER TO A LEVEL EXTENDING A

MINIMUM OF TWO (2) INCHES INTO THE RISERS, AND MONITORED FOR A 1- HOUR PERIOD, WITH NO

B) EXISTING TANKS. FOR EXISTING TANKS, THE TANK SHALL BE FILLED WITH WATER TO A LEVEL EVEN WITH THE INVERT OF THE OUTLET PIPE, AND MONITORED FOR A 1—HOUR PERIOD, WITH NO MEASURABLE DROP IN WATER LEVEL. HOWEVER, IN CASES WHERE THERE THE GROUNDWATER LEVEL IS KNOWN OR ESTIMATED TO RISE ABOVE THE LEVEL OF THE OUTLET PIPE DURING ANY TIME OF THE YEAR, THE WATER—TIGHTNESS TEST SHALL BE CONDUCTED FOLLOWING THE PROCEDURE FOR NEW TANK INSTALLATIONS; I.E., BY FILLING THE TANK WITH

### C. PIPE REQUIREMENTS

- R 1. SOLID PIPE, JOINTS AND CONNECTIONS. SOLID (NON-PERFORATED) PIPE FOR OWTS MUST CONFORM TO THE STANDARDS OF THE MOST RECENT EDITION OF THE UNIFORM PLUMBING CODE, WHICH IS ADOPTED BY REFERENCE INTO THE COUNTY'S BUILDING ORDINANCES. PIPE DIAMETER MUST BE FOUR INCHES. ALL SOLID PIPE JOINTS AND CONNECTIONS MUST BE GLUED, CEMENTED OR MADE WITH AN ELASTOMERIC SEAL SO AS TO BE WATERTIGHT.
  - 2. TIGHTLINES UNDER RESIDENTIAL DRIVEWAY. TIGHTLINES IN RESIDENTIAL TRAFFIC AREAS MUST BE INSTALLED WITH SCHEDULE 40 PVC. AN ALTERNATIVE IS TO SLEEVE (I.E., DOUBLE PIPE) THE THIN WALL TIGHTLINE PIPE WITHIN AN OUTER PIPE CONSISTING OF SCHEDULE 40 PVC, ABS OR SUITABLE ALTERNATIVE AND RATED BY THE UNIFORM PLUMBING CODE.
- 3. DISTRIBUTION PIPE. PERFORATED PIPE FOR CONVENTIONAL OWTS DISPERSAL SYSTEMS MUST CONFORM TO THE MOST RECENT EDITION OF THE UNIFORM PLUMBING CODE, WHICH IS ADOPTED BY REFERENCE INTO THE COUNTY'S BUILDING ORDINANCES. THE PIPE DIAMETER MUST BE FOUR INCHES.

### D. DISPERSAL SYSTEM REQUIREMENTS

### 4 TOTALOU CONCEDUOT

A) TRENCHES MUST BE PLACED IN UNDISTURBED EARTH, IN AN ACCESSIBLE AREA, AND SHALL NOT BE COVERED BY PAVING OR OTHER IMPERMEABLE OR COMPACTED SURFACE. NATURAL TOPOGRAPHY SHALL NOT BE GRADED TO MODIFY SLOPE.

B) THE BOTTOM OF A TRENCH MUST BE LEVEL, WITH A VARIATION OF NO MORE THAN 2 INCHES PER 100

LÍNEAL FEET OF TRENCH; TRENCHES SHALL BE ALIGNED PARALLEL TO THE GROUND SURFACE CONTOURS

TO THE GREATEST EXTENT PRACTICABLE.

C) ADJACENT TRENCHES ON SLOPES MUST BE CONNECTED WITH A WATERTIGHT OVERFLOW LINE ("RELIEF LINE") IN A MANNER THAT ALLOWS EACH TRENCH TO BE FILLED WITH SEWAGE EFFLUENT TO THE DEPTH OF THE ROCK BEFORE THE SEWAGE FLOWS TO THE NEXT LOWER TRENCH. ALTERNATIVELY, A DISTRIBUTION BOX (D-BOX) MAY BE USED TO EQUALLY DIVIDE THE FLOW AMONGST THE TRENCHES, PROVIDED THE PROPOSED D-BOX IS OF A DESIGN APPROVED AND LISTED BY THE DEH PER PART 3.1.E (MATERIALS AND EQUIPMENT) OF THIS MANUAL. FOR SYSTEMS LOCATED ON SITES HAVING SLOPES OF LESS THAN 5%, A "GRID" DESIGN MAY BE USED IN ACCORDANCE WITH GUIDELINES PROVIDED UNDER AT THE END OF THIS SECTION (E.3.F).

D) TRENCHES MUST NOT BE EXCAVATED WHEN THE SOIL IS SO WET THAT SMEARING OR COMPACTION

OCCURS.

E) IN CLAY SOILS WHEN GLAZING OCCURS, THE TRENCH SURFACES MUST BE SCARIFIED TO THE DEPTH OF THE GLAZING AND THE LOOSE MATERIAL REMOVED.

OF THE GLAZING AND THE LOOSE MATERIAL REMOVED.

F) ROCK MATERIAL IN THE TRENCH MUST BE WASHED AND FREE OF FINES, AND MUST BE COVERED WITH AN APPROVED FILTER FABRIC SILT BARRIER (GEOTEXTILE) PRIOR TO BACKFILLING WITH NATURAL EARTH.

G) A CAPPED INSPECTION RISER SHALL BE INSTALLED WITHIN EACH TRENCH TO PROVIDE A MEANS OF OBSERVING THE EFFLUENT LEVEL IN THE TRENCH.

H) EROSION CONTROL MEASURES SHALL BE IMPLEMENTED FOLLOWING INSTALLATION PER REQUIREMENTS OF SECTION B11-83(C) FOR ANY CONVENTIONAL DISPERSAL SYSTEM WHERE: (1) GROUND SLOPE EXCEEDS 20%; (2) ABOVE-GRADE COVER FILL IS ADDED; (3) DESIGN FLOW EXCEEDS 1,000 GPD; OR (4) A GRADING AND/OR DRAINAGE PERMIT IS REQUIRED FOR PROJECT SITE DEVELOPMENT PER DIVISION C12, CHAPTER III OF THE COUNTY CODE. THE PLAN SUBMITTAL FOR THE OWTS SHALL INCLUDE AN EROSION CONTROL PLAN IN ACCORDANCE WITH REQUIREMENTS OF ORDINANCE SECTION B11-83(C)

# CT 12/09/22 CT 12/09/22 DESIGNED DATE CT 12/09/22 DRAWN DATE CT CT AS NOTED AS NOTED CHECKED BY DATE APP'D REVISIONS

