STANFORD RAN 12 / RED BARN SITE NAME:

35 VISTA LANE STANFORD, CA 94305 SITE ADDRESS:

SANTA CLARA COUNTY:

JURISDICTION: SANTA CLARA COUNTY

(N) 40'-0" JPA WOOD POLE SITE TYPE:

POLE ID: **TBD**

SITE INFORMATION

STANFORD RAN 12 / RED BARN

REDWOOD CITY, CA 94063

STANFORD, CA 94305

37.422952, -122.187560

SANTA CLARA COUNTY

3RD FLOOR

±455 SQFT

PROJECT: 4G/5G UPGRADE



CROWN CASTLE



SAN CLEMENTE, CA 92673 VWW.LEAFCOMM.COM

SITE NAME: STANFORD RAN 12 / RED BARN

SITE ADDRESS: 35 VISTA LANE STANFORD, CA 94305

SITE TYPE: (N) 40'-0" JPA WOOD POLE

SITE NO SCALE

LOCATION MAP

FROM CROWN CASTLE OFFICE: 1 PARK PL, DUBLIN, CA 94568

- GET ON I-680 S IN PLEASANTON FROM HACIENDA DR, W LAS POSITAS BLVI AND FOOTHILL RD
- FOLLOW I-680 S AND I-280 N TO ALPINE RD IN SAN MATEO COUNTY. TAKE EXIT 22 FROM I-280 N
- FOLLOW I-680 S AND I-280 N TO ALPINE RD IN SAN MATEO COUNTY. TAKE EXIT 22 FROM I-280 N
- TURN RIGHT ONTO JUNIPERO SERRA BLVD

DESTINATION WILL BE ON THE RIGHT

SHEET#	
T-1	TITLE SHEET
GN-1	GENERAL NOTES
A-1	SITE PLAN
A-2	ENLARGED SITE PLAN
A-3	ANTENNA LAYOUT EQUIPMENT LAYOUT
A-4	ELEVATIONS
A-5	ELEVATIONS
A-6	PHOTO SIMULATION
A-7	PHOTO SIMULATION
D-1	EQUIPMENT DETAILS
D-2	EQUIPMENT DETAILS
TCP-1	TRAFFIC CONTROL PLAN
1	

DRAWING INDEX

SHEET#	
T-1	TITLE SHEET
GN-1	GENERAL NOTES
A-1	SITE PLAN
A-2	ENLARGED SITE PLAN
A-3	ANTENNA LAYOUT EQUIPMENT LAYOUT
A-4	ELEVATIONS
A-5	ELEVATIONS
A-6	PHOTO SIMULATION
A-7	PHOTO SIMULATION
D-1	EQUIPMENT DETAILS
D-2	EQUIPMENT DETAILS
TCP-1	TRAFFIC CONTROL PLAN

JURISDICTION APPROVAL

PROJECT TEAM APPROVAL

CROWN (NRE):	
	(DATE)
CROWN (PM):	
	(DATE)
CROWN (RF):	
	(DATE)
STANFORD (IT):	
	(DATE)
GUP CHECKLIST:	
	(DATE)

EXISTING SITE PHOTO

ISSUED FOR:

L	<i>(</i>		100	0221011	
	REV	DATE	DRWN	DESCRIPTION	QA
	0	09/03/2021	MJC	90% CONSTRUCTION DWGS	CG
	1	09/21/2021	MJC	90% CD REVISION	CG
	2	10/13/2021	MJC	100% CONSTRUCTION DWGS	CG
	3	01/20/2022	СТ	100% CD CLIENT REVISION	CG
	4	06/10/2022	СТ	100% CD REVISIONS	CG
	5	11/15/2022	JG	100% CD REVISIONS	CG
	6	11/17/2022	СТ	100% CD REVISIONS	CG
1					





EXPIRES: 2023/09/30

UNLESS THEY ARE ACTING UNDER THE DIRECTION OF A LICENSED PROFESSIONAL ENGINEER, TO ALTER THIS DOCUMENT

> **SHEET TITLE:** TITLE SHEET

SHEET NUMBER:

SANTA CLARA COUNTY PLANNING DEPARTMENT

70 W HEDDING ST 7TH FLOOR, EAST WING SAN JOSE, CA 95110

STANFORD UNIVERSITY PLANNING DEPARTMENT 31160 PORTER DR

PALO ALTO, CA 94304

PROJECT TEAM

STANFORD UNIVERSITY

ARCHITECTURAL & ENGINEERING CONTACTS:

CROWN CASTLE FIBER LLC

GROUND ELEVATION: ±144'

CONSTRUCTION TYPE: NA

NUMBER OF STORIES: NA

SITE NAME:

SITE ADDRESS:

MAP/PARCEL #:

JURISDICTION:

LEASE AREA:

OCCUPANCY:

ACCESSIBILITY

REQUIREMENTS:

POWER COMPANY:

WATER COMPANY:

LAT/LONG:

PROPERTY OWNER:

CURRENT ZONING:

LEAF COMMUNICATIONS 1000 CALLE CORDILLERA SAN CLEMENTE, CA 92673 DAN LEAF- (949) 485-8793 DAN.LEAF@LEAFCOMM.COM

THE FACILITY IS UNMANNED AND NOT FOR

SANTA CLARA VALLEY WATER DISTRICT

CONTINUOUS HUMAN HABITATION. DISABLED /

CHALLENGED ACCESS IS NOT REQUIRED PER CBC 2019, SECTION 11B-203.4(LIMITED ACCESS SPACE)

ENGINEER OF **RECORD CONTACT:**

LEAF COMMUNICATIONS 1000 CALLE CORDILLERA

SAN CLEMENTE, CA 92673 ESRA H. PERSELLIN, P.E. - (949) 388-0192 ESRA.PERSELLIN@LEAFCOMM.COM

PROJECT MANAGER CONTACT:

CROWN CASTLE

1 PARK PL, DUBLIN, CA 94568 JOHN GRIFFITHS

JOHN.GRIFFITHS@CROWNCASTLE.COM

(707) 756-2030

CALL CALIFORNIA ONE CALL (800) 227-2600 CALL 3 WORKING DAYS BEFORE YOU DIG!



PROJECT DESCRIPTION

- (2) ERICSSON RADIO/ANTENNA UNITS
- (2) COMMSCOPE ANTENNAS
- (2) ERICSSON RADIO UNITS
- NEW ANTENNAS BE PAINTED/WRAPPED TO MATCH
- (1) U/G FIBER TRENCH ±20'-0"; ±60'-0" FIBER RUN

EQUIPMENT TO BE REMOVED:

- (2) ERICSSON RADIO UNITS

DESIGN REFERENCE DOCUMENT: RAN_12_Red_Barn_01 29 2020_IRF DATED: 04/14/2022 VERSION: v9

STRUCTURAL ANALYSIS REFERENCE DOCUMENT: RAN 12_STRUCTURAL ANALYSIS_20220207 DATED: 02/07/2022 **RESULT: PASS**

PROJECT CONSISTS OF INSTALLING:

- (1) 40'-0", TBD, DF UTILITY POLE

- EXISTING COLOR
- (1) U/G POWER TRENCH $\pm 10'$ -0"; $\pm 50'$ -0" POWER RUN

• (4) POWERWAVE ANTENNAS

2019 CALIFORNIA ENERGY CODE 2019 CALIFORNIA FIRE CODE

(DATE)

(DATE)

- PRIOR TO ACCESSING/ENTERING THE SITE YOU MUST CONTACT THE CROWN NOC AT (800) 788-7011 & CROWN CONSTRUCTION MANAGER
- THE FACILITY IS UNMANNED AND NOT FOR HUMAN HABITATION. A TECHNICIAN WILL VISIT THE SITE AS REQUIRED FOR ROUTINE MAINTENANCE. THE PROJECT WILL NOT RESULT IN ANY SIGNIFICANT DISTURBANCE OR EFFECT DRAINAGE; NO SANITARY SEWER SERVICE, PORTABLE WATER, OR TRASH DISPOSAL IS REQUIRED AND NO COMMERCIAL SIGNAGE IS PROPOSED.
- VERIFY ALL PLANS AND EXISTING DIMENSIONS AND CONDITIONS ON THE JOB SITE AND SHALL IMMEDIATELY NOTIFY THE ENGINEER IN WRITING OF ANY DISCREPANCIES BEFORE PROCEEDING WITH THE WORK OR BE RESPONSIBLE FOR SAME.

APPLICABLE CODES/REFERENCE DOCUMENTS

ALL WORK SHALL BE PERFORMED AND MATERIALS INSTALLED IN ACCORDANCE WITH THE CURRENT EDITIONS OF THE FOLLOWING CODES AS ADOPTED BY THE LOCAL GOVERNING AUTHORITIES. NOTHING IN THESE PLANS IS TO BE CONSTRUED TO PERMIT WORK NOT CONFORMING TO THESE CODES:

2019 CALIFORNIA BUILDING CODE 2019 CALIFORNIA ADMINISTRATIVE CODE 2019 CALIFORNIA ELECTRICAL CODE 2019 CALIFORNIA MECHANICAL CODE 2019 CALIFORNIA PLUMBING CODE 2019 NFPA 101 2019 NFPA 72 2019 NFPA 13

CITY/COUNY ORDINANCES

ANSI/TIA-222-H

ALL DRAWINGS CONTAINED HEREIN ARE FORMATTED FOR FULL SIZE. CONTRACTOR SHALL



SITE WORK GENERAL NOTES

- 1. THE SUBCONTRACTOR SHALL CONTACT UTILITY LOCATING SERVICES PRIOR TO THE START OF CONSTRUCTION.
- 2. ALL EXISTING ACTIVE SEWER, WATER, GAS, ELECTRIC AND OTHER UTILITIES WHERE ENCOUNTERED IN THE WORK, SHALL BE PROTECTED AT ALL TIMES AND WHERE REQUIRED FOR THE PROPER EXECUTION OF THE WORK, SHALL BE RELOCATED AS DIRECTED BY CONTRACTOR. EXTREME CAUTION SHOULD BE USED BY THE SUBCONTRACTOR WHEN EXCAVATING OR DRILLING PIERS AROUND OR NEAR UTILITIES, SUBCONTRACTOR SHALL PROVIDE SAFETY TRAINING FOR THE WORKING CREW. THIS WILL INCLUDE BUT NOT BE LIMITED TO A) FALL PROTECTION B) CONFINED SPACE C) ELECTRICAL SAFETY D) TRENCHING AND EXCAVATION.
- 3. ALL SITE WORK TO COMPLY WITH QAS-STD-10068 "INSTALLATION STANDARDS FOR CONSTRUCTION ACTIVITIES ON CROWN CASTLE TOWER SITE" AND LATEST VERSION OF TIA 1019 "STANDARD FOR INSTALLATION, ALTERATION, AND MAINTENANCE OF ANTENNA SUPPORTING STRUCTURES AND ANTENNAS."
- 4. ALL SITE WORK SHALL BE AS INDICATED ON THE STAMPED CONSTRUCTION DRAWINGS AND PROJECT SPECIFICATIONS.
- 5. IF NECESSARY, RUBBISH, STUMPS, DEBRIS, STICKS, STONES AND OTHER REFUSE SHALL BE REMOVED FROM THE SITE AND DISPOSED OF LEGALLY.
- 6. ALL EXISTING INACTIVE SEWER, WATER, GAS, ELECTRIC AND OTHER UTILITIES, WHICH INTERFERE WITH THE EXECUTION OF THE WORK, SHALL BE REMOVED AND/OR CAPPED, PLUGGED OR OTHERWISE DISCONTINUED AT POINTS WHICH WILL NOT INTERFERE WITH THE EXECUTION OF THE WORK, SUBJECT TO THE APPROVAL OF CONTRACTOR, OWNER AND/OR LOCAL UTILITIES.
- 7. THE SUBCONTRACTOR SHALL PROVIDE SITE SIGNAGE IN ACCORDANCE WITH THE TECHNICAL SPECIFICATION FOR SITE SIGNAGE.
- 8. THE SITE SHALL BE GRADED TO CAUSE SURFACE WATER TO FLOW AWAY FROM THE BTS EQUIPMENT AND TOWER AREAS.
- 9. NO FILL OR EMBANKMENT MATERIAL SHALL BE PLACED ON FROZEN GROUND. FROZEN MATERIALS, SNOW OR ICE SHALL NOT BE PLACED IN ANY FILL OR EMBANKMENT.
- 10. THE SUB GRADE SHALL BE COMPACTED AND BROUGHT TO A SMOOTH UNIFORM GRADE PRIOR TO FINISHED SURFACE APPLICATION.
- 11. THE AREAS OF THE OWNERS PROPERTY DISTURBED BY THE WORK AND NOT COVERED BY THE TOWER, EQUIPMENT OR DRIVEWAY, SHALL BE GRADED TO A UNIFORM SLOPE, AND STABILIZED TO PREVENT EROSION AS SPECIFIED ON THE PROJECT SPECIFICATIONS.
- 12. SUBCONTRACTOR SHALL MINIMIZE DISTURBANCE TO EXISTING SITE DURING CONSTRUCTION. EROSION CONTROL MEASURES, IF REQUIRED DURING CONSTRUCTION, SHALL BE IN CONFORMANCE WITH THE LOCAL GUIDELINES FOR EROSION AND SEDIMENT CONTROL.
- 13. NOTICE TO PROCEED- NO WORK TO COMMENCE PRIOR TO COMPANY'S WRITTEN NOTICE TO PROCEED AND THE ISSUANCE OF A PURCHASE ORDER.
- 14. ALL CONSTRUCTION MEANS AND METHODS; INCLUDING BUT NOT LIMITED TO, ERECTION PLANS, RIGGING PLANS, CLIMBING PLANS, AND RESCUE PLANS SHALL BE THE RESPONSIBILITY OF THE GENERAL CONTRACTOR RESPONSIBLE FOR THE EXECUTION OF THE WORK CONTAINED HEREIN AND SHALL MEET ANSI/ASSE A10.48 (LATEST EDITION); FEDERAL STATE, AND LOCAL REGULATIONS; AND ANY APPLICABLE INDUSTRY CONSENSUS STANDARDS RELATED TO THE CONSTRUCTION ACTIVITIES BEING PERFORMED. ALL RIGGING PLANS SHALL ADHERE TO ANSI/ASSE A10.48 (LATEST EDITION) AND CROWN STANDARD CED-STD-10253 INCLUDING THE REQUIRED INVOLVEMENT OF A QUALIFIED ENGINEER FOR CLASS IV CONSTRUCTION TO CERTIFY THE SUPPORTING STRUCTURE(S) IN ACCORDANCE WITH THE ANSI/TIA-322 (LATEST EDITION).

STRUCTURAL STEEL NOTES:

- . ALL STEEL WORK SHALL BE PAINTED IN ACCORDANCE WITH THE PROJECT SPECIFICATIONS AND IN ACCORDANCE WITH ASTM A36 UNLESS OTHERWISE NOTED.
- 2. BOLTED CONNECTIONS SHALL BE ASTM A325 BEARING TYPE (3/4"\$) CONNECTIONS AND SHALL HAVE MINIMUM OF TWO BOLTS UNLESS NOTED OTHERWISE.
- 3. NON-STRUCTURAL CONNECTIONS FOR STEEL GRATING MAY USE 5/8"Ø ASTM A307 BOLTS UNLESS NOTED OTHERWISE.
- 4. INSTALLATION OF CONCRETE EXPANSION/WEDGE ANCHOR, SHALL BE PER MANUFACTURER'S RECOMMENDED PROCEDURE. THE ANCHOR BOLT, DOWEL OR ROD SHALL CONFORM TO MANUFACTURER'S RECOMMENDATION FOR EMBEDMENT DEPTH OR AS SHOWN ON THE DRAWINGS. NO REBAR SHALL BE CUT WITHOUT PRIOR CONTRACTOR APPROVAL WHEN DRILLING HOLES IN CONCRETE. SPECIAL INSPECTIONS, REQUIRED BY GOVERNING CODES, SHALL BE PERFORMED IN ORDER TO MAINTAIN MANUFACTURER'S MAXIMUM ALLOWABLE LOADS.

CONCRETE AND REINFORCING STEEL NOTES:

- 1. ALL CONCRETE WORK SHALL BE IN ACCORDANCE WITH THE ACI 301, ACI 318, ACI 336, ASTM A184, ASTM A185 AND THE DESIGN AND CONSTRUCTION SPECIFICATION FOR CAST-IN-PLACE CONCRETE.
- 2. ALL CONCRETE SHALL HAVE A MINIMUM COMPRESSIVE STRENGTH OF 3000 PSI AT 28 DAYS, UNLESS NOTED OTHERWISE. SLAB FOUNDATION DESIGN ASSUMING ALLOWABLE SOIL BEARING PRESSURE OF 2000 PSF.
- 3. REINFORCING STEEL SHALL CONFORM TO ASTM A615, GRADE 60, DEFORMED UNLESS NOTED OTHERWISE. WELDED WIRE FABRIC SHALL CONFORM TO ASTM A185 WELDED STEEL WIRE FABRIC UNLESS NOTED OTHERWISE. SPLICES SHALL BE CLASS "B" AND ALL HOOKS SHALL BE STANDARD, UNO.
- 4. THE FOLLOWING MINIMUM CONCRETE COVER SHALL BE PROVIDED FOR REINFORCING STEEL UNLESS SHOWN OTHERWISE ON DRAWINGS:

CONCRETE CAST AGAINST EARTH..... CONCRETE EXPOSED TO EARTH OR WEATHER: #6 AND LARGER... #5 AND SMALLER & WWF...1 1/2 IN. CONCRETE NOT EXPOSED TO EARTH OR WEATHER OR NOT CAST AGAINST THE **GROUND:**

SLAB AND WALLS... ...3/4 IN. BEAMS AND COLUMNS.....1 1/2 IN.

5. A CHAMFER 3/4" SHALL BE PROVIDED AT ALL EXPOSED EDGES OF CONCRETE, UNLESS NOTED OTHERWISE. IN ACCORDANCE WITH ACI 301 SECTION 4.2.4.

MASONRY NOTES:

- 1. HOLLOW CONCRETE MASONRY UNITS SHALL MEET A.S.T.M. SPECIFICATION C90, GRADE N. TYPE 1. THE SPECIFIED DESIGN COMPRESSIVE STRENGTH OF CONCRETE MASONRY (F'm) SHALL BE 1500 PSI.
- 2. MORTAR SHALL MEET THE PROPERTY SPECIFICATION OF A.S.T.M. C270 TYP. "S" MORTAR AND SHALL HAVE A MINIMUM COMPRESSIVE STRENGTH OF 2000 PSI.
- 3. GROUT SHALL MEET A.S.T.M. SPECIFICATION C475 AND HAVE A MINIMUM 28 DAY COMPRESSIVE STRENGTH OF 2000 PSI.
- 4. CONCRETE MASONRY SHALL BE LAID IN RUNNING (COMMON) BOND.
- 5. WALL SHALL RECEIVE TEMPORARY BRACING. TEMPORARY BRACING SHALL NOT BE REMOVED UNTIL GROUT IS FULLY CURED.

GENERAL NOTES:

1. FOR THE PURPOSE OF CONSTRUCTION DRAWING, THE FOLLOWING DEFINITIONS SHALL APPLY: CONTRACTOR-

SUBCONTRACTOR - GENERAL CONTRACTOR (CONSTRUCTION) TOWER OWNER - CROWN CASTLE FIBER LLC OEM-ORIGINAL EQUIPMENT MANUFACTURER

- 2. PRIOR TO THE SUBMISSION OF BIDS, THE BIDDING SUBCONTRACTOR SHALL VISIT THE CELL SITE TO FAMILIARIZE WITH THE EXISTING CONDITIONS AND TO CONFIRM THAT THE WORK CAN BE ACCOMPLISHED AS SHOWN ON THE CONSTRUCTION DRAWINGS. ANY DISCREPANCY FOUND SHALL BE BROUGHT TO THE ATTENTION OF CONTRACTOR AND CROWN CASTLE.
- 3. ALL MATERIALS FURNISHED AND INSTALLED SHALL BE IN STRICT ACCORDANCE WITH ALL APPLICABLE CODES, REGULATIONS AND ORDINANCES. SUBCONTRACTOR SHALL ISSUE ALL APPROPRIATE NOTICES AND COMPLY WITH ALL LAWS, ORDINANCES, RULES, REGULATIONS AND LAWFUL ORDERS OF ANY PUBLIC AUTHORITY REGARDING THE PERFORMANCE OF THE WORK, ALL WORK CARRIED OUT SHALL COMPLY WITH ALL APPLICABLE MUNICIPAL AND UTILITY COMPANY SPECIFICATIONS AND LOCAL JURISDICTIONAL CODES, ORDINANCES AND APPLICABLE REGULATIONS.
- 4. DRAWINGS PROVIDED HERE ARE NOT TO SCALE AND ARE INTENDED TO SHOW OUTLINE ONLY.
- 5. UNLESS NOTED OTHERWISE, THE WORK SHALL INCLUDE FURNISHING MATERIALS, EQUIPMENT, APPURTENANCES AND LABOR NECESSARY TO COMPLETE ALL INSTALLATIONS AS INDICATED ON THE DRAWINGS.
- 6. "KITTING LIST" SUPPLIED WITH THE BID PACKAGE IDENTIFIES ITEMS THAT WILL BE SUPPLIED BY CONTRACTOR. ITEMS NOT INCLUDED IN THE BILL OF MATERIALS AND KITTING LIST SHALL BE SUPPLIED BY THE SUBCONTRACTOR.
- 7. THE SUBCONTRACTOR SHALL INSTALL ALL EQUIPMENT AND MATERIALS IN ACCORDANCE WITH MANUFACTURER'S RECOMMENDATIONS UNLESS SPECIFICALLY STATED OTHERWISE.
- 8. IF THE SPECIFIED EQUIPMENT CAN NOT BE INSTALLED AS SHOWN ON THESE DRAWINGS, THE SUBCONTRACTOR SHALL PROPOSE AN ALTERNATIVE INSTALLATION FOR APPROVAL BY THE CONTRACTOR AND CROWN CASTLE PRIOR TO PROCEEDING WITH ANY SUCH CHANGE OF INSTALLATION.
- SUBCONTRACTOR SHALL DETERMINE ACTUAL ROUTING OF CONDUIT. POWER AND T1 CABLES. GROUNDING CABLES AS SHOWN ON THE POWER, GROUNDING AND TELCO PLAN DRAWINGS.
- 10. THE SUBCONTRACTOR SHALL PROTECT EXISTING IMPROVEMENTS, PAVEMENTS, CURBS, LANDSCAPING AND STRUCTURES. ANY DAMAGED PART SHALL BE REPAIRED AT SUBCONTRACTOR'S EXPENSE TO THE SATISFACTION OF OWNER.
- 11. SUBCONTRACTOR SHALL LEGALLY AND PROPERLY DISPOSE OF ALL SCRAP MATERIALS SUCH AS COAXIAL CABLES AND OTHER ITEMS REMOVED FROM THE EXISTING FACILITY. ANTENNAS REMOVED SHALL BE RETURNED TO THE OWNER'S DESIGNATED LOCATION.
- 12. SUBCONTRACTOR SHALL LEAVE PREMISES IN CLEAN CONDITION. TRASH AND DEBRIS SHOULD BE REMOVED FROM SITE ON A DAILY BASIS.

ABBREVIATIONS AND SYMBOLS:

ABOVE GRADE LEVEL

ABBREVIATIONS:

BASE TRANSCEIVER STATION EXISTING MINIMUM REF REFERENCE RADIO FREQUENCY T.B.D. TO BE DETERMINED T.B.R. TO BE RESOLVED TYP TYPICAL REQ REQUIRED EGR EQUIPMENT GROUND RING AWG AMERICAN WIRE GAUGE MGB MASTER GROUND BAR EG EQUIPMENT GROUND BARE COPPER WIRE BCW SMART INTEGRATED ACCESS DEVICE GEN GENERATOR IGR INTERIOR GROUND RING (HALO) RBS

RADIO BASE STATION

SYMBOLS:

SOLID GROUND BUS BAR -S/N- SOLID NEUTRAL BUS BAR SUPPLEMENTAL GROUND CONDUCTOR 2-POLE THERMAL-MAGNETIC CIRCUIT BREAKER

SINGLE-POLE THERMAL-MAGNETIC CIRCUIT BREAKER

CHEMICAL GROUND ROD

TEST WELL DISCONNECT SWITCH

> METER EXOTHERMIC WELD (CADWELD) (UNLESS OTHERWISE NOTED)

MECHANICAL CONNECTION

—— GROUNDING WIRE

ELECTRICAL INSTALLATION NOTES:

- 1. ALL ELECTRICAL WORK SHALL BE PERFORMED IN ACCORDANCE WITH THE PROJECT SPECIFICATIONS, NEC AND ALL APPLICABLE FEDERAL, STATE, AND LOCAL CODES/ORDINANCES.
- 2. CONDUIT ROUTINGS ARE SCHEMATIC. SUBCONTRACTOR SHALL INSTALL CONDUITS SO THAT ACCESS TO EQUIPMENT IS NOT BLOCKED AND TRIP HAZARDS ARE ELIMINATED.
- 3. WIRING, RACEWAY AND SUPPORT METHODS AND MATERIALS SHALL COMPLY WITH THE REQUIREMENTS OF THE NEC. HILTI EPOXY ANCHORS ARE REQUIRED BY CROWN CASTLE.
- 4. ALL CIRCUITS SHALL BE SEGREGATED AND MAINTAIN MINIMUM CABLE SEPARATION AS REQUIRED BY THE NEC.
- 5. CABLES SHALL NOT BE ROUTED THROUGH LADDER-STYLE CABLE TRAY RUNGS.
- EACH END OF EVERY POWER, POWER PHASE CONDUCTOR (I.E., HOTS), GROUNDING AND T1 CONDUCTOR AND CABLE SHALL BE LABELED WITH COLOR-CODED INSULATION OR ELECTRICAL TAPE (3M BRAND, 1/2" PLASTIC ELECTRICAL TAPE WITH UV PROTECTION, OR EQUAL). THE IDENTIFICATION METHOD SHALL CONFORM WITH NEC AND OSHA.
- ALL ELECTRICAL COMPONENTS SHALL BE CLEARLY LABELED WITH PLASTIC TAPE PER COLOR SCHEDULE. ALL EQUIPMENT SHALL BE LABELED WITH THEIR VOLTAGE RATING, PHASE CONFIGURATION, WIRE CONFIGURATION, POWER OR AMPACITY RATING AND BRANCH CIRCUIT ID NUMBERS (I.E. PANEL BOARD AND CIRCUIT ID'S).
- 8. PANEL BOARDS (ID NUMBERS) AND INTERNAL CIRCUIT BREAKERS (CIRCUIT ID NUMBERS) SHALL BE CLEARLY LABELED WITH PLASTIC LABELS.
- 9. ALL TIE WRAPS SHALL BE CUT FLUSH WITH APPROVED CUTTING TOOL TO REMOVE SHARP EDGES.
- 10. POWER, CONTROL AND EQUIPMENT GROUND WIRING IN TUBING OR CONDUIT SHALL BE SINGLE CONDUCTOR (#14 AWG OR LARGER), 600 V, OIL RESISTANT THHN OR THWN-2, CLASS B STRANDED COPPER CABLE RATED FOR 90° C (WET & DRY) OPERATION LISTED OR LABELED FOR THE LOCATION AND RACEWAY SYSTEM USED UNLESS OTHERWISE SPECIFIED.
- 11. SUPPLEMENTAL EQUIPMENT GROUND WIRING LOCATED INDOORS SHALL BE SINGLE CONDUCTOR (#6 AWG OR LARGER), 600V, OIL RESISTANT THHN OR THWN-2 GREEN INSULATION CLASS B STRANDED COPPER CABLE RATED FOR 90° C (WET AND DRY) OPERATION LISTED OR LABELED FOR THE LOCATION AND RACEWAY SYSTEM USED UNLESS OTHERWISE SPECIFIED.
- 12. POWER AND CONTROL WIRING, NOT IN TUBING OR CONDUIT, SHALL BE MULTI-CONDUCTOR, TYPE TC CABLE (#14 AWG OR LARGER), 600 V, OIL RESISTANT THHN OR THWN-2, CLASS B STRANDED COPPER CABLE RATED FOR 90° C (WET AND DRY) OPERATION WITH OUTER JACKET LISTED OR LABELED FOR THE LOCATION USED UNLESS OTHERWISE SPECIFIED.
- 13. ALL POWER AND GROUNDING CONNECTIONS SHALL BE CRIMP-STYLE, COMPRESSION WIRE LUGS AND WIRE NUTS BY THOMAS AND BETTS (OR EQUAL). LUGS AND WIRE NUTS SHALL BE RATED FOR OPERATION AT NO LESS THAN 75° C (90° C IF
- 14. RACEWAY AND CABLE TRAY SHALL BE LISTED OR LABELED FOR ELECTRICAL USE IN ACCORDANCE WITH NEMA, UL, ANSI/IEEE AND NEC.
- 15. ELECTRICAL METALLIC TUBING (EMT) OR RIGID NONMETALLIC CONDUIT (I.E. RIGID PVC SCHEDULE 40 OR RIGID PVC SCHEDULE 80 FOR LOCATIONS SUBJECT TO PHYSICAL DAMAGE) SHALL BE USED FOR EXPOSED INDOOR LOCATIONS.
- 16. ELECTRICAL METALLIC TUBING (EMT), ELECTRICAL NONMETALLIC TUBING (ENT) OR RIGID NONMETALLIC CONDUIT (RIGID PVC, SCHEDULE 40) SHALL BE USED FOR CONCEALED INDOOR LOCATIONS.
- ELBOWS/90s AND ALL APPROVED ABOVE GRADE PVC CONDUIT.

17. SCHEDULE 40 PVC UNDERGROUND ON STRAIGHTS AND SCHEDULE 80 PVC FOR ALL

- 18. LIQUID-TIGHT FLEXIBLE METALLIC CONDUIT (LIQUID-TITE FLEX) SHALL BE USED INDOORS AND OUTDOORS, WHERE VIBRATION OCCURS OR FLEXIBILITY IS NEEDED.
- 19. CONDUIT AND TUBING FITTINGS SHALL BE THREADED OR COMPRESSION—TYPE AND APPROVED FOR THE LOCATION USED. SET SCREW FITTINGS ARE NOT ACCEPTABLE.
- 20. CABINETS, BOXES AND WIRE WAYS SHALL BE LABELED FOR ELECTRICAL USE IN ACCORDANCE WITH NEMA, UL, ANSI/IEEE AND NEC.
- 21. WIREWAYS SHALL BE EPOXY—COATED (GRAY) AND INCLUDE A HINGED COVER, DESIGNED TO SWING OPEN DOWNWARDS; SHALL BE PANDUIT TYPE E (OR EQUAL); AND RATED NEMA 1 (OR BETTER).
- 22. CONDUITS SHALL BE FASTENED SECURELY IN PLACE WITH APPROVED NON-PERFORATED STRAPS AND HANGERS. EXPLOSIVE DEVICES FOR ATTACHING HANGERS TO STRUCTURE WILL NOT BE PERMITTED. CLOSELY FOLLOW THE LINES OF THE STRUCTURE, MAINTAIN CLOSE PROXIMITY TO THE STRUCTURE AND KEEP CONDUITS IN TIGHT ENVELOPES. CHANGES IN DIRECTION TO ROUTE AROUND OBSTACLES SHALL BE MADE WITH CONDUIT OUTLET BODIES. CONDUIT SHALL BE INSTALLED IN A NEAT AND WORKMANLIKE MANNER. PARALLEL AND PERPENDICULAR TO STRUCTURE WALL AND CEILING LINES. ALL CONDUIT SHALL BE FISHED TO CLEAR OBSTRUCTIONS. ENDS OF CONDUITS SHALL BE TEMPORARILY CAPPED FLUSH TO FINISH GRADE TO PREVENT CONCRETE, PLASTER OR DIRT FROM ENTERING. CONDUITS SHALL BE RIGIDLY CLAMPED TO BOXES BY GALVANIZED MALLEABLE IRON BUSHIN ON INSIDE AND GALVANIZED MALLEABLE IRON LOCKNUT ON OUTSIDE AND INSIDE.
- 23. EQUIPMENT CABINETS, TERMINAL BOXES, JUNCTION BOXES AND PULL BOXES SHALL BE GALVANIZED OR EPOXY-COATED SHEET STEEL; SHALL MEET OR EXCEED UL 50 AND RATED NEMA 1 (OR BETTER) INDOORS OR NEMA 3R (OR BETTER) OUTDOORS.
- 24. METAL RECEPTACLE, SWITCH AND DEVICE BOXES SHALL BE GALVANIZED, EPOXY-COATED OR NON-CORRODING; SHALL MEET OR EXCEED UL 514A AND NEMA OS 1; AND RATED NEMA 1 (OR BETTER) INDOORS OR WEATHER PROTECTED (WP OR BETTER) OUTDOORS.
- 25. NONMETALLIC RECEPTACLE, SWITCH AND DEVICE BOXES SHALL MEET OR EXCEED NEMA OS 2; AND RATED NEMA 1 (OR BETTER) INDOORS OR WEATHER PROTECTED (WP OR BETTER) OUTDOORS.
- 26. THE SUBCONTRACTOR SHALL NOTIFY AND OBTAIN NECESSARY AUTHORIZATION FROM THE CONTRACTOR BEFORE COMMENCING WORK ON THE AC POWER DISTRIBUTION PANELS.
- 27. THE SUBCONTRACTOR SHALL PROVIDE NECESSARY TAGGING ON THE BREAKERS, CABLES AND DISTRIBUTION PANELS IN ACCORDANCE WITH THE APPLICABLE CODES AND STANDARDS TO SAFEGUARD LIFE AND PROPERTY.
- 28. INSTALL PLASTIC LABEL ON THE METER CENTER TO SHOW "CROWN CASTLE".
- 29. ALL CONDUITS THAT ARE INSTALLED ARE TO HAVE A METERED MULE TAPE PULL CORD INSTALLED.

GREENFIELD GROUNDING NOTES:

- 1. ALL GROUND ELECTRODE SYSTEMS (INCLUDING TELECOMMUNICATION, RADIO, LIGHTNING PROTECTION AND AC POWER GES'S) SHALL BE BONDED TOGETHER AT OR BELOW GRADE, BY TWO OR MORE COPPER BONDING CONDUCTORS IN ACCORDANCE WITH THE NEC.
- 2. THE SUBCONTRACTOR SHALL PERFORM IEEE FALL-OF-POTENTAL RESISTANCE TO EARTH TESTING (PER IEEE 1100 AND 81) FOR GROUND ELECTRODE SYSTEMS, THE SUBCONTRACTOR SHALL FURNISH AND INSTALL SUPPLEMENTAL GROUND ELECTRODES AS NEEDED TO ACHIEVE A TEST RESULT OF 5 OHMS OR LESS.
- 3. THE SUBCONTRACTOR IS RESPONSIBLE FOR PROPERLY SEQUENCING GROUNDING AND UNDERGROUND CONDUIT INSTALLATION AS TO PREVEN ANY LOSS OF CONTINUITY IN THE GROUNDING SYSTEM OR DAMAGE THE CONDUIT AND PROVIDE TESTING RESULTS.
- 4. METAL CONDUIT AND TRAY SHALL BE GROUNDED AND MADE ELECTRICALLY CONTINUOUS WITH LISTED BONDING FITTINGS OR BY BONDING ACROSS THE DISCONTINUITY WITH #6 AWG COPPER WIRE UL APPROVED GROUNDING TYPE CONDUIT CLAMPS.
- 5. METAL RACEWAY SHALL NOT BE USED AS THE NEC REQUIRED EQUIPMENT GROUND CONDUCTOR. STRANDED COPPER CONDUCTORS WITH GREEN INSULATION, SIZED IN ACCORDANCE WITH THE NEC, SHALL BE FURNISHED AND INSTALLED WITH THE POWER CIRCUITS TO BTS EQUIPMENT.
- 6. EACH CABINET FRAME SHALL BE DIRECTLY CONNECTED TO THE MASTER GROUND BAR WITH GREEN INSULATED SUPPLEMENTAL EQUIPMENT GROUND WIRES, 6 AWG STRANDED COPPER OR LARGER FOR INDOOR BTS; #2 AWG SOLID TINNED COPPER FOR OUTDOOR BTS.
- CONNECTIONS TO THE GROUND BUS SHALL NOT BE DOUBLED UP OR STACKED BACK TO BACK CONNECTIONS ON OPPOSITE SIDE OF THE GROUND BUS ARE PERMITTED.
- 8. ALL EXTERIOR GROUND CONDUCTORS BETWEEN EQUIPMENT/GROUND BARS AND THE GROUND RING SHALL BE #2 AWG SOLID TINNED COPPER UNLESS OTHERWISE INDICATED.
- 9. ALUMINUM CONDUCTOR OR COPPER CLAD STEEL CONDUCTOR SHALL NOT BE USED FOR GROUNDING CONNECTIONS.
- 10. USE OF 90° BENDS IN THE PROTECTION GROUNDING CONDUCTORS SHALL BE AVOIDED WHEN 45° BENDS CAN BE ADEQUATELY SUPPORTED
- 11. EXOTHERMIC WELDS SHALL BE USED FOR ALL GROUNDING CONNECTIONS BELOW GRADE.
- 12. ALL GROUND CONNECTIONS ABOVE GRADE (INTERIOR AND EXTERIOR) SHALL BE FORMED USING HIGH PRESS CRIMPS.
- 13. COMPRESSION GROUND CONNECTIONS MAY BE REPLACED BY EXOTHERMIC WELD CONNECTIONS. 14. ICE BRIDGE BONDING CONDUCTORS SHALL BE EXOTHERMICALLY BONDE
- OR BOLTED TO THE BRIDGE AND THE TOWER GROUND BAR. 15. APPROVED ANTIOXIDANT COATINGS (I.E. CONDUCTIVE GEL OR PASTE) SHALL BE USED ON ALL COMPRESSION AND BOLTED GROUND
- 16. ALL EXTERIOR GROUND CONNECTIONS SHALL BE COATED WITH A CORROSION RESISTANT MATERIAL.

CONNECTIONS.

- 17. MISCELLANEOUS ELECTRICAL AND NON-ELECTRICAL METAL BOXES, FRAMES AND SUPPORTS SHALL BE BONDED TO THE GROUND RING, IN ACCORDANCE WITH THE NEC.
- 18. BOND ALL METALLIC OBJECTS WITHIN 6 FT. OF MAIN GROUND WIRES WITH 1-#2 AWG TIN-PLATED COPPER GROUND CONDUCTOR.
- 19. GROUND CONDUCTORS USED IN THE FACILITY GROUND AND LIGHTNING PROTECTION SYSTEMS SHALL NOT BE ROUTED THROUGH METALLIC OBJECTS THAT FORM A RING AROUND THE CONDUCTOR, SUCH AS METALLIC CONDUITS, METAL SUPPORT CLIPS OR SLEEVES THROUGH WALLS OR FLOORS, WHEN IT IS REQUIRED TO BE HOUSED IN CONDUIT TO MEET CODE REQUIREMENTS OR LOCAL CONDITIONS, NON-METALLIC MATERIAL SUCH AS PVC PLASTIC CONDUIT SHALL BE USED. WHERE USE OF METAL CONDUIT IS UNAVOIDABLE (E.G., NONMETALLIC CONDUIT PROHIBITED BY LOCAL CODE) THE GROUND CONDUCTOR SHALL BE BONDED TO EACH END OF THE METAL CONDUIT.
- 20. ALL GROUNDS THAT TRANSITION FROM BELOW GRADE TO ABOVE GRADE MUST BE #2 TINNED SOLID IN 3/4" LIQUID TIGHT CONDUIT FROM 24" BELOW GRADE TO WITHIN 3" TO 6" OF CAD-WELD TERMINATION POINT. THE EXPOSED END OF THE LIQUID TIGHT CONDUIT MUST BE SEALED WITH SILICONE CAULK. (ADD TRANSITIONING GROUND STANDARD DETAIL AS WELL).

NEC INSULATOR COLOR CODE

DESCRIPTION	PHASE/CODE LETTER	WIRE COLOR
240/120 1Ø	LEG 1	BLACK
240/120 10	LEG 2	RED
AC NEUTRAL	N	WHITE
GROUND (EGC)	G	GREEN
VDC POS	+	*RED-POLARITY MARK AT TERMINATION
VDC NEG	-	*BLACK-POLARITY MARK AT TERMINATION
	PHASE A	BLACK
240V OR 208V, 3Ø	PHASE B	RED(ORG. IF HI LEG)
	PHASE C	BLUE
	PHASE A	BROWN

PHASE B

PHASE C

ORANGE

YELLOW

* SEE NEC 210.5(C)(1) AND (2)

480V, 3Ø



DUBLIN, CA 94568



1000 CALLE CORDILLERA SAN CLEMENTE, CA 92673 WWW.LEAFCOMM.COM TEL: (949) 388-0192

SITE NAME: STANFORD RAN 12 / RED BARN

SITE ADDRESS: 35 VISTA LANE STANFORD, CA 94305

SITE TYPE: (N) 40'-0" JPA WOOD POLE

ISSUED FOR

	1	(133	OED FOR:	
		REV	DATE	DRWN	DESCRIPTION	QA
		0	09/03/2021	MJC	90% CONSTRUCTION DWGS	CC
		1	09/21/2021	MJC	90% CD REVISION	CC
		2	10/13/2021	MJC	100% CONSTRUCTION DWGS	CC
Ν		3	01/20/2022	СТ	100% CD CLIENT REVISION	CC
		4	06/10/2022	СТ	100% CD REVISIONS	CC
		5	11/15/2022	JG	100% CD REVISIONS	CC
5		6	11/17/2022	СТ	100% CD REVISIONS	CC
	1					
		•		l		






IT IS A VIOLATION OF LAW FOR ANY PERSON, UNLESS THEY ARE ACTING UNDER THE DIRECTION OF A LICENSED PROFESSIONAL ENGINEER, TO ALTER THIS DOCUMENT.

> **SHEET TITLE:** GENERAL NOTES

SHEET NUMBER:

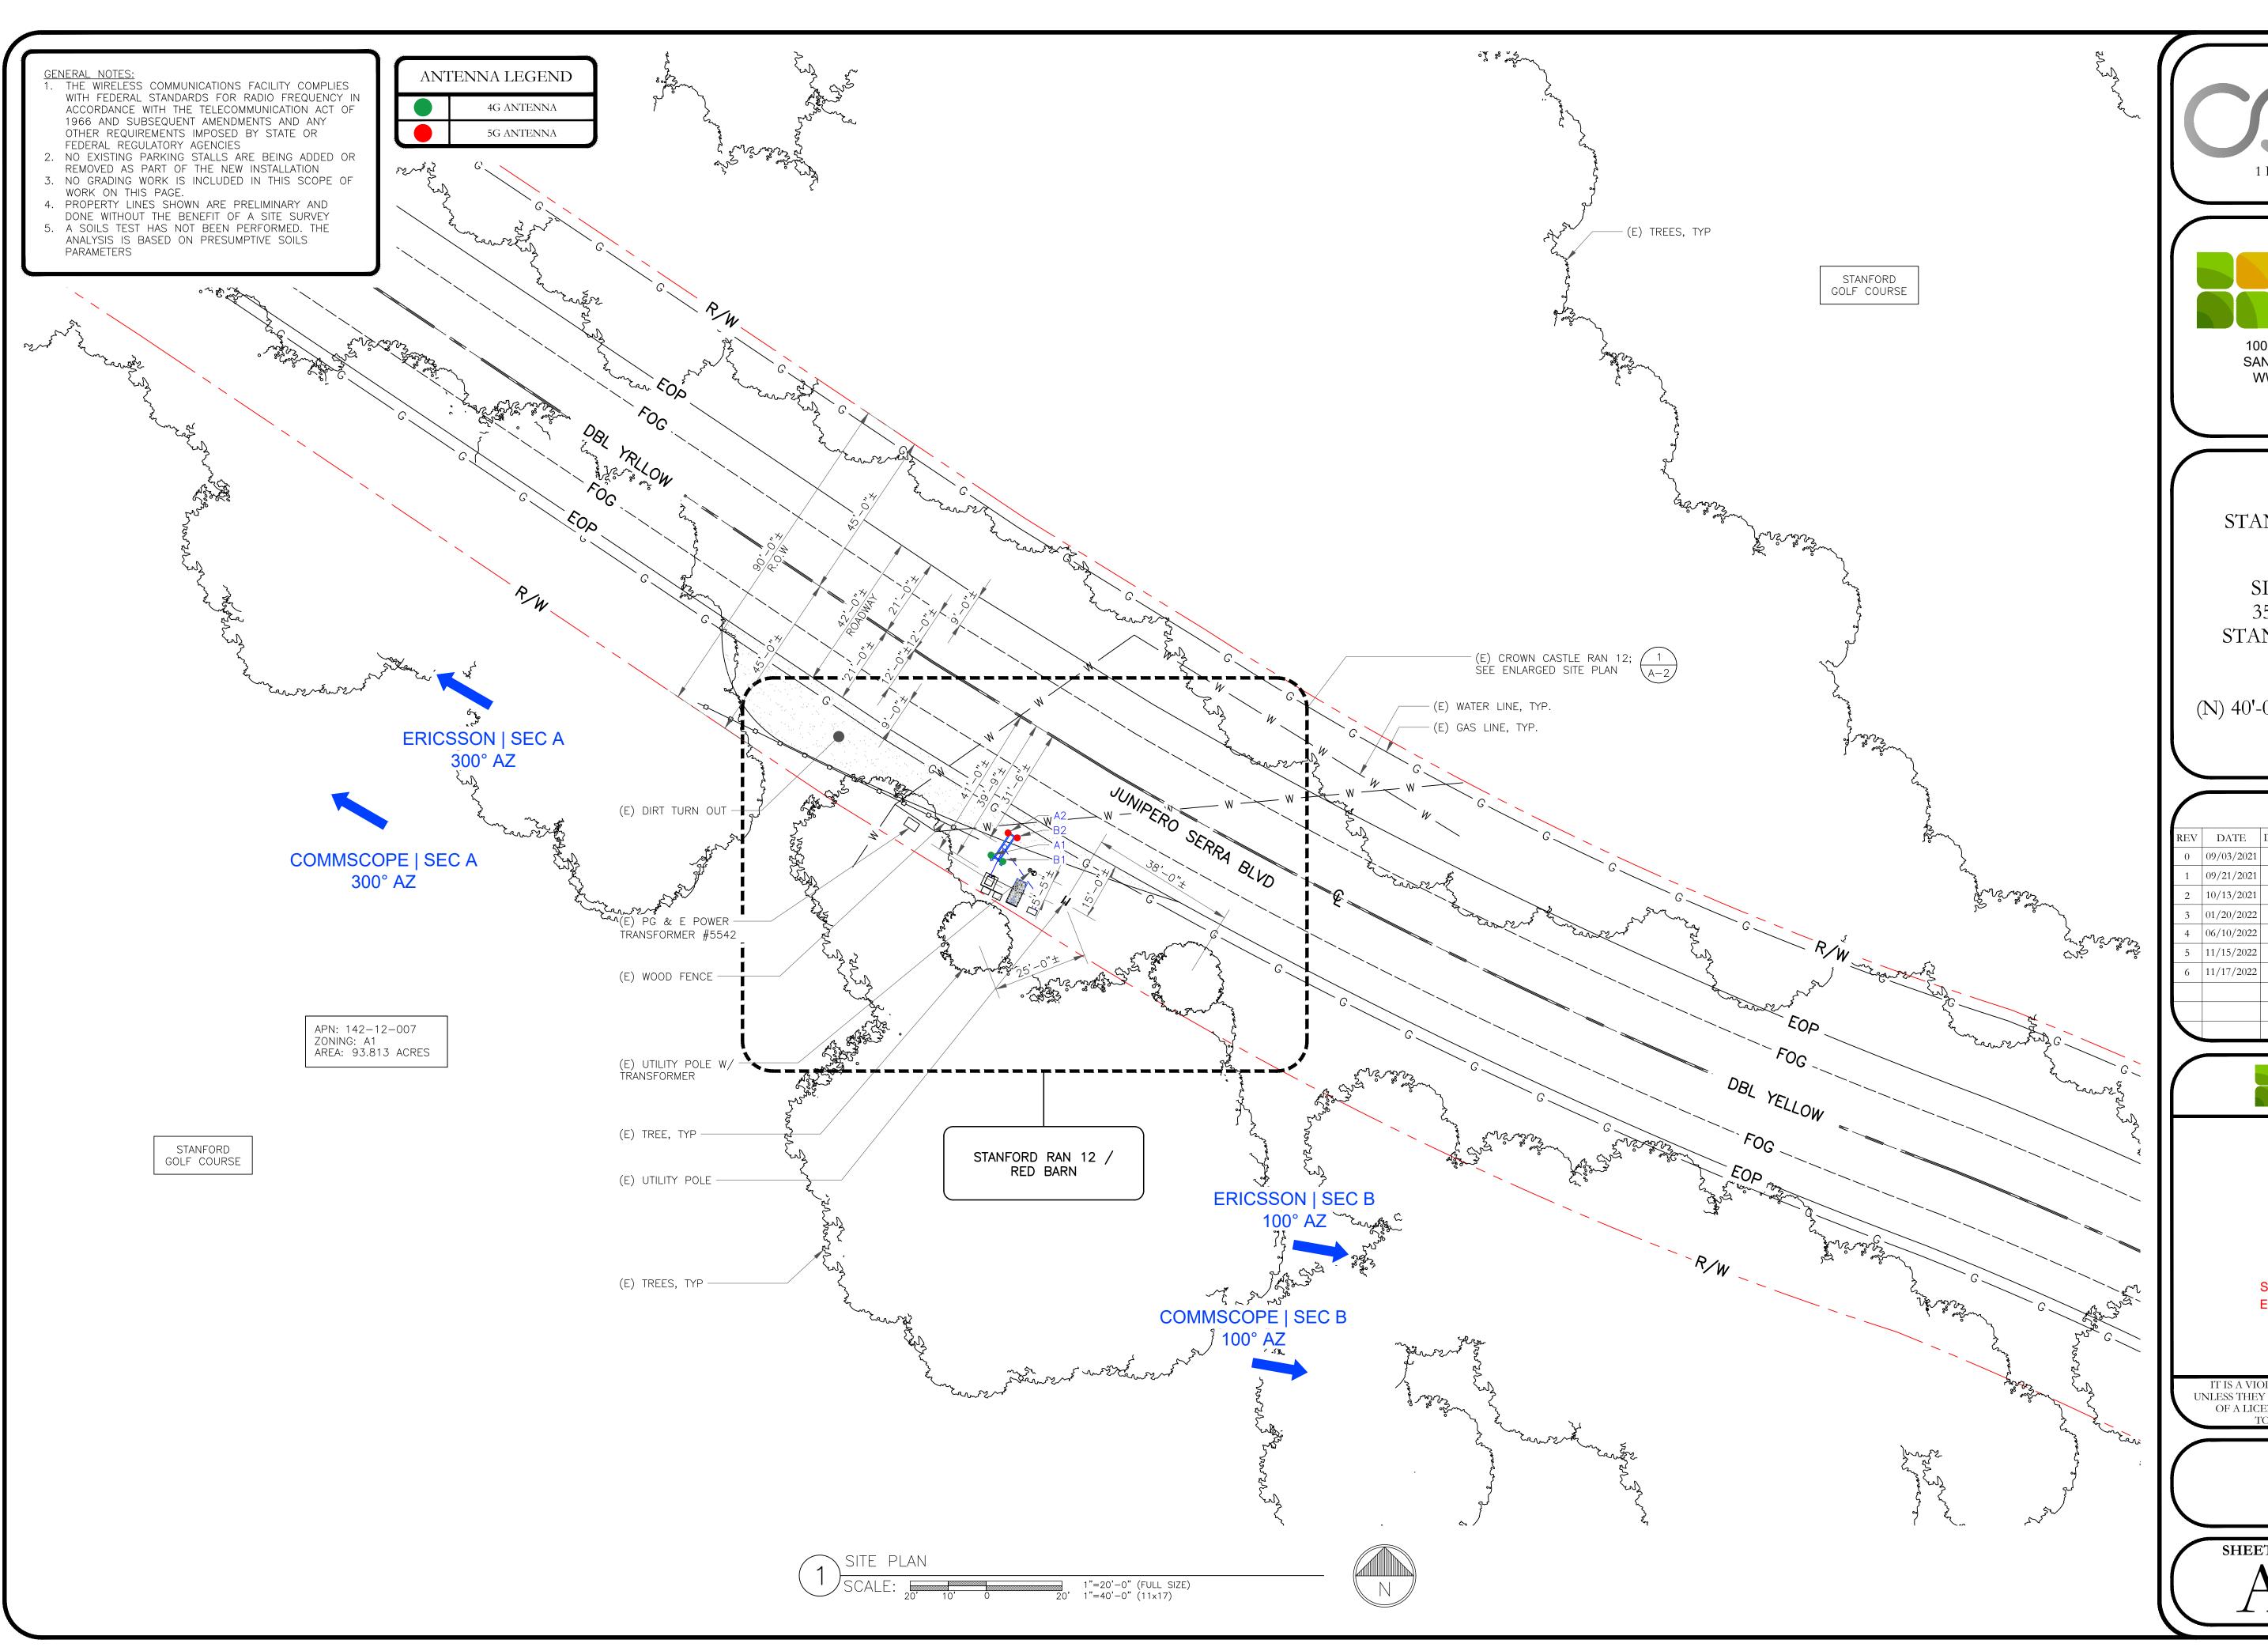





1000 CALLE CORDILLERA SAN CLEMENTE, CA 92673 WWW.LEAFCOMM.COM TEL: (949) 388-0192

SITE NAME: STANFORD RAN 12 / RED BARN

SITE ADDRESS: 35 VISTA LANE STANFORD, CA 94305

SITE TYPE: (N) 40'-0" JPA WOOD POLE

ISSUED FOR:

	REV	DATE	DRWN	DESCRIPTION	QA
	0	09/03/2021	MJC	90% CONSTRUCTION DWGS	CG
	1	09/21/2021	MJC	90% CD REVISION	CG
	2	10/13/2021	MJC	100% CONSTRUCTION DWGS	CG
	3	01/20/2022	СТ	100% CD CLIENT REVISION	CG
	4	06/10/2022	СТ	100% CD REVISIONS	CG
r r	5	11/15/2022	JG	100% CD REVISIONS	CG
	6	11/17/2022	СТ	100% CD REVISIONS	CG






SIGNED: 2022/11/17 EXPIRES: 2023/09/30

IT IS A VIOLATION OF LAW FOR ANY PERSON, UNLESS THEY ARE ACTING UNDER THE DIRECTION OF A LICENSED PROFESSIONAL ENGINEER, TO ALTER THIS DOCUMENT.

> SHEET TITLE: SITE PLAN

SHEET NUMBER:

-1 (6

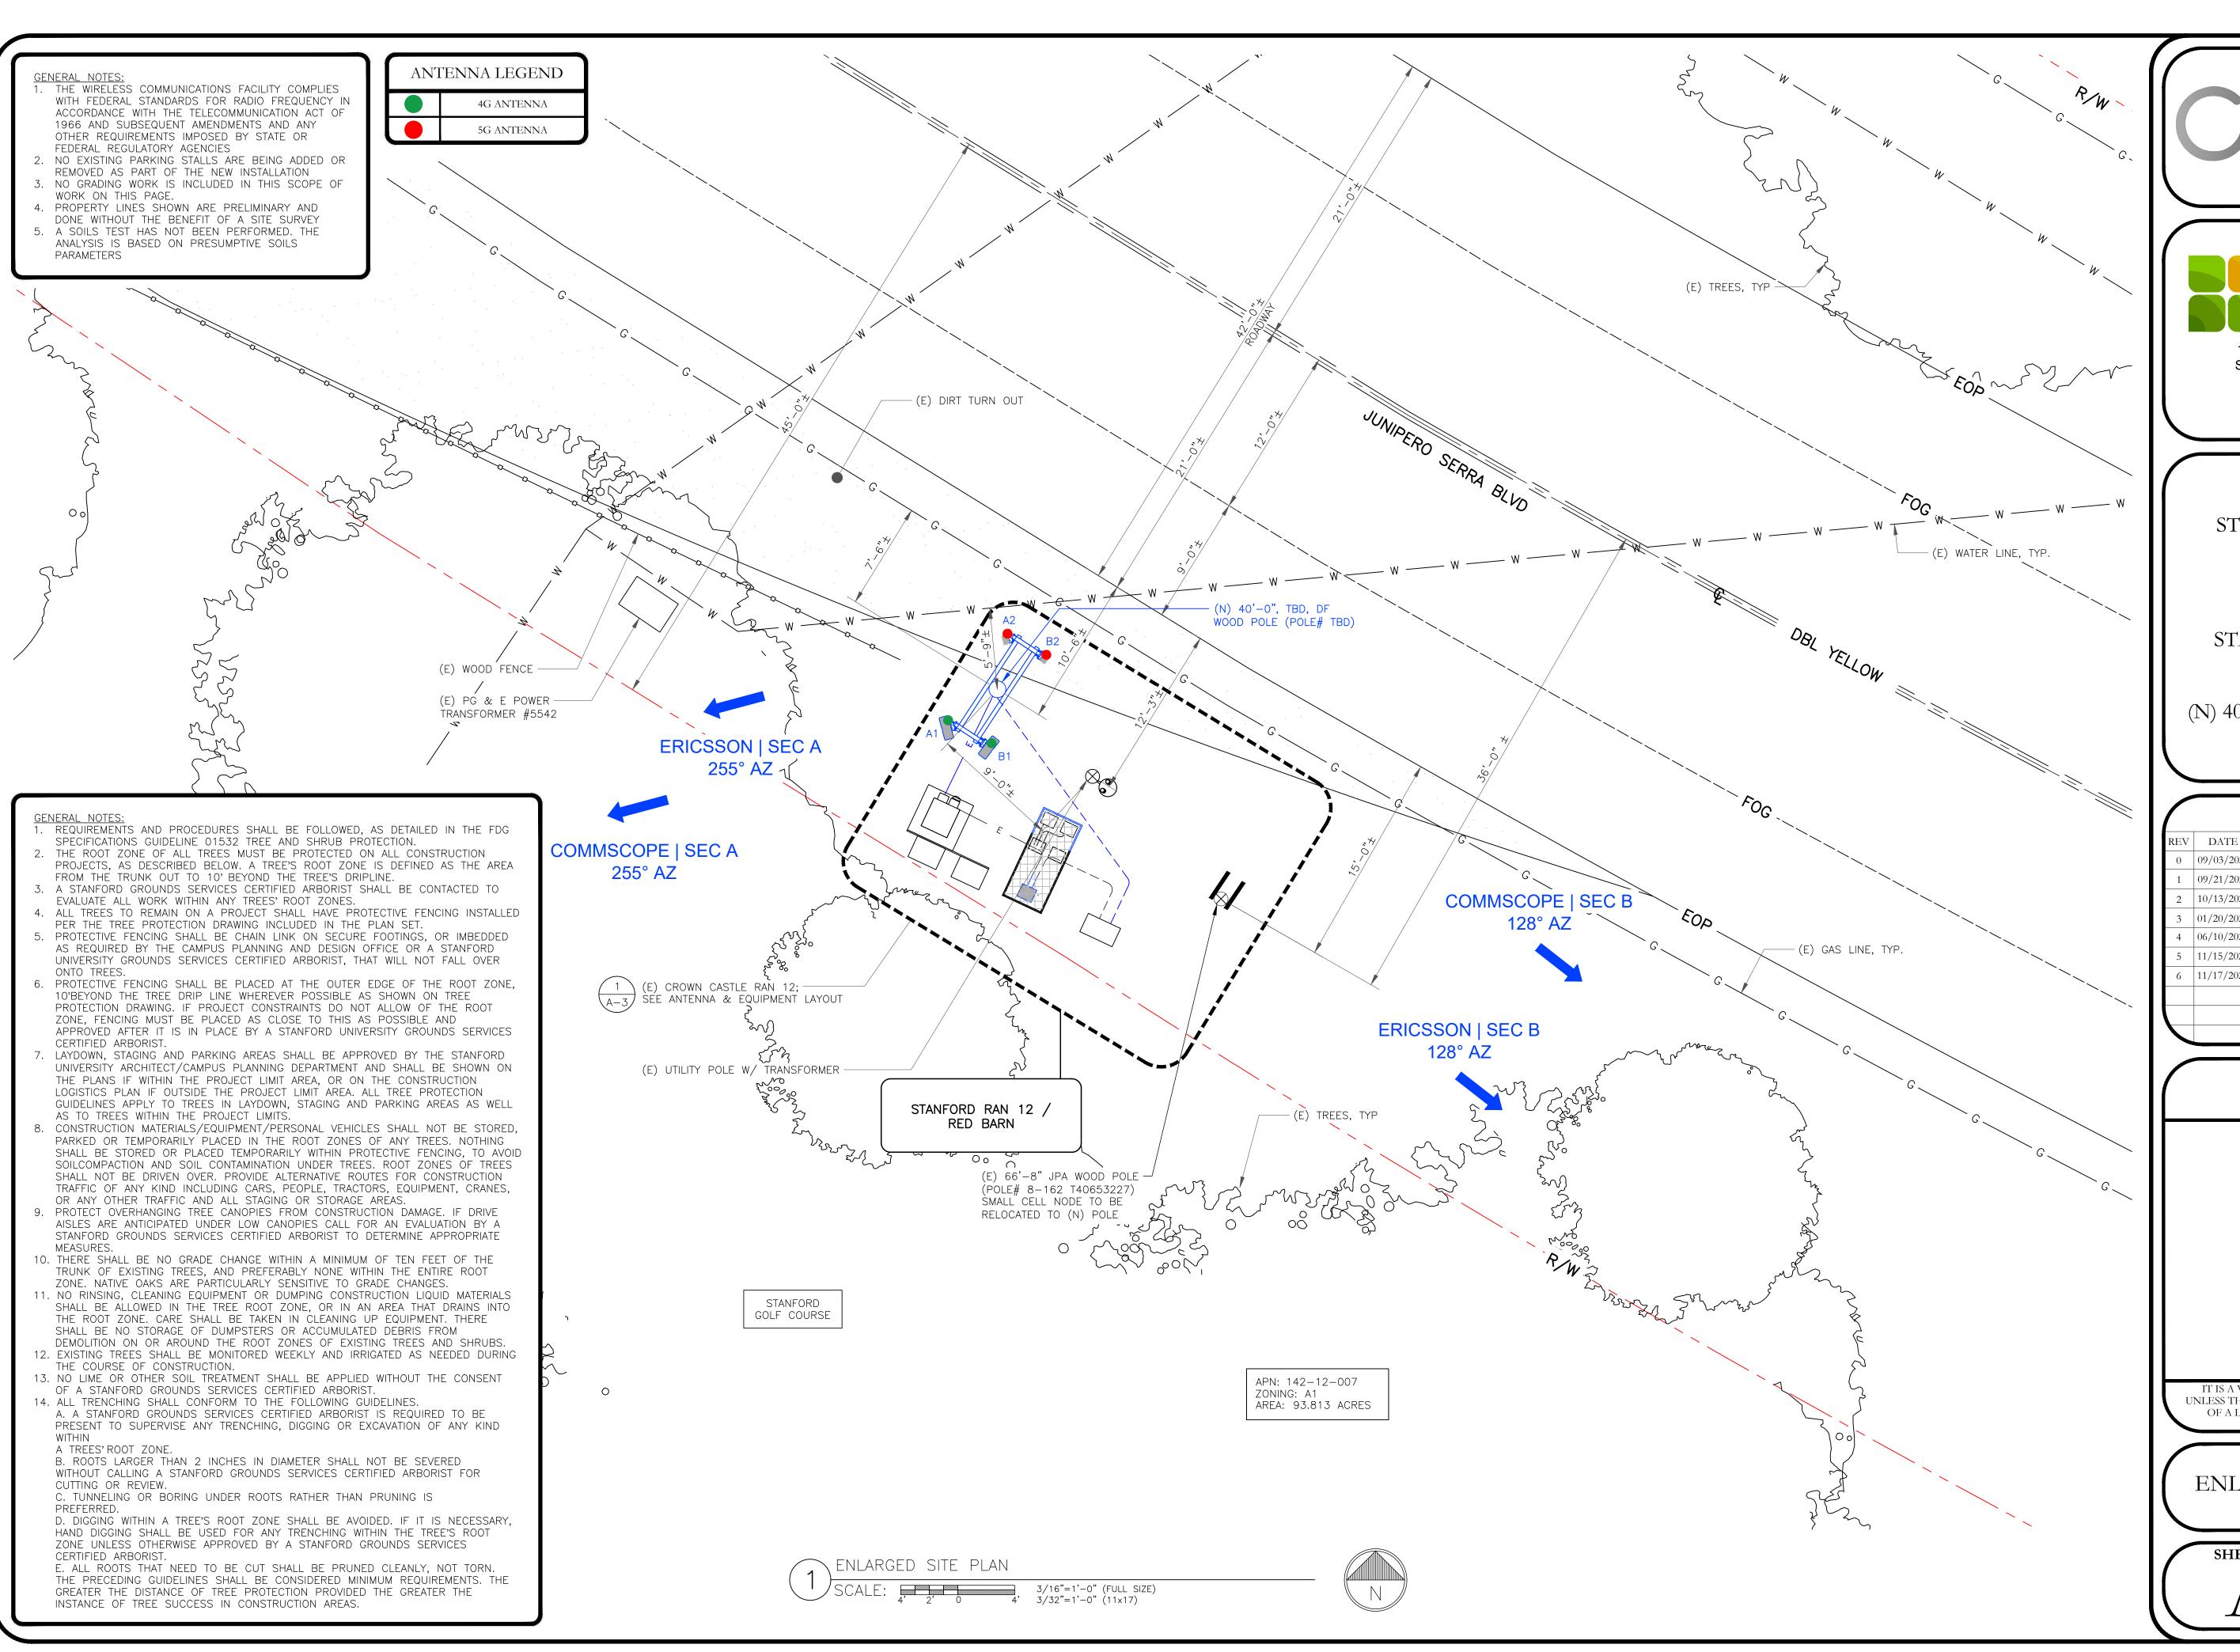





1000 CALLE CORDILLERA SAN CLEMENTE, CA 92673 WWW.LEAFCOMM.COM TEL: (949) 388-0192

SITE NAME: STANFORD RAN 12 / RED BARN

SITE ADDRESS: 35 VISTA LANE STANFORD, CA 94305

SITE TYPE: (N) 40'-0" JPA WOOD POLE

ISSUED FOR:

REV	DATE	DRWN	DESCRIPTION	QA
0	09/03/2021	MJC	90% CONSTRUCTION DWGS	CG
1	09/21/2021	MJC	90% CD REVISION	CG
2	10/13/2021	MJC	100% CONSTRUCTION DWGS	CG
3	01/20/2022	СТ	100% CD CLIENT REVISION	CG
4	06/10/2022	СТ	100% CD REVISIONS	CG
5	11/15/2022	JG	100% CD REVISIONS	CG
6	11/17/2022	СТ	100% CD REVISIONS	CG
T				






EXPIRES: 2023/09/30

IT IS A VIOLATION OF LAW FOR ANY PERSON, UNLESS THEY ARE ACTING UNDER THE DIRECTION OF A LICENSED PROFESSIONAL ENGINEER, TO ALTER THIS DOCUMENT.

SHEET TITLE:
ENLARGED SITE PLAN

SHEET NUMBER:

-2 (6

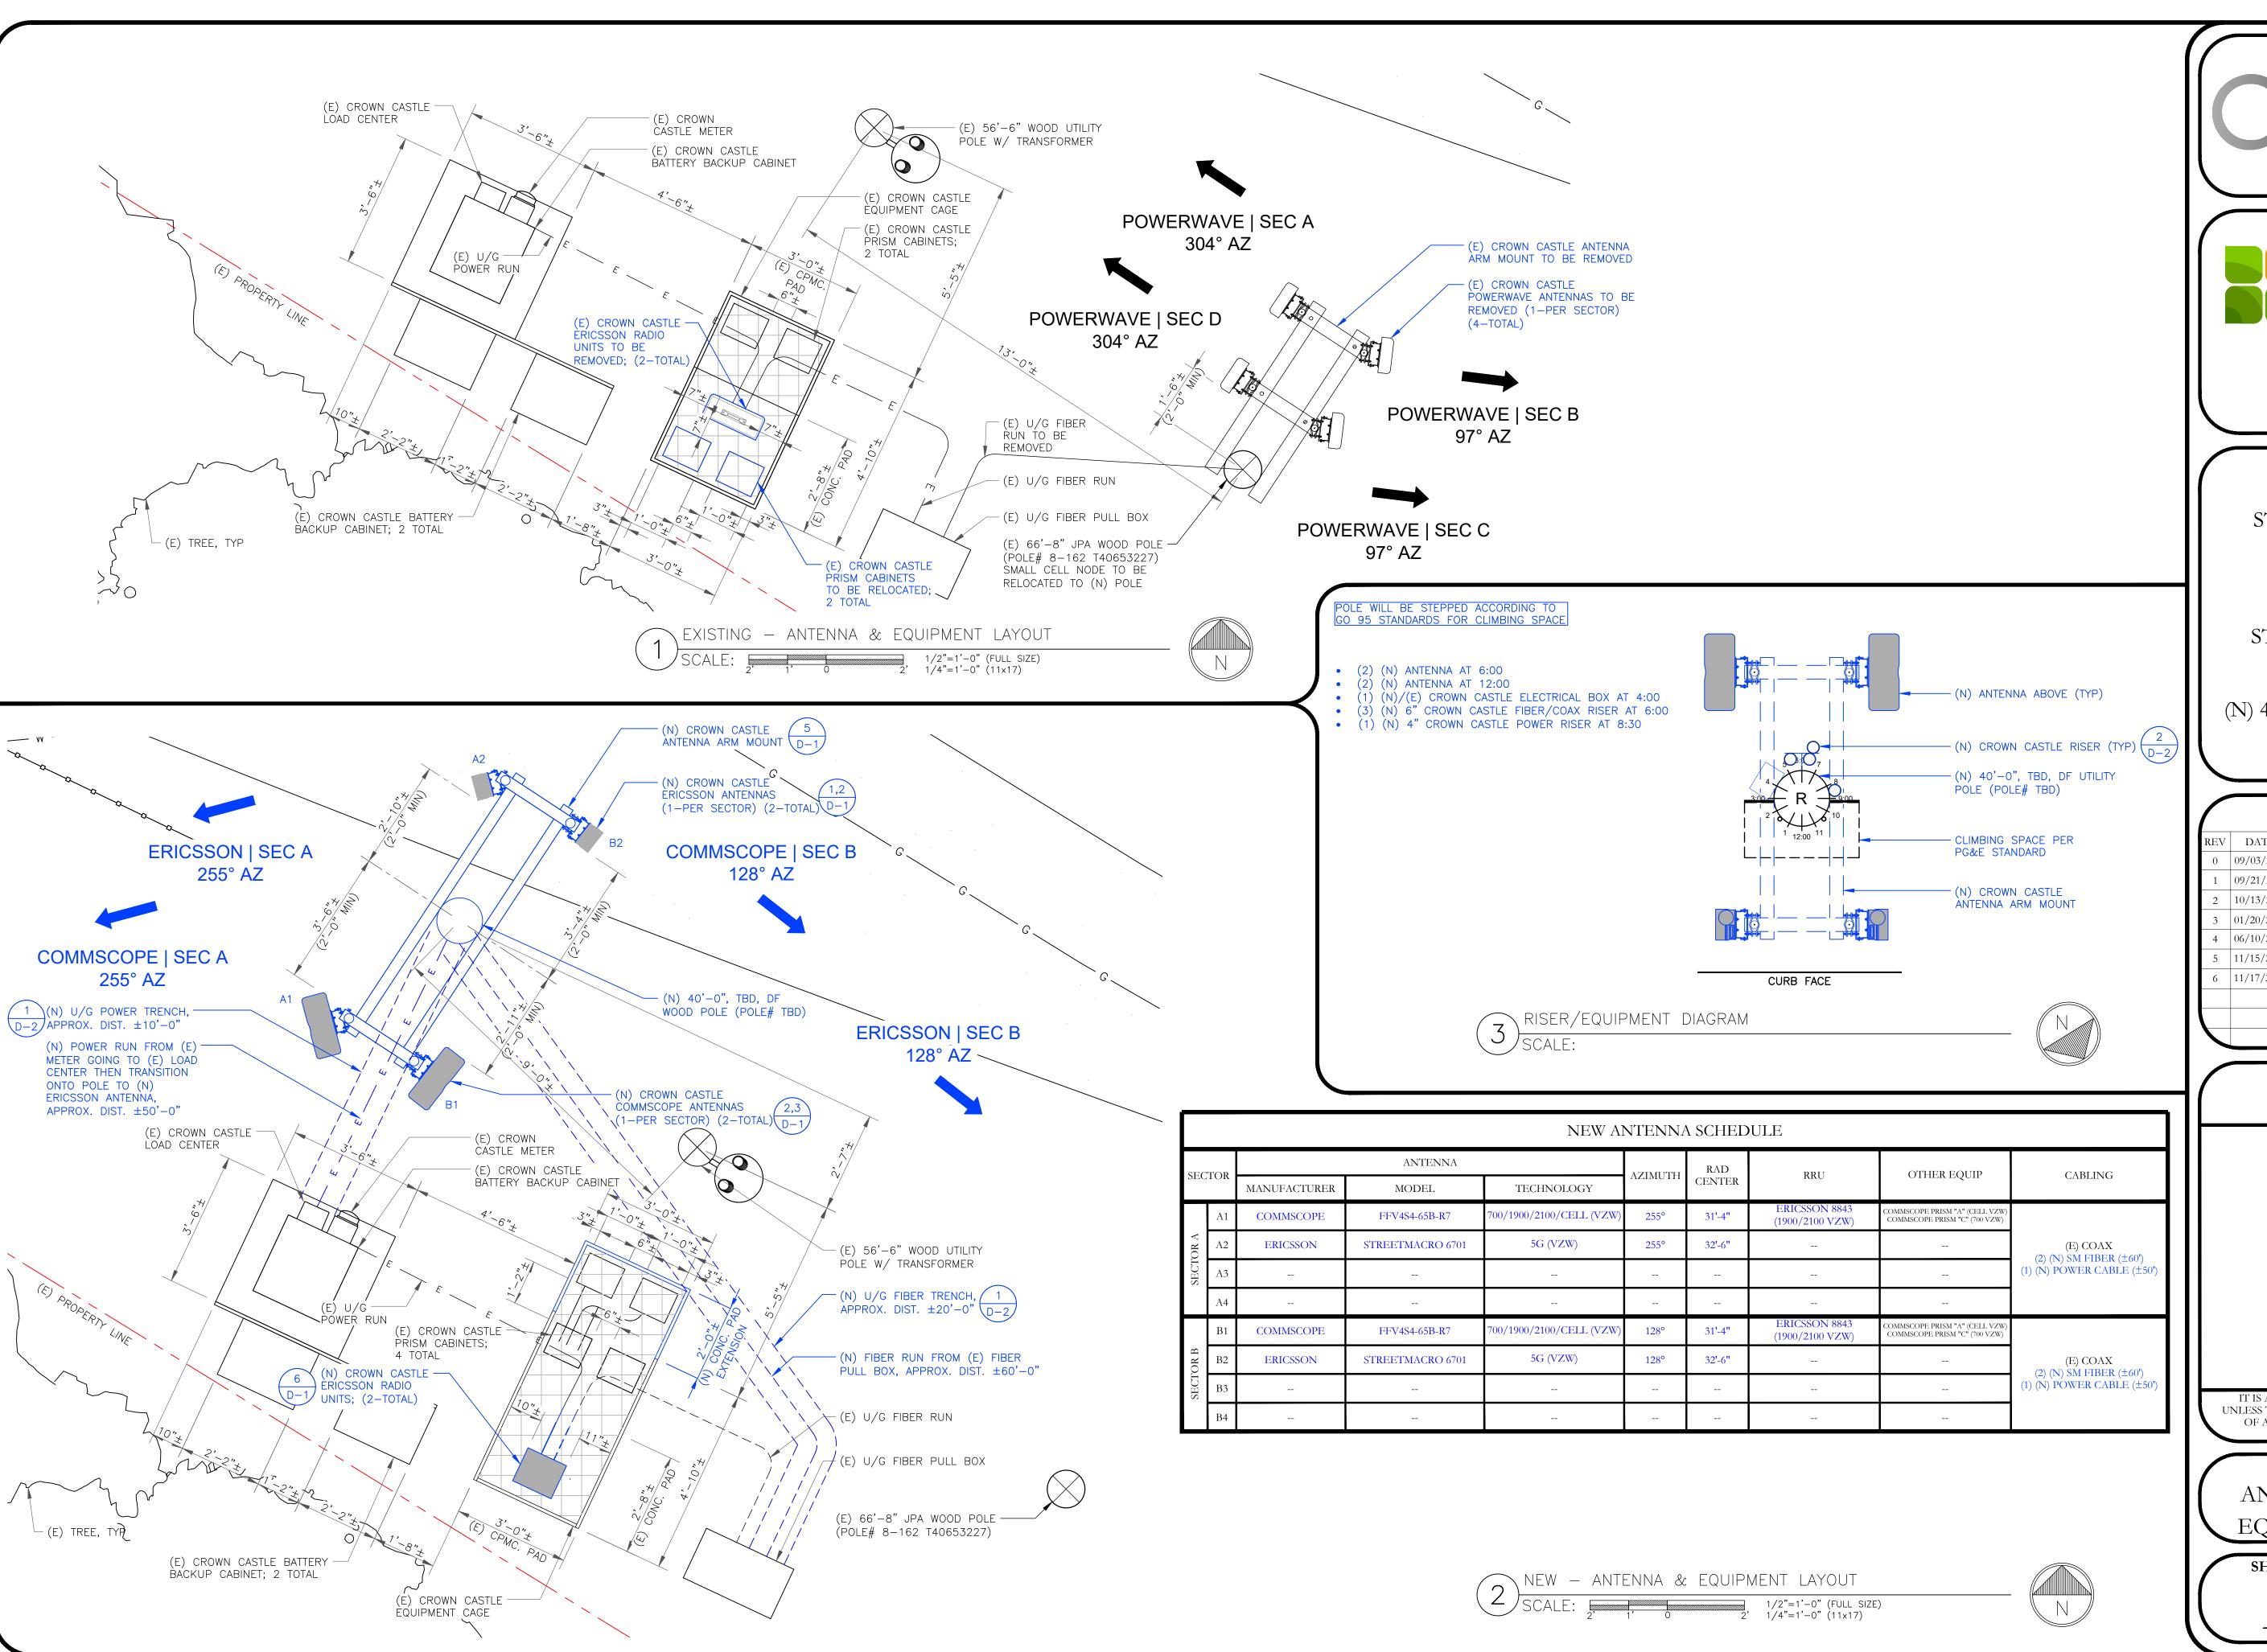





1000 CALLE CORDILLERA SAN CLEMENTE, CA 92673 WWW.LEAFCOMM.COM TEL: (949) 388-0192

SITE NAME: STANFORD RAN 12 / RED BARN

SITE ADDRESS: 35 VISTA LANE STANFORD, CA 94305

SITE TYPE: (N) 40'-0" JPA WOOD POLE

ISSUED FOR:						
EV	DATE	DRWN	DESCRIPTION	QA		
0	09/03/2021	MJC	90% CONSTRUCTION DWGS	CG		
1	09/21/2021	MJC	90% CD REVISION	CG		
2	10/13/2021	MJC	100% CONSTRUCTION DWGS	CG		
3	01/20/2022	СТ	100% CD CLIENT REVISION	CG		
4	06/10/2022	СТ	100% CD REVISIONS	CG		
5	11/15/2022	JG	100% CD REVISIONS	CG		
6	11/17/2022	СТ	100% CD REVISIONS	CG		







EXPIRES: 2023/09/30

IT IS A VIOLATION OF LAW FOR ANY PERSON, UNLESS THEY ARE ACTING UNDER THE DIRECTION OF A LICENSED PROFESSIONAL ENGINEER, TO ALTER THIS DOCUMENT.

SHEET TITLE: ANTENNA LAYOUT EQUIPMENT LAYOUT


SHEET NUMBER:

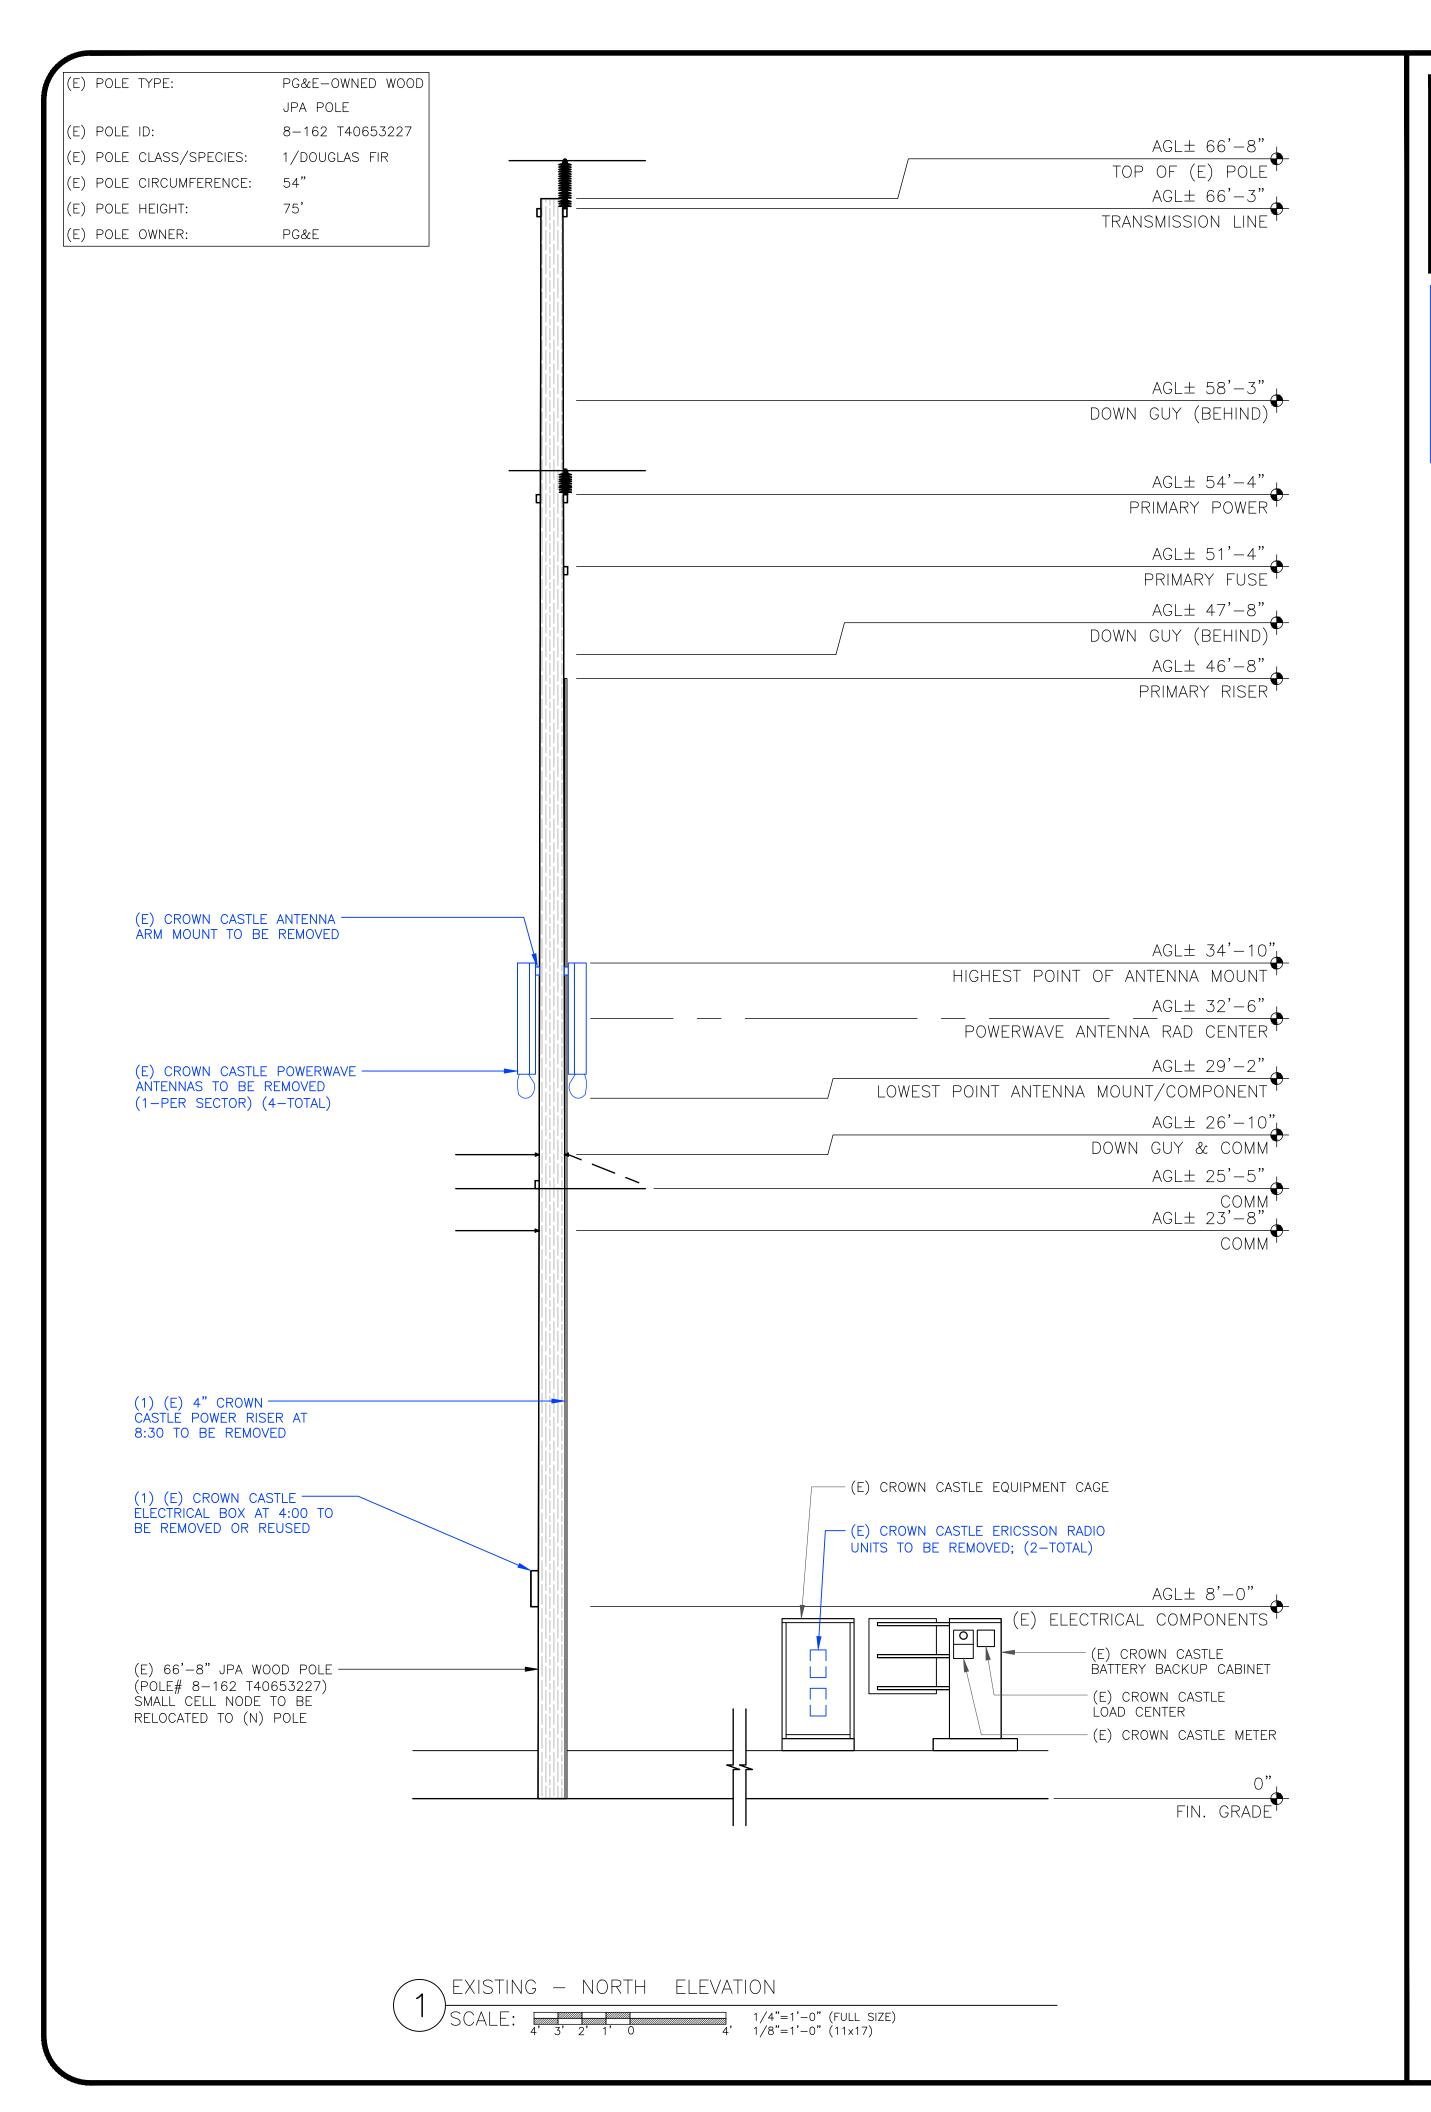

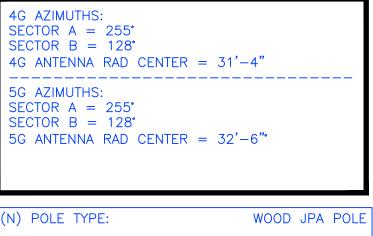

(N) POLE TYPE: WOOD JPA POLE
(N) POLE LENGTH / CLASS: 40' / 2
(N) POLE SPECIES: DOUGLAS FIR
(N) SETTING DEPTH: 5'
(N) POLE G/L CIRCUMFERENCE: 38.90"
(N) POLE HEIGHT: 35' AGL
(N) POLE OWNER: CROWN CASTLE

APPROX. DIST. $\pm 50'-0$ "

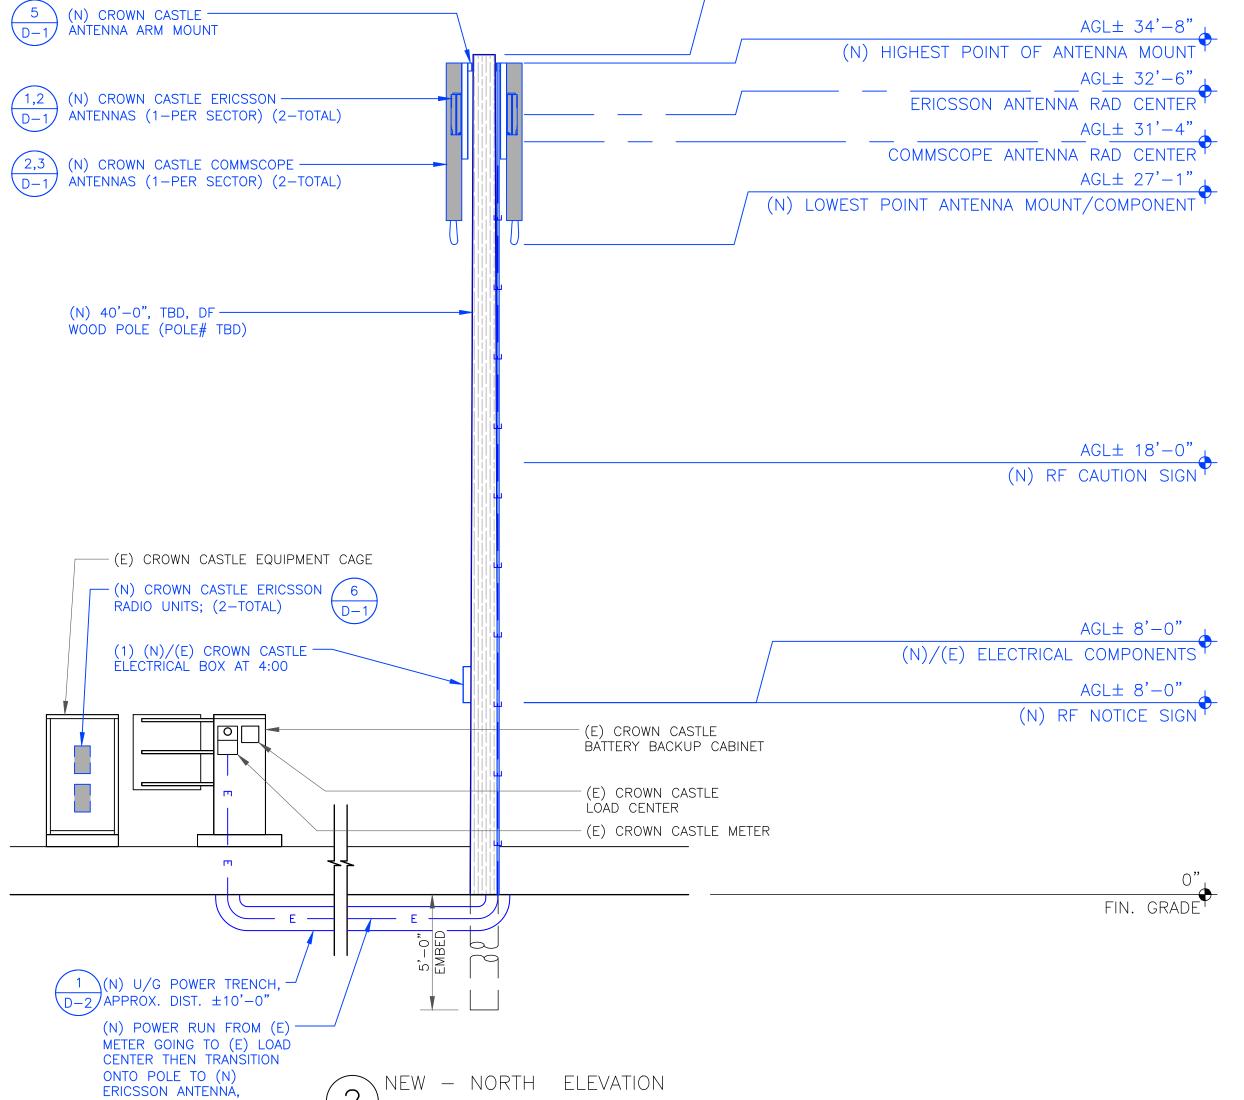





1000 CALLE CORDILLERA SAN CLEMENTE, CA 92673 WWW.LEAFCOMM.COM TEL: (949) 388-0192

SITE NAME: STANFORD RAN 12 / RED BARN

SITE ADDRESS: 35 VISTA LANE STANFORD, CA 94305

SITE TYPE: (N) 40'-0" JPA WOOD POLE

AGL± 35'-0"
TOP OF (N) POLE

ISSUED FOR:

REV	DATE	DRWN	DESCRIPTION	QA
0	09/03/2021	MJC	90% CONSTRUCTION DWGS	CG
1	09/21/2021	MJC	90% CD REVISION	CG
2	10/13/2021	MJC	100% CONSTRUCTION DWGS	CG
3	01/20/2022	СТ	100% CD CLIENT REVISION	CG
4	06/10/2022	СТ	100% CD REVISIONS	CG
5	11/15/2022	JG	100% CD REVISIONS	CG
6	11/17/2022	СТ	100% CD REVISIONS	CG







EXPIRES: 2023/09/30

IT IS A VIOLATION OF LAW FOR ANY PERSON, UNLESS THEY ARE ACTING UNDER THE DIRECTION OF A LICENSED PROFESSIONAL ENGINEER, TO ALTER THIS DOCUMENT.

> SHEET TITLE: ELEVATIONS

SHEET NUMBER:

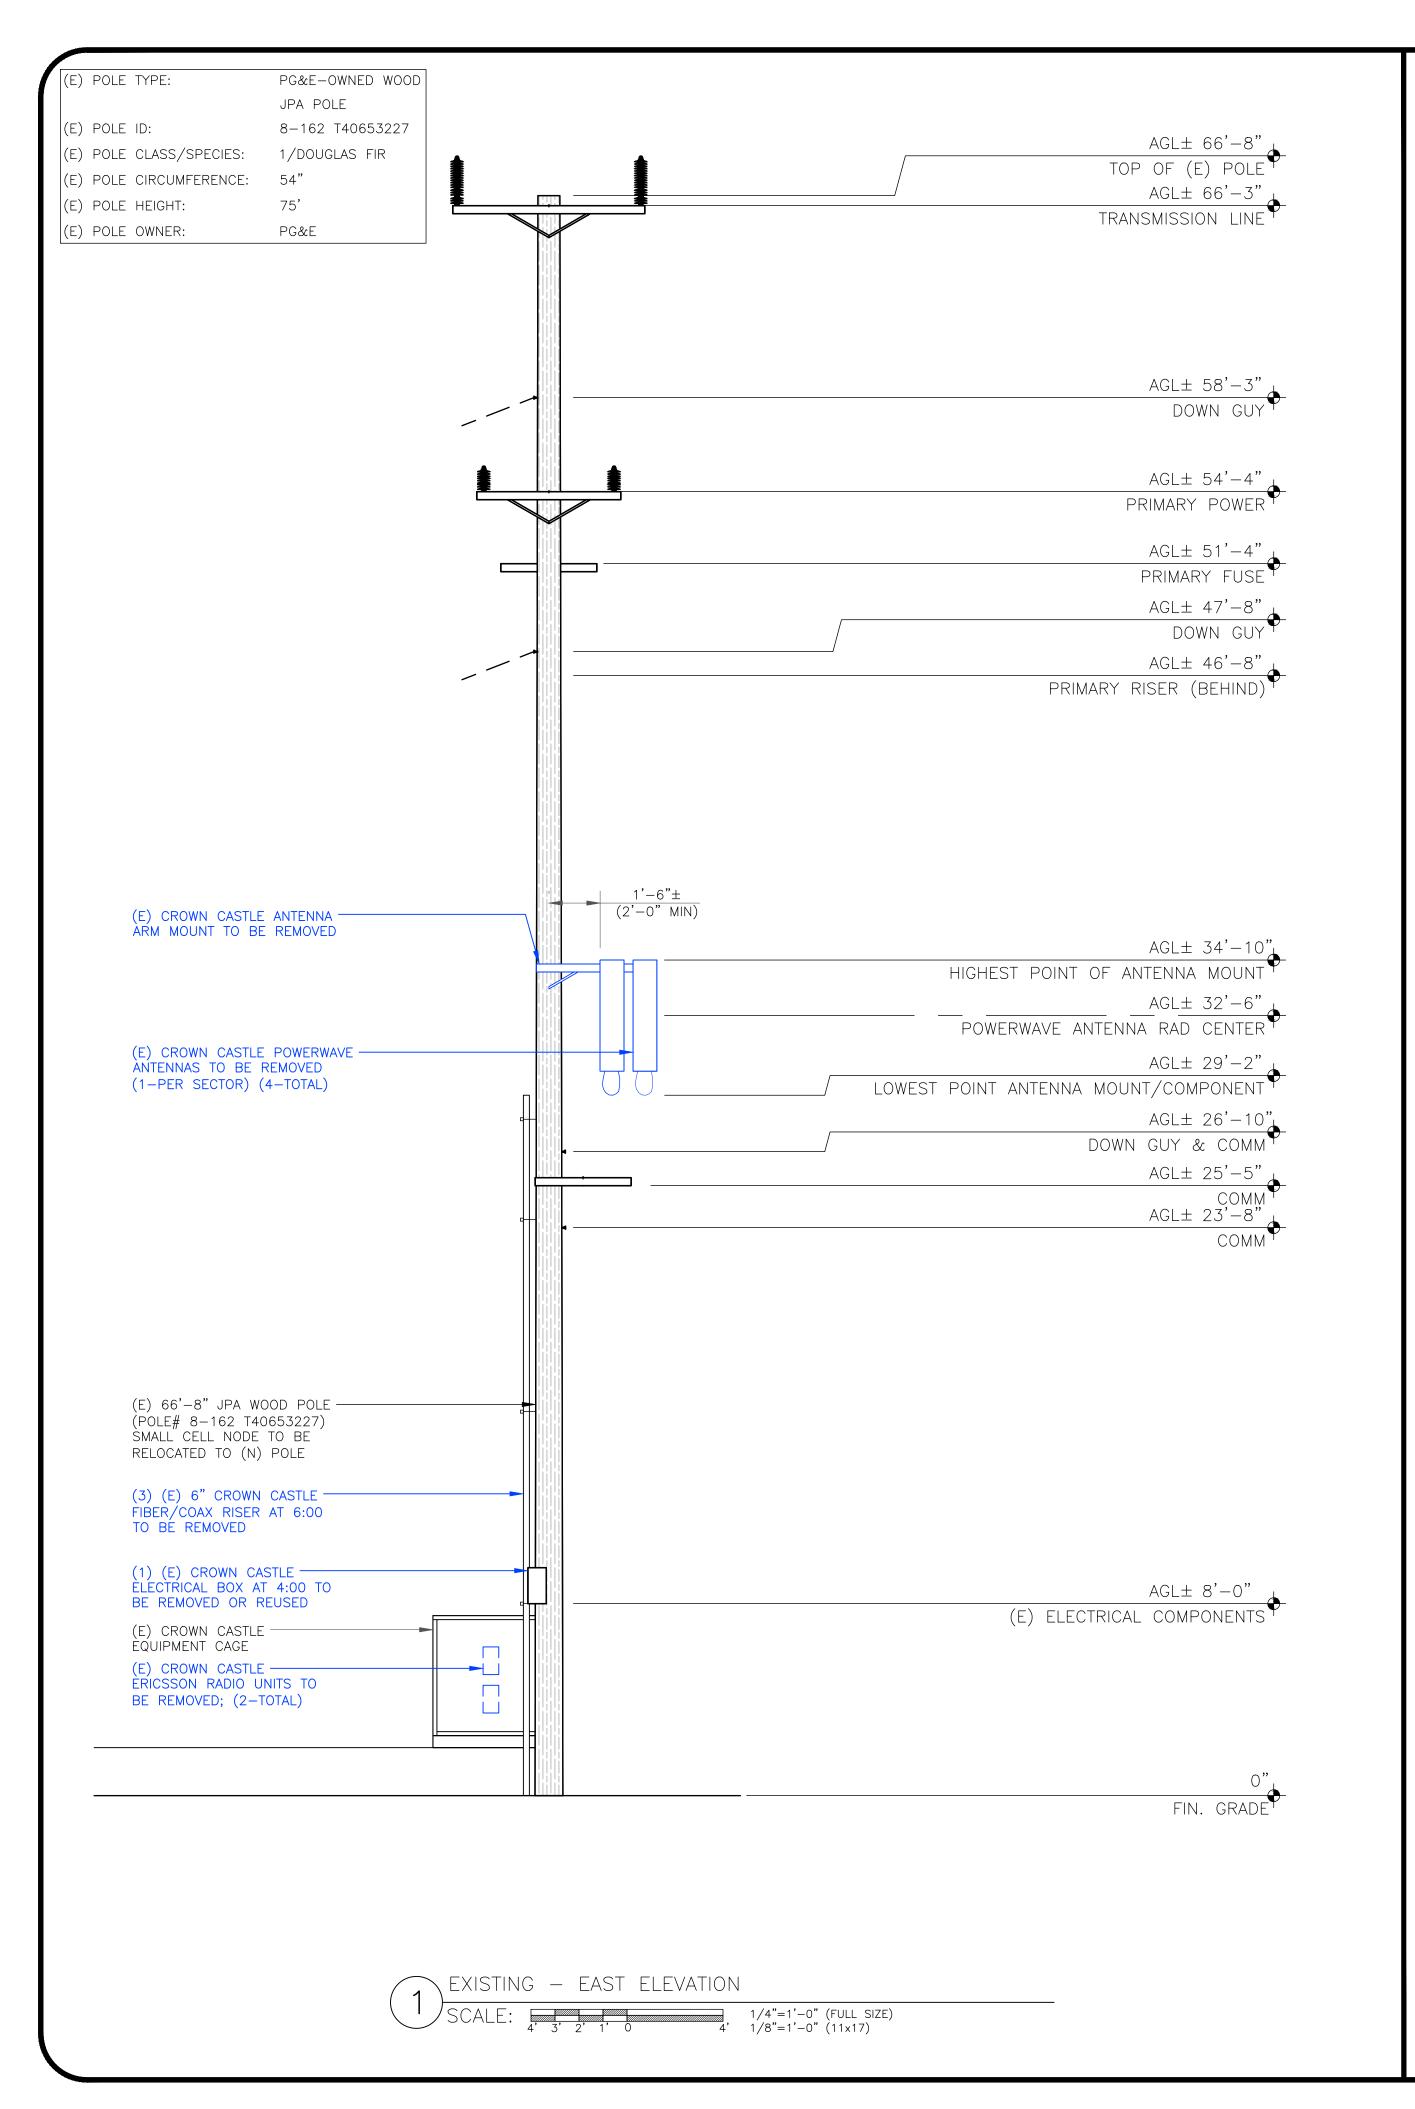

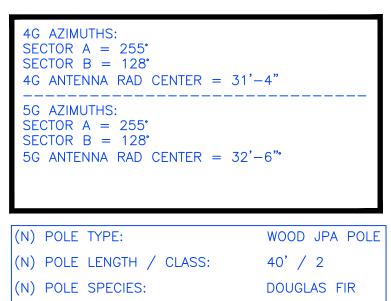

38.90"

35' AGL


CROWN CASTLE

(N) SETTING DEPTH:

(N) POLE HEIGHT:

(N) POLE OWNER:

(N) POLE G/L CIRCUMFERENCE:

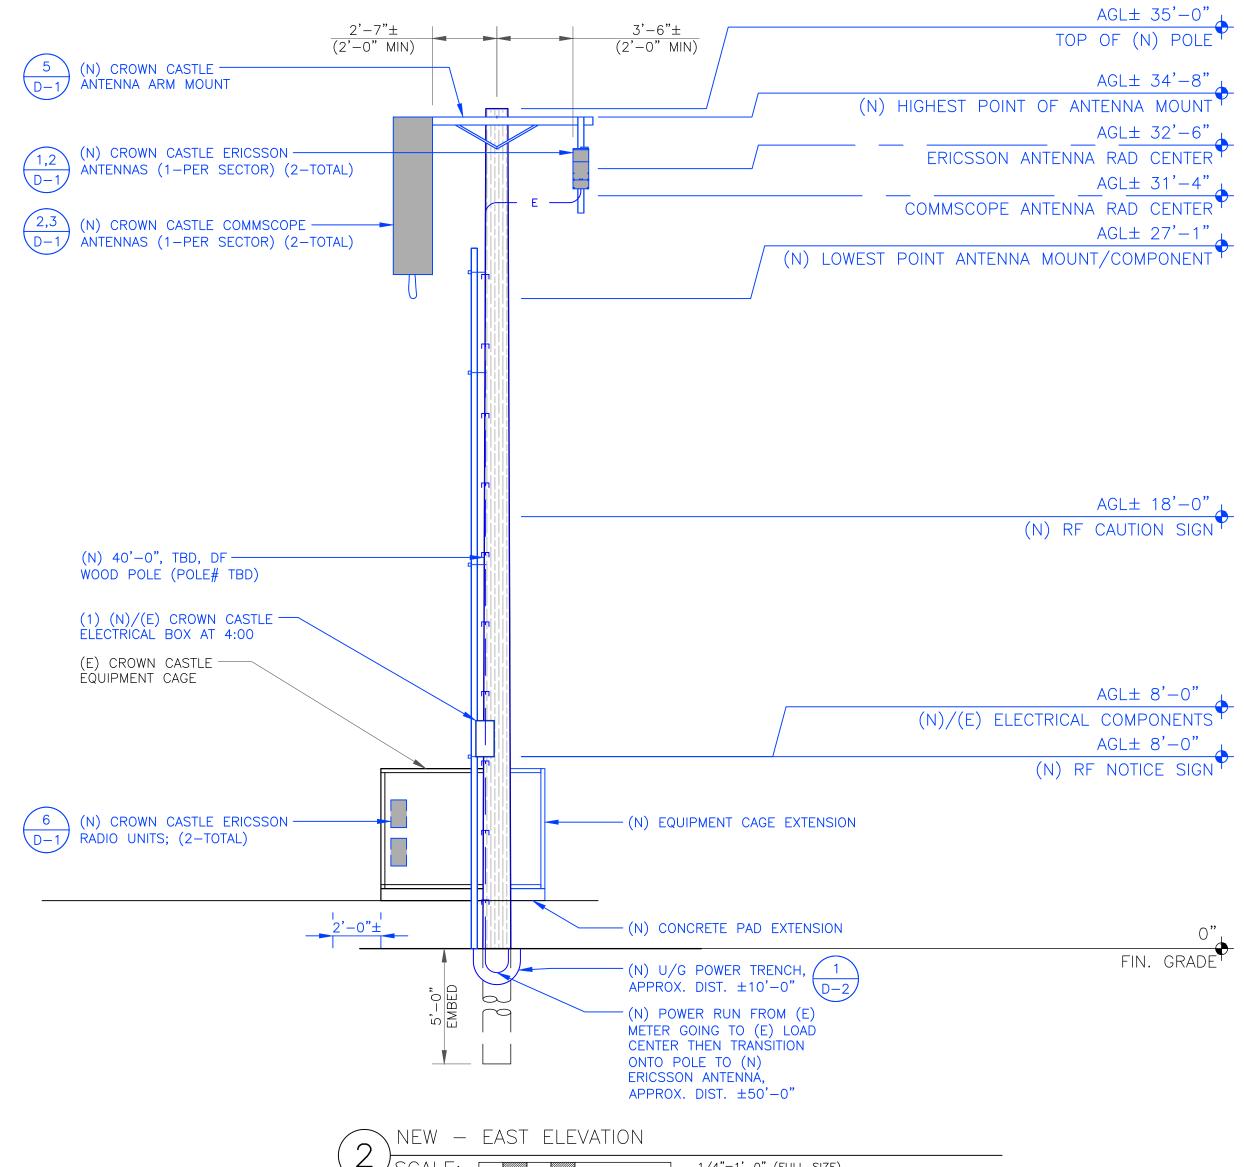





1000 CALLE CORDILLERA SAN CLEMENTE, CA 92673 WWW.LEAFCOMM.COM TEL: (949) 388-0192

SITE NAME: STANFORD RAN 12 / RED BARN

SITE ADDRESS: 35 VISTA LANE STANFORD, CA 94305

SITE TYPE: (N) 40'-0" JPA WOOD POLE

ISSUED FOR:

REV	DATE	DRWN	DESCRIPTION	QA
0	09/03/2021	MJC	90% CONSTRUCTION DWGS	CG
1	09/21/2021	MJC	90% CD REVISION	CG
2	10/13/2021	MJC	100% CONSTRUCTION DWGS	CG
3	01/20/2022	СТ	100% CD CLIENT REVISION	CG
4	06/10/2022	СТ	100% CD REVISIONS	CG
5	11/15/2022	JG	100% CD REVISIONS	CG
6	11/17/2022	СТ	100% CD REVISIONS	CG






LAFINES. 2023/09/30

IT IS A VIOLATION OF LAW FOR ANY PERSON, UNLESS THEY ARE ACTING UNDER THE DIRECTION OF A LICENSED PROFESSIONAL ENGINEER, TO ALTER THIS DOCUMENT.

> SHEET TITLE: ELEVATIONS

SHEET NUMBER:



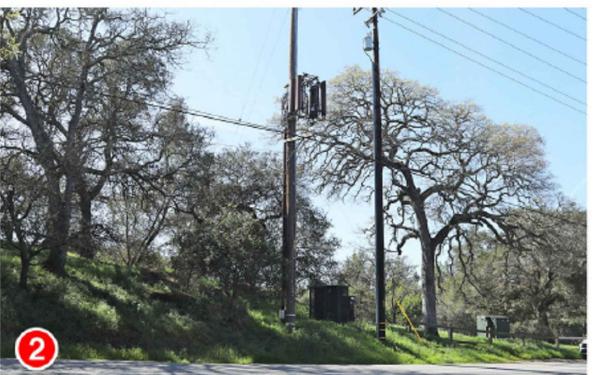





CROWN CASTLE 2/4/22

Stanford RAN 12 / Red Barn

160 Junipero Serra Blvd Stanford, CA

Applied Imagination 510 914-0500

Aerial Map





CROWN CASTLE 2/4/22

Stanford RAN 12 / Red Barn

160 Junipero Serra Blvd Stanford, CA Looking Northwest from Junipero Serra Blvd

View #1

Applied Imagination 510 914-0500









1000 CALLE CORDILLERA SAN CLEMENTE, CA 92673 WWW.LEAFCOMM.COM TEL: (949) 388-0192

SITE NAME: STANFORD RAN 12 / RED BARN

SITE ADDRESS: 35 VISTA LANE STANFORD, CA 94305

SITE TYPE: (N) 40'-0" JPA WOOD POLE

ISSUED FOR:

		133	OED FOR.	`
REV	DATE	DRWN	DESCRIPTION	QA
0	09/03/2021	MJC	90% CONSTRUCTION DWGS	CG
1	09/21/2021	MJC	90% CD REVISION	CG
2	10/13/2021	MJC	100% CONSTRUCTION DWGS	CG
3	01/20/2022	СТ	100% CD CLIENT REVISION	CG
4	06/10/2022	СТ	100% CD REVISIONS	CG
5	11/15/2022	JG	100% CD REVISIONS	CG
6	11/17/2022	СТ	100% CD REVISIONS	CG






SIGNED: 2022/11/17 EXPIRES: 2023/09/30

IT IS A VIOLATION OF LAW FOR ANY PERSON, UNLESS THEY ARE ACTING UNDER THE DIRECTION OF A LICENSED PROFESSIONAL ENGINEER, TO ALTER THIS DOCUMENT.

SHEET TITLE:
PHOTO SIMULATION

SHEET NUMBER:

6

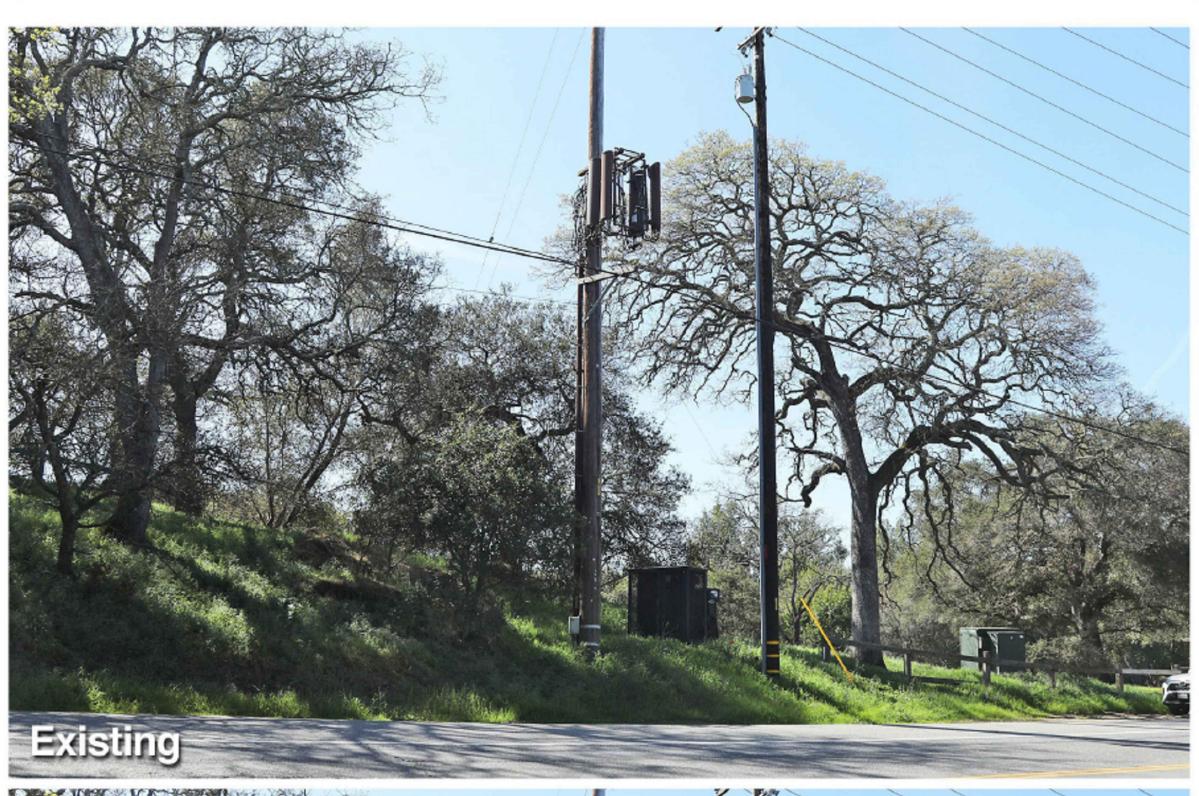



CROWN CASTLE 2/4/22


Stanford RAN 12 / Red Barn


Luninora Carra Plud

160 Junipero Serra Blvd Stanford, CA Looking Northwest from Junipero Serra Blvd

View #2

Applied Imagination 510 914-0500

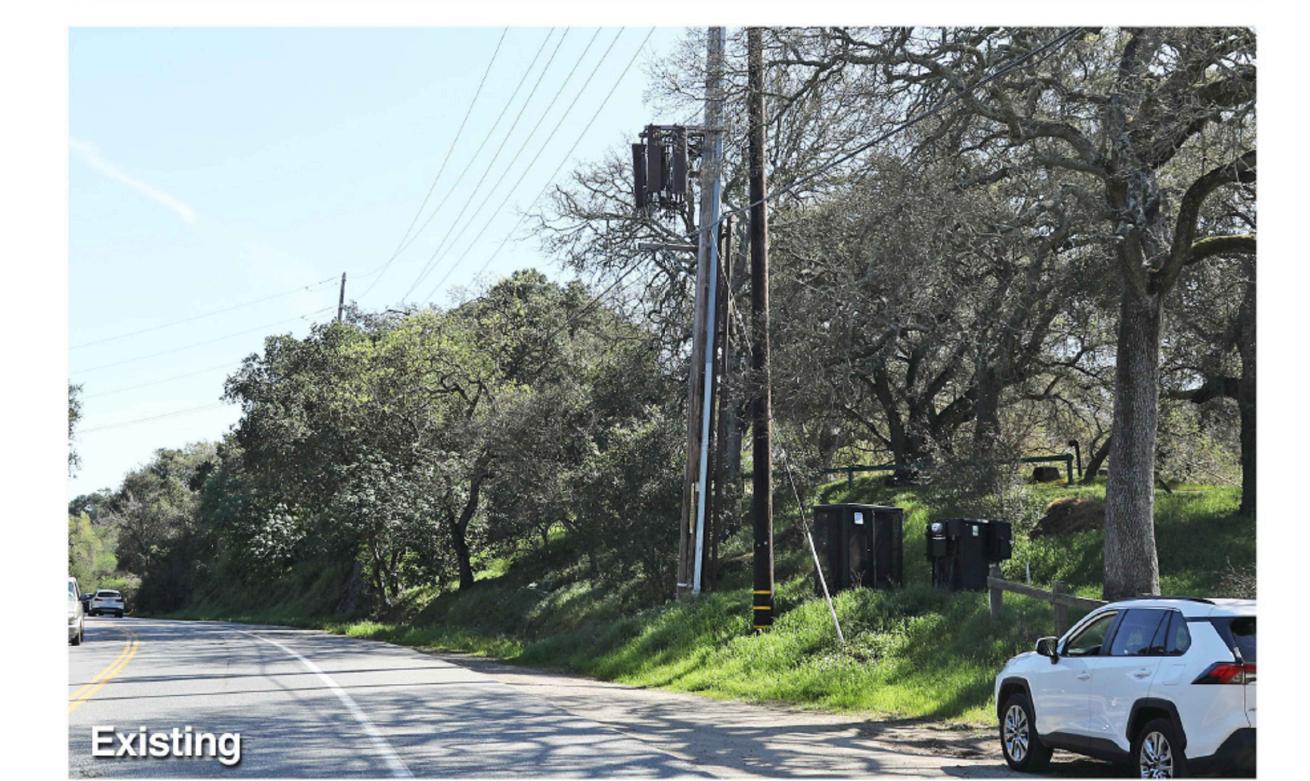

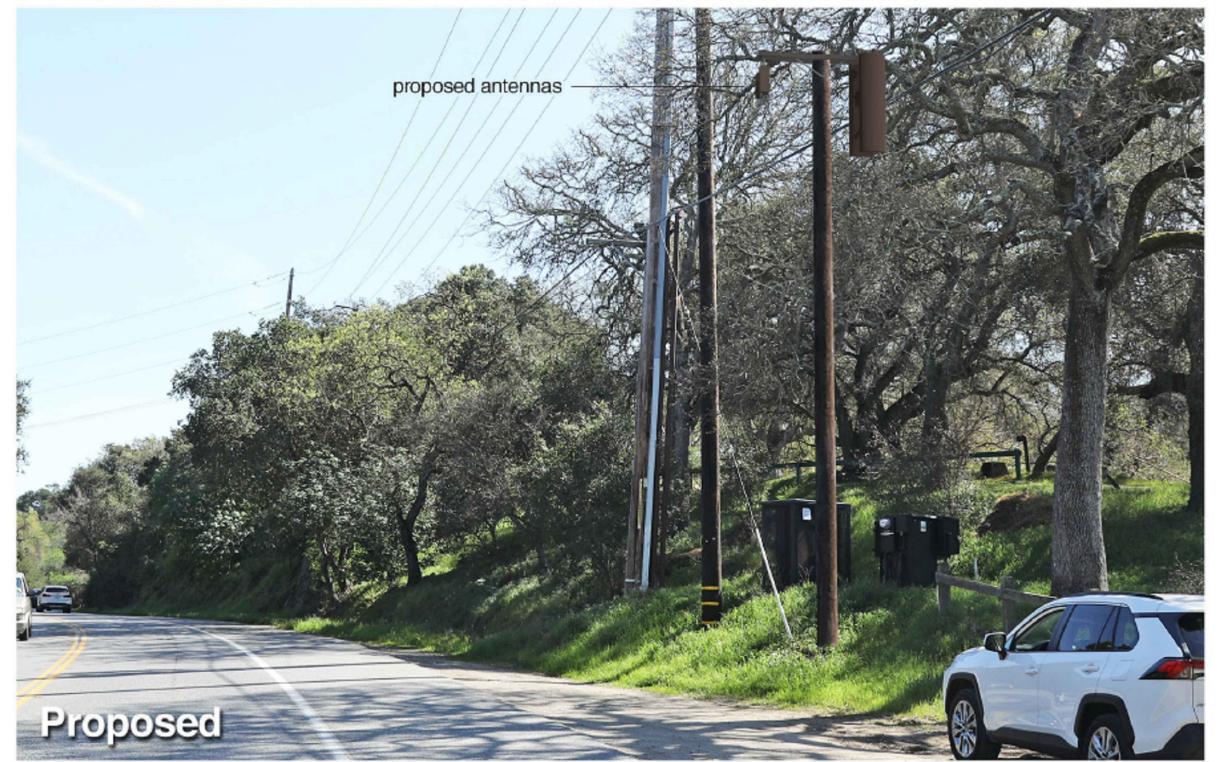

CROWN CASTLE 2/4/22

Stanford RAN 12 / Red Barn

160 Junipero Serra Blvd Stanford, CA Looking South from Junipero Serra Blvd

View #3
Applied Imagination 510 914-0500

SHEET TITLE:

SIGNED: 2022/11/17 EXPIRES: 2023/09/30

UNLESS THEY ARE ACTING UNDER THE DIRECTION OF A LICENSED PROFESSIONAL ENGINEER, TO ALTER THIS DOCUMENT.

PHOTO SIMULATION

A-7

6 REV:

CROWN

1 PARK PLACE PLACE DUBLIN, CA 94568

1000 CALLE CORDILLERA SAN CLEMENTE, CA 92673 WWW.LEAFCOMM.COM TEL: (949) 388-0192

SITE NAME:

STANFORD RAN 12 /

RED BARN

SITE ADDRESS:

35 VISTA LANE

STANFORD, CA 94305

SITE TYPE:

(N) 40'-0" JPA WOOD POLE


ISSUED FOR:

09/03/2021 MJC 90% CONSTRUCTION DWGS

100% CD REVISIONS 100% CD REVISIONS

5 11/15/2022 JG


PHOTO SIMULATION - VIEW #3
SCALE: N.T.S

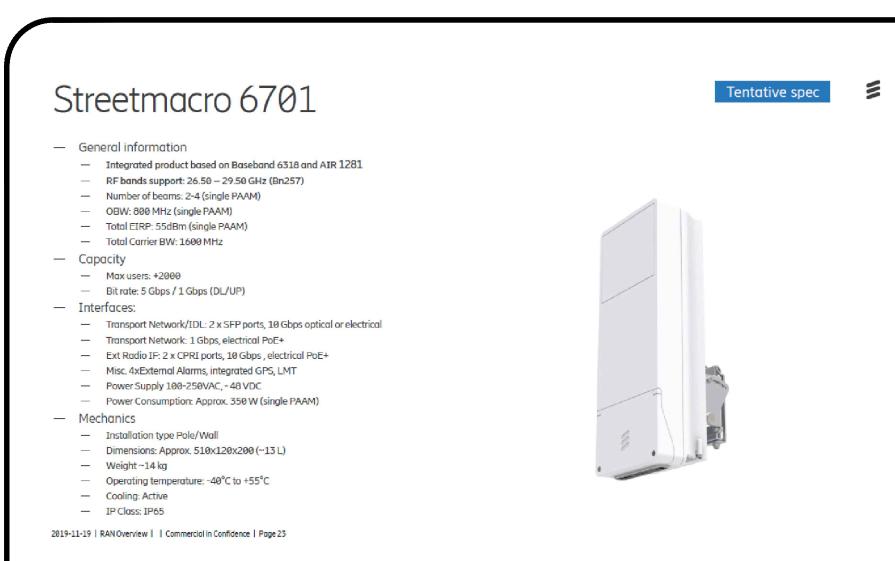

ERICSSON ANTENNA SPEC. SHEET SCALE: N.T.S

NOTE:

ALL PIPES BRACKETS AND MISCELLANEOUS HARDWARE TO BE GALVANIZED UNLESS NOTED OTHERWISE

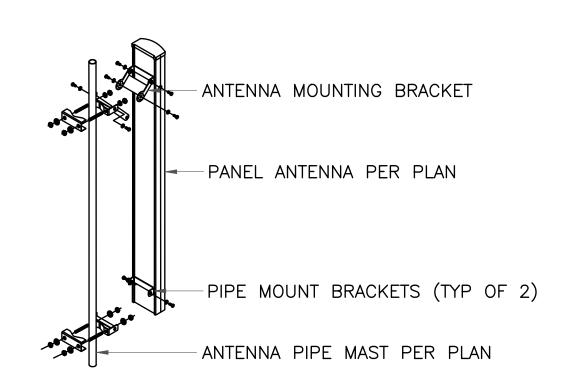



ANTENNA MOUNTING DETAIL

(3) SCALE: N.T.S

90° HPBW, 7x RET • All Internal RET actuators are connected in "Casc	1695-2690 MHz 65° HPBW and 8x 3300-3800 MHz,		
90° HPBW, 7x RET • All Internal RET actuators are connected in "Casc	1695-2690 MHz 65° HPBW and 8x 3300-3800 MHz,		
 Gluster connectors for the beam-forming array, if 	aded SRET' configuration scluding eight RF ports plus one calibration port	185.4 (INSIDE)	
Samuel Samuel Samuel			
General Specifications			496
	Sector- and beamforming		less Let
	Multiband		
	M-LOC 1		
	1 Light gray		le
Grounding Type	Light gray RF connector inner conductor and body grounded to reflector and mounting bracket		⟨ ⊘ 11.50HC
	Outdoor usage		Ē.
	Fiberglass, UV resistant		
	Aluminum		
	4.3-10 Female M-L00		
	Bottom		
RF Connector Quantity, high band	8		
	8		
RF Connector Quantity, low band	4		
RF Connector Quantity, total	20		
Remote Electrical Tilt (RET) Informat	ion		
, , , , , , , , , , , , , , , , , , , ,	CommRET v2		
	8-pin DIN Female 8-pin DIN Male		65.0
	1 female 1 male		
	10-30 Vde		
1 1	High band (1) Low band (2) Mid band (4)		
	8 W	F	
	1 W		
FV4S4-65B-R7		<u> </u>	
	SCPP/AISG 2:0 (Single RET)		94.7
Dimensions			
Width 4	198 mm 19.606 in		
	97 mm 7.756 in		210
	1000 mm 78.74 in		6
Net Weight, without mounting kit 4	3 kg 94.799 lb		

PARTS LIST						
NO.	DESCRIPTION	MANUFACTURE	PART NO.	PHONE /ORDER		
Α	WOOD ARM	HUGHES BROTHERS	TYPE 04 OR 05 OR APPROVED EQUAL	GRAYBAR OR HD SUPPLY		
В	MOUNTING PLATE	CUSTOM/JA-V INDUSTRIES	N/A	GLENN (909) 946-5959		
С	ANGLE BRACE	JOSLYN/MACLEAN POWER	J1442	GRAYBAR OR HD SUPPLY		
D	ALL POLE LINE HARDWARE	JOSLYN/MACLEAN POWER	VARIES	GRAYBAR OR HD SUPPLY		
Ε	SPACER	GALVANIZED PIPE - 4-3/4" x 1"ø				
F	ANTENNA PIPE MAST	2"ø X 22" MOUNTING PIPE W/ (1) THREADED END				
G	THREADED BOLT	5/8"ø X 30" LONG				
Н	THREADED CAP					

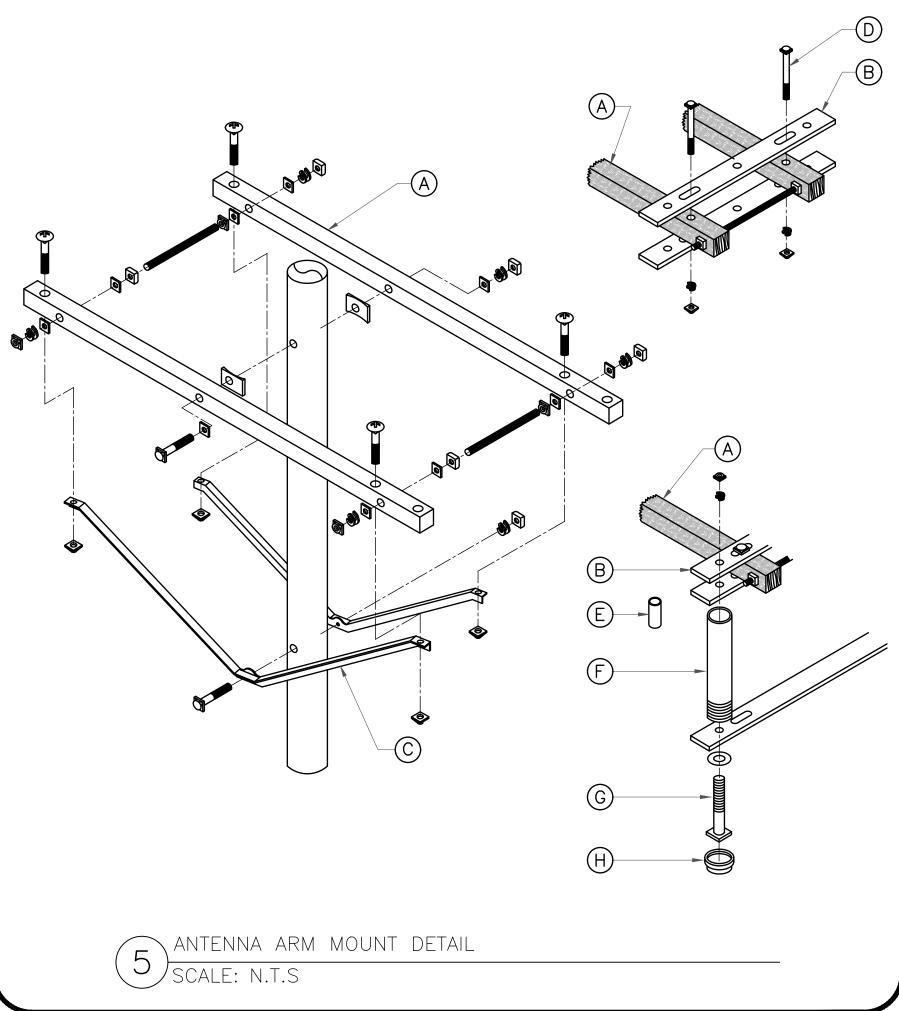

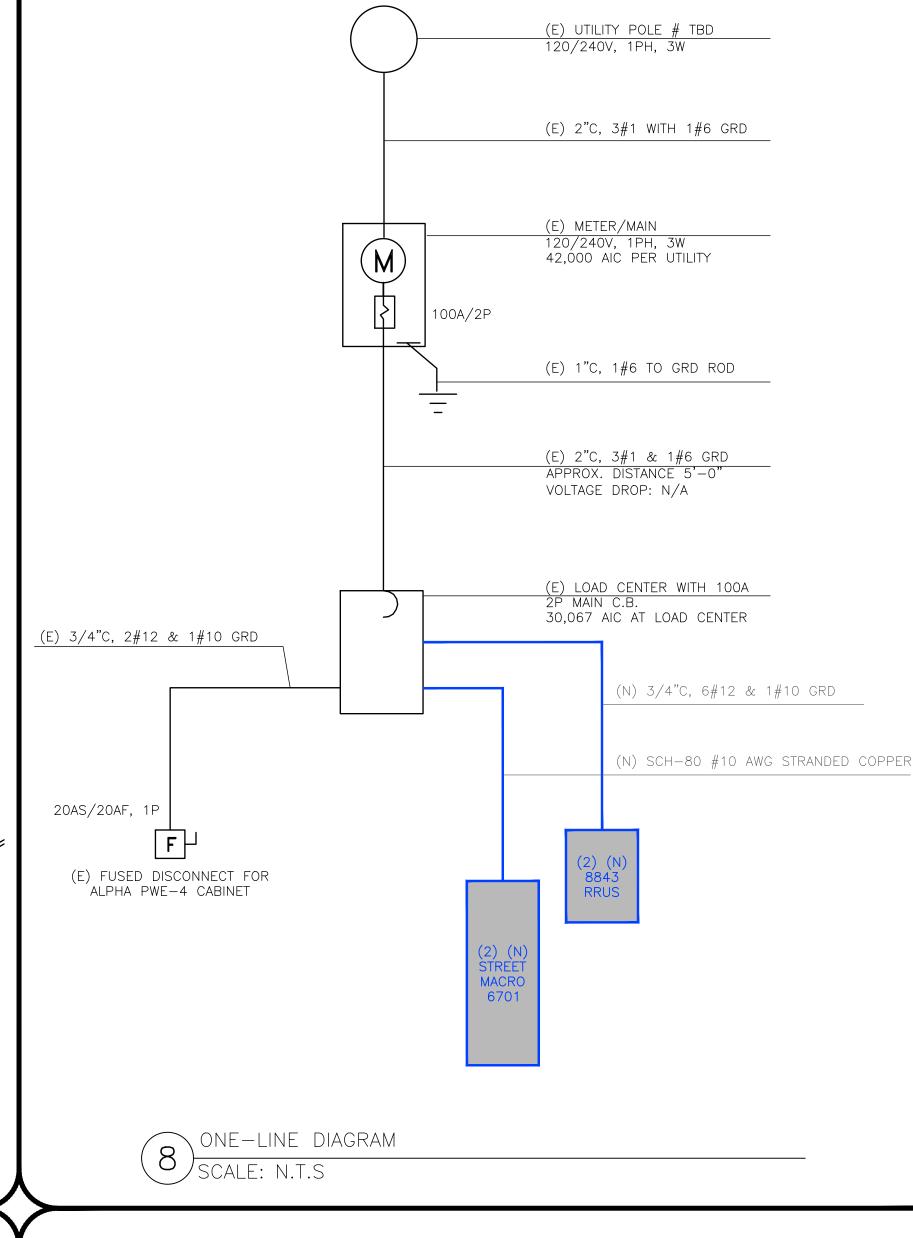



8 antenna ports, 4TX/4RX for 2 bands with separate RF ports
 Up to 320W RF Power shared between 2 bands

Examples:
 4x40W on each band or

4x20W on B2 and 4x60W on Band 66A
 2x60W on Band 2 and 2x80W on Band 66A

Carrier Capacity:

Up to 24 carrier and up to 60+70 MHZ OBW for LTE

2x 10Gbps CPRI

 Weight:
 Width
 Depth
 Weight

 wo protruding items
 15 ln (380 mm)
 13.2 ln (282 mm)
 15 ln (282 mm)
 75 lbs

 w protruding items
 18 ln (455 mm)
 13.2 ln (287 mm)
 11.3 ln (287 mm)
 (34.02 Kg)

> -48 VDC

> 2xTBD fuse (2 power connectors, 2 or 3 wire)

› AISG TMA & RET support (2 Bias-T, 1 ALD port)

Type 4.3-10 RF connectors2 external alarms

> IP 65, -40 to +55 ℃

6 ERICSSON RADIO SPEC. SHEET SCALE: N.T.S



LOAD CENTER 100 AMP MAIN A.I.C 42,000 KA WEATHERPROOF 100 AMP BUS 120/240V, 1PH, 3W L R M CB C CB M R L WATTAGE
T E S P/A C A B C P/A C C S A B DESCRIPTION DESCRIPTION В - 1 2 1/20 1 (E) FLEX. PRISM CAB SPACE 1 1/20 3 4 1/20 1 1000 | 8843 RRUS (E) ALPHA PWE-4 1 1/20 5 6 - | - | STREETMACRO 6701 700 SPACE SPACE SPACE A = 1,700B = 2,920TOTAL WATTS = 4,620WITH LCL N/A AMPS = 19.3

9 LOAD CENTER
SCALE: N.T.S





1000 CALLE CORDILLERA SAN CLEMENTE, CA 92673 WWW.LEAFCOMM.COM TEL: (949) 388-0192

SITE NAME: STANFORD RAN 12 / RED BARN

SITE ADDRESS: 35 VISTA LANE STANFORD, CA 94305

SITE TYPE: (N) 40'-0" JPA WOOD POLE

ISSUED FOR:					
REV	DATE	DRWN	DESCRIPTION	QA	
0	09/03/2021	MJC	90% CONSTRUCTION DWGS	CG	
1	09/21/2021	MJC	90% CD REVISION	CG	
2	10/13/2021	MJC	100% CONSTRUCTION DWGS	CG	
3	01/20/2022	СТ	100% CD CLIENT REVISION	CG	
4	06/10/2022	СТ	100% CD REVISIONS	CG	
5	11/15/2022	JG	100% CD REVISIONS	CG	
6	11/17/2022	СТ	100% CD REVISIONS	CG	






IT IS A VIOLATION OF LAW FOR ANY PERSON, UNLESS THEY ARE ACTING UNDER THE DIRECTION OF A LICENSED PROFESSIONAL ENGINEER, TO ALTER THIS DOCUMENT.

SHEET TITLE:
EQUIPMENT DETAILS


SHEET NUMBER:

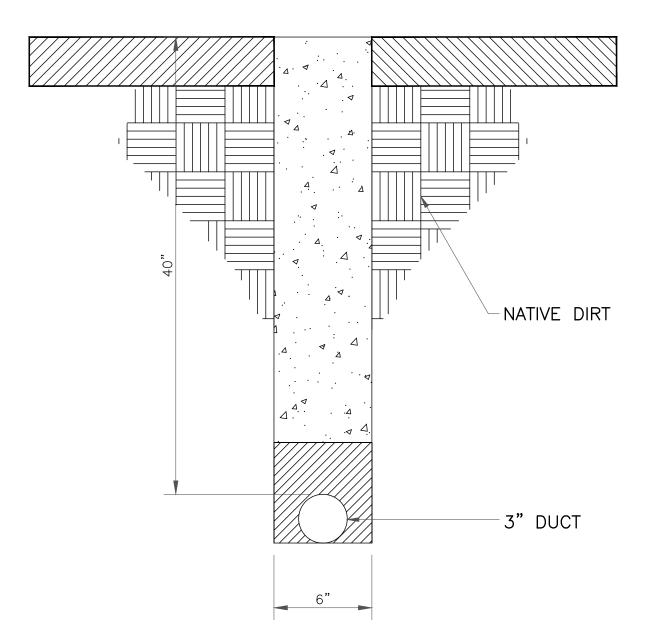

TO 90% OR BETTER & REPLACE LANDSCAPING IN KIND.



SPECIFICATIONS				
DIMENSIONS (HXWXD)	5.5"x4"x6"			
WEIGHT	4.5 LBS			
MANUFACTURER	HUBBELL POWER SYSTEMS			
MODEL	C6CS018 (OR APPROVED EQUAL)			

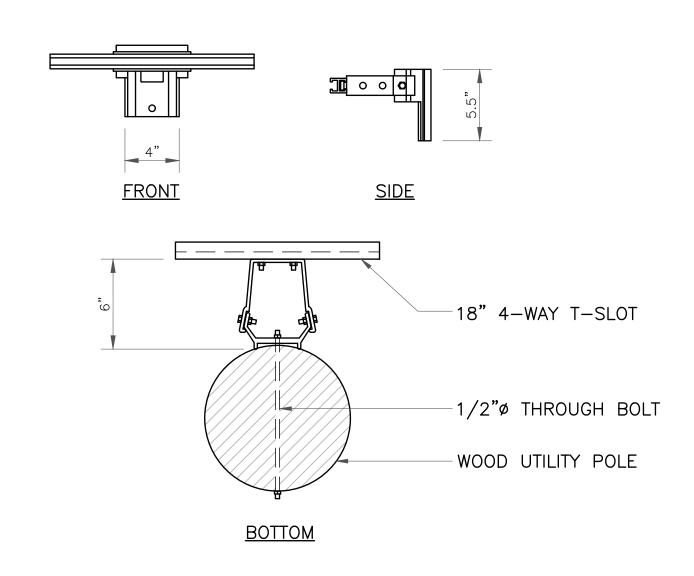

RISER STAND OFF SPECS.



Keep Back ____FT From this Antenna. FCC RF Public **Exposure Limits May Be Exceeded Within This Distance.** Call 888-632-0931 for Instructions. **Qualified Workers:** FCC Occupational Limits May Be **Exceeded Within This Distance.** Site ID#

RF WARNING SIGN



POLE WORKERS

There is an antenna operation high on this pole. Please follow guidance on signs near the antenna or call the number below.

Site ID#

CCROWN 888-632-0931

REV. A

REV. A





SAN CLEMENTE, CA 92673 WWW.LEAFCOMM.COM

SITE NAME: STANFORD RAN 12 / RED BARN

SITE ADDRESS: 35 VISTA LANE STANFORD, CA 94305

SITE TYPE: (N) 40'-0" JPA WOOD POLE


_				_	
ISSUED FOR:					
REV	DATE	DRWN	DESCRIPTION	QA	
0	09/03/2021	MJC	90% CONSTRUCTION DWGS	CG	
1	09/21/2021	MJC	90% CD REVISION	CG	
2	10/13/2021	MJC	100% CONSTRUCTION DWGS	CG	
3	01/20/2022	СТ	100% CD CLIENT REVISION	CG	
4	06/10/2022	СТ	100% CD REVISIONS	CG	
5	11/15/2022	JG	100% CD REVISIONS	CG	
6	11/17/2022	СТ	100% CD REVISIONS	CG	





SHEET TITLE: EQUIPMENT DETAILS



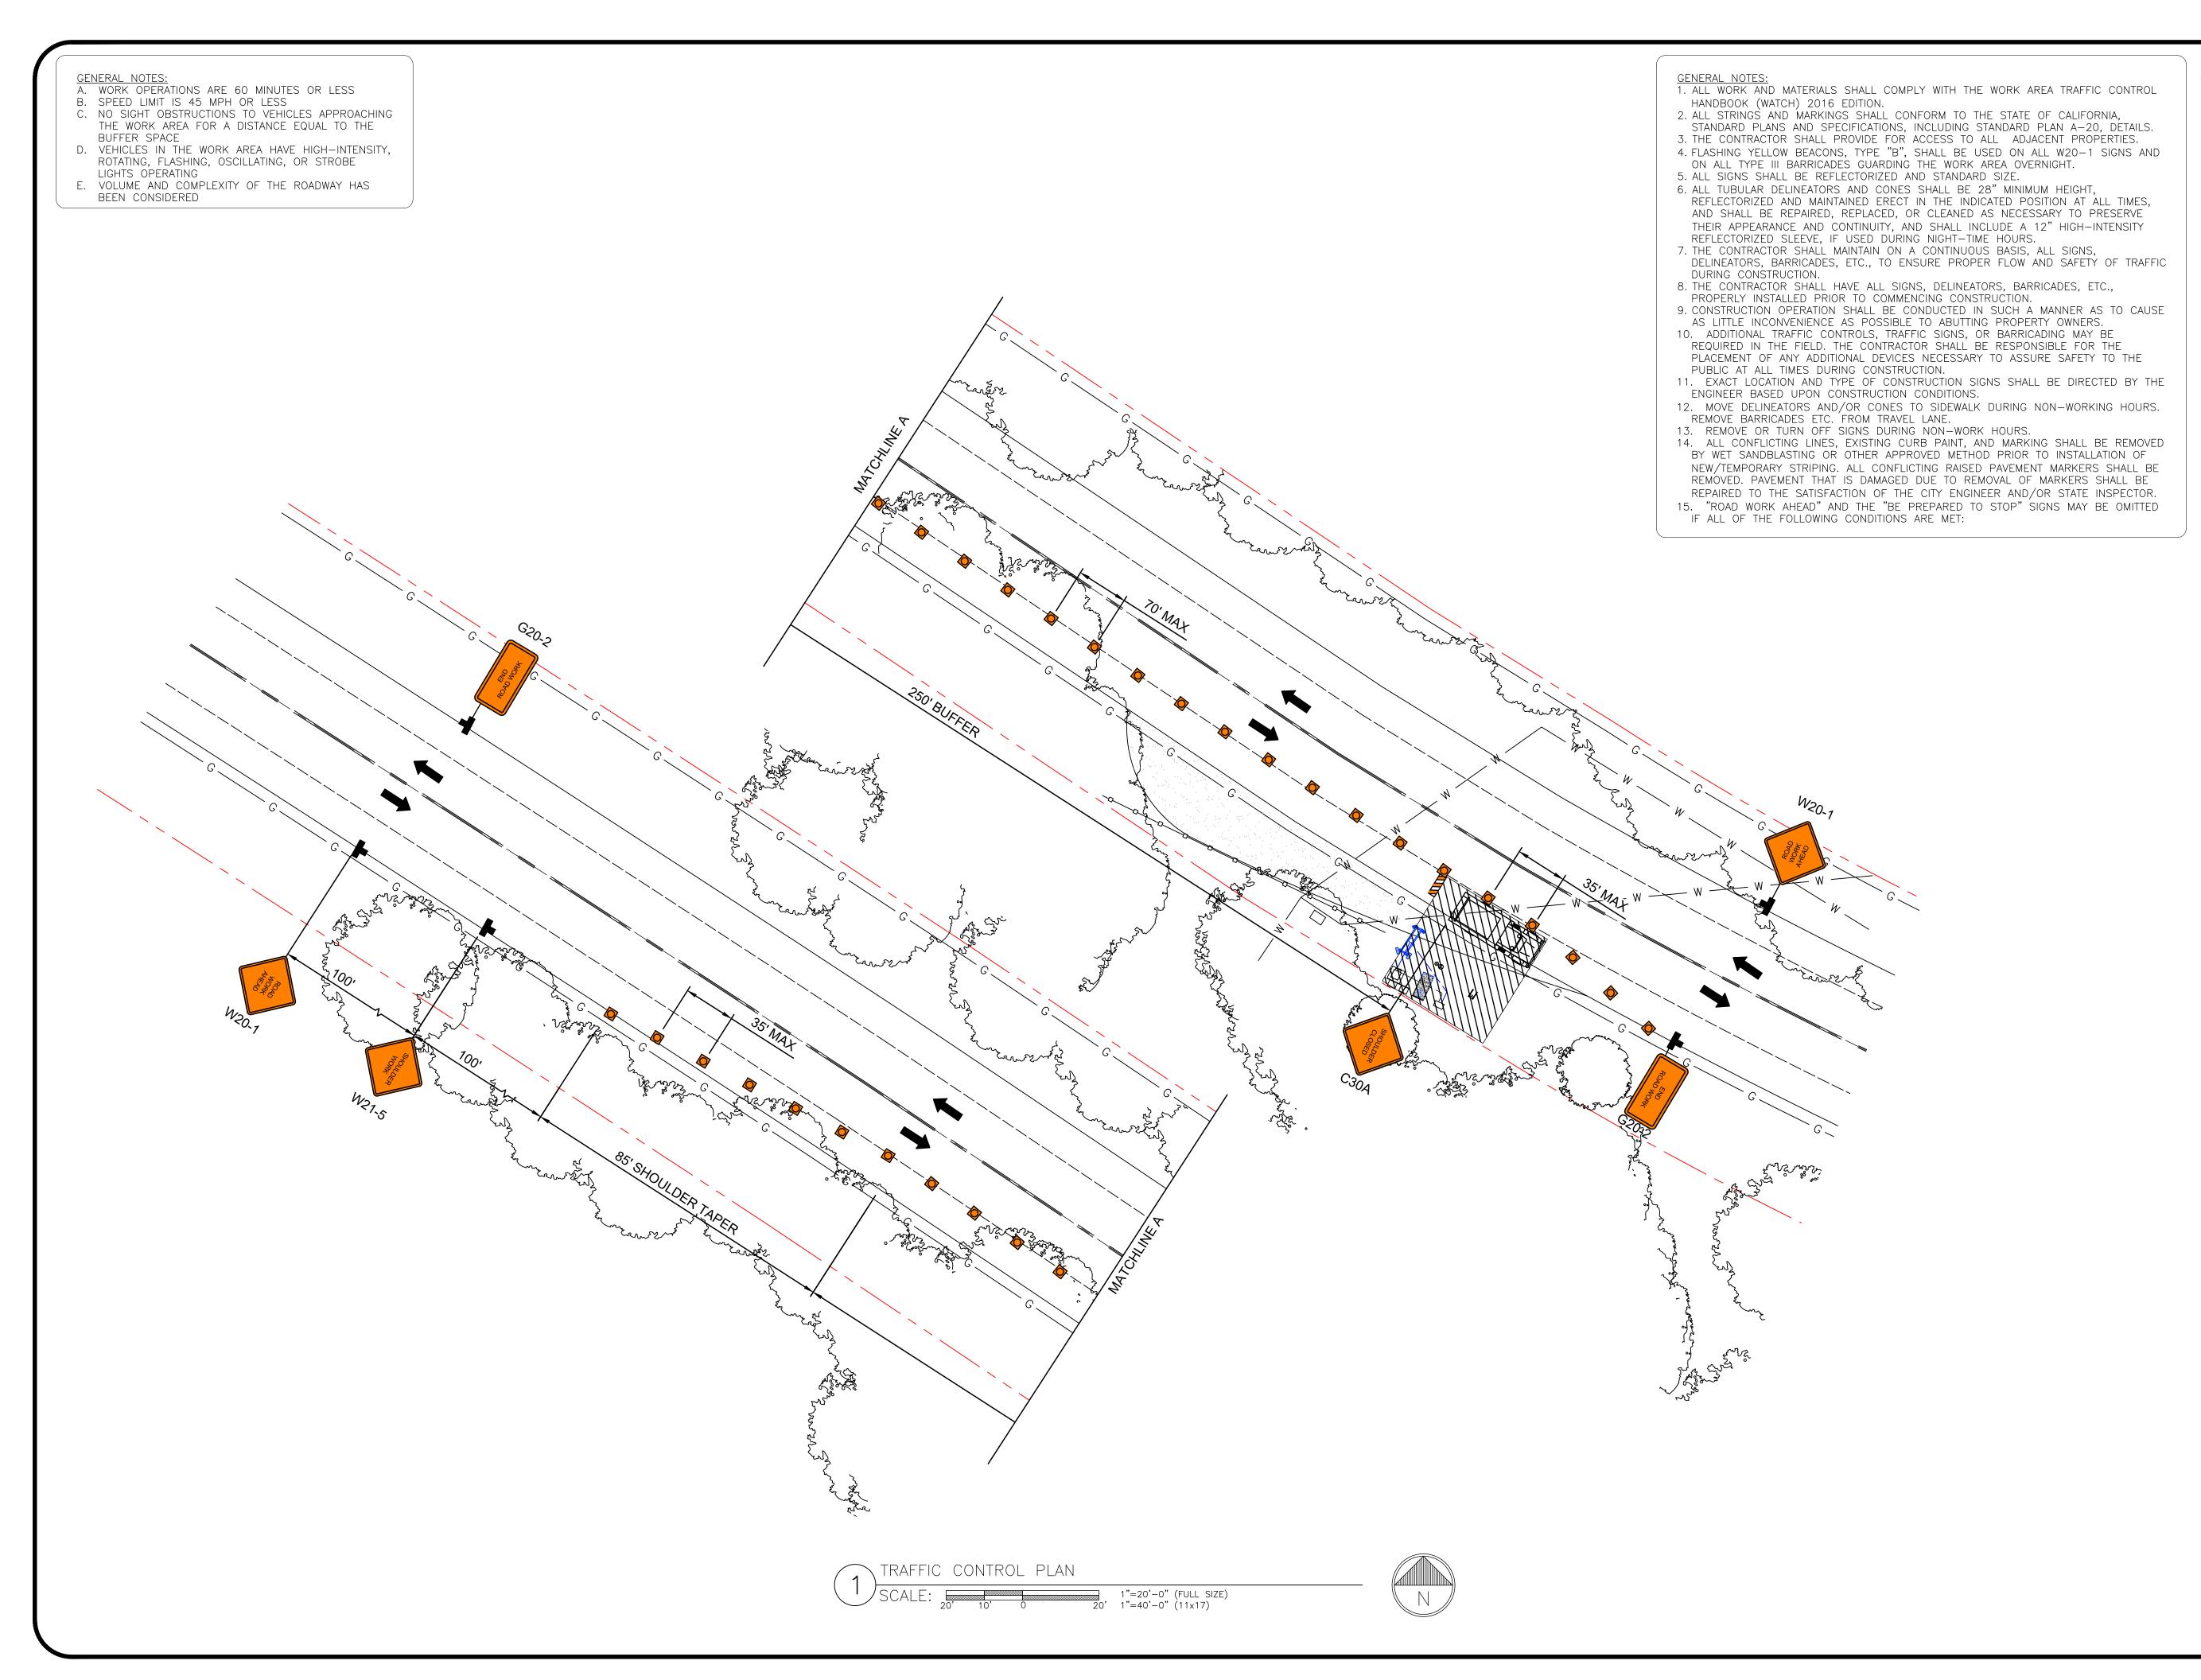



1 PARK PLACE PLACE DUBLIN, CA 94568



1000 CALLE CORDILLERA SAN CLEMENTE, CA 92673 WWW.LEAFCOMM.COM TEL: (949) 388-0192

SITE NAME: STANFORD RAN 12 / RED BARN

SITE ADDRESS: 35 VISTA LANE STANFORD, CA 94305

SITE TYPE: (N) 40'-0" JPA WOOD POLE

ISSUED FOR:

REV	DATE	DRWN	DESCRIPTION	QA
0	09/03/2021	MJC	90% CONSTRUCTION DWGS	CG
1	09/21/2021	MJC	90% CD REVISION	CG
2	10/13/2021	MJC	100% CONSTRUCTION DWGS	CG
3	01/20/2022	СТ	100% CD CLIENT REVISION	CG
4	06/10/2022	СТ	100% CD REVISIONS	CG
5	11/15/2022	JG	100% CD REVISIONS	CG
6	11/17/2022	СТ	100% CD REVISIONS	CG





EXPIRES: 2023/09/30

IT IS A VIOLATION OF LAW FOR ANY PERSON, UNLESS THEY ARE ACTING UNDER THE DIRECTION OF A LICENSED PROFESSIONAL ENGINEER, TO ALTER THIS DOCUMENT

SHEET TITLE:
TRAFFIC CONTROL PLAN

SHEET NUMBER: