# **County of Santa Clara**

**Department of Planning and Development** 

County Government Center, East Wing, 7th Floor 70 West Hedding Street San Jose, CA 95110 Phone: (408) 299-5700 www.sccplandev.org



STAFF REPORT Zoning Administration April 6, 2023

**Item #4** 

Staff Contact: Charu Ahluwalia, Senior Planner (408) 299-5740, charu.ahluwalia@pln.sccgov.org

# PLN23-011 (STANFORD UNIVERSITY)

Architecture and Site Approval – Unmanned Wireless Telecommunication Facility for Crown Castle, along Junipero Serra Boulevard.

Summary: Architecture and Site Approval, for installation of a new thirty-five-feet high wooden pole with four new antennas and two radio units, along Junipero Serra Boulevard. The project includes removal of four antennas and two radio units from an existing PG&E utility pole. No tree removal, exterior lighting, or parking is proposed with this project.

Owner: Crown Castle/ Stanford University Community Plan Designation:

Applicant: Tabitha Schneider, Project Manager Foothills

Address: 25 Junipero Serra Blvd., Stanford Zoning: OSF-sr

APN: 142-12-007 Project Area: 0.1 acres
Supervisorial District: 5

### RECOMMENDED ACTIONS

- A. Approve the use of a prior California Environmental Quality Act (CEQA) document [2000 Stanford Community Plan and General Use Permit (GUP) Program Environmental Impact Report (EIR)].
- B. Grant Architecture & Site Approval (ASA), subject to conditions of approval outlined in Attachment B.

### ATTACHMENTS INCLUDED

Attachment A – CEQA Determination – Use of a Prior CEQA Document

Attachment B – Preliminary ASA Conditions of Approval

Attachment C – Location & Vicinity Map

Attachment D – Proposed Plans

Attachment E – Extension of Small Cell Facility 90-day Shot Clock Deadline

### PROJECT DESCRIPTION

The proposed project is for installation of a new thirty-five-feet high wooden pole with four new antennas and two radio units, along Junipero Serra Boulevard. The project includes removal of four antennas and two radio units from an existing PG&E utility pole. The existing equipment cabinet and pedestal will not be altered or moved.

The proposed new wireless telecommunications infrastructure for 5G upgrades would replace an existing telecommunications facility that was established as a part of Stanford University's campus-wide Distributive Antenna System (DAS), which is a series of telecommunication nodes installed throughout the campus. The existing facility [with a prior Architecture and Site Approval; Record number: 9969-08A; Stanford University Telecommunications Distributive Antenna System (DAS) Radio Access Network (RAN) #12] is located 25 feet away from the proposed location of the new wooden pole.

The project site is located within the right-of-way of Junipero Serra Blvd. No tree removal or exterior lighting is proposed with this project.

### REASONS FOR RECOMMENDATION

### A. Environmental Review and Determination (CEQA)

The proposed project is in conformance with both the 2000 Stanford Community Plan ("SCP") and General Use Permit ("GUP") and has no new effects beyond those analyzed in the Program EIR, certified by the Board of Supervisors in December 2000. The Program EIR analyzed the environmental impacts of campus development allowed under the SCP and GUP. The proposed project is within the scope of the campus development analyzed in the 2000 GUP. Therefore, use of the prior CEQA document is adequate for this project.

### B. Project/Proposal

1. Stanford Community Plan and GUP: The project conforms to applicable Community Plan goals, strategies, and policies. Utility infrastructure, like the wireless telecommunication facility, is a permitted use within the Open Space and Field Research land use designation, and as conditioned will satisfy the requirements of the GUP. The 2000 Community Plan and GUP governs development projects on the Stanford campus. This project conforms to the criteria set forth by the GUP and provisions identified within the Community Plan, and subject to compliance with the preliminary conditions outlined in Attachment B.

### 2. ASA approval:

ASA approval standards, applicable regulations, and findings: The project substantially conforms to the requirements and guidelines in the SCP and GUP. These requirements meet all of the ASA Guidelines through the ASA approval process approved by the Zoning Administrator.

### C. ASA Findings:

Pursuant to §5.40.040 of the County Zoning Ordinance, the Zoning Administrator may grant an Architecture & Site Approval contingent upon specific findings. In the following discussion, the scope of review findings are listed in **bold**, and an explanation of how the project meets the required standard is in plain text below.

# A. Adequate traffic safety, on-site circulation, parking and loading areas, and insignificant effect of the development on traffic movement in the area;

The project site is located within the right-of-way of Junipero Serra Blvd. The application has been reviewed and approved by Department of Roads and Airports. The proposed facility will be unmanned. Service technicians will visit the site periodically for routine maintenance and for any emergency maintenance. Adequate on-street parking is currently available at the site. There will be no impact to existing traffic patterns. As such, the proposed wireless telecommunications facility would not result in any change in the amount of traffic and does not generate any new trips from a traffic impact perspective. The traffic would be consistent with that analyzed in the prior 2000 GUP EIR.

### Short-term construction traffic

The project will result in short-term impacts related to construction activities; however, conditions of approval have been added to this project to mitigate these short-term impacts to a "less than significant level". All construction trucks will be required to use approved truck routes, for transporting construction materials to and from the site. Furthermore, the project has been conditioned to restrict construction material deliveries to non-peak hours, as defined the 2000 GUP EIR. Compliance with the Conditions of Approval (Attachment B) ensures that the short-term construction traffic associated with the project will not have a significant effect on traffic movement in the area.

For the reasons stated above, this finding *can* be made.

# B. Appearance of proposed site development and structures, including signs will not be detrimental to the character of the surrounding neighborhood or zoning district;

The new wireless telecommunications facility will not be detrimental to the character of the surrounding neighborhood or zoning district. The project includes removal of four panel antennas and two radio units from an existing PG&E utility pole and installation of a new thirty-five-feet high wooden pole with four antennas and two radio units (see Attachment D). The pole and antennas are to be installed adjacent to a previously approved telecommunications facility. The height of the pole is maintained below the existing infrastructure (existing pole height is 70 feet and proposed pole height is 35 feet). The condition of approval to paint the pole and antennas with a brown color of less than 45 light reflectivity value (LRV) will minimize the visibility of the installation.

The proposal minimizes removal or modification of site landscaping, minimizes visual impact through design, and siting, color and materials of the pole and antennas blend with the natural setting, and no exterior lighting is proposed. Thus, the project substantially conforms to applicable sections of the Wireless Telecommunication Facilities Design Guidelines.

For the reasons stated above, this finding *can* be made.

# C. Appearance and continued maintenance of proposed landscaping will not be detrimental to the character of the surrounding neighborhood or zoning district;

No landscaping or tree removal is proposed as part of this project. No landscaping is proposed as part of this project. There are existing mature trees in the vicinity, that provide screening for the pole installation. As such, this finding *can* be made.

# D. No significant, unmitigated adverse public health, safety and environmental effects of proposed development;

The Program GUP EIR certified by the Board of Supervisors in December 2000 analyzed the environmental impacts of Stanford campus development allowed under the SCP and GUP. The proposed wireless telecommunications facility is within the scope of the development analyzed in the 2000 GUP EIR. All appropriate conditions of approval have been added to ensure conformance with the 2000 GUP EIR.

The prior CEQA analysis concluded that the proposed wireless facility would not result in any significant environmental impacts as it relates to parking, traffic, construction noise, and air quality. The project has been reviewed with respect to all applicable regulations relating to public health and safety by County subject matter experts, including Land Development Engineering, Department of Environmental Health, and the Fire Marshal. All subject matter experts have recommended approval of the project with Conditions and determined that the project will not result in significant, unmitigated adverse public health, safety, or environmental effect. Furthermore, the CEQA analysis for the project determined that with the conditions of approval, the project would not result in any significant environmental impacts (See Attachment A). As such, this finding can be made.

# E. No adverse effect of the development on flood control, storm drainage, and surface water drainage;

The project site does not contain any creeks or streams and is not located within a 100-year flood zone. The project has been reviewed by County Land Development and Engineering staff with respect to all applicable regulations relating to drainage and flood control. As such, this finding *can* be made.

# F. Adequate existing and proposed fire protection improvements to serve the development;

The Fire Marshal's Office has reviewed the project and determined that the existing fire protection improvements are sufficient to ensure fire safety for this proposal. For these reasons, this finding *can* be made.

### G. No significant increase in noise levels;

There would be no increase in noise levels due to the operation of this project. The project may create short-term/temporary construction noise impacts due to construction activities and construction traffic. The project has been conditioned to require submittal of a Traffic and Construction Management Plan prior to building permit issuance. Furthermore, construction activities shall be limited to the hours of 7AM and 7PM, Monday through Saturday, with no construction activity occurring after 7PM, or on Sundays. Therefore, as conditioned, this finding *can* be made.

# H. Conformance with zoning standards, unless such standards are expressly eligible for modification by the Zoning Administrator as specified in the Zoning Ordinance.

The project site is zoned OS/F-sr, which is the "Open Space and Field Research" zoning district. This district was established to implement the 2000 Stanford University Community Plan policies for the Open Space and Field Research land use designation, to maintain the open space character of those Stanford University OS/F lands outside the Academic Growth Boundary. Allowable uses include utilities infrastructure. Per County Zoning Ordinance Table 2.50-1, note 13, within the OS/F district, new utilities may be constructed that serve either Stanford or other lands if such facilities reasonably minimize degradation to the natural environment and maintain the predominantly natural appearance and habitat values of the setting.

The proposed project site is located within the right-of-way of Junipero Serra Blvd. The proposed new pole is located 25 feet away from the existing wireless telecommunications facility that would be replaced by the proposed infrastructure. The proposal minimizes impact to the natural environment to the extent possible through design, screening, and siting. The pole and antennas are to be installed adjacent to a previously approved telecommunications facility. The height of the pole is maintained below the existing infrastructure (existing pole height is 70 feet and proposed pole height is 35 feet). The condition of approval to paint the pole and antennas with a color of less than 45 light reflectivity value (LRV) will minimize the visibility of the installation. No tree removal, parking, or exterior lighting is proposed with this project.

As such, and this finding *can* be made.

# I. Conformance with the general plan and any applicable area or specific plan, or, where applicable, city general plan conformance for property located within a city's urban service area; and

The Stanford academic campus is primarily designated as Major Educational and Institutional Use within the Santa Clara County general plan. The Community Plan identifies the project site as Open Space and Field Research. The proposed project will replace an existing wireless telecommunication facility and complies with the

applicable policies set forth in the Community Plan with reference to SCP-LU26 and SCP-LU27, which state that allowable uses within the Open Space and Field Research land use designation include utility infrastructure.

J. Substantial conformance with the adopted "Guidelines for Architecture and Site Approval" and other applicable guidelines adopted by the County.

The proposed project complies with the Wireless Telecommunication Facilities Design Guidelines as no tree removal or landscaping modification is proposed, visual impact through design, and siting is minimized, color and materials of the pole and antennas blend with the natural setting, and no exterior lighting is proposed. As such, conformance with the provisions noted above ensures compliance with the Guidelines for Architecture and Site Approval. As such, this finding *can* be made.

### **BACKGROUND**

On January 19, 2023, an application for Architecture and Site Approval was submitted for a wireless telecommunications facility. The application was deemed complete on February 17, 2023. The proposed project is considered a small cell facility as defined in 47 Code of Federal Regulations (CFR) 1.6002(l) and is subject to 90-day shot clock for permit approval as established by Federal Communications Commission (FCC) for wireless telecommunications facility (wireless shot clock). County Staff requested a 45-day extension to the 90-day shot clock, which was granted by the applicant (Attachment E). The 90-day wireless shot-clock ends on April 19, 2023, and the 45-day extension to the 90-day shot clock ends on June 3, 2023.

As of writing of this report, no public comments were received for this project. A public notice was mailed to all property owners within a 300-foot radius on March 24, 2023, and was also published in the Post Records on March 24, 2023.

### STAFF REPORT REVIEW

Prepared by: Charu Ahluwalia, Senior Planner

Reviewed by: Samuel Gutierrez, Principal Planner

56

# ATTACHMENT A

Use of a Prior CEQA Document

# USE OF A PRIOR CEQA DOCUMENT PROGRAM ENVIRONMENTAL IMPACT REPORT (EIR)

Pursuant to Section 15162 of the CEQA Guidelines, the County of Santa Clara has determined that the project described below is pursuant to or in furtherance of an Environmental Impact Report which has been previously adopted and does not involve new significant impacts beyond those analyzed in the previous Environmental Impact Report.

File Number	APN(s)	Date
PLN23-011	142-12-007	April 06, 2023
Project Name	Project Type	
Unmanned Wireless Telecommunication Facility for Crown	Architecture and Site Approval	
Castle/ Stanford University, along Junipero Serra		
Owner	Applicant	
Crown Castle/ Stanford University	Tabitha Schneider, Project Mar	nager
Project Location		
25 Junipara Sarra Plyd Stanford		

25 Junipero Serra Blvd., Stanford

### **Project Description**

The proposed project is for installation of a new thirty-five-feet high wooden pole with four new antennas and two radio units, along Junipero Serra Boulevard. The project includes removal of four antennas and two radio units from an existing PG&E utility pole. The existing equipment cabinet and pedestal will not be altered or moved. The proposed new wireless telecommunications infrastructure for 5G upgrades, would replace an existing telecommunications facility that was established as a part of Stanford University's campus-wide Distributive Antenna System (DAS), which is a series of telecommunication nodes installed throughout the campus. The existing facility [with a prior Architecture and Site Approval; Record number: 9969-08A; Stanford University Telecommunications Distributive Antenna System (DAS) Radio Access Network (RAN) #12] is located 25 feet away from the proposed location of the new wooden pole. The project site is located within the right-of-way of Junipero Serra Blvd. No tree removal, parking or exterior lighting is proposed with this project.

### **Background and Summary of Findings**

Per the California Environmental Quality Act (CEQA) of 1970 (as amended), all development permits processed by the County Planning Office which require discretionary approval are subject to environmental review. A new Negative Declaration or EIR is not required if a previous CEQA document has been prepared and adopted or certified which adequately address all the possible environmental impacts of the proposed project and (a) no substantial changes are proposed in the project which will result in new significant environmental effects, (b) no substantial changes have occurred with respect to the circumstances under which will result in the identification of new significant impacts, or (c) no new information is available which shows that the project will have new significant impacts or mitigation measures and alternatives which were previously found to be infeasible would now in fact be feasible (CEQA Guidelines 15162).

The Planning Office evaluated the project described above and has determined that none of the circumstances exist which would require additional environmental review. As such the environmental impacts of the project have been adequately evaluated in the Environmental Impact Report adopted by the Board of Supervisors on December 15, 2000, for the project entitled "Stanford University Community Plan and General Use Permit" and that no further environmental review is required under the California Environmental Quality Act.

Approved by:	DocuSigned by:	3/30/2023
Samuel Gutierrez, Principal Planner	Signature	Date

File PLN23-011 Attachment A

# ATTACHMENT B

# **Preliminary Conditions of Approval**

### ATTACHMENT B

# PRELIMINARY CONDITIONS OF APPROVAL FOR ARCHITECTURE & SITE APPROVAL

**Date:** April 6, 2023

Owner/Applicant: Tabitha Schneider/ Eric Snow, Stanford University
Location: 25 Junipero Serra Blvd., Stanford (APN: 142-12-007)

File Number: PLN23-011

CEQA: Prior CEQA - 2000 Stanford Community Plan and General Use Permit

(GUP) Program Environmental Impact Report (EIR)

Project Description: Architecture and Site Approval, for installation of a new thirty-five-feet

high wooden pole with four new antennas and two radio units, along Junipero Serra Boulevard. The project includes removal of four antennas and two radio units from an existing PG&E utility pole. No tree removal,

exterior lighting, or parking is proposed with this project.

If you have any question regarding the following preliminary conditions of approval, call the person whose name is listed as the contact for that agency. They represent a specialty or office and can provide details about the conditions of approval.

Agency	Name	Phone	E-mail
Planning	Charu Ahluwalia	(408) 299-5740	charu.ahluwalia@pln.sccgov.org
Roads and Airports	Christine Hii	(408) 299-5763	christine.hii@rda.sccgov.org
Environmental Health	Darrin Lee	(408) 573-2464	darrin.lee@cep.sccgov.org
<b>Building Inspection</b>	Building Inspection Office	(408) 299-5700	

### **STANDARD CONDITIONS OF APPROVAL**

### **Building Inspection**

1. For detailed information about the requirements for a building permit, obtain a Building Permit Application Instruction handout from the Office of Building Inspection or visit their website (www.sccbuilding.org).

### Planning

1. Development and maintenance of the project site shall take place in accordance with approved plans, received by the Planning Department on February 9, 2023, and as approved by the Zoning Administrator. The project involves removal of four panel antennas and two radio units from an existing PG&E utility pole and installation of a new thirty-five-feet high

wooden pole with four new antennas and two radio units. The plans submitted into Plan Check shall be in substantial conformance with the approved plans. Any changes to the approved project included such as (but not limited to) the design, quantity, location or other modifications to the approved plans are required to be submitted for review by the Planning Office and may result in a Modification to the approved ASA, and may be subject to additional review under the California Environmental Quality Act (CEQA).

- 2. The prior approved telecommunication facility [Planning Record number: 9969-08A; Stanford University Telecommunications Distributive Antenna System (DAS) Radio Access Network (RAN) #12] is hereby replaced with the new Unmanned Wireless Telecommunications Facility for Crown Castle/ Stanford University, along Junipero Serra Boulevard.
- 3. File and obtain necessary demolition and building permits from the Building Inspection Division.
- 4. All painted, or otherwise treated, surfaces of the pole and antennas shall be maintained at all times to avoid paint peeling or bare material surfaces from being exposed. If the pole or antennas are improperly maintained, the approval may be revoked and subject to violation and fines.
- 5. The permittee shall keep the project site free of graffiti. "Graffiti" means any unauthorized inscription, writing, lettering, word, figure, mark, design or other inscribed material that is written, marked, etched, scratched, drawn, painted or otherwise placed on any structures, fences, or other permanent or temporary surfaces.
- 6. All telecommunications equipment installed on-site shall comply with the standards of the Federal Communications Commission (FCC) for health, safety, and other pertinent requirements.
- 7. No signs are approved at this time except for (1) an informational sign that provides phone numbers to be used in case of an emergency, and (2) a bilingual NIER hazard warning sign posted at the outer perimeter of the project site. These signs must be in compliance with FCC rules regarding required telecommunication facility signage. Such signs shall be limited to an area of one square foot.
- 8. The project shall comply with the Stanford University 2000 General Use Permit Conditions of Approval, and approved Stanford University 2000 GUP Mitigation Monitoring and Reporting Program.
- 9. Stanford shall be responsible for paying all reasonable costs associated with work by the County Planning Department, or with work conducted under the supervision of the County Planning Office, in conjunction with, or in any way related to the conditions of approval

- identified in this project. This includes but is not limited to costs for staff time, consultant fees, and direct costs associated with report production and distribution.
- 10. In the event that previously unidentified historic or prehistoric archaeological resources are discovered during construction, the contractor shall cease work in the immediate area and the County Planning Office and Campus Archaeologist shall be contacted. An independent qualified archaeologist retained by the County at the expense of Stanford shall assess the significance of the find and make mitigation recommendations.
- 11. If archeological resources are discovered as described above, construction monitoring shall be conducted at any time ground-disturbing activities (greater than 12 inches in depth) are taking place in the immediate vicinity of the identified resources. If monitoring does not produce evidence of significant cultural resources within the project area, further mitigation shall be limited to construction monitoring, unless additional testing or other specific mitigation measures are determined by a qualified archaeologist to be necessary to ensure avoidance of damage to significant archaeological resources. A technical report of findings describing the results of all monitoring shall be prepared in accordance with professional standards. The archaeological monitoring program shall be implemented by an individual meeting the Secretary of Interior Professional Qualifications Standards in Archaeology (36 CFR 61); individual field monitors shall be qualified in the recognition of cultural resources and possess sufficient academic and field training as required to conduct the work effectively and without undue delay.
- 12. In the event that human skeletal remains are encountered, the applicant is required by County Ordinance No. B6-18 to immediately notify the County Coroner. Upon determination by the County Coroner that the remains are Native American, the coroner shall contact the California Native American Heritage Commission, pursuant to subdivision (c) of section 7050.5 of the Health and Safety Code and the County Coordinator of Indian affairs. No further disturbance of the site may be made except as authorized by the County Coordinator of Indian Affairs in accordance with the provisions of state law and this chapter. If artifacts are found on the site a qualified archaeologist shall be contacted along with the County Planning Office. No further disturbance of the artifacts may be made except as authorized by the County Planning Office.
- 13. In the event that fossilized shell or bone is uncovered during any earth-disturbing operation, contractors shall stop work in the immediate area of the find and notify the Campus Archaeologist and the County Building Inspector assigned to the project. The Campus Archaeologist shall visit the site and make recommendations for treatment of the find (including but not limited to consultation with a paleontologist and excavation, if warranted), which would be sent to the County Building Inspection Office and the County Planning Office. If a fossil find is confirmed, it will be recorded with the

### **Environmental Health**

14. All construction activities shall be in conformance with the Santa Clara County Noise Ordinance Section B11-154 and prohibited between the hours of 7:00 p.m. and 7:00 a.m. on weekdays and Saturdays, or at any time on Sundays for the duration of construction.

# CONDITIONS OF APPROVAL TO BE COMPLETED PRIOR TO BUILDING PERMIT ISSUANCE

### **Planning**

- 15. The color of all new surfaces shall be non-reflective, have a Light Reflectivity Value (LRV) of 45 or less and match the brown color of the existing facility to blend into the background and minimize visual impact. Label the elevations indicating the brown color and compliant LRV level. Prior to issuance of the Building Permit, submit a color sample of the antennas to the Planning Office.
- 16. Place a construction note on the site plan that states the following: "All construction contractors shall properly maintain the equipment and where feasible, use "clean fuel" equipment and emissions control technology (e.g., CNG fired engines, catalytic converters, particulate traps, etc.). Measures to reduce diesel emission would be considered feasible when they are capable of being used on equipment without interfering substantially with equipment performance."
- 17. Submit a Final Construction Management and Logistics Plan for approval by Planning and Land Development Engineering, **prior to issuance of any building permits**.
- 18. The following tree removal/protection requirements shall apply:
  - A. No tree removal is approved with this project.
  - B. All trees in the project area shall remain and are protected after the approval of this ASA.
  - C. If any trees are proposed to be removed after the approval of the ASA, further review by the Planning Office may be required to assess the visual impact of the tree removal to the project and surrounding area.
  - D. Final plans shall show the size and species of all trees over 12 inches in diameter (at 4.5 feet above grade) within the proposed work area for the project and clearly label all trees.
- 19. No lighting is approved with this project.
- 20. Adequate signs shall be posted along the street frontages or in front of the project site, no smaller than 1,296 square inches in size, containing the name, telephone number, and email address of the appropriate Stanford person the public may contact to register a complaint about construction noise. Additionally, Stanford shall create an outreach and information portal to facilitate information and alerts to be delivered to the immediate neighborhoods on construction activities. Stanford shall keep a written record of all such complaints and shall provide copies of these records to the County Planning Office.

File No. PLN23-011 ZA Hearing April 6, 2023 21. Preconstruction surveys for nesting raptors and migratory birds shall be conducted by a qualified ornithologist to identify active nests that may be disturbed during project implementation. Between January 1 and April 30, preconstruction surveys shall be conducted no more than 14 days **prior to the initiation of construction activities or tree removal**. Between May 1 and August 31, preconstruction surveys no more than 30 days **prior to the initiation of these activities**. Stanford University shall conduct an additional preconstruction survey within 24 hours of initiation of construction activities, by the Campus Biologist, to verify no new nesting has occurred. If an active nest is found near, or in close proximity to, the construction area where the nest could be disturbed by these activities, the ornithologist or Campus Biologist, shall, in consultation with the California Department of Fish and Game, designate a construction free buffer zone (typically 250 feet) around the nest.

### Road and Airports

- 22. Obtain a Santa Clara County Roads and Airports Department Encroachment Permit for work in the County right-of-way of Junipero Serra Blvd.
  - a. Encroachment Permit ENC22-1129 has been submitted and approved.


# <u>CONDITIONS OF APPROVAL TO BE COMPLETED PRIOR TO OCCUPANCY OR FINAL INSPECTION</u>

### **Planning**

- 23. All grading materials and stockpiled materials shall be removed and disposed at an approved location.
- 24. Following completion of construction, contact the Planning Department (Charu Ahluwalia at 408-299-5740) at least two weeks in advance to set up an appointment to schedule a site visit to verify the development is per approved plans.

# **ATTACHMENT C**

Location and Vicinity Map

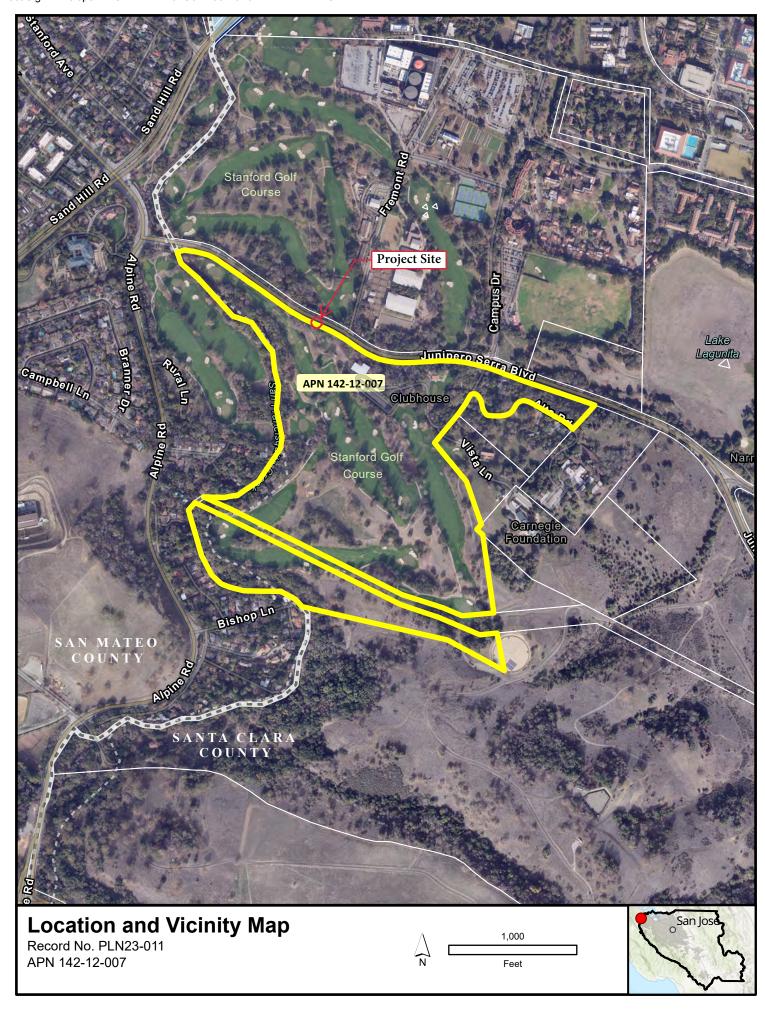

# $\underline{\textbf{ATTACHMENT D}}$

Proposed Project plan s

STANFORD RAN 12 / RED BARN SITE NAME:

35 VISTA LANE STANFORD, CA 94305 SITE ADDRESS:

SHEET#

SANTA CLARA **COUNTY:** 

JURISDICTION: SANTA CLARA COUNTY

(N) 40'-0" JPA WOOD POLE SITE TYPE:

POLE ID: **TBD** 

PROJECT: 4G/5G UPGRADE





**CROWN** 

SAN CLEMENTE, CA 92673 VWW.LEAFCOMM.COM

SITE NAME: STANFORD RAN 12 / RED BARN

SITE ADDRESS: 35 VISTA LANE STANFORD, CA 94305

SITE TYPE: (N) 40'-0" JPA WOOD POLE

**ISSUED FOR:** 

100% CD REVISIONS

100% CD REVISIONS

PCC REVISIONS

# SITE

**LOCATION MAP** 

FROM CROWN CASTLE OFFICE: 1 PARK PL, DUBLIN, CA 94568

- GET ON I-680 S IN PLEASANTON FROM HACIENDA DR, W LAS POSITAS BLVI AND FOOTHILL RD
- FOLLOW I-680 S AND I-280 N TO ALPINE RD IN SAN MATEO COUNTY. TAKE EXIT 22 FROM I-280 N
- FOLLOW I-680 S AND I-280 N TO ALPINE RD IN SAN MATEO COUNTY. TAKE EXIT 22 FROM I-280 N

DESTINATION WILL BE ON THE RIGHT

# **SITE INFORMATION**

CROWN CASTLE FIBER LLC

STANFORD RAN 12 / RED BARN SITE NAME:

SITE ADDRESS: 35 VISTA LANE STANFORD, CA 94305

PROPERTY OWNER:

3RD FLOOR

REDWOOD CITY, CA 94063

MAP/PARCEL #:

37.422952, -122.187560 LAT/LONG:

GROUND ELEVATION: ±144' CURRENT ZONING:

SANTA CLARA COUNTY **JURISDICTION:** 

LEASE AREA: ±455 SQFT OCCUPANCY: CONSTRUCTION TYPE: NA

NUMBER OF STORIES: NA

ACCESSIBILITY

THE FACILITY IS UNMANNED AND NOT FOR REQUIREMENTS: CONTINUOUS HUMAN HABITATION. DISABLED / CHALLENGED ACCESS IS NOT REQUIRED PER CBC 2019, SECTION 11B-203.4(LIMITED ACCESS SPACE)

POWER COMPANY: STANFORD UNIVERSITY

SANTA CLARA VALLEY WATER DISTRICT WATER COMPANY:

# **DRAWING INDEX**

31112121 #	
T-1	TITLE SHEET
GN-1	GENERAL NOTES
A-1	SITE PLAN
A-2	ENLARGED SITE PLAN
A-3	ANTENNA LAYOUT   EQUIPMENT LAYOUT
A-4	ELEVATIONS
A-5	ELEVATIONS
A-6	PHOTO SIMULATION
A-7	PHOTO SIMULATION
D-1	EQUIPMENT DETAILS
D-2	EQUIPMENT DETAILS
D-3	COUNTY DETAILS
TCP-1	TRAFFIC CONTROL PLAN

# **JURISDICTION APPROVAL**

SANTA CLARA COUNTY PLANNING DEPARTMENT 70 W HEDDING ST

7TH FLOOR, EAST WING SAN JOSE, CA 95110

STANFORD UNIVERSITY

PLANNING DEPARTMENT 31160 PORTER DR PALO ALTO, CA 94304

(DATE)

# PROJECT TEAM

ARCHITECTURAL & ENGINEERING CONTACTS:

LEAF COMMUNICATIONS 1000 CALLE CORDILLERA SAN CLEMENTE, CA 92673 DAN LEAF- (949) 485-8793 DAN.LEAF@LEAFCOMM.COM

ENGINEER OF **RECORD CONTACT:** 

LEAF COMMUNICATIONS 1000 CALLE CORDILLERA

> SAN CLEMENTE, CA 92673 ESRA H. PERSELLIN, P.E. - (949) 388-0192 ESRA.PERSELLIN@LEAFCOMM.COM

PROJECT MANAGER

CONTACT:

CROWN CASTLE

1 PARK PL, DUBLIN, CA 94568 JOHN GRIFFITHS

JOHN.GRIFFITHS@CROWNCASTLE.COM

(707) 756-2030

# PROJECT DESCRIPTION

PROJECT CONSISTS OF INSTALLING:

- (2) COMMSCOPE ANTENNAS
- EXISTING COLOR: BROWN
- (1) U/G FIBER TRENCH ±20'-0"; ±60'-0" FIBER RUN

# EQUIPMENT TO BE REMOVED:

- (4) POWERWAVE ANTENNAS
- (2) ERICSSON RADIO UNITS

DESIGN REFERENCE DOCUMENT:

STRUCTURAL ANALYSIS REFERENCE DOCUMENT: RAN 12\_STRUCTURAL ANALYSIS\_20220207 DATED: 02/07/2022

- (1) 40'-0", TBD, DF UTILITY POLE
- (2) ERICSSON RADIO/ANTENNA UNITS
- (2) ERICSSON RADIO UNITS
- NEW ANTENNAS BE PAINTED/WRAPPED TO MATCH
- (1) U/G POWER TRENCH  $\pm 10'$ -0";  $\pm 50'$ -0" POWER RUN

RAN\_12\_Red\_Barn\_01 29 2020\_IRF DATED: 04/14/2022 VERSION: v9

**RESULT: PASS** 

PROJECT TEAM APPROVAL

**EXISTING SITE PHOTO** 

2019 CALIFORNIA PLUMBING CODE 2019 CALIFORNIA ENERGY CODE

2019 NFPA 101 2019 NFPA 72

STANFORD (IT):

**GUP CHECKLIST:** 

(DATE)

2019 NFPA 13 CITY/COUNY ORDINANCES ANSI/TIA-222-H

(DATE)

(DATE)

(DATE)

(DATE)

(DATE)


- TURN RIGHT ONTO JUNIPERO SERRA BLVD

# APPLICABLE CODES/REFERENCE DOCUMENTS

ALL WORK SHALL BE PERFORMED AND MATERIALS INSTALLED IN ACCORDANCE WITH THE CURRENT EDITIONS OF THE FOLLOWING CODES AS ADOPTED BY THE LOCAL GOVERNING AUTHORITIES. NOTHING IN THESE PLANS IS TO BE CONSTRUED TO PERMIT WORK NOT CONFORMING TO THESE CODES:

2019 CALIFORNIA BUILDING CODE 2019 CALIFORNIA ADMINISTRATIVE CODE 2019 CALIFORNIA ELECTRICAL CODE 2019 CALIFORNIA MECHANICAL CODE 2019 CALIFORNIA FIRE CODE

- PRIOR TO ACCESSING/ENTERING THE SITE YOU MUST CONTACT THE CROWN NOC AT (800) 788-7011 & CROWN CONSTRUCTION MANAGER
- THE FACILITY IS UNMANNED AND NOT FOR HUMAN HABITATION. A TECHNICIAN WILL VISIT THE SITE AS REQUIRED FOR ROUTINE MAINTENANCE. THE PROJECT WILL NOT RESULT IN ANY SIGNIFICANT DISTURBANCE OR EFFECT DRAINAGE; NO SANITARY SEWER SERVICE, PORTABLE WATER, OR TRASH DISPOSAL IS REQUIRED AND NO COMMERCIAL SIGNAGE IS PROPOSED.
- ALL DRAWINGS CONTAINED HEREIN ARE FORMATTED FOR FULL SIZE. CONTRACTOR SHALL VERIFY ALL PLANS AND EXISTING DIMENSIONS AND CONDITIONS ON THE JOB SITE AND SHALL IMMEDIATELY NOTIFY THE ENGINEER IN WRITING OF ANY DISCREPANCIES BEFORE PROCEEDING WITH THE WORK OR BE RESPONSIBLE FOR SAME.

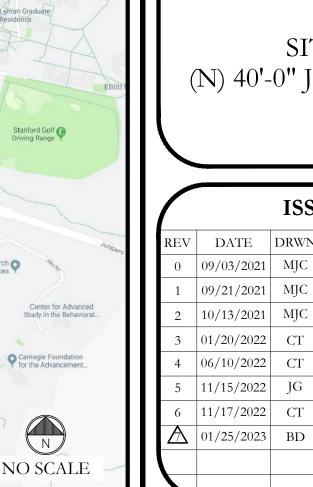





UNLESS THEY ARE ACTING UNDER THE DIRECTION OF A LICENSED PROFESSIONAL ENGINEER, TO ALTER THIS DOCUMENT


> **SHEET TITLE:** TITLE SHEET

**SHEET NUMBER:** 



(800) 227-2600 CALL 3 WORKING DAYS BEFORE YOU DIG!



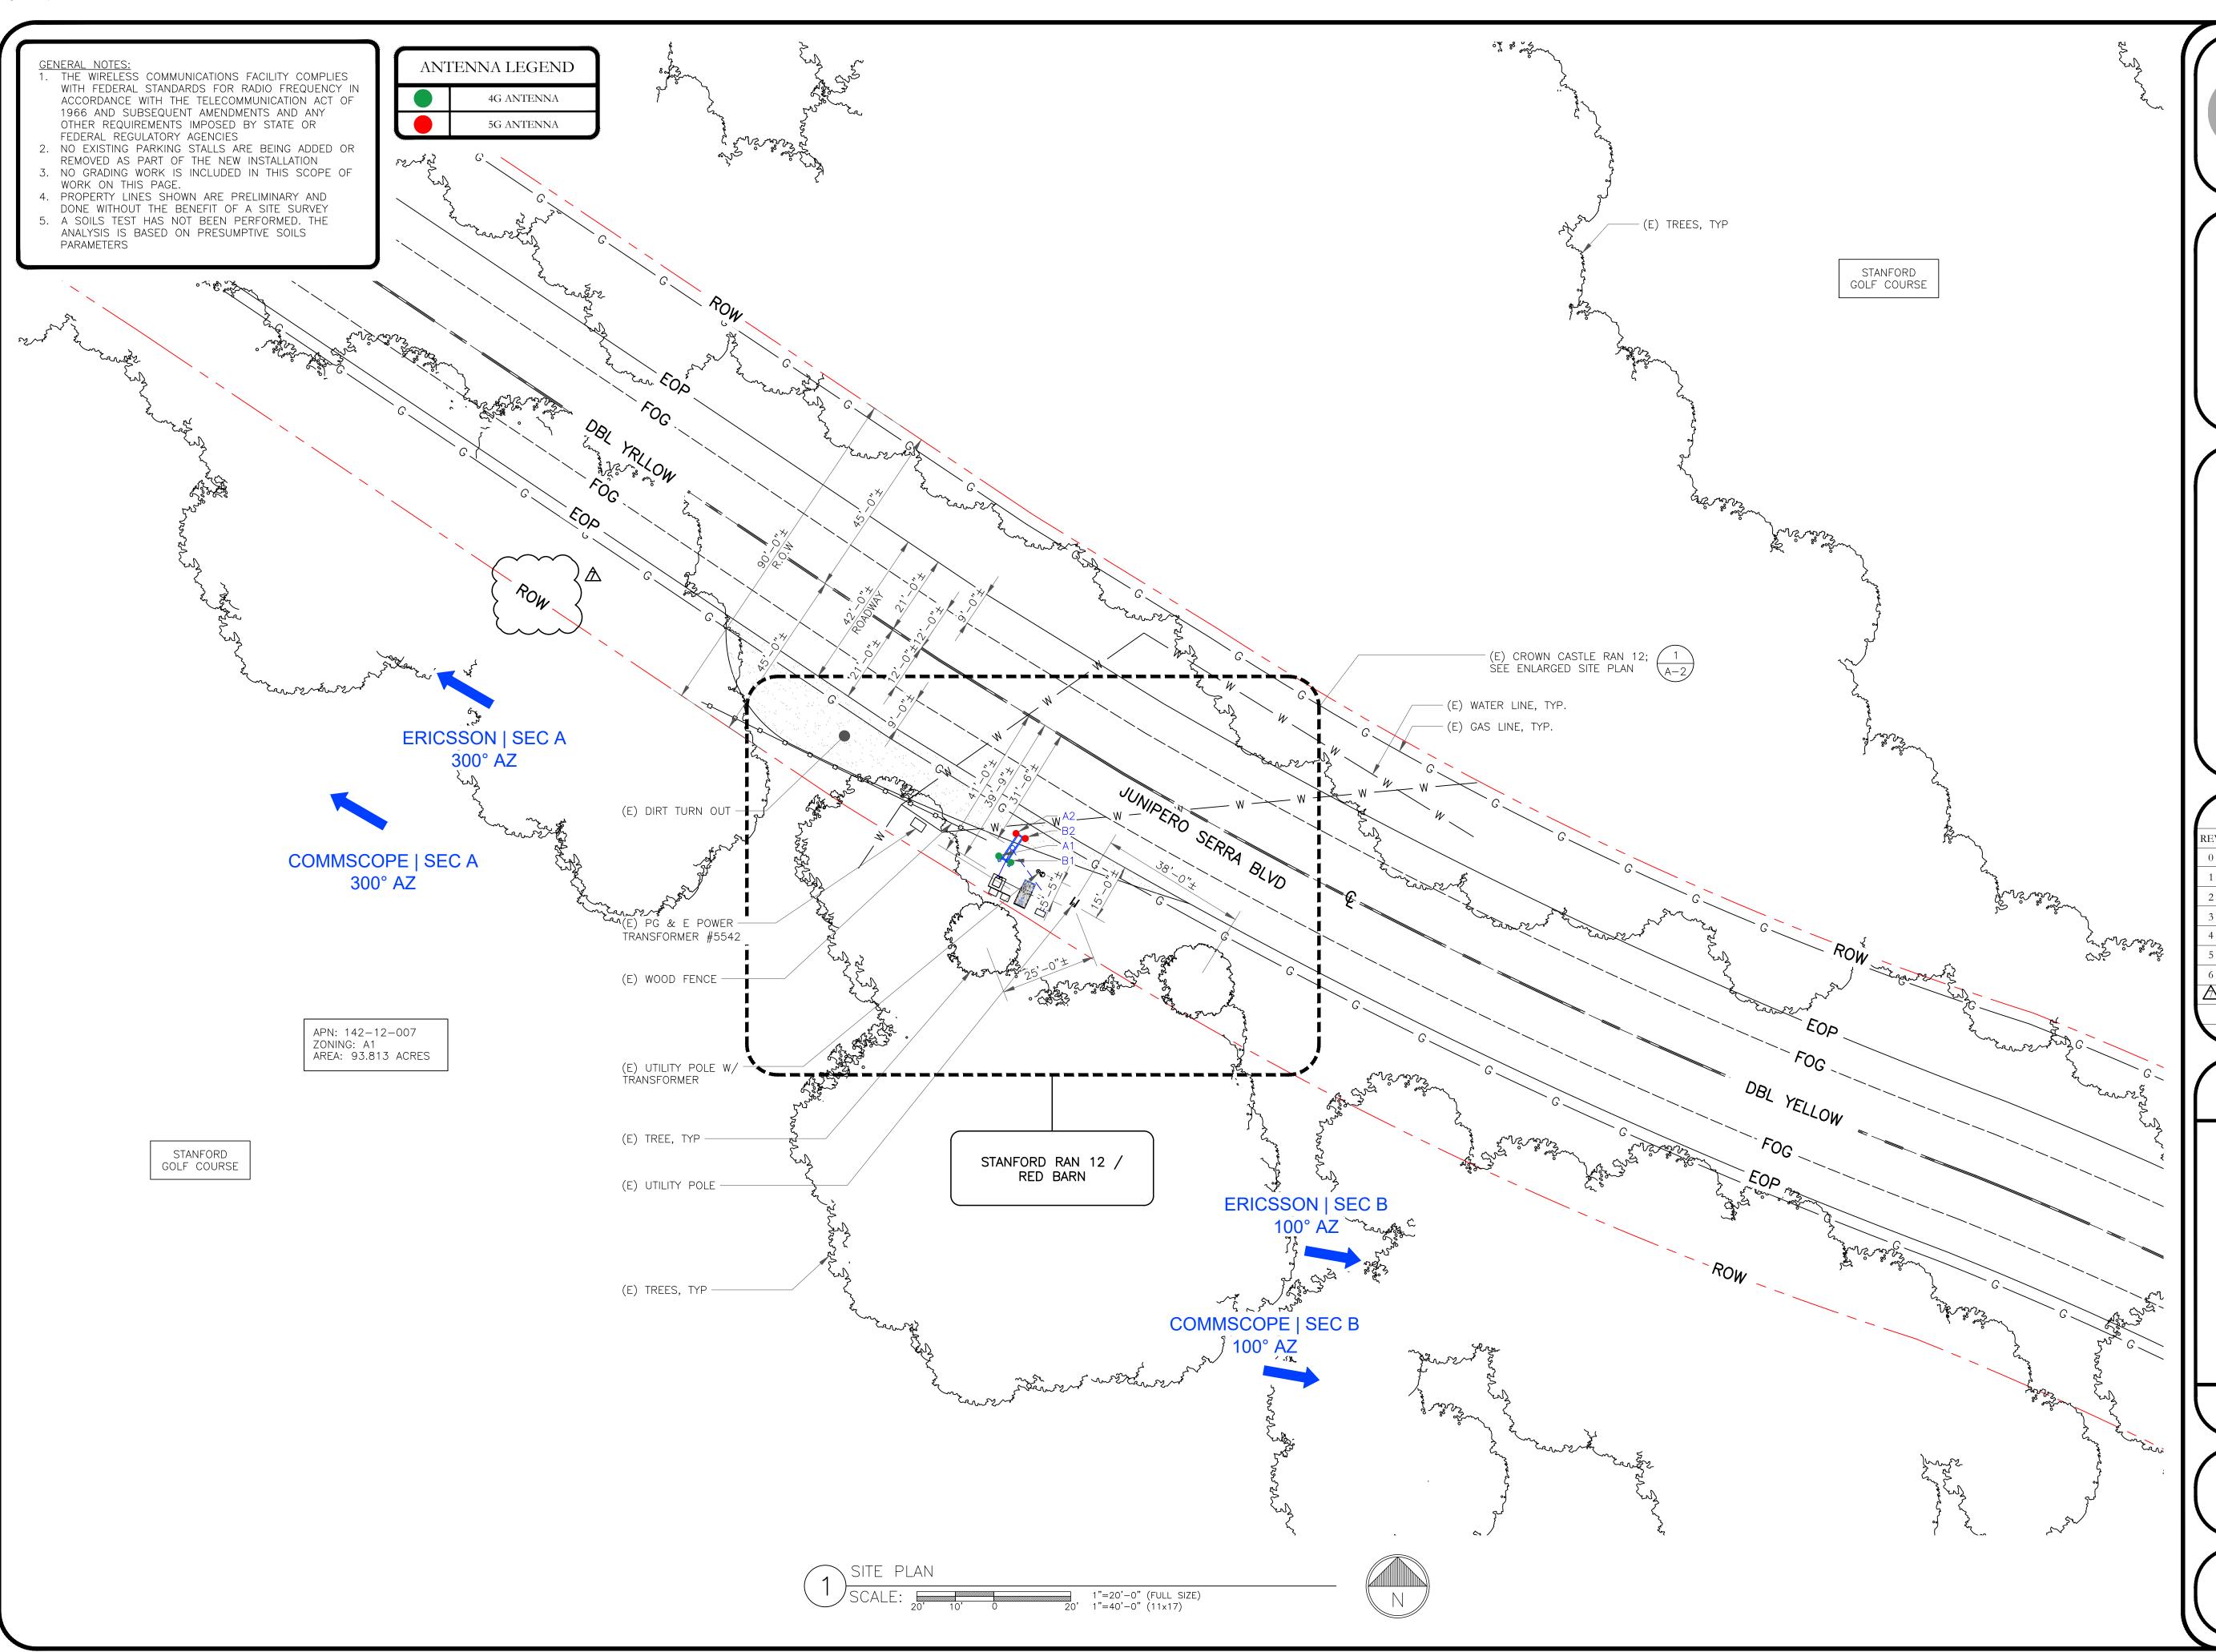





SITE NAME: STANFORD RAN 12 / RED BARN

SITE ADDRESS: 35 VISTA LANE STANFORD, CA 94305

SITE TYPE: (N) 40'-0" JPA WOOD POLE

# **ISSUED FOR:**

	REV	DATE	DRWN	DESCRIPTION	QA
	0	09/03/2021	MJC	90% CONSTRUCTION DWGS	CG
	1	09/21/2021	MJC	90% CD REVISION	CG
	2	10/13/2021	MJC	100% CONSTRUCTION DWGS	CG
	3	01/20/2022	СТ	100% CD CLIENT REVISION	CG
	4	06/10/2022	СТ	100% CD REVISIONS	CG
È	5	11/15/2022	JG	100% CD REVISIONS	CG
	6	11/17/2022	СТ	100% CD REVISIONS	CG
	$\triangle$	01/25/2023	BD	PCC REVISIONS	CG






SIGNED: 2023/01/26 EXPIRES: 2023/09/30

IT IS A VIOLATION OF LAW FOR ANY PERSON, UNLESS THEY ARE ACTING UNDER THE DIRECTION OF A LICENSED PROFESSIONAL ENGINEER, TO ALTER THIS DOCUMENT.

> SHEET TITLE: SITE PLAN

SHEET NUMBER:

1 ( 6

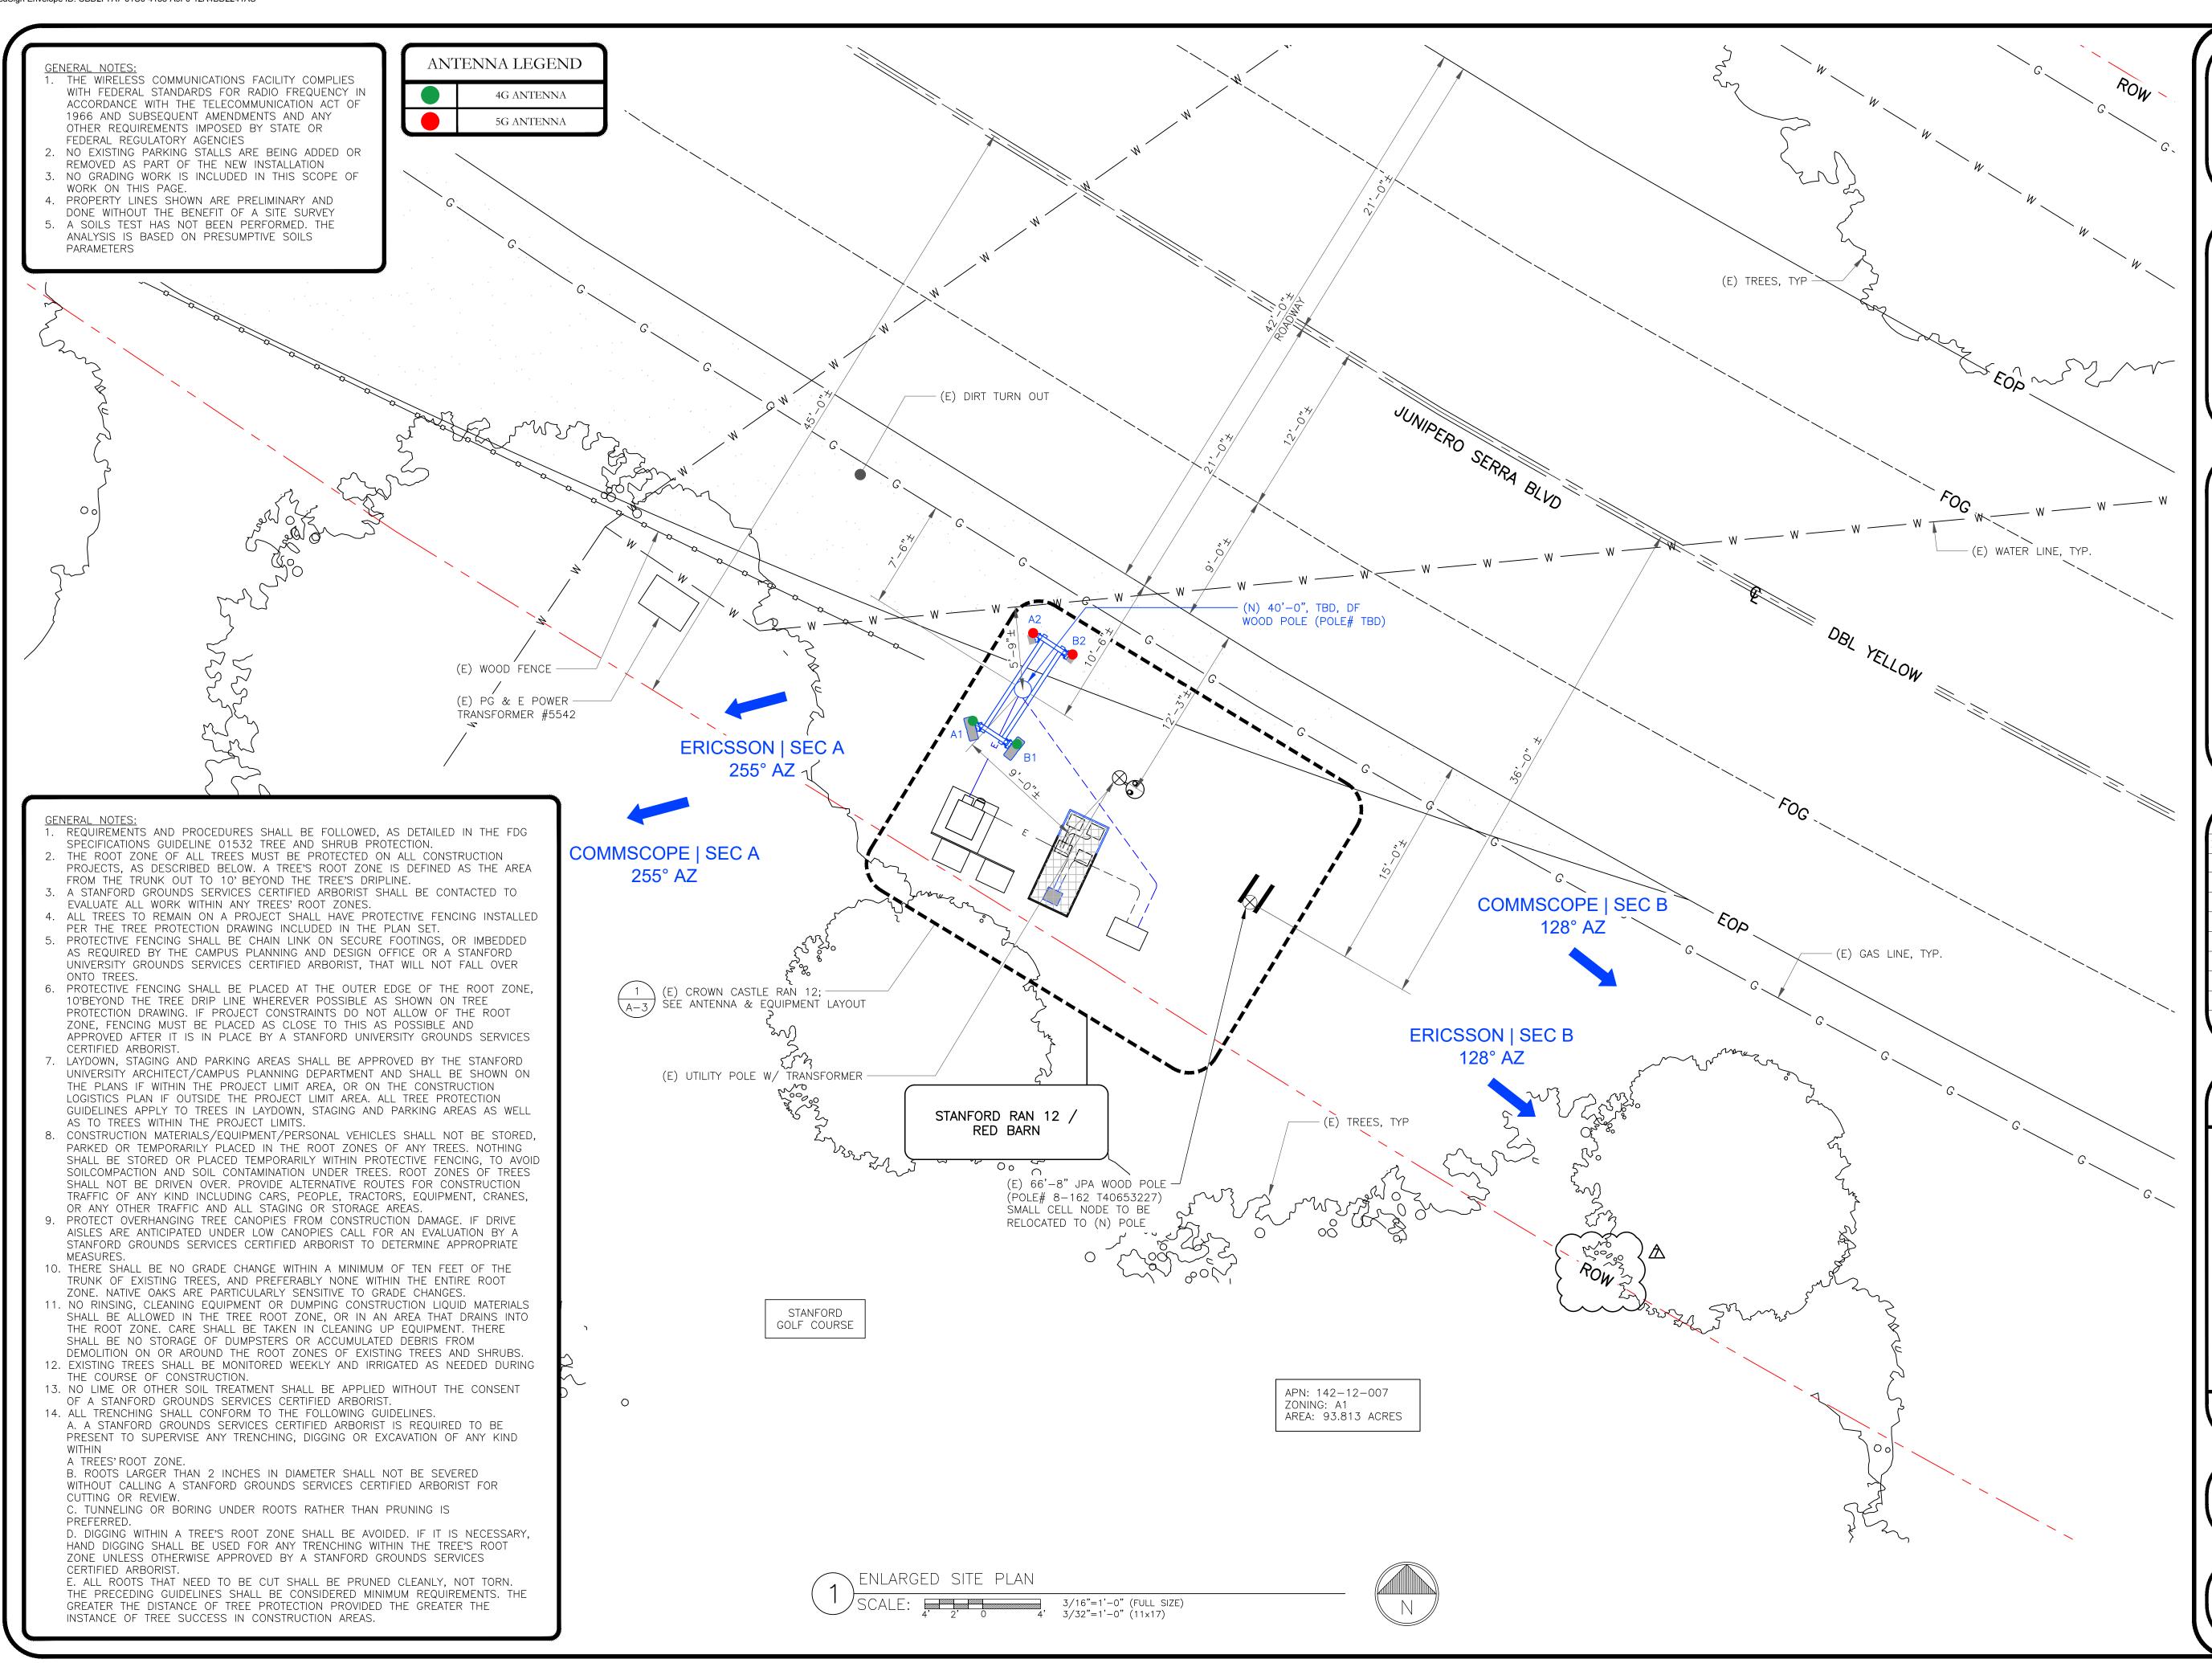





SITE NAME: STANFORD RAN 12 / RED BARN

SITE ADDRESS: 35 VISTA LANE STANFORD, CA 94305

SITE TYPE: (N) 40'-0" JPA WOOD POLE

# ISSUED FOR:

L					
	REV	DATE	DRWN	DESCRIPTION	QA
	0	09/03/2021	MJC	90% CONSTRUCTION DWGS	CG
	1	09/21/2021	MJC	90% CD REVISION	CG
	2	10/13/2021	MJC	100% CONSTRUCTION DWGS	CG
	3	01/20/2022	СТ	100% CD CLIENT REVISION	CG
	4	06/10/2022	СТ	100% CD REVISIONS	CG
	5	11/15/2022	JG	100% CD REVISIONS	CG
I	6	11/17/2022	СТ	100% CD REVISIONS	CG
	$\triangle$	01/25/2023	BD	PCC REVISIONS	CG
1					
•					






EXPIRES: 2023/09/30

IT IS A VIOLATION OF LAW FOR ANY PERSON, UNLESS THEY ARE ACTING UNDER THE DIRECTION OF A LICENSED PROFESSIONAL ENGINEER, TO ALTER THIS DOCUMENT.

SHEET TITLE:
ENLARGED SITE PLAN

SHEET NUMBER:

-2 (6

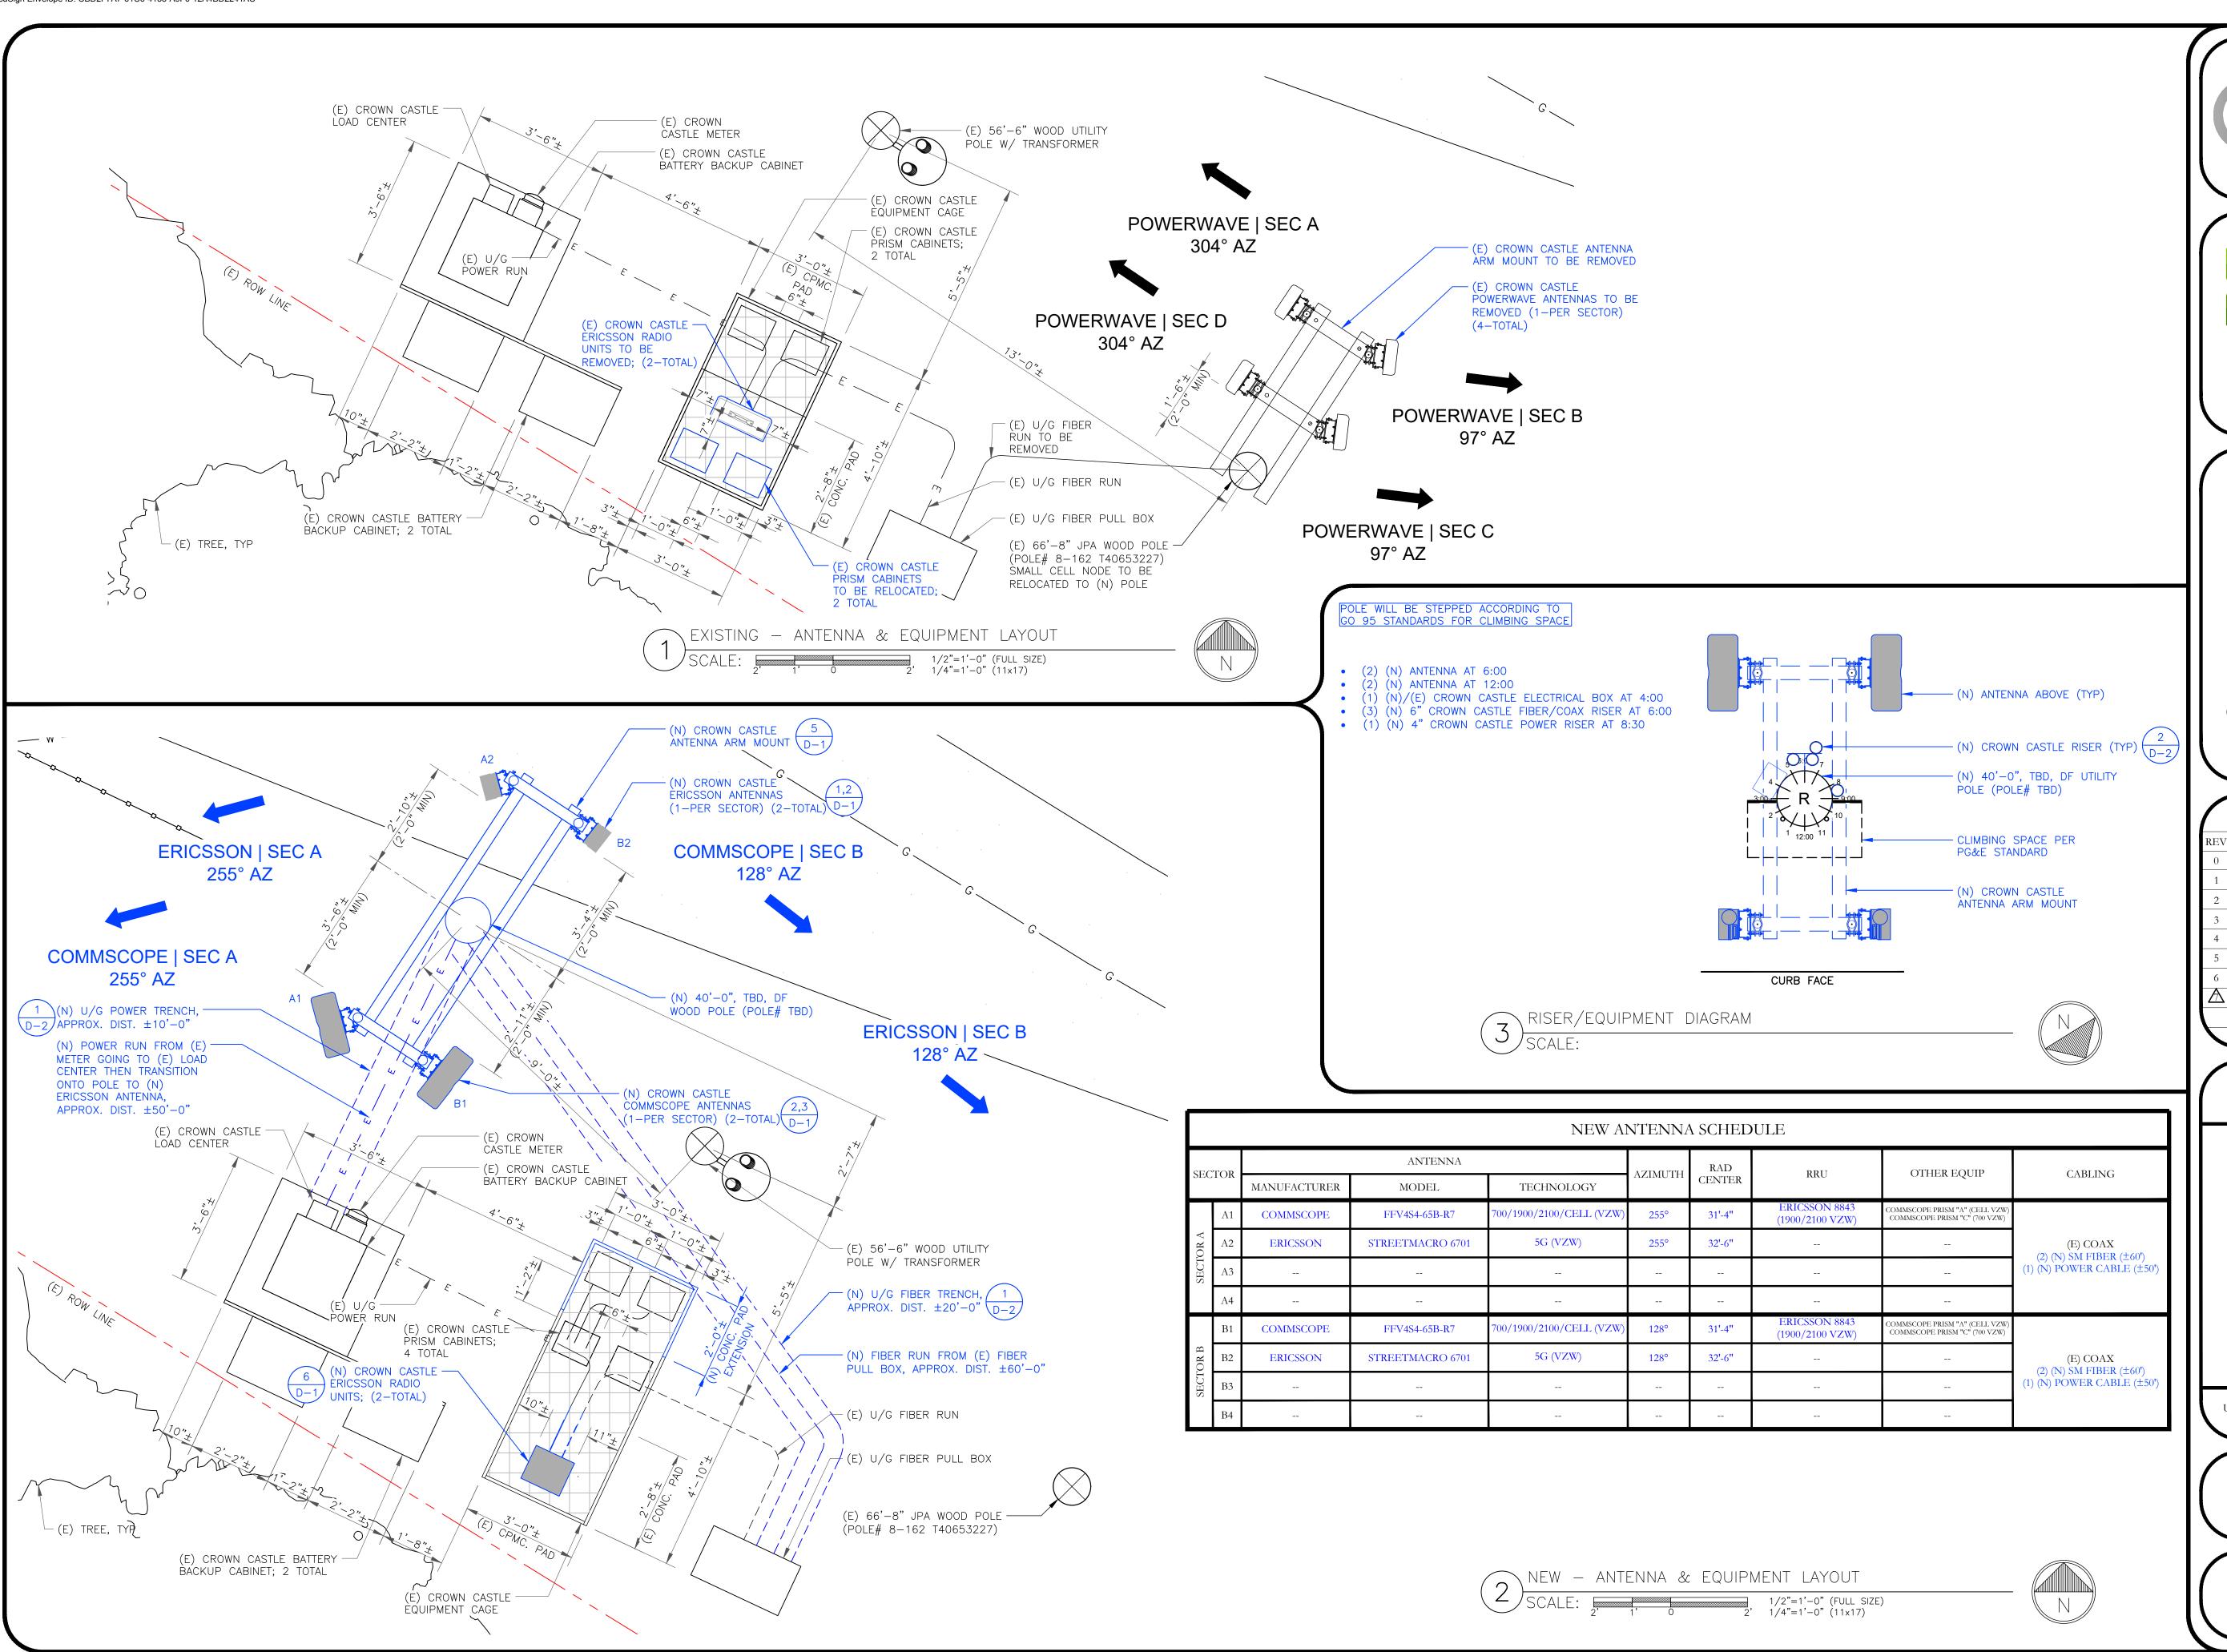





SITE NAME: STANFORD RAN 12 / RED BARN

SITE ADDRESS: 35 VISTA LANE STANFORD, CA 94305

SITE TYPE: (N) 40'-0" JPA WOOD POLE

		ISS	UED FOR:	
REV	DATE	DRWN	DESCRIPTION	QA
0	09/03/2021	MJC	90% CONSTRUCTION DWGS	CG
1	09/21/2021	MJC	90% CD REVISION	CG
2	10/13/2021	MJC	100% CONSTRUCTION DWGS	CG
3	01/20/2022	СТ	100% CD CLIENT REVISION	CG
4	06/10/2022	СТ	100% CD REVISIONS	CG
5	11/15/2022	JG	100% CD REVISIONS	CG
6	11/17/2022	СТ	100% CD REVISIONS	CG
$\triangle$	01/25/2023	BD	PCC REVISIONS	CG
•				





SIGNED: 2023/01/26 EXPIRES: 2023/09/30

IT IS A VIOLATION OF LAW FOR ANY PERSON, UNLESS THEY ARE ACTING UNDER THE DIRECTION OF A LICENSED PROFESSIONAL ENGINEER, TO ALTER THIS DOCUMENT.


SHEET TITLE:


ANTENNA LAYOUT |

EQUIPMENT LAYOUT

SHEET NUMBER:

-3

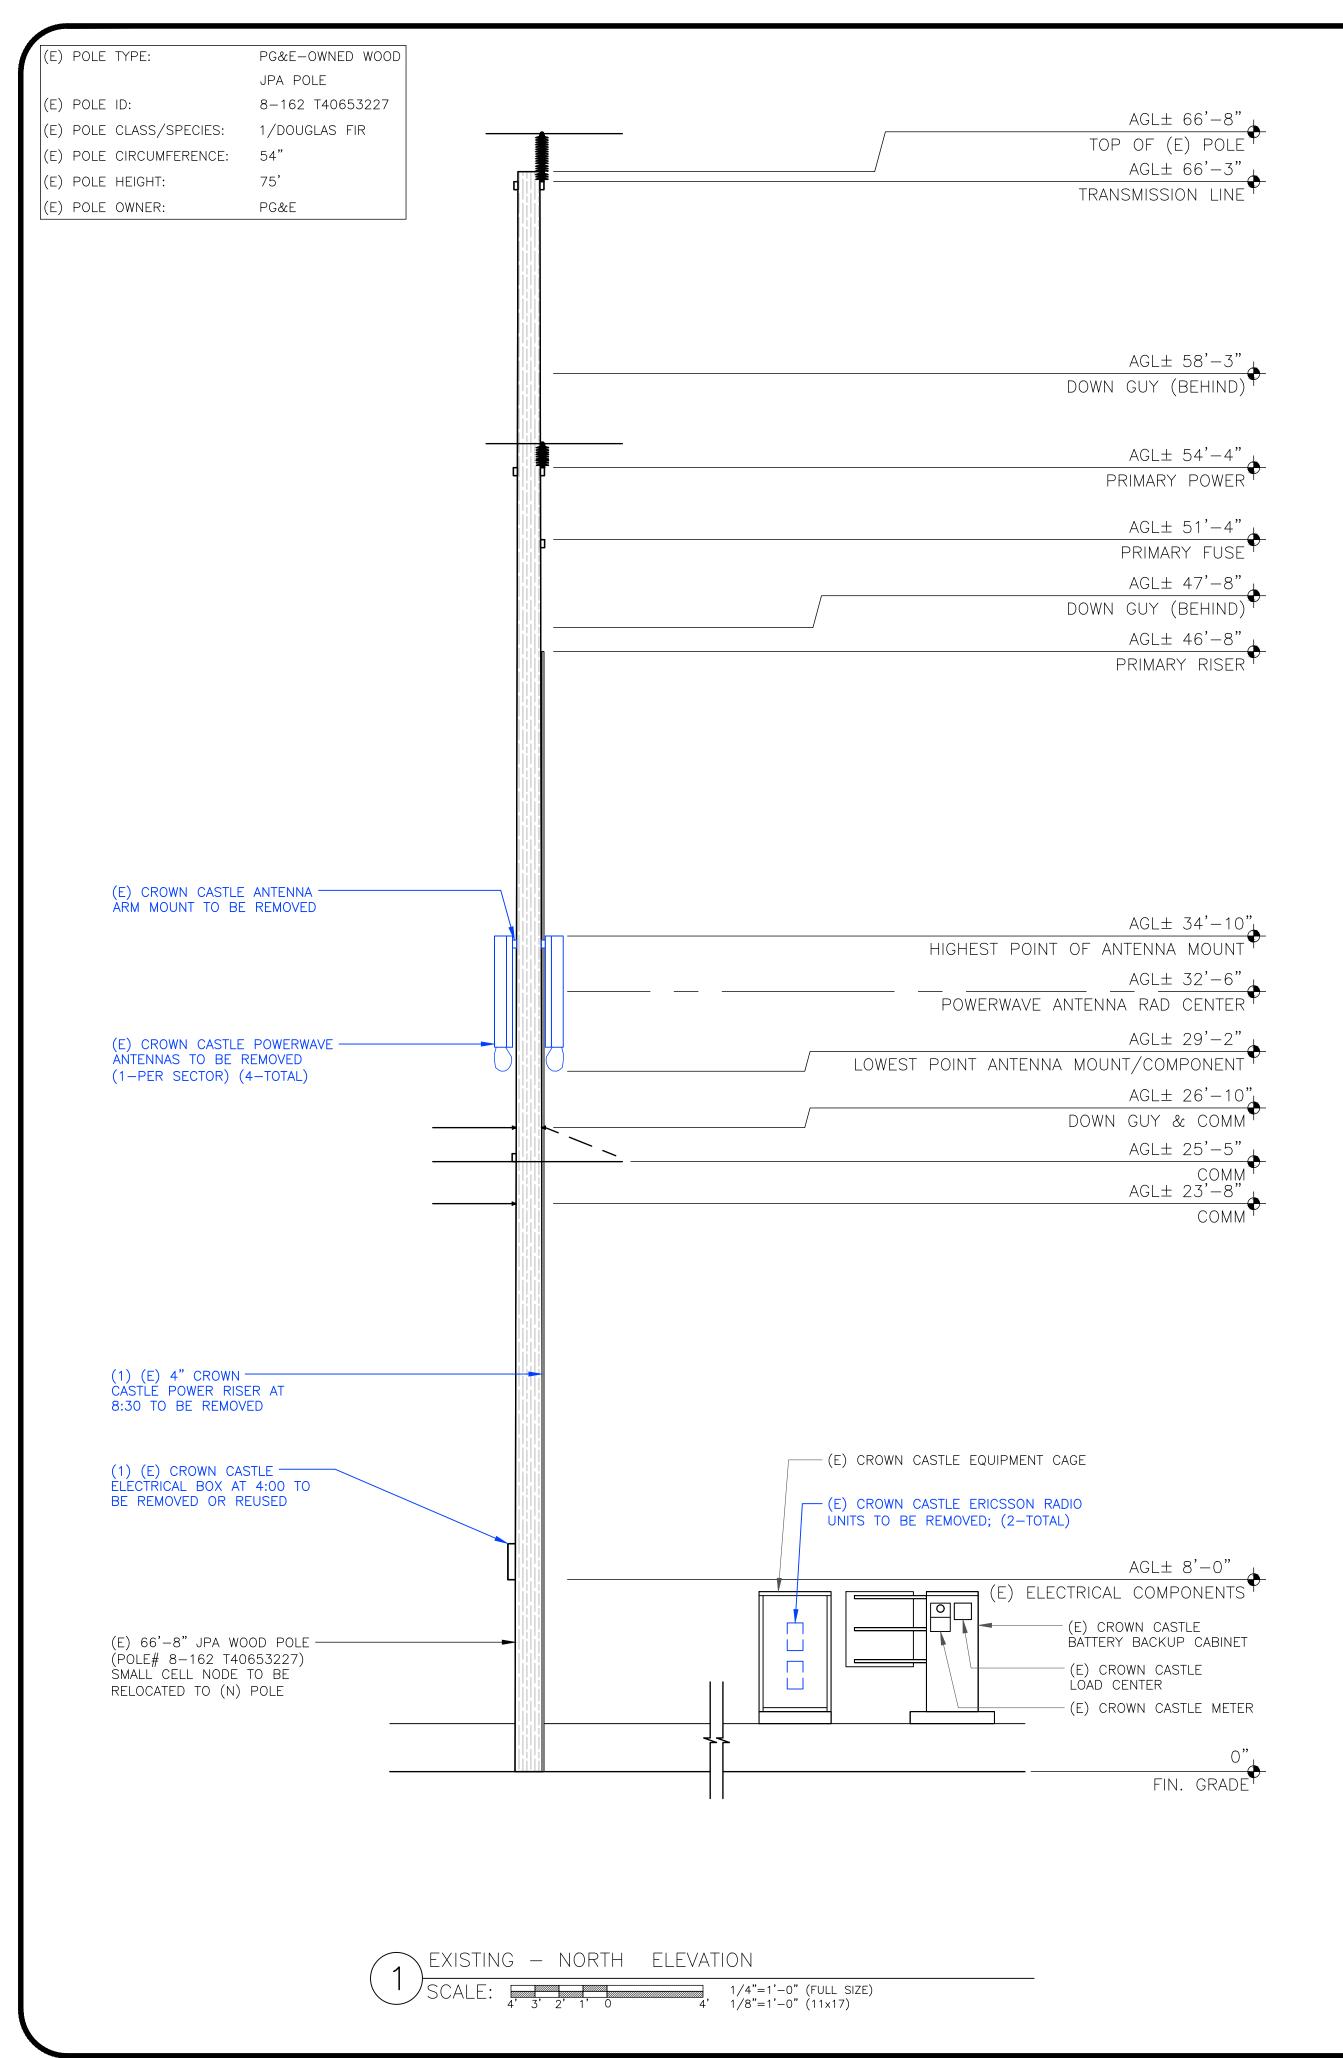


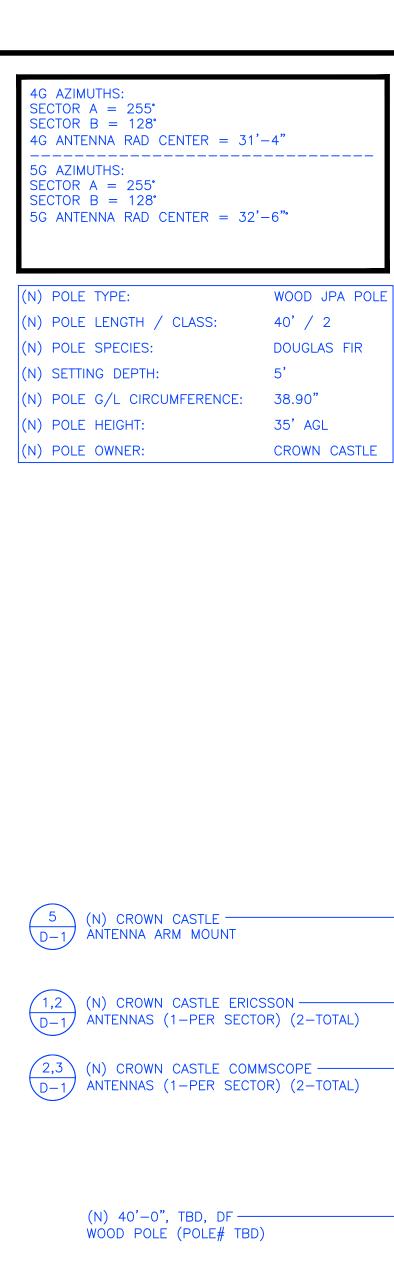

(N) POWER RUN FROM (E) — METER GOING TO (E) LOAD CENTER THEN TRANSITION

ONTO POLE TO (N) ERICSSON ANTENNA,

APPROX. DIST.  $\pm 50'-0$ "

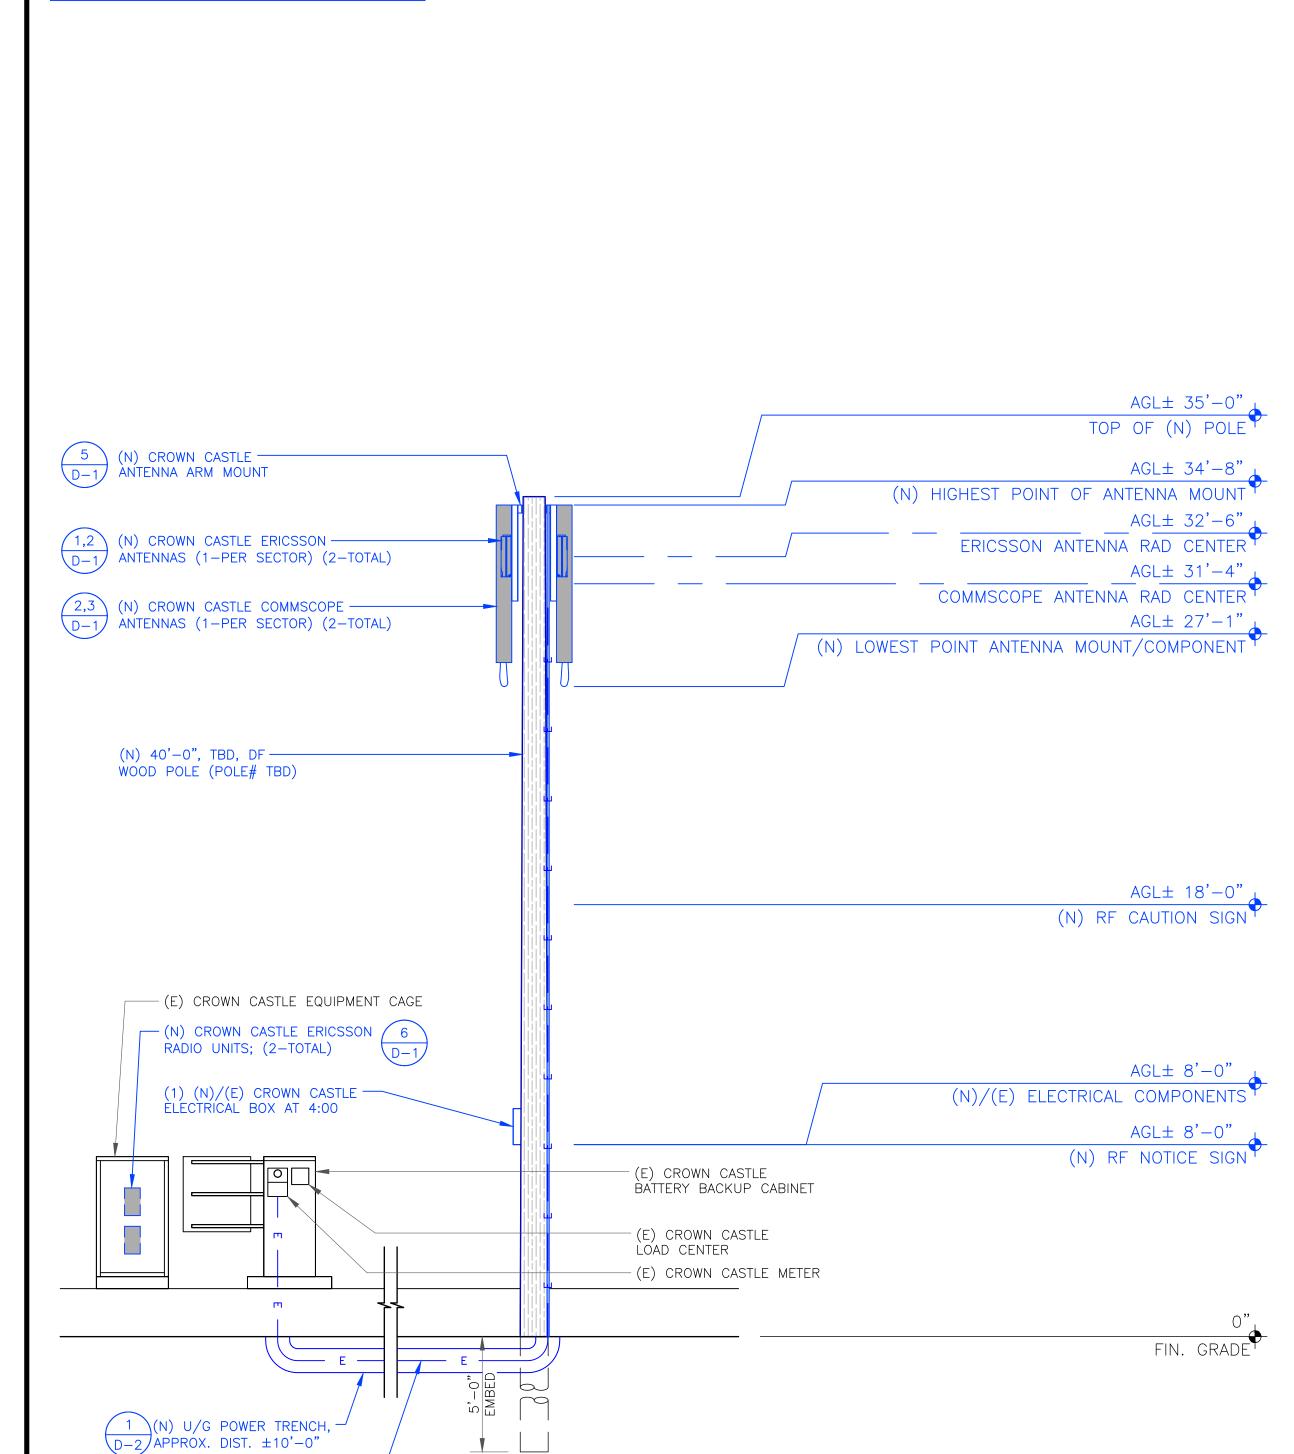

NEW - NORTH ELEVATION





1000 CALLE CORDILLERA SAN CLEMENTE, CA 92673 WWW.LEAFCOMM.COM TEL: (949) 388-0192

SITE NAME: STANFORD RAN 12 / RED BARN

SITE ADDRESS: 35 VISTA LANE STANFORD, CA 94305

SITE TYPE: (N) 40'-0" JPA WOOD POLE

# **ISSUED FOR:**

/	1000EB 1 OII.			
REV	DATE	DRWN	DESCRIPTION	QA
0	09/03/2021	MJC	90% CONSTRUCTION DWGS	CG
1	09/21/2021	MJC	90% CD REVISION	CG
2	10/13/2021	MJC	100% CONSTRUCTION DWGS	CG
3	01/20/2022	СТ	100% CD CLIENT REVISION	CG
4	06/10/2022	СТ	100% CD REVISIONS	CG
5	11/15/2022	JG	100% CD REVISIONS	CG
6	11/17/2022	СТ	100% CD REVISIONS	CG
$\triangle$	01/25/2023	BD	PCC REVISIONS	CG
				1







EXPIRES: 2023/09/30

IT IS A VIOLATION OF LAW FOR ANY PERSON, UNLESS THEY ARE ACTING UNDER THE DIRECTION OF A LICENSED PROFESSIONAL ENGINEER, TO ALTER THIS DOCUMENT.

> SHEET TITLE: **ELEVATIONS**


SHEET NUMBER:

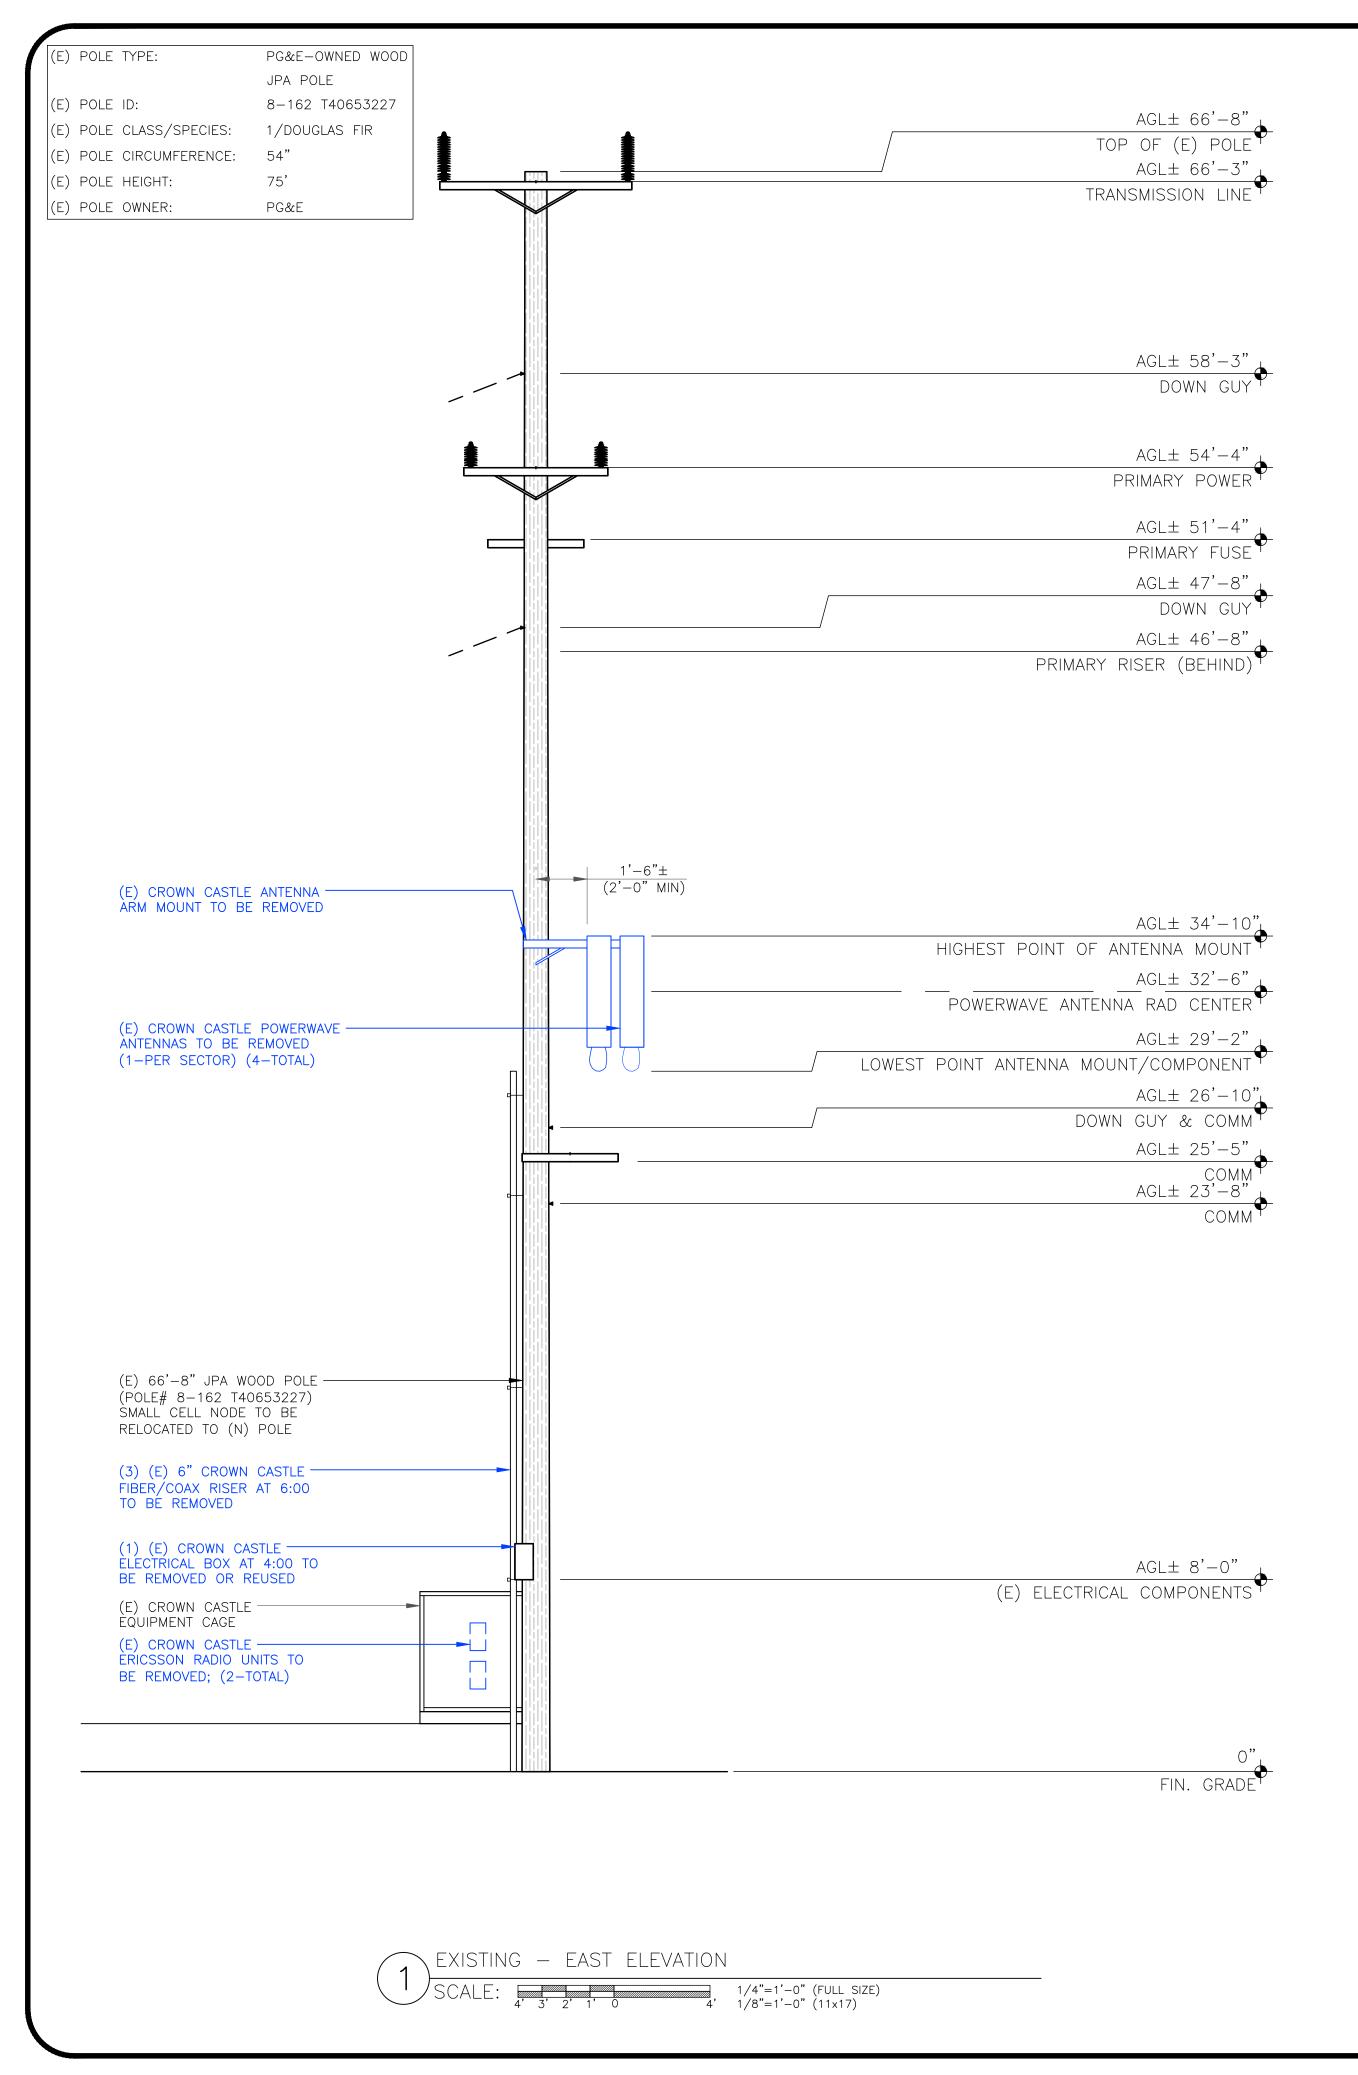

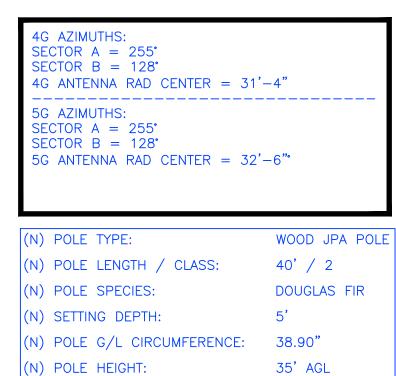

CROWN CASTLE

(N) POLE OWNER:

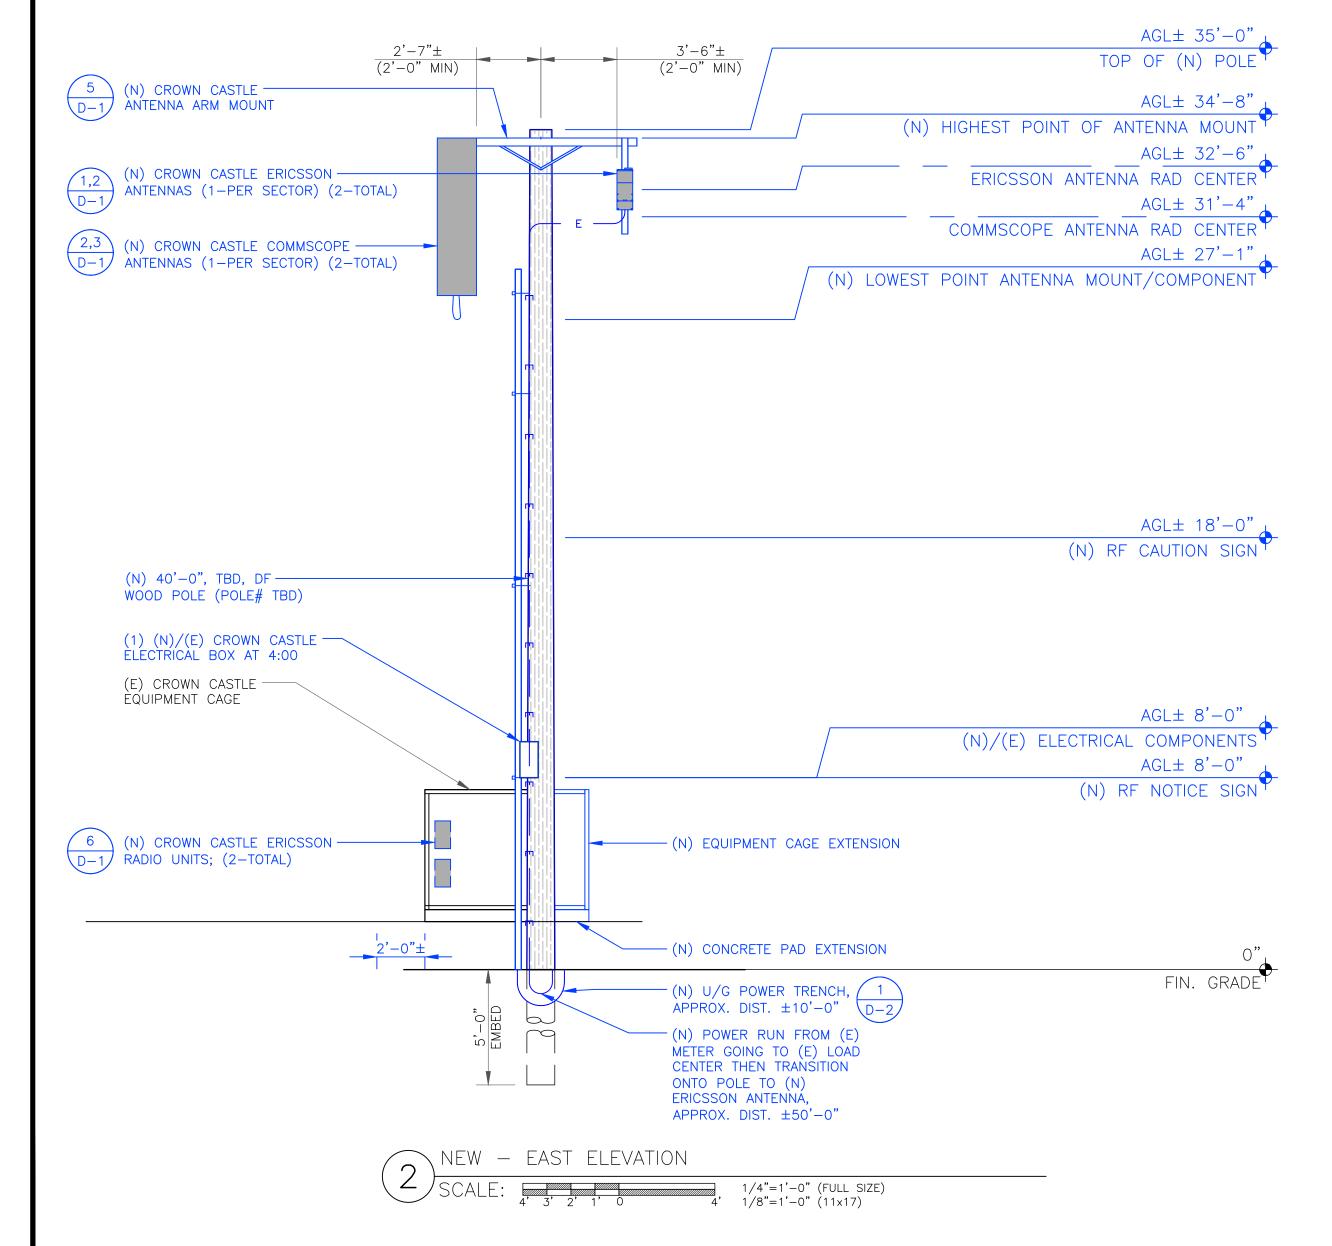





1000 CALLE CORDILLERA SAN CLEMENTE, CA 92673 WWW.LEAFCOMM.COM TEL: (949) 388-0192

SITE NAME: STANFORD RAN 12 / RED BARN

SITE ADDRESS: 35 VISTA LANE STANFORD, CA 94305

SITE TYPE: (N) 40'-0" JPA WOOD POLE

# **ISSUED FOR:**

REV	DATE	DRWN	DESCRIPTION	QA
0	09/03/2021	MJC	90% CONSTRUCTION DWGS	CG
1	09/21/2021	MJC	90% CD REVISION	CG
2	10/13/2021	MJC	100% CONSTRUCTION DWGS	CG
3	01/20/2022	СТ	100% CD CLIENT REVISION	CG
4	06/10/2022	СТ	100% CD REVISIONS	CG
5	11/15/2022	JG	100% CD REVISIONS	CG
6	11/17/2022	СТ	100% CD REVISIONS	CG
$\triangle$	01/25/2023	BD	PCC REVISIONS	CG





EXPIRES: 2023/09/30


IT IS A VIOLATION OF LAW FOR ANY PERSON, UNLESS THEY ARE ACTING UNDER THE DIRECTION OF A LICENSED PROFESSIONAL ENGINEER, TO ALTER THIS DOCUMENT.


> SHEET TITLE: ELEVATIONS

SHEET NUMBER:

REV:



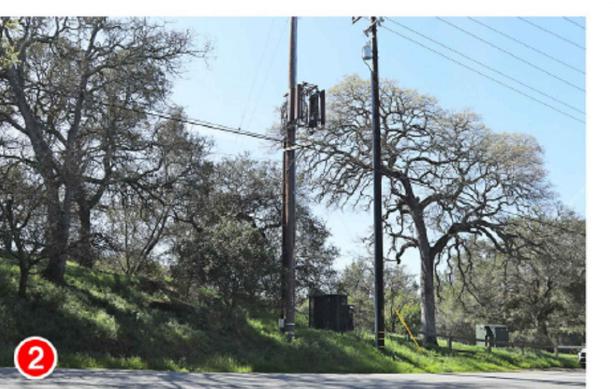

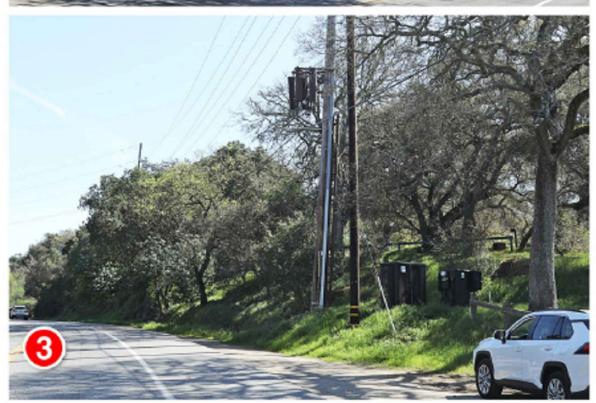



CROWN 2/4/22


Stanford RAN 12 / Red Barn

Aerial Map

160 Junipero Serra Blvd Stanford, CA

Applied Imagination 510 914-0500

AERIAL MAP SCALE: N.T.S

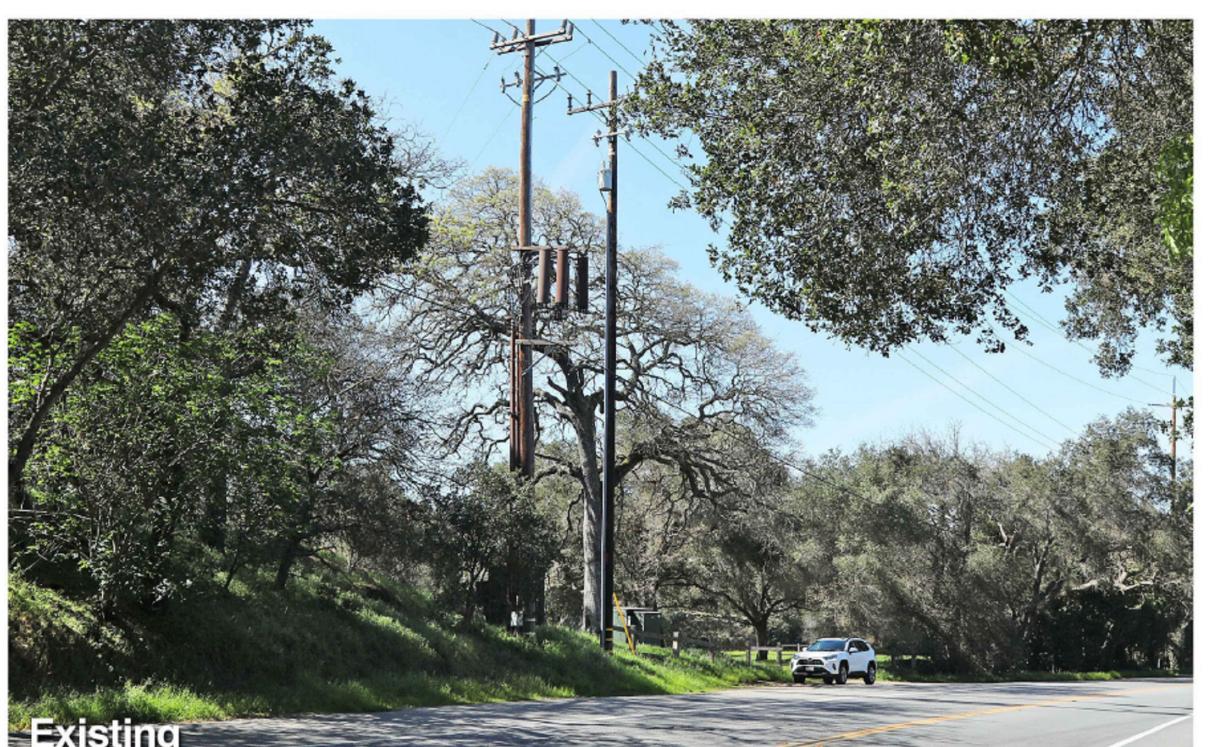



CROWN 2/4/22

Stanford RAN 12 / Red Barn

160 Junipero Serra Blvd Stanford, CA

Looking Northwest from Junipero Serra Blvd

View #1 Applied Imagination 510 914-0500

> SHEET TITLE: PHOTO SIMULATION

> > SHEET NUMBER:

SIGNED: 2023/01/26 EXPIRES: 2023/09/30

IT IS A VIOLATION OF LAW FOR ANY PERSON, UNLESS THEY ARE ACTING UNDER THE DIRECTION OF A LICENSED PROFESSIONAL ENGINEER, TO ALTER THIS DOCUMENT.

CROWN CASTLE

1 PARK PLACE PLACE DUBLIN, CA 94568

1000 CALLE CORDILLERA SAN CLEMENTE, CA 92673 WWW.LEAFCOMM.COM TEL: (949) 388-0192

SITE NAME:

STANFORD RAN 12 /

RED BARN

SITE ADDRESS:

35 VISTA LANE

STANFORD, CA 94305

SITE TYPE:

(N) 40'-0" JPA WOOD POLE

**ISSUED FOR:** 

09/03/2021 MJC 90% CONSTRUCTION DWGS

100% CD REVISIONS 100% CD REVISIONS

PCC REVISIONS

PHOTO SIMULATION - VIEW #1
SCALE: N T S







Stanford RAN 12 / Red Barn


PHOTO SIMULATION - VIEW #2

160 Junipero Serra Blvd Stanford, CA

SCALE: N.T.S

CROWN

2/4/22

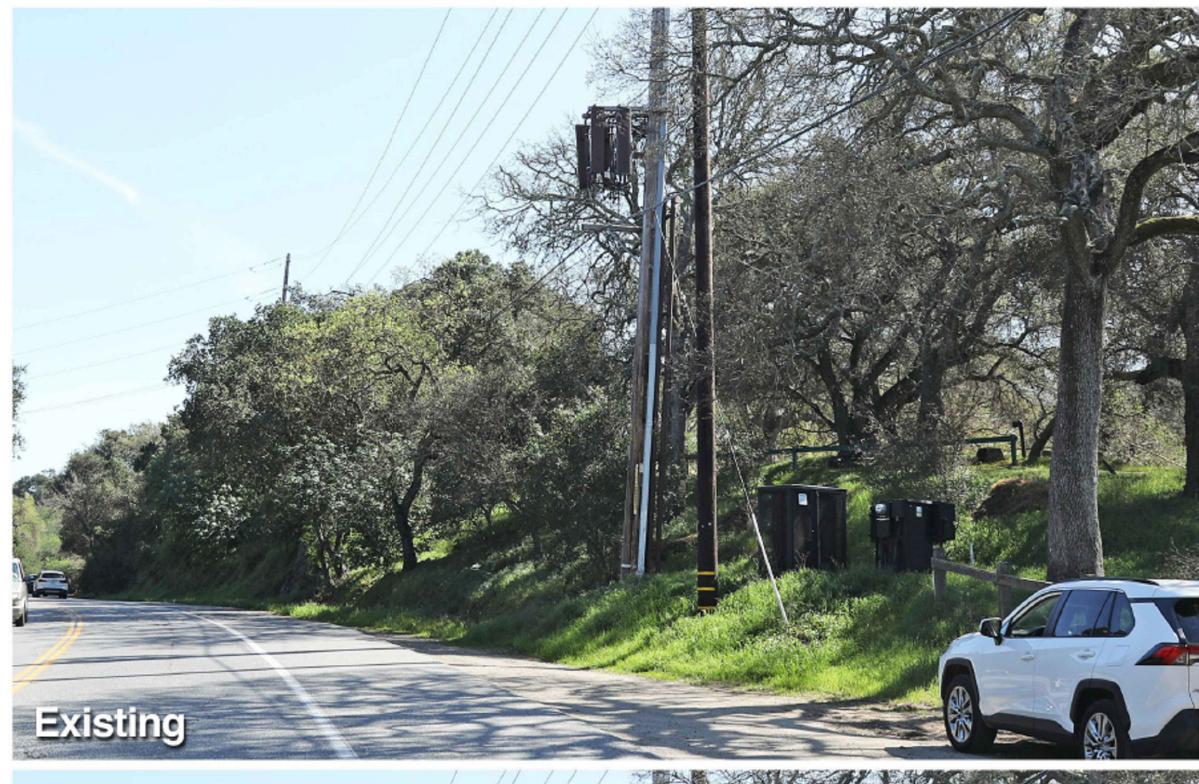



CROWN CASTLE 2/4/22

Looking Northwest from Junipero Serra Blvd

View #2

Applied Imagination 510 914-0500

Stanford RAN 12 / Red Barn

Looking South from Junipero Serra Blvd

160 Junipero Serra Blvd Stanford, CA

View #3 Applied Imagination 510 914-0500

PHOTO SIMULATION - VIEW #3

SCALE: N.T.S





1000 CALLE CORDILLERA SAN CLEMENTE, CA 92673 WWW.LEAFCOMM.COM TEL: (949) 388-0192

SITE NAME: STANFORD RAN 12 / RED BARN

SITE ADDRESS: 35 VISTA LANE STANFORD, CA 94305

SITE TYPE: (N) 40'-0" JPA WOOD POLE

# ISSUED FOR:

1				,
REV	DATE	DRWN	DESCRIPTION	QA
0	09/03/2021	MJC	90% CONSTRUCTION DWGS	CG
1	09/21/2021	MJC	90% CD REVISION	CG
2	10/13/2021	MJC	100% CONSTRUCTION DWGS	CG
3	01/20/2022	СТ	100% CD CLIENT REVISION	CG
4	06/10/2022	СТ	100% CD REVISIONS	CG
5	11/15/2022	JG	100% CD REVISIONS	CG
6	11/17/2022	СТ	100% CD REVISIONS	CG
$\triangle$	01/25/2023	BD	PCC REVISIONS	CG
				1






SIGNED: 2023/01/26 EXPIRES: 2023/09/30

IT IS A VIOLATION OF LAW FOR ANY PERSON, UNLESS THEY ARE ACTING UNDER THE DIRECTION OF A LICENSED PROFESSIONAL ENGINEER, TO ALTER THIS DOCUMENT.

SHEET TITLE:
PHOTO SIMULATION

SHEET NUMBER:

REV:

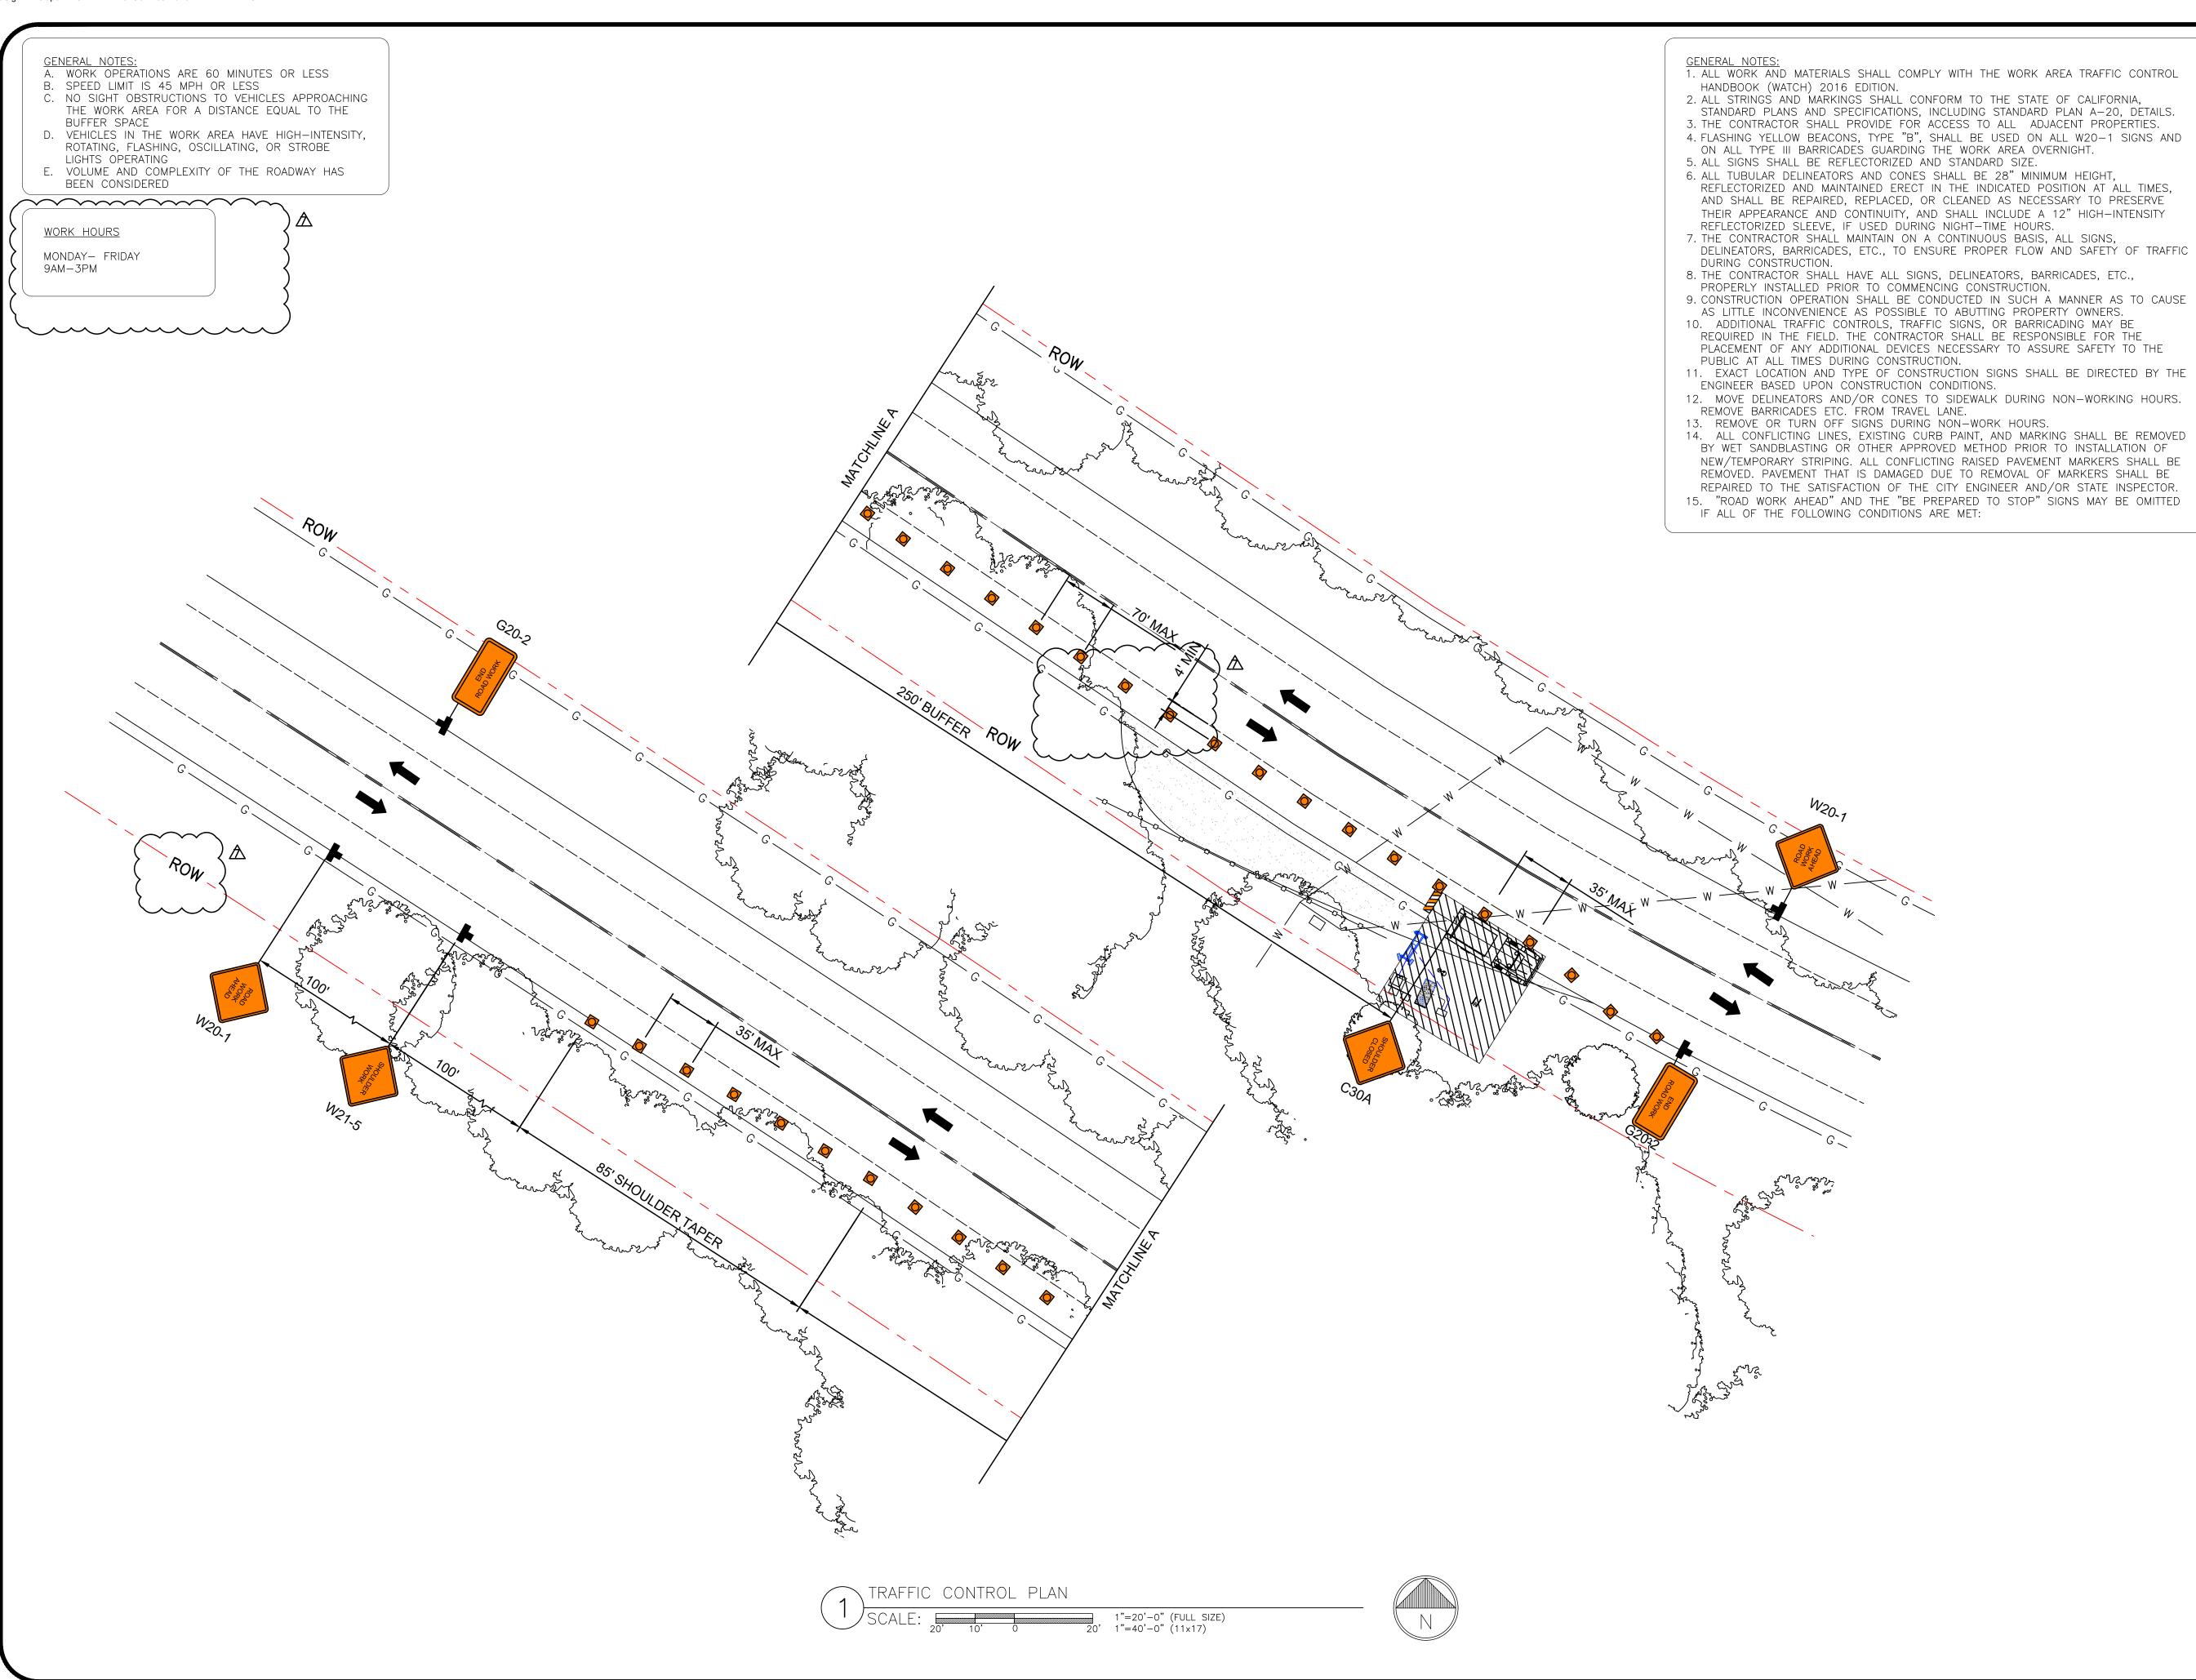





SITE NAME: STANFORD RAN 12 / RED BARN

SITE ADDRESS: 35 VISTA LANE STANFORD, CA 94305

SITE TYPE: (N) 40'-0" JPA WOOD POLE

# **ISSUED FOR:**

	REV	DATE	DRWN	DESCRIPTION	QA
	0	09/03/2021	MJC	90% CONSTRUCTION DWGS	CG
	1	09/21/2021	MJC	90% CD REVISION	CG
	2	10/13/2021	MJC	100% CONSTRUCTION DWGS	CG
	3	01/20/2022	СТ	100% CD CLIENT REVISION	CG
	4	06/10/2022	СТ	100% CD REVISIONS	CG
	5	11/15/2022	JG	100% CD REVISIONS	CG
	6	11/17/2022	СТ	100% CD REVISIONS	CG
	$\triangle$	01/25/2023	BD	PCC REVISIONS	CG
١					





EXPIRES: 2023/09/30

IT IS A VIOLATION OF LAW FOR ANY PERSON,
JNLESS THEY ARE ACTING UNDER THE DIRECTION
OF A LICENSED PROFESSIONAL ENGINEER,
TO ALTER THIS DOCUMENT

SHEET TITLE:
TRAFFIC CONTROL PLAN

SHEET NUMBER:

6 REV:

## $\underline{\textbf{ATTACHMENT E}}$

Extension of Small Cell Facility 90-day Shot Clock Deadline

From: Schneider, Tabitha

To: Ahluwalia, Charu

Subject: [EXTERNAL] RE: PLN23-011\_New Wireless Telecommunication Facility (Stanford)\_Extension of Time Request

**Date:** Wednesday, March 15, 2023 8:51:35 AM

Attachments: image002.png

image003.png

Hello Charu,

The Applicant is granting a 45-day extension of time to the 90-day shot clock for the new wireless telecommunication facility located on Junipero Serra Blvd. (Record No. PLN23-011. I will send a more formalized letter on our Crown Castle letterhead as a followup. Thanks for reaching out and let me know if you need anything else.

### **Tabitha Schneider**

Supervisor Network Permitting

### **Crown Castle**

1 Park Place, Suite 300, Dublin, Ca. 94568

CrownCastle.com
CROWN
CASTLE

From:

**Sent:** Friday, March 10, 2023 1:37 PM

To: Schneider, Tabitha

Subject: PLN23-011\_New Wireless Telecommunication Facility (Stanford)\_Extension of Time

Request

**CAUTION:** This email originated from outside of the organization. Do not click links or open attachments unless you recognize the sender and know the content is safe.

Hi Tabitha,

As discussed on call this afternoon, County Staff is requesting a 45-day extension to the 90-day shot clock for the new wireless telecommunication facility located on Junipero Serra Blvd. (Record No. PLN23-011). The application was deemed complete on Feb 17, 2023 (intake date Jan 19, 2023), and the 90 day shot-clock ends on April 19, 2023. With the 45-day extension, the new deadline would be **June 3, 2023**.

Hope you can provide a response to this extension request by Tuesday, March 14, 2023.

You can respond to this email with the following: "The Applicant is granting a 45-day extension of time to the 90-day shot clock for the new wireless telecommunication facility located on Junipero Serra Blvd. (Record No. PLN23-011).

Let me know if you have any questions.

Best,



### **CHARU AHLUWALIA**

Senior Planner

Department of Planning and Development County of Santa Clara 70 W. Hedding Street | 7th Floor | East Wing

San Jose | CA 95110 Phone: (408) 299-5740 charu.ahluwalia@pln.sccgov.org

This email may contain confidential or privileged material. Use or disclosure of it by anyone other than the recipient is unauthorized. If you are not an intended recipient, please delete this email.