
GENERAL NOTES

- IT IS THE RESPONSIBILITY OF THE CONTRACTOR AND SUBCONTRACTORS TO CHECK AND VERIFY ALL DIMENSIONS AND CONDITIONS INDICATED ON THESE DRAWINGS AND MAKE KNOWN ANY DISCREPANCIES PRIOR TO COMMENCING THEIR WORK.
- THESE DRAWINGS ARE INTENDED FOR USE IN A NEGOTIATED CONSTRUCTION CONTRACT AND, THEREFORE, MAY NOT SPECIFICALLY DETAILS OR SPECIFY MATERIALS AND/OR MANUFACTURERS.
- THE CONTRACTOR SHALL PROVIDE ALL SAMPLES AND/OR CUT-SHEETS AS REQUIRED TO ASSIST OWNER OR HIS AGENT IN MAKING MATERIAL SELECTIONS.
- FOR THE PURPOSE OF ESTIMATING, THE CONTRACTORS SHALL USE THE MATERIALS SELECTED BY THE OWNER, OR IN ABSENCE OF SAME, HE SHALL PROVIDE AN ALLOWANCE AMOUNT AND SO CONDITION ANY COST ESTIMATE.
- ALL MATERIALS SPECIFIED IN THESE DRAWINGS SHALL BE INCLUDED IN SUCH
- NO GUARANTEE OF QUALITY OF CONSTRUCTION IS IMPLIED OR INTENDED BY THE CONSTRUCTION DOCUMENTS, AND THE CONTRACTOR SHALL ASSUME FULL RESPONSIBILITY FOR ANY OR ALL CONSTRUCTION DEFICIENCIES.
- THE GENERAL CONTRACTOR SHALL HOLD HARMLESS, INDEMNIFY AND DEFEND THE DESIGNER/ARCHITECT FROM ANY ACTION INITIATED BY THE INITIAL OWNER OR ANY SUBSEQUENT OWNERS FOR CONSTRUCTION DEFICIENCIES, MODIFICATIONS OR SUCH CONDITIONS WHICH MAY BE BEYOND THE CONTROL OF THE ARCHITECT.
- ALL WORK SHALL COMPLY WITH APPLICABLE CODES AND TRADE STANDARDS WHICH GOVERN EACH PHASE OF WORK, INCLUDING BUT NOT LIMITED TO CALIFORNIA BUILDING CODE (CBC), CALIFORNIA MECHANICAL CODE (CMC), CALIFRONIA ELECTRICAL CODE (CEC), CALIFORNIA PLUMBING CODE (CPC), CALIFORNIA RESIDENTAL CODE (CRC) AND ALL APPLICABLE LOCAL CODES AND LEGISLATION.
- THE CONTRACTOR SHALL REVIEW AND RECORD THE CONDITIONS OF ALL EXISTING SITE IMPROVEMENTS INCLUDING PAVED AREAS, HE SHALL MAKE KNOWN ALL EXISTING DAMAGED OR DISREPAIRED ITEMS AND CONDITIONS THAT MAY WORSEN DUE TO THE CONSTRUCTION.
- 10. ALL ITEMS IN GOOD CONDITION SHALL BE MAINTAIN IN THEIR PRESENT CONDITION AND ANY REPAIR OR DAMAGE WHICH OCCURS DURING CONSTRUCTION SHALL BE THE RESPONSIBILITY OF THE CONTRACTOR.
- CONTRACTOR SHALL THOROUGHLY EXAMINE THE SITE AND SATISFY HIMSELF AS OF THE CONDITIONS UNDER WHICH THE WORK IS TO BE PERFORMED.
- 12. THE CONTRACTOR SHALL VERIFY AT THE SITE ALL MEASUREMENTS AFFECTING HIS WORK AND SHALL BE RESPONSIBLE FOR THE CORRECTNESS OF SAME.
- 13. NO EXTRA COMPENSATION WILL BE ALLOWED TO THE CONTRACTOR FOR THE EXPENSES DUE TO HIS NEGLECT TO EXAMINE OR FAILURE TO DISCOVER CONDITIONS
- 14. ALL NEW INTERIOR PAINT COLOR, FLOOR, WALLS AND CEILING FINISHES SHALL BE SELECTED BY OWNER AT THE TIME WHEN IT IS NECESSARY FOR THE COMPLETION
- 15. ALL PUBLIC IMPROVEMENTS SHALL BE MADE IN ACCORDANCE WITH THE LATEST
- 16. THE STORING OF GOODS AND MATERIALS ON SIDEWALK AND/OR STREET WILL NOT BE ALLOWED UNLESS THE CONTRACTOR HAS APPLIED AND SECURED A SPECIAL PERMIT WHICH ALLOWS SUCH STORAGE TO BE PLACED.
- 17. GENERAL CONTRACTOR AND OWNER ARE REQUIRED TO SIGN THE STRUCTURAL SPECIAL INSPECTION FORM OF THE EXPOXY HOLDOWN ANCHOR BOLTS BEFORE THE BUILDING PERMIT IS ISSUED BY CITY.
- 18. THE LIST OF DEFERRED ITEMS WILL PROVIDED ON THE COVER SHEET. THE DEFERRED ITEMS SHALL NOT BE CONSTRUCTED OR INSTALLED UNTIL REVIEWED AND APPROVED
- 19. UNDER SPECIAL INSPECTION TITLE ALL WORK REQUIRING SPECIAL INSPECTION PER 2019 CBC CHAPTER 17. ALL WORK REQUIRING INSPECTIONS MUST BE DONE BY CERTIFIED INSPECTION AGENCY.
- 20. RETROFIT HOLDOWN ANCHORS MAY BE INSPECTED BY THE ENGINEER OF RECORD. THE EOR SHALL PROVIDE A LETTER TO THE CITY FIELD INSPECTOR AT THE TIME OF HOLDOWN INSPECTION DESCRIBING THE RESULTS OF THE INSPECTION(S).

SYMBOLS

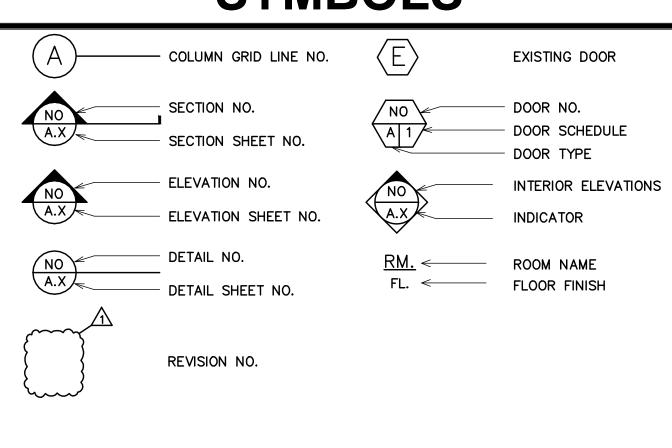

BLDG DATA

31,798.8 S.F.

RHS-sr

CURRENT USE: PROPOSED USE:	SFH SFH
PROPOSED BUILDING FLOOR AREA:	
(E) FLOOR AREA	4220 SF
PROPOSED FLOOR AREA	NO CHANGE
(N) FRONT PORCH	80 SF
(N) BALCONY	13 SF
TOTAL COVERED AREA:	3,165 SF

BUILDING: OCCUPANCY: CONSTRUCTION TYPE: STORY (IES): AUTO. FIRE SPRINKLER:

DESIGN COMPLY WITH

LOT SIZE:

CURRENT ZONING:

COUNTY/CITY OF Los Alto Hills ZONING ORDINACE 2019 CALIFORNIA BUILDING CODE 2019 CALIFORNIA RESIDENTIAL CODE

2019 CALIFORNIA ELECTRICAL CODE 2019 CALIFORNIA MECHANICAL CODE

2019 CALIFORNIA ENERGY CODE

2019 CALIFORNIA GREEN BUILDING STANDARDS CODE

2019 CALIFORNIA PLUMBING CODE 2019 CALIFORNIA FIRE CODE

SCOPE OF WORK

- NEW REMODELING TO EXISTING S.F.H.
- NEW EXTERIOR FINISH TO BE STUCCO AND MATCH EXISTING COLOR.
- INTERIOR REMODELING INCLUDES ALL ROOMS WITH NEW LAYOUT AND FINISHES. REMODEL KITCHEN, ADD NEW PANTRY PORCH.
- RELATD MECH/PLUMBING/HVAC SYSTEM.
- EXISTING GAS METER TO REMAIN, ELECTRICAL PANEL TO UPGRADE TO 200AMP.

REVISION #3 SCOPE OF WORK:

- REVISED ROOF PLAN WITH PARTIAL NEW ROOF LAYOUT AND ROOF FINISHES REVISED EXTERIOR WINDOW AND PATIO DOOR LAYOUT, AND EXTERIOR WALL FINISH
- REVISED LAYOUT TO BEDROOMS AND BATHROOM ON 1ST AND 2ND FLOOR
- REVISED STAIR LAYOUT TO BASEMENT AREA
- REVISED LIGHTING LAYOUT

VICINITY MAP Foothills Preserve

Annie's Residence

Remodeling


11470 Page Mill Road, Los Alto Hills, CA


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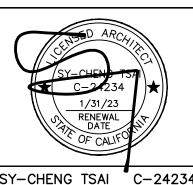
SHEET INDEX

ARCHITECTURAL

ARCHITECTURAL			
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A1.1	FLOOR PLAN NOTES		
A1.2	PROPOSED 1ST & BASEMENT FLOOR PLAN		
A1.3	EXISTIONG 2ND FLOOR DEMO. PLAN		
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A1.4	PROPOSED ROOF PLAN		
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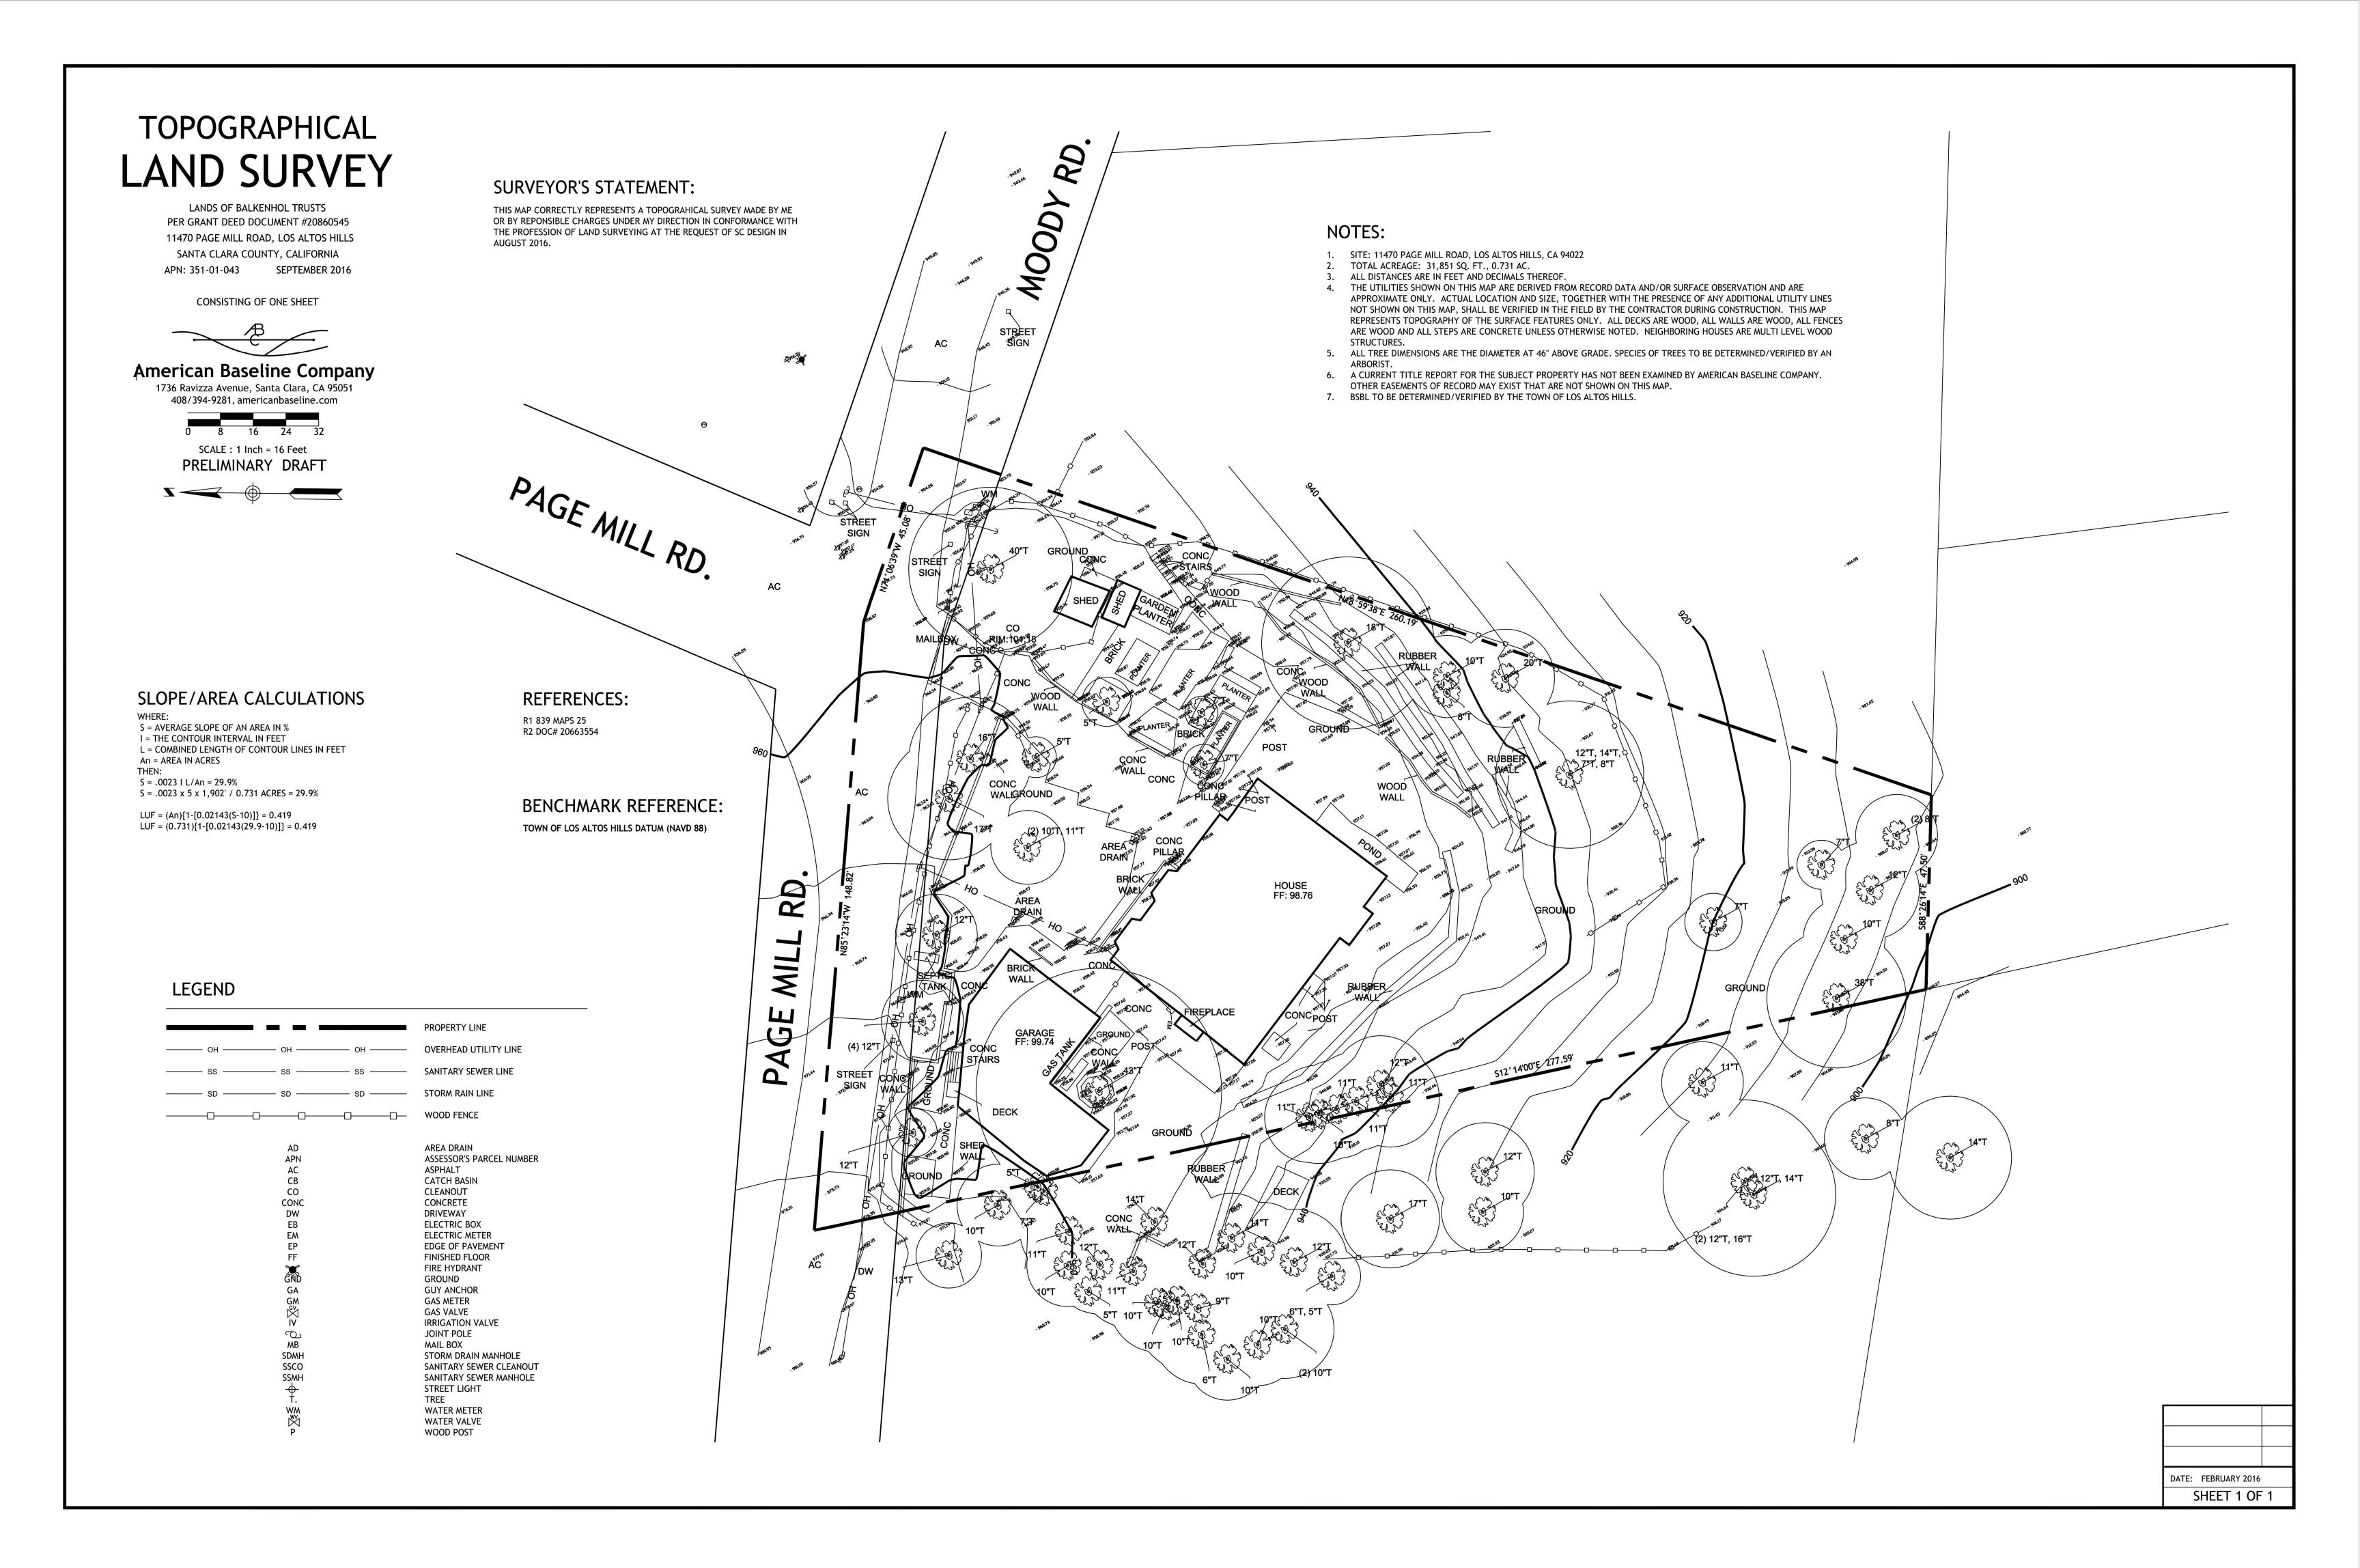
TITLE SHEET


DATE: 06/20/2022 JOB NO. TS211148

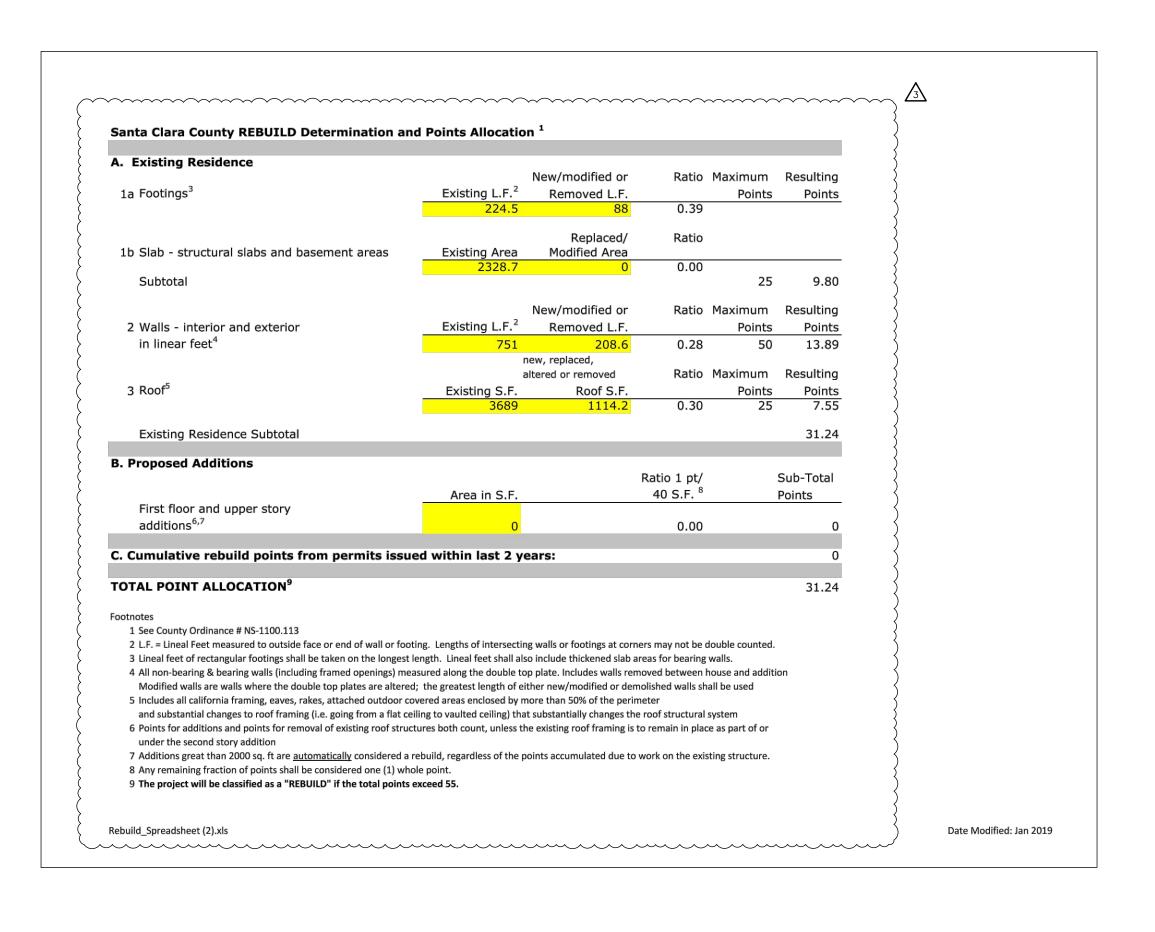ISSUE & REVISION
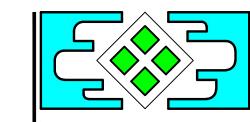
| 01/20/22 | ROA Change /3 | 06/20/22 | Owner Rev

SHEET NO.



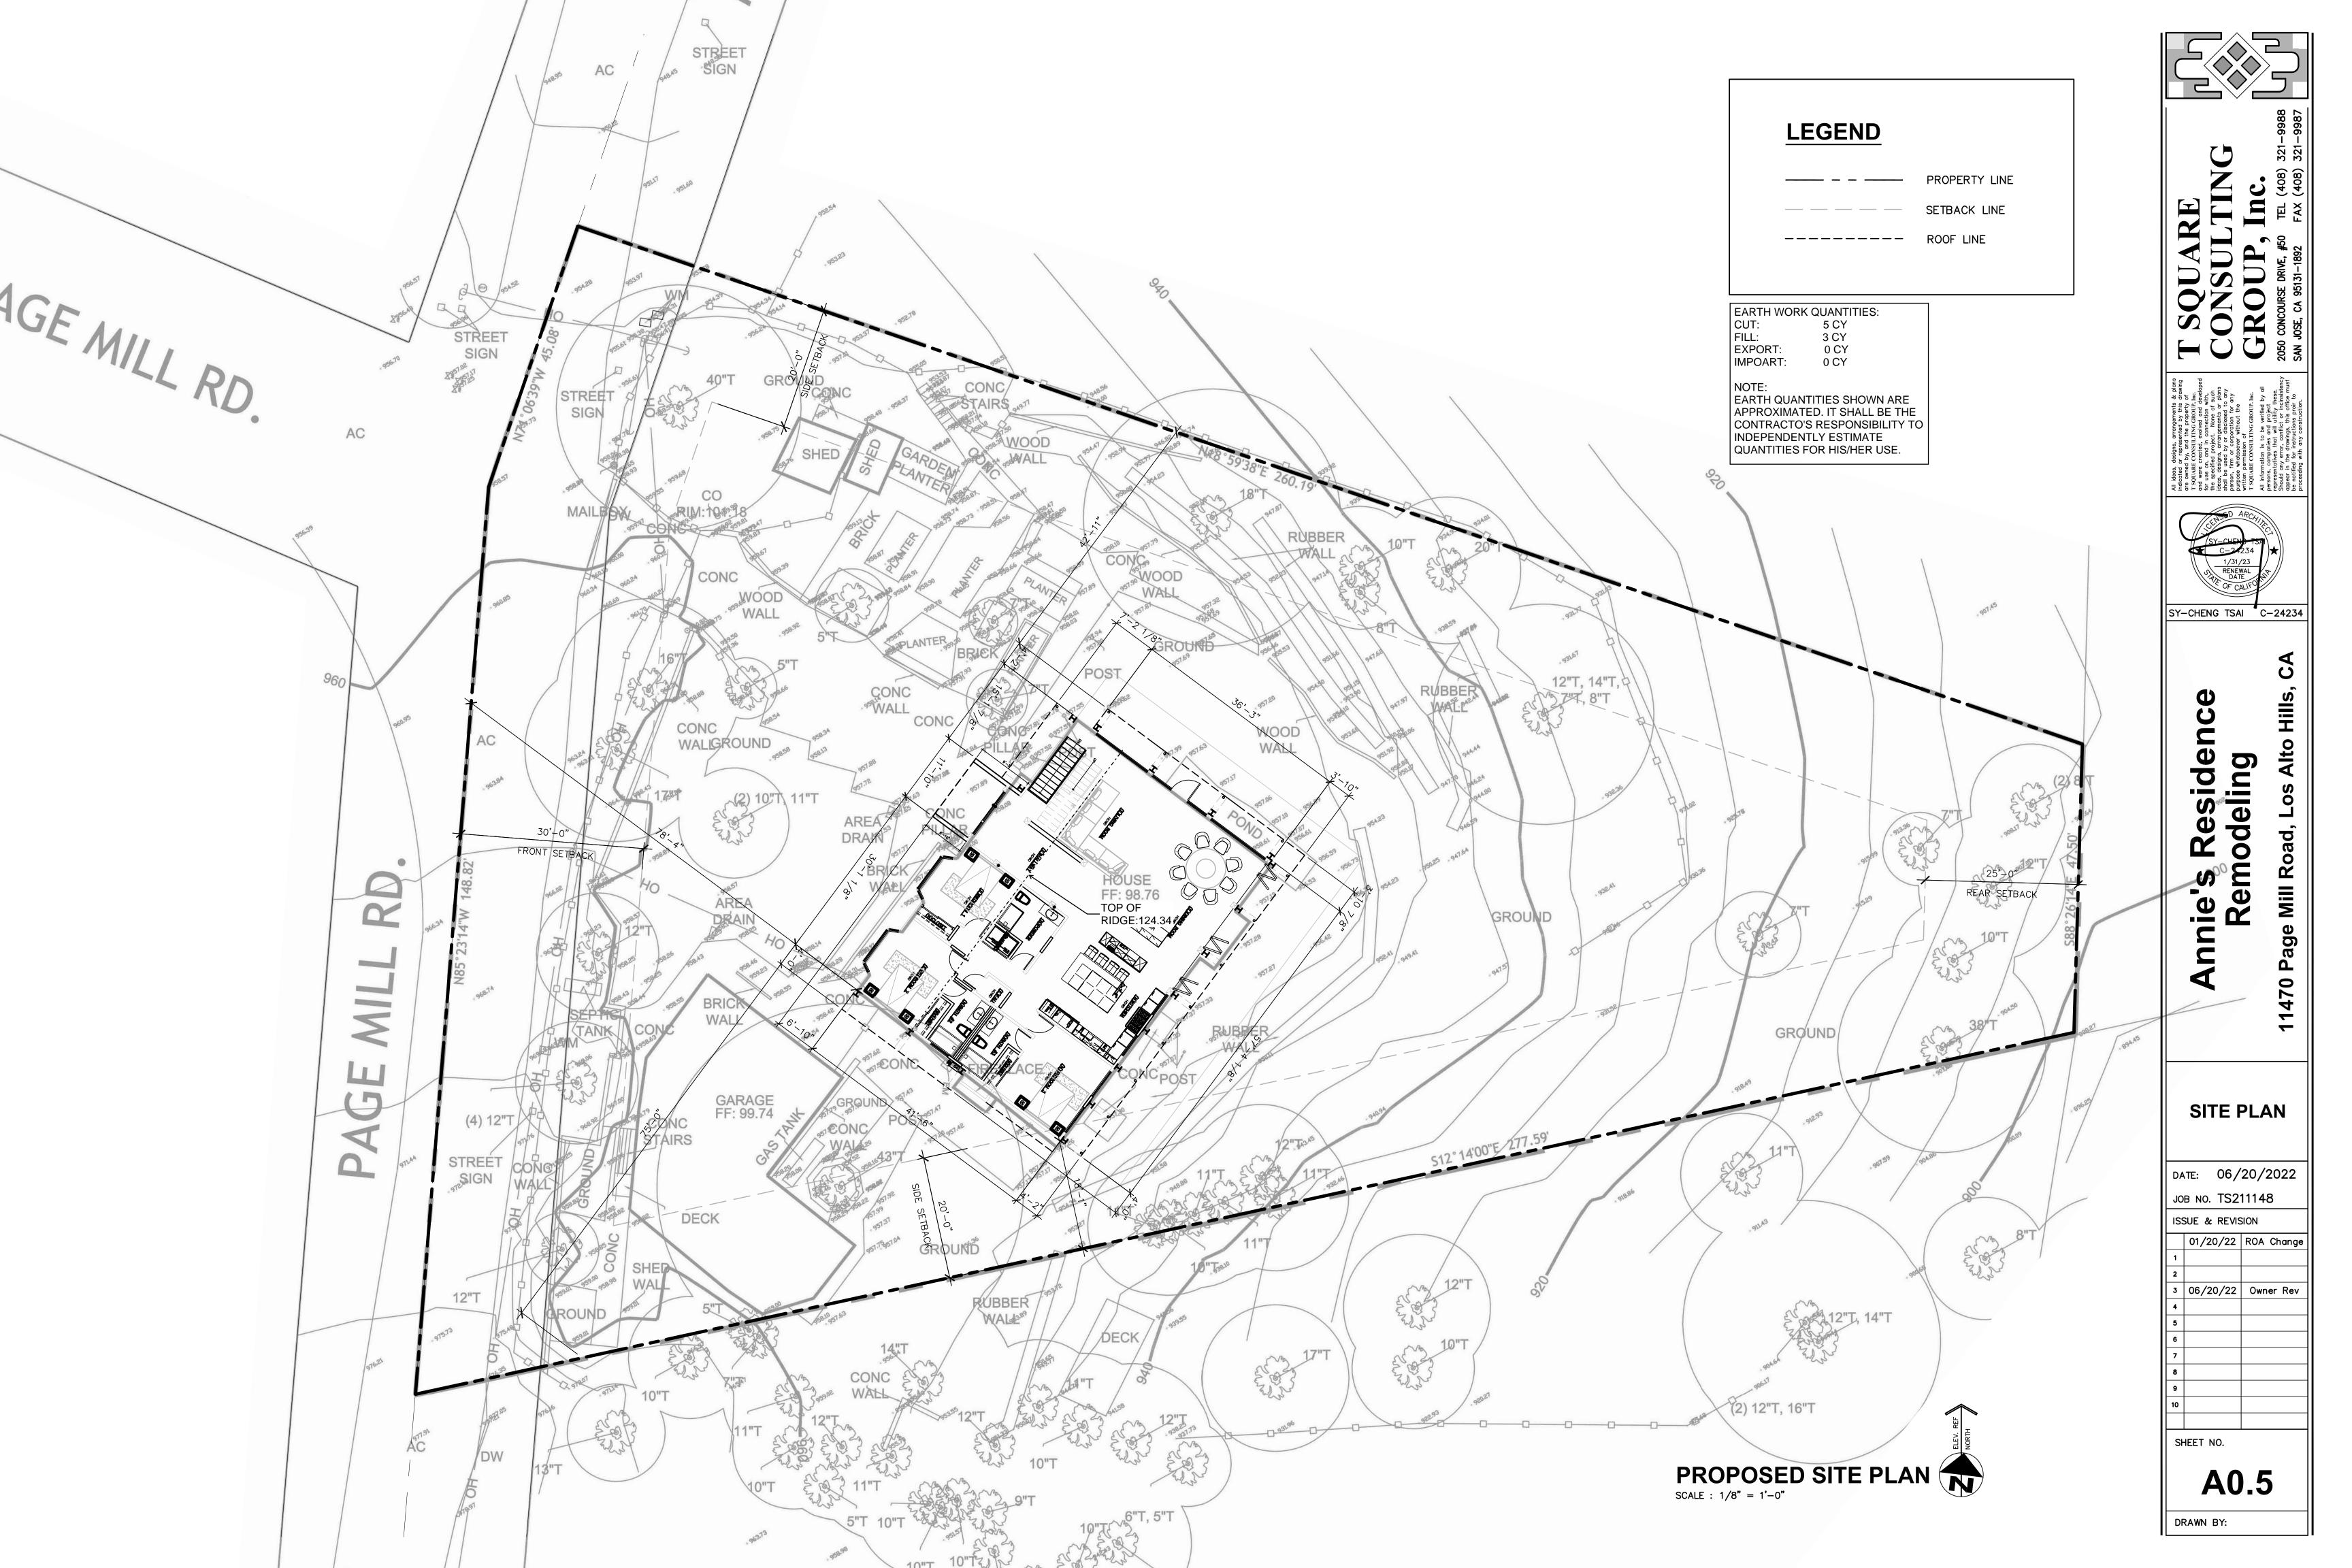



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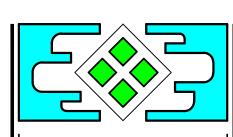
LEGEND

EXISTING WALLS TO REMAIN REPAIR AS REQUIRED

EXISTING WINDOWS WALLS AND DOORS TO BE REMOVED



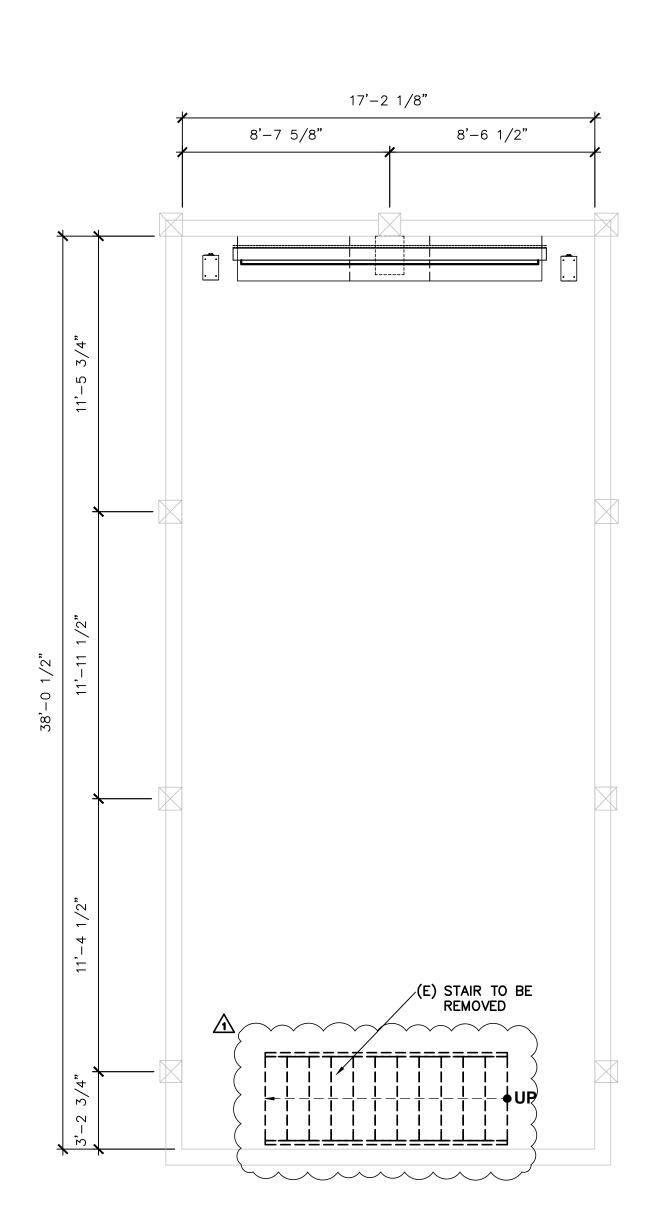

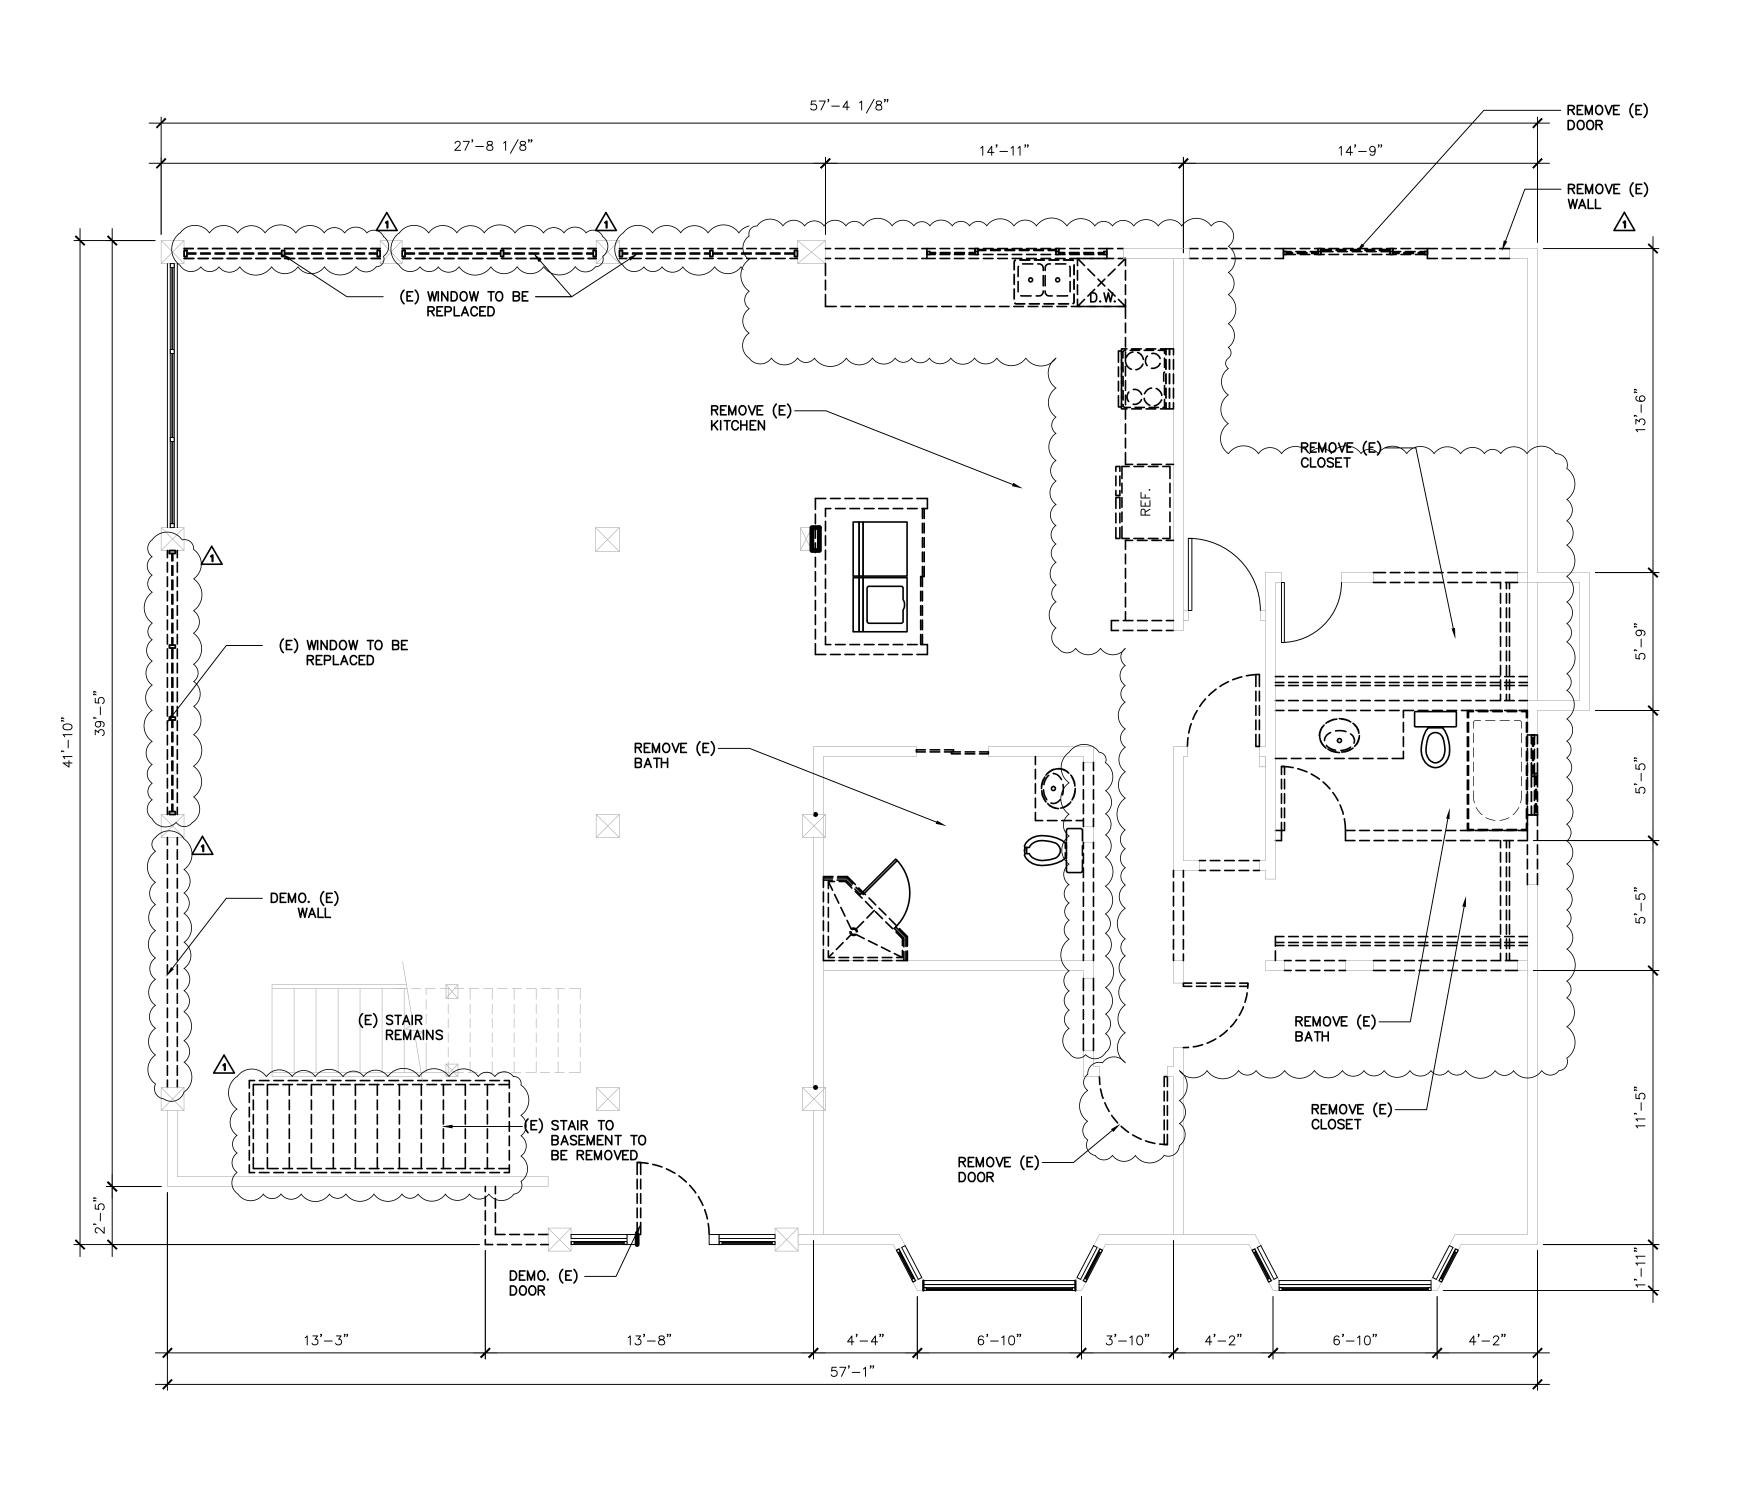


ULTING

JP, Inc.

NWE, #50 TEL (408) 321-9988

-1892 FAX (408) 321-9987

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SY-CHENG TSAI C-24234

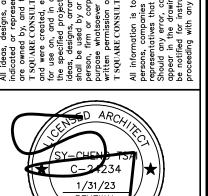Annie's Residence Remodeling

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EXISTING 1ST FLOOR DEMO. PLAN

DATE: 06/20/2022 JOB NO. TS211148

ISSUE & REVISION

	01/20/22	ROA Change
1		
2		
3	06/20/22	Owner Rev
4		
5		
6		
7		
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9		

SHEET NO.

DRAWN BY:

A1.0

WALL LEGEND

EXISTING CONSTRUCTION TO REMAIN

(N) FURRED WALL / COLUMN.

NEW WOOD FRAMING WALL OUT OF 2X4 WOOD STUDS @ 16" O.C. AND IN THE EXTERIOR STUCCO 7/8" MIN. STUCCO O/ METAL LATH O/ TWO LAYERS OF GRADE 'D' BLDG. PAPER O/

NEW 2X4 WOOD STUDS @ 16" O.C. W/ 1/2" THK. GYP. BD. ON THE BOTH SIDES

NEW 2X4 WOOD STUDS @ 16" O.C. W/ 1/2" THK. GYP. BD. ON THE BOTH SIDES USE WONDER BD. OR DUROCK AS BACKING MATERIAL AND WATER PROOFED MATERIAL.


ONE HOUR RATED WALL 2X4 WOOD STUDS @ 16" O.C. W/ 5/8" TYPE 'X' GYP. BD. @ GARAGE INTERIOR SIDE.

SAFETY GLAZING WINDOW/TEMPERED GLASS

CRAWL ACCESS 18"X24" MIN. (2016 CRC R408)

ATTIC ACCESS 22"X30" MIN. (2016 CRC R807)
ATTIC ACCESS 36"X36" MIN. WHEN FURNACE AT ATTIC. A HEAD ROOM CLEAR HEIGHT IN A ATTIC AT LEAST 30" AT THE ATTIC ACCESS.


LEGEND

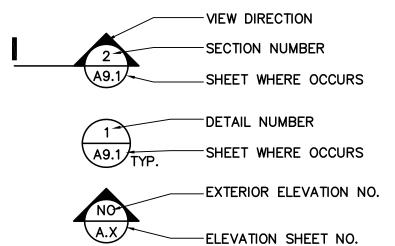


WINDOW LIGHT / VENT CAL


			VENTILATION	LIGHTING	
ROOM NAME AND LOCATION		ROOM SIZE (S.F.)	AREA REQ'D - (4%) OR 5 S.F. MIN.	AREA REQ'D - (8%) OR 10 S.F. MIN.	PROVIDED WINDOW AREA (S.F.)
st FL.	(E) DINING ROOM	206	9	18	436
st FL.	(E) LIVING ROOM	454	19	38	342
st FL.	(N) KITCHEN	469	19	38	86
st FL.	(E) HALLWAY	189	8	16	61
st FL.	(E) BEDROOM #1	142	6	12	49
st FL.	(E) BEDROOM #2	172	7	14	49
st FL.	(N) BEDROOM #3	193	8	16	96

SEE NOTES ON SHEET A-1.1

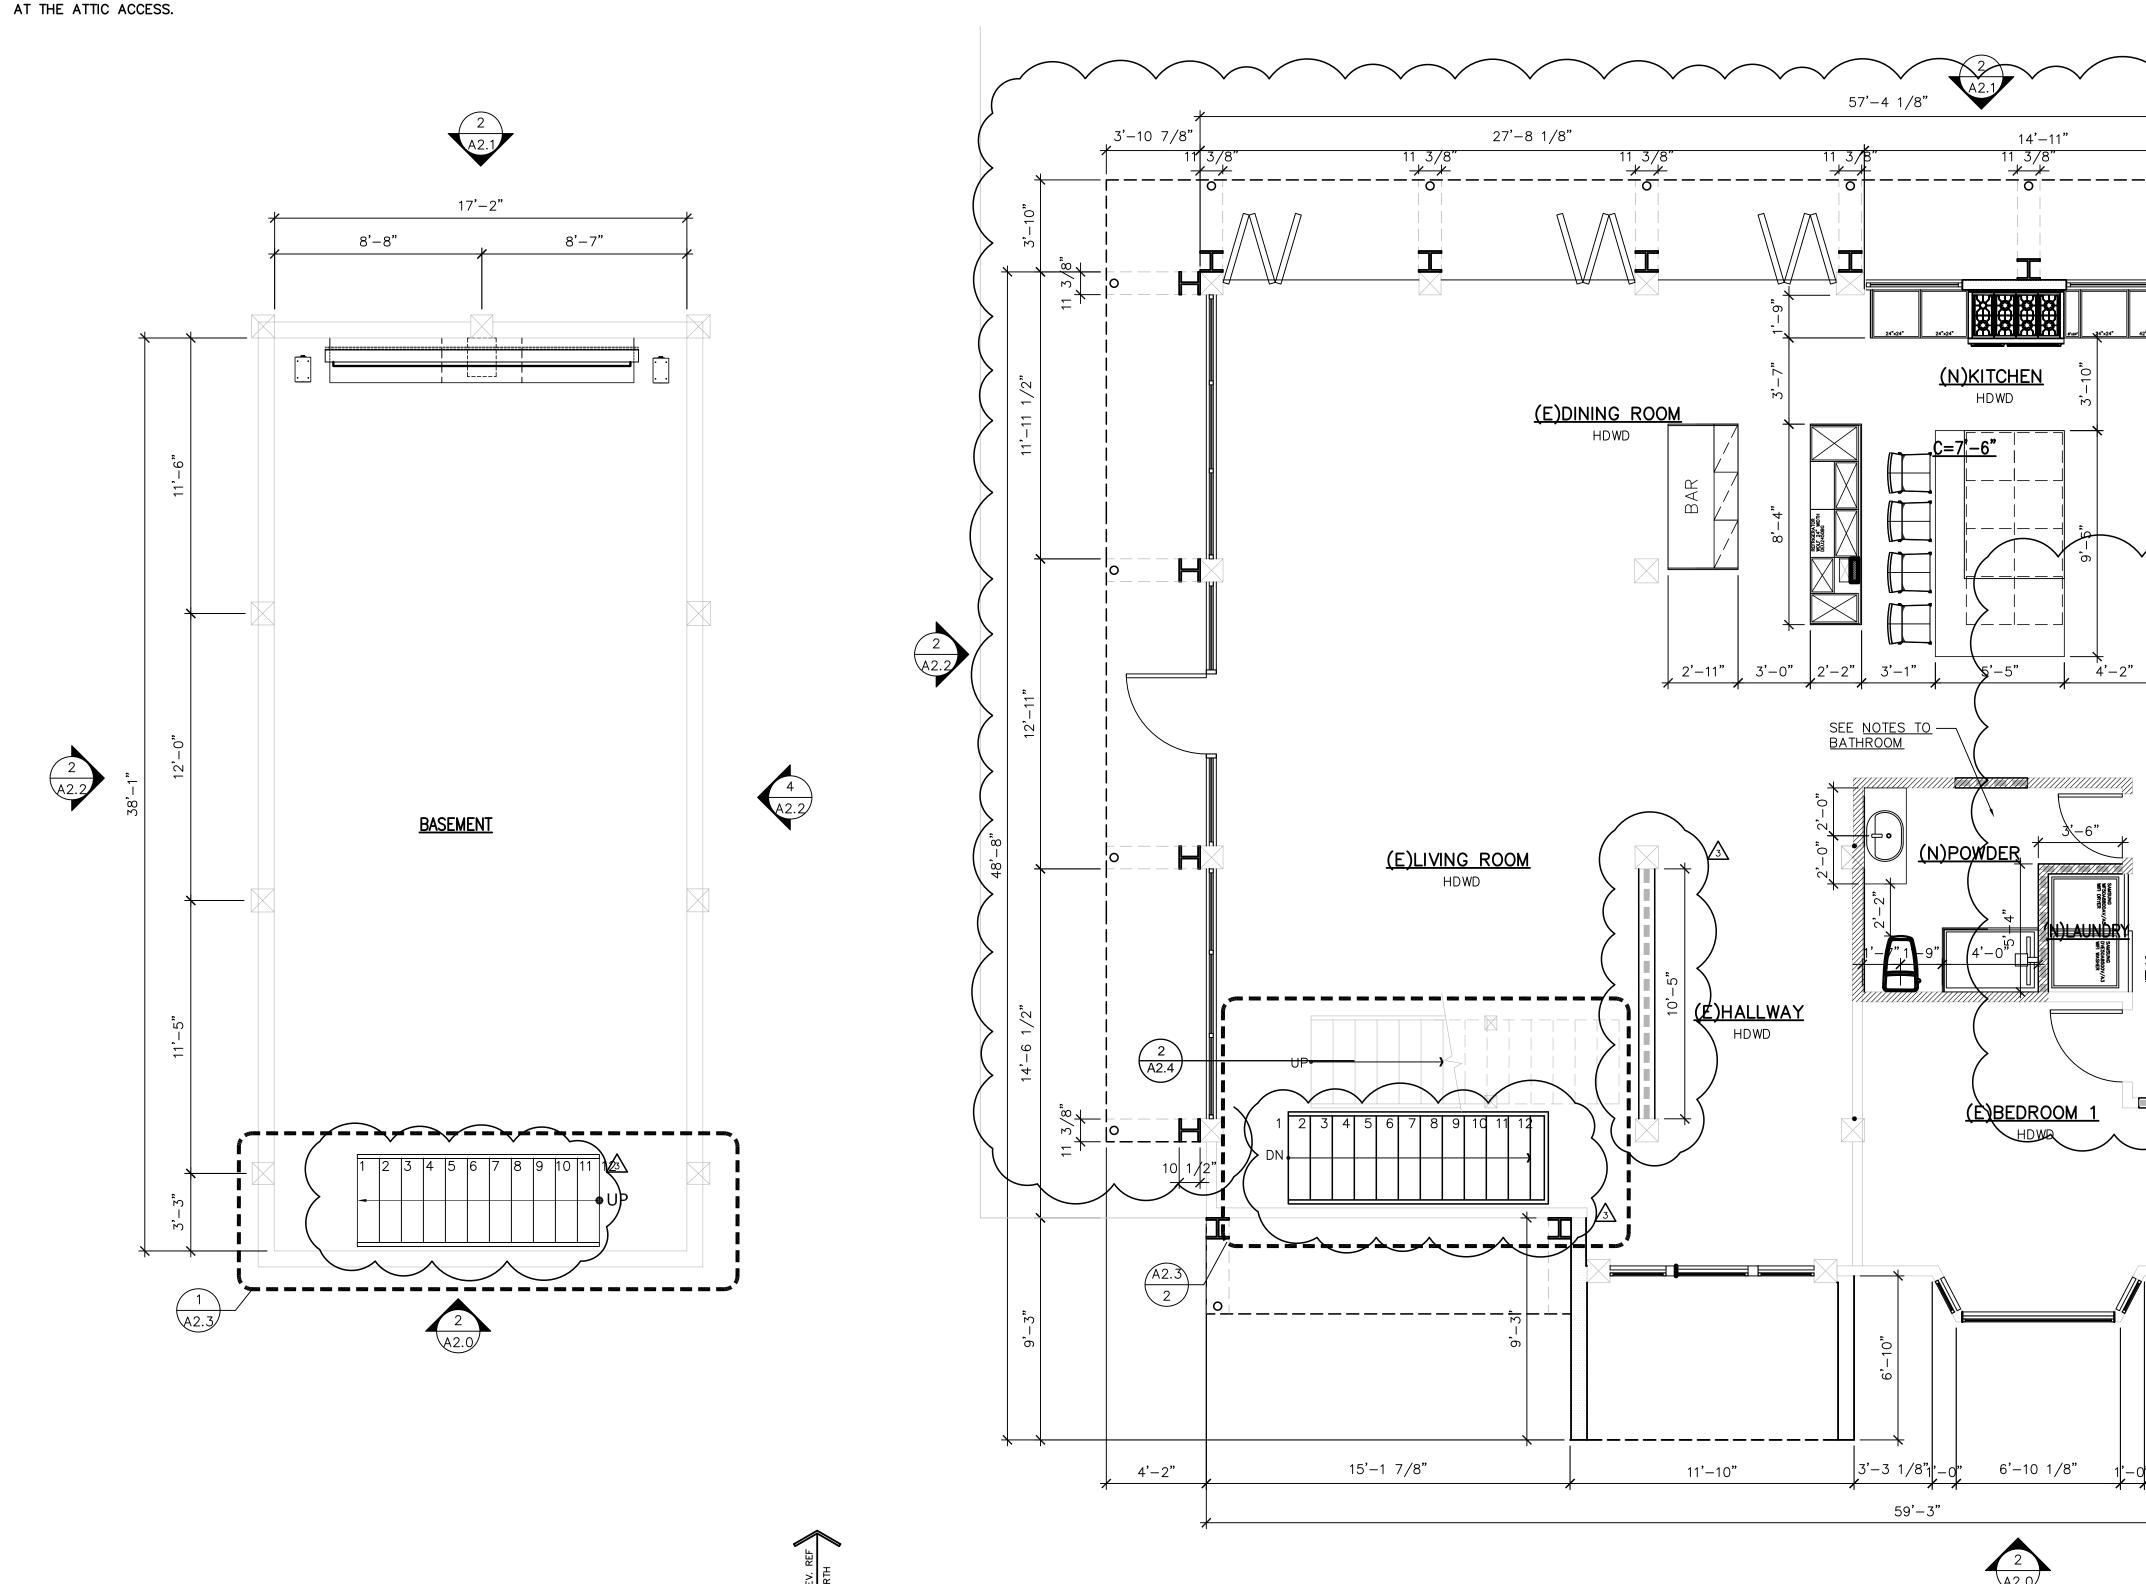

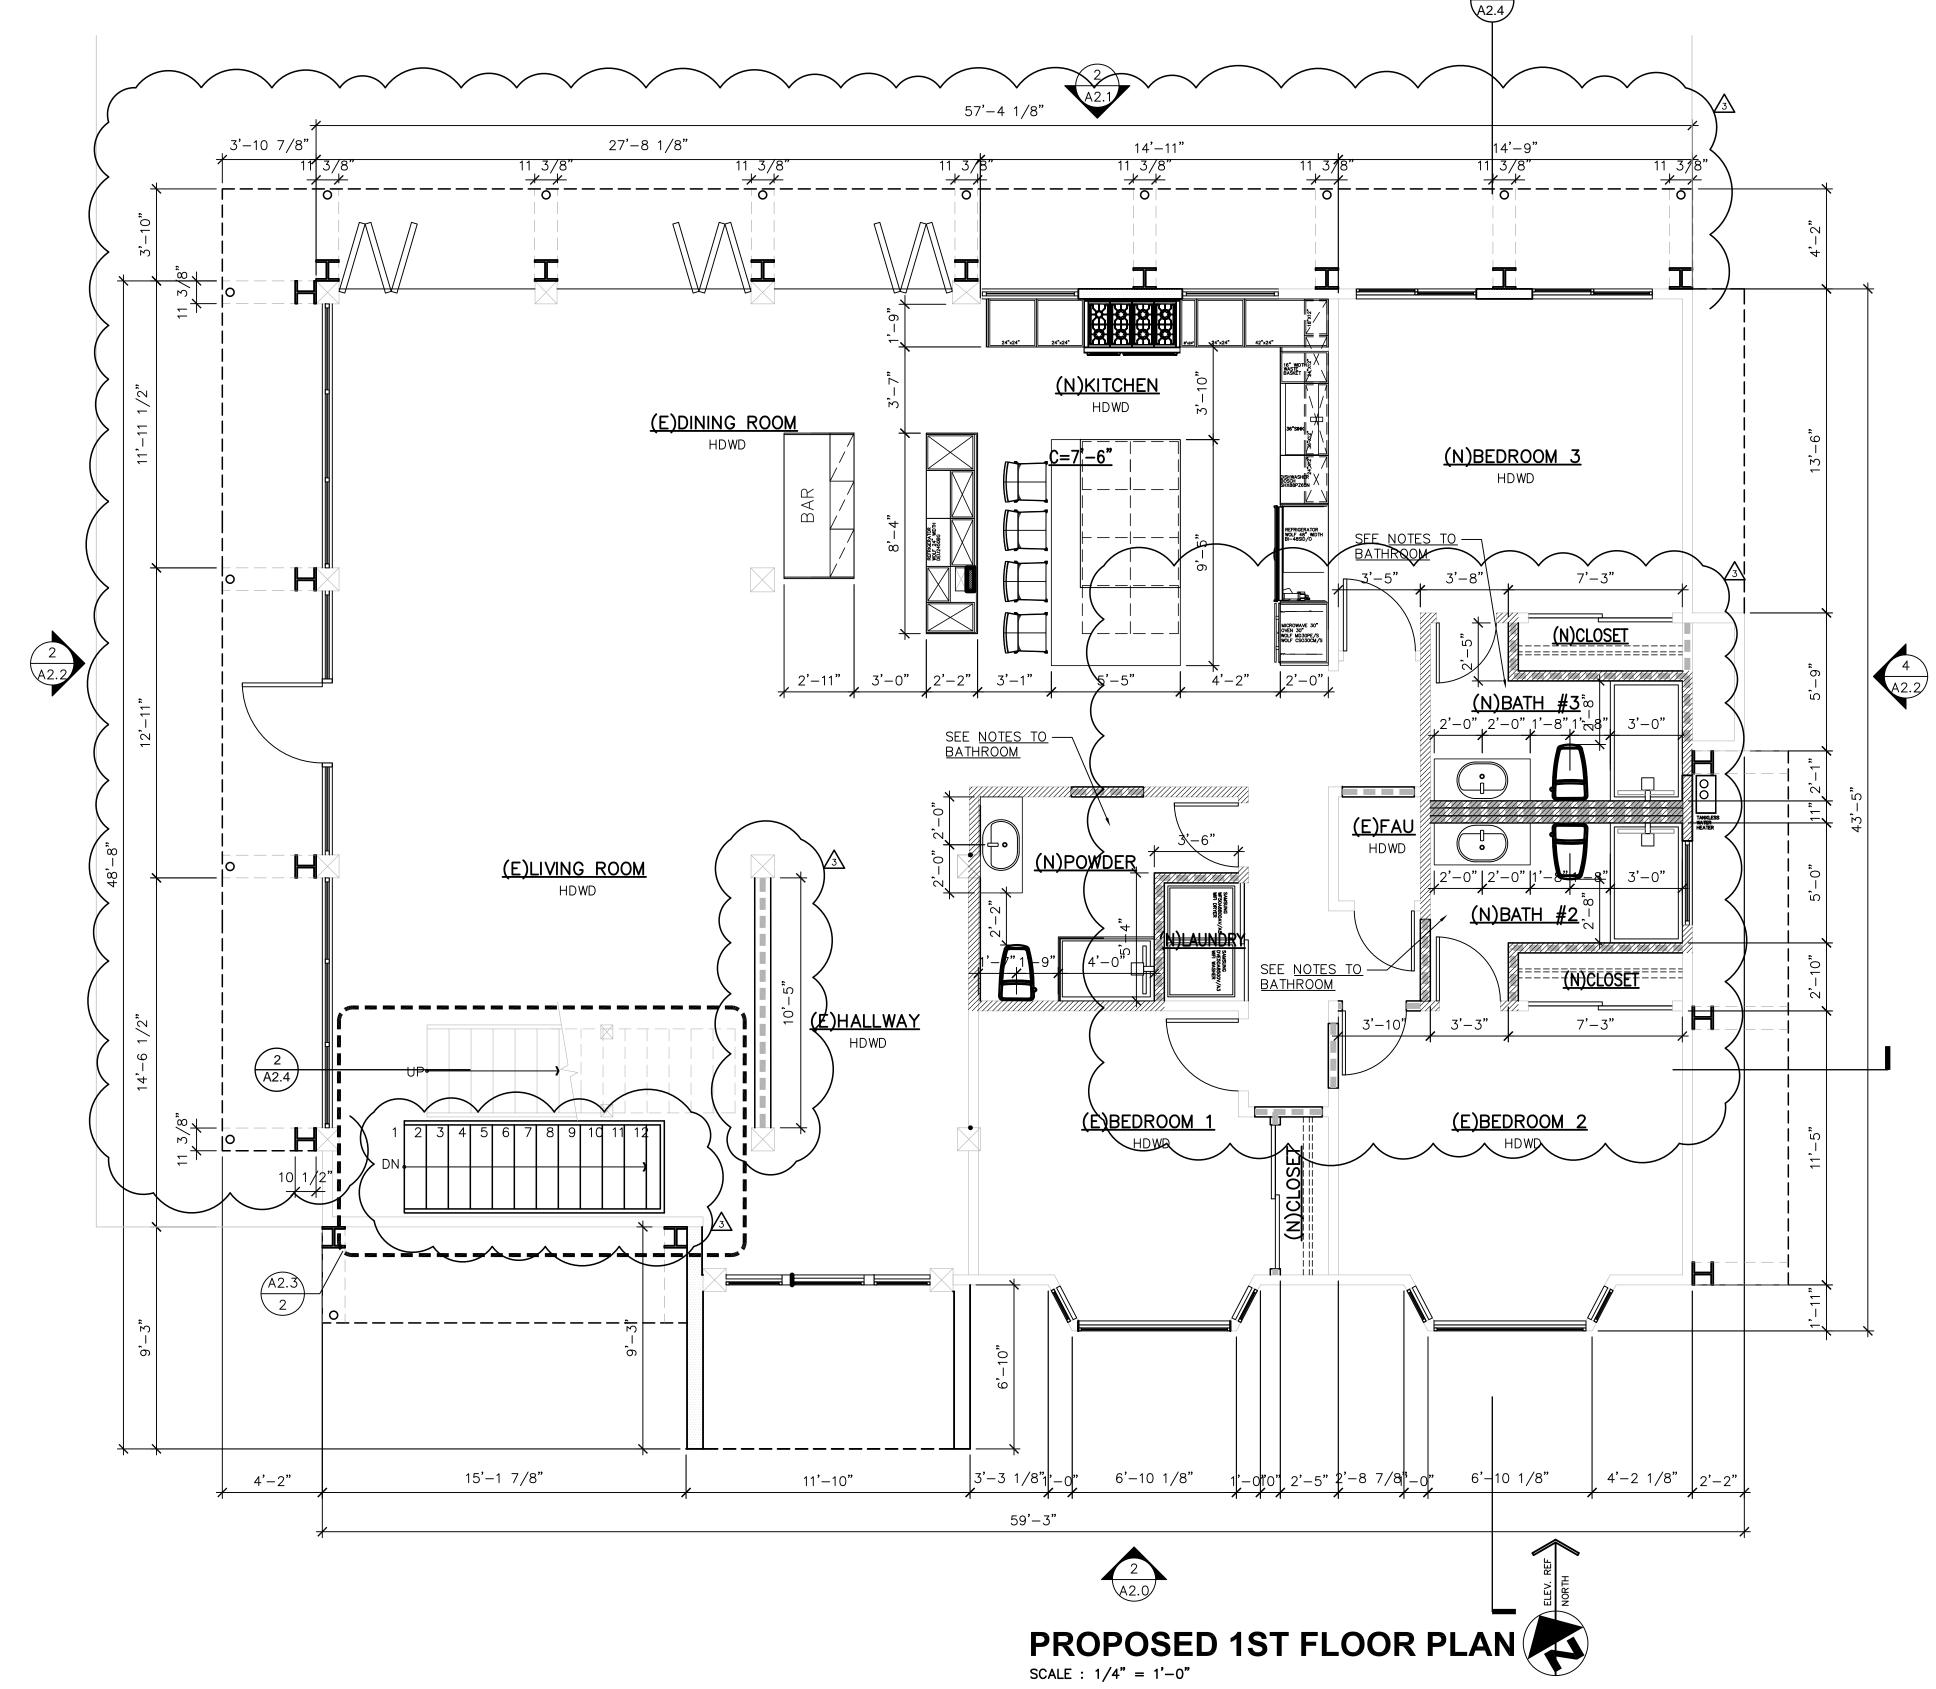



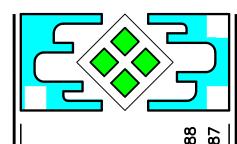

SY-CHENG TSAI C-24234

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PROPOSED 1ST & **BASEMENT FLOOR PLAN**

DATE: 06/20/2022 JOB NO. TS211148

ISSUE & REVISION

01/20/22 ROA Change 3 06/20/22 Owner Rev


SHEET NO. A1.2

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- 15. ANY PIPE, CONDUIT, OR CABLE ORIGINALLY CONNECTED TO THE REMOVED ITEMS TO BE DISCONNECTED AND CAPPED PROPERLY. IF THE ITEMS IS PART OF A SYSTEM THEN NEED TO RE-CONNECT TO EXISTING SYSTEM AND KEEP IN A WORKING CONDITION.
- 16. THE LOCATION OF DISCONNECTED AND/OR CAPPED LINES SHALL IDENTIFIED ON SITE AND MARKED ON THE PROJECT RECORD DOCUMENTS FOR FUTURE REFERENCE.




LEGEND


EXISTING WALLS TO REMAIN REPAIR AS REQUIRED

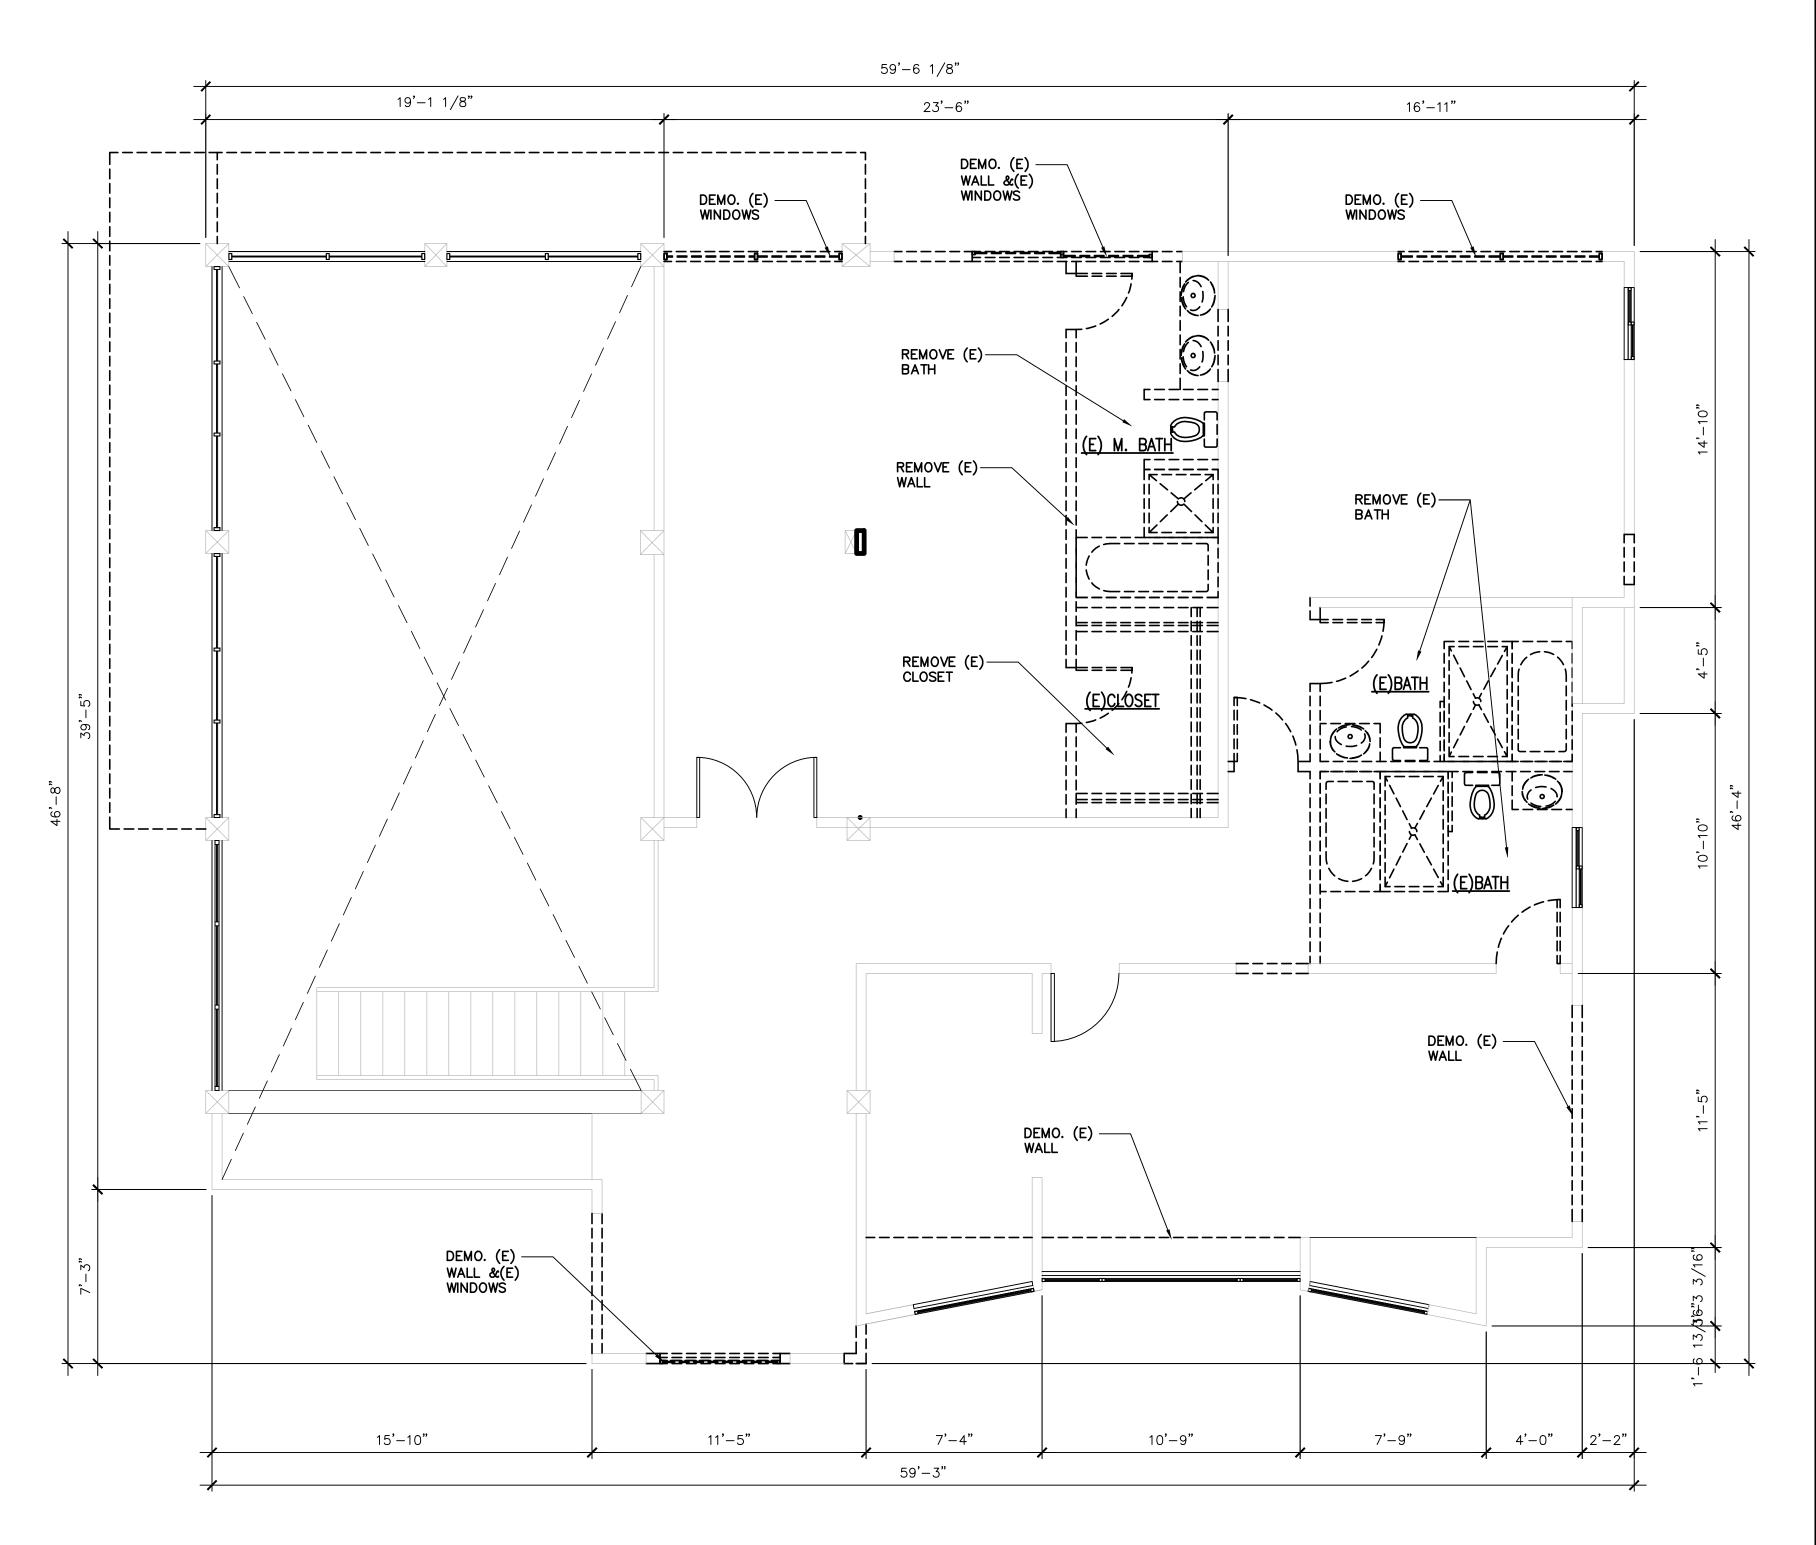EXISTING WINDOWS WALLS AND DOORS TO BE REMOVED



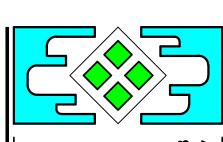

All ideas, and information of the special of the sp

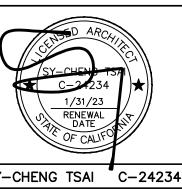

SY-CHENG TSAI C-24234

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EXISTING 2ND FLOOR DEMO. **PLAN**

DATE: 06/20/2022 JOB NO. TS211148

ISSUE & REVISION

| 01/20/22 | ROA Change 3 | 06/20/22 | Owner Rev

SHEET NO.

WALL LEGEND

EXISTING CONSTRUCTION TO REMAIN

(N) FURRED WALL / COLUMN.

NEW WOOD FRAMING WALL OUT OF 2X4 WOOD STUDS @ 16" O.C. AND IN THE EXTERIOR STUCCO 7/8" MIN. STUCCO O/ METAL LATH O/ TWO LAYERS OF GRADE 'D' BLDG. PAPER O/

NEW 2X4 WOOD STUDS @ 16" O.C. W/ 1/2" THK. GYP. BD. ON THE BOTH SIDES

NEW 2X4 WOOD STUDS @ 16" O.C. W/ 1/2" THK. GYP. BD. ON THE BOTH SIDES USE WONDER BD. OR DUROCK AS BACKING MATERIAL AND WATER PROOFED MATERIAL.


ONE HOUR RATED WALL 2X4 WOOD STUDS @ 16" O.C. W/ 5/8" TYPE 'X' GYP. BD. @ GARAGE INTERIOR SIDE.

SAFETY GLAZING WINDOW/TEMPERED GLASS

CRAWL ACCESS 18"X24" MIN. (2016 CRC R408)

ATTIC ACCESS 22"X30" MIN. (2016 CRC R807)
ATTIC ACCESS 36"X36" MIN. WHEN FURNACE AT ATTIC. A HEAD ROOM CLEAR HEIGHT IN A ATTIC AT LEAST 30"


LEGEND

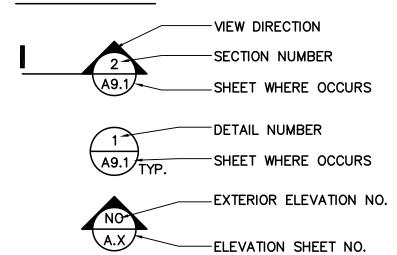



WINDOW LIGHT / VENT CAL


			VENTILATION	LIGHTING	
ROOM NAME AND LOCATION		ROOM SIZE (S.F.)	AREA REQ'D - (4%) OR 5 S.F. MIN.	AREA REQ'D - (8%) OR 10 S.F. MIN.	PROVIDED WINDOW AREA (S.F.
2nd FL.	(N) M. BEDROOM	535	22	44	163
2nd FL.	(N) HALLWAY	156	7	14	83
2nd FL.	(N) TEAROOM	106	5	10	29
2nd FL.	(N) BEDROOM #4	243	10	20	116


SEE NOTES ON SHEET A-2.1

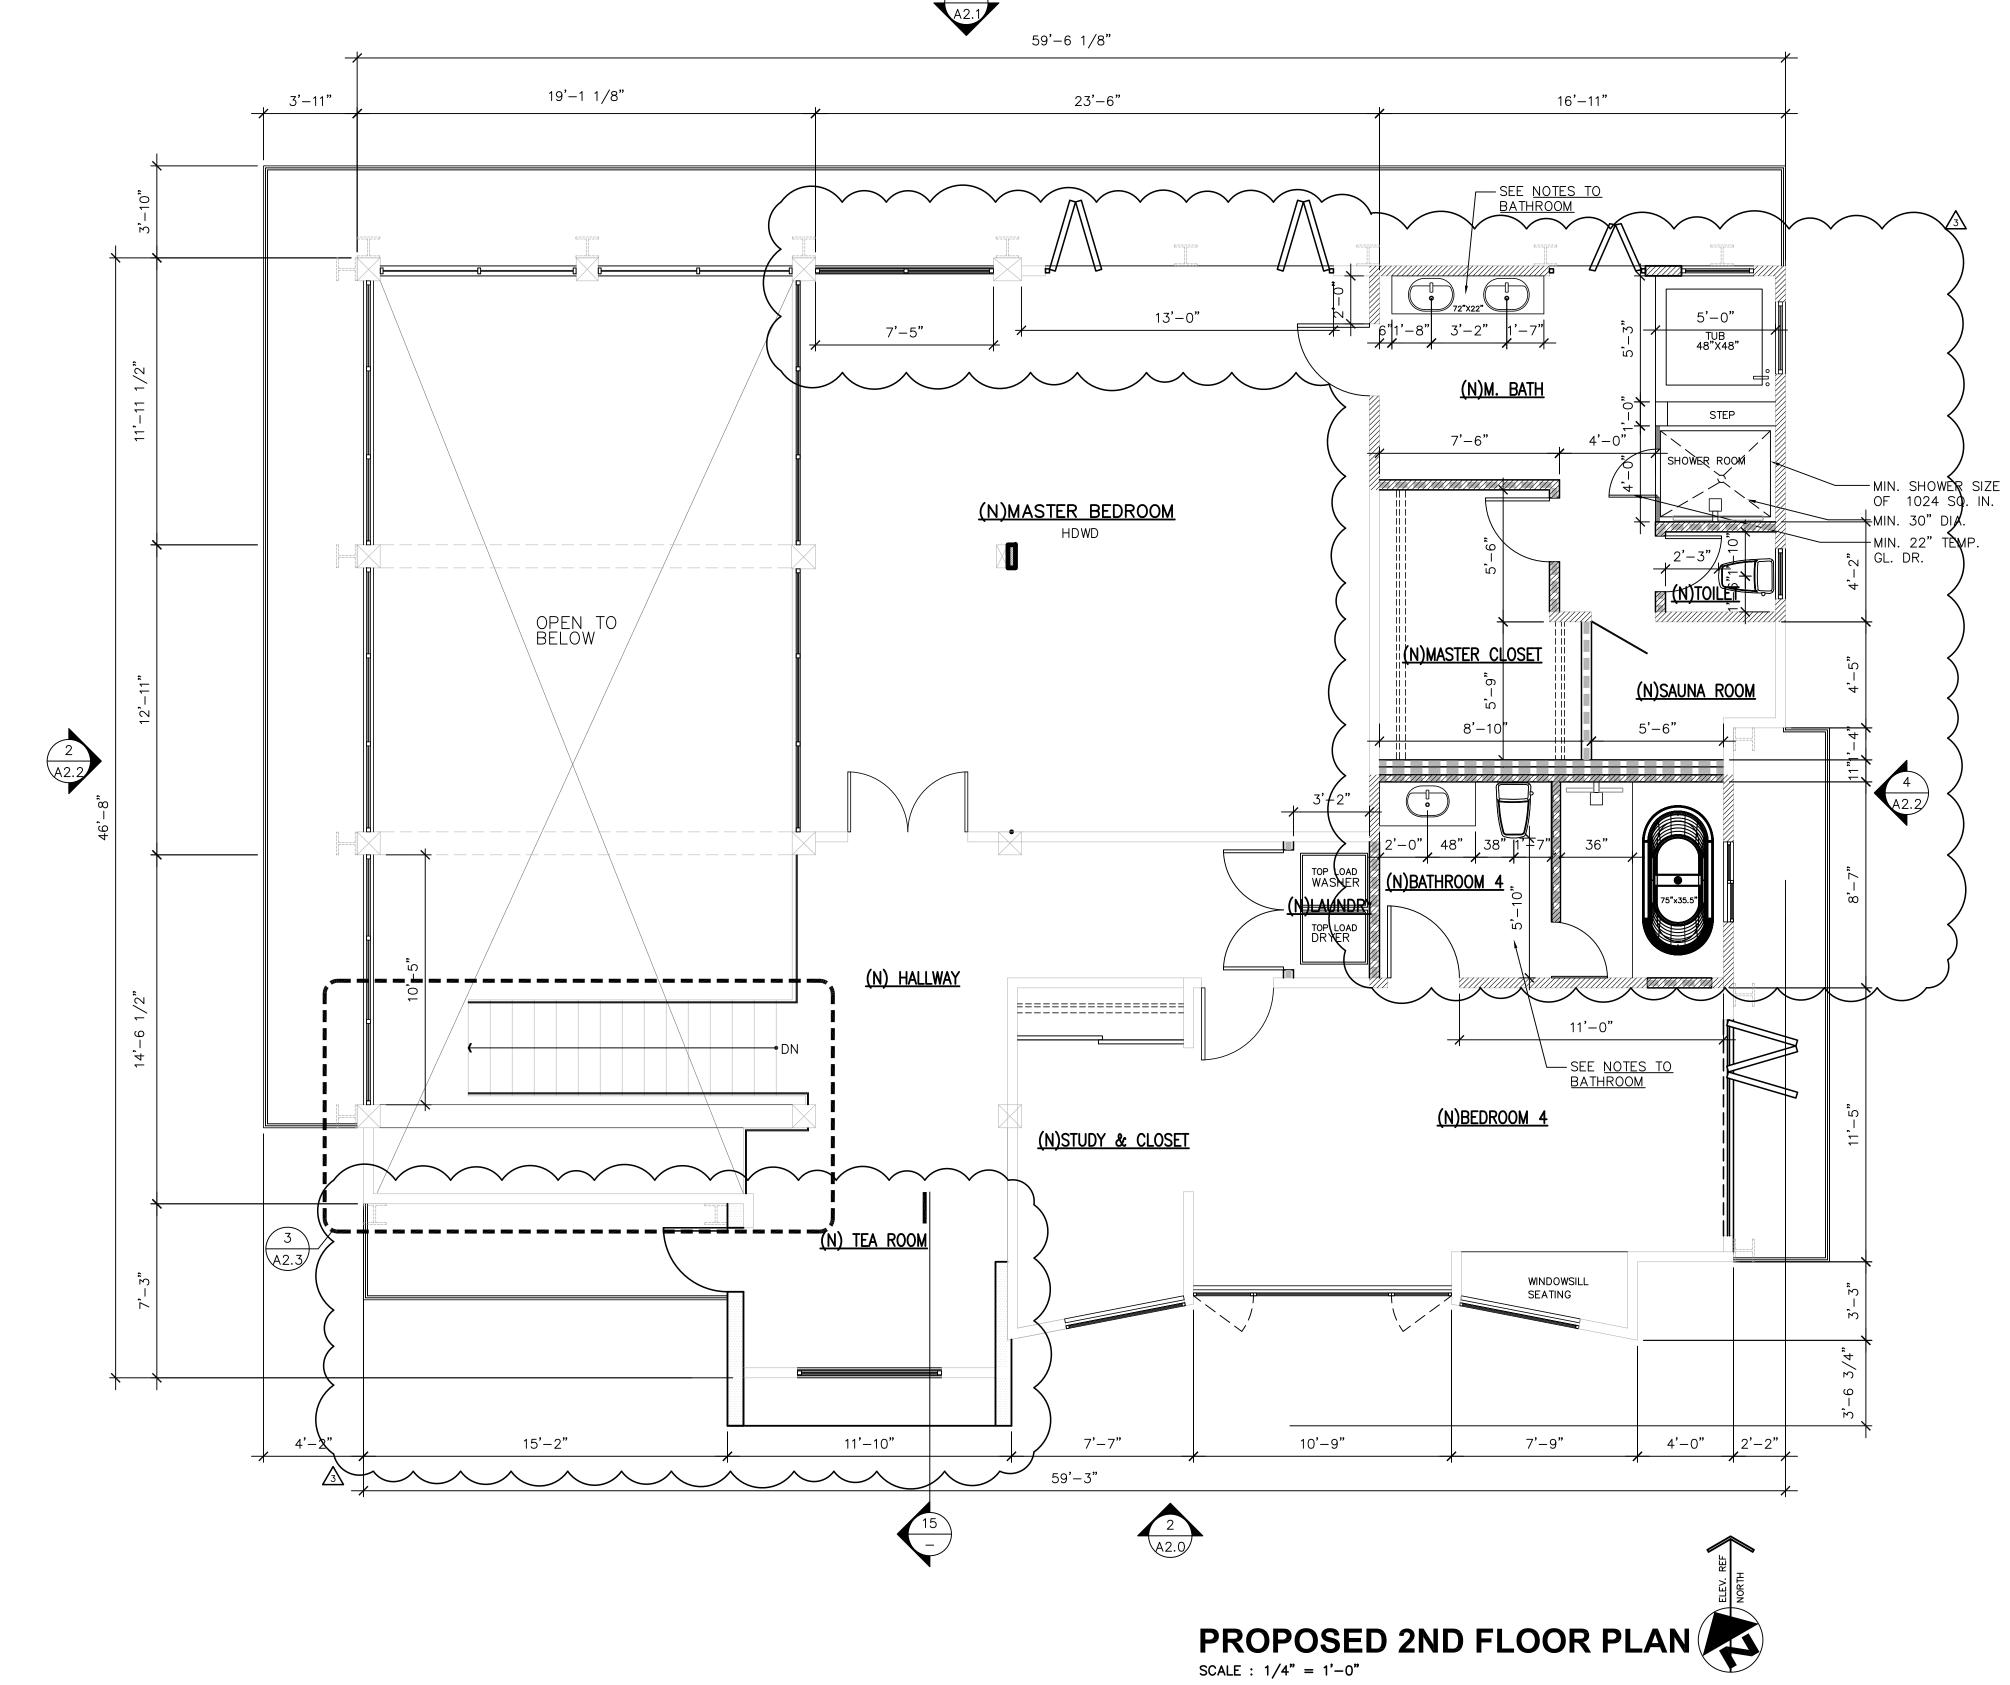

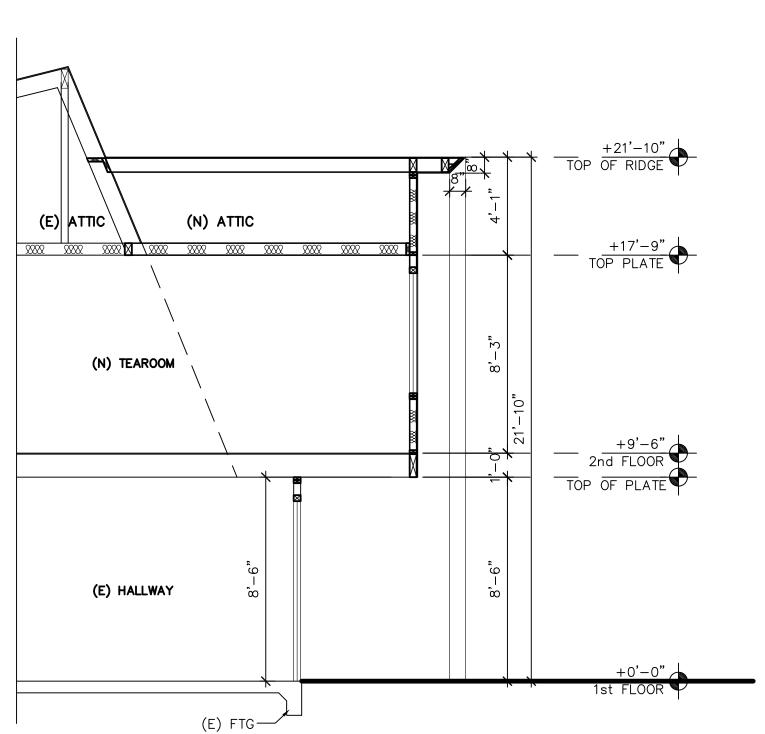

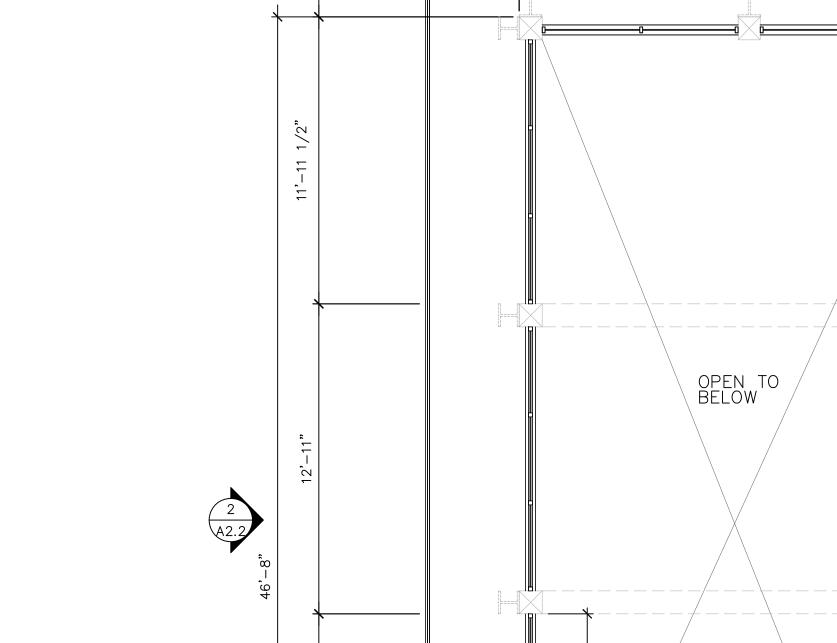

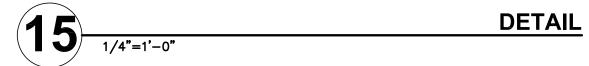

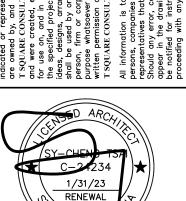

SY-CHENG TSAI C-24234

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> **PROPOSED** 2ND **FLOOR PLAN**

DATE: 06/20/2022 JOB NO. TS211148

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01/20/22 ROA Change 3 06/20/22 Owner Rev

SHEET NO.

DRAWN BY:

A1.4

ROOF NOTES:

- 1. ALL ROOFING TO BE CLASS "A".
- ALL NEW FASTENERS FOR ROOFING SHALL BE CORROSION RESISTANT IN ACCORDANCE WITH CRC R905.2.5.
- 3. ROOF SLOPE TO MEET EXISTING ROOF OR MEET THE SLOPE OF MAIN HOUSE.
- 4. COOL ROOF SPECIFICATION, IF "COOL ROOF" IS SPECIFIED BY TITLE 24 REPROT. THE ASPHALT SHINGLE TO BE THE FOLLOWING:
- A. OWNERS CORNING: DURATION PREMINUM COOL ROOF.
- B. GAF: TIMBERLINE COOL SERIES.
- C. CERTAIN TEED: LANDMARK SOLARIS OR PRESIDENTIAL SOLARIS.
- D. EQUAL PRODUCES CERTIFICATED BY COOL ROOF RATING COUNCIL AND MEET TITLE 24 REQUIREMENTS.
- ASPHALT SHINGLE COLOR TO MATCH EXISTING BUILDING OR SIMILAR TO MAIN BUILIDING.

NOTES


* ALL ROOF MATERIAL ARE COMP. SHINGLE.




AREA OF NEW ROOF — METAL ROOF COVERING (STRUCTURE & FRAMING)




AREA OF ROOF TO BE REMOVED (STRUCTURE & FRAMING)

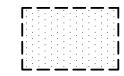

AREA OF RE-ROOFING ONLY -METAL ROOF COVERING

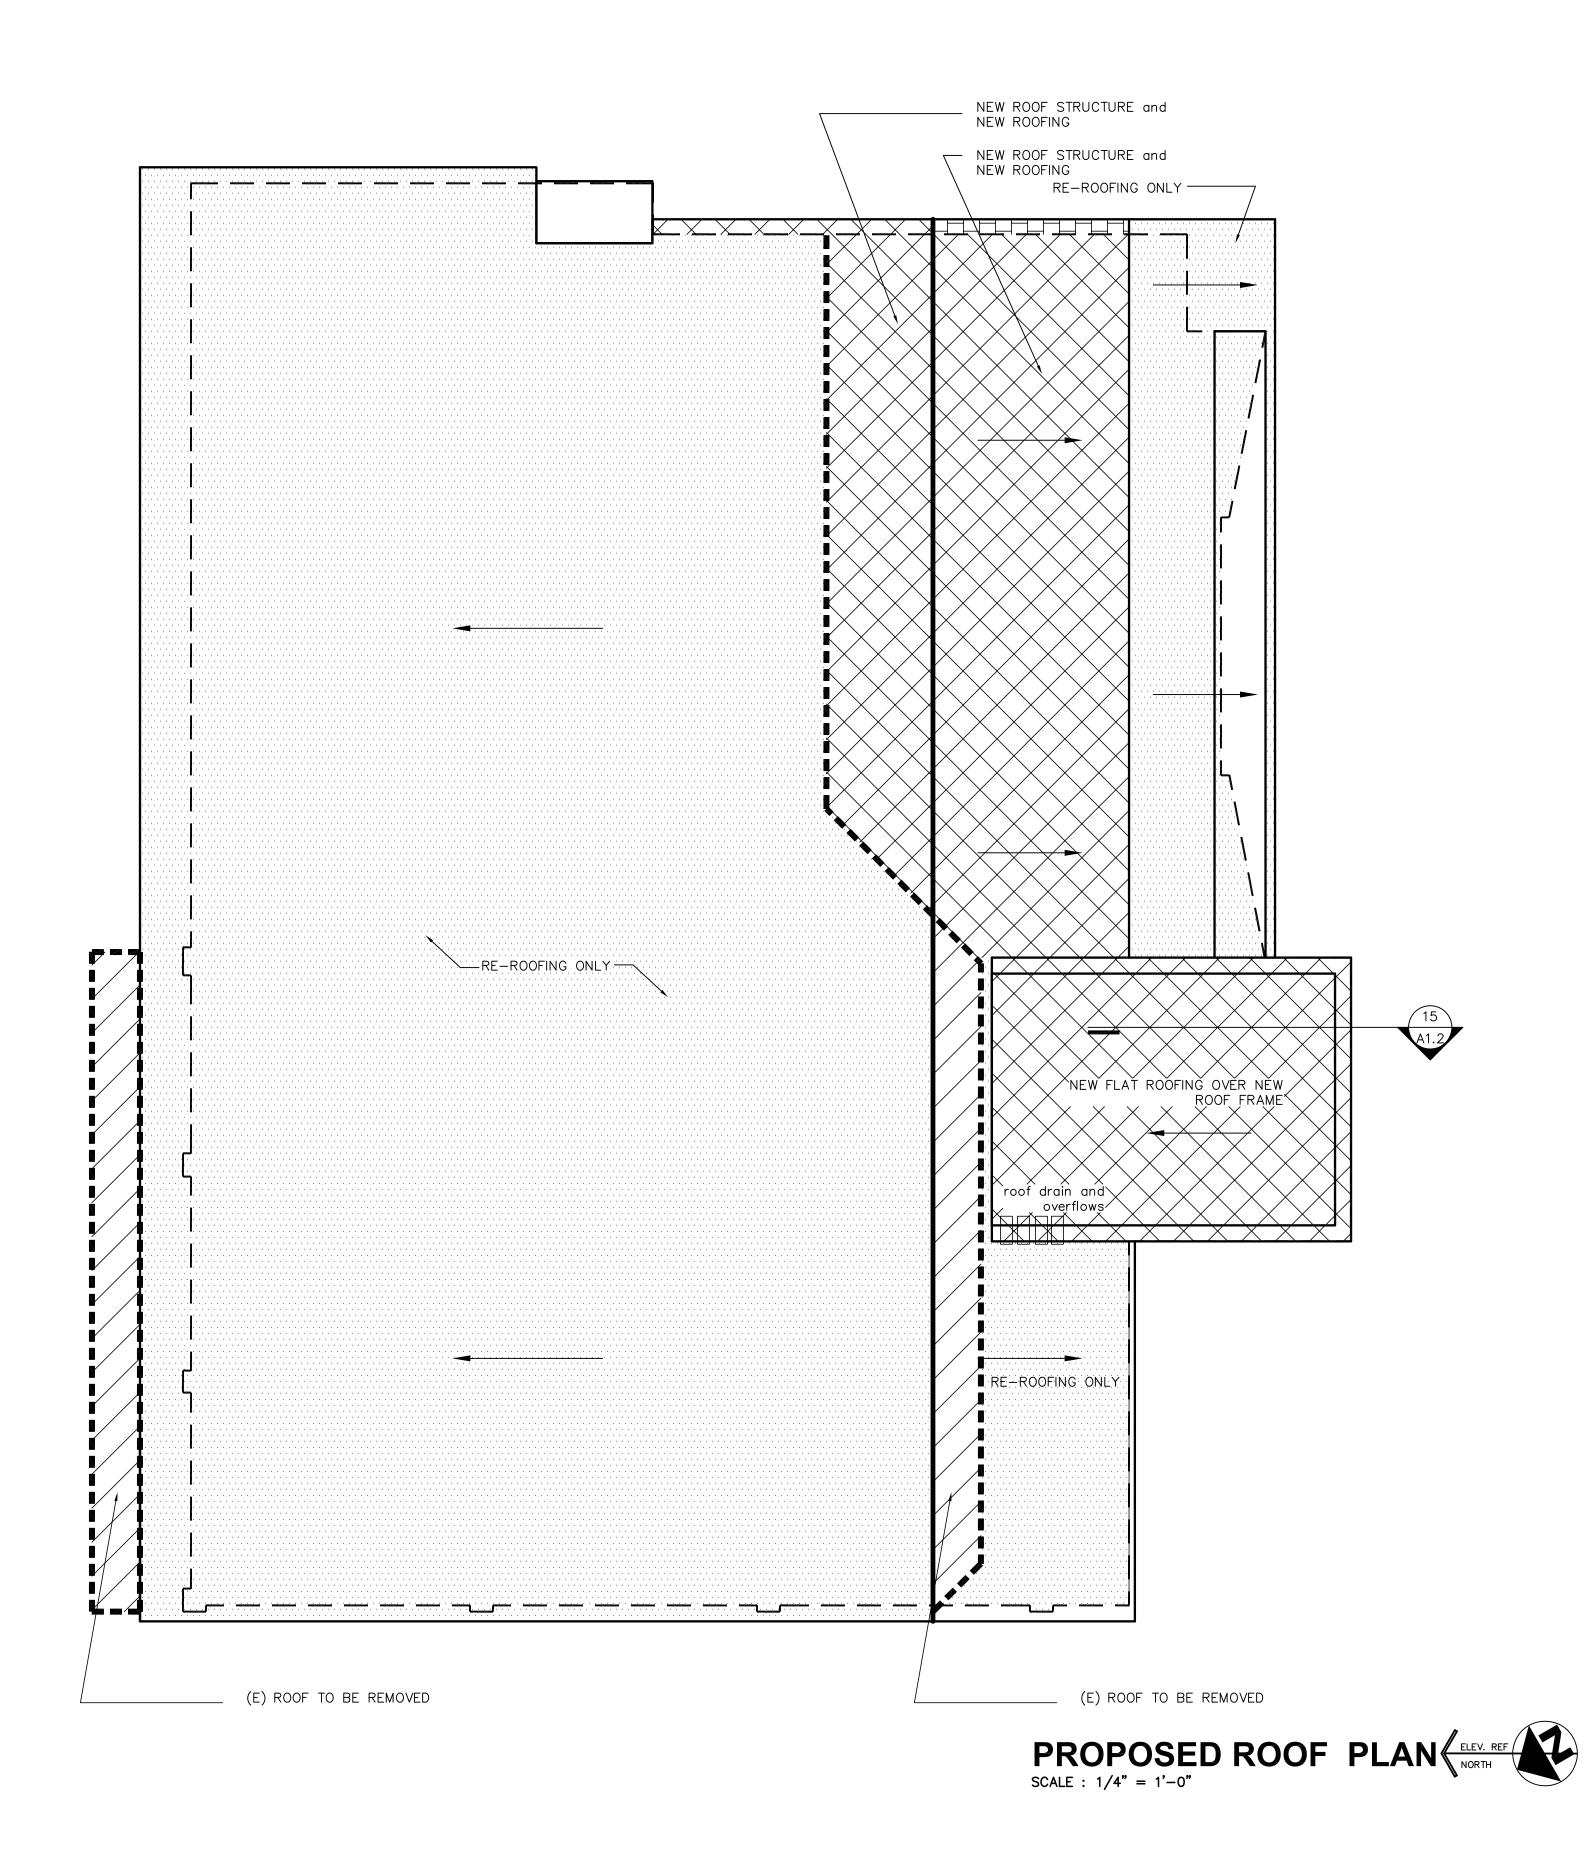

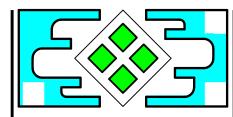


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Annie's Residence Remodeling

PROPOSED ROOF PLAN

01/20/22 ROA Change

DATE: 06/20/2022 JOB NO. TS211148
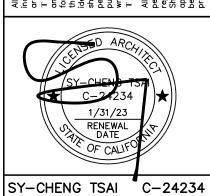
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1		
2		
3	06/20/22	Owner Rev
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8		

SHEET NO.

A1.5

ELEVATION NOTES:

- 1. EXTERIOR STUCCO FINISH:
 - A. STUCCO IS 3-COAT SYSTEM, 7/8-INCH MINIMUM. [CRC
 - INSTALL 26 GAGE GALVANIZED WEEP. [CRC 703.5.2.1] C. TWO LAYERS OF GRADE "D" BUILDING PAPER UNDER
- STUCCO OVER PLYWOOD SHEATHING. [CRC R703.6.3].
 D. PROVIDE WEEP SCREED AT FOUNDATION PLATE LONE ON
- ALL STUCCO WALLS [2019 CRC R703.2.1]. E. WEEP SCREED SHALL BE 4" ABOVE EARTH AND 2" ABOVE PAVED AREA.
- F. CRAWL SPACE VENTS DO NOT INSTALLED IN SHEAR

2. NEW WINDOWS SHALL MEET THE FOLLOWING SPECIFICATION:

- A. NEW WINDOW FRMAE TO BE YINYL, COLOR TO BE
- B. WINDOW GLAZING TO HAVE 0.31 U-FACTOR AND 0.27
- C. SLIDING GALLSS DOOR TO HAVE SAME U-FACTOR AND

3. BUILDING ADDRESS TO BE:

- COLOR TO BE CONTRAST WITH BACKGROUND COLOR. C. VISIBLE FRON STREET.



Western state metal roofing



EUROPEAN SIDING NORWEGIAN BOARD UH46 BRAZILIAN IPE


Specceramics




Venice Villa Terrazzo porcelain Graphite






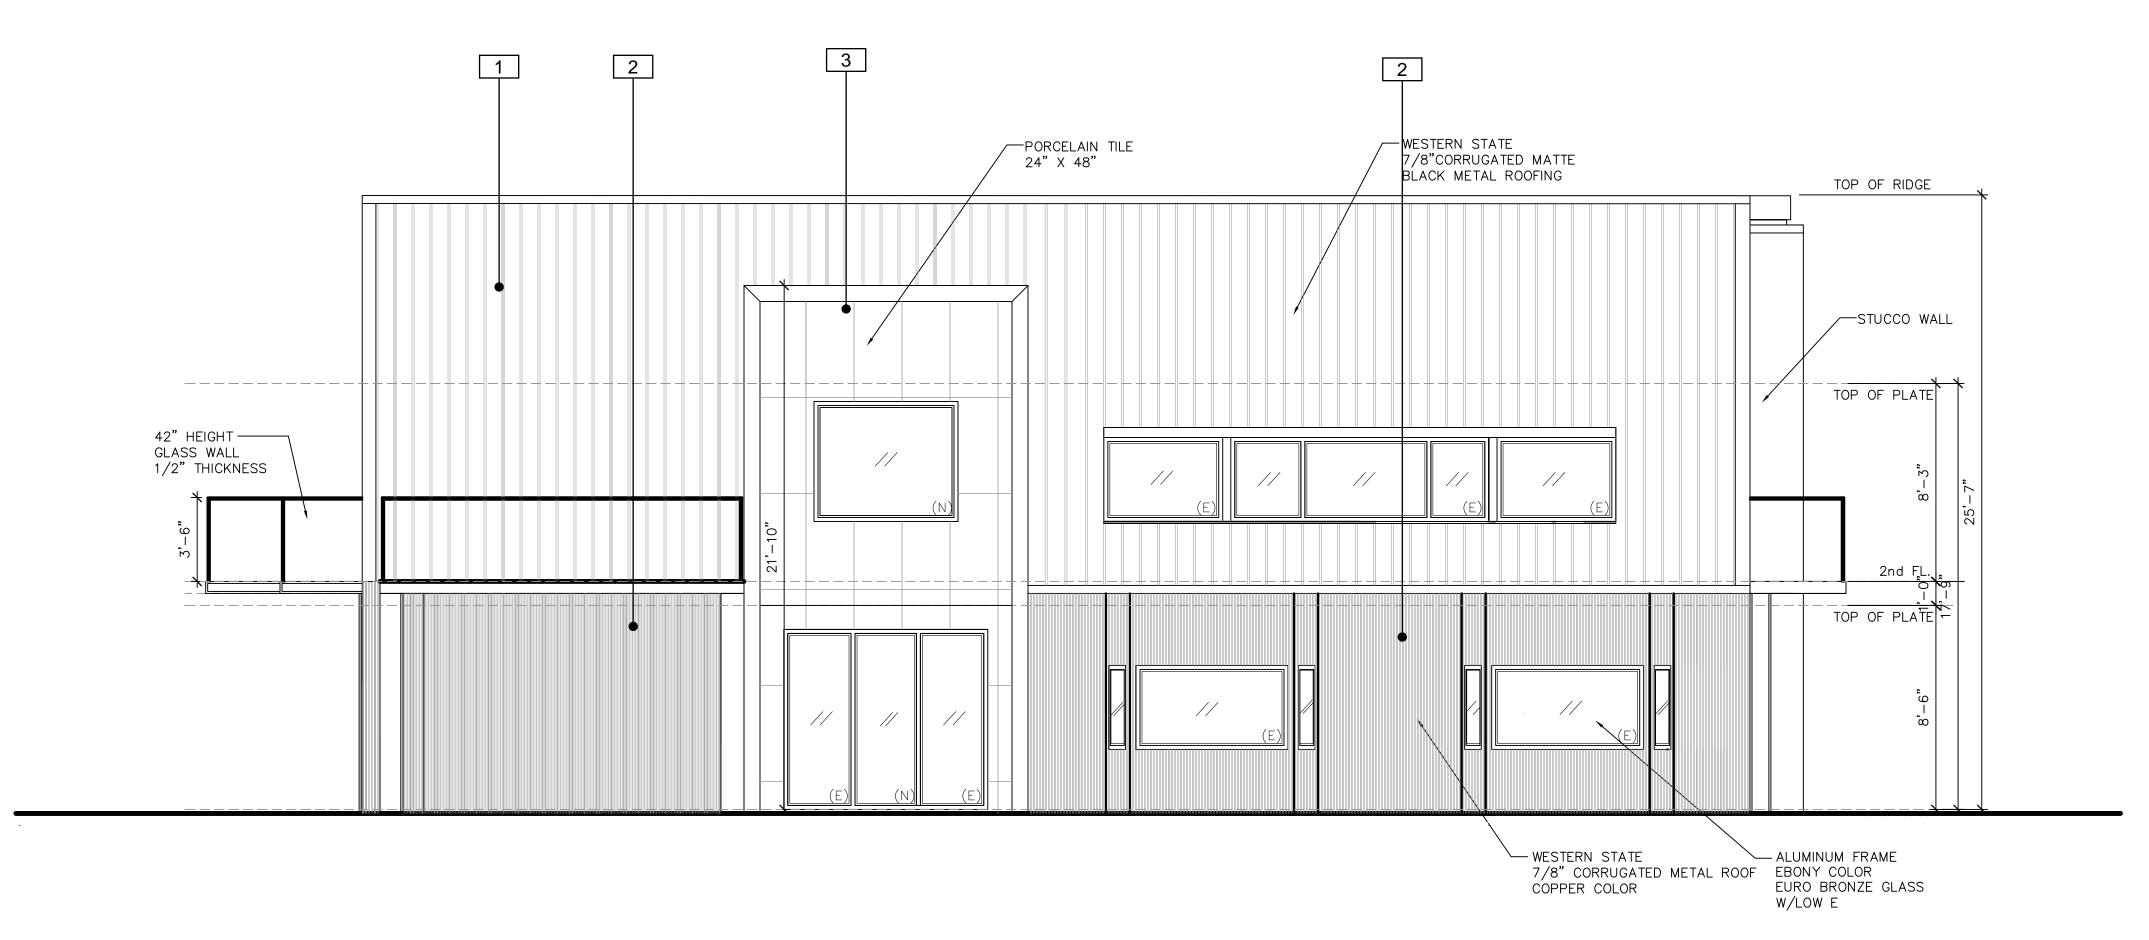



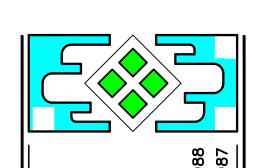

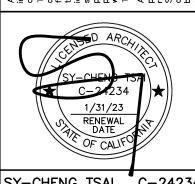

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EXISTING & PROPOSED ELEVATIONS

DATE: 06/20/2022 JOB NO. TS211148

ISSUE & REVISION 01/20/22 ROA Change

3 06/20/22 Owner Rev SHEET NO.

A2.0

ELEVATION NOTES:

- 1. EXTERIOR STUCCO FINISH:
 - A. STUCCO IS 3-COAT SYSTEM, 7/8-INCH MINIMUM. [CRC P703.6.2]
 - B. INSTALL 26 GAGE GALVANIZED WEEP. [CRC 703.5.2.1]C. TWO LAYERS OF GRADE "D" BUILDING PAPER UNDER
- STUCCO OVER PLYWOOD SHEATHING. [CRC R703.6.3].

 D. PROVIDE WEEP SCREED AT FOUNDATION PLATE LONE ON ALL STUCCO WALLS [2019 CRC R703.2.1].
- E. WEEP SCREED SHALL BE 4" ABOVE EARTH AND 2" ABOVE PAVED AREA.
- F. CRAWL SPACE VENTS DO NOT INSTALLED IN SHEAR

2. NEW WINDOWS SHALL MEET THE FOLLOWING SPECIFICATION:

- A. NEW WINDOW FRMAE TO BE YINYL, COLOR TO BE
- B. WINDOW GLAZING TO HAVE 0.31 U-FACTOR AND 0.27 SHGC.
- C. SLIDING GALLSS DOOR TO HAVE SAME U-FACTOR AND SHGC VALIF

3. BUILDING ADDRESS TO BE:

- Δ MINI 4" I FTTFI
- B. COLOR TO BE CONTRAST WITH BACKGROUND COLOR.C. VISIBLE FRON STREET.

1 7/8" corrugated metal roofing sheets

Western state metal roofing



EUROPEAN SIDING NORWEGIAN BOARD UH46 BRAZILIAN IPE


3 Specceramics




Venice Villa Terrazzo porcelain Graphite





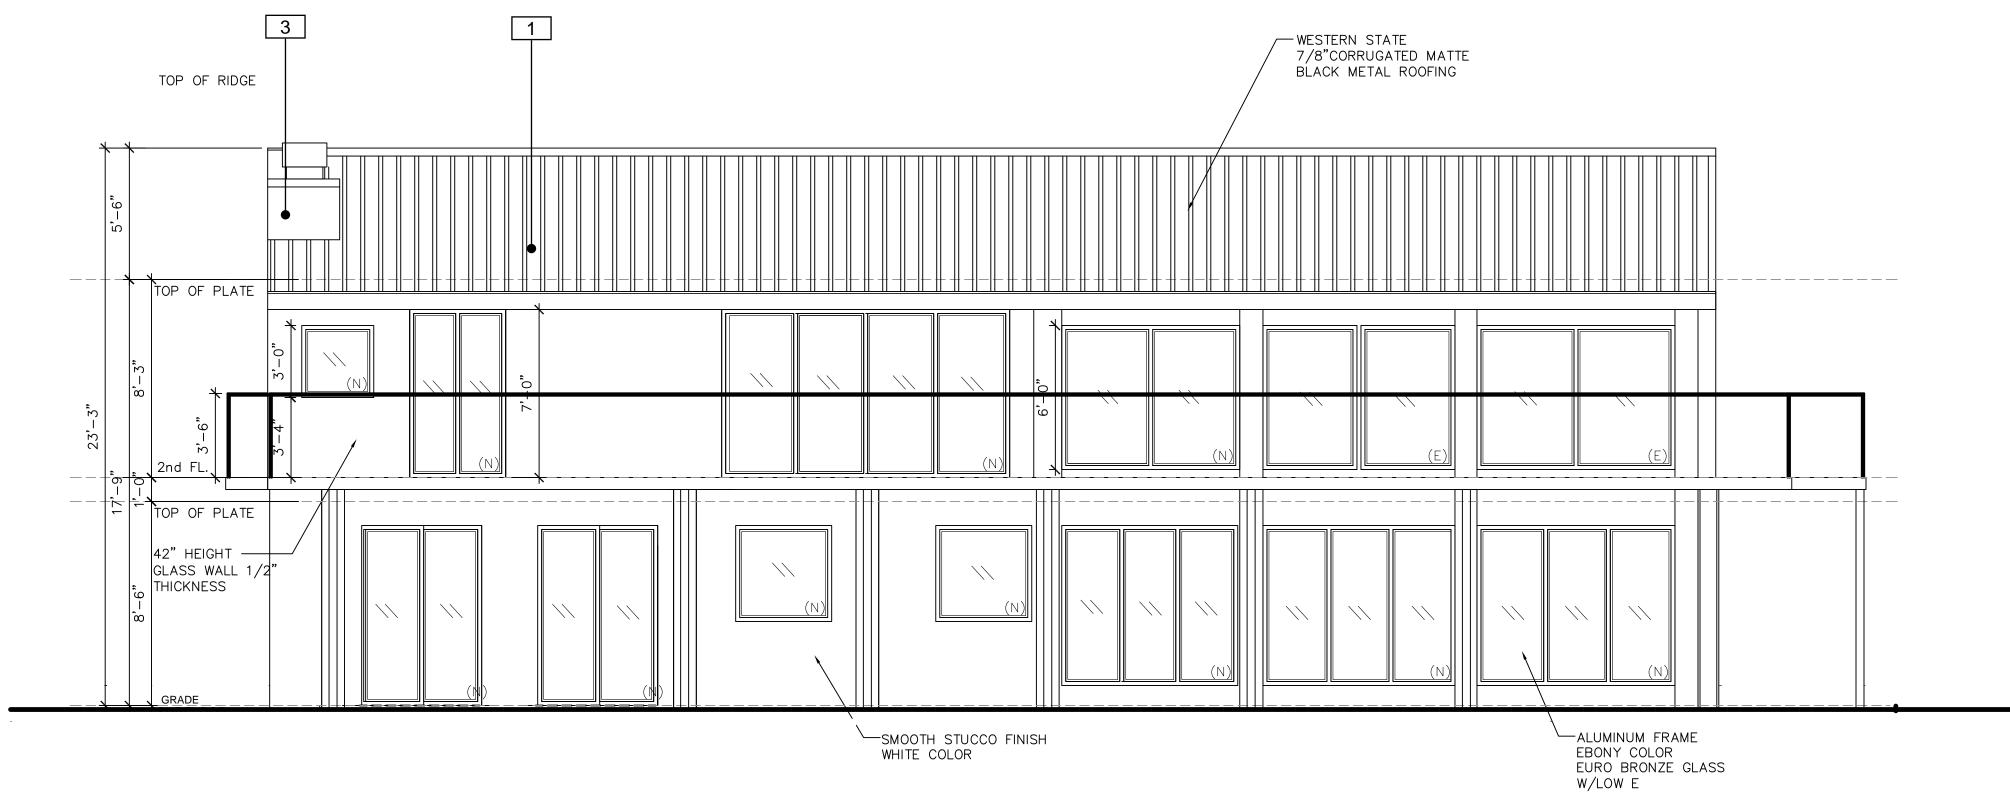



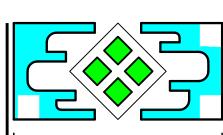

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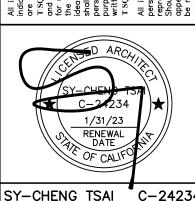
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d by, and the property of cooking and the property of created, evolved and developed on and in connection with, fifed project. None of such signs, arrangements or plans last, arrangements or plans were by or disclosed to any irm or corporation for any irm or corporation for any emission of E. CONSULTING GROUP. Inc.

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Annie's Residence Remodeling

EXISTING &
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ELEVATIONS

DATE: 06/20/2022 JOB NO. TS211148

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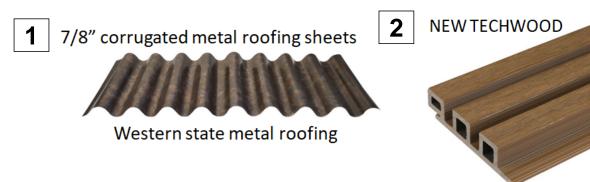
01/20/22 ROA Change

SHEET NO.


A2.1

ELEVATION NOTES:


- 1. EXTERIOR STUCCO FINISH:
 - A. STUCCO IS 3-COAT SYSTEM, 7/8-INCH MINIMUM. [CRC
 - B. INSTALL 26 GAGE GALVANIZED WEEP. [CRC 703.5.2.1] C. TWO LAYERS OF GRADE "D" BUILDING PAPER UNDER
- STUCCO OVER PLYWOOD SHEATHING. [CRC R703.6.3].
 D. PROVIDE WEEP SCREED AT FOUNDATION PLATE LONE ON
- ALL STUCCO WALLS [2019 CRC R703.2.1]. E. WEEP SCREED SHALL BE 4" ABOVE EARTH AND 2"
- ABOVE PAVED AREA. F. CRAWL SPACE VENTS DO NOT INSTALLED IN SHEAR
- 2. NEW WINDOWS SHALL MEET THE FOLLOWING SPECIFICATION:
- A. NEW WINDOW FRMAE TO BE YINYL, COLOR TO BE SELECTED.
- B. WINDOW GLAZING TO HAVE 0.31 U-FACTOR AND 0.27 SHGC.
 C. SLIDING GALLSS DOOR TO HAVE SAME U-FACTOR AND
- SHGC VAUE.
- 3. BUILDING ADDRESS TO BE:
- B. COLOR TO BE CONTRAST WITH BACKGROUND COLOR. C. VISIBLE FRON STREET.





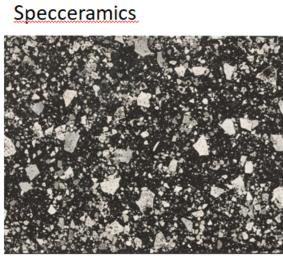


Venice Villa Terrazzo porcelain Graphite

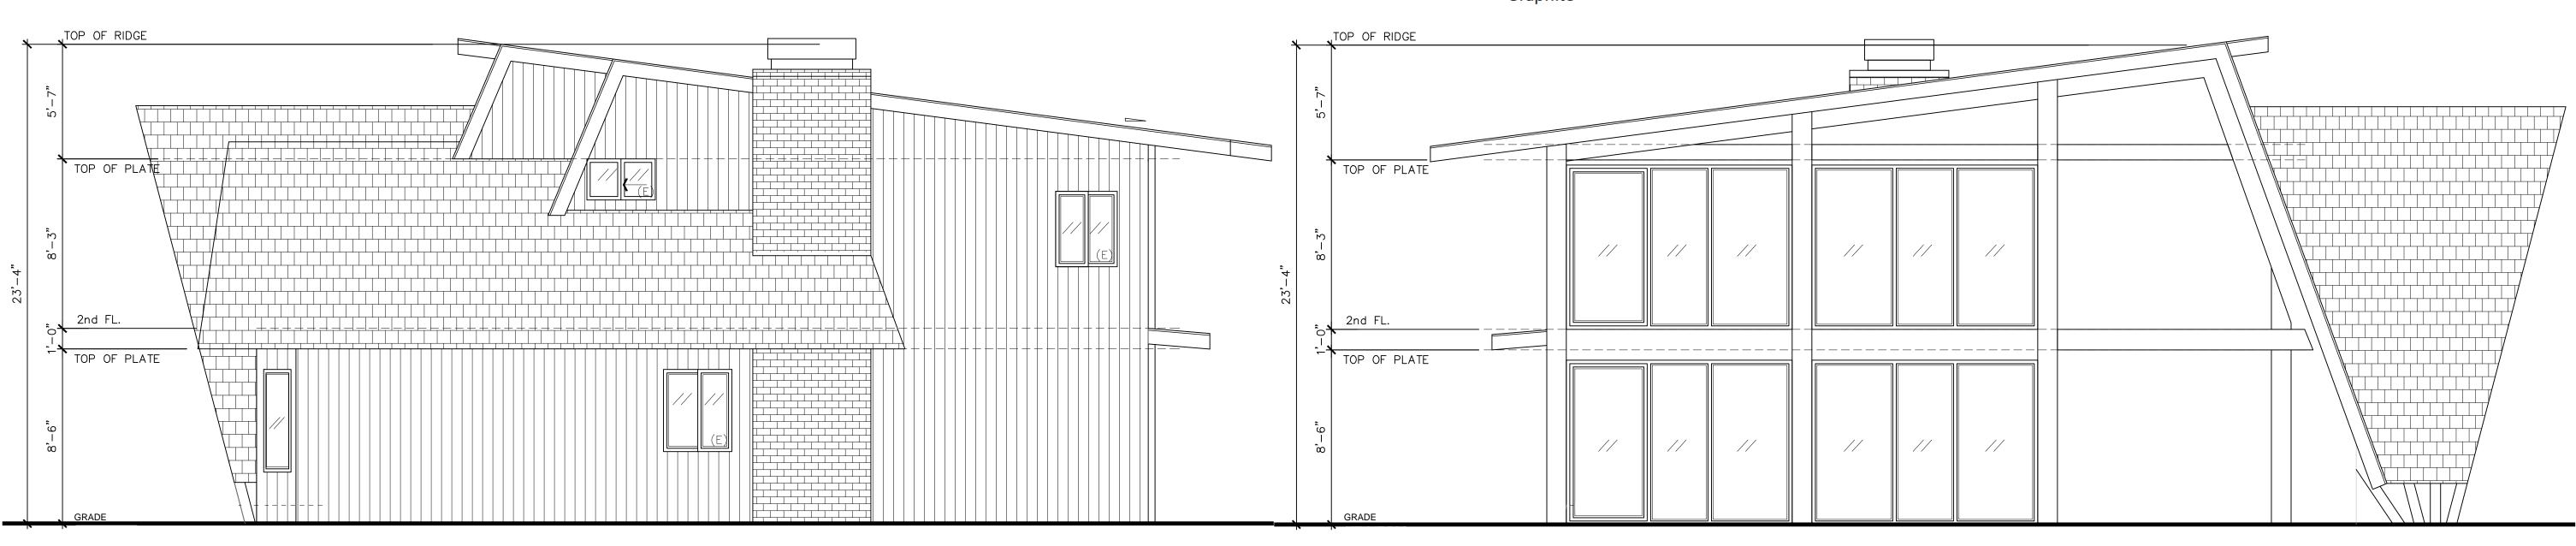


EXISTING RIGHT ELEVATION


PROPOSED RIGHT ELEVATION

EXISTING LEFT ELEVATION

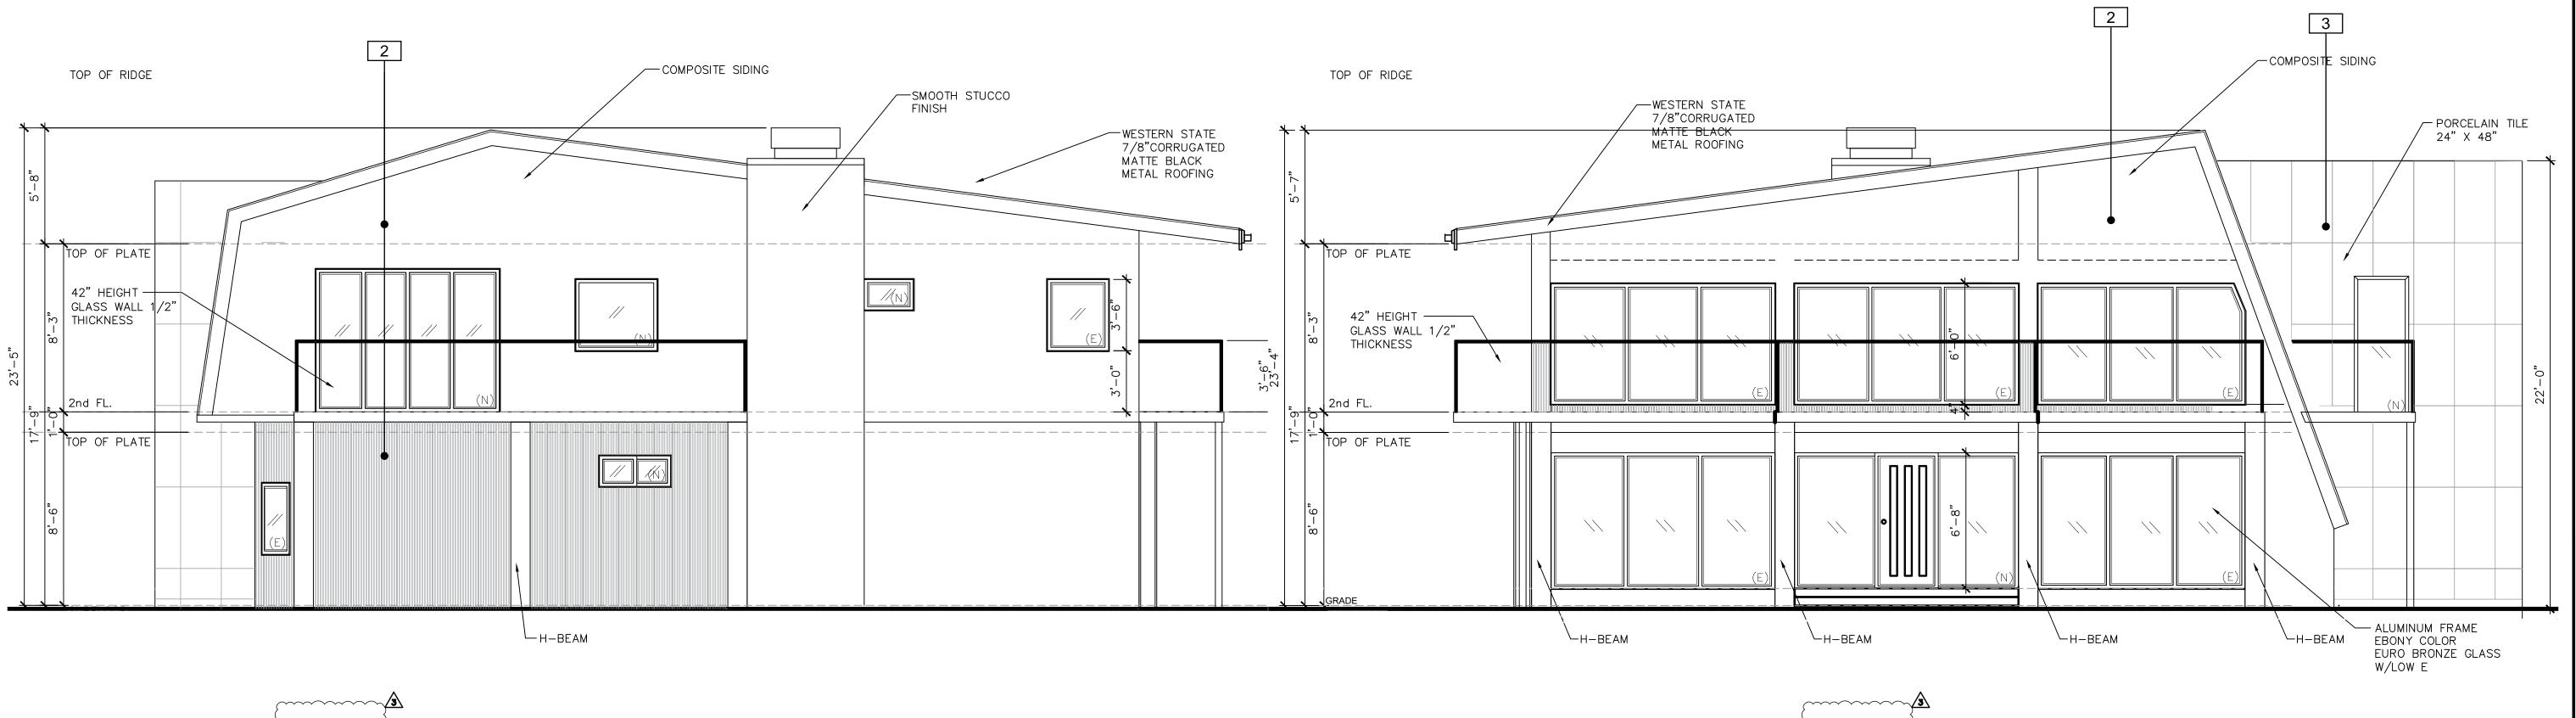



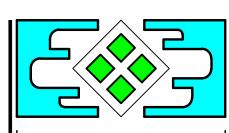

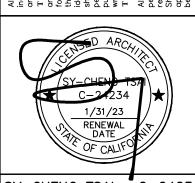

SY-CHENG TSAI C-24234

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Mill Road,

|1470 Page |

EXISTING & PROPOSED ELEVATIONS

DATE: 06/20/2022 JOB NO. TS211148

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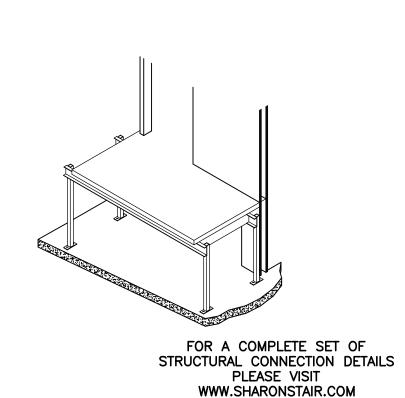
01/20/22 ROA Change 06/20/22 | Owner Rev


DRAWN BY:

SHEET NO.

ANGLE/TUBE STRUT LANDING SUPPORTS

FOR STUDWALL/DRYWALL PARTITION AND HOLLOW MASONRY BLOCK WALL FRAMED STAIRWELLS



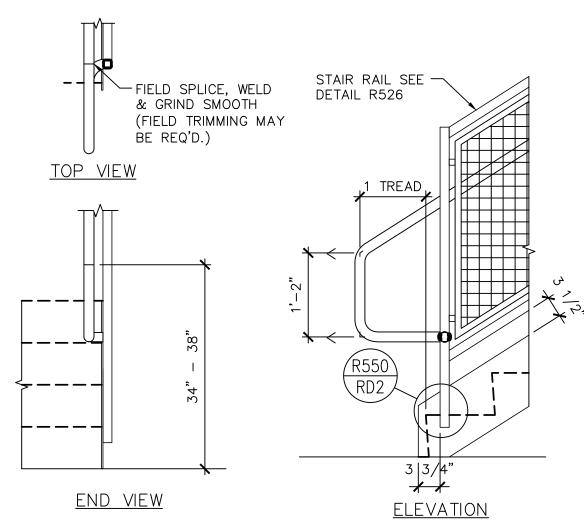

STARTER RAIL WITH OUT LEVEL OFF HANDRAIL

1. POST AND TOP LINE MATERIAL TO BE HSS 1 1/2" x 1 1/2" x 0.120"

2. HANDRAIL MATERIAL TO BE 1 1/2" ~ (1.66" O.D.) PIPE


3. PANEL TO BE 8 GA. x 2" SQUARE WIRE MESH

NOSING REQUIRED AT SOILD— RISER RUN AT OPEN RISERS, A SPHERE 4" IN DIAMETER CANNOT PASS THROUGH (EXCEPT FOR STAIRS WITH A TOTAL RISE OF 30" OR LESS). PROTECT ENCLOSED ACCESSIBLE SPACE UNDER STAIRS WITH 1/2" GYPSUM BOARD


TYPICAL STAIR SECTION R311.7


- 1. THESE REGULATIONS APPLY TO STAIRWAYS FOR ONE— AND TWO—FAMILY DWELLINGS AND TOWNHOUSES SUBJECT TO THE 2010 CRC. REFE TO THE 2016 CBC. REQUIREMENTS FOR STAIRS IN OTHER CONDITIONS.
- 2. FOR EXCEPTIONS RELATED TO THE CONSTRUCTION OF CIRCULAR, SPIRAL, OR WINDING STAIRWAYS, SEE R311.7.10.
- 3. THE LARGEST RISE OR RUN WITHIN ANY FLIGHT OF STAIRS IS NOT TO EXCEED THE SMALLEST BY MORE THAN 3/8".
- 4. A LANDING EXTENDING THE WIDTH OF THE STAIR AND MEASURING A MINIMUM OF 36" IN THE DIRECTION OF TRAVEL IS REQUIRED AT THE TOP AND BOTTOM OF EVERY STAIRWAY.
- 5. A FLOOR LANDING IS NOT REQUIRED AT THE TOP OF AN INTERIOR FLIGHT OF STAIRS, PROVIDED A DOOR DOES NOT SWING OVER THE STAIRS.
- 6. INTERIOR AND EXTERIOR STAIRS MUST BE ILLMINATED WITH AN ARTIFICIAL LIGHT SOURCE AT EACH LANDING OR OVER EACH STAIRWAY SECTION PER R3036. LIGHT ACTIVATION MUST BE ACCESSIBLE AT THE TOP AND BOTTOM OF EACH LANDING WITHOUT TRAVERSING ANY STEPS. EXTERIOR STAIRWAYS MUST BE CONTROLLED FROM INSIDE THE DWELLING UNIT UNLESS CONTINUOUSLY ILLUMINATED OR AUTOMATICALLY CONTROLLED.



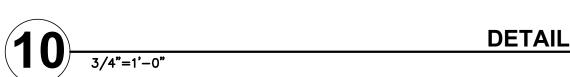

12 GA x 1"—

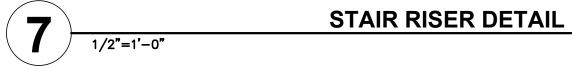

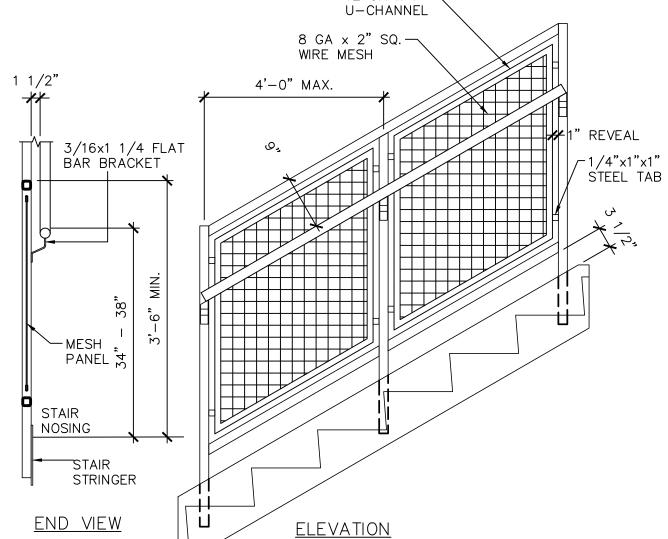

STARTER RAIL WITH OUT LEVEL OFF HANDRAIL

1. POST AND TOP LINE MATERIAL TO BE HSS 1 1/2" x 1 1/2" x 0.120"

2. HANDRAIL MATERIAL TO BE 1 1/2"~ (1.66" O.D.) PIPE

3. PANEL TO BE 8 GA. x 2" SQUARE WIRE MESH

WOOD FRAMING SEE
STRUC. DWGS.

5/8" GYP. BD. TYP.

2X WOOD CARRIAGE

'X' FIRE, TAPED &
PAINT. SEE PLAN
FOR SEILING PLAN


7/8" MIN. THK.
WOOD TREAD TYP.

NOTE: CHECK W/ STRUC. DWG. FOR FRAMING

11 DETAIL

8 1 1/2"=1'-0" STAIR DETAIL

R-STAIR-DIL-19

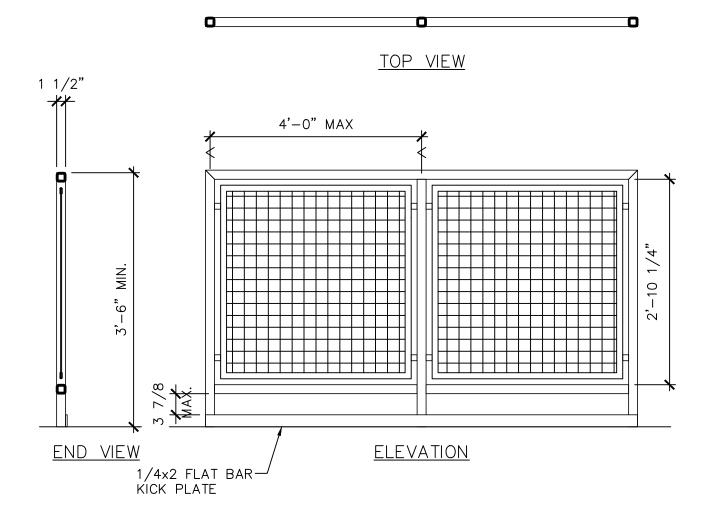

STANDARD GUARD RAIL WITH HANDRAIL


1. POST AND TOP LINE MATERIAL TO BE HSS 1 1/2" x 1 1/2" x 0.120"

2. HANDRAIL MATERIAL TO BE 1 1/2" ~ (1.66" O.D.) PIPE

3. PANEL TO BE 8 GA. x 2" SQUARE WIRE MESH

12 3/4"=1'-0"

DETAIL

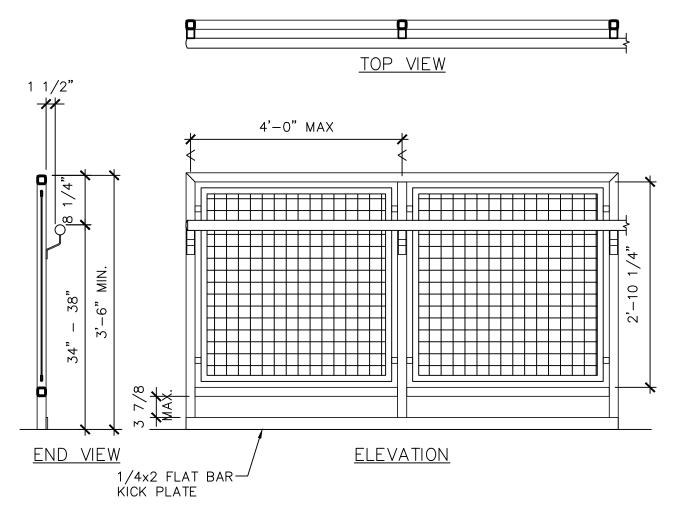


STANDARD GUARD RAIL WITH HANDRAIL


1. POST AND TOP LINE MATERIAL TO BE HSS 1 1/2" x 1 1/2" x 0.120"

2. HANDRAIL MATERIAL TO BE 1 1/2"~ (1.66" O.D.) PIPE

3. PANEL TO BE 8 GA. x 2" SQUARE WIRE MESH

9 DETAIL

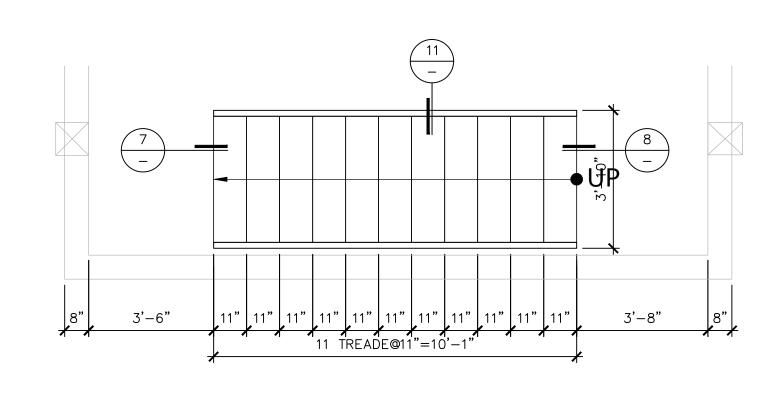

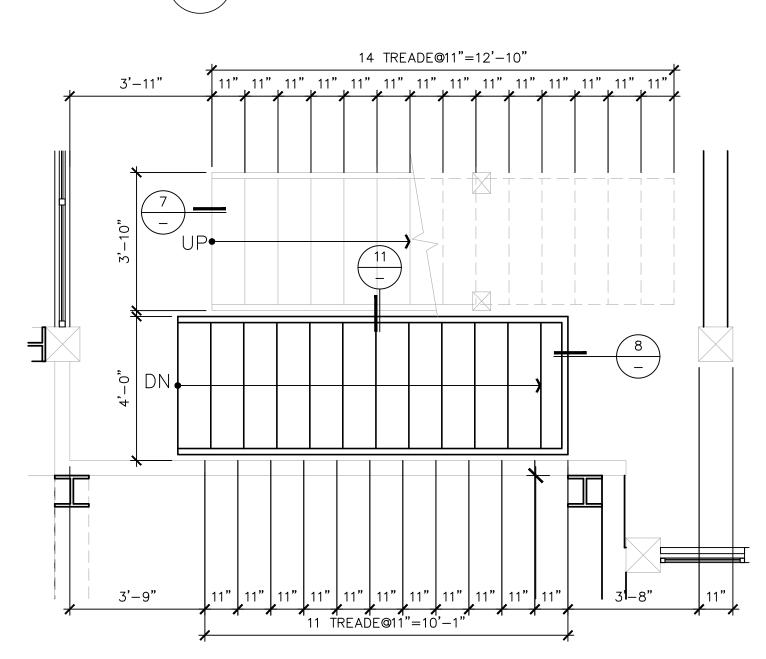


(N)BASEMENT FLOOR STAIR PLAN

1st FLOOR STAIR PLAN

(E)2nd FLOOR STAIR PLAN


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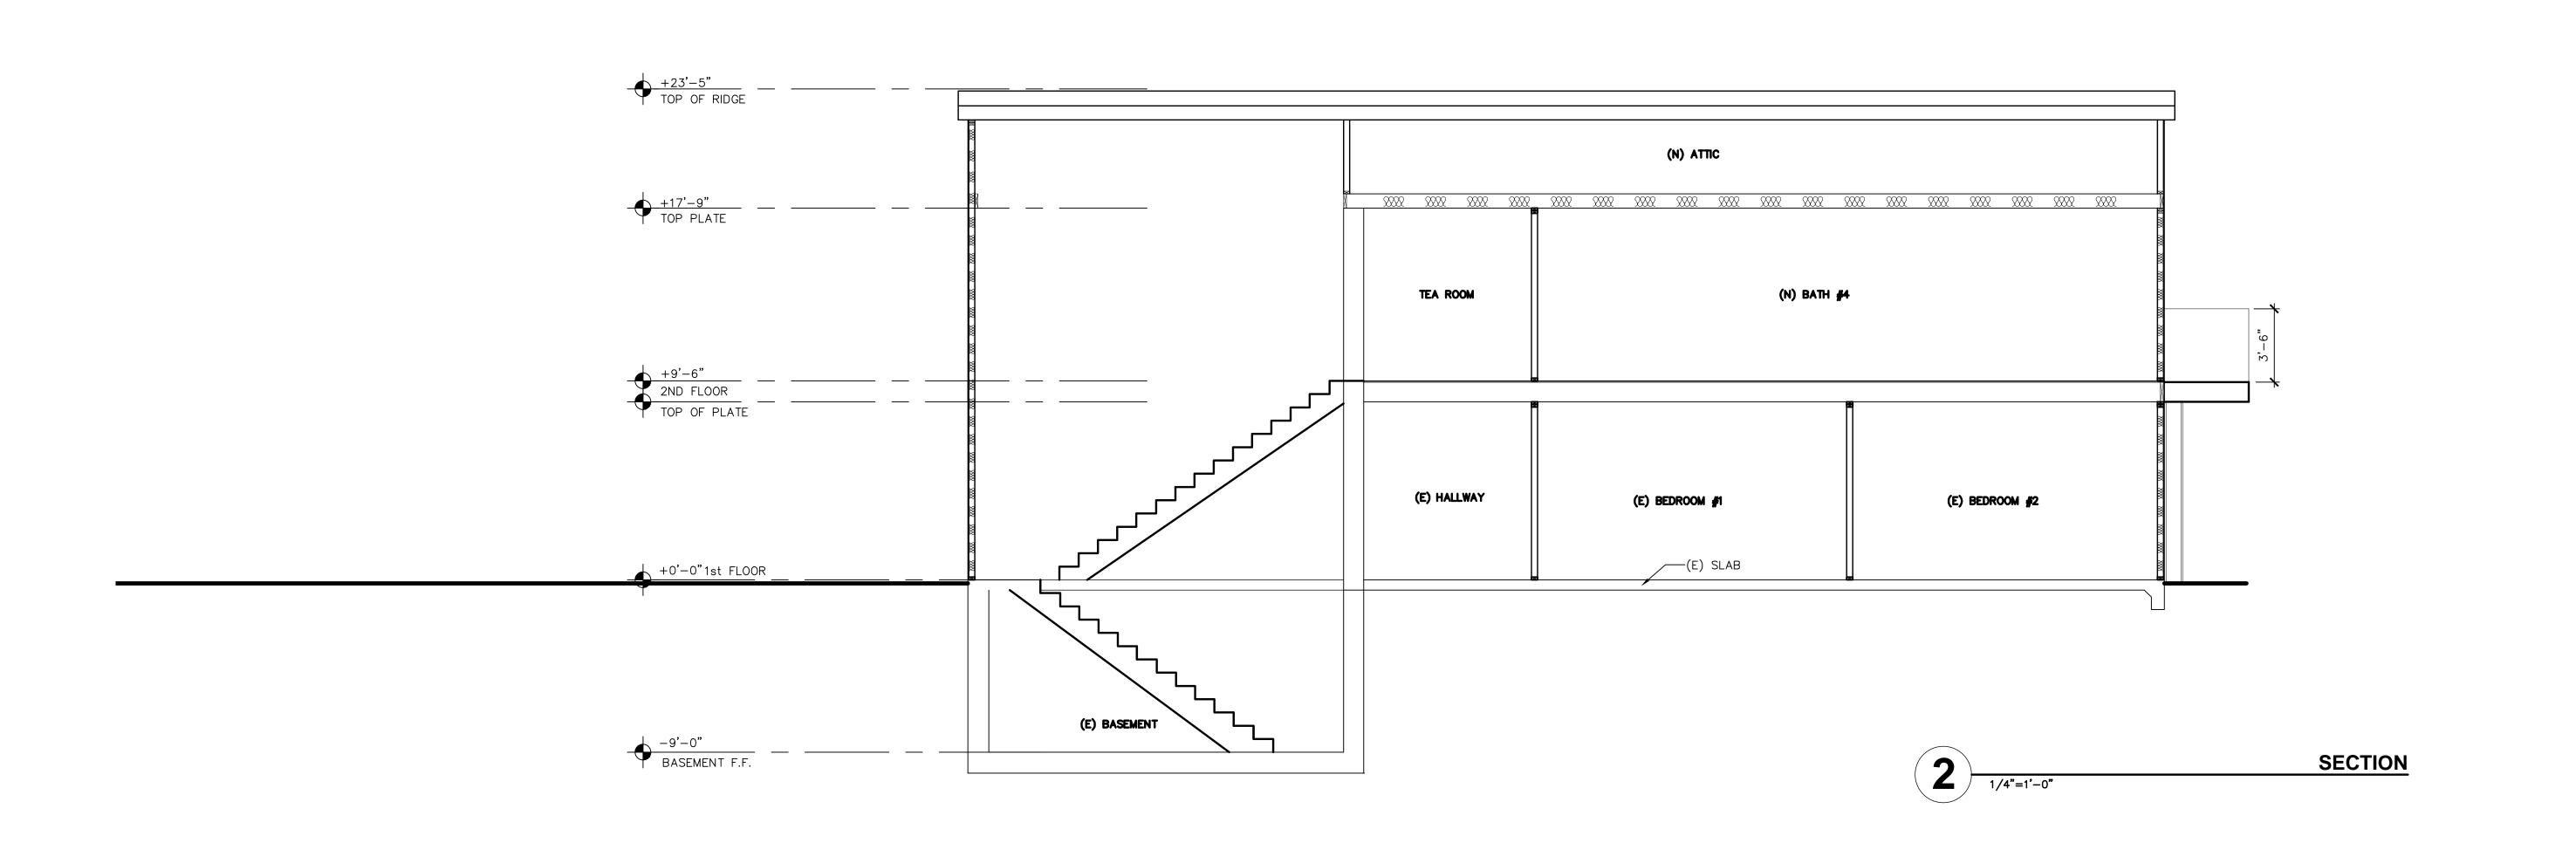


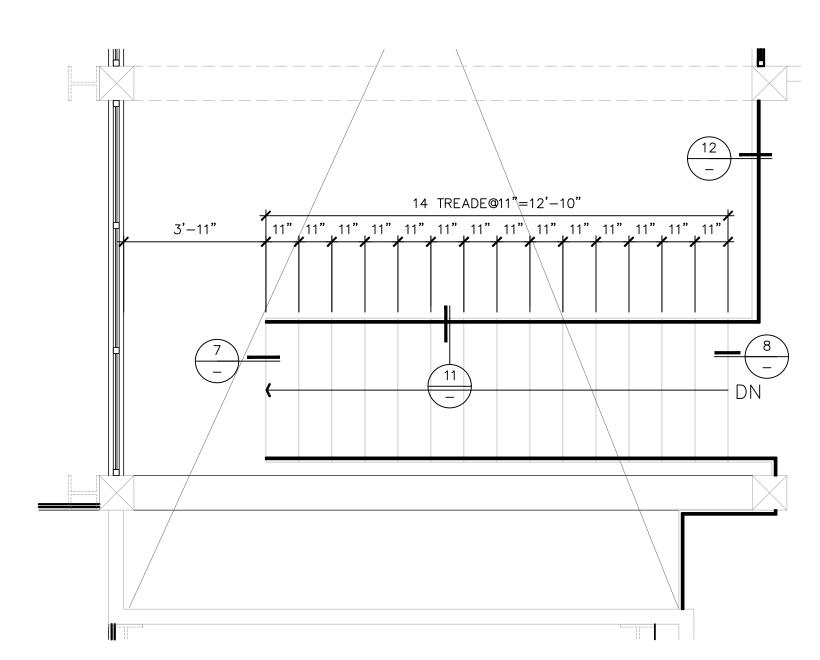
3/8"=1'-0"

3/8"=1'-0"





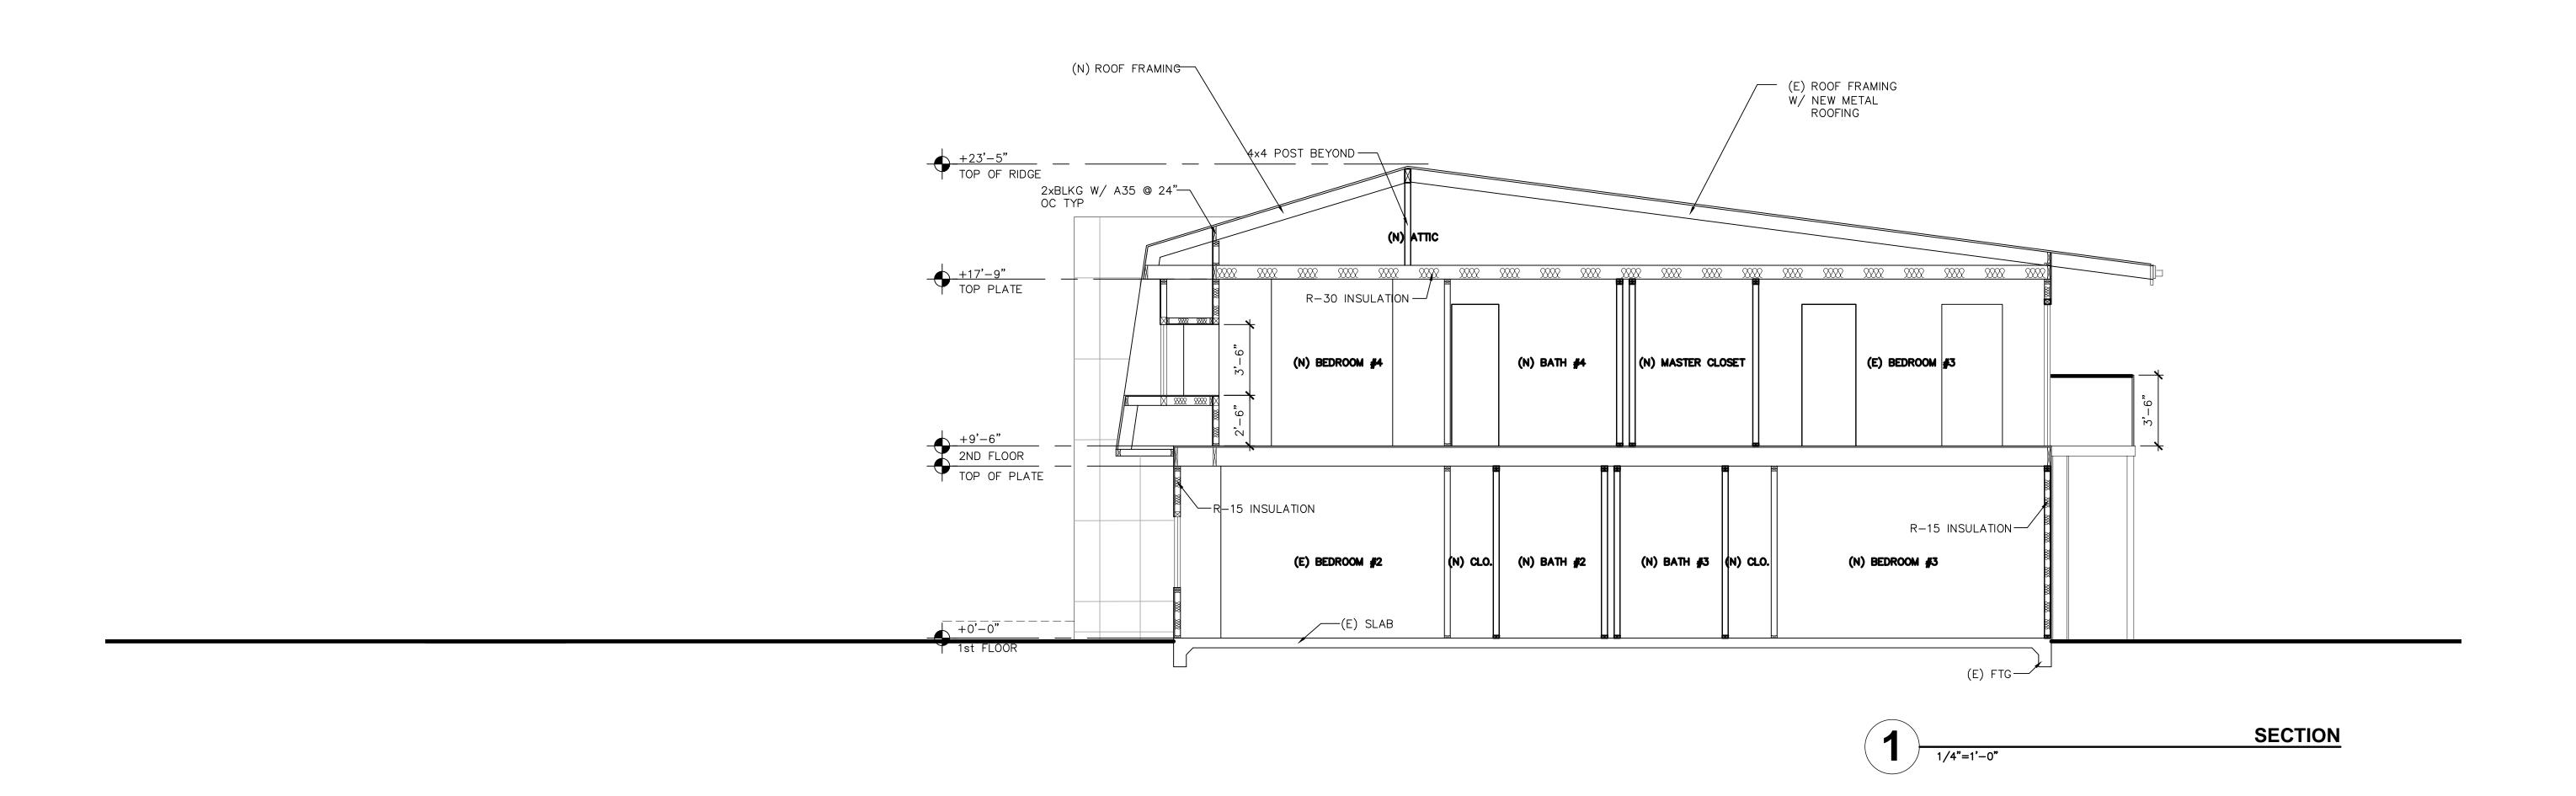

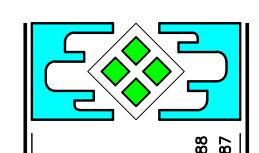



SY-CHENG TSAI C-24234

Alto Hills,

11470 Page Mill Road,

Annie's Residence Remodeling

SECTIONS


DATE: 06/20/2022 JOB NO. TS211148


ISSUE & REVISION

	01/20/22	ROA Change
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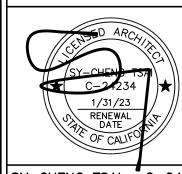




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ie's Residence Remodeling
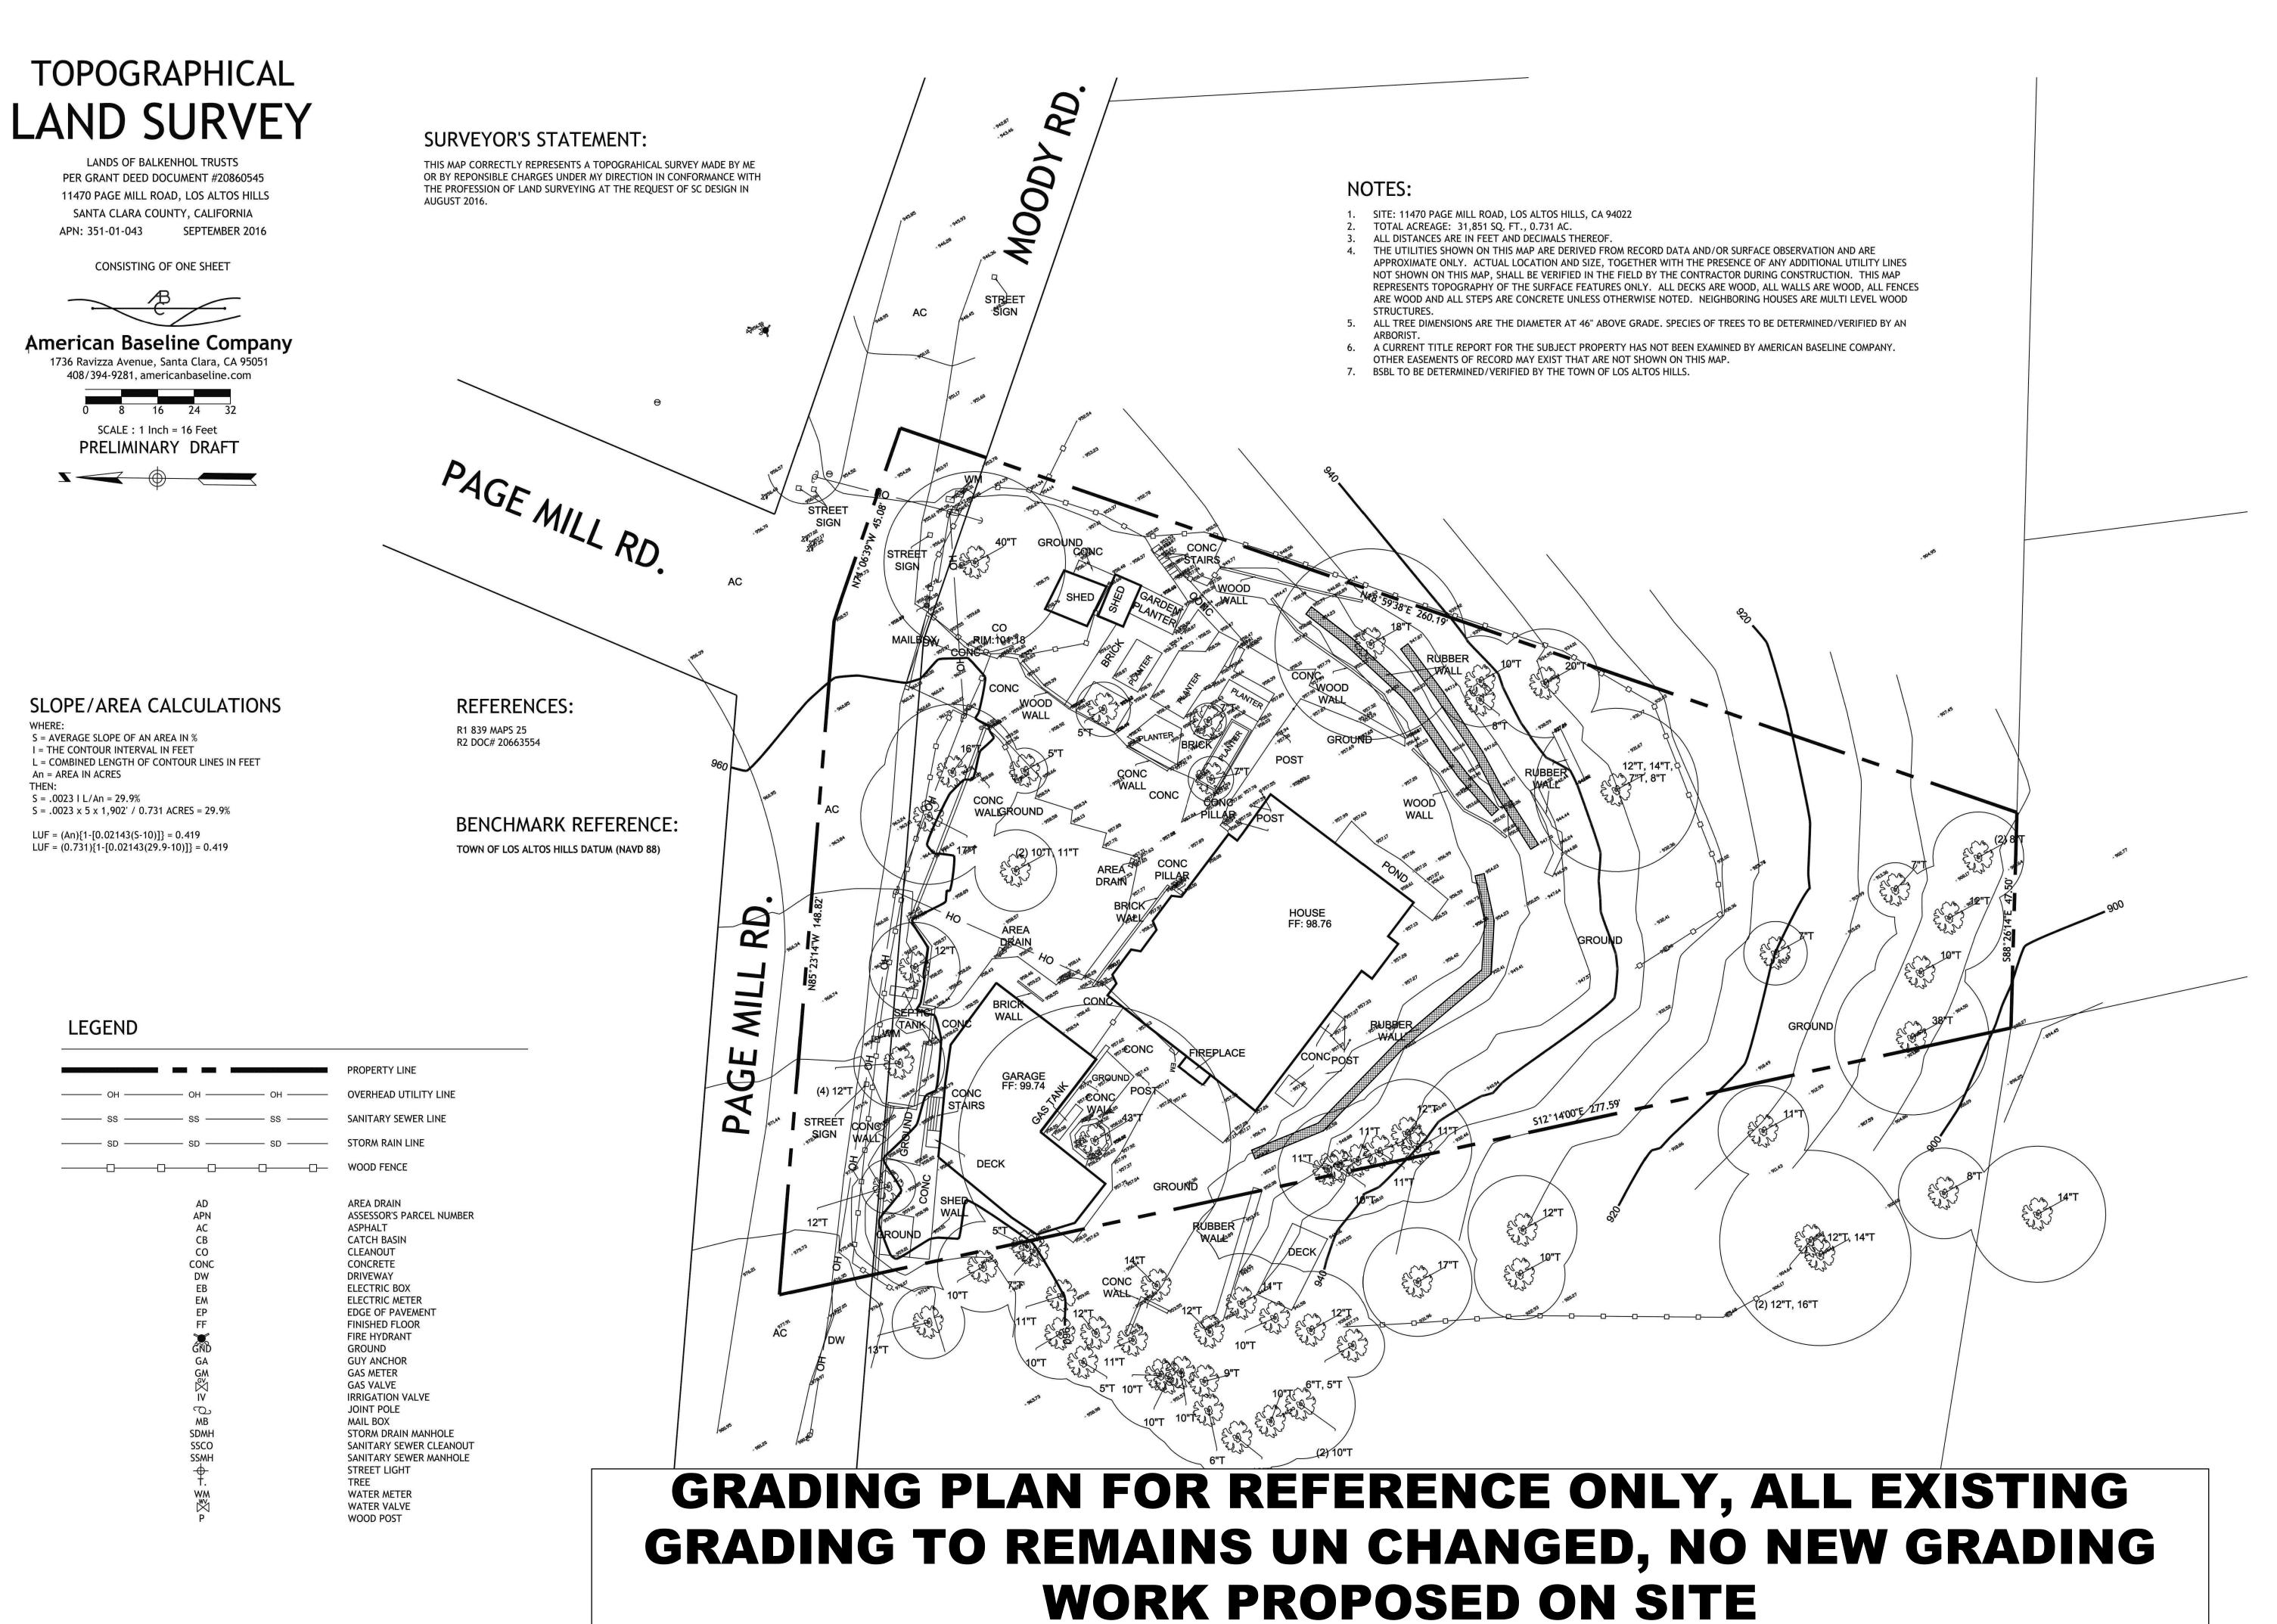
> EXISTING GRADING PLAN

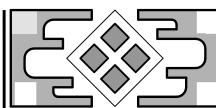DATE: 06/20/2022 JOB NO. TS211148


ISSUE & REVISION

01/20/22 ROA Change

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3 06/20/22 Owner Rev
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ANDSCAPE

ANDSCA

's Residence modeling

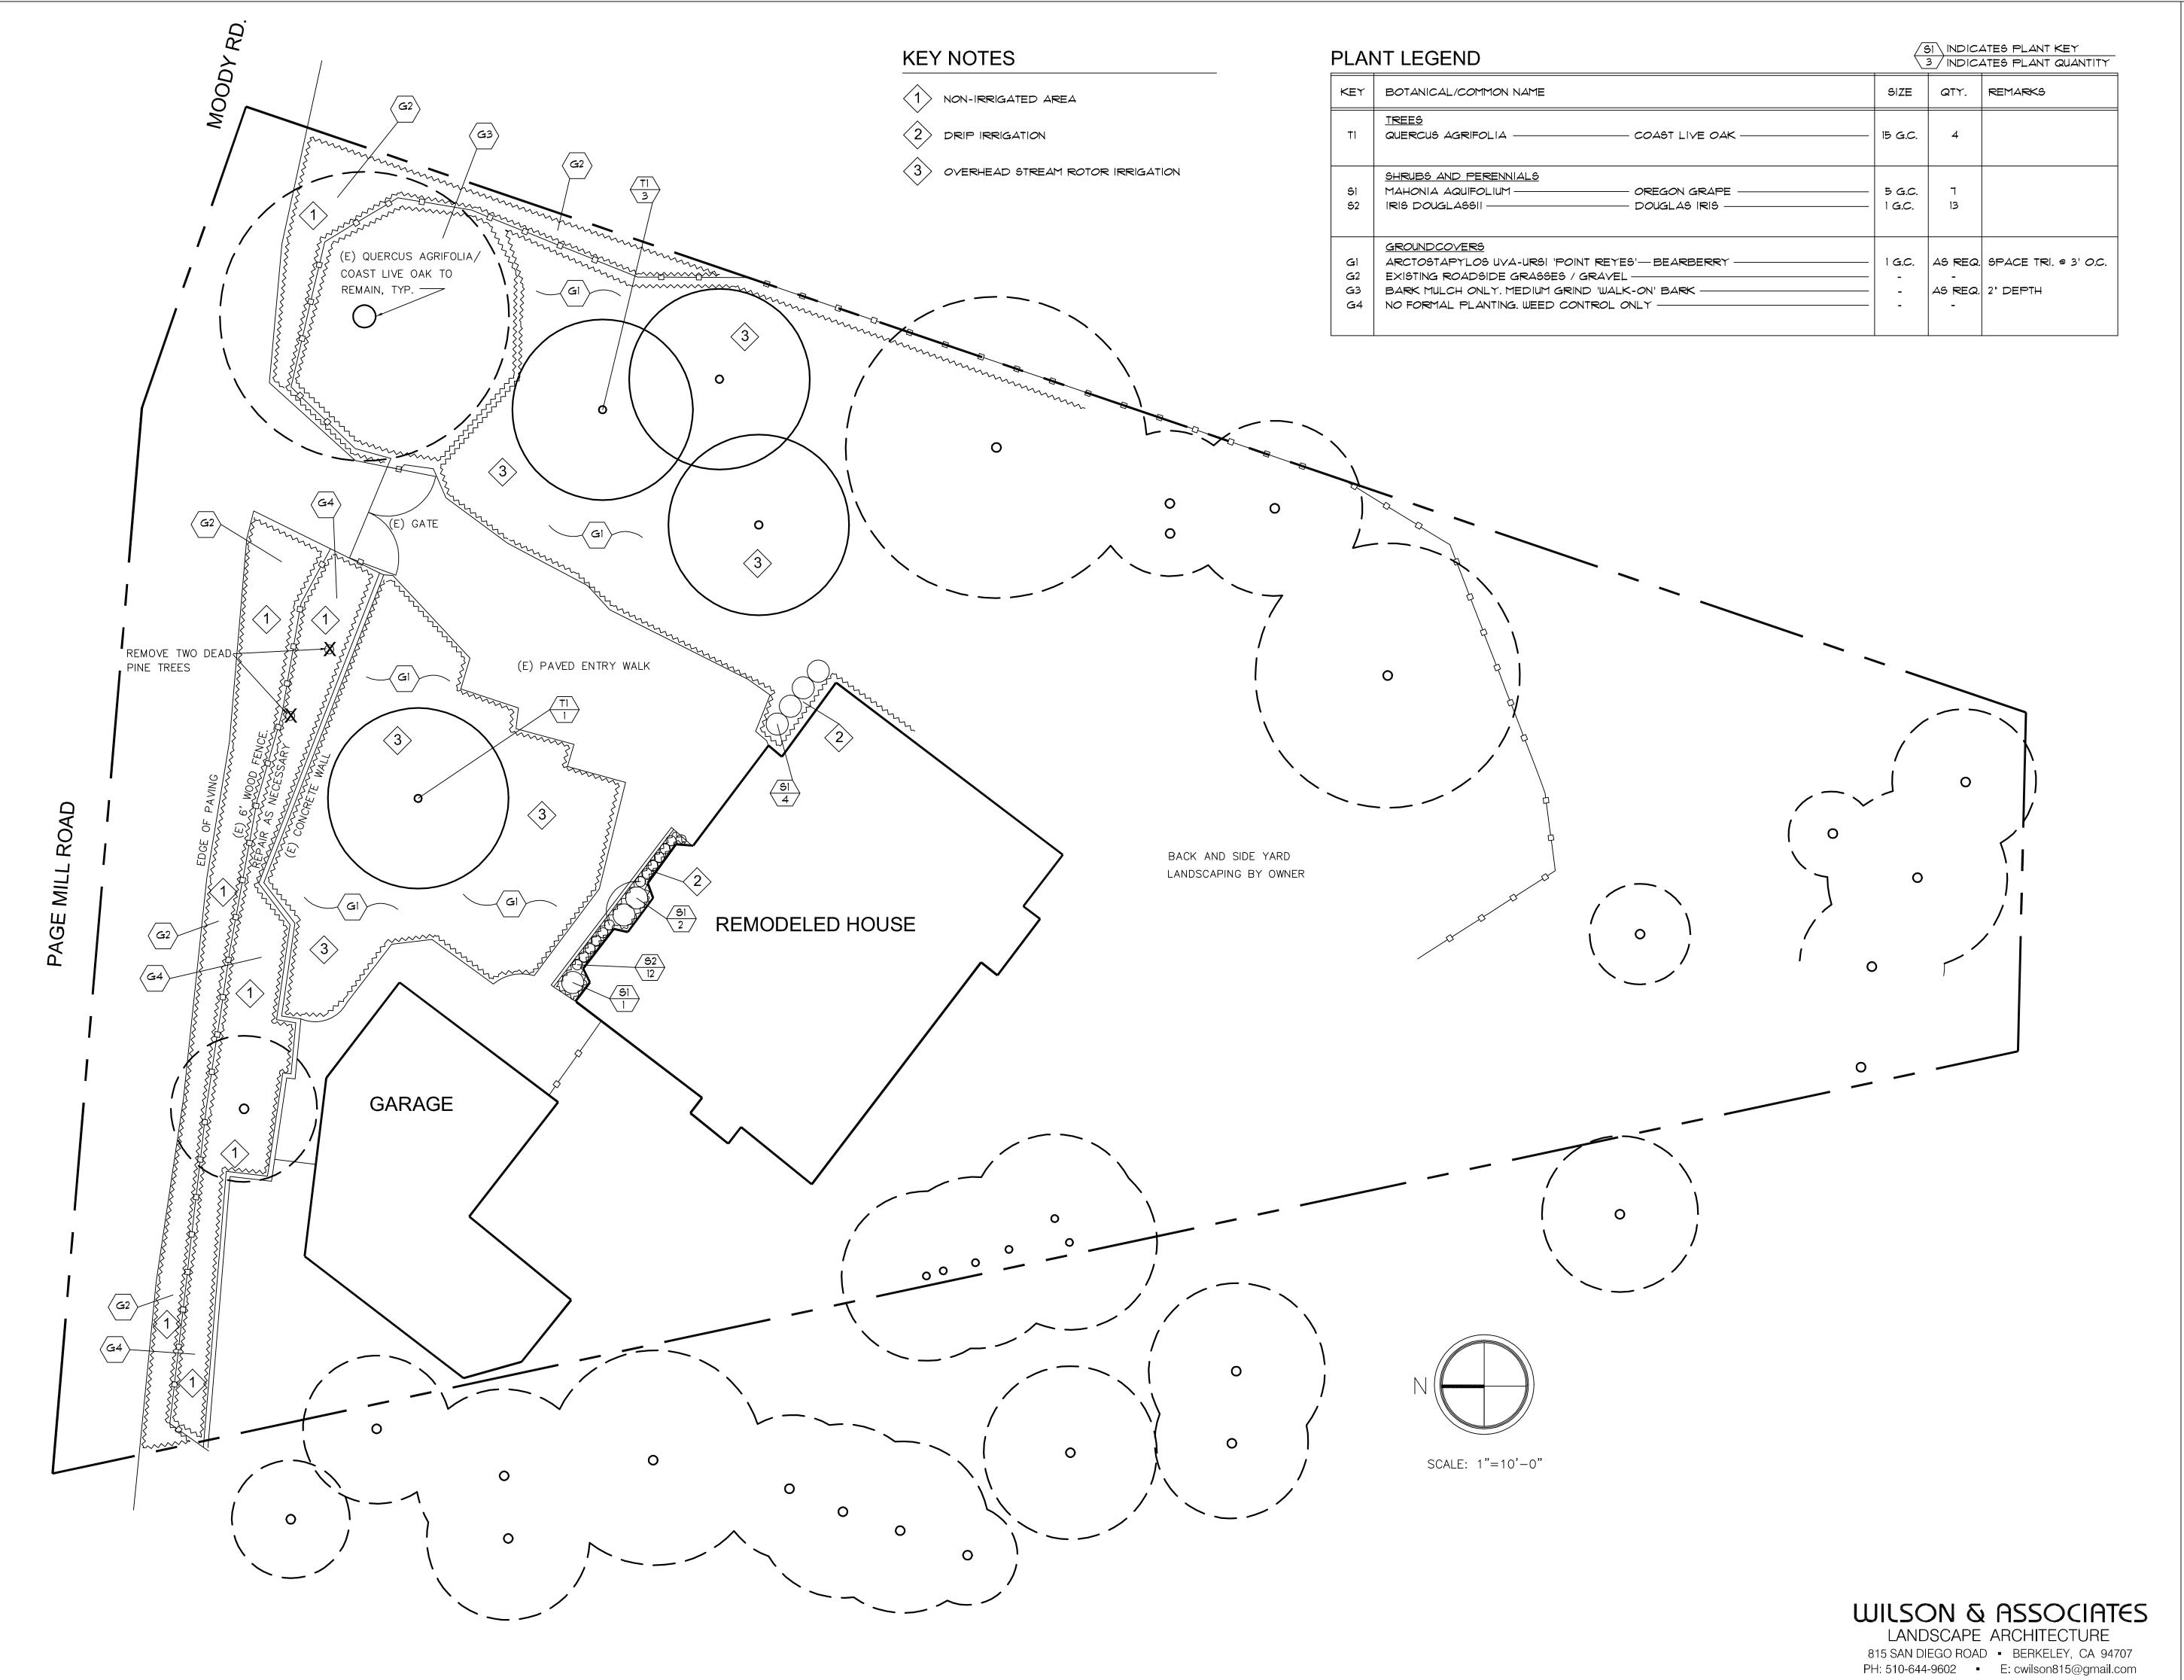LANDSCAPE PLAN

DATE: 01/12/2023

JOB NO.

SHEET NO.

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DRAWN BY: CW