ASA SUBMITTAL SET

# STANFORD UNIVERSITY TAUBE SOUTH COVERED TENNIS COURTS

PROJECT 5674

DRAWING STATUS SUBMITTAL DATE: APPROVAL DATE: ASA SUBMITTAL 03/01/2023

ASA SUBMITTAL
ASA COMPLIANCE RE-SUBMITTAL
PERMIT APPLICATION
CONSTRUCTION PERMIT

RECORD DRAWINGS

638 CAMPUS DRIVE

Stanford, California

# Proposed site

**VICINITY MAP** 

### DEFERRED SUBMITTALS

- 1. FIRE SPINKLERS
- 2. FIRE ALARM SYSTEM & FA CONTROL PANEL ALARMS SHALL HAVE VOICE ACTIVATION PER CBC 907.5.2.2.

### DRAWING INDEX

PL0.0 TITLE SHEET

PL1.2 GUP INFORMATION MAP

A1-0 COVERED TENNIS COURTS DEMO SITE PLAN
A1-1 COVERED TENNIS COURTS PROPOSED SITE PLAN
A1-2 COVERED TENNIS COURTS PROPOSED PLAN & RCP
A3-1 COVERED TENNIS COURTS CONTEXT ELEVATIONS
A3-2 COVERED TENNIS COURTS ELEVATIONS
A3-3 COVERED TENNIS COURTS ELEVATIONS
A3-4 COVERED TENNIS COURTS BUILDING ELEVATIONS
A3-5 COVERED TENNIS COURTS BUILDING ELEVATIONS
A3-6 COVERED TENNIS COURTS SECTIONS

A4-1 COVERED TENNIS COURTS RENDERINGS
A4-2 COVERED TENNIS COURTS RENDERINGS

C-1.0 COVER SHEET

C-1.1 COUNTY CONSTRUCTION NOTES

C-1.2 FIRE SAFETY NOTES

C-2.0 TOPOGRAPHIC SURVEY

C-3.0 DEMOLITION/TREE REMOVAL PLAN

C-3.1 DEMOLITION/TREE REMOVAL NOTES

C-4.0 GRADING AND DRAINAGE PLAN

-5.0 UTILITY PLAN

C-6.0 STORMWATER MANAGEMENT PLAN

C-7.0 EROSION CONTROL PLAN C-7.1 COUNTY BMP NOTES

C-7.2 COUNTY BMP NOTES

C-8.0 CONSTRUCTION SITE LOGISTICS/

SAFETY PLAN

C-9.0 FIRE ACCESS PLAN

L-1.01 LANDSCAPE PLAN

### SITE DATA INFORMATION

### **GENERAL**

APN: 142-04-036 PARCEL SIZE: 580.15 AC

DEVELOPMENT DISTRICT: DAPER AND ADMINISTRATIVE

BUILDING/QUAD: 08-025

LAND USE DESIGNATION: ACADEMIC CAMPUS

SITE AREA: 49,063 SF

### PERCENTAGE OF SITE AREA:

LANDSCAPE: 2 % CONCRETE PAVING: 98 %

### **CBC BUILDING TYPE:**

II-B

NUMBER OF NET

NEW PARKING SPACES:

ESTIMATED CUT AND FILL:

CUT: 0 CUBIC YARDS FILL: 0 CUBIC YARDS

NONE

### PROJECT DESCRIPTION:

CONSTRUCTION OF NEW COVERING OVER EXISTING TENNIS COURTS AND ASSOCIATED SITE IMPROVEMENTS.

PROJECT MANAGER:
Mark Bonino
340 Bonair Siding Road
Stanford, CA 94304
mbonino@stanford.edu

'I' MANAGEMENT

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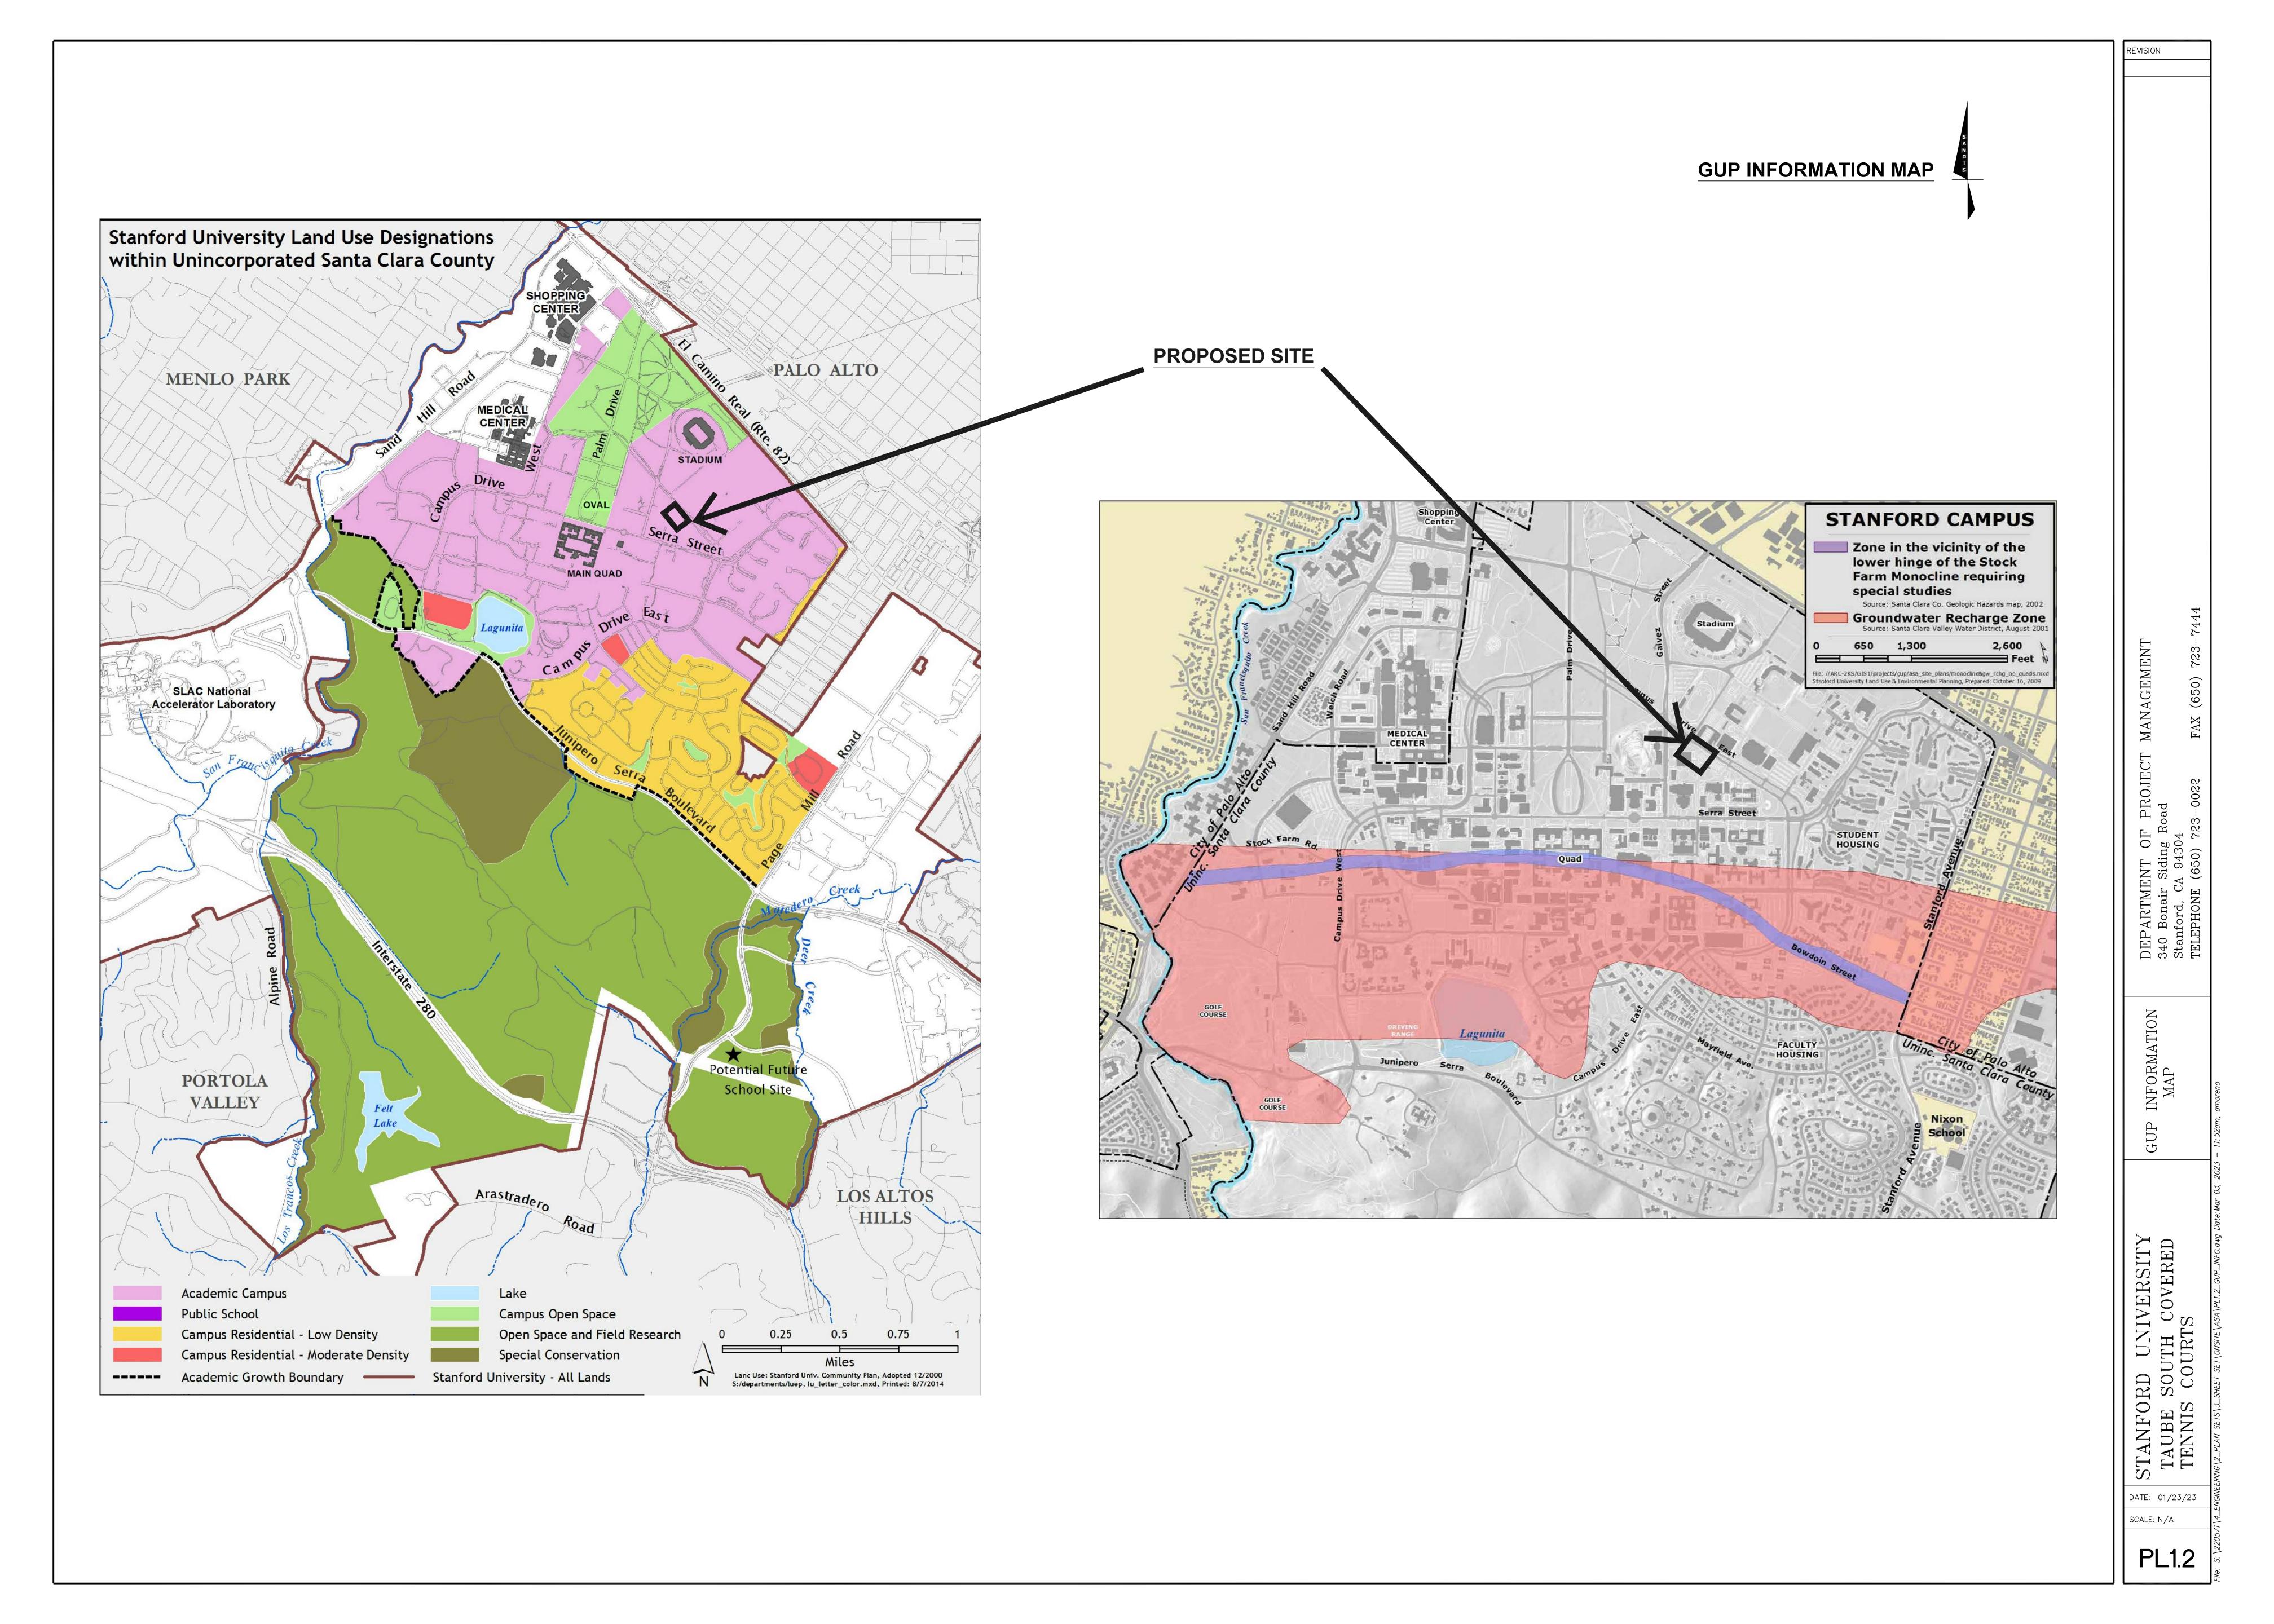
CE SHEET


STANFORD UNIVERSITY TAUBE SOUTH COVERED TENNIS COURTS

DATE: 01-23-23

SCALE: N/A

PL0.0



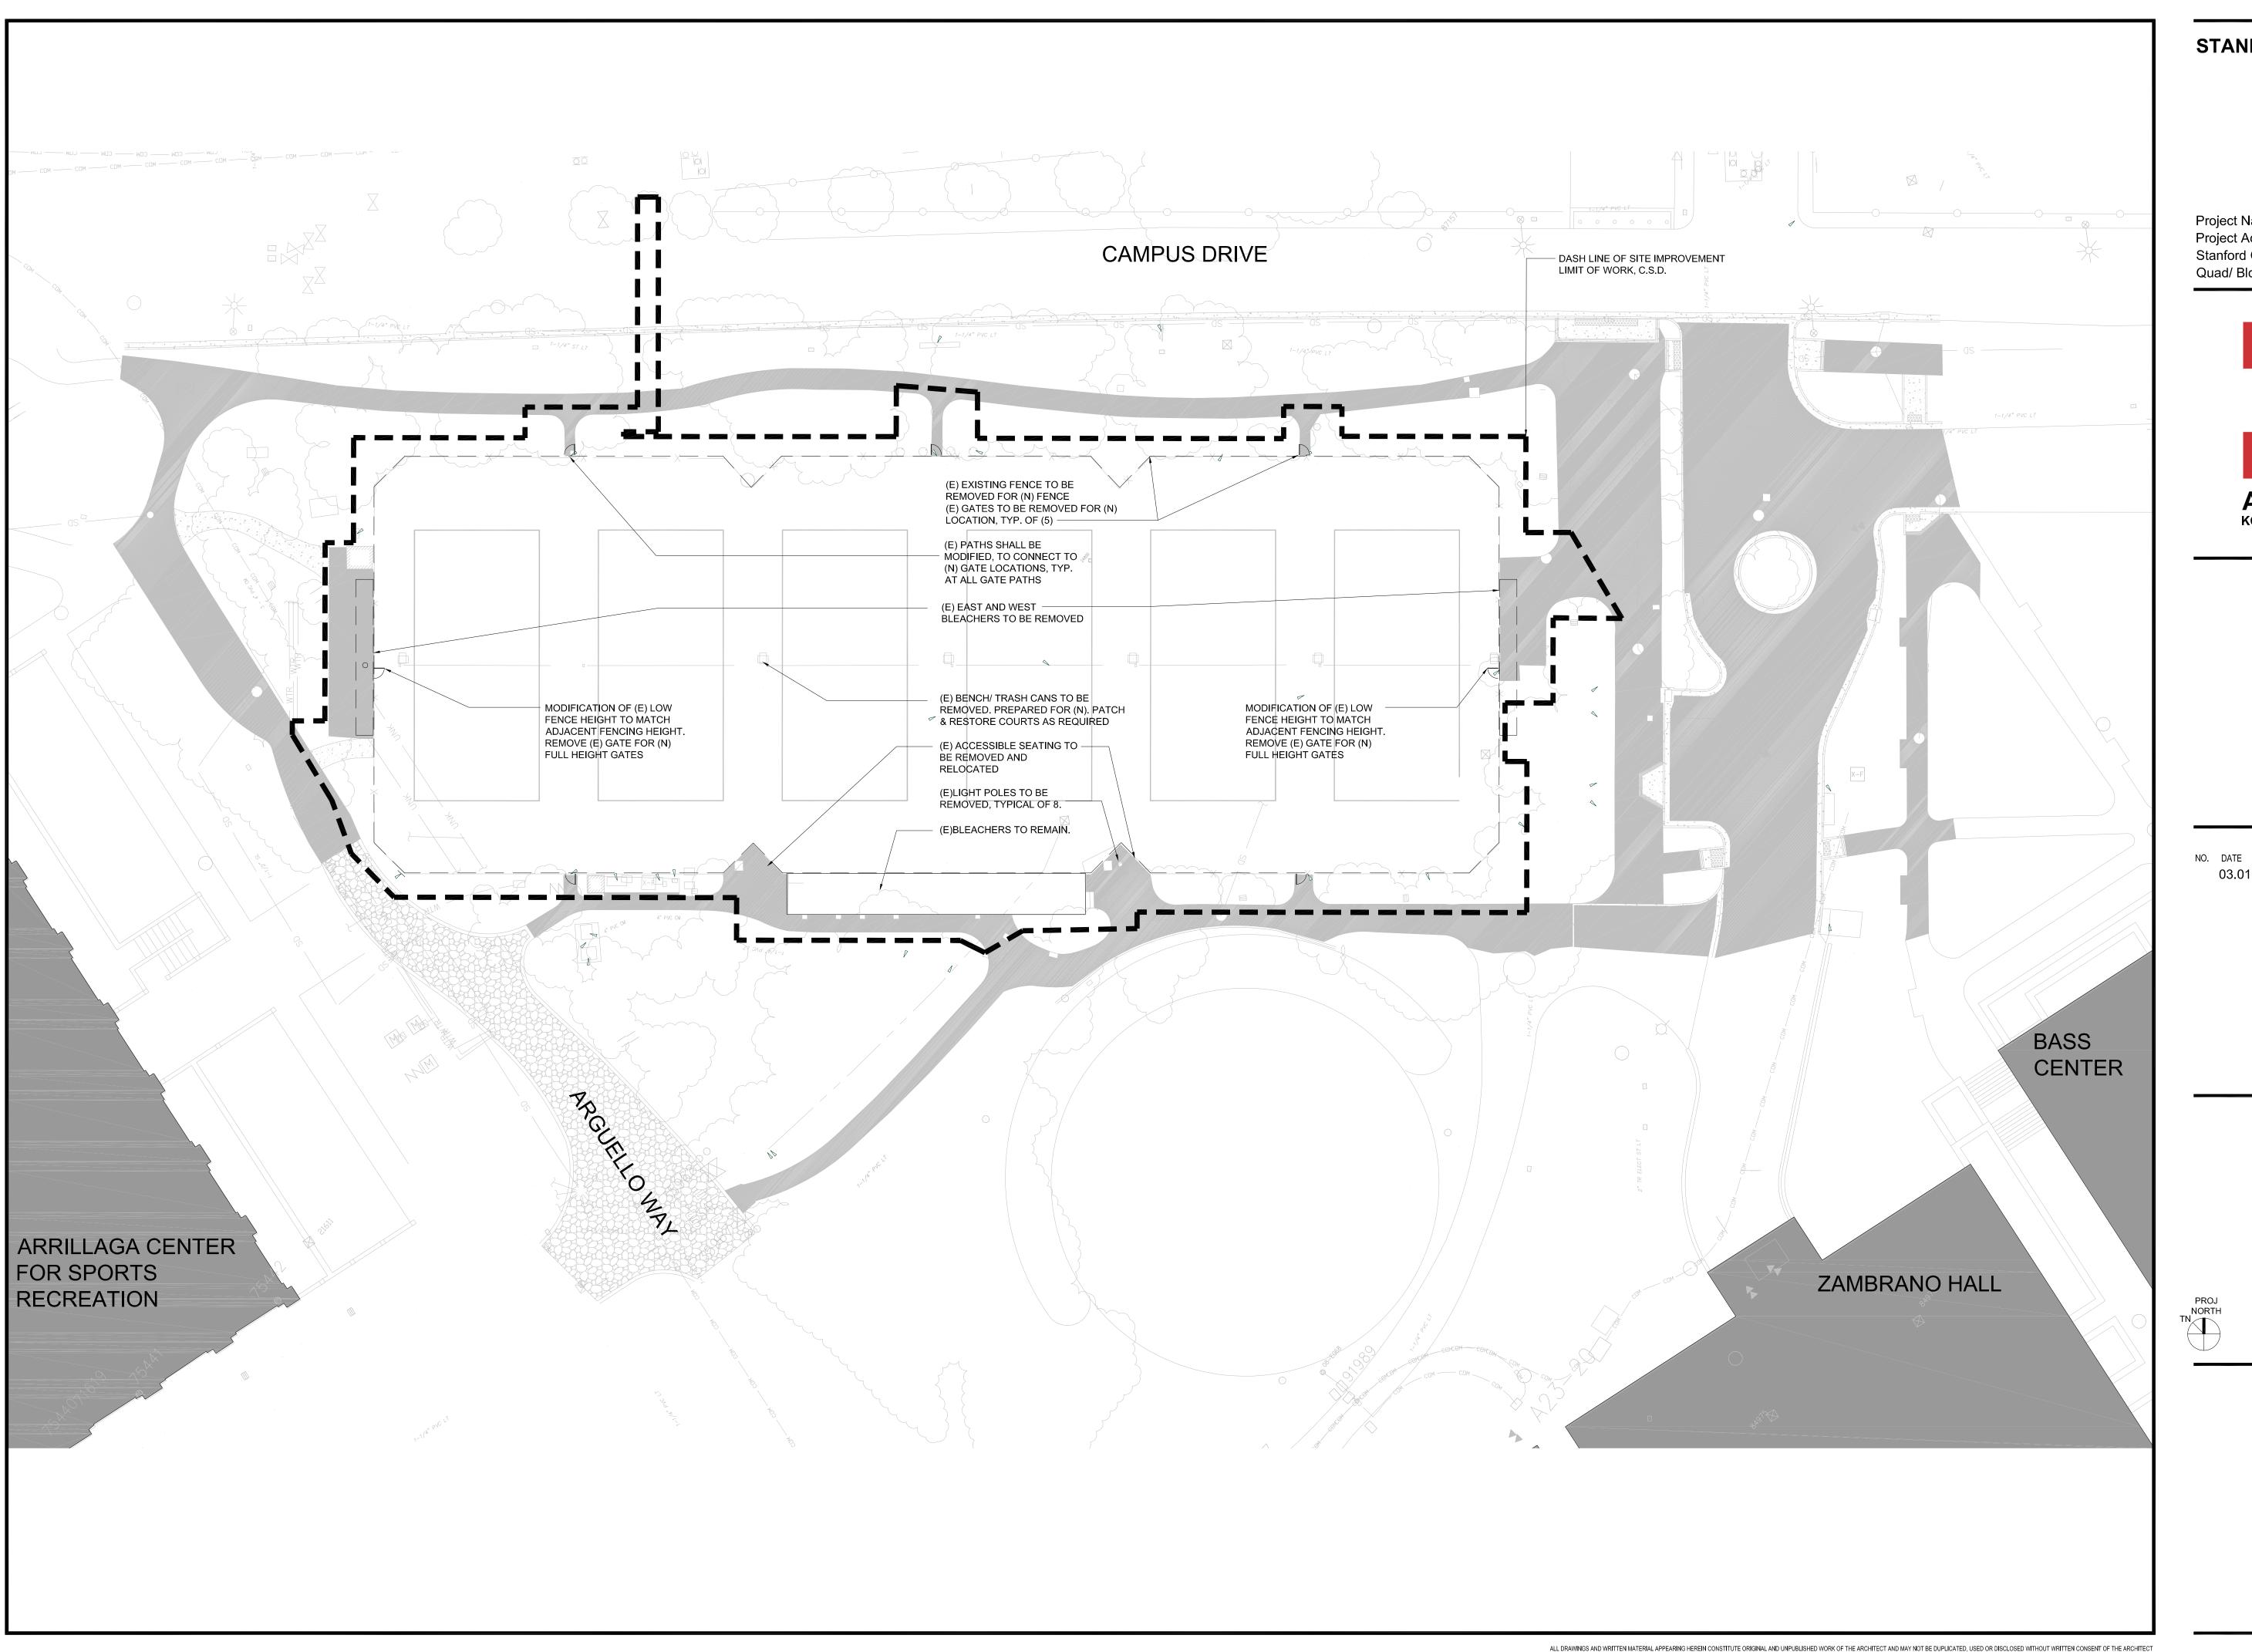

Project Name: Covered Tennis Courts Project Address: 638 Campus Drive, Stanford CA. 94305 Quad/ Bldg. Number: 08-025



ISSUES AND REVISIONS

DESCRIPTION 03.01.2023 ASA SET

SHEET TITLE


COVERED TENNIS COURTS DEMO SITE PLAN


SCALE

1/32" = 1'-0"

SHEET NUMBER

ALL DRAWINGS AND WRITTEN MATERIAL APPEARING HEREIN CONSTITUTE ORIGINAL AND UNPUBLISHED WORK OF THE ARCHITECT AND MAY NOT BE DUPLICATED, USED OR DISCLOSED WITHOUT WRITTEN CONSENT OF THE ARCHITECT

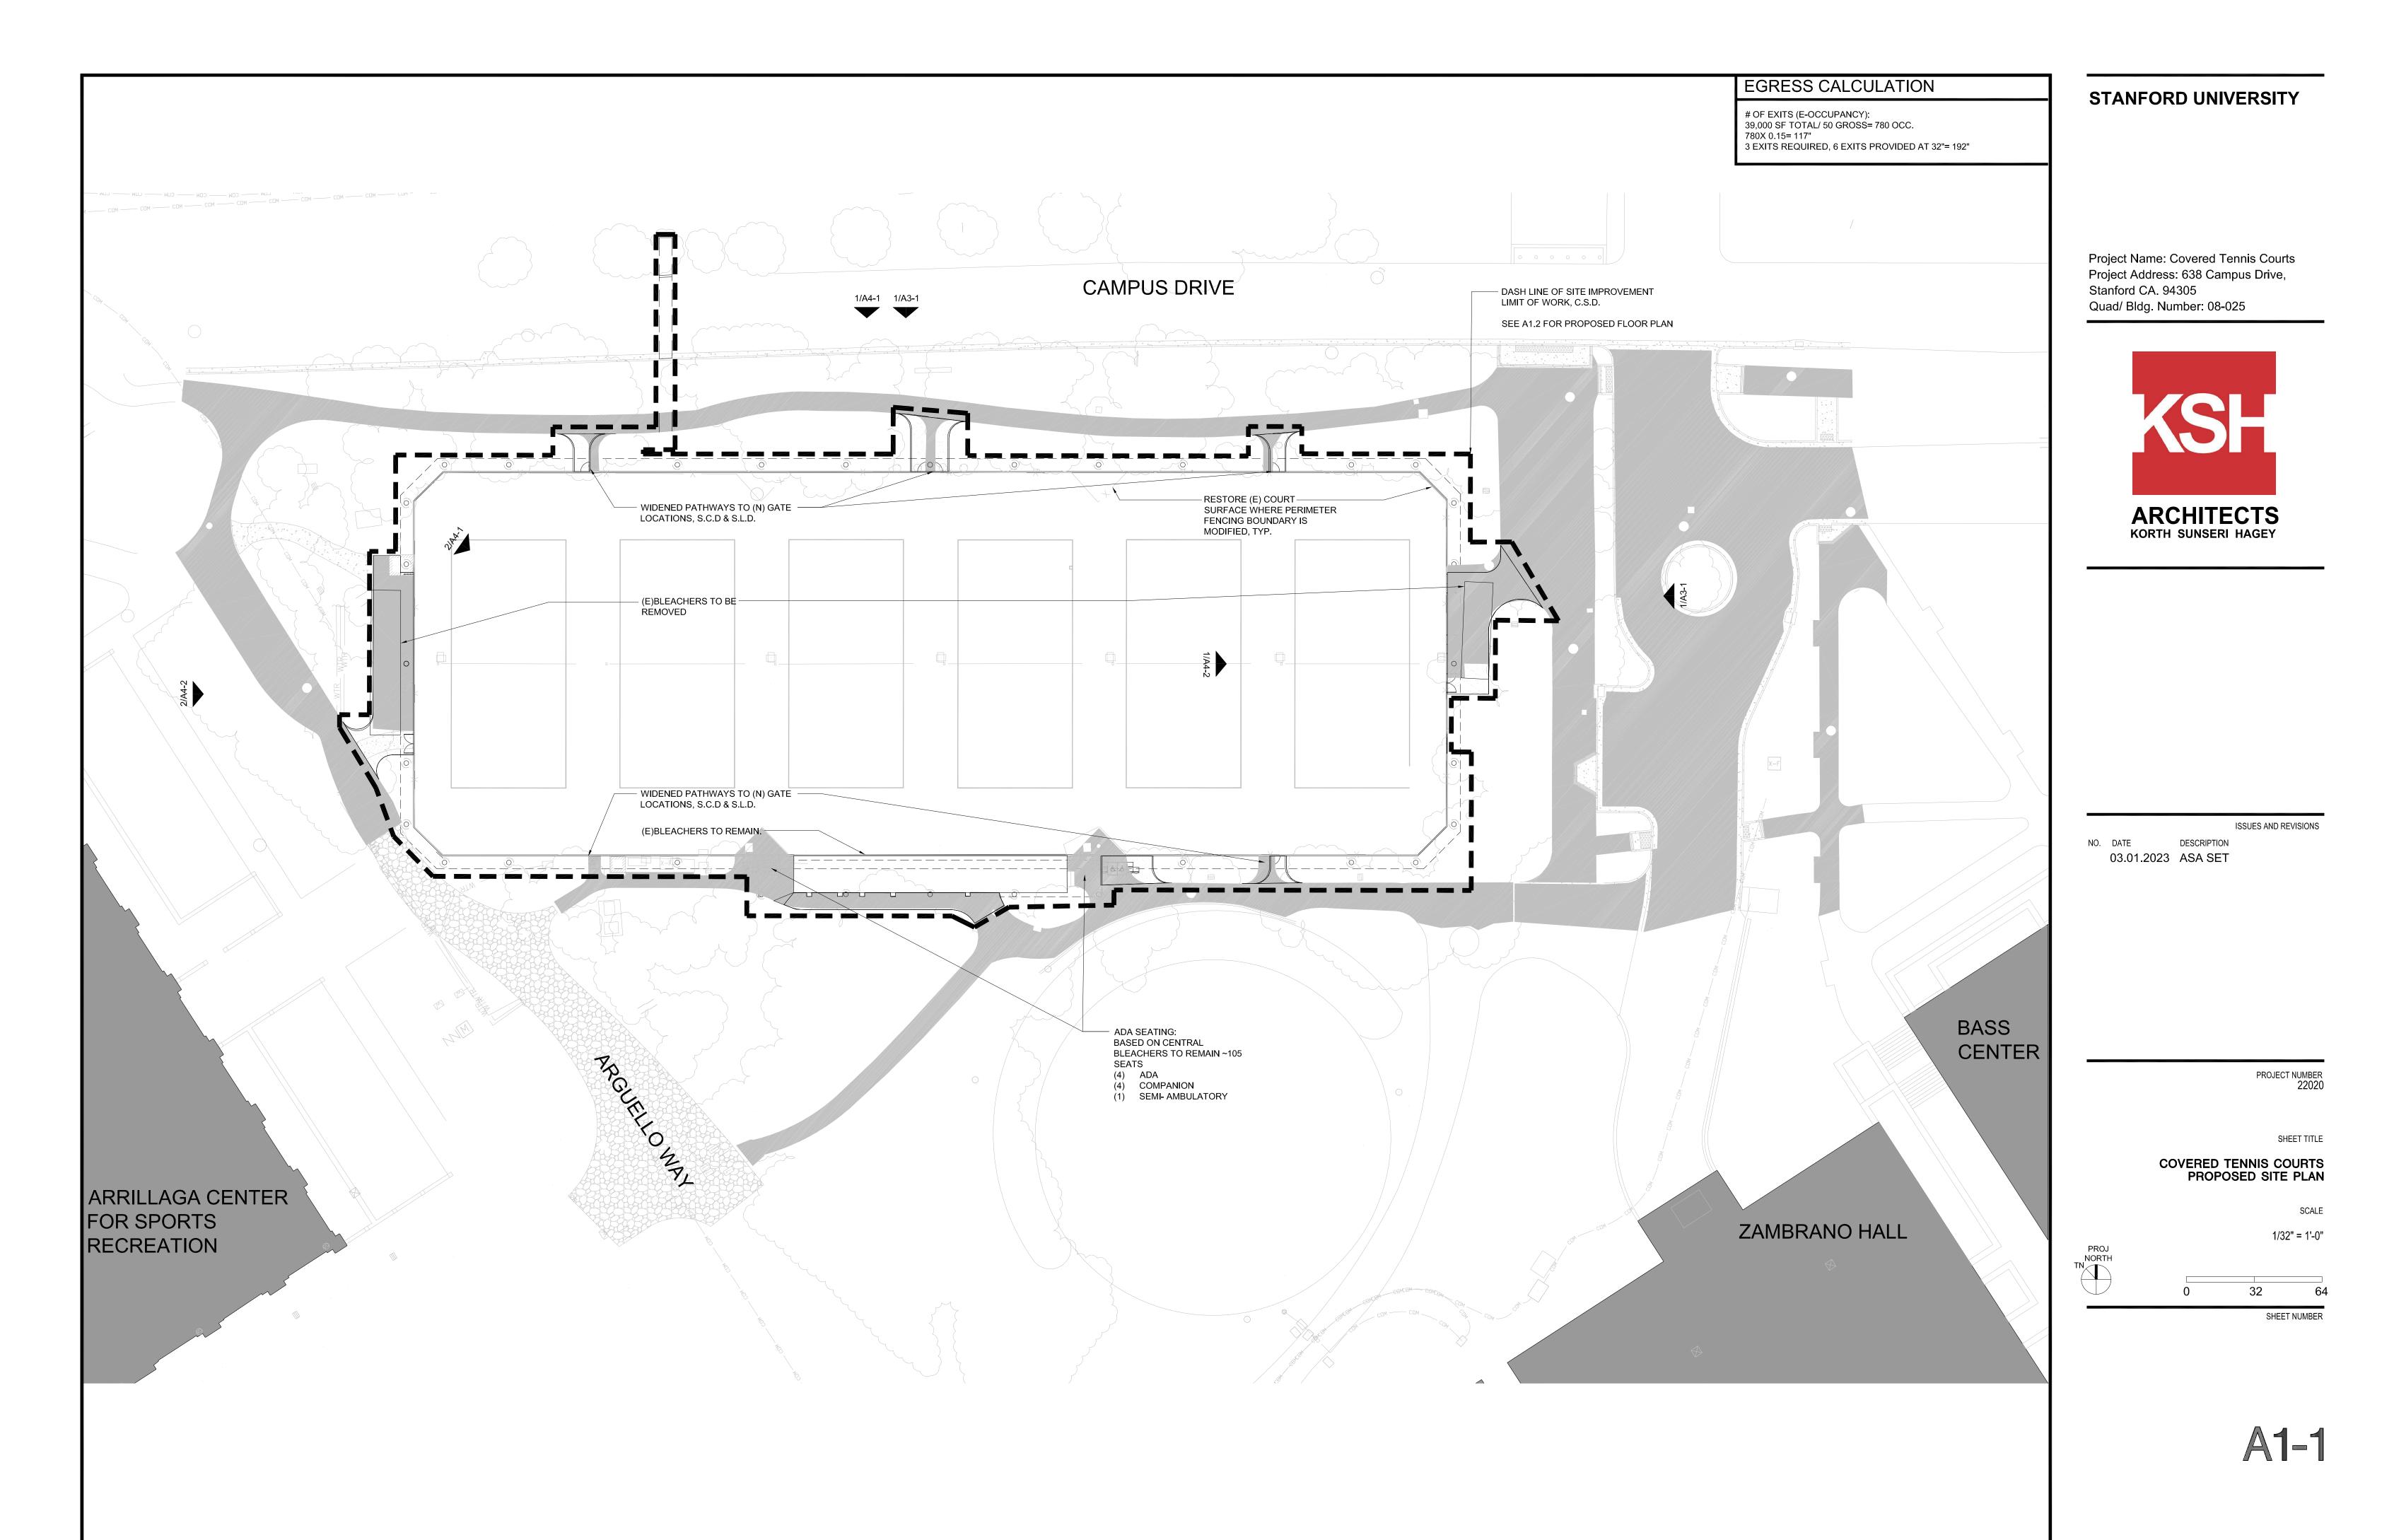

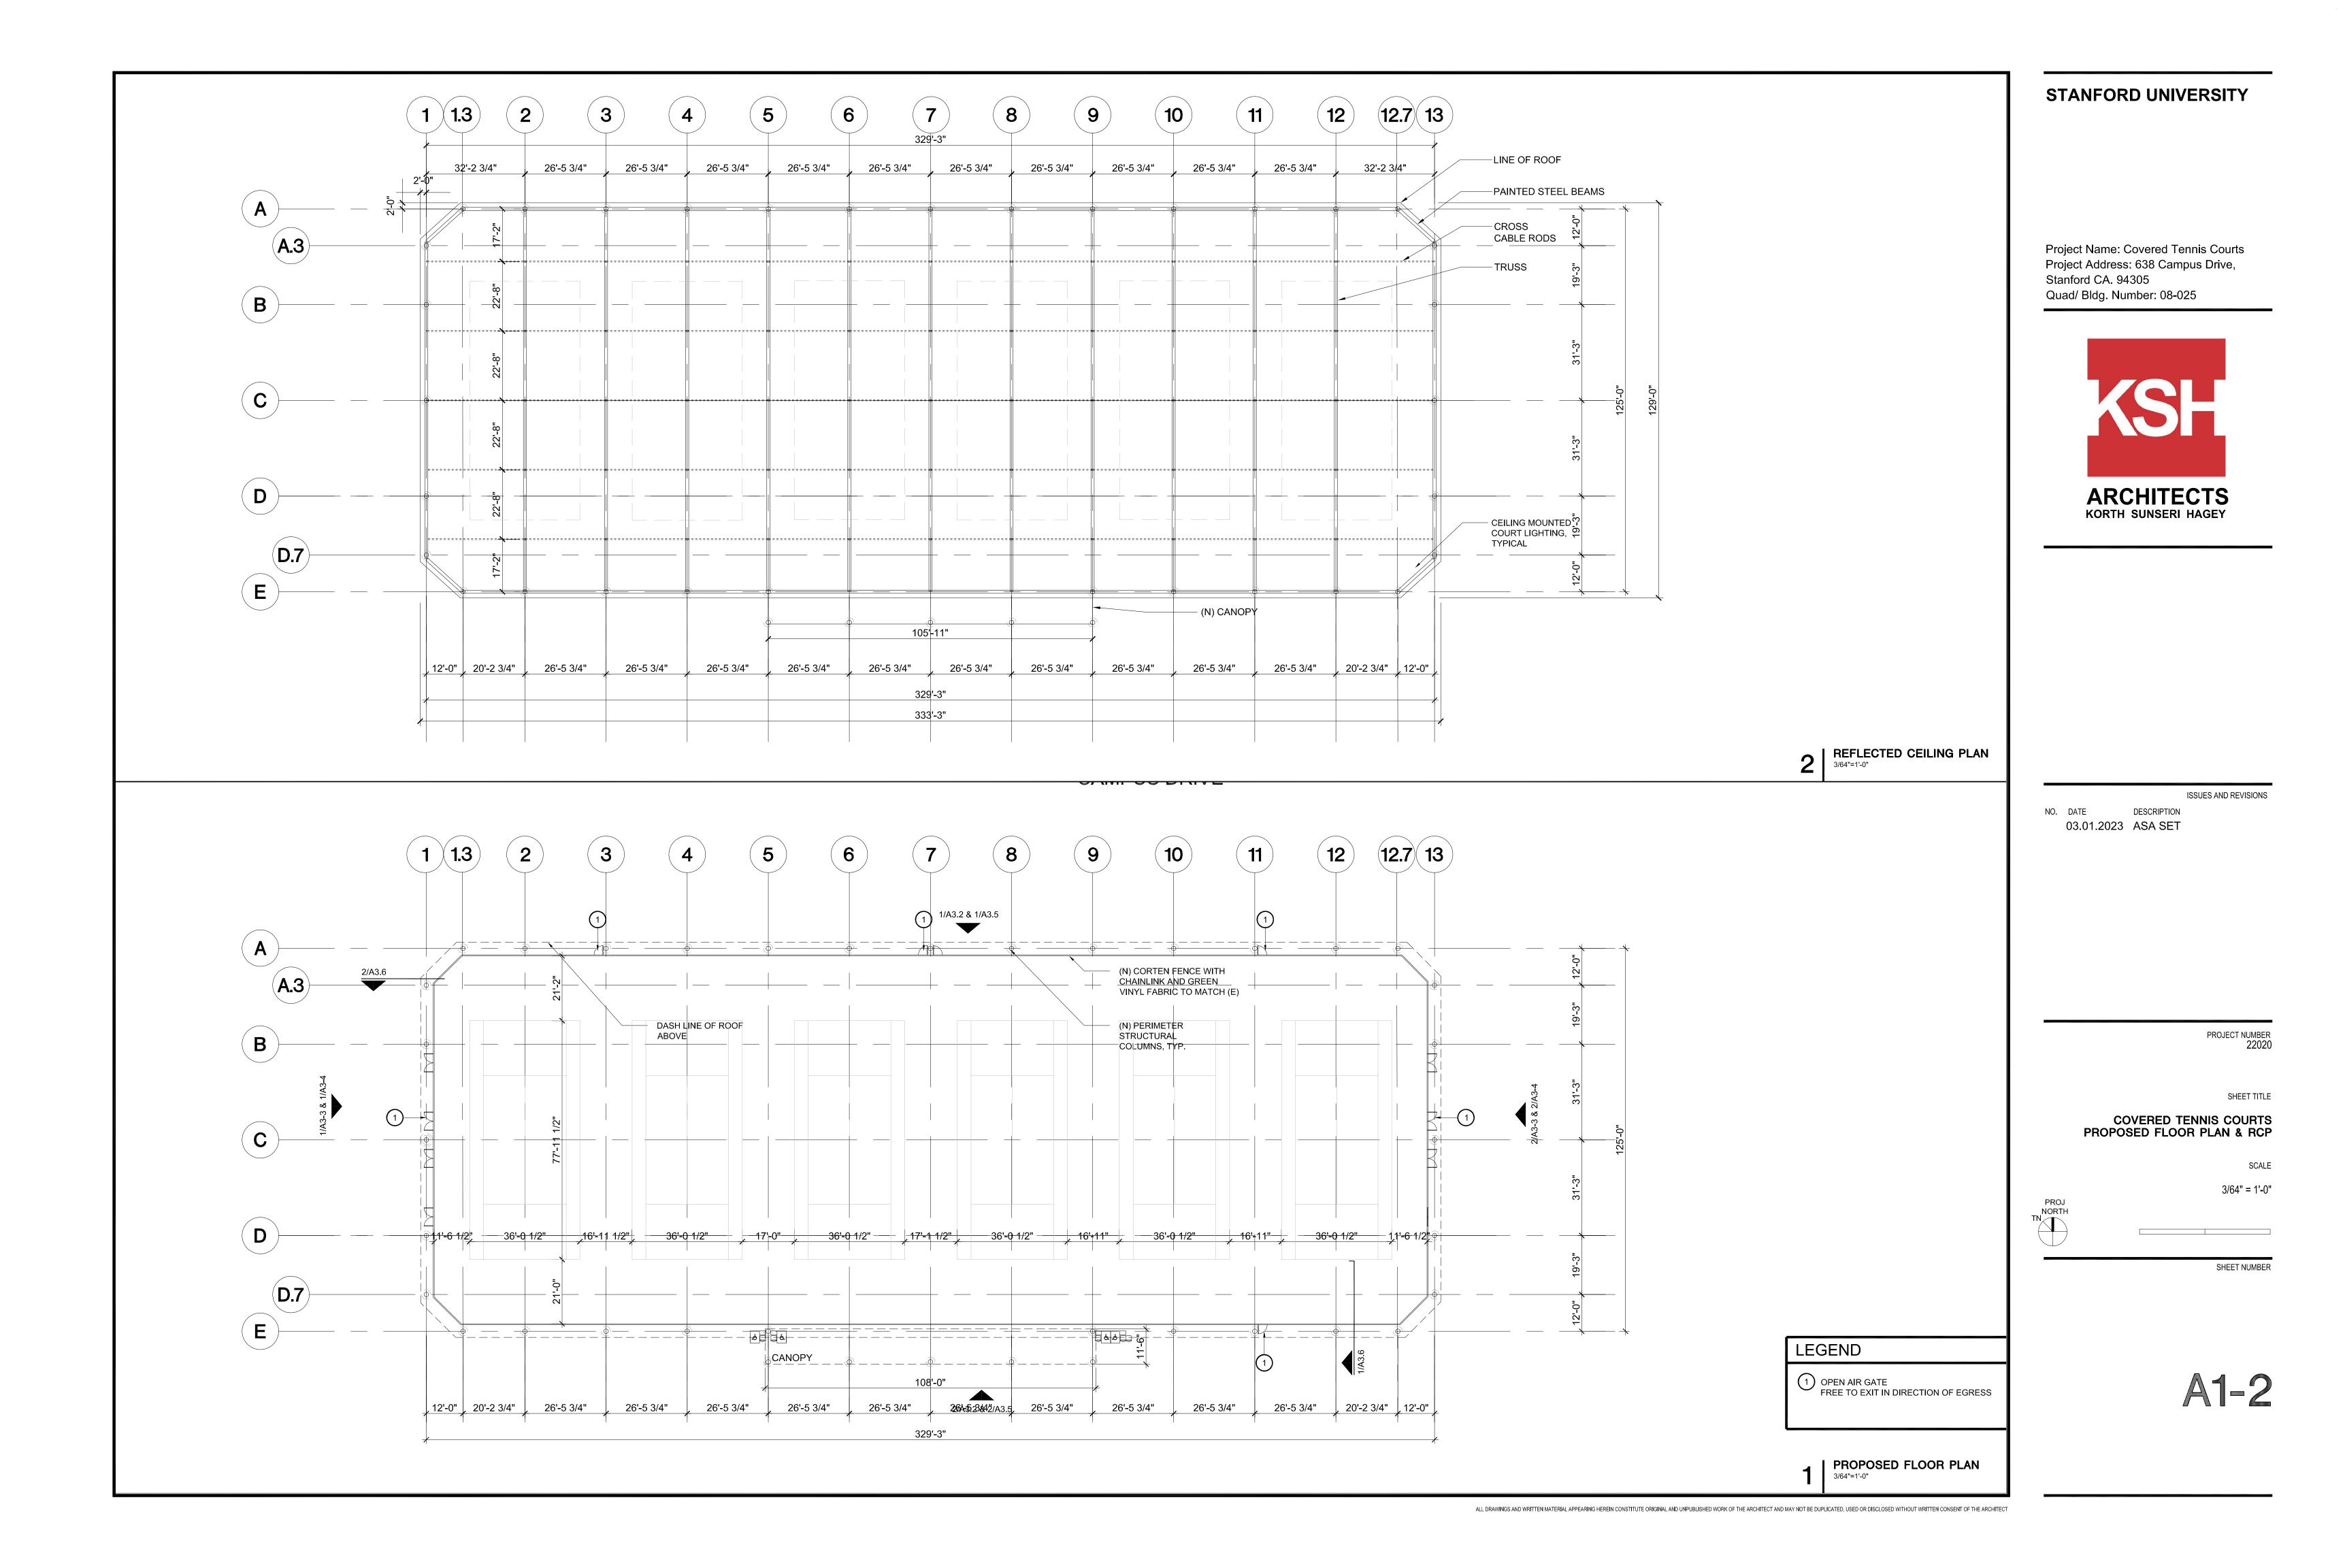

Project Name: Covered Tennis Courts Project Address: 638 Campus Drive, Stanford CA. 94305 Quad/ Bldg. Number: 08-025





ISSUES AND REVISIONS

03.01.2023 ASA SET

PROJECT NUMB 220

SHEET TITLE

COVERED TENNIS COURTS
CONTEXT ELEVATIONS

SCALE

PROJ NORTH TN

SHEET NUMBER

A 2\_1

2 CONTEXT ELEVATION (CAMPUS DRIVE)



CONTEXT ELEVATION (KNIGHT MANAGEMENT CENTER)

1/32"=1'-0"

# — PAINTED ROUND COLUMNS, 18"-20" +/-PAINTED ROUND COLUMNS, 18"-20" +/-MUSCO SPORTS LIGHTING, TLC-LED-1200 PAINTED WIDE FLANGE BEAMS (E) CONCRETE SPECTATOR SEATING STRUCTURAL HSS MEMBER MESH SCREEN, SHADE OF BROWN EL. 44'-0" T.O. PARAPET EL. 10'-0" T.O. FENCE TYPICAL EL. 0'-0" FINISH FLOOR



Project Name: Covered Tennis Courts Project Address: 638 Campus Drive, Stanford CA. 94305 Quad/ Bldg. Number: 08-025



SOUTH ELEVATION (VIEW FROM ARRILLAGA HALL)
1/16"=1'-0"

ROOFING OVER STRUCTURAL DECKING

SHEET TITLE COVERED TENNIS COURTS ELEVATIONS

PROJ NORTH TN

03.01.2023 ASA SET

SHEET NUMBER

ISSUES AND REVISIONS



MESH SCREEN, SHADE OF BROWN

- STRUCTURAL HSS MEMBER PAINTED WIDE FLANGE BEAMS

Project Name: Covered Tennis Courts Project Address: 638 Campus Drive, Stanford CA. 94305 Quad/ Bldg. Number: 08-025



# PAINTED ROUND COLUMNS, 19°-20° DA STEUCTURAL HAS MEMBERS STRUCTURAL HAS MEMBERS FAINTED WIS FLANGE BEAMS 12° DEEP PAINTED STEEL CANOPY T.O. PARAPET ■ EL 10-0° T.O. PARA

2 | WEST ELEVATION (VIEW FROM ARRILAGA CENTER FOR SPORTS AND RECREATION)

DATE DESCRIPTION D3.01.2023 ASA SET

PROJECT NUMBER

SHEET TITLE

COVERED TENNIS COURTS ELEVATIONS

SCALE
AS NOTED

PROJ NORTH TN


SHEET NUMBER

A 2\_ 2



EAST ELEVATION (VIEW FROM KNIGHT MANAGEMENT CENTER)

1/16"=1'-0"

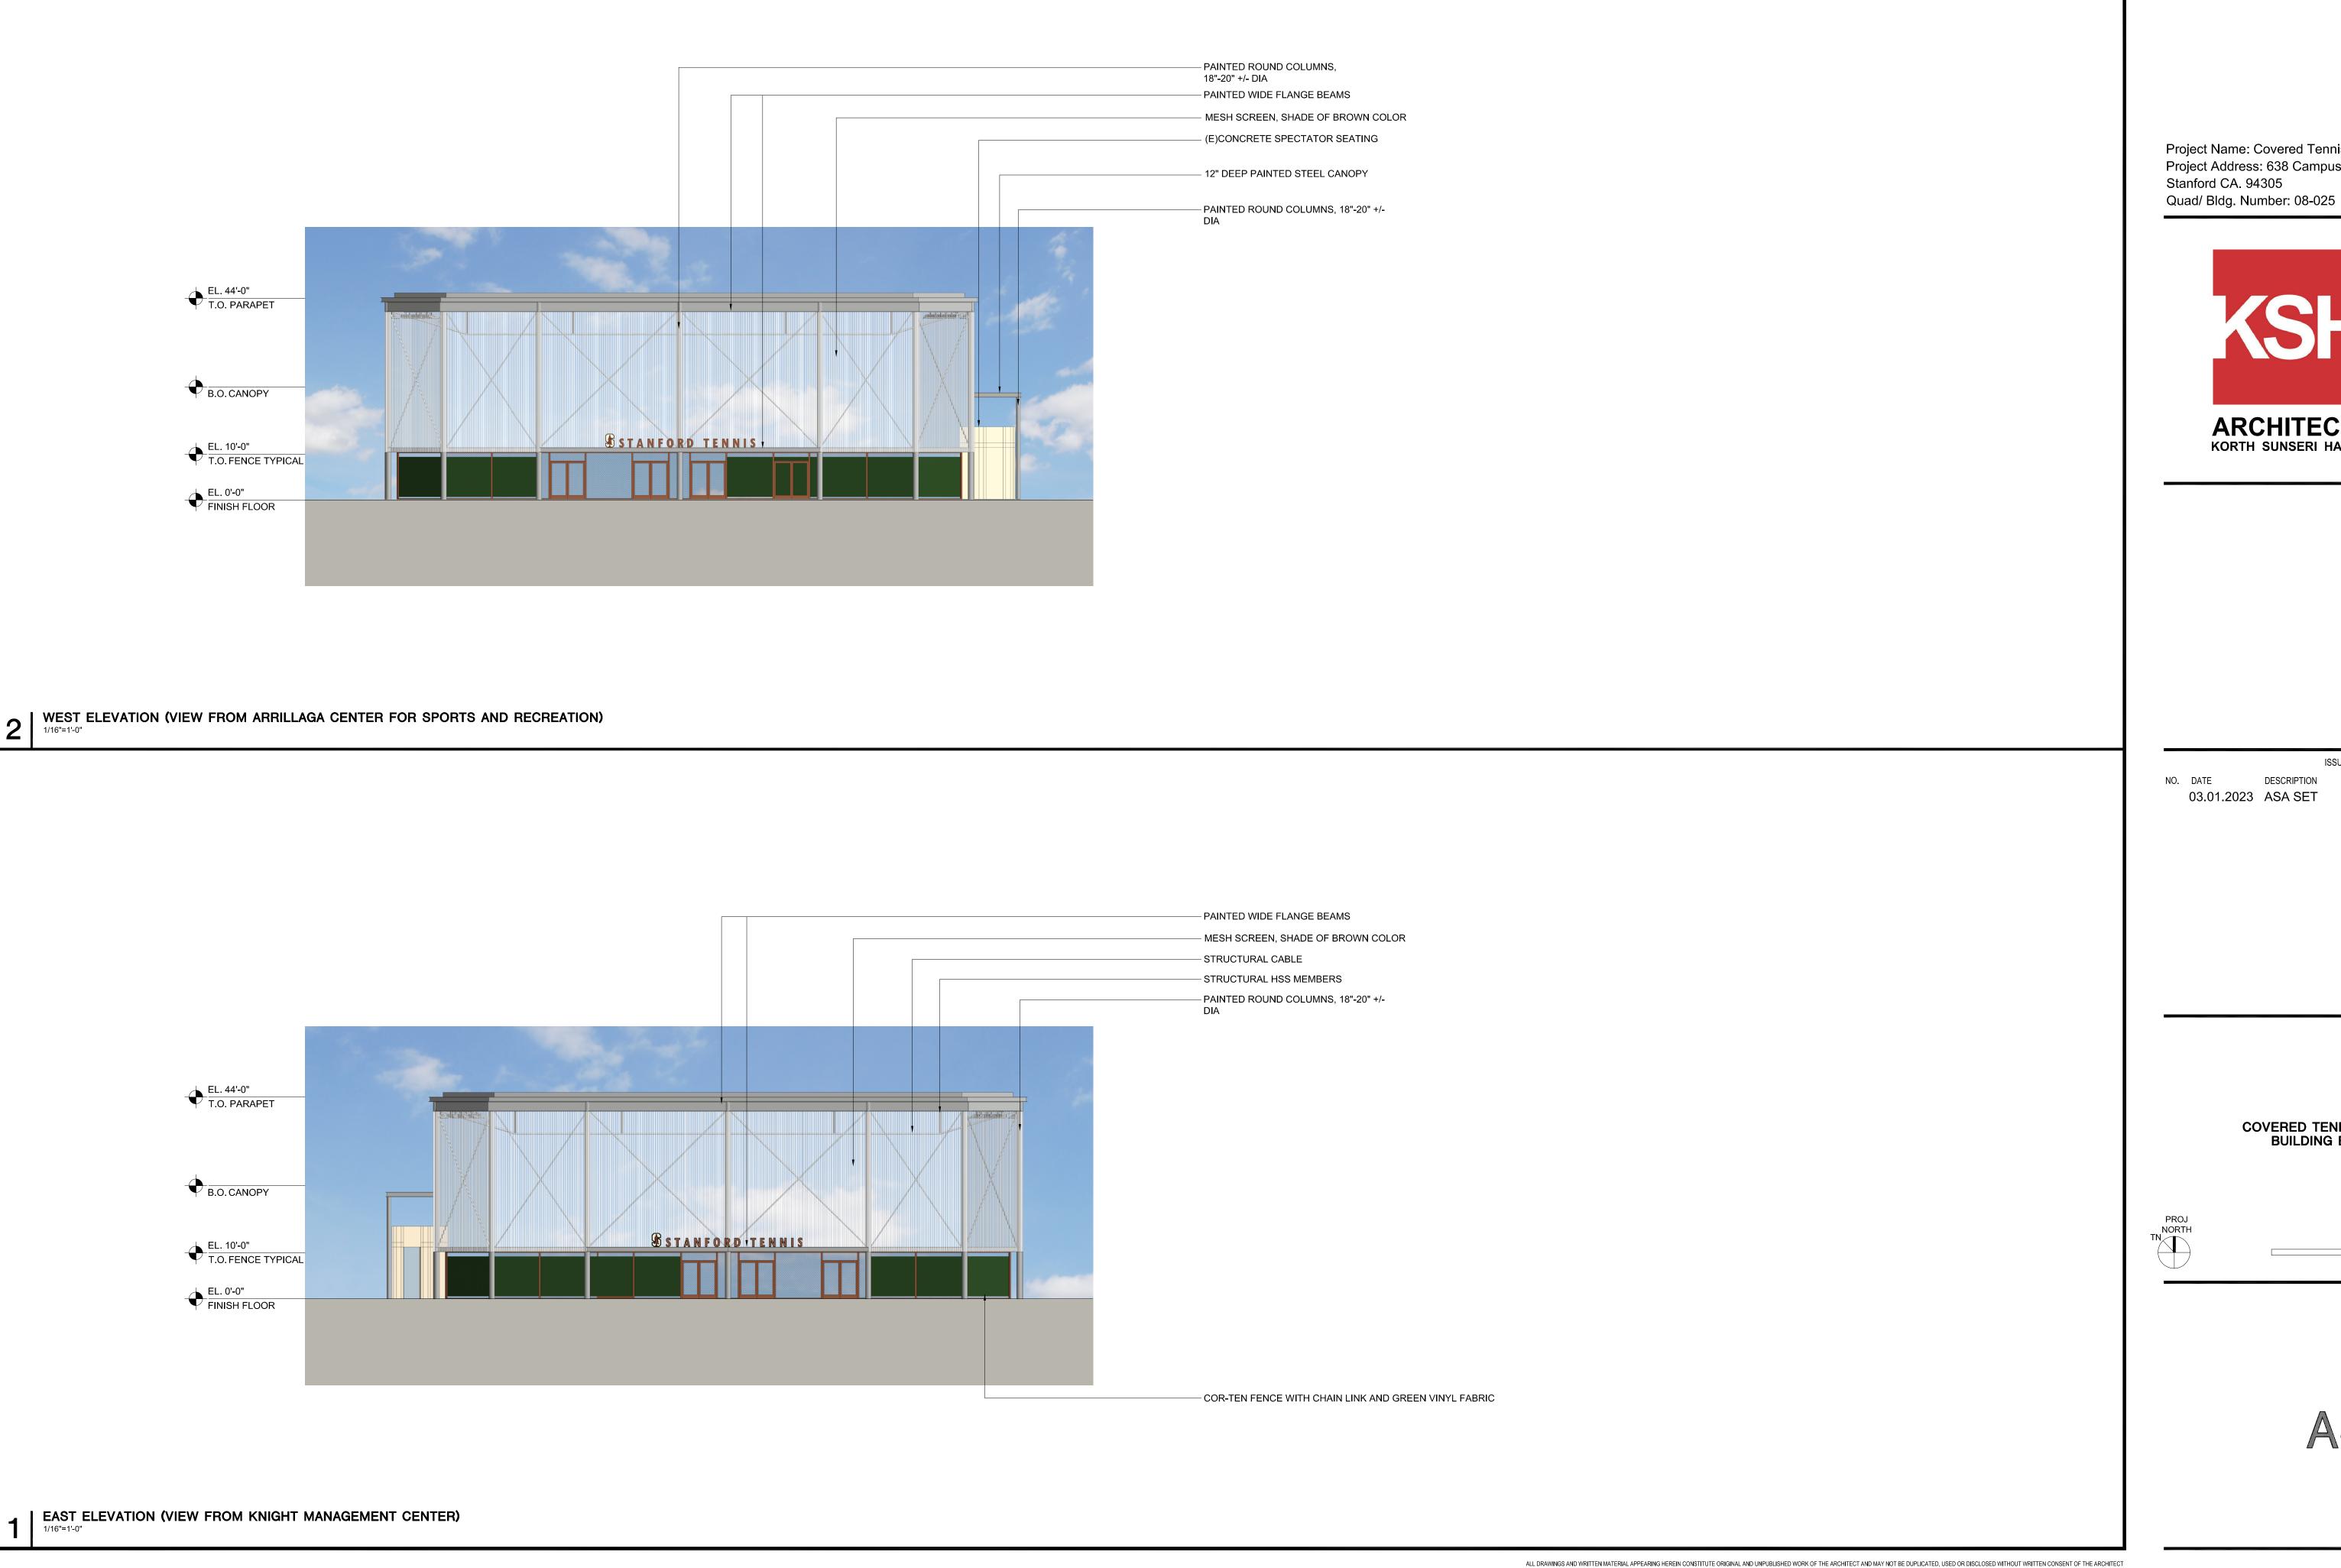

Project Name: Covered Tennis Courts Project Address: 638 Campus Drive,



ISSUES AND REVISIONS

DESCRIPTION

03.01.2023 ASA SET

PROJECT NUMBER 22020


SHEET TITLE

COVERED TENNIS COURTS
BUILDING ELEVATIONS

SCALE


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SHEET NUMBER

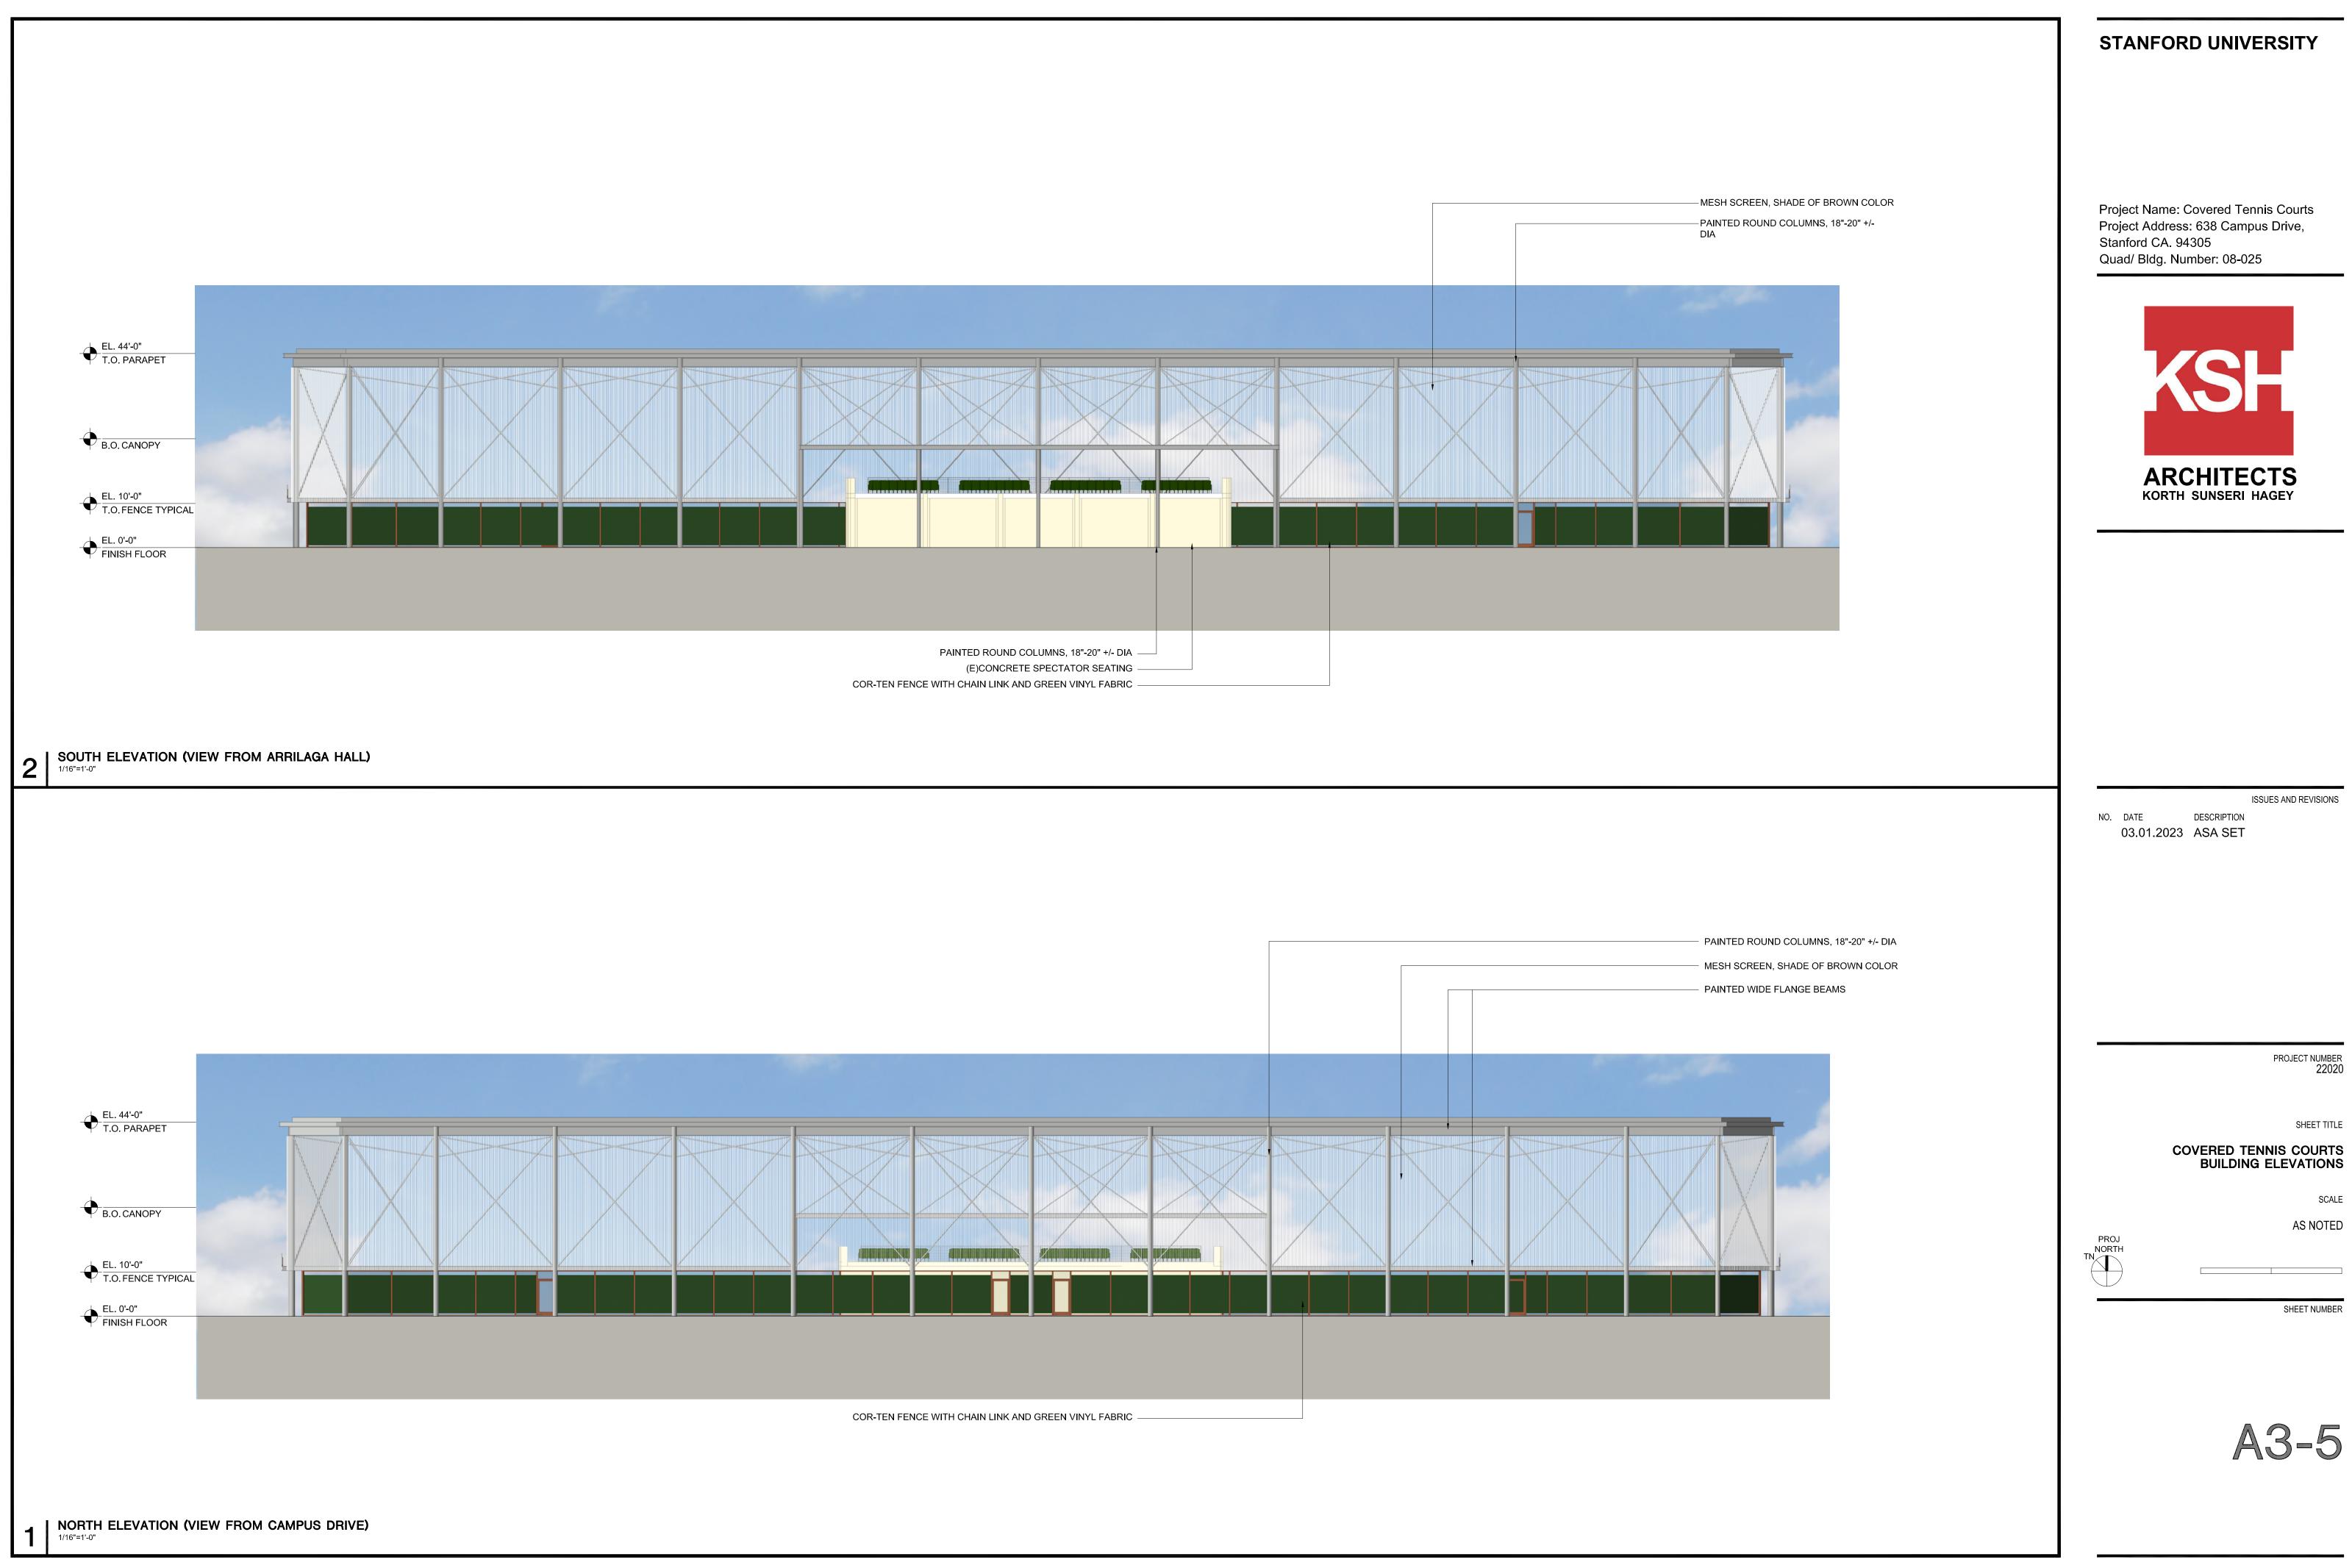

ISSUES AND REVISIONS

SHEET TITLE



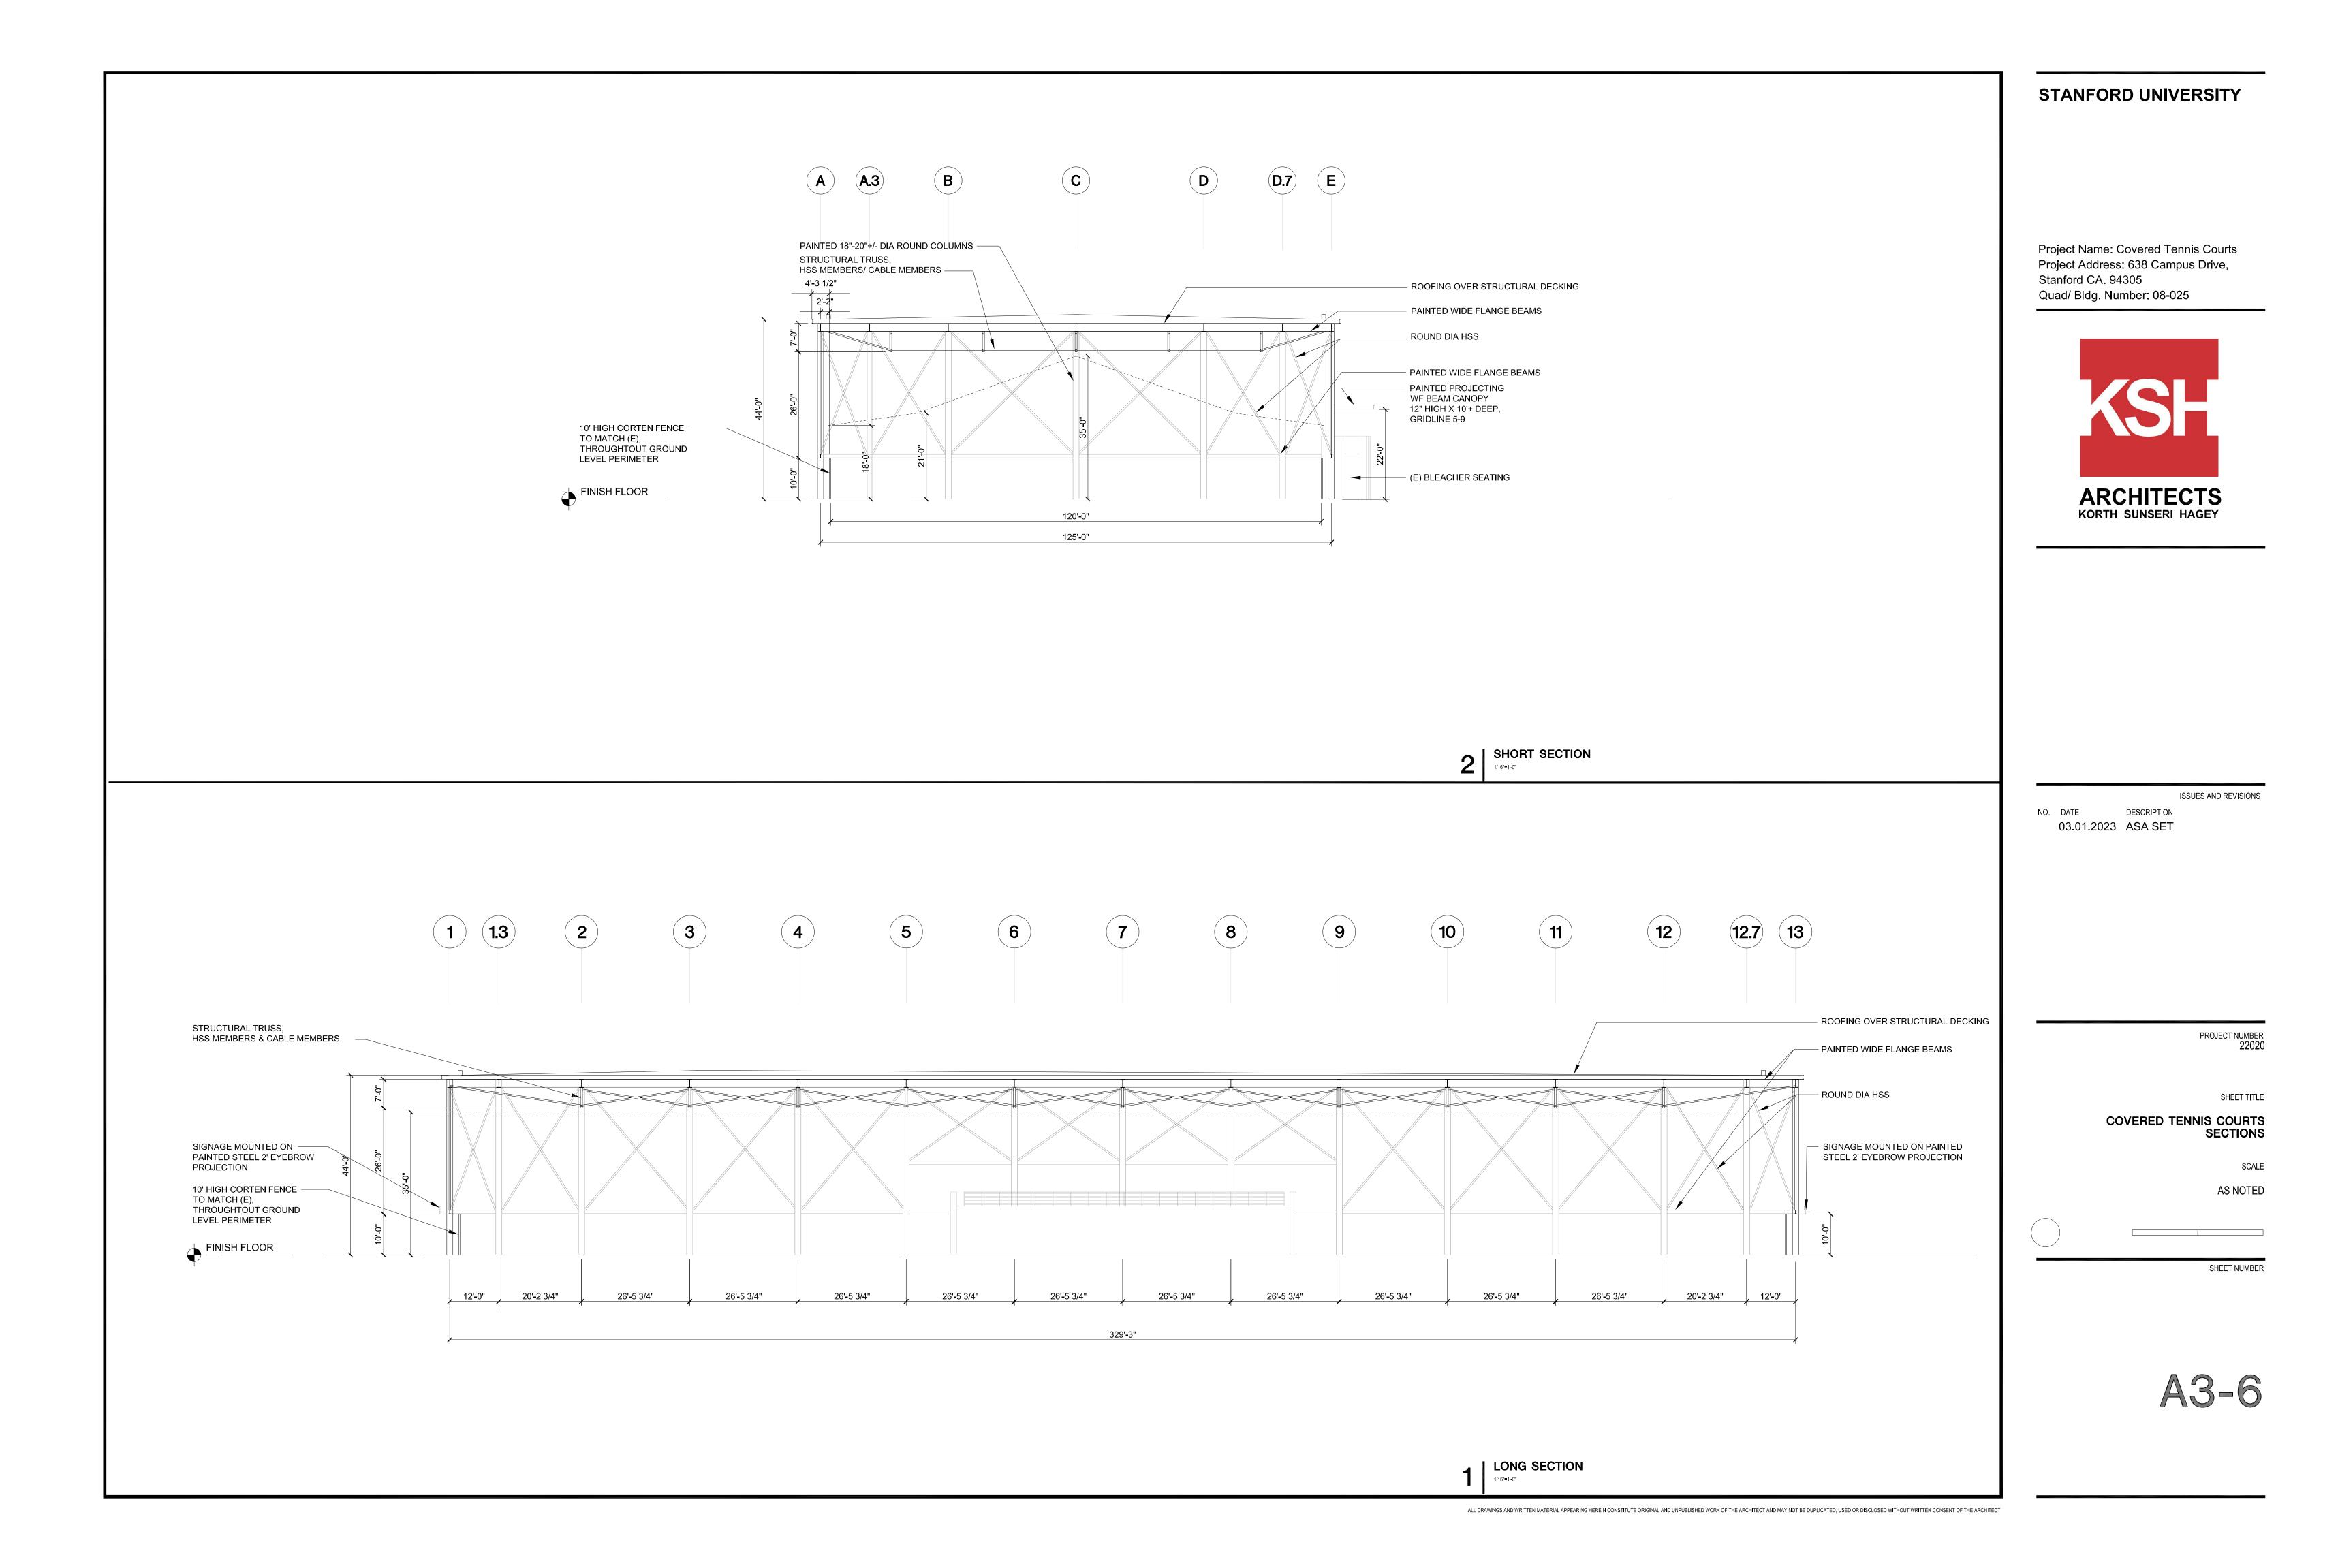

Project Name: Covered Tennis Courts Project Address: 638 Campus Drive, Stanford CA. 94305 Quad/ Bldg. Number: 08-025



1 INTERIOR VIEW FROM EAST COVERED TENNIS COURTS



ISSUES AND REVISIONS

03.01.2023 ASA SET

PROJECT NUMB

SHEET TITL

COVERED TENNIS COURTS RENDERINGS

00/12

SHEET NUME

A4-1


| VIEW FROM CAMPUS DRIVE



Project Name: Covered Tennis Courts Project Address: 638 Campus Drive, Stanford CA. 94305 Quad/ Bldg. Number: 08-025



VIEW FROM ARRILLAGA CENTER FOR SPORTS AND RECREATION

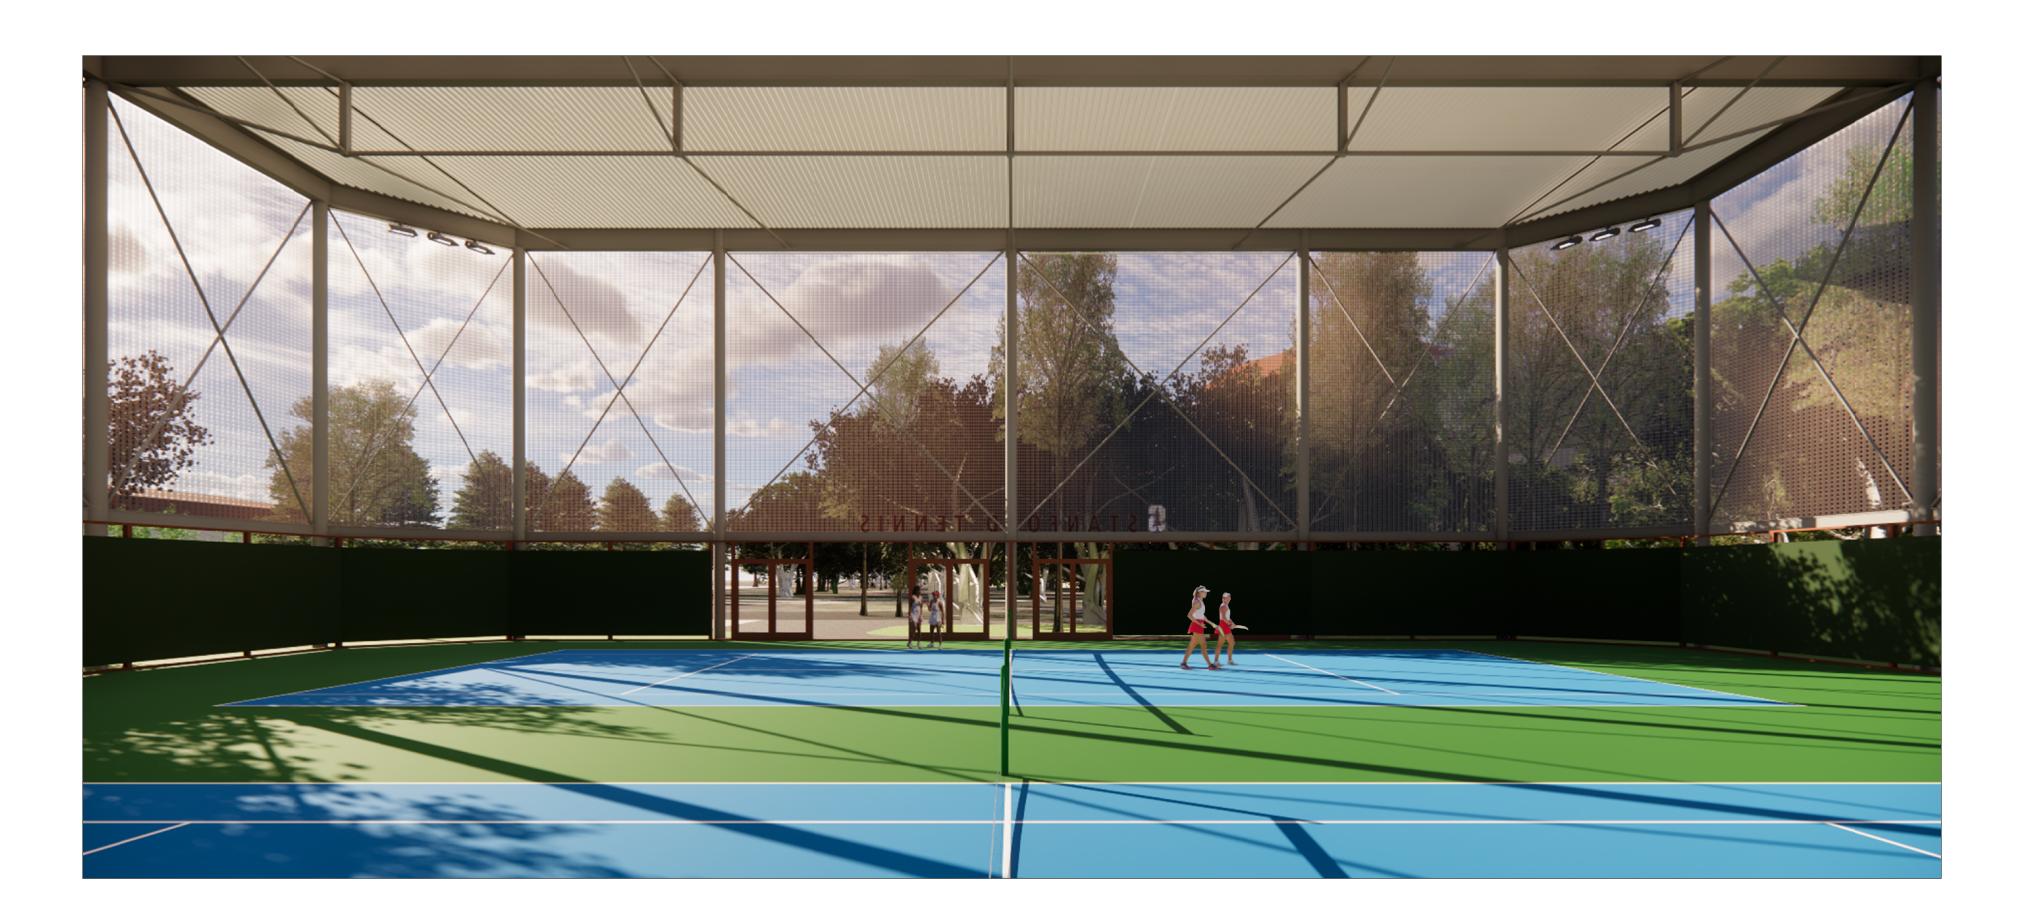

ISSUES AND REVISIONS

03.01.2023 ASA SET

PROJECT NUME 220

SHEET I

COVERED TENNIS RENDERINGS

SCAL

AS NOTED

SHEET NUME

44-2

I INTERIOR VIEW OF WEST

### **ABBREVIATIONS**

 AGGREGATE BASE ASPHALT CONCRETE AREA DRAIN - AMERICANS WITH DISABILITIES ACT AGGREGATE SUBBASE - BEGINNING OF CURVE

 BACK FLOW PREVENTOR BLDC BUILDING CORNER **BLDG** BUILDING BOD - BOTTOM OF DOCK BOLLARD - BOTTOM OF STEP - FG @ BOTTOM OF WALL - BEGIN VERTICAL CURVE

 BACK OF WALK CONCRETE OR CIVIL - CURB AND GUTTER CATCH BASIN - COMBINATION INLET - CAST IRON PIPE - CENTER LINE OR CLASS CORRUGATED METAL PIPE

CLEANOUT - CURB OPENING INLET CONCRETE CONSTRUCTION OR CONSTRUCT CUBIC YARD - DOUBLE CHECK DETECTOR ASSEMBLY DROP INLET

- DUCTILE IRON PIPE DOMESTIC - DOMESTIC WATER DRAWING EAST END OF CURVE

 EDGE OF PAVEMENT END OF RETURN END VERTICAL CURVE ELEV ELEVATION EX., EXIST. EXISTING - FACE OF CURB - FIRE DEPARTMENT CONNECTION FINISHED FLOOR

 FINISHED GRADE FIRE HYDRANT FLOW LINE FOUNDATION - FINISHED SURFACE FOOT

FIRE WATER - GROUND ELEVATION GRADE BREAK GATE VALVE - ACCESSIBLE RAMP HIGH POINT INVERT ELEVATION

MAX

- JOINT POLE JOINT TRENCH LIP OF GUTTER - LOW POINT LANDSCAPE ARCHITECT MAXIMUM

MECHANICAL/ELECTRICAL/PLUMBING MANHOLE MINIMUM - MIDPOINT OF VERTICAL CURVE MONUMENT NORTH

 NOT IN CONTRACT NUMBER NOT TO SCALE PAVEMENT ELEVATION PCC – PORTLAND CEMENT CONCRETE / POINT OF CONTINUOUS CURVATURE POST INDICATOR VALVE

- POWER MANHOLE POINT ON CURVE - POWER POLE POINT OF REVERSE CURVATURE POLYVINYL CHLORIDE PIPE RADIUS - RELATIVE COMPACTION

PROPERTY LINE

RCP- REINFORCED CONCRETE PIPE RPPA REDUCED PRESSURE PRINCIPLE ASSEMBLY R/W - RIGHT OF WAY - SLOPE OR SOUTH

S.A.D. SEE ARCHITECTURAL DRAWINGS SEDIMENT BASIN STORM DRAIN - SEE ELECTRICAL DRAWINGS SILT FENCE

SUBGRADE - SEE LANDSCAPE DRAWINGS - SEE MECHANICAL DRAWINGS S.M.D. - SIGNAL MANHOLE S.P.D. - SEE PLUMBING DRAWINGS

SANITARY SEWER STATION STANDARD SIDEWALK

- TOP OF CURB TRENCH DRAIN - TOP OF DOCK - TOE OF SLOPE TOP OF STAIR - FG @ TOP OF WALL TOP OF SLAB

TYPICAL UON UNLESS OTHERWISE NOTED UNDERGROUND VERTICAL CURVE WATER METER WATER VALVE

WEST WELDED WIRE FABRIC


APPROVED FOR ISSUANCE. REFER TO ENCROACHMENT AND / OR CONSTRUCTION PERMIT AND PLAN COVER SHEET FOR SPECIAL CONDITIONS


# STANFORD UNIVERSITY

# TAUBE SOUTH COVERED TENNIS COURTS **BUILDING 08-025**

### PALO ALTO



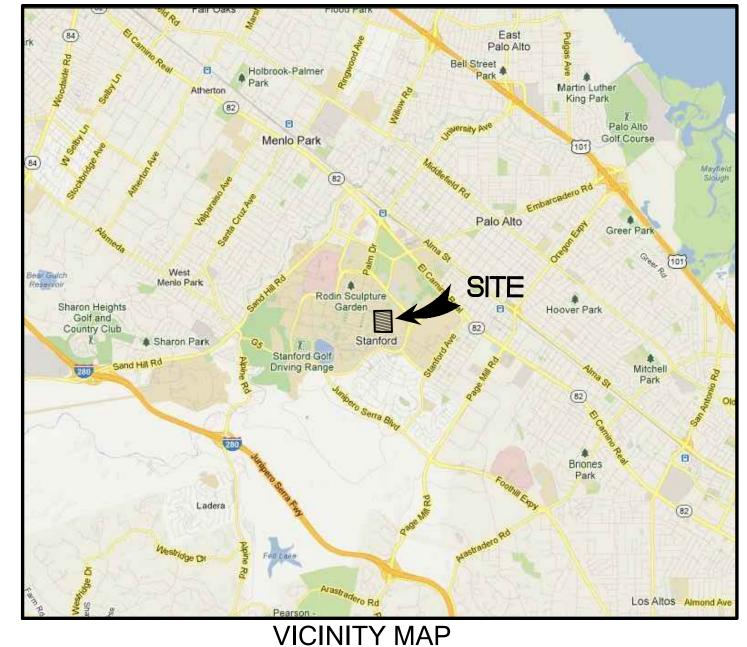

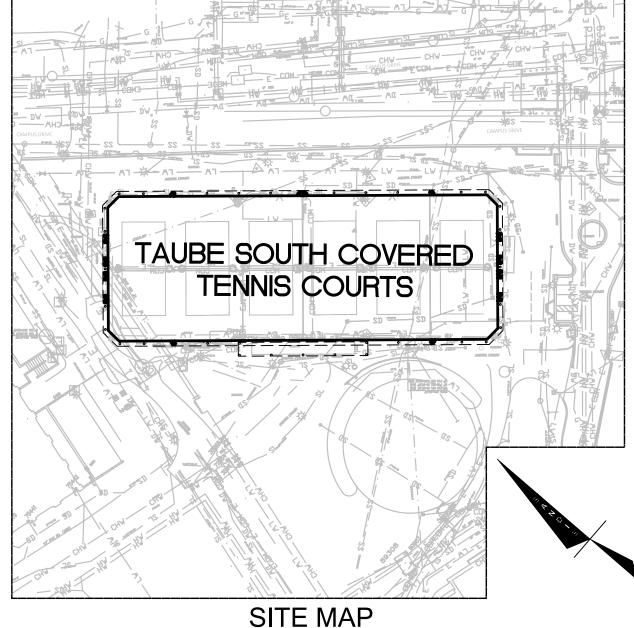

NOT TO SCALE

### EARTHWORK FOR CONSTRUCTION NOTE

IT SHALL BE THE CONTRACTOR'S RESPONSIBILITY TO INCLUDE ALL MATERIAL AND LABOR REQUIRED WITHIN THE BID PRICE, FOR EARTHWORK CONSTRUCTION, TO CARRY OUT THE CUT/FILL AND/OR IMPORT/EXPORT AS NECESSARY TO MEET THE DESIGN GRADES SHOWN ON THE PLANS. CONTRACTOR IS TO DELIVER TO OWNER THE PROJECT IN A COMPLETE AND OPERATIONAL MANNER.

### TOPOGRAPHIC SURVEY NOTES

TOPOGRAPHIC SURVEY INFORMATION SHOWN HEREON IS BASED UPON MULTIPLE SUPPLEMENTAL TOPOGRAPHIC SURVEYS COMPLETED BY SANDIS. UNDER THE DIRECTION OF LAURA CABRAL, PLS 7756, IN ADDITION TO BASEMAP INFORMATION PROVIDED BY STANFORD UNIVERSITY.

### **DEMOLITION NOTES**

- CONTRACTOR SHALL PROVIDE LABOR, MATERIAL AND EQUIPMENT REQUIRED FOR DEMOLISHING. CUTTING. CAPPING. REMOVING AND DISPOSING OF EXISTING IMPROVEMENTS AS DESIGNATED AND SHOWN ON THE DRAWINGS AND AS REQUIRED, UNLESS OTHERWISE NOTED.
- 2. CONTRACTOR SHALL DEMOLISH, ABANDON OR REROUTE EXISTING UTILITIES AS REQUIRED FOR NEW CONSTRUCTION. UTILITIES AND APPURTENANCES TO REMAIN WITHIN THE PROJECT LIMIT OF WORK SHALL BE PROTECTED.
- 3. CONTRACTOR SHALL MAINTAIN THE EXISTING SITE LIGHTING SYSTEM UNLESS OTHERWISE NOTED.
- 4. CONTRACTOR SHALL COORDINATE ALL UTILITY SHUT-DOWNS WITH THE OWNER'S *REPRESENTATIVE.*
- 5. ITEMS INDICATED TO BE SALVAGED SHALL BE REMOVED CAREFULLY, CLEANED AND DELIVERED TO THE OWNER. COORDINATE WITH THE OWNER'S REPRESENTATIVE.
- 6. CONTRACTOR SHALL PERFORM WORK IN ACCORDANCE WITH THE PROJECT SPECIFICATIONS.

### SCOPE OF WORK

CONSTRUCTION OF TENNIS COURT COVERING AND STRUCTURAL COLUMNS, AND ASSOCIATED SITE IMPROVEMENTS.

### STREET CLEANING NOTE

THE PRIME CONTRACTOR OR DEVELOPER IS TO HIRE A STREET CLEANING CONTRACTOR TO CLEAN UP DIRT AND DEBRIS FROM UNIVERSITY STREETS THAT ARE ATTRIBUTABLE TO THE DEVELOPMENT'S CONSTRUCTION ACTIVITIES. THE STREET CLEANING CONTRACTOR IS TO HAVE THE CAPABILITY OF WASHING THE STREETS FROM A TANKER TRUCK WITH A HIGH-PRESSURE NOZZLE WITH RECLAIMED WATER, WHERE FEASIBLE, AND/OR SWEEPING THE STREETS WITH BOTH A BROOM-TYPE SWEEPER AND A REGENERATIVE AIR VACUUM SWEEPER, AS DIRECTED BY THE DISTRICT, OR HIS/ HER DESIGNATED REPRESENTATIVE.

### SHUT DOWN NOTE

CONTRACTOR SHALL COORDINATE ALL SYSTEM SHUT DOWNS WITH OWNER. NO SHUT DOWNS OF ANY SERVICES WILL BE ALLOWED WITHOUT PRIOR SCHEDULE APPROVAL OF OWNER AND THEIR TENANTS.

### DISCREPANCIES

IF THERE ARE ANY DISCREPANCIES BETWEEN THE CONSTRUCTION DOCUMENTS AND EXISTING CONDITIONS WHICH WILL AFFECT THE WORK, THE CONTRACTOR SHALL BRING SUCH DISCREPANCIES TO THE ATTENTION OF THE ENGINEER FOR ADJUSTMENT BEFORE PROCEEDING WITH THE WORK. THE CONTRACTOR SHALL BE RESPONSIBLE FOR THE PROPER FITTING OF ALL WORK AND FOR THE COORDINATION OF ALL TRADES, SUBCONTRACTORS. AND PERSONS ENGAGED UPON THIS CONTRACT.

### **HYDROMODIFICATION NOTE**

THE PROJECT IS EXEMPT FROM HYDROMODIFICATION REQUIREMENTS PER THE SANTA CLARA COUNTY C.3 TECHNICAL GUIDANCE DOCUMENT. THE PROJECT IS EXEMPT FROM HYDROMODIFICATION DUE TO THE SITE BEING LOCATED IN A WATER SHED THAT DISCHARGES TO A TIDAL AREA, HARDENED CHANNEL, OR DIRECTLY TO THE BAY.

### **FLOODZONE**

SITE IS LOCATED WITHIN ZONE D BASED ON FIRM MAP PANEL NUMBER 06085 C0016H, PATED MAY 18 2009. ZONE D IS THE AREA DETERMINED TO BE AREAS FOR WHICH FLOOD HAZARDS ARE UNDETERMINED, BUT POSSIBLE.

### **UTILITY NOTE**

THE TYPES, LOCATIONS, SIZES AND /OR DEPTHS OF EXISTING UNDERGROUND UTILITIES AS SHOWN ON THIS TOPOGRAPHIC SURVEY ARE APPROXIMATE AND WERE OBTAINED FROM SOURCES OF VARYING RELIABILITY. ONLY ACTUAL EXCAVATION WILL REVEAL THE TYPES. EXTENT, SIZES, LOCATIONS AND DEPTHS OF SUCH UNDERGROUND UTILITIES. A REASONABLE EFFORT HAS BEEN MADE TO LOCATE AND DELINEATE ALL KNOWN UNDERGROUND UTILITIES. HOWEVER, THE ENGINEER CAN ASSUME NO RESPONSIBILITY FOR THE COMPLETENESS OR ACCURACY OF ITS DELINEATION OF SUCH UNDERGROUND UTILITIES WHICH MAY BE ENCOUNTERED, BUT WHICH ARE NOT SHOWN ON THIS SURVEY.

### FIRE SYSTEM NOTES

THE CONTRACTOR SHALL DESIGN, PREPARE SHOP DRAWINGS FOR, OBTAIN ALL REQUIRED APPROVALS. AND CONSTRUCT THE FIRE SYSTEM FOR THE PROPOSED PROJECT.

# - PROJECT LOCATION LOS GATOS

### COUNTY LOCATION MAP

### **ENGINEER'S STATEMENT**

I HEREBY STATE THAT THESE PLANS ARE IN COMPLIANCE WITH ADOPTED COUNTY STANDARDS, THE APPROVED TENTATIVE MAP (OR PLAN) AND CONDITIONS OF APPROVAL PERTAINING THERETO DATED

R.C.E. NO.

### COUNTY ENGINEER'S NOTE

ISSUED BY: \_\_\_\_\_

ISSUANCE OF A PERMIT AUTHORIZING CONSTRUCTION DOES NOT RELEASE THE DEVELOPER, PERMITTEE OF ENGINEER FROM RESPONSIBILITY FOR THE CORRECTION OF ERRORS OR OMISSIONS CONTAINED IN THE PLANS. IF, DURING THE COURSE OF CONSTRUCTION, THE PUBLIC INTEREST REQUIRES A MODIFICATION OF (OR DEPARTURE FROM) THE SPECIFICATIONS OF THE PLANS, THE COUNTY SHALL HAVE THE AUTHORITY TO REQUIRE THE SUSPENSION OF WORK, AND THE NECESSARY MODIFICATION OR DEPARTURE AND TO SPECIFY THE MANNER IN WHICH THE SAME IS TO BE MADE.

DATE		
	SIGNA TURE	
	R.C.E. NO.	EXPIRATION DATE
COUNTY OF SANTA CLARA LAND DEVELOPMENT ENGINEERING & SURVEYING		
CONSTRUCTION PERMIT NO.		

DATE:\_

### **CIVIL SHEET INDEX**

C-9.0

EXPIRATION DATE

C-1.1C-1.2FIRE SAFETY NOTES C-2.0 TOPOGRAPHIC SURVEY C-3.0 DEMOLITION/TREE REMOVAL PLAN C-3.1 DEMOLITION/TREE REMOVAL NOTES C-4.0 GRADING AND DRAINAGE PLAN C-5.0 UTILITY PLAN C-6.0STORMWATER MANAGEMENT PLAN C-7.0 EROSION CONTROL PLAN C-7.1 COUNTY BMP NOTES C-7.2 COUNTY BMP NOTES

FIRE ACCESS PLAN

**Know what's below Call** before you dia.

CONSTRUCTION SITE LOGISTICS/SAFETY PLAN

### POST INDICATOR VALVE FIRE DEPARTMENT CONNECTION WATER LINE TEE CAP AND PLUG END AIR RELEASE VALVE SIGN ACCESSIBLE RAMP CONCRETE THRUST BLOCK REDUCER SANITARY SEWER MANHOLE SANITARY SEWER CLEANOUT STORM DRAIN MANHOLE $\bigcirc$ STORM DRAIN AREA DRAIN STORM DRAIN CATCH BASIN ☐ CB STORM DRAIN CURB INLET STORM DRAIN CLEANOUT ELECTROLIER • <del>\*</del> \* • \* COVER SHEET CONSTRUCTION NOTES JOINT POLE

OVERLAND RELEASE

CONSTRUCTION DETAIL REFERENCE

**LEGEND** 

RETAINING WALL

A.C. PAVEMENT

CONC. VALLEY GUTTER

6" CURB & GUTTER

6" VERTICAL CURB

SANITARY SEWER MAIN

STORM DRAIN MAIN

PERFORATED PIPE

FIRE WATER MAIN

DOMESTIC WATER MAIN

CHILLED WATER MAIN

HOT WATER SUPPLY & RETURN

ELECTRIC AND SIGNAL DUCT BANK

OVERHEAD ELECTRIC LINE

STREET LIGHT CONDUIT

SPOT ELEVATION

GAS METER

GAS VALVE

WATER METER

WATER VALVE

FIRE HYDRANT

BACK FLOW PREVENTOR

DIRECTION OF SLOPE

CONTOUR ELEVATION LINE

UNDERGROUND ELECTRIC LINE

IRRIGATION LINE

LAKE WATER LINE

TRENCH DRAIN

CONDENSATE RETURN

CHAIN LINK FENCE

STEAM LINE

FLOW LINE

GAS MAIN

WATER MAIN

CENTER LINE

CONC. SIDEWALK OR PAD

EDGE OF A.C. PAVEMENT

SAWCUT AND CONFORM LINE

**EXISTING** 

x 95.94 \$

XX +O+

**PROPOSED** 

—\_\_\_x —\_\_\_x —\_\_

FG 95.94

## **UNAUTHORIZED CHANGES AND USES**

**CAUTION:** The engineer preparing these plans will not be responsible for, or liable for, unauthorized changes to or uses of these plans. All changes to the plans must be in writing and must be approved by the preparer of the plans.

Construction contractor agrees that in accordance with generally accepted construction practices, construction contractor will be required to assume sole and complete responsibility or job site conditions during the course of construction of the project, including safety of all persons and property; that this requirement shall be made to apply continuously and not be limited to normal working hours and construction contractor further agrees to defend, indemnify and hold design professional harmless from any and all liability, real or alleged in connection with the performance of work on this project, excepting liability arising from sole negligence of design professional.

Consulting Engineers & Land Surveyors of California

DETAIL REFERENC

SHEET REFERENCE

SDCO

C5.2

### STANFORD UNIVERSITY

**Project Name: Covered Tennis Courts** Project Address: 638 Campus Drive, Stanford CA. 94305 Quad/ Bldg. Number: 08-025





ISSUES AND REVISIONS

DESCRIPTION 03.01.2023 ASA SUBMITTAL

PROJECT NUMBER

SHEET TITLE

**COVER SHEET** 

SCALE

SHEET NUMBER

# COUNTY OF SANTA CLARA GENERAL CONSTRUCTION SPECIFICATIONS

- GENERAL CONDITIONS
- 1. ALL CONSTRUCTION WORK SHALL BE PERFORMED IN ACCORDANCE WITH THE SOILS AND/OR GEOTECHNICAL REPORT PREPARED BY CORNERSTONE EARTH GROUP. THIS REPORT IS SUPPLEMENTED BY:
- 1) THESE PLANS AND SPECIFICATIONS,
- 2) THE COUNTY OF SANTA CLARA STANDARD DETAILS.
  3) THE COUNTY OF SANTA CLARA STANDARD SPECS,
  4) STATE OF CALIFORNIA STANDARD DETAILS,
- 5) STATE OF CALIFORNIA STANDARD SPECIFICATIONS.
  IN THE EVENT OF CONFLICT THE FORMER SHALL TAKE PRECEDENCE OVER THE LATTER. THE PERFORMANCE AND COMPLETION OF ALL WORK MUST BE TO THE SATISFACTION OF THE COUNTY.
- 2. DEVELOPER IS RESPONSIBLE FOR INSTALLATION OF THE IMPROVEMENTS SHOWN ON THESE PLANS AND HE OR HIS SUCCESSOR PROPERTY OWNERS ARE RESPONSIBLE FOR THEIR CONTINUED MAINTENANCE.
- 3. DEVELOPER SHALL BE RESPONSIBLE FOR CORRECTION OF ANY ERRORS OR OMISSIONS IN THESE PLANS. THE COUNTY SHALL BE AUTHORIZED TO REQUIRE DISCONTINUANCE OF ANY WORK AND SUCH CORRECTION AND MODIFICATION OF PLANS AS MAY BE NECESSARY TO COMPLY WITH COUNTY STANDARDS OR CONDITIONS OF DEVELOPMENT APPROVAL.
- 4. DEVELOPER SHALL OBTAIN ENCROACHMENT PERMITS FROM THE SANTA CLARA VALLEY WATER DISTRICT AND CALIFORNIA DEPARTMENT OF TRANSPORTATION WHERE NEEDED. COPIES OF THESE PERMITS SHALL BE KEPT AT THE JOB SITE FOR REVIEW BY THE COUNTY'S INSPECTOR.
- 5. DEVELOPER SHALL REMOVE OR TRIM ALL TREES TO PROVIDE AN UNOBSTRUCTED FIFTEEN (15) FOOT VERTICAL CLEARANCE FOR ROADWAY AREA.
- 6. THIS PLAN AUTHORIZES THE REMOVAL OF ONLY THOSE TREES WITH TRUNK DIAMETERS GREATER THAN 12 INCHES MEASURED 4.5 FEET ABOVE THE GROUND THAT ARE SHOWN TO BE REMOVED UNLESS AN AMENDED PLAN IS APPROVED OR A SEPARATE TREE REMOVAL PERMIT IS OBTAINED FROM THE PLANNING OFFICE. IT IS THE CONTRACTOR'S RESPONSIBILITY TO ENSURE THAT REMOVAL OF ADDITIONAL TREES HAS BEEN PERMITTED.
- 7. DEVELOPER SHALL PROVIDE ADEQUATE DUST CONTROL AS REQUIRED BY THE COUNTY INSPECTOR.
- 8. ALL PERSONS MUST COMPLY WITH SECTION 4442 OF THE PUBLIC RESOURCES CODE AND SECTION 13005 OF THE HEALTH AND SAFETY CODE RELATING TO THE USE OF SPARK ARRESTERS.
- 9. UPON DISCOVERING OR UNEARTHING ANY BURIAL SITE AS EVIDENCED BY HUMAN SKELETAL REMAINS OR ARTIFACTS, THE PERSON MAKING SUCH DISCOVERY SHALL IMMEDIATELY NOTIFY THE COUNTY CORONER AT (408) 454–2520 AND LAND DEVELOPMENT ENGINEERING OFFICE AT (408) 299–5730. NO FURTHER DISTURBANCE OF THE SITE MAY BE MADE EXCEPT AS AUTHORIZED BY THE LAND DEVELOPMENT OFFICE IN ACCORD WITH PROVISIONS OF THIS ORDINANCE (COUNTY ORDINANCE CODE SECTION B6–18).
- 10. THESE PLANS ARE FOR THE WORK DESCRIBED IN THE SCOPE OF WORK ONLY. A SEPARATE PERMIT WILL BE REQUIRED FOR THE SEPTIC LINE CONSTRUCTION.
- 11. ANY DEVIATION FROM THESE APPROVED PLANS SHALL BE RE—APPROVED IN WRITING BY THE COUNTY ENGINEER PRIOR TO CONSTRUCTION.
- 12. "THE BAY AREA AIR QUALITY MANAGEMENT DISTRICT (BAAQMD) HAS IDENTIFIED A SET OF FEASIBLE PM10 CONTROL MEASURES FOR ALL CONSTRUCTION ACTIVITIES. THESE CONTROL MEASURES, AS PREVIOUSLY REQUIRED IN THE EIR, SHALL BE ADHERED TO DURING ALL CONSTRUCTION ACTIVITIES.
- A. WATER ALL ACTIVE CONSTRUCTION AREA AT LEAST TWICE DAILY.
- B. COVER ALL TRUCK HAULING SOIL, SAND AND OTHER LOOSE MATERIALS OR REQUIRE ALL TRUCKS TO MAINTAIN AT LEAST TWO FEET OF FREEBOARD.
- C. PAVE, APPLY WATER THREE TIMES DAILY, OR APPLY (NON—TOXIC) SOIL STABILIZERS ON ALL UNPAVED ACCESS ROADS, PARKING AREAS AND STAGING AREAS AT CONSTRUCTION SITES.
- D. SWEEP DAILY (WITH WATER SWEEPERS) ALL PAVED ACCESS ROADS, PARKING AREAS, AND STAGING AREAS AT CONSTRUCTIONS SITES.
- E. SWEEP STREETS DAILY (WITH WATER SWEEPERS) IF VISIBLE SOIL MATERIAL ARE CARRIED ONTO ADJACENT PUBLIC STREETS.
- F. HYDROSEED OR APPLY (NON—TOXIC) SOIL STABILIZERS TO INACTIVE CONSTRUCTION AREA (PREVIOUSLY GRADED AREAS INACTIVE FOR TEN DAYS OR MORE).
- G. ENCLOSE, COVER, WATER TWICE DAILY OR APPLY (NON-TOXIC) SOIL BINDERS TO EXPOSED STOCKPILES (DIRT, SAND).
- H. LIMIT TRAFFIC SPEEDS ON UNPAVED ROADS TO 15 MPH.
- I. INSTALL FIBER ROLLS, SAND BAGS OR OTHER EROSION CONTROL MEASURES TO PREVENT SILT RUNOFF TO PUBLIC ROADWAYS.
- J. REPLANT VEGETATIONS DISTURBED AREAS AS QUICKLY AS POSSIBLE.
- K. INSTALL WHEEL WASHERS FOR ALL EXISTING TRUCKS, OR WASH OFF THE TIRES OF TRACKS OF ALL TRUCKS AND EQUIPMENT LEAVING THE SITE AND
- L. SUSPEND EXCAVATION AND GRADING ACTIVITY WHEN WINDS (INSTANTANEOUS GUSTS) EXCEED 25 MPH.
- 13. PLACE A CONSTRUCTION NOTE ON THE SITE PLAN THAT STATES THE FOLLOWING: "ALL CONSTRUCTION CONTRACTORS SHALL PROPERLY MAINTAIN THE EQUIPMENT EQUIPMENT AND EMISSIONS CONTROL" CLEAN FUEL" WHERE FEASIBLE USE TECHNOLOGY (E.G. CNS FIRED ENGINES, CATALYTIC CONVERTERS, PARTICULATE TRAPS, ETC.). MEASURES TO REDUCE DIESEL EMISSION WOULD BE CONSIDERED FEASIBLE WHEN THEY ARE CAPABLE OF BEING USED ON EQUIPMENT, WITHOUT INTERFERING SUBSTANTIALLY WITH EQUIPMENT PERFORMANCE.
- 14. IN THE EVENT THAT PREVIOUSLY UNIDENTIFIED HISTORIC AND PREHISTORIC ARCHAEOLOGICAL RESOURCES ARE DISCOVERED DURING BUILDING CONSTRUCTION, THE CONTRACTOR SHALL CEASE WORK IN THE IMMEDIATE AREA AND THE COUNTY PLANNING OFFICE AND CAMPUS ARCHAEOLOGIST SHALL BE CONTACTED. AN INDEPENDENT QUALIFIED ARCHAEOLOGIST RETAINED BY THE COUNTY AT THE EXPENSE OF STANFORD SHALL ASSESS THE SIGNIFICANCE OF THE FIND AND MAKE MITIGATION RECOMMENDATIONS.

- 15. IF ARCHEOLOGICAL RESOURCES ARE DISCOVERED AS DESCRIBED ABOVE, CONSTRUCTION MONITORING SHALL BE CONDUCTED AT ANY TIME GROUND-DISTURBING ACTIVITIES (GREATER THAN 12 IN DEPTH) ARE TAKING PLACE IN THE IMMEDIATE VICINITY OF THE IDENTIFIED RESOURCES. IF MONITORING DOES NOT PRODUCE EVIDENCE OF SIGNIFICANT CULTURAL RESOURCES WITHIN THE PROJECT AREA, FURTHER MITIGATION SHALL BE LIMITED TO CONSTRUCTION MONITORING, UNLESS ADDITIONAL TESTING OR OTHER SPECIFIC MITIGATION MEASURES ARE DETERMINED BY A QUALIFIED ARCHAEOLOGIST TO BE NECESSARY TO ENSURE AVOIDANCE OR DAMAGE TO SIGNIFICANT ARCHEOLOGICAL RESOURCES. A TECHNICAL REPORT OF FINDINGS DESCRIBING THE RESULTS OF ALL MONITORING SHALL BE PREPARED IN ACCORDANCE WITH PROFESSIONAL STANDARDS. THE ARCHAEOLOGICAL MONITORING PROGRAM SHALL BE IMPLEMENTED BY AN INDIVIDUAL MEETING THE SECRETARY OF INTERIOR PROFESSIONAL QUALIFICATIONS STANDARDS IN ARCHAEOLOGY (36 CFR 61): INDIVIDUAL FIELD MONITORS SHALL BE QUALIFIED IN THE RECOGNITION OF CULTURAL RESOURCES AND POSSESS SUFFICIENT ACADEMIC AND FIELD TRAINING AS REQUIRED TO CONDUCT THE WORK EFFECTIVELY AND WITHOUT UNDUE
- 16. IN THE EVENT THAT HUMAN SKELETAL REMAINS ARE ENCOUNTERED, THE APPLICANT IS REQUIRED BY COUNTY ORDINANCE NO. B6-18 TO IMMEDIATELY NOTIFY THE COUNTY CORONER. UPON DETERMINATION BY THE COUNTY CORONER THAT THE REMAINS ARE NATIVE AMERICAN, THE CORONER SHALL CONTACT THE CALIFORNIA NATIVE AMERICAN HERITAGE COMMISSION, PURSUANT TO SUBDIVISION (C) OF SECTION 7050.5 OF THE HEALTH AND SAFETY CODE AND THE COUNTY COORDINATOR OF INDIAN AFFAIRS. NO FURTHER DISTURBANCE OF THE SITE MAY BE MADE EXCEPT AS AUTHORIZED BY THE COUNTY COORDINATOR OF INDIAN AFFAIRS IN ACCORDANCE WITH THE PROVISIONS OF STATE LAW AND THIS CHAPTER. IF ARTIFACTS ARE FOUND ON THE SITE A QUALIFIED ARCHAEOLOGIST SHALL BE CONTACTED ALONG WITH THE COUNTY PLANNING OFFICE. NO FURTHER DISTURBANCE OF THE ARTIFACTS MAY BE MADE EXCEPT AS AUTHORIZED BY THE COUNTY PLANNING OFFICE.
- 17. IN THE EVENT THAT FOSSILIZED SHELL OR BONE IS UNCOVERED DURING ANY EARTH—DISTURBING OPERATION, CONTRACTORS SHALL STOP WORK IN THE IMMEDIATE AREA OF THE FIND AND NOTIFY THE CAMPUS ARCHAEOLOGIST AND THE COUNTY BUILDING INSPECTOR ASSIGNED TO THE PROJECT. THE CAMPUS ARCHAEOLOGIST SHALL VISIT THE SITE AND MAKE RECOMMENDATIONS FOR TREATMENT OF THE FIND (INCLUDING BUT NOT LIMITED TO CONSULTATION WITH A PALEONTOLOGIST AND EXCAVATION, IF WARRANTED), WHICH WOULD BE SENT TO THE COUNTY BUILDING INSPECTION OFFICE AND THE COUNTY PLANNING OFFICE. IF A FOSSIL FIND IS CONFIRMED, IT WILL BE RECORDED WITH THE UNITED STATES GEOLOGICAL SURVEY AND CURATED IN AN APPROPRIATE REPOSITORY.
- 18. ONE SIGN SHALL BE POSTED ALONG A STREET FRONTAGE OR IN FRONT OF THE PROJECT SITE, NO SMALLER THAN 1,296 SQUARE INCHES IN SIZE, CONTAINING THE NAME, TELEPHONE NUMBER, AND EMAIL ADDRESS OF THE APPROPRIATE STANFORD PERSON THE PUBLIC MAY CONTACT TO REGISTER A COMPLAINT ABOUT CONSTRUCTION NOISE. STANFORD SHALL KEEP A WRITTEN RECORD OF ALL SUCH COMPLAINTS AND SHALL PROVIDE COPIES OF THESE RECORDS TO THE COUNTY PLANNING OFFICE.
- 19. CONSTRUCTION MATERIALS AND FILL DIRT DELIVERED FROM OFF CAMPUS SHALL NOT BE DELIVERED BETWEEN THE HOURS OF 7:00 AM TO 9:00 AM AND 4:00 PM TO 6:00 PM ON WEEKDAYS.
- 20. TRUCKS EXPORTING/IMPORTING FILL DIRT AND BUILDING MATERIALS FOR THE PROJECT SHALL USE APPROVED TRUCK ROUTES SHOWN IN THE 2000 GUP, AS DESIGNATED BY THE CITIES OF PALO ALTO AND MENLO PARK.

### CONSTRUCTION STAKING

- 1. THE DEVELOPER'S ENGINEER IS RESPONSIBLE FOR THE INITIAL PLACEMENT AND REPLACEMENT OF CONSTRUCTION GRADE STAKES. THE STAKES ARE TO BE ADEQUATELY IDENTIFIED, LOCATED, STABILIZED, ETC. FOR THE CONVENIENCE OF CONTRACTORS. LATERAL OFFSET OF STAKES SET FOR CURBS AND GUTTERS SHALL NOT EXCEED 2 1/2 FEET FROM BACK OF CURB.
- 2. ANY PROPERTY LINE STAKES OR ROAD MONUMENTS DISTURBED DURING CONSTRUCTION SHALL BE REPLACED BY DEVELOPER'S ENGINEER AND LICENSED LAND SURVEYOR.
- 3. PROPERTY LINE STAKING MUST BE PERFORMED BY THE PROJECT ENGINEER OR LAND SURVEYOR TO ESTABLISH OR RE-ESTABLISH THE PROJECT BOUNDARY AND SHALL BE INSPECTED BY THE COUNTY INSPECTOR PRIOR TO THE BEGINNING OF THE WORK.
- 4. PROPER CONSTRUCTION STAKES SHALL BE SET IN THE FIELD BY THE PROJECT ENGINEER OR LAND SURVEYOR AND VERIFIED BY THE COUNTY INSPECTOR PRIOR TO THE COMMENCEMENT OF GRADING.

### CONSTRUCTION INSPECTION

- 1. CONTRACTOR SHALL NOTIFY PERMIT INSPECTION UNIT, SANTA CLARA COUNTY PRIOR TO COMMENCING WORK AND FOR FINAL INSPECTION OF WORK AND SITE.
- 2. THE COUNTY REQUIRES A MINIMUM OF 24 HOURS ADVANCE NOTICE FOR GENERAL INSPECTION, 48 HOURS FOR ASPHALT CONCRETE INSPECTION.
- 3. INSPECTION BY SANTA CLARA COUNTY SHALL BE LIMITED TO INSPECTION OF MATERIALS AND PROCESSES OF CONSTRUCTION TO OBSERVE THEIR COMPLIANCE WITH PLANS & SPECIFICATIONS BUT DOES NOT INCLUDE RESPONSIBILITY FOR THE SUPERINTENDENT OF CONSTRUCTION, SITE CONDITIONS, EQUIPMENT OR PERSONNEL. CONTRACTOR SHALL NOTIFY THE COUNTY LAND DEVELOPMENT INSPECTOR AT PHONE (408) 299–6868 AT LEAST 24 HOURS PRIOR TO COMMENCING WORK AND FOR FINAL INSPECTION OF WORK AND SITE.
- 4. DEVELOPER AND/OR HIS AUTHORIZED REPRESENTATIVE MUST SUBMIT WRITTEN REQUEST FOR FINAL INSPECTION AND ACCEPTANCE. SAID REQUEST SHALL BE DIRECTED TO THE INSPECTION OFFICE NOTED ON THE PERMIT FORM.
- 5. THE CONTRACTOR SHALL PROVIDE TO THE COUNTY CONSTRUCTION INSPECTOR WITH PAD ELEVATION AND LOCATION CERTIFICATES, PREPARED BY THE PROJECT ENGINEER OR LAND SURVEYOR, PRIOR COMMENCEMENT OF THE BUILDING FOUNDATION.

### SITE PREPARATION (CLEARING AND GRUBBING)

- 1. EXISTING TREES AUTHORIZED FOR REMOVAL, ROOTS, AND FOREIGN MATERIAL IN AREAS TO BE IMPROVED WILL BE REMOVED TO AN AUTHORIZED DISPOSAL SITE AS FOLLOWS:
- A) TO A MINIMUM DEPTH OF TWO FEET BELOW THE FINISHED GRADE OF PROPOSED ROADWAYS (EITHER PRIVATE OR TO BE DEDICATED TO PUBLIC USE)
- B) FROM AREAS AFFECTED BY THE PROPOSED GRADING EXCEPT WHERE NOTED ON THE PLANS.
- 2. IT SHALL BE THE RESPONSIBILITY OF THE DEVELOPER TO MOVE OR RELOCATE UTILITY POLES AND OTHER OBSTRUCTIONS IN THE WAY OF CONSTRUCTION.

UTILITY LOCATION, TRENCHING & BACKFILL

- 1. CONTRACTOR SHALL NOTIFY USA (UNDERGROUND SERVICE ALERT) AT 1-800-277-2600 A MINIMUM OF 24 HOURS BEFORE BEGINNING UNDERGROUND WORK FOR VERIFICATION OF THE LOCATION OF UNDERGROUND UTILITIES.
- 2. ACCURATE VERIFICATION AS TO SIZE, LOCATION, AND DEPTH OF EXISTING UNDERGROUND CONDUITS OR FACILITIES SHALL BE THE INDIVIDUAL CONTRACTORS RESPONSIBILITY. PLAN LOCATIONS ARE APPROXIMATE AND FOR GENERAL INFORMATION ONLY.
- 3. ALL UNDERGROUND INSTALLATIONS SHALL BE IN PLACE AND THE TRENCH BACKFILLED AND COMPACTED BEFORE PLACING AGGREGATE BASE MATERIAL OR SURFACE STRUCTURES. SURFACING MAY BE DONE IF THE UTILITY COMPANY CONCERNED INDICATES BY LETTER THAT IT WILL BORE. UNLESS SPECIFICALLY AUTHORIZED BY THE COUNTY, GAS AND WATER MAINS SHALL BE INSTALLED OUTSIDE THE PAVED AREAS.
- 4. TRENCH BACKFILL IN EXISTING PAVEMENT AREAS SHALL BE SAND MATERIAL IN ACCORDANCE WITH THE APPLICABLE PROVISIONS OF THE STATE SPECIFICATIONS. THE STRUCTURAL SECTION FOR TRENCH REPLACEMENT SHALL CONSIST OF NOT LESS THAN 12 INCHES OF APPROVED AGGREGATE BASE MATERIAL COMPACTED TO A RELATIVE COMPACTION OF AT LEAST 95%% AND 4 INCHES OF HOT ASPHALT CONCRETE PLACED IN TWO LIFTS. TRENCH RESTORATION FOR HIGHER TYPE PAVEMENTS SHALL BE MADE IN KIND OR AS DIRECTED BY THE COUNTY.
- 5. TRENCH BACKFILL IN NEW CONSTRUCTION AREAS SHALL BE SAND MATERIAL COMPACTED TO A RELATIVE COMPACTION OF AT LEAST 90%%. THE REQUIREMENT FOR SELECT MATERIAL MAY BE WAIVED BY COUNTY IF THE NATIVE SOIL IS SUITABLE FOR USE AS TRENCH BACKFILL BUT THE COMPACTION REQUIREMENTS WILL NOT BE THEREBY WAIVED.
- 6. BACKFILL AND TRENCH RESTORATION REQUIREMENTS SHALL APPLY AS MINIMUM STANDARDS TO ALL UNDERGROUND FACILITIES INSTALLED BY OTHER FIRMS OR PUBLIC AGENCIES.

### <u>GRADING</u>

- 1. EXCAVATED MATERIAL SHALL BE PLACED IN THE FILL AREAS DESIGNATED OR SHALL BE HAULED AWAY FROM THE SITE. WHERE FILL MATERIAL IS TO BE PLACED ON NATURAL GROUND, IS SHALL BE STRIPPED OF ALL VEGETATION. TO ACHIEVE A PROPER BOND WITH THE FILL MATERIAL, THE SURFACE OF THE GROUND SHALL BE SCARIFIED TO DEPTH OF 6" BEFORE FILL IS PLACED. WHERE NATURAL GROUND IS STEEPER THAN 5:1, IT SHALL BE BENCHED AND THE FILL KEYED IN TO ACHIEVE STABILITY. WHERE NEW FILL IS TO BE PLACED ON EXISTING FILL THE EXISTING FILL SHALL BE REMOVED UNTIL MATERIAL COMPACTED TO 90% RELATIVE COMPACTION IS EXPOSED. THEN THE NEW FILL MATERIAL SHALL BE PLACED AS PER THESE CONSTRUCTION NOTES. FILL MATERIAL SHALL BE PLACED IN UNIFORM LIFTS NOT EXCEEDING 6" IN UNCOMPACTED THICKNESS. BEFORE COMPACTION BEGINS, THE FILL SHALL BE BROUGHT TO A WATER CONTENT THAT WILL PERMIT PROPER COMPACTION BY EITHER 1) AERATING THE FILL IF IT IS TOO WET OR 2) MOISTENING THE FILL WITH WATER IF IT IS TOO DRY. EACH LIFT SHALL BE THOROUGHLY MIXED BEFORE COMPACTION TO ENSURE A UNIFORM DISTRIBUTION OF MOISTURE.
- 2. SURPLUS EARTH FILL MATERIAL SHALL BE PLACED IN A SINGLE (8" MAX)
  THICK LAYER COMPACTED TO WITHSTAND WEATHERING IN THE AREA(S)
  DELINEATED ON THE PLAN.
- 3. NO ORGANIC MATERIAL SHALL BE PLACED IN ANY FILL. NO TREES SHALL BE REMOVED OUTSIDE OF CUT, FILL OR ROADWAY AREAS.
- 4. THE UPPER 6" OF SUBGRADE BELOW DRIVEWAY ACCESS ROAD OR PARKING AREA SHALL BE COMPACTED TO 95% OF MAXIMUM DENSITY.
- 5. MAXIMUM CUT SLOPE SHALL BE 2 HORIZONTAL TO 1 VERTICAL. MAXIMUM FILL SLOPE SHALL 2 HORIZONTAL TO 1 VERTICAL.

ESTIMATED VOLUME OF SI	TE GRADING	O CUBIC YARDS CU O CUBIC YARDS FIL
	NET	O CUBIC YARDS
MAXIMUM DEPTH OF	CUT	O FEET

FILL

EXCESS MATERIAL SHALL BE OFF HAULED TO A COUNTY APPROVED DUMP

O FEET

- 6. NOTIFY SOILS ENGINEER TWO (2) DAYS PRIOR TO COMMENCEMENT OF ANY GRADING WORK TO COORDINATE THE WORK IN THE FIELD.
- 7. ALL MATERIALS FOR FILL SHOULD BE APPROVED BY THE SOILS ENGINEER BEFORE IT IS BROUGHT TO THE SITE.
- 8. THE UPPER 6" OF THE SUBGRADE SOIL SHALL BE SCARIFIED, MOISTURE CONDITIONED AND COMPACTED TO A MINIMUM RELATIVE COMPACTION OF
- 9. ALL AGGREGATE BASE MATERIAL SHALL BE COMPACTED TO A MINIMUM 95% RELATIVE COMPACTION.
- 10. THE GEOTECHNICAL PLAN REVIEW LETTER MUST BE REVIEWED AND APPROVED BY THE COUNTY GEOLOGIST PRIOR TO FINAL APPROVAL BY THE COUNTY ENGINEER FOR BUILDING OCCUPANCY.
- 11. THE PROJECT GEOTECHNICAL ENGINEER SHALL PERFORM COMPACTION TESTING AND PRESENT THE RESULTS TO THE COUNTY ENGINEERING INSPECTOR PRIOR TO THE CONSTRUCTION OF ANY PAVED AREA.

### AIR QUALITY, LANDSCAPING AND EROSION CONTROL

- WATER ALL ACTIVE CONSTRUCTION AREAS AT LEAST TWICE DAILY.
   COVER ALL TRUCKS HAULING SOIL, SAND, AND OTHER LOOSE MATERIALS OR REQUIRE ALL TRUCKS TO MAINTAIN AT LEAST TWO FEET OF FREEBOARD.
- 3. PAVE, APPLY WATER THREE TIMES DAILY, OR APPLY (NON-TOXIC) SOIL STABILIZERS ON ALL UNPAVED ACCESS ROADS, PARKING AREAS AND STAGING AREAS AT CONSTRUCTION SITES.
- 4. SWEEP DAILY (WITH WATER SWEEPERS) ALL PAVED ACCESS ROADS, PARKING AREAS AND STAGING AREAS AT CONSTRUCTION SITES. THE USE OF DRY POWDER SWEEPING IS PROHIBITED.
- 5. SWEEP STREETS DAILY (WITH WATER SWEEPERS) IF VISIBLE SOIL MATERIAL IS CARRIED ONTO ADJACENT PUBLIC STREETS. THE USE OF DRY POWDER SWEEPING IS PROHIBITED.
- 6. ALL CONSTRUCTION VEHICLES, EQUIPMENT AND DELIVERY TRUCKS SHALL HAVE A MAXIMUM IDLING TIME OF 5 MINUTES (AS REQUIRED BY THE CALIFORNIA AIRBORNE TOXIC CONTROL MEASURE TITLE 13, SECTION 2485 OF CALIFORNIA CODE OF REGULATIONS (CCR)). ENGINES SHALL BE SHUT OFF IF CONSTRUCTION REQUIRES LONGER IDLING TIME UNLESS NECESSARY FOR PROPER OPERATION OF THE VEHICLE.

7. ALL VEHICLE SPEEDS ON UNPAVED ROADS SHALL BE LIMITED TO 15 MILES PER HOUR.

8. ALL CONSTRUCTION EQUIPMENT SHALL BE MAINTAINED AND PROPERLY TUNED IN ACCORDANCE WITH MANUFACTURER'S SPECIFICATIONS. ALL EQUIPMENT SHALL BE CHECKED BY A CERTIFIED MECHANIC AND DETERMINED TO BE RUNNING IN PROPER CONDITION PRIOR TO OPERATION.

9. POST A SIGN THAT IS AT LEAST 32 SQUARE FEET MINIMUM 2 INCHES LETTER HEIGHT VISIBLE NEAR THE ENTRANCE OF CONSTRUCTION SITE THAT IDENTIFIES THE FOLLOWING REQUIREMENTS. OBTAIN ENCROACHMENT PERMIT FOR SIGN FROM ROADS DEPARTMENT OR OTHER APPLICABLE AGENCY IF REQUIRED.

- A. 15 MILES PER HOUR (MPH) SPEED LIMIT
- B. 5 MINUTES MAXIMUM IDLING TIME OF VEHICLES
  C. TELEPHONE NUMBER TO CONTACT THE BAY AREA AIR QUALITY
  MANAGEMENT DISTRICT REGARDING DUST COMPLAINTS. NOTE
  PHONE NUMBER OF THE BAY AREA AIR QUALITY MANAGEMENT
  DISTRICT AIR POLLUTION COMPLAIN HOTLINE OF 1-800-334-6367.
- 10. ALL FILL SLOPES SHALL BE COMPACTED AND LEFT IN A SMOOTH AND FIRM CONDITION CAPABLE OF WITHSTANDING WEATHERING.

11. ALL EXPOSED DISTURBED AREAS SHALL BE SEEDED WITH BROME SEED

- SPREAD AT THE RATE OF 5 LB. PER 1000 SQUARE FEET (OR APPROVED EQUAL). SEEDING AND WATERING SHALL BE MAINTAINED AS REQUIRED TO ENSURE GROWTH.
- 12. ALL DITCHES SHALL BE LINED PER COUNTY STANDARD SD8.
- 13. ALL STORM DRAINAGE STRUCTURES SHALL BE INSTALLED WITH EFFECTIVE ENTRANCE & OUTFALL EROSION CONTROLS E.G. SACKED CONCRETE RIP—RAP. ENERGY DISSIPATERS SHALL BE INSTALLED AT ALL DITCH OUTFALLS. WHERE OUTFALLS ARE NOT INTO AN EXISTING CREEK OR WATER COURSE, RUNOFF SHALL BE RELEASED TO SHEET FLOW.
- 14. THIS PLAN AUTHORIZES THE REMOVAL OF ONLY THOSE TREES WITH TRUNK DIAMETERS GREATER THAN 12 INCHES MEASURED 4.5 FEET ABOVE THE GROUND WHICH ARE SHOWN TO BE REMOVED. ANY OTHER SUCH TREES ARE NOT TO BE REMOVED UNLESS AMENDED PLAN IS APPROVED OR A SEPARATE TREE REMOVAL PERMIT IS OBTAINED FROM THE PLANNING OFFICE. IT IS THE CONTRACTOR'S RESPONSIBILITY TO ENSURE THAT THE REMOVAL OF ADDITIONAL TREES HAS BEEN PERMITTED.
- 15. PRIOR TO GRADING COMPLETION AND RELEASE OF THE BOND, ALL GRADED AREAS SHALL BE RESEEDED IN CONFORMANCE WITH THE COUNTY GRADING ORDINANCE TO MINIMIZE THE VISUAL IMPACTS OF THE GRADE SLOPES AND REDUCE THE POTENTIAL FOR EROSION OF THE SUBJECT
- 16. PERMANENT LANDSCAPING SHOWN ON THE ATTACHED LANDSCAPE PLAN MUST BE INSTALLED AND FIELD APPROVED BY THE COUNTY PLANNING OFFICE PRIOR TO FINAL APPROVAL BY THE COUNTY ENGINEER, AND FINAL OCCUPANCY RELEASE BY THE BUILDING INSPECTION OFFICE.
- 17. THE OWNER SHALL PREPARE AND PRESENT A WINTERIZATION REPORT TO THE COUNTY INSPECTOR FOR REVIEW PRIOR TO OCTOBER 15TH OF EVERY

### ACCESS ROADS AND DRIVEWAYS

- 1. DRIVEWAY LOCATIONS SHALL BE AS SHOWN ON THE IMPROVEMENT PLANS WITH CENTERLINE STATIONING. THE MINIMUM CONCRETE THICKNESS SHALL BE 6 INCHES THROUGHOUT (WITH A MAXIMUM APPROACH SLOPE OF 1 1/4 INCHES PER FOOT).
- 2. ALL DRIVEWAY OR COMMON ACCESS ROAD SECTIONS IN EXCESS OF 15%% LONGITUDINAL SLOPE MUST BE PAVED WITH A MINIMUM 2-INCH ASPHALT LIFT OR FULL DEPTH CONCRETE LIFT PRIOR TO ANY COMBUSTIBLE FRAMING
- 3. ROADWAYS DESIGNATED AS NOT COUNTY MAINTAINED ROADS AS SHOWN ON THE PLAN WILL NOT BE ELIGIBLE FOR COUNTY MAINTENANCE UNTIL THE ROADWAYS ARE IMPROVED (AT NO COST TO THE COUNTY) TO THE PUBLIC MAINTENANCE ROAD STANDARDS APPROVED BY THE BOARD OF SUPERVISORS AND IN EFFECT AT SUCH TIME THAT THE ROADWAYS ARE CONSIDERED FOR ACCEPTANCE INTO THE COUNTY'S ROAD SYSTEM.

### <u>RETAINING WALLS</u>

- 1. REINFORCED CONCRETE AND CONCRETE MASONRY UNIT RETAINING WALLS
  SHALL HAVE FOUNDATION AND REINFORCEMENT INSPECTED BY THE COUNTY
  ENGINEERING INSPECTOR AND ENGINEER OF RECORD PRIOR TO POURING THE 2.
  FOUNDATION AND FORMING THE WALL.
- 2. SEGMENTAL BLOCK RETAINING WALLS SHALL HAVE FOUNDATION AND REINFORCEMENT INSPECTED BY THE COUNTY ENGINEERING INSPECTOR.

### STREET LIGHTING

1. PACIFIC GAS & ELECTRIC ELECTROLIER SERVICE FEE SHALL BE PAID BY THE DEVELOPER AND/OR HIS AUTHORIZED REPRESENTATIVE.

### STORM DRAINAGE

1. DEVELOPER IS RESPONSIBLE FOR ALL NECESSARY DRAINAGE FACILITIES WHETHER SHOWN ON THE PLANS OR NOT AND HE OR HIS SUCCESSOR PROPERTY OWNERS ARE RESPONSIBLE FOR THE ADEQUACY AND CONTINUED MAINTENANCE OF THESE FACILITIES IN A MANNER WHICH WILL PRECLUDE ANY HAZARD TO LIFE, HEALTH, OR DAMAGE TO ADJOINING PROPERTY.

2. DROP INLETS SHALL BE COUNTY STANDARD TYPE 5 UNLESS OTHERWISE

NOTED ON THE PLANS. THE DEVELOPER'S ENGINEER SHALL BE RESPONSIBLE FOR THE PROPER LOCATION OF DROP INLETS. WHERE STREET PROFILE GRADE EXCEEDS 6%% DROP INLETS SHALL BE SET AT 500 ANGLE CURB LINE TO ACCEPT WATER OR AS SHOWN ON THE PLANS.

WHERE CULVERTS ARE INSTALLED THE DEVELOPER SHALL BE RESPONSIBLE

- FOR GRADING THE OUTLET DITCH TO DRAIN TO AN EXISTING SWALE OR TO AN OPEN AREA FOR SHEET FLOW.
- 4. UPON INSTALLATION OF DRIVEWAY CONNECTIONS, PROPERTY OWNERS SHALL PROVIDE FOR THE UNINTERRUPTED FLOW OF WATER IN ROADSIDE DITCHES.
- 5. THE COUNTY ENGINEERING INSPECTOR SHALL INSPECT UNDERGROUND DRAINAGE IMPROVEMENTS PRIOR TO BACKFILL.

### SANITARY SEWER

1. ALL MATERIALS AND METHODS OF CONSTRUCTION OF SANITARY SEWERS SHALL CONFORM TO THE SPECIFICATIONS OF THE JURISDICTION INVOLVED. INSPECTION OF SANITARY SEWER WORK SHALL BE DONE BY SAID JURISDICTION.

### PORTLAND CEMENT CONCRETE

1. CONCRETE USED FOR STRUCTURAL PURPOSES SHALL BE CLASS "A" (6 SACK PER CUBIC YARD) AS SPECIFIED IN THE STATE STANDARD SPECIFICATIONS. CONCRETE PLACED MUST DEVELOP A MINIMUM STRENGTH FACTOR OF 2800 PSI IN A SEVEN-DAY PERIOD. THE CONCRETE MIX DESIGN SHALL BE UNDER THE CONTINUAL CONTROL OF THE COUNTY INSPECTOR.

### AS-BUILT PLANS STATEMENT

THIS IS A TRUE COPY OF THE AS-BUILT PLANS.

THERE (\_\_\_\_ WERE) (\_\_\_ WERE NOT) MINOR FIELD CHANGES - MARKED
WITH THE SYMBOL (^).

THERE (\_\_\_ WERE) (\_\_\_ WERE NOT) PLAN REVISIONS INDICATING
SIGNIFICANT CHANGES REVIEWED BY THE COUNTY ENGINEER AND MARKED
WITH THE SYMBOL .

DATE \_\_\_\_\_\_ SIGNATURE \_\_\_\_\_

NOTE: THIS STATEMENT IS TO BE SIGNED BY THE PERSON AUTHORIZED BY THE COUNTY
ENGINEER TO PERFORM THE INSPECTION WORK. A REPRODUCIBLE COPY OF THE AS-BUILT
PLANS MUST BE FURNISHED TO THE COUNTY ENGINEER AFTER CONSTRUCTION.

1. A CONSTRUCTION OBSERVATION LETTER FROM THE RESPONSIBLE GEOTECHNICAL ENGINEER DETAILING CONSTRUCTION OBSERVATIONS AND CERTIFYING THAT THE WORK WAS DONE IN ACCORDANCE WITH THE RECOMMENDATIONS IN THE GEOTECHNICAL REPORTS SHALL BE SUBMITTED PRIOR TO THE GRADING COMPLETION AND RELEASE OF THE BOND.

NSTRUCTION / ENCROACHMENT / GRADING PERMIT	
RMIT(S) NO.:	
E(S) NO.:	

DATE:

LAND DEVELOPMENT ENGINEERING & SURVEYING DEVELOPMENT SERVICES OFFICE COUNTY OF SANTA CLARA

### GENERAL NOTES

ISSUED BY:

- 1. THE WATER AND SANITARY UTILITIES SHOWN ON THESE PLANS ARE NOT PART OF THIS GRADING PERMIT AND ARE SHOWN FOR REFERENCE
- 2. THE OWNER AND PRIME CONTRACTOR ARE RESPONSIBLE FOR MAINTAINING PROJECT SITE ACCESS AND NEIGHBORHOOD ACCESS FOR EMERGENCY VEHICLES AND LOCAL RESIDENTS.

  TREE PROTECTION NOTES
- 1. THE GENERAL CONTRACTOR SHALL TAKE THE FOLLOWING STEPS TO PRESERVE AND PROTECT ALL EXISTING TREES SHOWN TO REMAIN:
- A. PRIOR TO COMMENCEMENT OF DEMOLITION, GRADING AND CONSTRUCTION, TEMPORARY FENCING SHALL BE INSTALLED AT THE DRIP LINE OF EACH TREE TO BE PRESERVED. REFER TO DETAIL FENCED AREAS SHALL NOT BE VIOLATED DURING CONSTRUCTION.
- B. ALL EXISTING ON SITE TREES INDICATED TO REMAIN SHALL BE TRIMMED BY A LICENSED ARBORIST FOUR WEEKS PRIOR TO COMMENCEMENT OF DEMOLITION OF GRADING OPERATIONS. ALL BROKEN OR BRUISED BRANCHES AND DEAD WOOD SHALL BE REMOVED. ALL CUTS OVER 3/4" DIAMETER SHALL BE PAINTED WITH "TREE SEAL" OR APPROVED EQUAL. IN NO CASE SHALL ANY TREE BE TOPPED.
- C. ALL EXISTING ON SITE TREES INDICATED TO REMAINS SHALL BE FERTILIZED BY ROOT INJECTION BY A LICENSED ARBORIST FOUR WEEKS PRIOR TO COMMENCEMENT OF GRADING OR DEMOLITION
- 2. ALL EXISTING ON—SITE TREES INDICATED TO REMAIN SHALL BE PRESERVED AND PROTECTED DURING CONSTRUCTION. NO GRADING IS PERMITTED WITHIN THE DRIP—LINE OF ANY TREE INDICATED TO REMAIN NO DEBRIS OR MATERIALS SHALL BE STOCKPILED AROUND THE BASE OF THE TREES. NO TRADESMAN SHALL DUMP DEBRIS OR FLUIDS WITHIN THE DRIP—LINE OF ANY TREES (PLASTER, PAINT, THINNER, ETC.). ALL TREES SHALL BE FENCED BY THE GENERAL CONTRACTOR TO AVOID COMPACTION OF THE TREE'S ROOT SYSTEM AND DAMAGE TO THE BARK. THE FENCE SHALL BE SIX FEET HIGH, AND EXTEND OUT TO THE DRIP—LINE OF THE TREE.

OPERATIONS.

- 3. ALL EXISTING ON—SITE TREES INDICATED TO REMAIN SHALL BE WATERED BY THE GENERAL CONTRACTOR CONTINUOUSLY DURING THE COURSE OF CONSTRUCTION. IF POTABLE WATER IS NOT AVAILABLE ON THE SITE, A WATERING TRUCK SHALL BE EMPLOYED TO ACCOMPLISH THE WATERING.
- 4. DO NOT DISTURB SURFACE SOIL WITHIN TREE DRIP—LINE EXCEPT AS MANDATED BY CONSTRUCTION PLANS.
- 5. DURING PERIODS OF EXTENDED DROUGHT, SPRAY WOAK TREES TO REMOVE ACCUMULATED CONSTRUCTION.
- 6. GRADE IN LINES RADIAL TO THE EXISTING TREE RATHER THAN TANGENTIAL. IF ROOTS ARE ENCOUNTERED WHILE GRADING, CUT THEM CLEANLY WITH A SAW. <u>DO NOT RIP THEM WITH GRADING EQUIPMENT.</u>
- WHEN TREES THAT ARE TO BE PRESERVED ARE IN THE VICINITY.

  TREE REMOVAL NOTES

  1. THE LOCATION OF ALL SERVICE RUNS SUCH AS WATER SUPPLY,
  SEWER, ELECTRICITY, TELEPHONES, CABLE, GAS, STORM DRAIN LINE

7. DO NOT ATTEMPT DEMOLITION OF TREES WITH GRADING EQUIPMENT

- SEWER, ELECTRICITY, TELEPHONES, CABLE, GAS, STORM DRAIN LINES, ETC. SHALL BE ASCERTAINED BEFORE TREE REMOVAL WORK IS STARTED. WHERE SUCH LINES WILL BE AFFECTED BY TREE REMOVAL, OR WHERE TREE REMOVAL MACHINERY WILL BE WORKING NEARBY, LINES SHOULD BE CAREFULLY SEALED OFF, PROTECTED OR DIVERTED. IT IS THE CONTRACTOR'S RESPONSIBILITY TO TAKE NECESSARY PRECAUTIONARY ACTIONS.
- 2. REMOVE ONLY THOSE TREES INDICATED ON THIS PLAN TO BE REMOVED. TREES INDICATED TO BE REMOVED SHALL HAVE ALL ROOTS AND STUMP REMOVED TO A DEPTH OF 24" BELOW GRADE.

### STANFORD UNIVERSITY

Project Name: Covered Tennis Courts Project Address: 638 Campus Drive, Stanford CA. 94305 Quad/ Bldg. Number: 08-025





DESCRIPTION

03.01.2023 ASA SUBMITTAL

NO. DATE

ISSUES AND REVISIONS

PROJECT NUMBER

SHEET TITLE

**CONSTRUCTION NOTES** 

SCALE

SHEET NUMBER

C-1 1



### FIRE SAFETY NOTES:

PLAN SUBMITTAL REQUIREMENTS:
FIRE ALARMS AND DETECTION SYSTEMS
ATTACHMENT A
CODE, STANDARDS & GUIDES
LIST OF 2022 CALIFORNIA CODE OF REGULATIONS

TO OF 2022 CALIFORNIA CODE OF REGULATION

APPLICABLE CODES AS OF JANUARY 1, 2023:
2022 CALIFORNIA BUILDING STANDARDS ADMINISTRATIVE CODE (PART 1, TITLE 24, CCR)

2022 CALIFORNIA BUILDING CODE, VOLUMES 1, 2 AND 3 (PART 2, TITLE 24, CCR) (BASED ON THE 2012 INTERNATIONAL BUILDING CODE)

2022 CALIFORNIA ELECTRICAL CODE (PART 3, TITLE 24, CCR) (BASED ON 2011 NATIONAL ELECTRICAL CODE)

2022 CALIFORNIA MECHANICAL CODE (PART 4, TITLE 24, CCR)

(BASED ON THE 2012 UNIFORM MECHANICAL CODE)

2022 CALIFORNIA PLUMBING CODE (PART 5, TITLE 24, CCR)

(BASED ON THE 2012 UNIFORM PLUMBING CODE)

2022 CALIFORNIA ENERGY CODE (PART 6, TITLE 24, CCR)

2022 CALIFORNIA ELEVATOR SAFETY CONSTRUCTION CODE (PART 7, TITLE 24, CCR)

2022 CALIFORNIA FIRE CODE (PART 9, TITLE 24, CCR) (BASED ON THE 2012 INTERNATIONAL FIRE CODE)

2022 CALIFORNIA REFERENCED STANDARDS CODE (PART 12, TITLE 24, CCR)

TITLE 19 C.C.R., PUBLIC SAFETY, STATE FIRE MARSHAL REGULATIONS

### PARTIAL LIST OF APPLICABLE STANDARDS:

NFPA 13 - SPRINKLER SYSTEMS - 2022 EDITION

NFPA 14 - STANDPIPES AND HOSE SYSTEMS - 2022 EDITION

NFPA 17A — WET CHEMICAL EXTINGUISHING SYSTEMS — 2022 EDITION

NFPA 24 - PRIVATE FIRE SERVICE MAINS AND THEIR APPURTENANCES - 2022 EDITION

NFPA 72 - NATIONAL FIRE ALARM AND SIGNALING CODE - 2022 EDITION

NFPA 253 — CRITICAL RADIANT FLUX OF FLOOR COVERING SYSTEMS USING A RADIANT HEAT ENERGY SOURCE — 2022 EDITION.

### UNDERGROUND FIRE SERVICE TO FIRE HYDRANTS REQUIREMENTS:

NFPA 24 CHAPTER 10.1.3: WHERE EXTERNALLY COATED AND WRAPPED AND INTERNALLY GALVANIZED, STEEL PIPE SHALL BE PERMITTED TO BE USED BETWEEN THE CHECK VALVE AND THE OUTSIDE BASE COUPLING FOR THE FIRE DEPARTMENT CONNECTION.

NFPA 24 CHAPTER 10.1.6.1: UNLESS THE REQUIREMENTS OF 10.1.6.2 ARE MET, ALL FERROUS METAL PIPE SHALL BE LINED IN ACCORDANCE WITH THE APPLICABLE STANDARDS IN TABLE 10.1.1.

NFPA 24 CHAPTER 10.1.6.2: STEEL PIPE UTILIZED IN FIRE DEPARTMENT CONNECTIONS AND PROTECTED IN ACCORDANCE WITH THE REQUIREMENTS OF 10.1.3 SHALL NOT BE ADDITIONALLY REQUIRED TO BE LINED.

NFPA 24 CHAPTER 10.3.5.2: ALL BOLTED JOINT ACCESSORIES SHALL B E CLEANED AND THOROUGHLY COATED WITH ASPHALT OR OTHER CORROSION RETARDING MATERIAL AFTER INSTALLATION.

NFPA 24 CHAPTER 10.8.3.5: AFTER INSTALLATION, RODS, NUTS, BOLTS, WASHERS, CLAMPS, AND OTHER RESTRAINING DEVICES, EXCEPT THRUST BLOCKS, SHALL BE CLEANED AND THOROUGHLY COATED WITH BITUMINOUS OR OTHER ACCEPTABLE CORROSION—RETARDING MATERIAL.

NFPA 24 CHAPTER 10.8.2.2: THRUST BLOCKS SHALL BE OF A CONCRETE MIX NOT LEANER THAN ONE PART CEMENT, TWO AND ONE HALF PARTS SAND, AND FIVE PARTS STONE.

NFPA 24 CHAPTER 10.8.2.3: THRUST BLOCKS SHALL BE PLACED BETWEEN UNDISTURBED EARTH AND THE FITTING TO BE RESTRAINED, AND SHALL BE OF SUCH BEARING AS TO ENSURE ADEQUATE RESISTANCE TO THE THRUST TO BE ENCOUNTERED.

NFPA 24 CHAPTER 10.8.2.4: IN GENERAL THRUST BLOCKS SHALL BE SO PLACED THAT THE JOINTS WILL BE ACCESSIBLE FOR INSPECTION AND REPAIR.

NFPA 24 CHAPTER 10.10.2.1.1: UNDERGROUND PIPING, FROM THE WATER SUPPLY TO THE SYSTEM RISER, AND LEAD—IN CONNECTIONS TO THE SYSTEM RISER SHALL BE COMPLETELY FLUSHED BEFORE THE CONNECTION IS MADE TO DOWNSTREAM FIRE PROTECTION SYSTEM PIPING.

NFPA 24 CHAPTER 10.10.2.1.3: THE MINIMUM RATE OF FLOW SHALL BE NO LESS THAN ONE OF THE FOLLOWING:

- (1) HYDRAULICALLY CALCULATED WATER DEMAND FLOW RATE OF THE SYSTEM, INCLUDING ANY HOSE REQUIREMENTS.
- REQUIREMENTS.
  (2) FLOW NECESSARY TO PROVIDE A VELOCITY OF 10 FT/SEC (3.1 M/SEC) IN ACCORDANCE WI
- (2) FLOW NECESSARY TO PROVIDE A VELOCITY OF 10 FT/SEC (3.1 M/SEC) IN ACCORDANCE WITH TABLE 10.10.2.1.3.

(3) MAXIMUM FLOW RATE AVAILABLE TO THE SYSTEM UNDER THE CONDITIONS.

NFPA 24 CHAPTER 10.10.2.2.1\*: ALL PIPING AND ATTACHED APPURTENANCES SUBJECTED TO SYSTEM WORKING PRESSURE SHALL BE HYDROSTATICALLY TESTED AT 200 PSI (13.8 BAR) OR 50 PSI (3.5 BAR) IN EXCESS OF THE SYSTEM WORKING PRESSURE, WHICHEVER IS GREATER, AND SHALL MAINTAIN THAT PRESSURE AT + 5 PSI (0.35 BAR) FOR 2 HOURS.

NFPA 24 CHAPTER 10.10.1: THE INSTALLING CONTRACTOR SHALL BE RESPONSIBLE FOR THE FOLLOWING:

- (1) NOTIFYING THE AUTHORITY HAVING JURISDICTION AND THE OWNER'S REPRESENTATIVE OF THE TIME AND DATE TESTING IS TO BE PERFORMED.
- (2) PERFORMING ALL REQUIRED ACCEPTANCE TESTS.
- (3) COMPLETING AND SIGNING THE CONTRACTOR'S MATERIAL AND TEST CERTIFICATE(S) SHOWN IN FIGURE 10.10.1.

CHAPTER 10.4.3: IN THOSE LOCATIONS WHERE FROST IS NOT A FACTOR, THE DEPTH OF COVER SHALL NOT BE LESS THAN 2 ½ FEET (0.8 M) TO PREVENT MECHANICAL DAMAGE.

NFPA 24 CHAPTER 10.4.4: PIPE UNDER DRIVEWAYS SHALL BE BURIED AT A MINIMUM DEPTH OF 3 FT (0.9M).

NFPA 24 CHAPTER 10.6.1: PIPE SHALL NOT BE RUN UNDER BUILDINGS.

### STANFORD UNIVERSITY

Project Name: Covered Tennis Courts Project Address: 638 Campus Drive, Stanford CA. 94305 Quad/ Bldg. Number: 08-025





ISSUES AND REVISIONS

NO. DATE DESCRIPTION 03.01.2023 ASA SUBMITTAL

PROJECT NUMBER


SHEET TITLE

FIRE SAFETY NOTES

SCALE

SHEET NUMBER

C-1.2

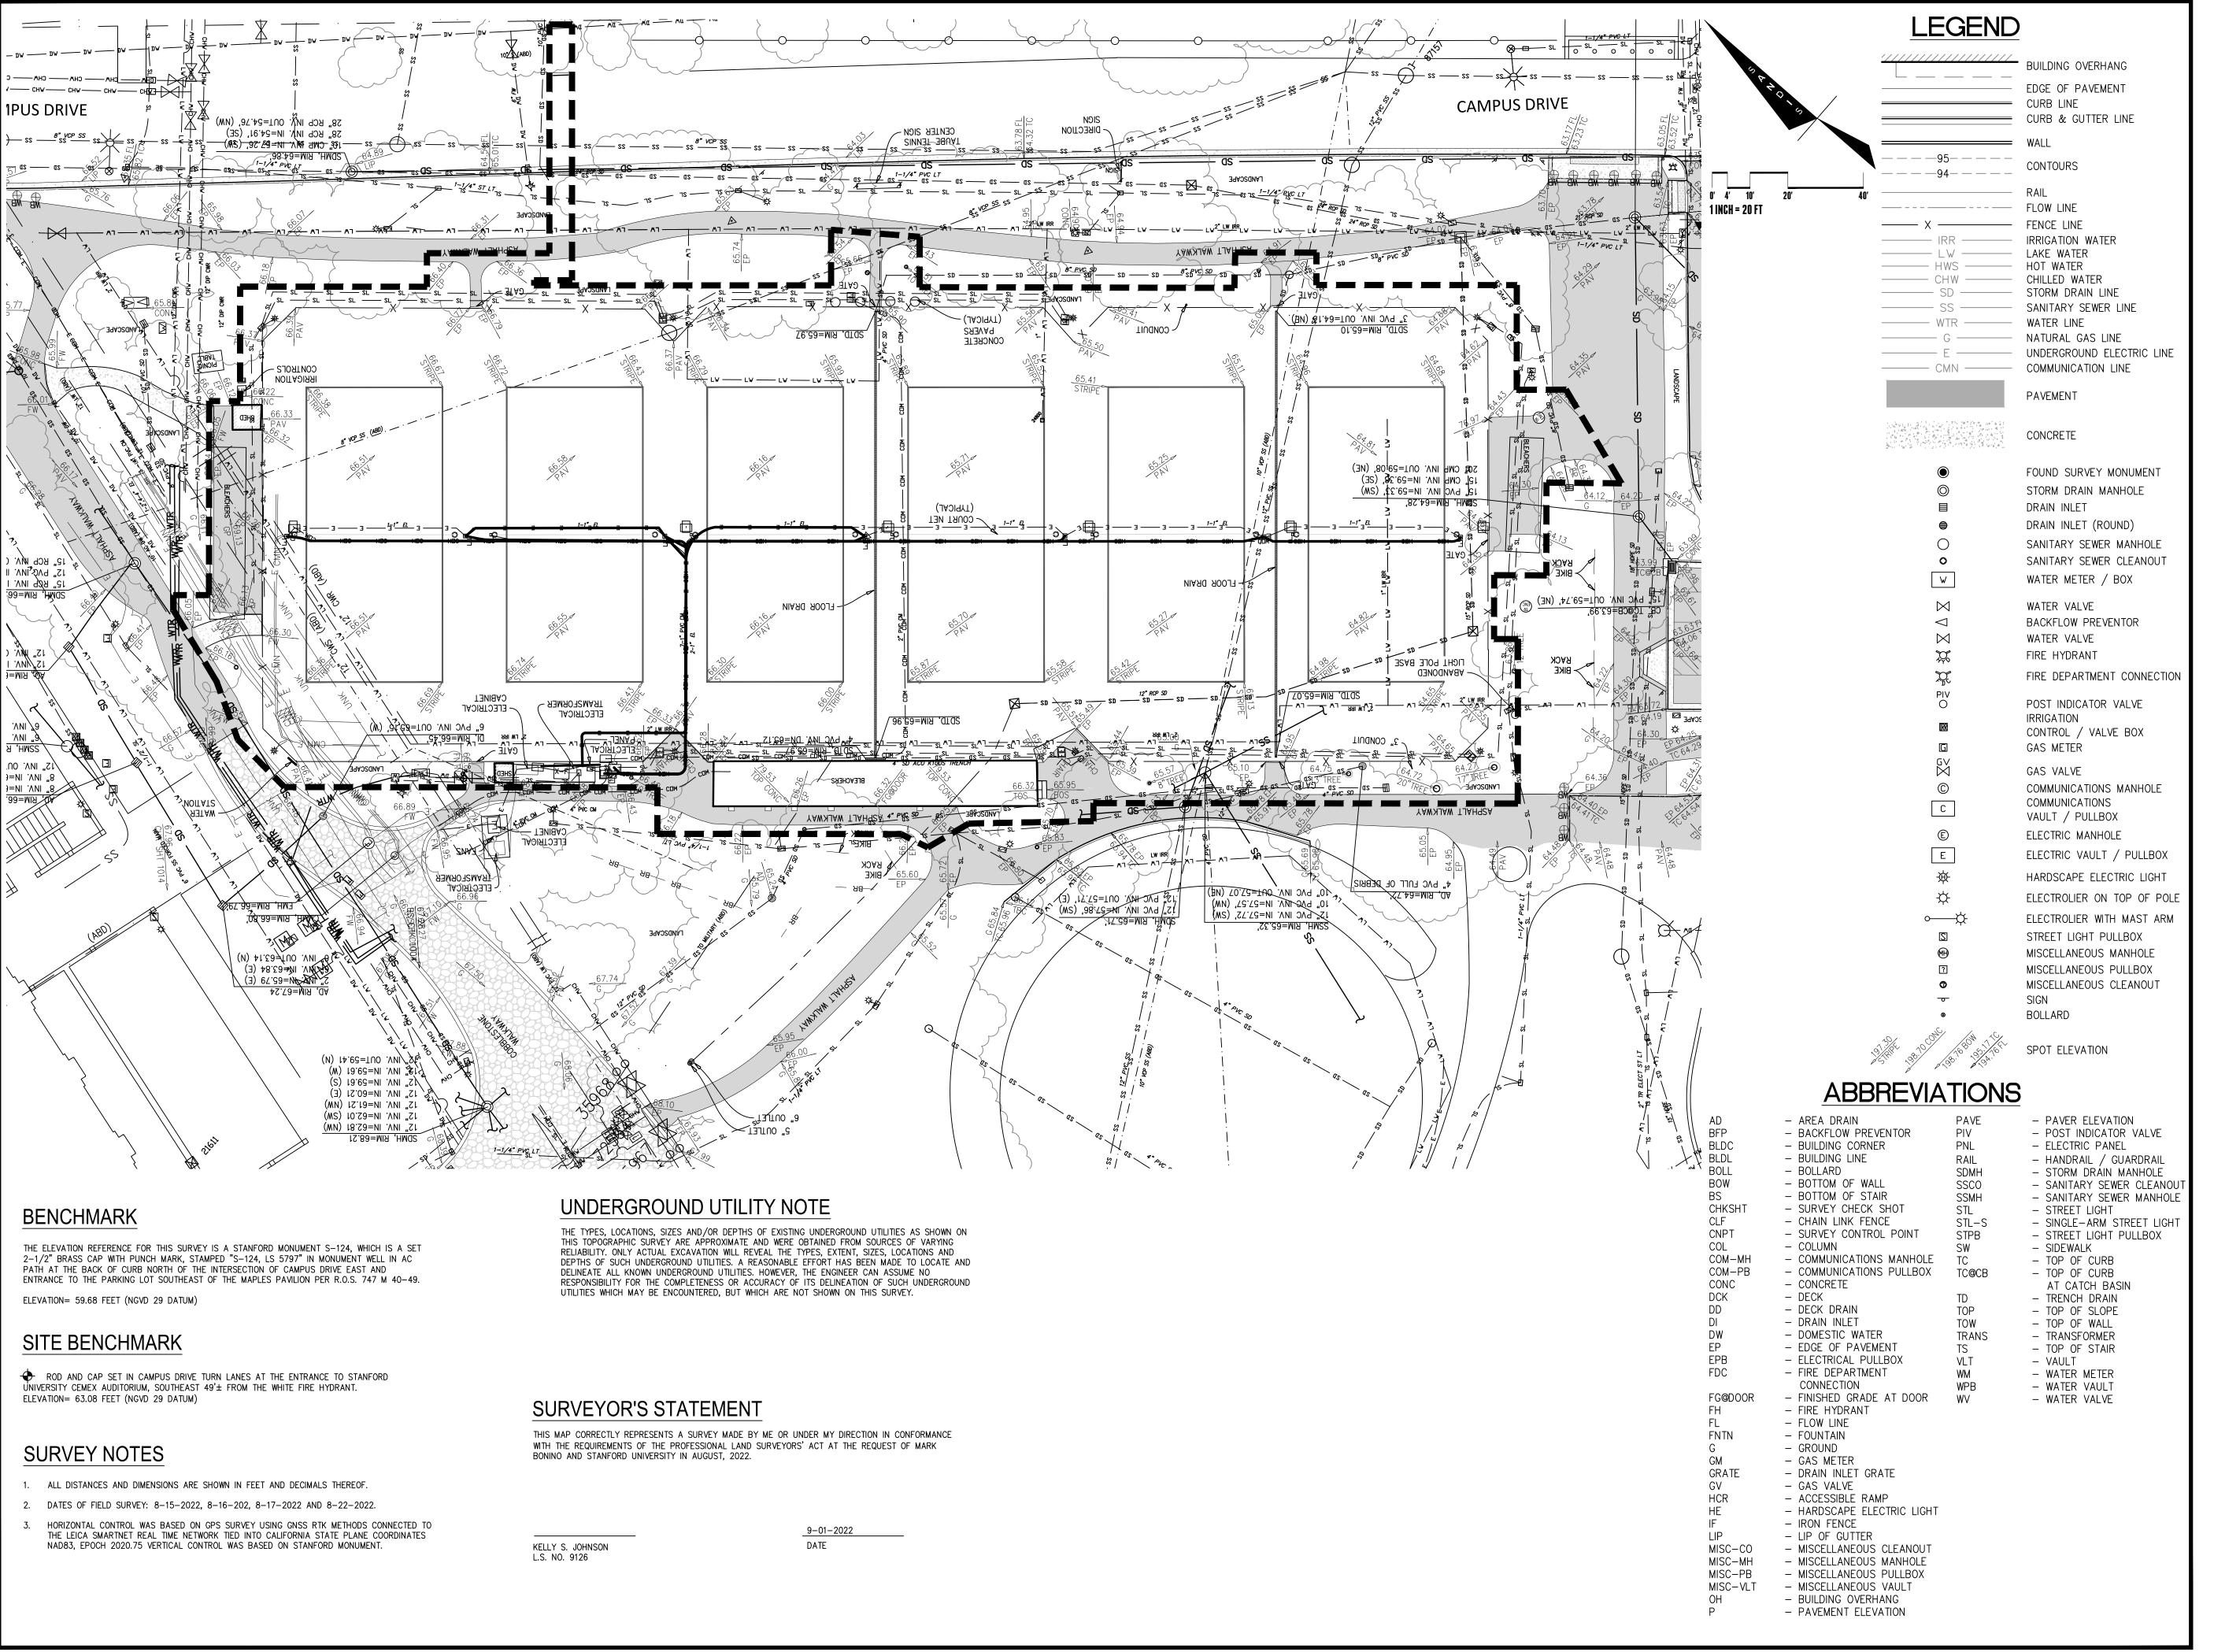

Project Name: Covered Tennis Courts Project Address: 638 Campus Drive, Stanford CA. 94305 Quad/ Bldg. Number: 08-025





ISSUES AND REVISIONS

NO. DATE DESCRIPTION ASA SUBMITTAL

PROJECT NUMBER

SHEET TITLE


TOPOGRAPHIC SURVEY

SCALE

1"=30'

SHEET NUMBER

C-2.0

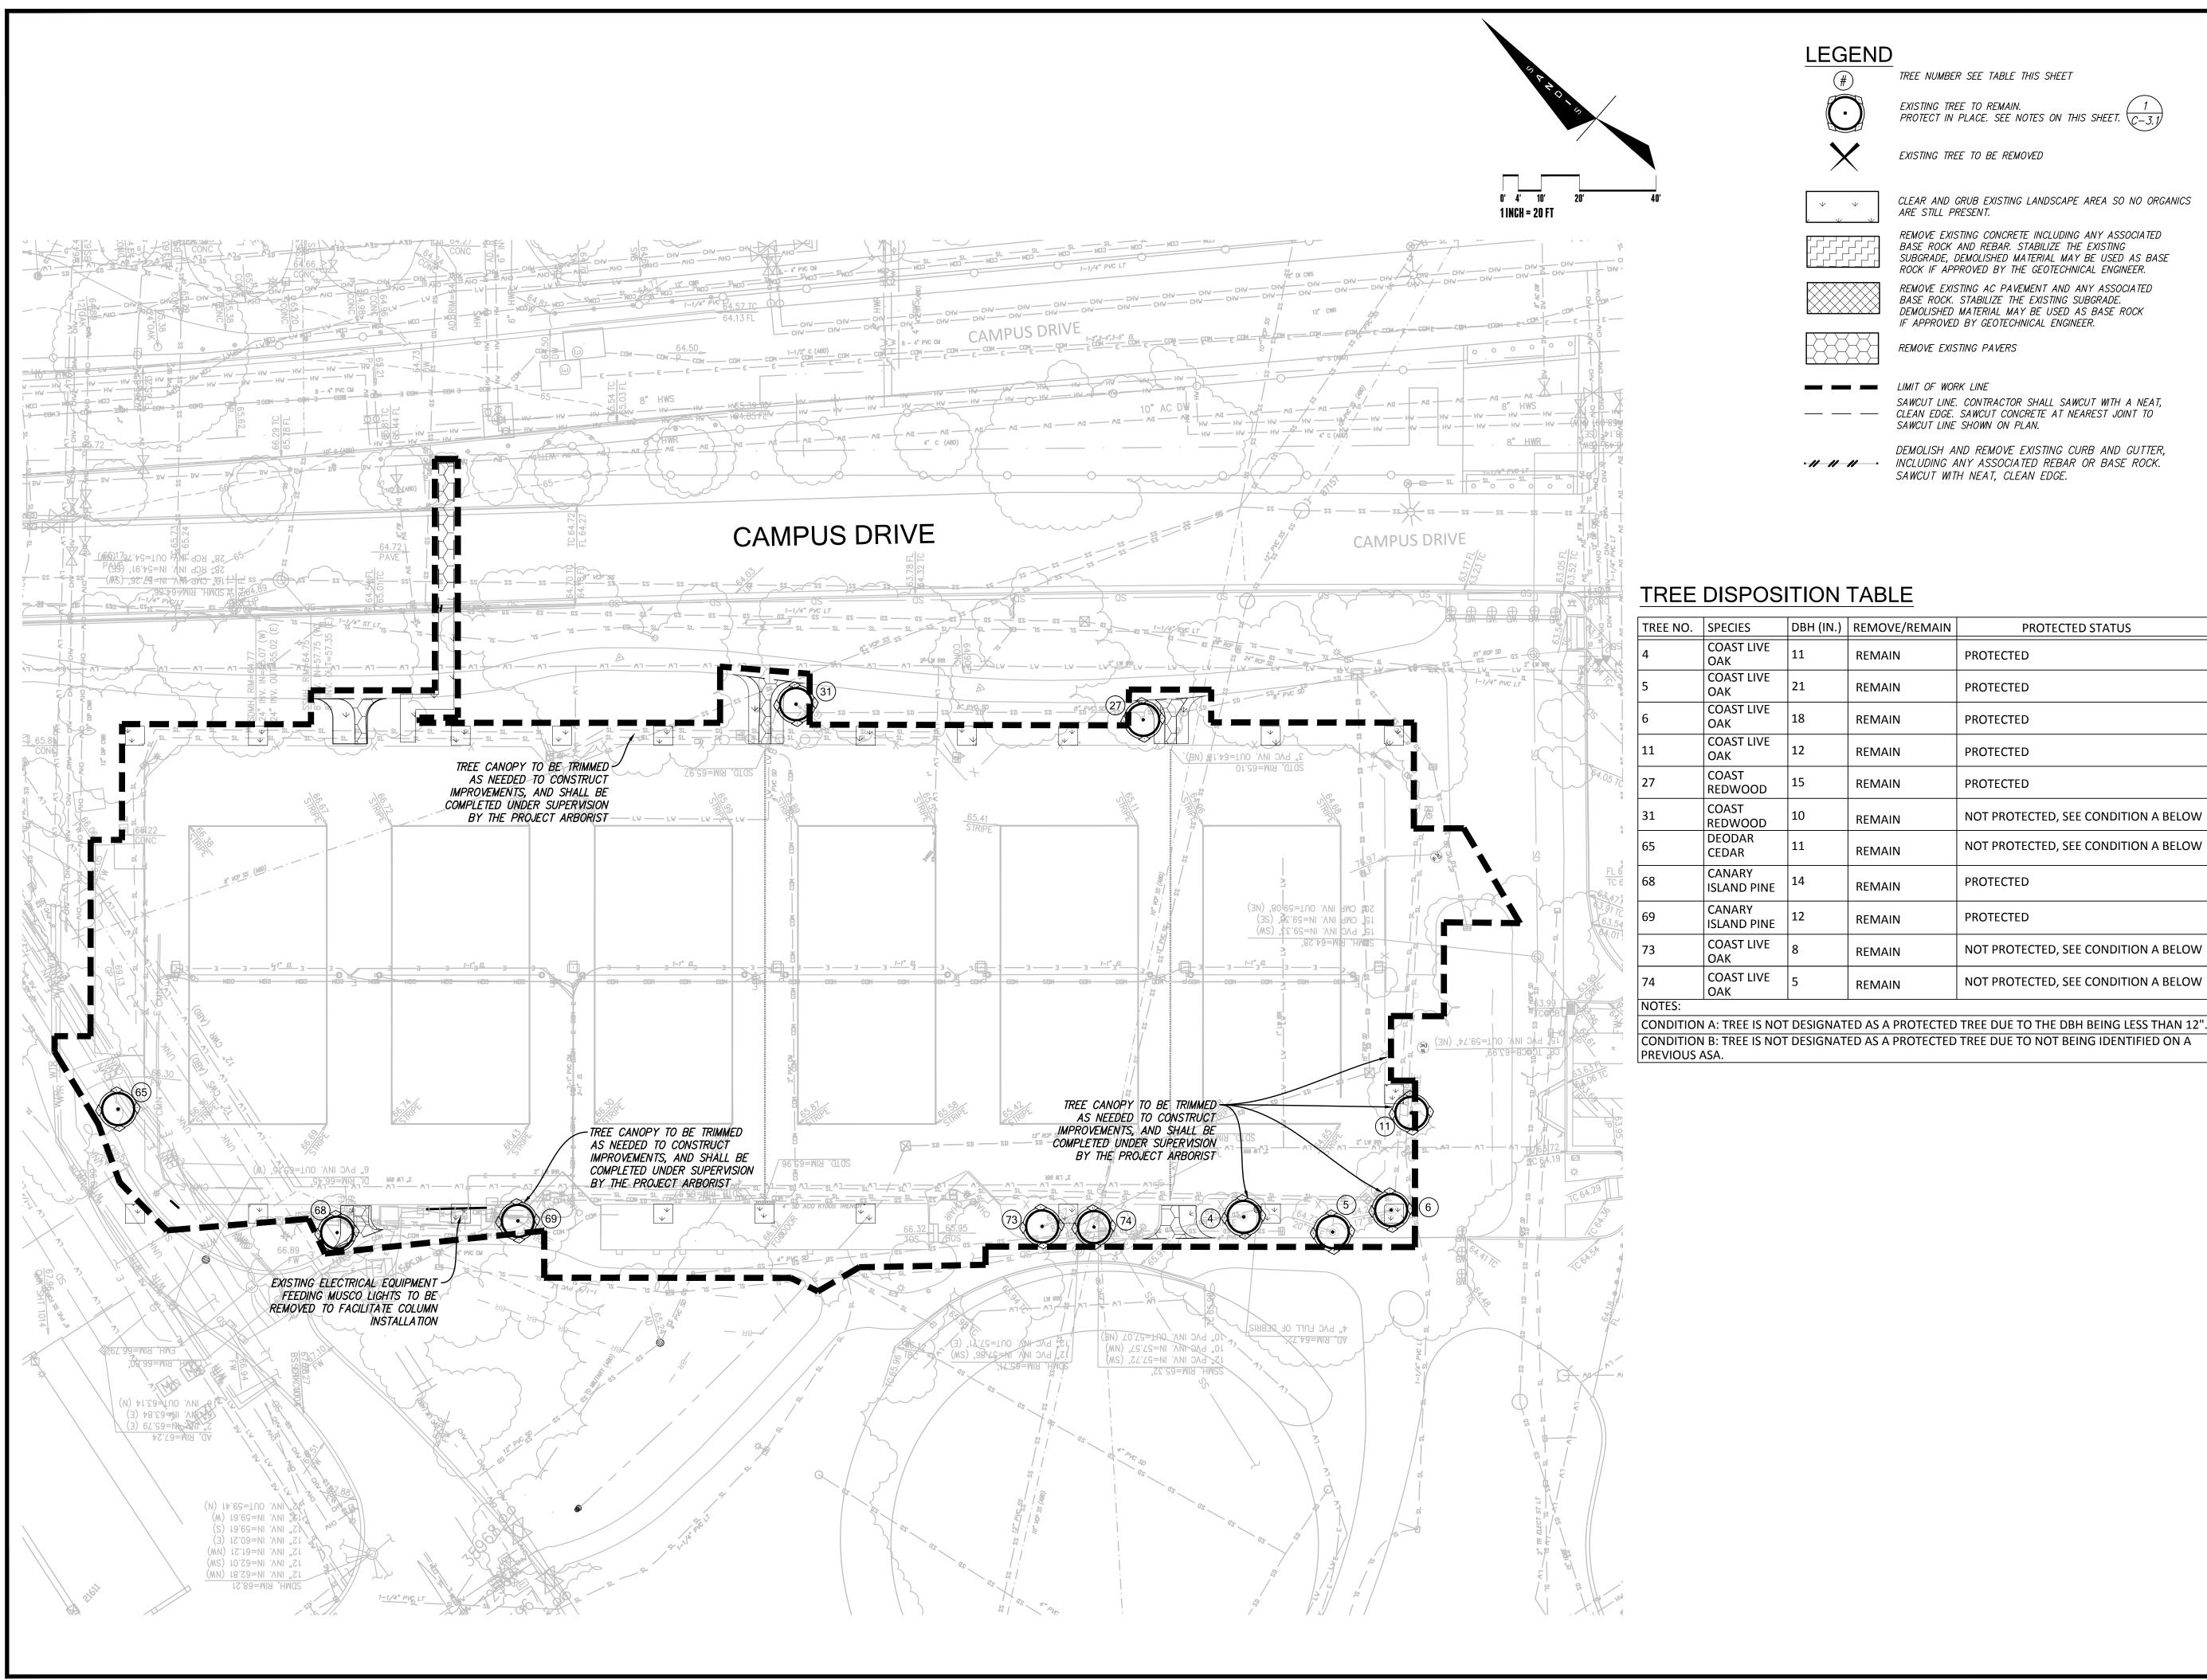

Project Name: Covered Tennis Courts Project Address: 638 Campus Drive, Stanford CA. 94305 Quad/ Bldg. Number: 08-025





ISSUES AND REVISIONS

DATE DESCRIPTION
03.01.2023 ASA SUBMITTAL

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SHEET TITLE

DEMOLITION/TREE REMOVAL PLAN

SCALE

AS NOTED


SHEET NUMBER

C-3.0

### STANFORD UNIVERSITY TREE PROTECTION PROCEDURES SUMMARY

- 1. WE HAVE STRICT REQUIREMENTS WHICH INCLUDE THE POINTS LISTED BELOW AND ADDITIONAL PROCEDURES AS DETAILED IN THE FDG SPECIFICATIONS GUIDELINE 01 56 39 TREE AND PLANT PROTECTION.
- 2. THE ROOT ZONE OF ALL TREES MUST BE PROTECTED ON ALL CONSTRUCTION PROJECTS, AS DESCRIBED BELOW. A TREE'S ROOT ZONE IS DEFINED AS LISTED IN DEFINITIONS 1.3B.
- 3. A STANFORD GROUNDS CERTIFIED ARBORIST SHALL BE CONTACTED TO EVALUATE ALL WORK WITHIN ANY TREES ROOT ZONES.
- 4. ALL TREES TO REMAIN ON A PROJECT SHALL HAVE PROTECTIVE FENCING INSTALLED PER THE TREE PROTECTION DRAWING INCLUDED IN THE PLAN SET.
- 5. PROTECTIVE FENCING SHALL BE CHAIN LINK ON SECURE FOOTINGS, OR IMBEDDED AS REQUIRED BY THE CAMPUS PLANNING AND DESIGN OFFICE OR A STANFORD GROUNDS CERTIFIED ARBORIST, THAT WILL NOT
- 6. PROTECTIVE FENCING SHALL BE PLACED AT THE OUTER EDGE OF THE ROOT ZONE, AS PER TREE PROTECTION PLAN 1.7.A.3, AND WHEREVER POSSIBLE AS SHOWN ON THE TREE PROTECTION DRAWING. IF PROJECT CONSTRAINTS DO NOT ALLOW FOR FENCING AT THE OUTER EDGE OF THE ROOT ZONE, FENCING MUST BE PLACED AS CLOSE TO THIS AS POSSIBLE AND APPROVED AFTER IT IS IN PLACE BY A STANFORD UNIVERSITY GROUNDS CERTIFIED ARBORIST.
- 7. LAYDOWN, STAGING AND PARKING AREAS SHALL BE APPROVED BY THE STANFORD UNIVERSITY
  ARCHITECT/CAMPUS PLANNING DEPARTMENT AND SHALL BE SHOWN ON THE PLANS IF WITHIN THE PROJECT
  LIMIT AREA, OR ON THE CONSTRUCTION LOGISTICS PLAN IF OUTSIDE THE PROJECT LIMIT AREA. ALL TREE
  PROTECTION GUIDELINES APPLY TO TREES IN LAYDOWN, STAGING AND PARKING AREAS AS WELL AS TO
  TREES WITHIN THE PROJECT LIMITS.
- 8. CONSTRUCTION MATERIALS/EQUIPMENT/PERSONAL VEHICLES SHALL NOT BE STORED, PARKED OR TEMPORARILY PLACED IN THE ROOT ZONE OF ANY TREES. NOTHING SHALL BE STORED OR PLACED TEMPORARILY WITHIN PROTECTIVE FENCING, TO AVOID SOIL COMPACTION AND SOIL CONTAMINATION UNDER TREES. ROOT ZONES OF TREES SHALL NOT BE DRIVEN OVER. PROVIDE ALTERNATIVE ROUTES FOR CONSTRUCTION TRAFFIC OF ANY KIND INCLUDING CARS, PEOPLE, TRACTORS, EQUIPMENT, CRANES, OR ANY OTHER TRAFFIC AND ALL STAGING OR STORAGE AREAS.
- 9. PROTECT OVERHANGING TREE CANOPIES FROM CONSTRUCTION DAMAGE. IF DRIVE AISLES ARE ANTICIPATED UNDER LOW CANOPIES CALL FOR AN EVALUATION BY A STANFORD GROUNDS CERTIFIED ARBORIST TO DETERMINE APPROPRIATE MEASURES.
- 10. THERE SHALL BE NO GRADE CHANGE WITHIN A MINIMUM OF TEN FEET OF THE TRUNK OF EXISTING TREES, AND PREFERABLY NONE WITHIN THE ENTIRE ROOT ZONE. NATIVE OAKS ARE PARTICULARLY SENSITIVE TO GRADE CHANGES.
- 11. NO RINSING, CLEANING EQUIPMENT OR DUMPING CONSTRUCTION LIQUID MATERIALS SHALL BE ALLOWED IN THE TREE ROOT ZONE, OR IN AN AREA THAT DRAINS INTO THE ROOT ZONE. CARE SHALL BE TAKEN IN CLEANING UP EQUIPMENT. THERE SHALL BE NO STORAGE OF DUMPSTERS OR ACCUMULATED DEBRIS FROM DEMOLITION ON OR AROUND THE ROOT ZONES OF EXISTING TREES AND SHRUBS.
- 12. EXISTING TREES SHALL BE MONITORED WEEKLY AND IRRIGATED AS NEEDED DURING THE COURSE OF CONSTRUCTION.
- 13. NO LIME OR OTHER SOIL TREATMENT SHALL BE APPLIED WITHOUT THE CONSENT OF A STANFORD GROUNDS CERTIFIED ARBORIST.
- 14. ALL TRENCHING SHALL CONFORM TO THE FOLLOWING GUIDELINES.
- A. STANFORD GROUNDS CERTIFIED ARBORIST IS REQUIRED TO BE PRESENT TO SUPERVISE ANY TRENCHING, DIGGING OR EXCAVATION OF ANY KIND WITHIN A TREES' ROOT ZONE.
- B. ROOTS LARGER THAN 2 INCHES IN DIAMETER SHALL NOT BE SEVERED WITHOUT CALLING A STANFORD GROUNDS CERTIFIED ARBORIST FOR CUTTING OR REVIEW.
- C. TUNNELING OR BORING UNDER ROOTS RATHER THAN PRUNING IS PREFERRED.
- D. DIGGING WITHIN A TREE'S ROOT ZONE SHALL BE AVOIDED. IF IT IS NECESSARY, HAND DIGGING SHALL BE USED FOR ANY TRENCHING WITHIN THE TREE'S ROOT ZONE UNLESS OTHERWISE APPROVED BY A STANFORD GROUNDS CERTIFIED ARBORIST.
  - E. ALL ROOTS THAT NEED TO BE CUT SHALL BE PERPENDICULAR PRUNED CLEANLY, NOT TORN.

THE PRECEDING GUIDELINES SHALL BE CONSIDERED MINIMUM REQUIREMENTS. THE GREATER THE DISTANCE OF TREE PROTECTION PROVIDED THE GREATER THE INSTANCE OF TREE SUCCESS IN CONSTRUCTION AREAS.

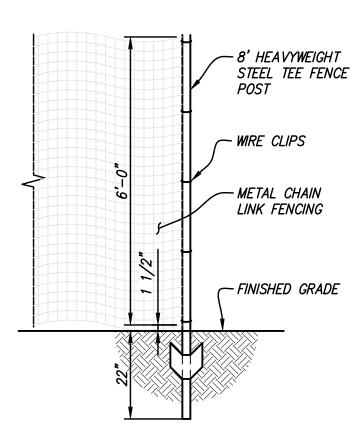

### <u>NOTES:</u>

- 1. THE DRIPLINE OF EACH TREE TO BE PROTECTED SHALL BE ENCLOSED WITH A 6' HIGH TEMPORARY FENCE. FENCE FABRIC SHALL BE HEAVY DUTY PERFORATATED, BRIGHT COLORED, PLASTIC MESH. FENCE STAKES SHALL BE 8' HEAVY WEIGHT STEEL TEE FENCE POSTS DRIVEN 22" INTO GRADE.
- 2. METAL CHAIN LINK FENCING ON SECURE FOOTINGS IMBEDDED WHERE REQUIRED BY CAMPUS PLANNING AND DESIGN OFFICE OR SGCA SHALL BE USED AT ALL TIMES TO PROTECT TREES EXCEPT IN AREAS WHERE IT WILL NOT PHYSICALLY FIT. ONLY IN AREAS WHERE IT CANNOT PHYSICALLY BE PLACED, WILL ORANGE PLASTIC SNOW FENCING WRAPPED 2" THICK AROUND THE TRUNK BE ALLOWED, AND ONLY AS APPROVED BY AN SGCA.

TREE PROTECTION DETAIL 1

### SHEET NOTES

- 1. REMOVAL, PROTECTION, AND RELOCATION OF ELECTRICAL UTILITIES AND WATER LINES ARE SHOWN FOR REFERENCE ONLY AND ARE NOT COVERED BY THE GRADING PERMIT.
- 2. COORDINATE DEMOLITION WORK WITH STANFORD UNIVERSITY'S; ADHERE TO ALL THEIR REQUIREMENTS.
- 3. DEMOLITION AND CONSTRUCTION WORK MAY BE PERFORMED OVER THE TOP OF AND AROUND COMMUNICATION AND POWER SERVICES. CONTRACTOR SHALL WORK BY HAND IN ALL AREAS WHERE THESE SERVICES MIGHT BE HARMED BY LARGER LESS PRECISE EQUIPMENT.
- 4. THE CONTRACTOR SHALL LOCATE AND CLEARLY MARK (AND THEN PRESERVE THESE MARKERS) FOR THE DURATION OF CONSTRUCTION OF ALL UNDERGROUND UTILITIES, INCLUDING TELEPHONE, DATA, STREET LIGHT, SIGNAL LIGHT AND POWER FACILITIES, LOW TEMPERATURE HOT WATER AND CHILLED HOT WATER LINES THAT ARE IN OR NEAR THE AREA OF DEMOLITION.
- 5. CONTRACTOR'S BID IS TO INCLUDE ALL VISIBLE SURFACE AND ALL SUBSURFACE FEATURES IDENTIFIED TO BE REMOVED OR ABANDONED IN THESE DOCUMENTS.
- 6. THE CONTRACTOR SHALL BE RESPONSIBLE FOR A SITE INSPECTION TO FULLY ACKNOWLEDGE THE EXTENT OF THE DEMOLITION WORK.
- 7. THE CONTRACTOR SHALL BE RESPONSIBLE FOR OBTAINING ANY AND ALL PERMITS NECESSARY FOR ENCROACHMENT, GRADING, DEMOLITION, AND DISPOSAL OF SAID MATERIALS AS REQUIRED BY PRIVATE, LOCAL AND STATE JURISDICTIONS. THE CONTRACTOR SHALL PAY ALL FEES ASSOCIATED WITH THE DEMOLITION WORK.
- 8. CONTRACTOR SHALL PAY DISPOSAL FEES.
- 9. BACKFILL ALL DEPRESSIONS AND TRENCHES FROM DEMOLITION OF FOUNDATIONS & UTILITIES TO EXISTING GRADE AND TO THE SATISFACTION OF THE GEOTECHNICAL ENGINEER, AND/OR UNIVERSITY FIELD CONSTRUCTION MANAGER (FCM).
- 10. WITHIN LIMITS OF WORK, REMOVE CURBS, GUTTERS, LANDSCAPING, SIGNAGE, TREES, SHRUBS, ASPHALT, UNDERGROUND PIPES, ETC. AS INDICATED ON THE DRAWINGS.
- 11. CONTRACTOR SHALL BE RESPONSIBLE FOR DISPOSING ALL DEMOLITION MATERIALS, OR STORING SELECTED ITEMS BY UNIVERSITY'S REPRESENTATIVE AT DESIGNATED LOCATIONS.
- 12. PRIOR TO BEGINNING DEMOLITION WORK, CONTRACTOR TO NOTIFY AND COORDINATE THE REMOVAL AND/OR ABANDONMENT OF ALL AFFECTED UTILITIES WITH THE FCM.
- 13. CONTRACTOR RESPONSIBLE FOR PREPARING WASTE MANAGEMENT PLAN, TRAINING OF EMPLOYEES & SUBCONTRACTORS, AND ENSURING PROPER REMOVAL AND DISPOSAL OF ALL HAZARDOUS
- 14. THESE DRAWINGS DO NOT ADDRESS CONTRACTOR MEANS, METHODS OR PROCESSES THAT MAY BE ASSOCIATED WITH ANY TOXIC SOILS IF FOUND ON SITE. THE CONTRACTOR IS RESPONSIBLE FOR COMPLYING WITH ALL UNIVERSITY AND COUNTY STANDARDS AND APPROPRIATE REGULATIONS IF TOXIC SOILS ARE ENCOUNTERED. CONTRACTOR MUST NOTIFY THE FCM IMMEDIATELY IF ANY SOILS ARE EVEN SUSPECTED OF BEING CONTAMINATED.
- 15. CONTRACTOR SHALL CONTACT UNDERGROUND SERVICE ALERT, USA, FOR LOCATION AND MARKING OF UNDERGROUND UTILITIES AT LEAST 48 HOURS PRIOR TO COMMENCEMENT OF CONSTRUCTION
- 16. CONTRACTOR SHALL MAINTAIN THE EXISTING SITE AND STREETS IN A SAFE AND USABLE MANNER SUCH THAT EMERGENCY VEHICLE ACCESS IS AVAILABLE AT ALL TIMES. CONTRACTOR TO SUPPLY, INSTALL AND MAINTAIN ALL NECESSARY FENCING, GATES, BARRICADES, SIGNAGE, AND PROVISIONS FOR ENSURING THE PROJECT'S SECURITY AND SAFE PASSAGEWAY AROUND IT.
- 17. CONTRACTOR SHALL GATHER ALL CONSTRUCTION DEBRIS ON A REGULAR BASIS AND PLACE IT IN A DUMPSTER OR OTHER CONTAINER WHICH IS EMPTIED OR REMOVED ON A REGULAR BASIS. WHEN APPROPRIATE, USE TARPS ON THE GROUND TO COLLECT FALLEN DEBRIS OR SPLATTERS THAT COULD CONTRIBUTE TO STORM WATER RUNOFF POLLUTION.
- 18. CONTRACTOR SHALL CLEAR AND GRUB WITHIN LIMIT OF WORK AS NEEDED TO PERFORM DEMOLITION ACTIVITIES.
- 19. SAWCUT & REMOVE HARDSCAPE SUCH AS, BUT NOT LIMITED TO, AC PAVEMENT, CURB, SIDEWALK,
- 20. TAKE ALL NECESSARY PRECAUTIONS NOT TO DAMAGE EXISTING UNDERGROUND UTILITY LINES TO REMAIN DURING DEMOLITION. CONTRACTOR TO HIRE AN INDEPENDENT UNDERGROUND UTILITY LOCATOR SERVICE TO LOCATE & PAINT UTILITIES IN THE FIELD PRIOR TO CONSTRUCTION. ANY DAMAGE TO EXISTING UTILITIES TO REMAIN SHALL BE REPAIRED AT THE CONTRACTOR'S EXPENSE.
- 21. CONTRACTOR TO GRIND/ROUND CONCRETE EDGE AFTER SAWCUTTING TO MAINTAIN APPEARANCE AND SAFETY.
- 22. CONTRACTOR SHALL SCHEDULE MEETING WITH STANFORD ARBORIST AND UA/CPD FOR REVIEW OF THE TREE PROTECTION PRIOR TO START OF CONSTRUCTION.
- 23. CONTRACTOR TO SCHEDULE MEETING WITH HIGH VOLTAGE SHOP PRIOR TO REMOVING ANY EXISTING PULLBOXES.

### NOTES

ETC.

- 1. ALL UNDERGROUND UTILITIES, LANDSCAPE FEATURES, AND HARDSCAPE FEATURES IMPACTED OR DAMAGED BY THE CONTRACTOR OR THEIR SUB—CONTRACTORS SHALL BE REMOVED AND REPLACED IN KIND. ITEMS MAY INCLUDE, BUT NOT LIMITED TO, UNDERGROUND UTILITY AND IRRIGATION LINES, CURB, GUTTER, SIDEWALK, PAVEMENT, FENCING, STRIPING AND OTHER PAVEMENT MARKINGS, PLANTING, LANDSCAPING, AND BOLLARDS.
- 2. PROTECT ALL EXISTING UTILITIES IN PLACE UNLESS OTHERWISE NOTED. REPLACE ANY DAMAGED UTILITY TO REMAIN TO KEEP OPERABLE DURING CONSTRUCTION.
- 3. TREES ADJACENT TO THE PROPOSED COVERING SHALL BE TRIMMED AS NEEDED TO CONSTRUCT IMPROVEMENTS. ALL TREE TRIMMING SHALL BE COMPLETED UNDER THE SUPERVISION OF THE PROJECT ARBORIST.

### STANFORD UNIVERSITY

Project Name: Covered Tennis Courts Project Address: 638 Campus Drive, Stanford CA. 94305 Quad/ Bldg. Number: 08-025





DESCRIPTION

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PROJECT NUMBER


SHEET TITLE

DEMOLITION/TREE REMOVAL NOTES

AS NOTED

SHEET NUMBER

C-3 1

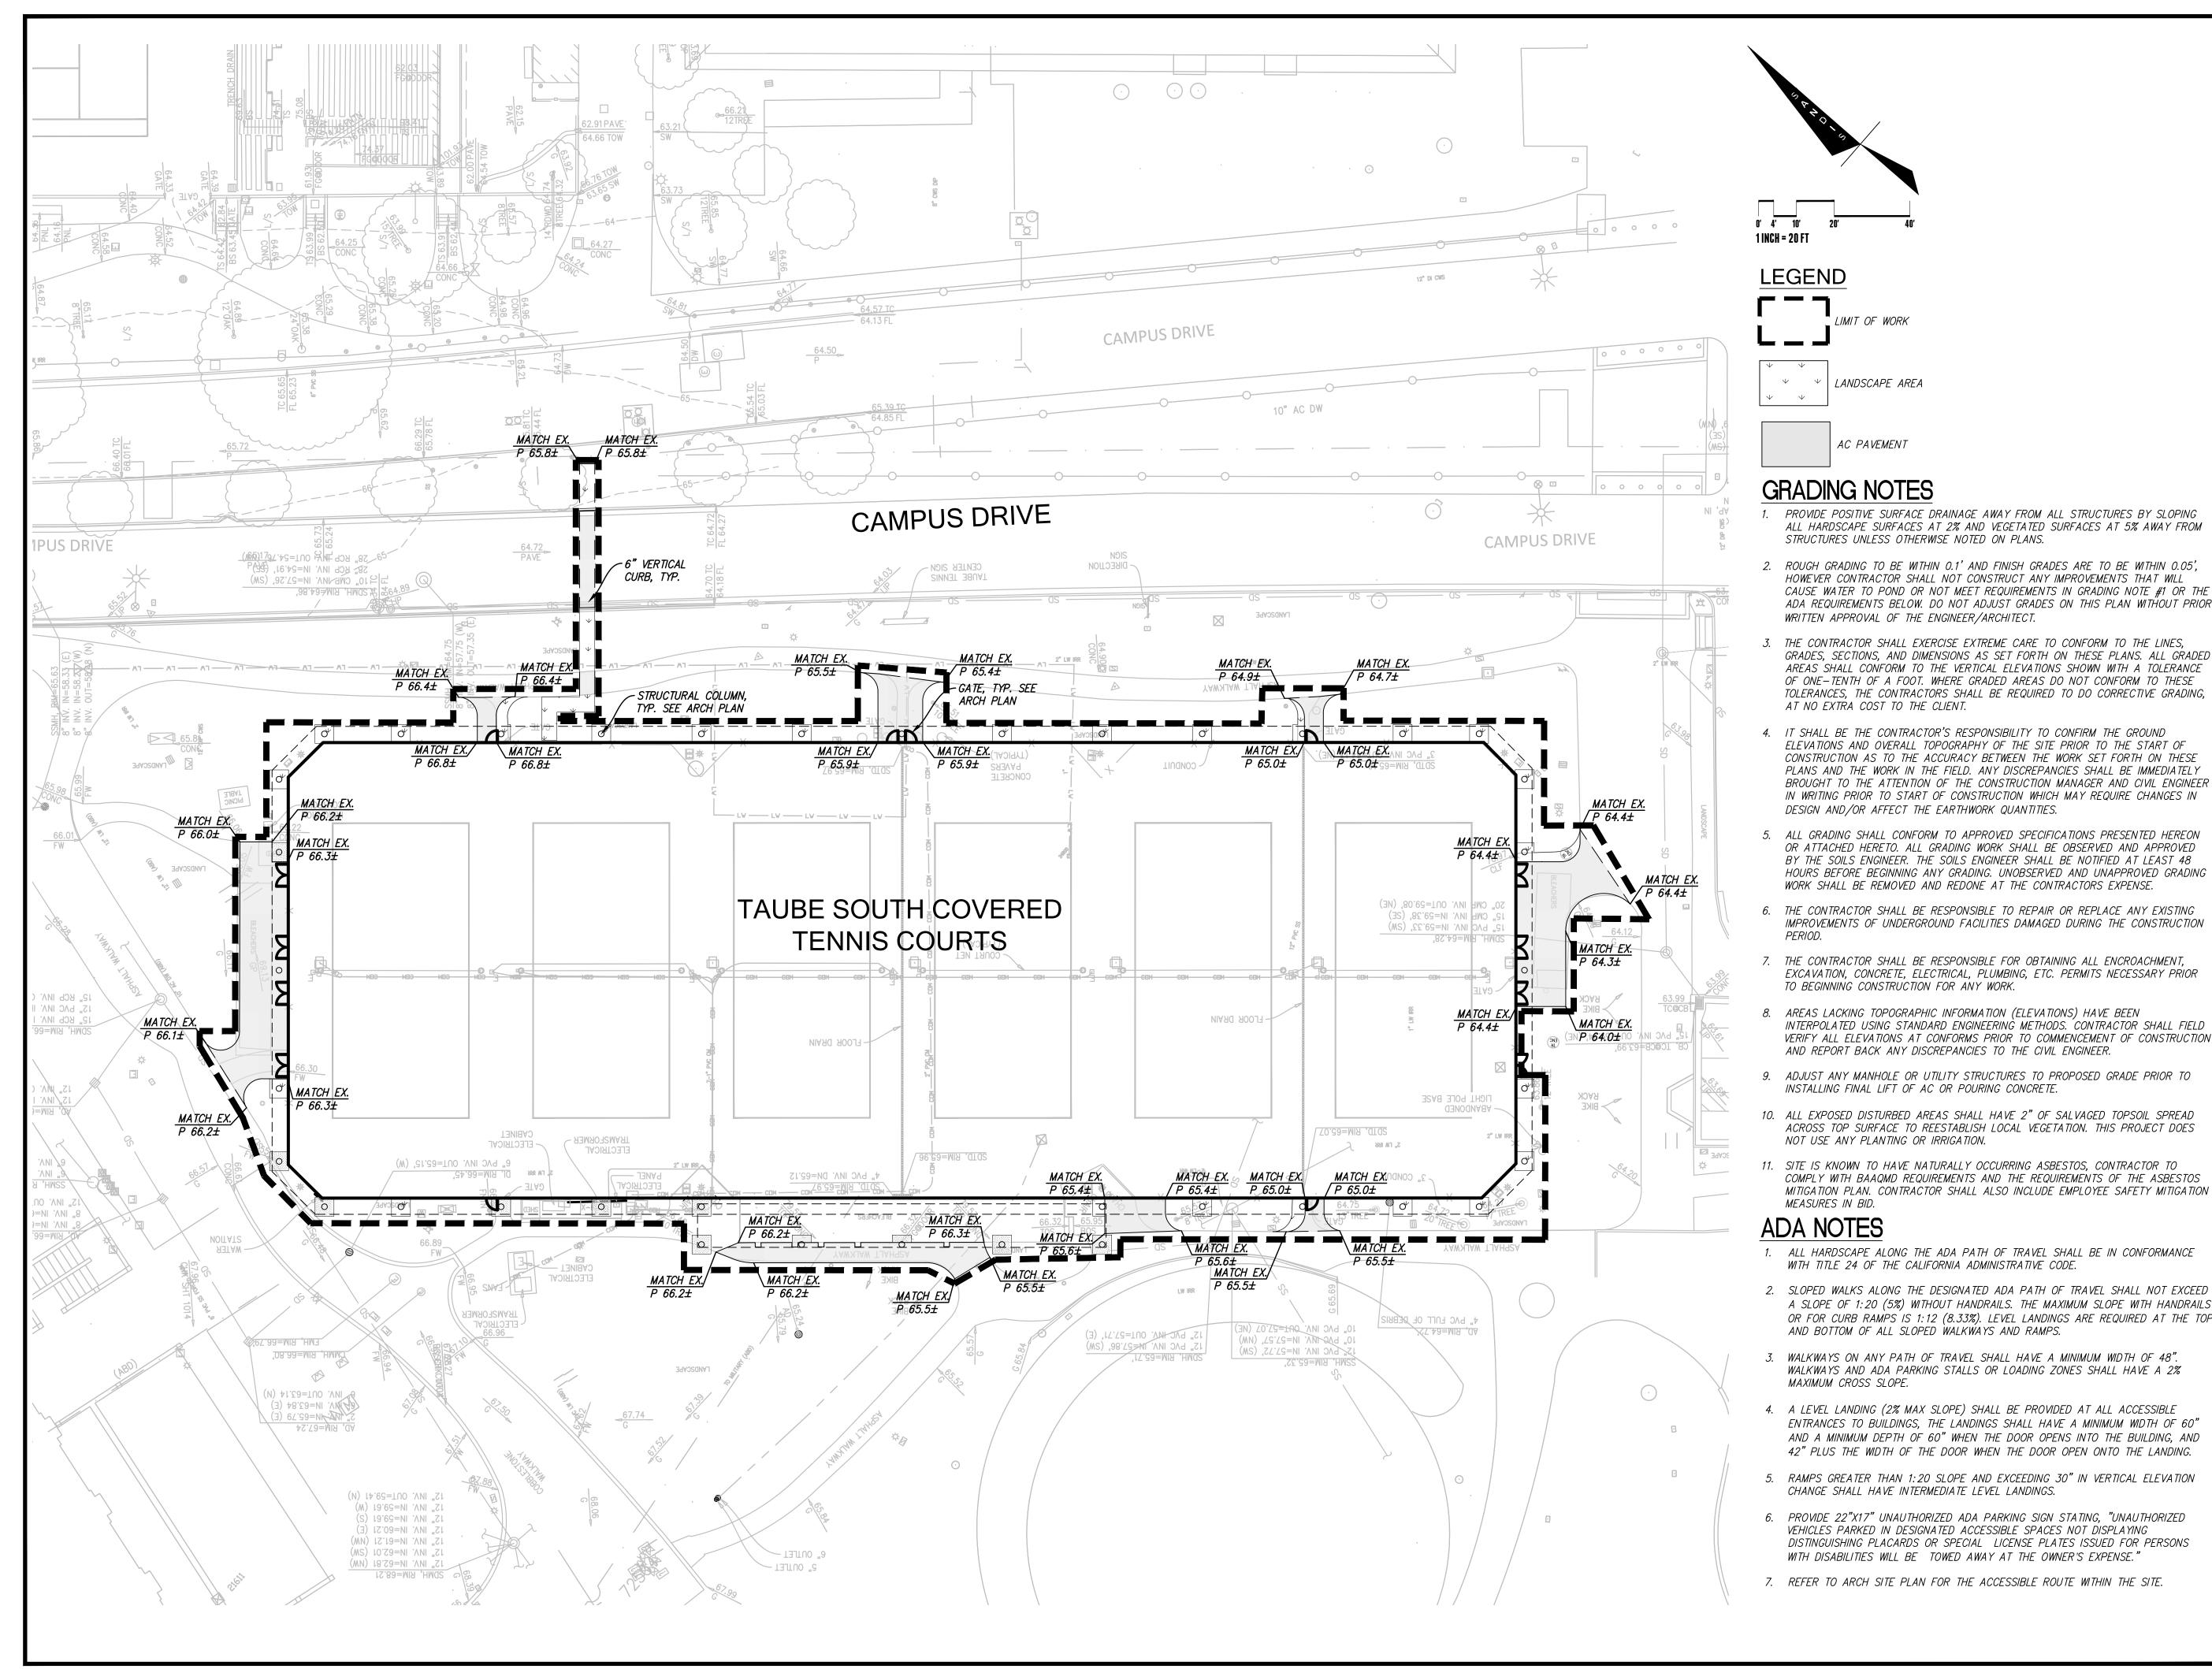

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SHEET TITLE

### GRADING AND DRAINAGE PLAN


SCALE

AS NOTED

SHEET NUMBER

**C-4.0** 

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SHEET TITLE

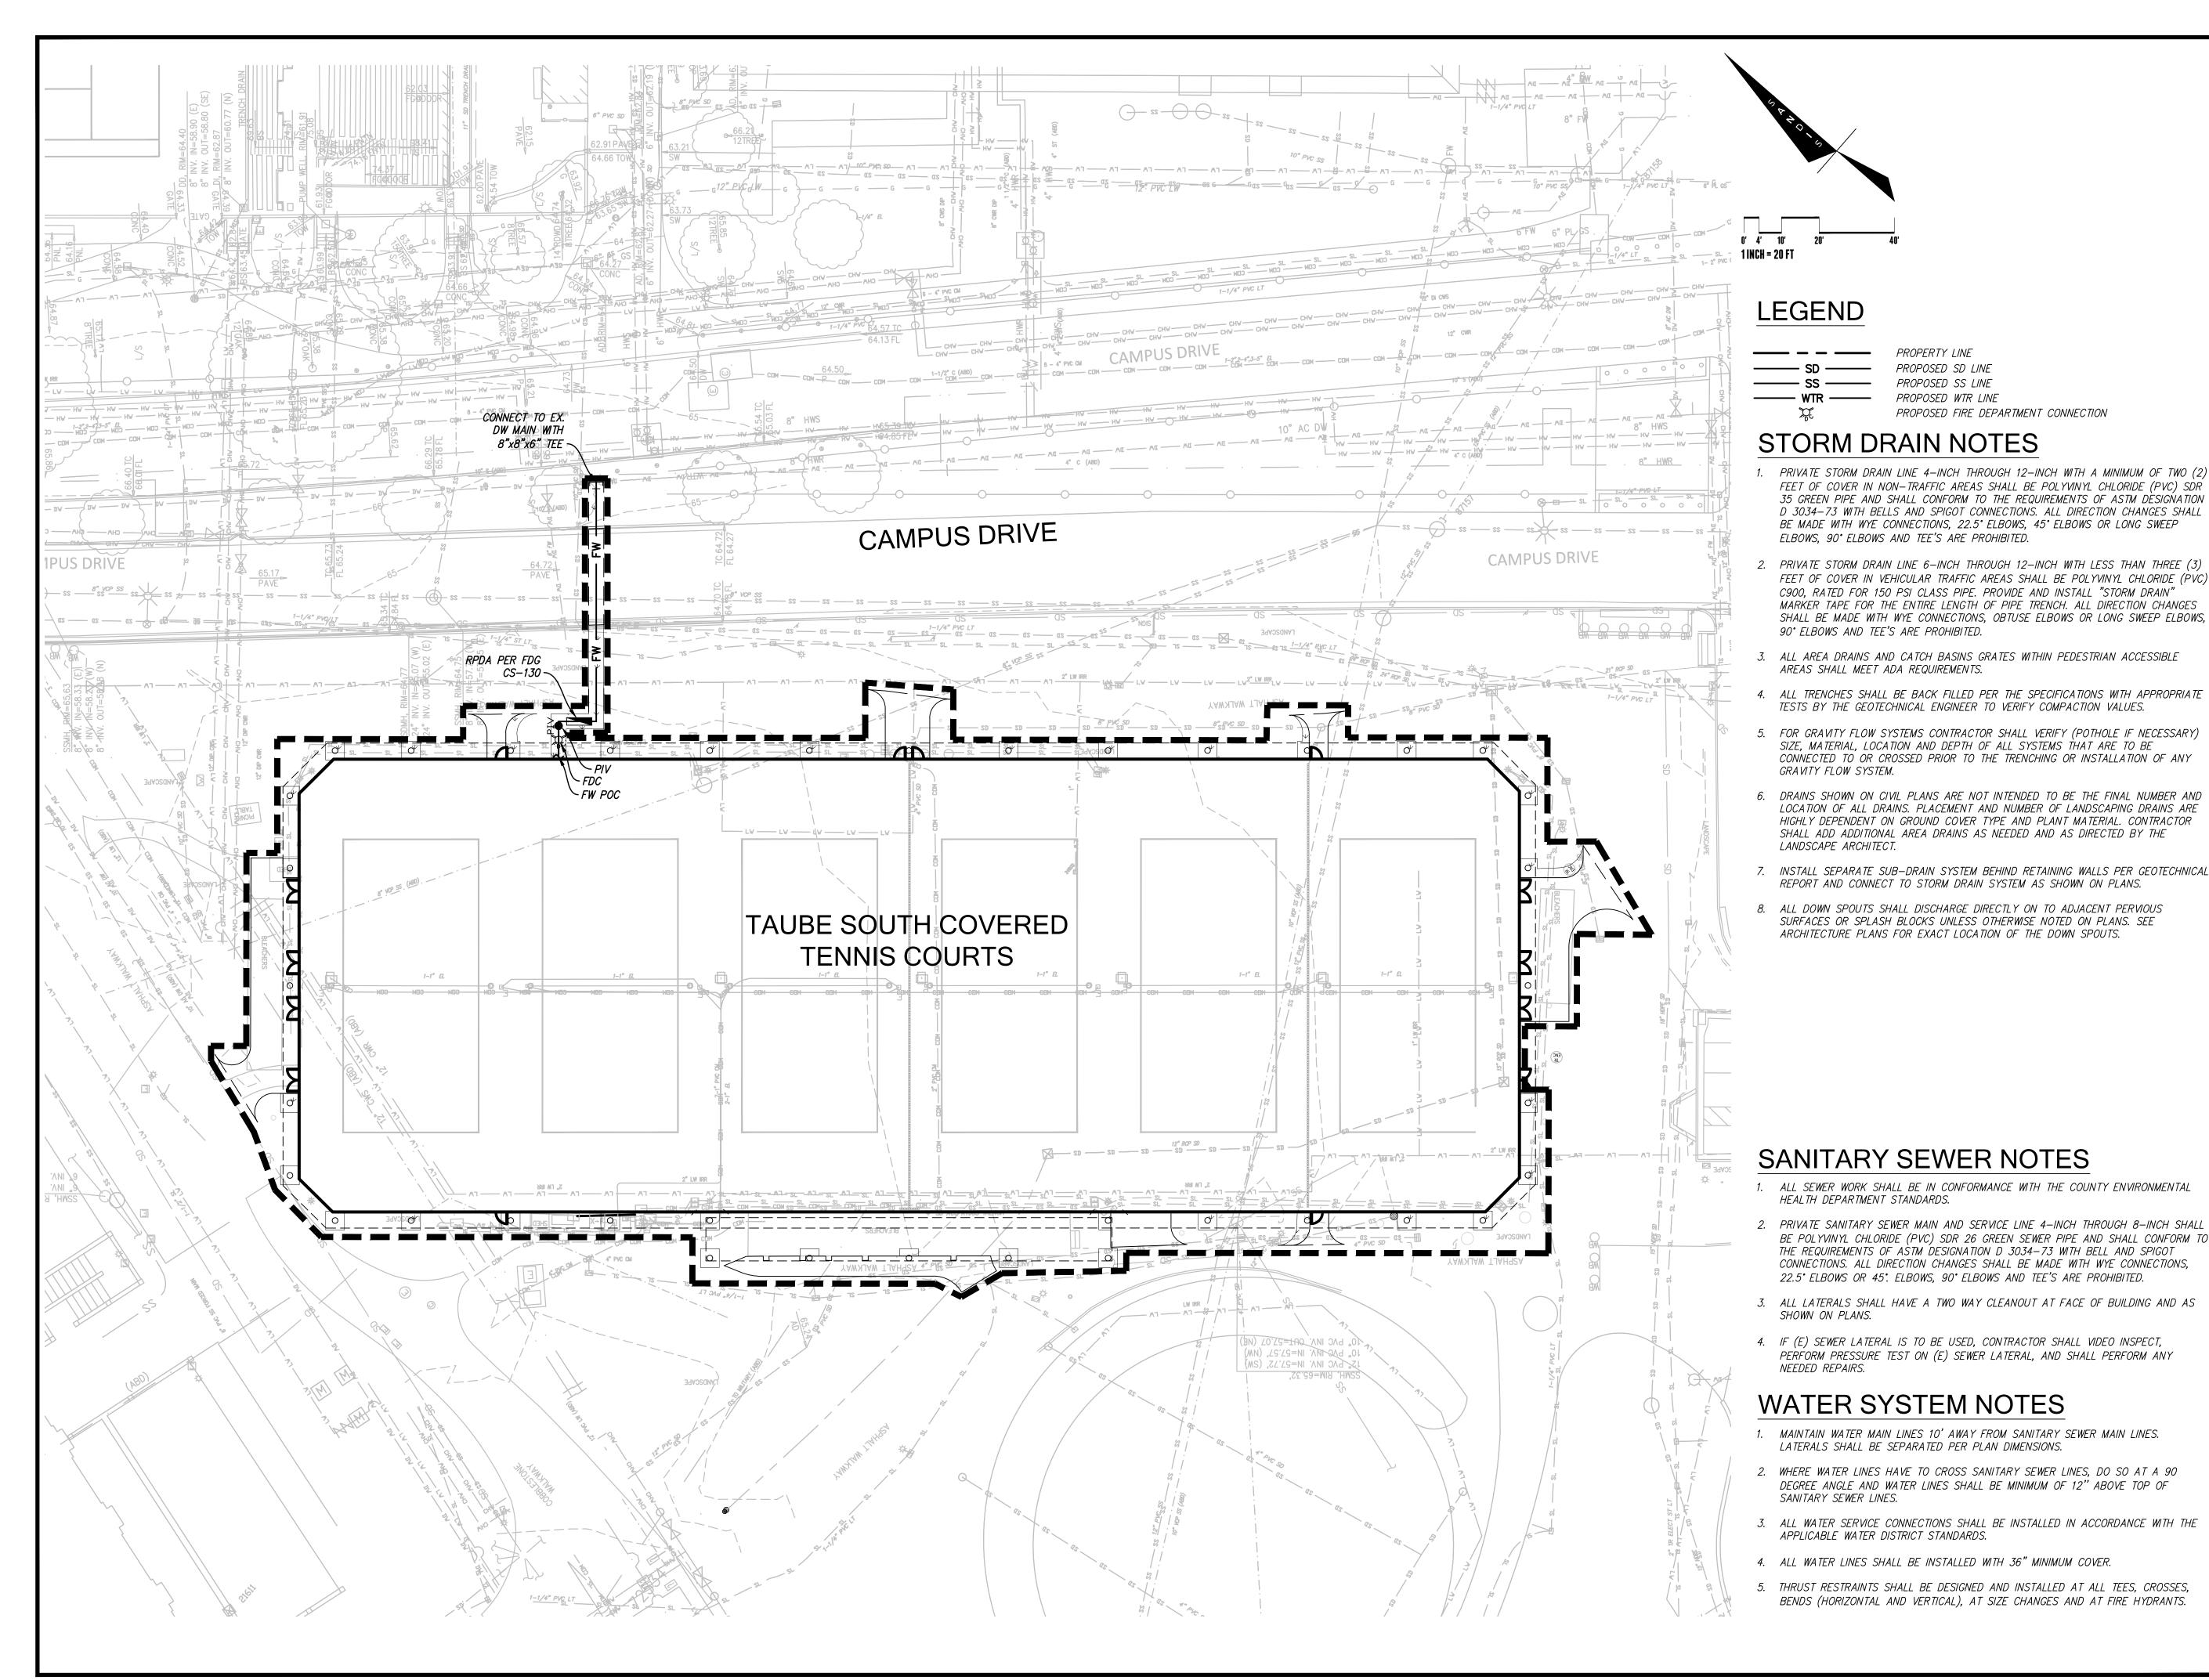UTILITY PLAN


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SHEET NUMBER

C-5.0

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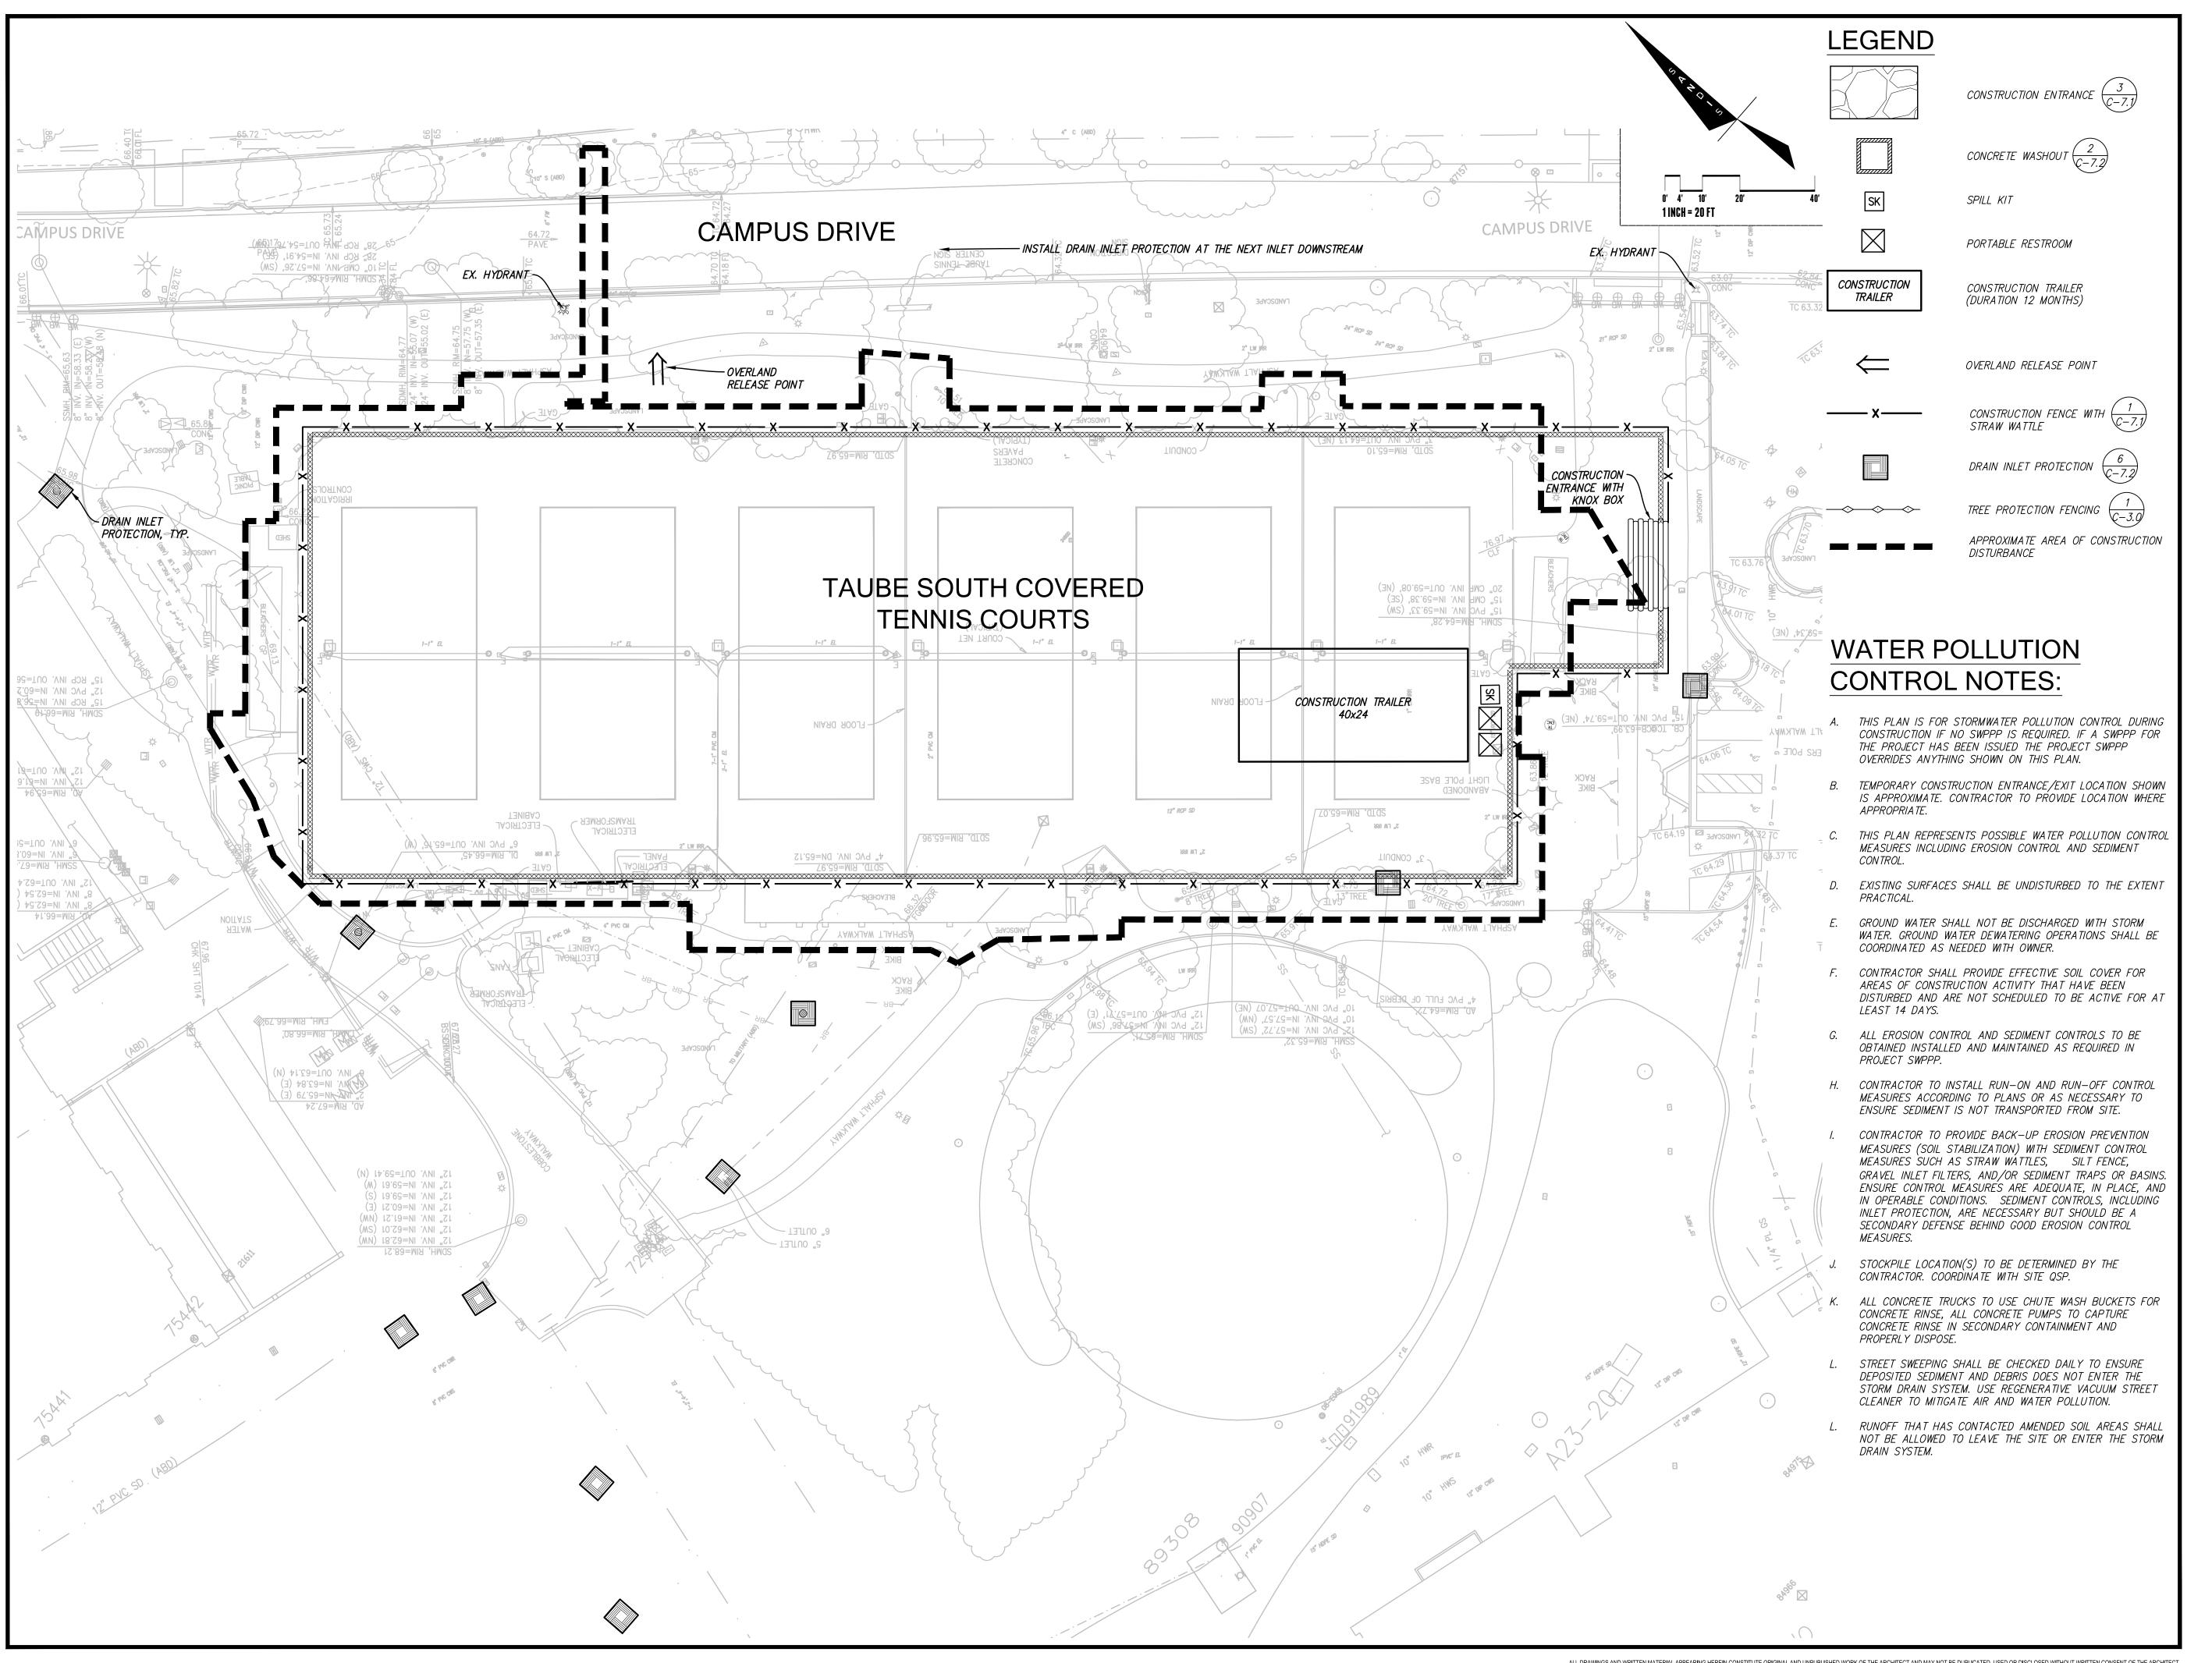
SHEET TITLE

STORMWATER MANAGEMENT PLAN

AS NOTED

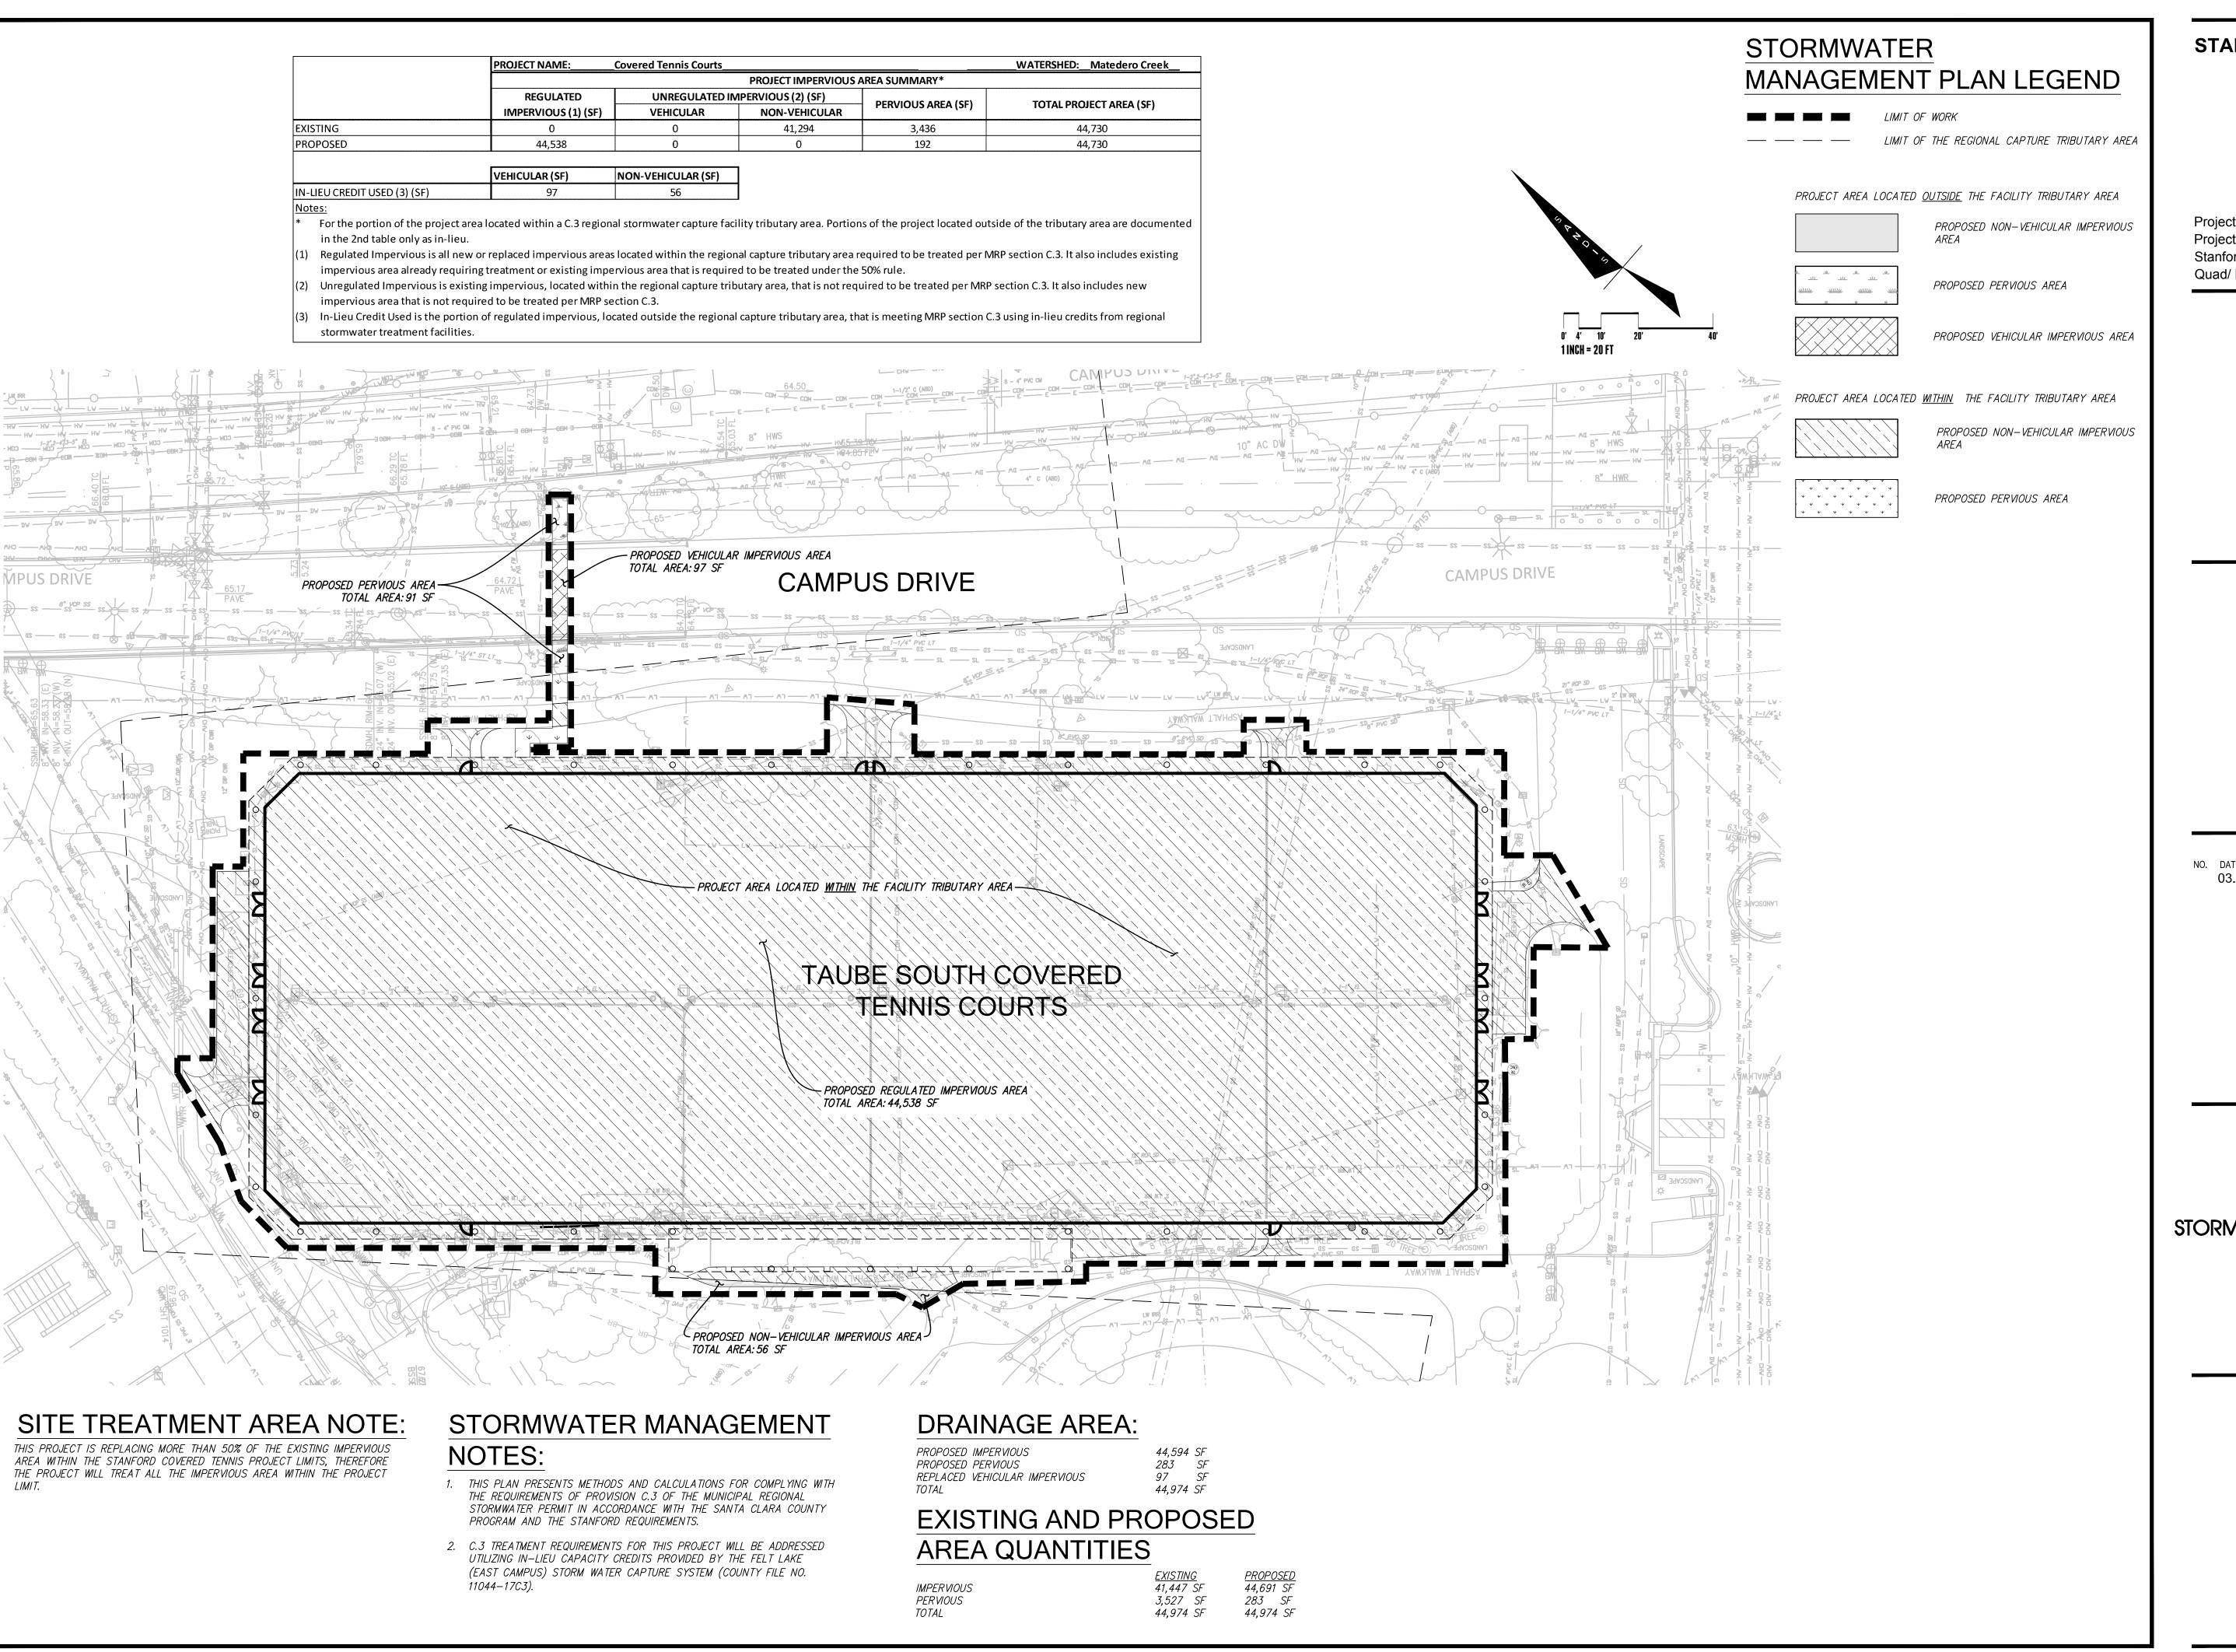SHEET NUMBER

C-6.0



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ISSUES AND REVISIONS

DESCRIPTION 03.01.2023 ASA SUBMITTAL

PROJECT NUMBER

SHEET TITLE EROSION CONTROL PLAN

SCALE

AS NOTED

SHEET NUMBER

Source for Graphics: California Stormwater BMP Handbook, California

Stormwater Quality Association, January 2003. Available from www.cabmphandbooks.com.

END DETAIL

OPTIONAL MAINTENANCE OPENING DETAIL

(SEE NOTE 11)

### STANDARD BEST MANAGEMENT PRACTICE NOTES

- 1. Solid and Demolition Waste Management: Provide designated waste collection areas and containers on site away from streets. gutters, storm drains, and waterways, and arrange for regular disposal. Waste containers must be watertight and covered at all times except when waste is deposited. Refer to Erosion & Sediment Control Field Manual, 4th Edition (page C3) or
- 2. Hazardom Waste Maragement: Provide proper handling and disposal of hazardous wastes by a licensed hazardous waste material hauler. Hazardous wastes shall be stored and properly labeled in scaled containers constructed of suitable materials. Refer to Erosion & Sediment Control Field Manual, 4th Edition (pages C-5 to C-6) or latest.
- 3. Spill Presention and Control: Provide proper storage areas for liquid and solid materials, including chemicals and hazardous substances, away from streets, gutters, storm drains, and waterways. Spill control materials must be kept on site where readily accessible. Spills must be cleaned up immediately and contaminated soil disposed properly. Refer to Erosion & Sediment Control Field Manual, 4th Edition (pages C-7 to C-8, C-13 to C-14) or latest.
- Vehicle and Construction Equipment Service and Storage: An area shall be designated for the maintenance, where onsite maintenance is required, and storage of equipment that is protected from stormwater run-on and runoff. Measures shall be provided to capture any waste oils, lubricants, or other potential pollutants and these wastes shall be properly disposed of off site. Fueling and major maintenance/repair, and washing shall be conducted off-site whenever feasible. Refer to Erosion & Sediment Control Field Manual, 4th Edition (page C9) or
- 5. Material Delivery, Handling and Storage: In general, materials should not be stockpiled on site. Where temporary stockpiles are necessary and approved by the County, they shall be covered with secured plastic sheeting or tarp and located in designated areas near construction entrances and away from drainage paths and waterways. Barriers shall be provided around storage areas where materials are potentially in contact with runoff. Refer to Erosion & Sediment Control Field Manual, 4th Edition (pages C-11 to C-12) or latest.
- Handling and Disposal of Concrete and Coment: When concrete tracks and equipment are washed on-site, concrete wastewater shall be contained in designated containers or in a temporary fined and watertight pit where wasted concrete can harden for later removal. If possible have concrete contractor remove concrete wash water from site. In no case shall fresh concrete be washed into the road right-of-way. Refer to Erosion & Sediment Control Field Manual, 4th Edition (pages C-15 to
- . Provement Construction Management: Prevent or reduce the discharge of pollutants from paving operations, using measures to prevent run-on and runoff pollution and properly disposing of wastes. Avoid paving in the wet season and reschedule paving when rain is in the forecast. Residue from sow-cutting shall be vacuumed for proper disposal. Refer to Erosion & Sediment Control Field Manual, 4th Edition (pages C-17 to C-18) or latest.
- 8. Contaminated Soil and Water Management: Impections to identify contaminated soils should occur prior to construction and at regular intervals during construction. Remediating contaminated soil should occur promptly after identification and be specific to the contaminant identified, which may include hazardous waste removal. Refer to Erosion & Sediment Control Field Manual, 4th Edition (pages C-19 to C-20) or
- Sanitary/Sentic Water Management: Temporary sanitary facilities should be located away from drainage paths, waterways, and traffic areas. Only licensed sanitary and septic waste haulers should be used. Secondary containment should be provided for all sanitary facilities. Refer to Erosion & Sediment Control Field Manual, 4th Edition (page C-21) or
- Inspection & Maintenance: Areas of material and equipment storage sites and temporary sanitary facilities must be inspected weekly. Problem areas shall be identified and appropriate additional and/or alternative control measures implemented immediately, within 24 hours of the problem being identified.

### STANDARD EROSION CONTROL NOTES

### Sediment Control Management

Storm Drain Inlet and Catch Basin Inlet Protection: All inlets within the vicinity of the project and within the project limits shall be protected with gravel bags placed around inlets or other inlet protection. At locations where exposed soils are present, staked fiber soles or staked silt fences can be used. Inlet filters are not allowed due to clogging and subsequent flooding. Refer to Erosion & Sediment Control Field Manual, 4th Edition (pages B-49 to B-51) or latest.

Storm Water Runoff: No storm water runoff shall be allowed to drain in to the existing and/or proposed underground storm drain system or other above ground watercourses until appropriate crosion control measures are fully installed.

Dust Control: The contractor shall provide dust suppression or chemical stabilization of exposed soils, providing for rapid clean up of sediments deposited on paved roads, furnishing construction road entrances and yehicle wash down areas, and limiting the amount of areas disturbed by clearing and earth moving operations by scheduling these activities in phases.

Stockpiling: Excavated soils shall not be placed in streets or on paved areas. Borrow and temporary stockpiles shall be protected with appropriate erosion control measures(tarps, straw bales, silt fences, ect.) to ensure silt does not leave the site or enter the storm drain system or neighboring watercourse.

- Erosion Control: During the rainy season, all disturbed areas must include an effective combination of crosson and sediment control. It is required that temporary crosson control measures are applied to all disturbed soil areas prior to a rain event. During the non-rainy season, crosion control measures must be applied sufficient to control wind crossion at the site.
- Inspection & Maintenance: Disturbed areas of the Project's site, locations where vehicles enter or that are identified as part of the Erosion Control Plans must be inspected by the Contractor before, during seasonal wet periods. Problem areas shall be identified and appropriate additional and/ or alternative control measures implemented identified
- 4. Project Completion: Prior to project completion and signoff by the County Inspector, all disturbed areas shall be reseeded, planted, or landscaped to minimize the potential for erosion on the subject site.
- 5. It shall be the Owner's/Contractor's responsibility to and to keep the entire site in compliance with the
- 6. Erosion and sediment control best management practices shall be operable year round or until vegetation is fully established on landscaped

Iracking Prevention & Clean Up: Activities shall be organized and measures taken as needed to prevent or minimize tracking of soil onto the public street system. A gravel or proprietary device construction entrance/exit is required for all sites. Clean up of tracked material shall be provided by means of a street sweeper prior to an approaching rain event, or at least once at the end of each workday that material is tracked, or, more frequently as determined by the County Inspector. Refer to Erosion & Sediment Control Field Manual, 4th Edition (pages B-31 to B-33) or latest.

control in graded areas as required by providing wet

- exit the site, and all erosion and sediment controls during, and after storm events, and at least weekly immediately, within 24 hours of the problem being
- maintain control of the entire construction operation crossion control plan.



STANFORD UNIVERSITY

Project Name: Covered Tennis Courts

Project Address: 638 Campus Drive,

Stanford CA. 94305

Quad/ Bldg. Number: 08-025

**ARCHITECTS** 



ISSUES AND REVISIONS

NO. DATE DESCRIPTION 03.01.2023 ASA SUBMITTAL

PROJECT NUMBER

**COUNTY BMP NOTES** 

N.T.S

SHEET NUMBER

Best Management Practices and Erosion Control Details Sheet 1 County of Santa Clara



BMP-1

1



Project Name: Covered Tennis Courts Project Address: 638 Campus Drive, Stanford CA. 94305 Quad/ Bldg. Number: 08-025





ISSUES AND REVISIONS

DESCRIPTION 03.01.2023 ASA SUBMITTAL

PROJECT NUMBER 22020


COUNTY BMP NOTES


SCALE


N.T.S


SHEET NUMBER

C-7.2

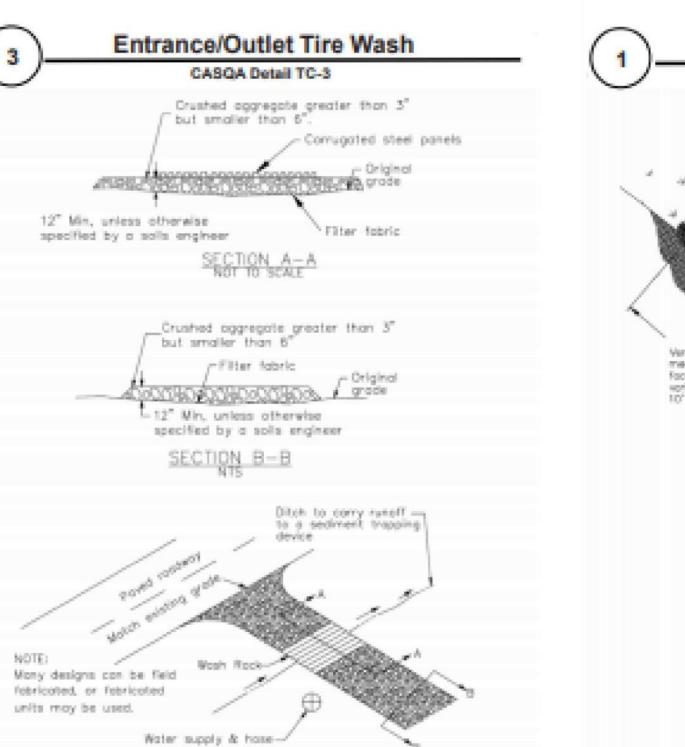

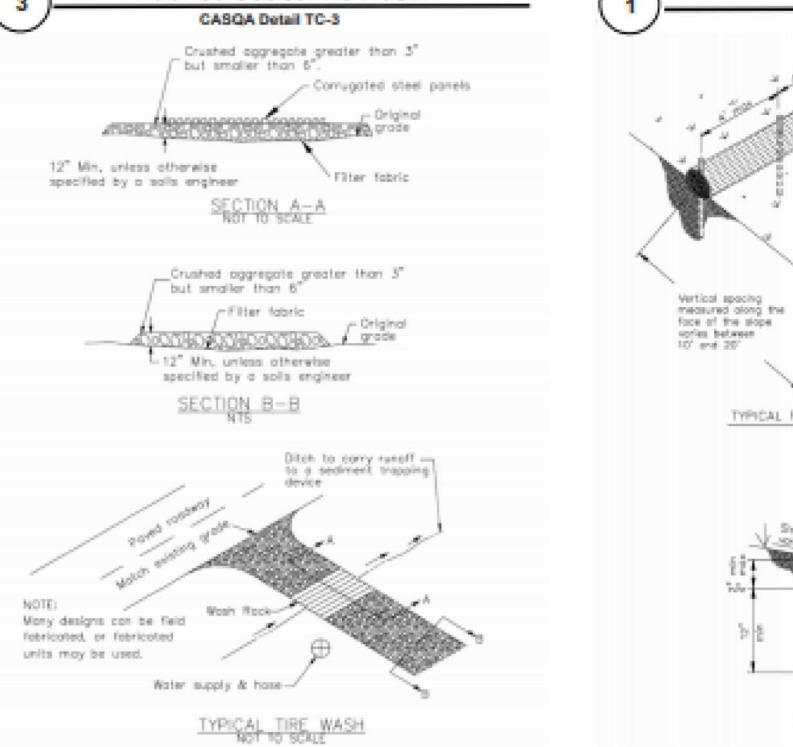

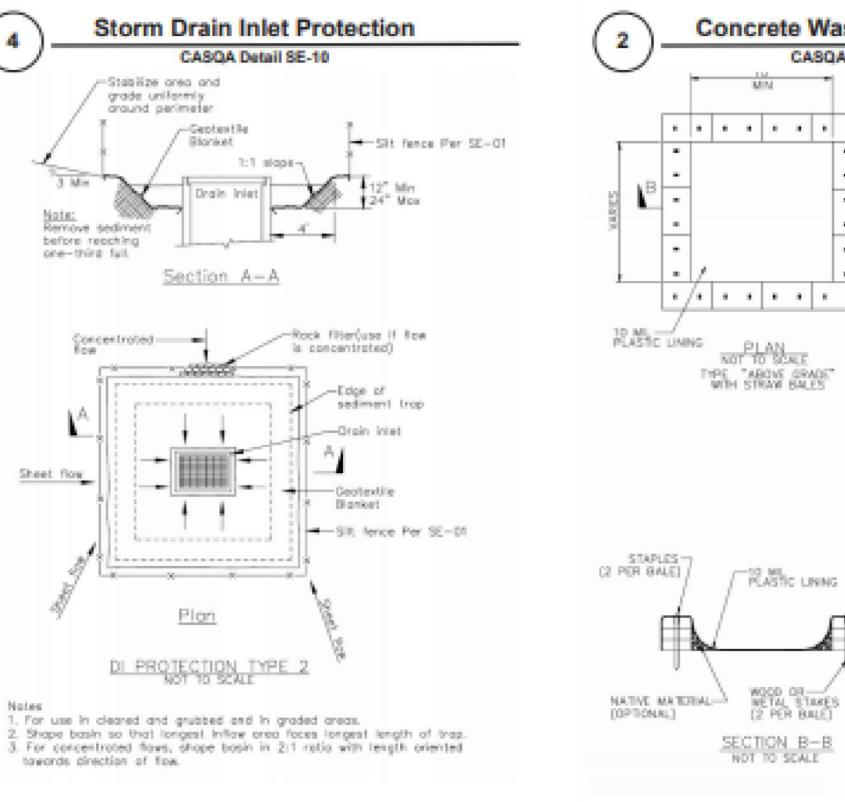

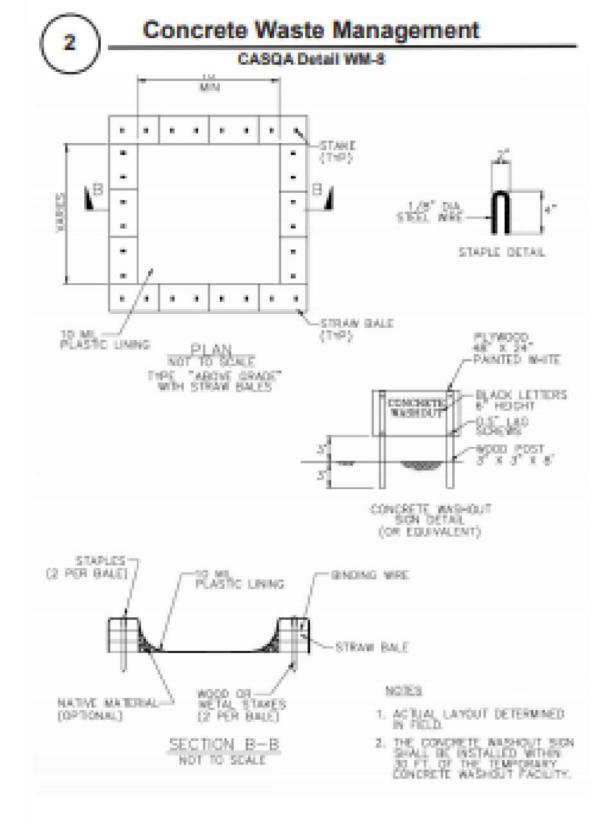

Fiber Rolls

CASQA Detail SE-5


TYPICAL FIBER ROLL INSTALLATION

ENTRENCHMENT DETAIL N.T.S.

Note: Install flaer rall

along a level contour.

\_instol a fiber roll neor slope where It Inorestions into a steeper stope

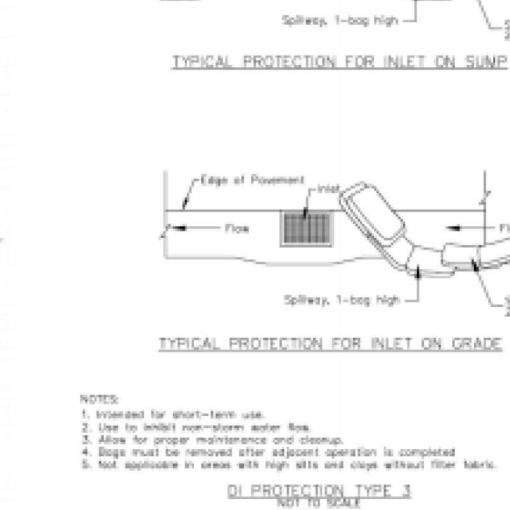

ISOMETRIC VIEW

Slage surface shall be free of rocks, clads, sticks and grass. Wats/biorkets shall have good sail contact.

TYPICAL INSTALLATION DETAIL

Storm Drain Inlet Protection

CASQA Detail SE-10

Les blankets leasely and stoke or stople to maintain direct contact with the sail. Do not stretch.

3. Install per monufacturer's recommendations



Geotextiles and Mats

CASQA Detail EC-7


Mots/blankets should be installed vertically


downstope.

4 4 44

geotextle filter fobrio under

WET SLOPE LINING

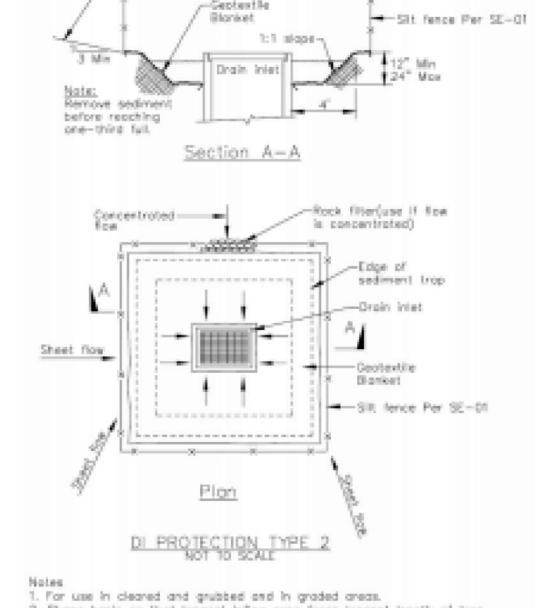


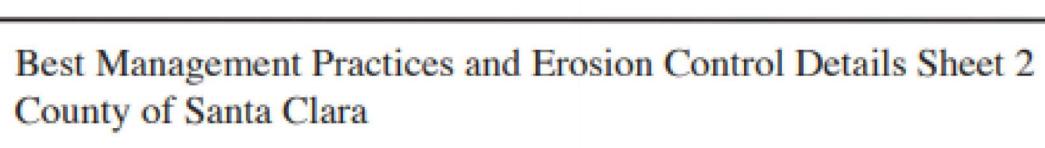



BMP-2

Information

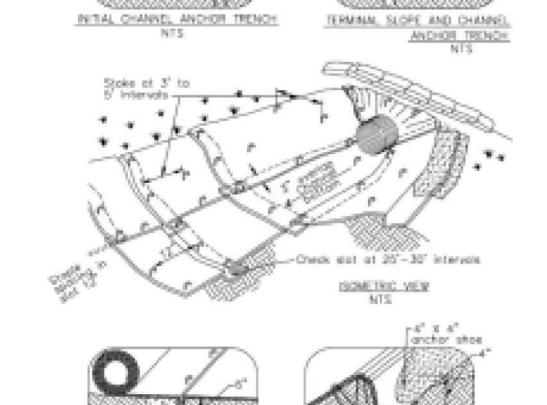


Geotextiles and Mats

CASQA Detail EC-7


INTERMITTENT CHECK SLOT 1. Check slots to be constructed per monufacturers specifications.



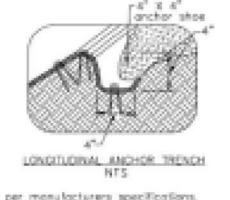

. Stoking or stapling layout per monufacturers specifications. 3. Install per monutacturer's recommendations


TYPICAL INSTALLATION DETAIL

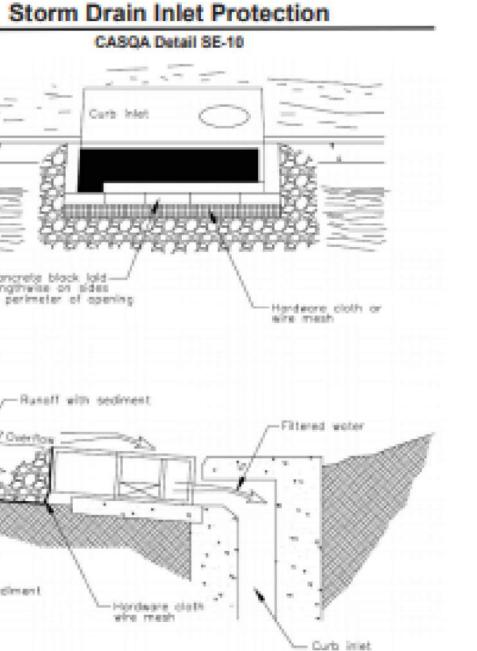

DI PROTECTION - TYPE 4
NOT TO SCALE Source for Graphics: California Stormwater BMP Handbook, California Stormwater Quality Association, January 2003. Available from www.cabmphandbooks.com.

Concrete black lold— lengthwise on sides @ perimeter of opening

- Rusett with sediment

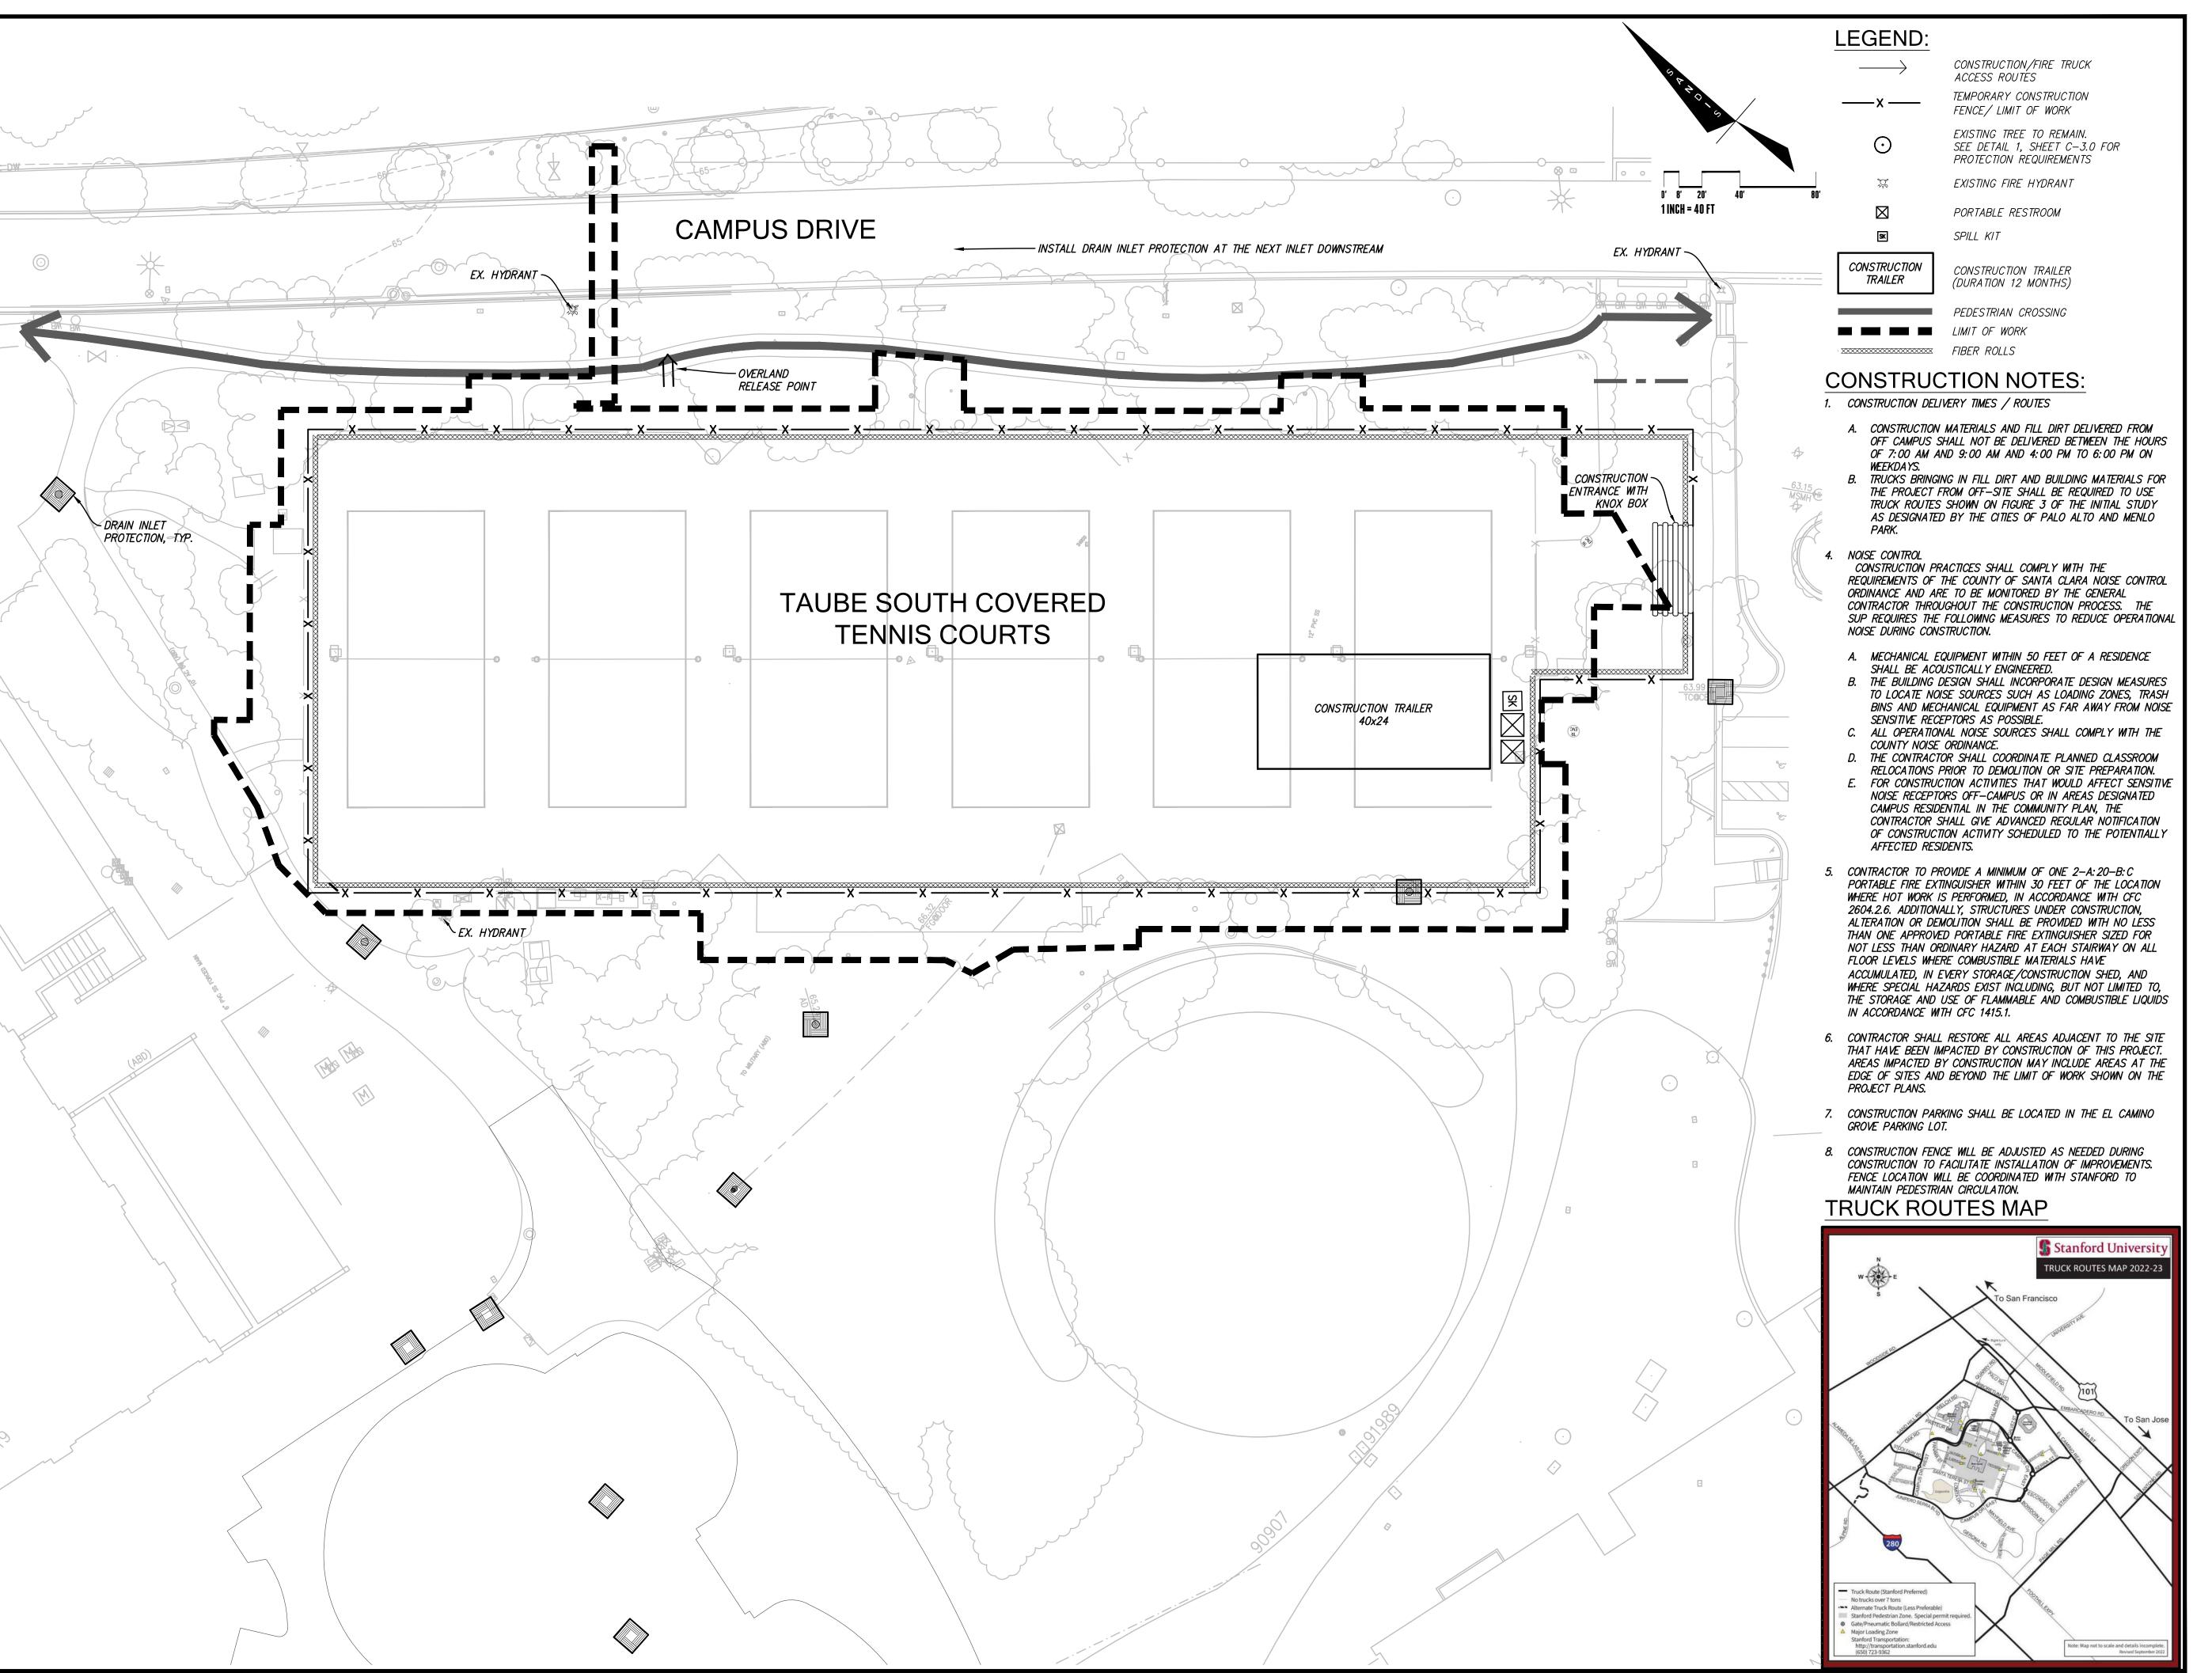

Project Name: Covered Tennis Courts Project Address: 638 Campus Drive, Stanford CA. 94305 Quad/ Bldg. Number: 08-025





ISSUES AND REVISIONS

O. DATE DESCRIPTION
03.01.2023 ASA SUBMITTAL

PROJECT NUMBER 22020


SHEET TITLE

# CONSTRUCTION SITE LOGISTICS/SAFETY PLAN

AS NOTED

SHEET NUMBER

C-8.0

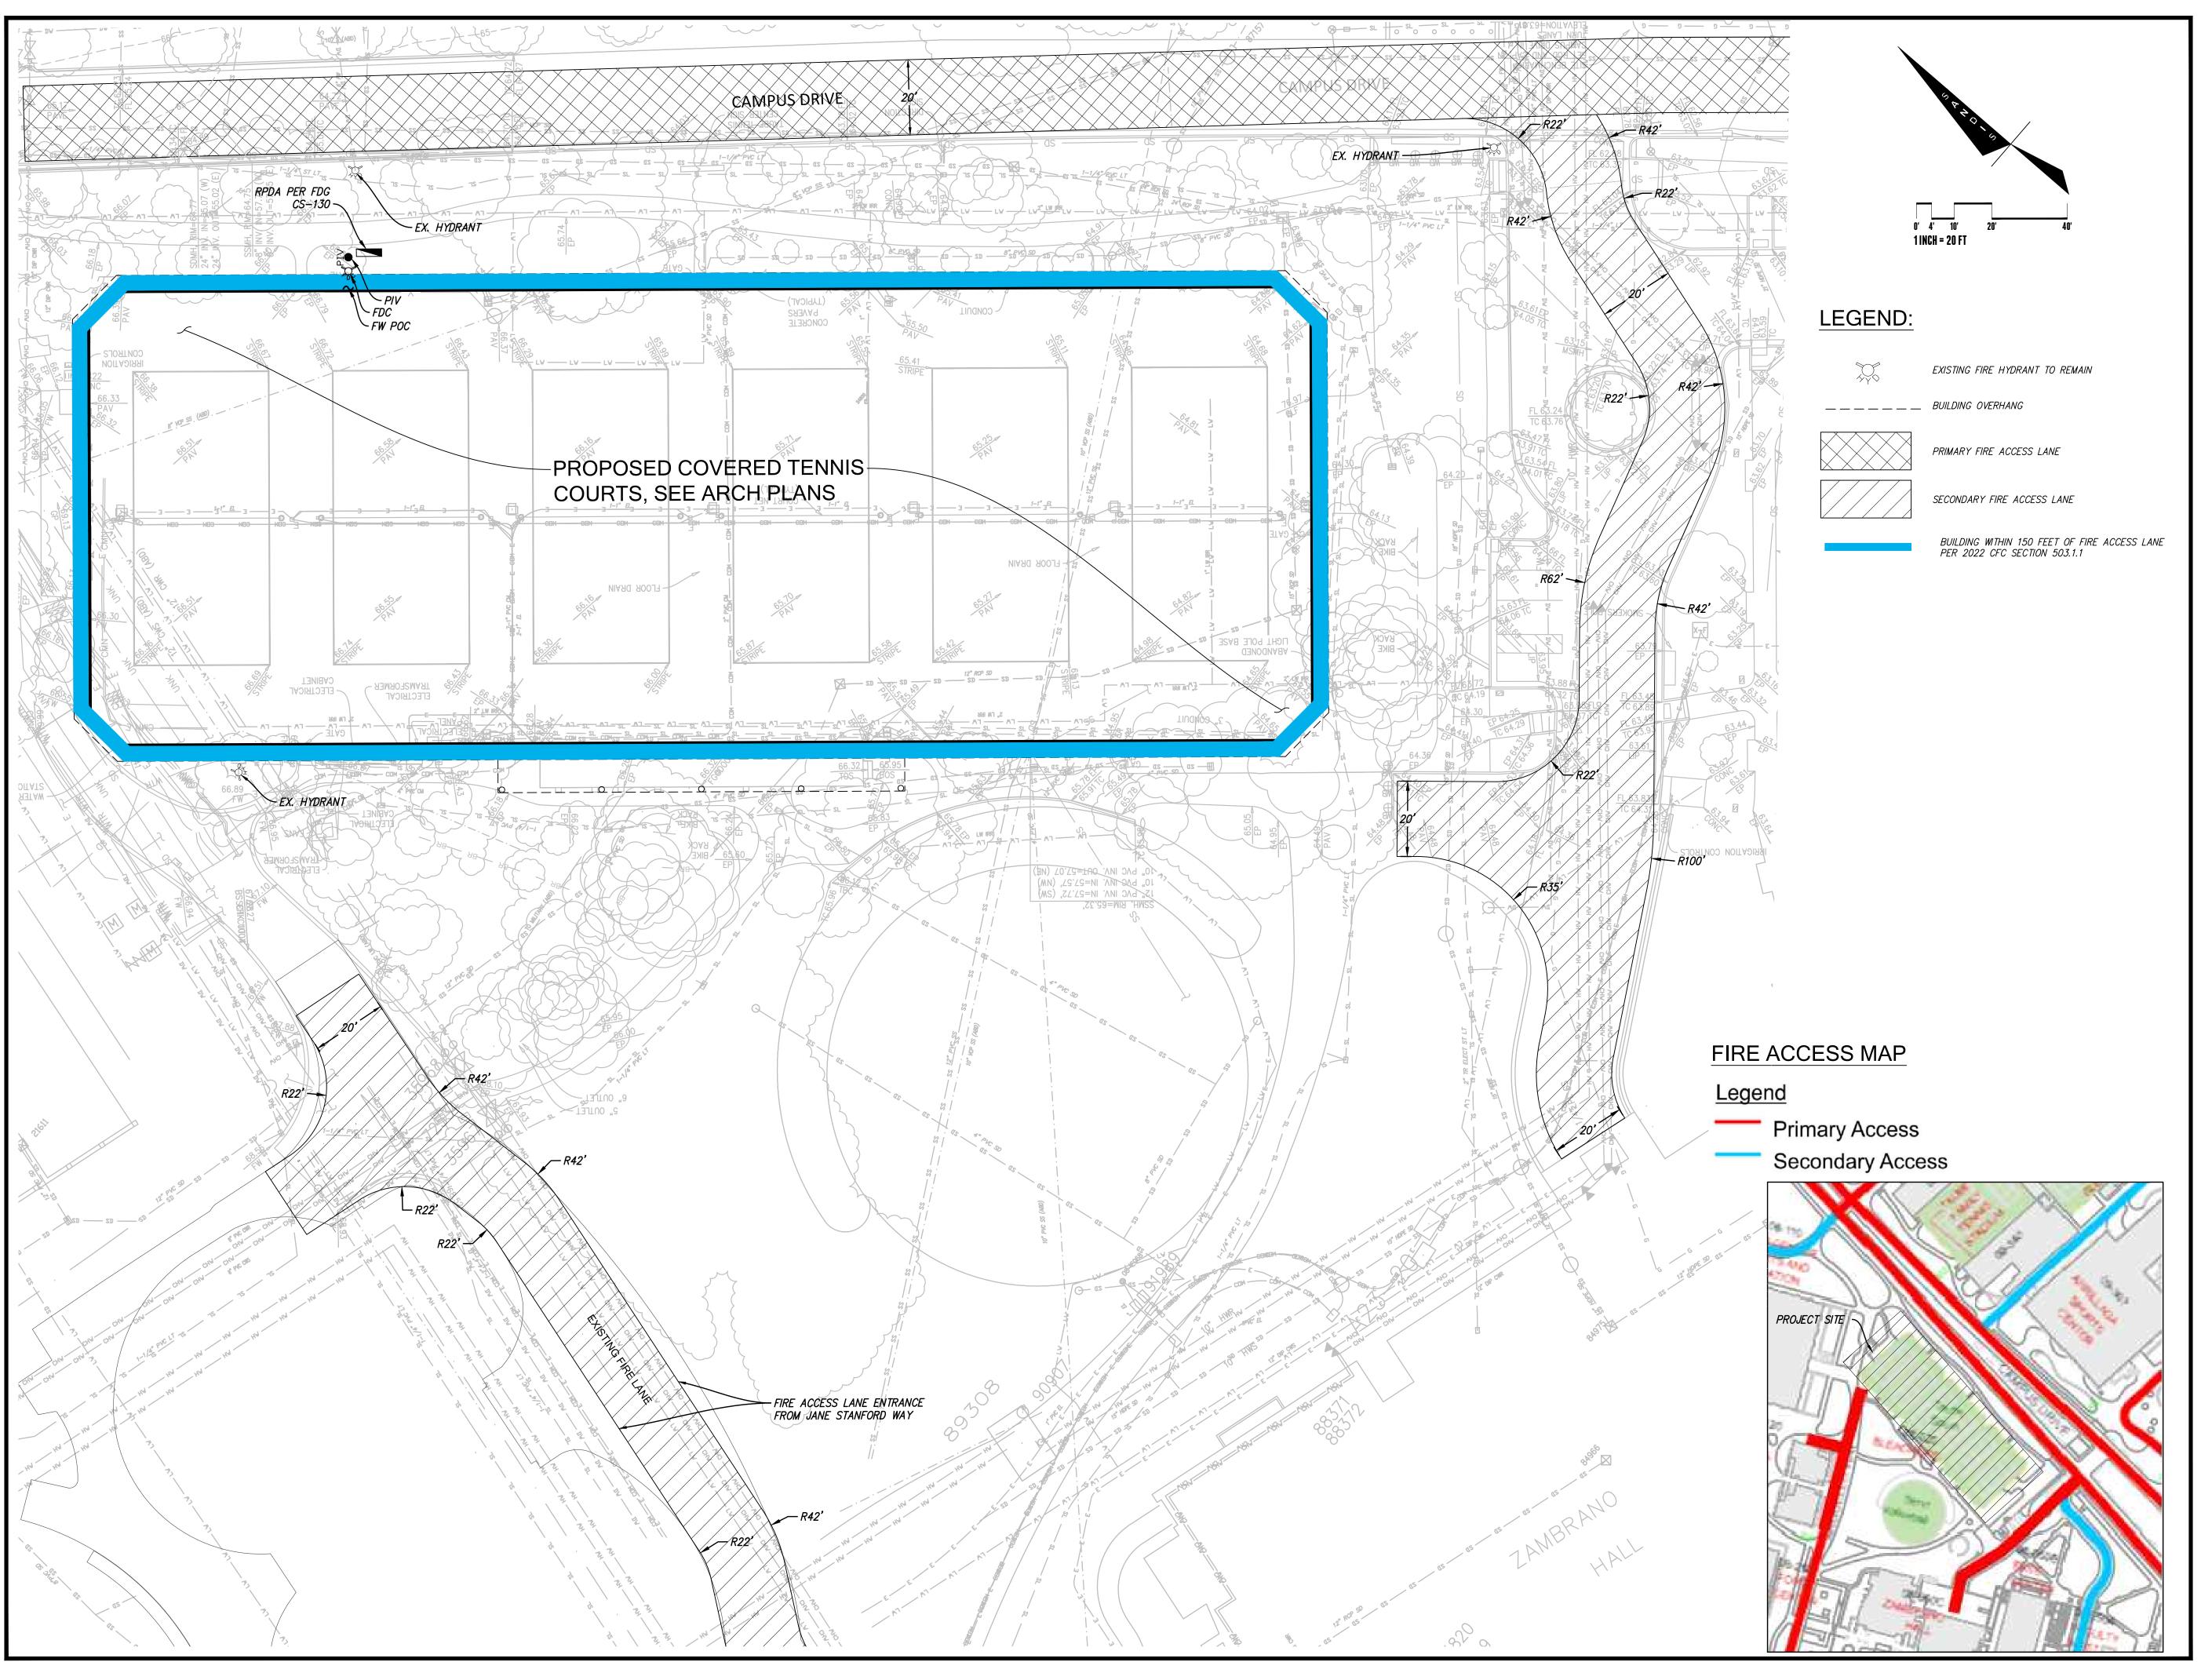

Project Name: Covered Tennis Courts Project Address: 638 Campus Drive, Stanford CA. 94305 Quad/ Bldg. Number: 08-025





ISSUES AND REVISIONS

03.01.2023 ASA SUBMITTAL

PROJECT NUME

SHEET TITLE

FIRE ACCESS PLAN

00/122

AS NOTED

SHEET NUME

C-9.0

### LANDSCAPE DESIGN CONCEPT


THE LANDSCAPE DESIGN FOR THE PROJECT PRESERVES THE EXISTING LANDSCAPING AT THE TENNIS COURTS. PLANTING AREAS ADJACENT TO THE COURTS WILL BE TOP DRESSED WITH BARK MULCH FOLLOWING CONSTRUCTION TO MATCH EXISTING CONDITIONS AROUND THE PROJECT SITE.

### TREE PRESERVATION NOTES

- 1. REFER TO THE TREE DISPOSITION TABLE ON SHEETS C-3.0 AND C-3.1 AND TO THE ARBORIST REPORT PREPARED BY DAVID BABBY, CONSULTING ARBORIST, FOR TREES TO BE SAVED AND REMOVED.
- 2. REFER TO TREE PROTECTION NOTES ON SHEET C-3.0 AND C-3.1.

### PLANTING NOTES

- 1. THERE IS NO NEW PLANTING PROPOSED FOR THE PROJECT.
- 2. EXISTING PLANTING AREAS ADJACENT TO THE COURTS WILL BE TOP DRESSED WITH BARK MULCH FOLLOWING CONSTRUCTION.
- 3. REFER TO CIVIL DRAWINGS FOR SITE DEMOLITION, PAVING, GRADING AND DRAINAGE AND STORMWATER MANAGEMENT.

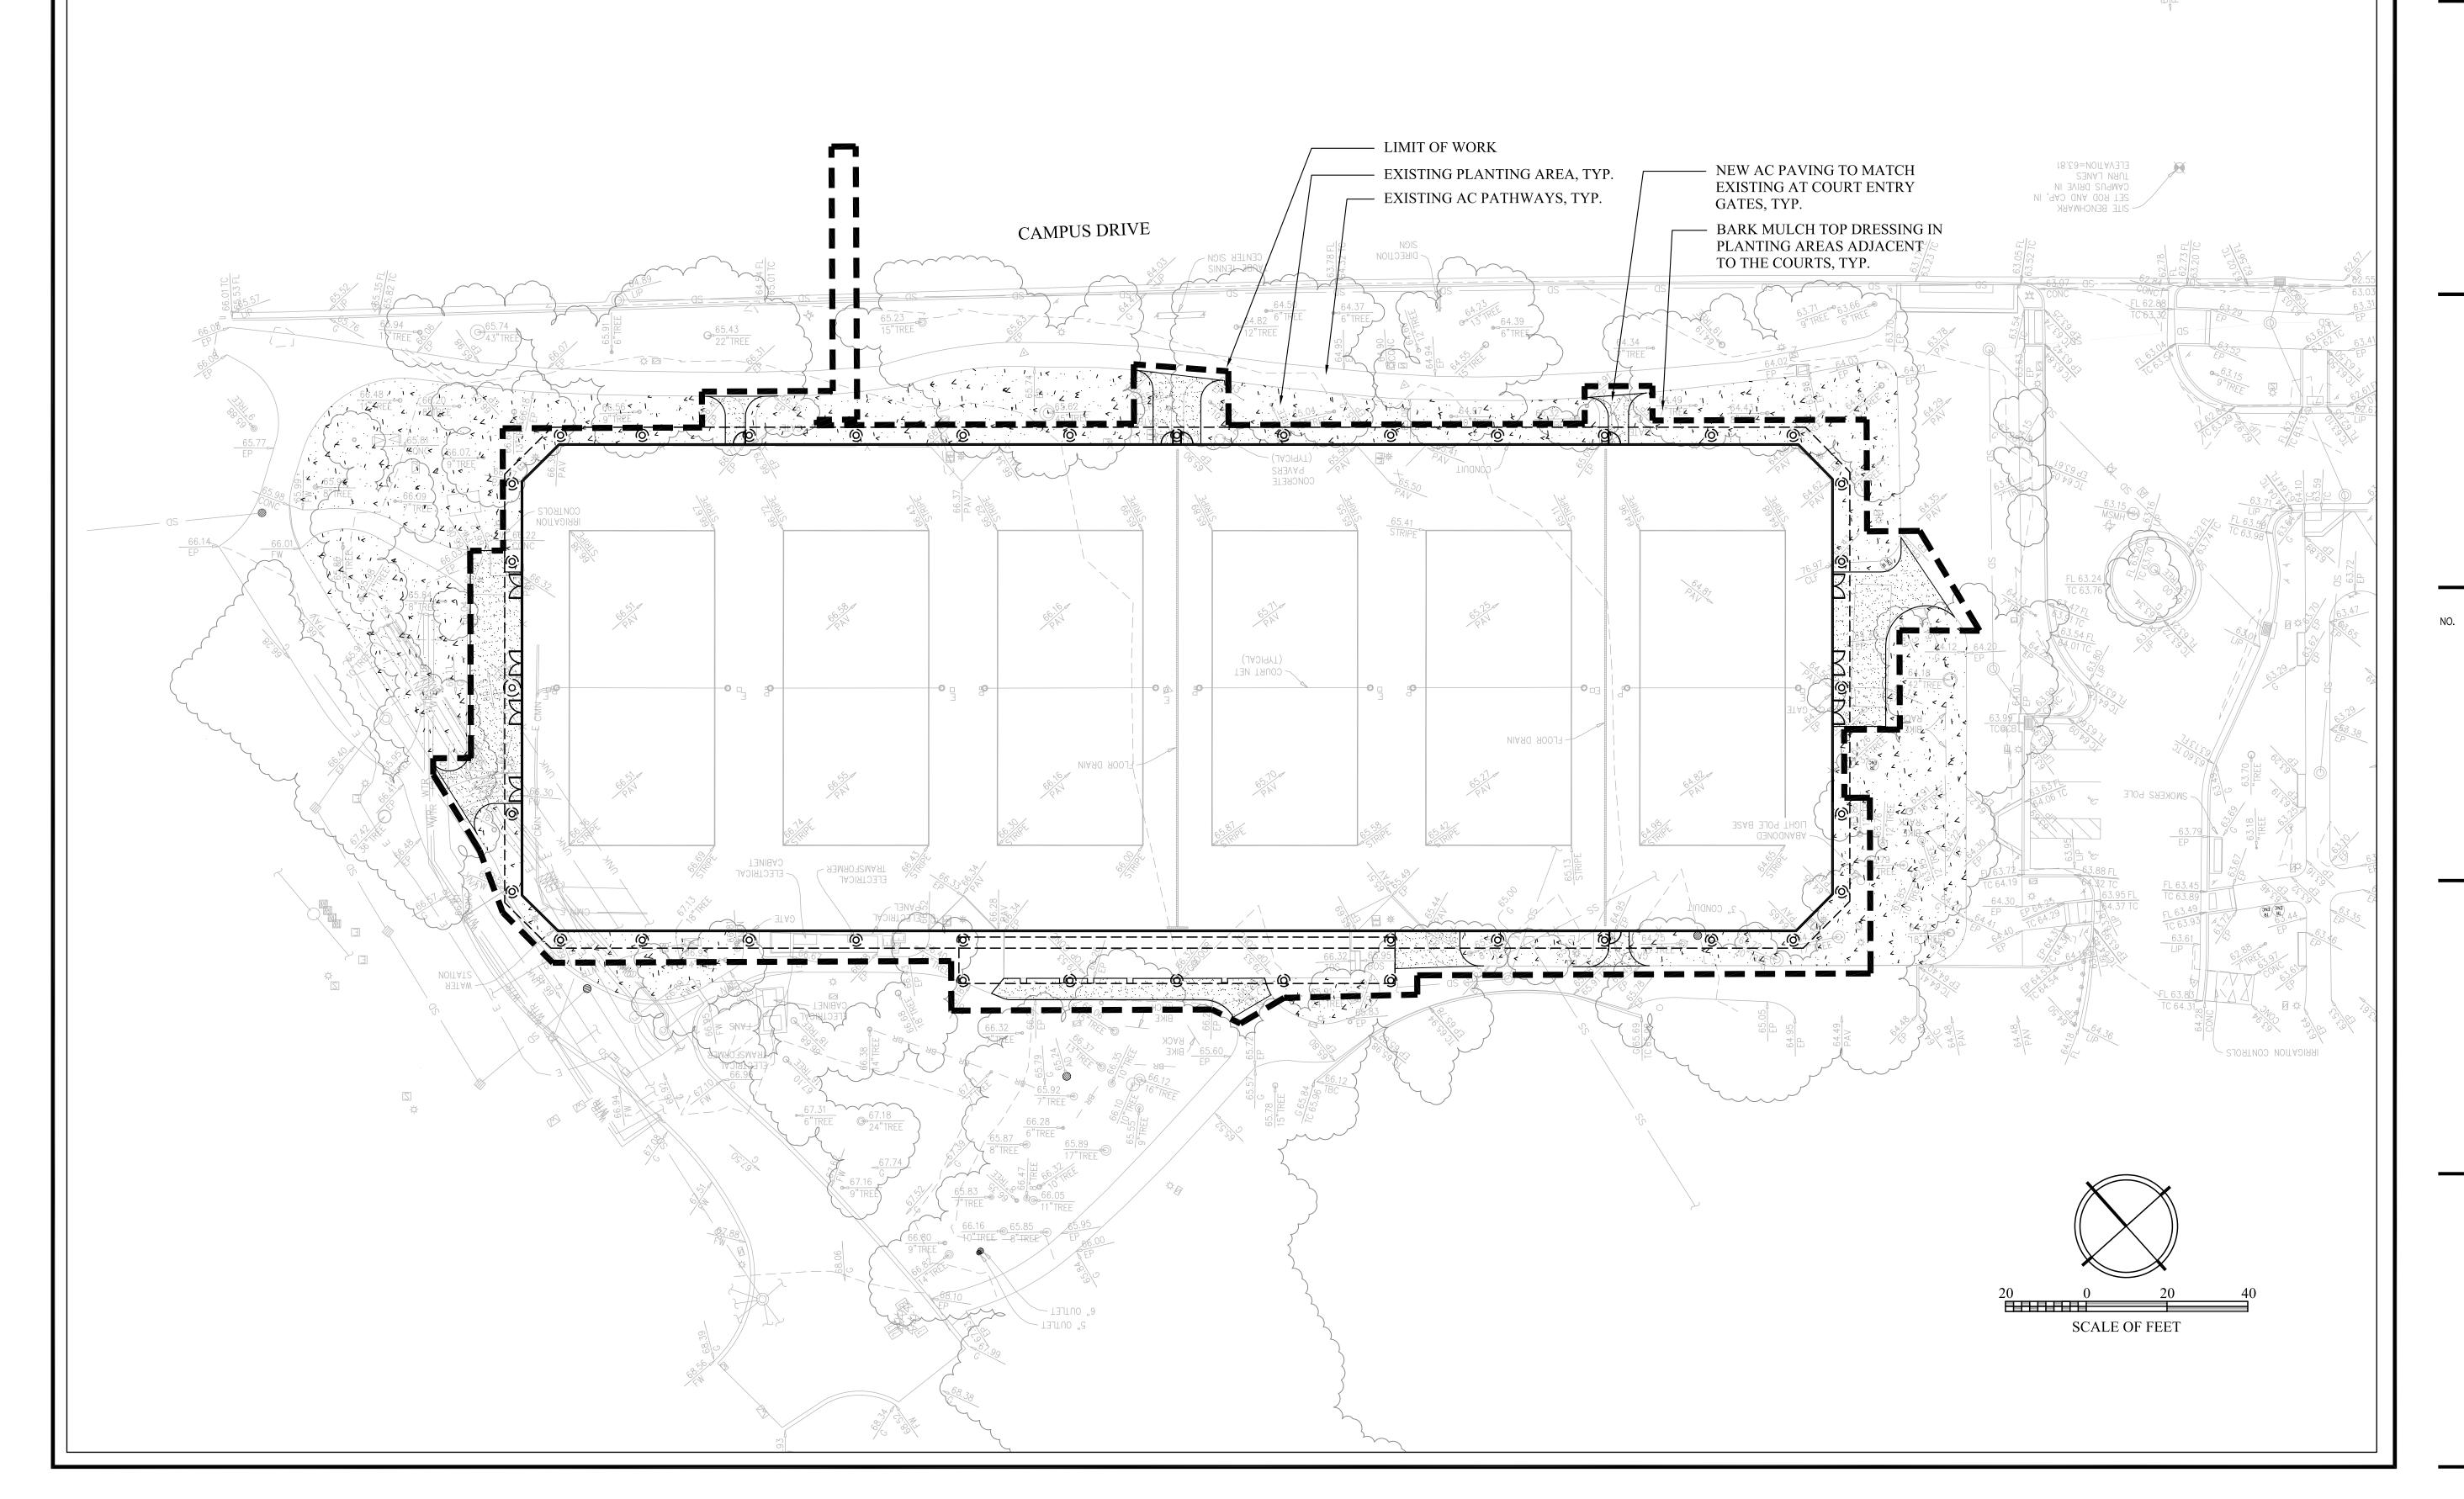

### STANFORD UNIVERSITY

Project Name: Covered Tennis Courts Project Address: 638 Campus Drive, Stanford CA. 94305 Quad/ Bldg. Number: 08-025



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Landscape Architects
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ISSUES AND REVISIONS

DATE DESCRIPTION

03.01.2023 ASA SUBMITTAL

PROJECT NUMBER

LANDSCAPE PLAN

SCALE 1" = 20'-0"

SHEET NUMB

L-1.01