County of Santa Clara

Department of Planning and Development

County Government Center, East Wing, 7th Floor 70 West Hedding Street San Jose, CA 95110

Phone: (408) 299-5700 www.sccplandev.org



STAFF REPORT Zoning Administration August 3, 2023

Item #1

Staff Contact: Lulu Pang, Assistant Planner (408) 299-5718, lulu.pang@pln.sccgov.org

PLN23-050 (STANFORD UNIVERSITY)

Architecture and Site Approval – New Covering Over Existing Stanford University Taube South Tennis Courts

Summary: Architecture & Site Approval for the construction of a new 41,368 square feet (sq. ft.) structure to cover the existing Taube South tennis courts, and associated site improvements. The existing tennis courts and precast concrete bleachers will be retained on the site. No protected tree is proposed to be removed. No grading or exterior lighting is proposed as part of this project.

Owner: Stanford University Community Plan Designation:

 Applicant:
 Mark Bonino, Project Manager
 Academic Campus

Address: 638 Campus Drive, Stanford **Zoning**: A1

APN: 142-04-036 **Project Area**: 49,063 sq. ft. / 1.1 acres

Supervisorial District: 5

RECOMMENDED ACTIONS

- A. Approve the use of a prior California Environmental Quality Act (CEQA) document [2000 Stanford Community Plan and General Use Permit (GUP) Program Environmental Impact Report (EIR)]; and,
- B. Grant an Architecture & Site Approval, pursuant to Conditions of Approval outlined in Attachment B.

ATTACHMENTS INCLUDED

Attachment A – CEQA Determination – Use of a Prior CEQA Document

Attachment B – Preliminary ASA Conditions of Approval

Attachment C – Location & Vicinity Map

Attachment D - Proposed Plans

PROJECT DESCRIPTION

The proposed project is for the construction of a new 41,368 sq. ft. structure to cover the existing Taube South tennis courts and associated site improvements. The project includes the demolition of the existing eight (8) light poles. The existing tennis courts, and precast concrete bleachers will be retained on the site. The site is surrounded by other Stanford athletic facilities including the Arrillaga Center for Sports and Recreation to the west, and Zambrano Hall to the south. El Camino Real is located approximately 2,300 feet northeast of the project site. Attachment C includes a location and vicinity map of the project site.

No new parking spaces are proposed as part of this project. One (1) oak tree with a trunk size of 10 inches in diameter at 4.5 feet above grade is proposed to be removed. The tree proposed for removal is not a protected tree per the County of Santa Clara tree preservation ordinance and is not required to be replaced. No tree is proposed to be planted on site.

No grading work or new exterior lighting is proposed as part of this project.

REASONS FOR RECOMMENDATION

A. Environmental Review and Determination (CEQA)

The proposed project is in conformance with both the 2000 Stanford Community Plan (SCP) and GUP and has no new effects beyond those analyzed in the Program EIR, certified by the Board of Supervisors in December 2000. The Program EIR analyzed the environmental impacts of campus development allowed under the SCP and GUP. The proposed project is within the scope of the campus development analyzed in the 2000 GUP. Therefore, the use of the prior CEQA document is adequate for this project.

B. Project/Proposal

1. Stanford Community Plan and GUP: The project conforms to applicable Community Plan goals, strategies, and policies. Academic Support uses like the athletic facilities (tennis courts) are permitted uses within the Academic Campus land use designation, and as conditioned will satisfy the requirements of the GUP. The 2000 Community Plan and GUP govern development projects on the Stanford campus. This project conforms to the criteria set forth by the GUP and provisions identified within the Community Plan and is subject to compliance with the preliminary conditions outlined in Attachment B.

2. ASA approval:

Architecture & Site Approval (ASA) approval standards, applicable regulations, and findings: The project substantially conforms to the requirements and guidelines in the SCP and GUP. These requirements meet all of the ASA Guidelines through the ASA approval process approved by the Zoning Administrator.

C. ASA Findings:

Pursuant to §5.40.040 of the County Zoning Ordinance, the Zoning Administrator may grant an Architecture & Site Approval contingent upon specific findings. In the following discussion, the scope of review findings is listed in **bold**, and an explanation of how the project meets the required standard is in plain text below.

A. Adequate traffic safety, on-site circulation, parking and loading areas, and insignificant effect of the development on traffic movement in the area;

Long-term traffic

The project is located within an established area of the Stanford academic campus with adequate parking facilities. Traffic impacts of academic and academic support projects in the core of the campus have been assessed in the programmatic 2000 GUP EIR. These traffic impacts are not dependent on the location of academic projects, as occupants of these buildings will travel to established parking areas, not to the proposed building itself. The proposed project is to renovate the existing Taube South tennis courts with a new covering. As such, the project does not generate any new trips from a traffic impact perspective as there is no increase in capacity associated with the project. Additionally, the traffic would be consistent with that analyzed in the 2000 GUP EIR.

Short-term construction traffic

The project will result in short-term impacts related to construction activities; however, conditions of approval have been added to this project to mitigate these short-term impacts to a "less than significant level". All construction trucks will be required to use approved truck routes, for transporting construction materials to and from the site. Furthermore, the project has been conditioned to restrict construction material deliveries to non-peak hours, as defined in the 2000 GUP EIR. Compliance with the Conditions of Approval (Attachment B) ensures that the short-term construction traffic associated with the project will not have a significant effect on traffic movement in the area.

Parking

Stanford addresses parking needs at the University in a comprehensive manner, staying within the parking cap established under the 2000 GUP. The project does not propose adding to or removing existing parking spaces, as the existing parking is adequate for the proposed development. The nearest commuter and visitor parking can be found at Sam McDonald Mall, in the Varsity Parking Lot, and on Bonair Siding Road, in the Maples Parking Lot.

For the reasons stated above, this finding *can* be made.

B. Appearance of proposed site development and structures, including signs will not be detrimental to the character of the surrounding neighborhood or zoning district;

The new covering over the existing Taube South tennis courts will not be detrimental to the character of the surrounding neighborhood. The project site is located in Stanford's Department of Athletics, Physical Education and Recreation (DAPER) and Administrative Development District, surrounded by other Stanford athletic facilities

including the Arrillaga Center for Sports and Recreation to the west, and Zambrano Hall to the south (Attachment D, sheet PL1.2).

The proposed new structure to cover the tennis courts will include a 41,368 sq. ft. metal deck roof supported by structural components such as round columns, flange beams, and structural cables. Existing tennis courts and bleachers will be retained on the site. To provide a compatible design with the other athletic facilities in DAPER District, the proposed covering includes a flat roof and comparable materials palette. The brown color of the mesh screen and the grey color of the structural components will match the surrounding buildings (shown on sheet A3-1 of Attachment D).

No exterior lighting is proposed for this project. Interior lighting under the roof and within the façade will be included in the project. Eight (8) existing light poles that are located around the outside perimeter of the tennis courts will be removed from the site.

As such, the new covering over the existing Taube South tennis courts would conform with the surrounding area and will not be detrimental to the character of the surrounding neighborhood or zoning district.

For the reasons stated above, this finding *can* be made.

C. Appearance and continued maintenance of proposed landscaping will not be detrimental to the character of the surrounding neighborhood or zoning district;

The GUP and the SCP require that replacement trees, for those removed that are 12 inches or greater in diameter at 4.5 feet from grade level, be planted at a 1:3 ratio for all protected oak trees and at a minimum 1:1 ratio for all protected non-oak trees. One oak tree with a trunk size of 10 inches in diameter at 4.5 feet above grade is proposed to be removed. The tree proposed for removal is not a protected tree per the County of Santa Clara tree preservation ordinance and is not required to be replaced. No tree is proposed to be planted on site. All other trees in the project area shall remain and will be considered protected after approval of this project (shown on sheet L-1.01 of Attachment D).

A preliminary landscape plan was submitted by the applicant for review. The landscape design for this project preserves the existing landscaping at the tennis courts. Planting areas adjacent to the courts will be top-dressed with bark mulch and areas at court entry gates will have new concrete paving to match existing conditions around the project site. No issues of concern were identified, and the preliminary landscape plan meets County requirements. Staff has added a condition of approval requiring that the landscaping meet the requirements of the SCP and GUP. The final landscape plan is also subject to the requirements of the County Sustainable Landscape Ordinance. The final landscape plan will not be detrimental to the surrounding area and will blend in with the area's surrounding character.

As such, this finding *can* be made.

D. No significant, unmitigated adverse public health, safety and environmental effects of proposed development;

The Program GUP EIR certified by the Board of Supervisors in December 2000 analyzed the environmental impacts of Stanford campus development allowed under the SCP and GUP. The proposed project is within the scope of the development analyzed in the 2000 GUP EIR. All appropriate conditions of approval have been added to ensure conformance with the 2000 GUP EIR.

The prior CEQA analysis concluded that the proposed development would not result in any significant environmental impacts as it relates to parking, traffic, construction noise, and air quality. The project has been reviewed with respect to all applicable regulations relating to public health and safety by County subject matter experts, including Land Development Engineering, Department of Environmental Health, and the Fire Marshal. All subject matter experts have recommended approval of the project with Conditions and determined that the project will not result in significant, unmitigated adverse public health, safety, or environmental effect. Furthermore, the CEQA analysis for the project determined that with the conditions of approval, the project would not result in any significant environmental impacts (See Attachment A).

As such, this finding *can* be made.

E. No adverse effect of the development on flood control, storm drainage, and surface water drainage;

The project site does not contain any creeks or streams and is not located within a 100-year flood zone. The project has been reviewed by County Land Development and Engineering staff with respect to all applicable regulations relating to drainage and flood control. As such, this finding can be made.

F. Adequate existing and proposed fire protection improvements to serve the development;

The Fire Marshal's Office has reviewed and conditioned the project to ensure existing and proposed fire protection access and water supply are in conformance with applicable regulations. Additionally, Conditions of Approval no. 26 through 29 (Attachment B) have been included to ensure compliance with County regulations relating to fire protection. For these reasons, this finding *can* be made.

G. No significant increase in noise levels;

The project is not anticipated to cause any significant increases in noise levels to the surrounding neighborhoods, due to its location within DAPER District, surrounded by other Stanford athletic facilities.

The project may create short-term/temporary construction noise impacts due to construction activities and construction traffic. The project has been conditioned to limit

construction activities to the hours of 7 AM and 7 PM, Monday through Saturday, with no construction activity occurring between the hours of 7 PM and 7 AM, or on Sundays.

Therefore, as conditioned, this finding *can* be made.

H. Conformance with zoning standards, unless such standards are expressly eligible for modification by the Zoning Administrator as specified in the Zoning Ordinance.

The project site is zoned A1, which is the "General Use" zoning district that provides for general purpose uses subject to discretionary land use approvals. The standards applicable to development within this zoning district are listed in Table 2.50-2 of the County Zoning Ordinance, which establishes a 35-foot maximum height requirement for the A1 district.

The proposed new covering has a maximum height of 44 feet, as measured from the finish floor to the top of the parapet (shown on sheet A3-2 of Attachment D). The proposed covering is 9 feet over the 35-foot standard height limit typically allowed in the A1 district. The Zoning Administrator is allowed to make an exception to the 35 feet height limitation, subject to the following limitations:

- 1. Nonresidential uses adjacent to any residentially developed property may be required to provide a minimum front yard setback equal to that of the adjacent residential use; and
- 2. Nonresidential uses adjacent to any residentially developed property shall be required to provide a minimum side and rear yard setback equal to one-half the height of the building closest to the setback, or five (5) feet, whichever is greater.

Since the proposed new covering over the existing Taube South tennis courts is not situated adjacent to residential uses as all buildings in the neighboring area are athletic facilities, the limitations for granting an exception to the maximum height noted above do not apply to this project. Additionally, the proposed covering is compatible with the existing height of the surrounding buildings in the DAPER District. The surrounding building heights of existing buildings range from 39 feet (Arrillaga Hall) to 50 feet (Zambrano Hall).

As such, Staff recommends support of the increase to the height limitations for this project, and this finding *can* be made.

I. Conformance with the general plan and any applicable area or specific plan, or, where applicable, city general plan conformance for property located within a city's urban service area; and

The Stanford academic campus is primarily designated as Major Educational and Institutional Use within the Santa Clara County General Plan. The Community Plan identifies the project site for Taube South Tennis Courts as Academic Campus. The proposed project is a construction of a new covering for an existing athletic facility and complies with the applicable policies set forth in the Community Plan with reference to

SCP-LU1 and SCP-LU2, which state that allowable academic uses include athletics, physical education, and recreation facilities. As such, this finding *can* be made.

J. Substantial conformance with the adopted "Guidelines for Architecture and Site Approval" and other applicable guidelines adopted by the County.

Some suggested regulations that are addressed in the ASA Guidelines are superseded by the requirements and guidelines of the SCP and GUP. Nonetheless, conformance with the SCP and GUP is consistent with the ASA Guidelines. Specifically, the proposed project complies with the landscaping guidelines set forth in the ASA Guidelines as the landscaping blends with vegetation on nearby properties, and natural vegetation is retained to the extent feasible. As such, this finding *can* be made.

BACKGROUND

On December 12, 2000 the County of Santa Clara approved the 2000 Stanford University Community Plan and GUP, governing development projects on the Stanford campus. The GUP allows Stanford to construct up to 2,035,000 net sq. ft. of academic and academic support uses, 3,018 new housing units, and 2,300 net new parking spaces on Stanford lands. The GUP was subsequently amended three times to move permitted academic square footage from one district to another, provide flexibility in the type of housing construction, and for additional housing.

The proposed new covering for the Taube South tennis courts is a 41,368 sq. ft. structure designed as unconditioned space, which is not counted as GUP square footage. The site is located within the DAPER and Administrative Development District. As of July 2023, the existing GUP square footage in the District is **79,494** sq. ft. As the project does not have any GUP square footage, after the addition of the new covering for the Taube South tennis courts, the District would still have a remaining balance of **79,494** sq. ft.

On March 23, 2023, an application for Architecture and Site Approval was submitted for the new covering over the existing Taube South tennis courts. The application was deemed incomplete on April 21, 2023, and was resubmitted on June 5, 2023. Subsequently, the application was deemed complete on June 29, 2023. As of writing this report, no public comments were received for this application. A public notice was mailed to all property owners within a 300-foot radius and the interested parties list on July 24, 2023, and was also published in the Post Records on July 24, 2023.

-Docusigned by:

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STAFF REPORT REVIEW

Prepared by: Lulu Pang, Assistant Planner

7/27/2023

Reviewed by: Samuel Gutierrez, Principal Planner

7/27/2023

DocuSigned by:

ATTACHMENT A

Use of A Prior CEQA Document

USE OF A PRIOR CEQA DOCUMENT PROGRAM ENVIRONMENTAL IMPACT REPORT (EIR)

Pursuant to Section 15162 of the CEQA Guidelines, the County of Santa Clara has determined that the project described below is pursuant to or in furtherance of an Environmental Impact Report which has been previously adopted and does not involve new significant impacts beyond those analyzed in the previous Environmental Impact Report.

File Number	APN(s)	Date		
PLN23-050	142-04-036	August 03, 2023		
Project Name	Project Type			
New Covering Over Existing Taube South Tennis Courts	Architecture and Site Approval			
(Stanford University)				
Owner	Applicant			
Stanford University	Mark Bonino, Project Manager			
Project Location				
638 Campus Drive, Stanford				
Project Description				

Architecture & Site Approval (ASA) for the construction of a new 41,368 square feet structure to cover the existing Taube South tennis courts, and associated site improvements. The existing tennis courts and precast concrete bleachers will be retained on the site. No protected tree is proposed to be removed. No grading or exterior lighting is proposed as part of this project.

Background and Summary of Findings

Per the California Environmental Quality Act (CEQA) of 1970 (as amended), all development permits processed by the County Planning Office which require discretionary approval are subject to environmental review. A new Negative Declaration or EIR is not required if a previous CEQA document has been prepared and adopted or certified which adequately addresses all the possible environmental impacts of the proposed project and (a) no substantial changes are proposed in the project which will result in new significant environmental effects, (b) no substantial changes have occurred with respect to the circumstances under which will result in the identification of new significant impacts, or (c) no new information is available which shows that the project will have new significant impacts or mitigation measures and alternatives which were previously found to be infeasible would now in fact be feasible (CEQA Guidelines 15162).

The Planning Office evaluated the project described above and has determined that none of the circumstances exist which would require additional environmental review. As such the environmental impacts of the project have been adequately evaluated in the Environmental Impact Report adopted by the Board of Supervisors on December 15, 2000, for the project entitled "Stanford University Community Plan and General Use Permit" and that no further environmental review is required under the California Environmental Quality Act.

	DocuSigned by:	
Prepared by: Lulu Pang, Assistant Planner	Lulu Pang	7/27/2023
	Signature	Date

File PLN23-050 Attachment A

ATTACHMENT B

Preliminary ASA Conditions of Approval

ATTACHMENT B

PRELIMINARY CONDITIONS OF APPROVAL FOR ARCHITECTURE & SITE APPROVAL

Date: August 3, 2023

Owner/Applicant: Stanford University

Location: 638 Campus Drive, Stanford (APN: 142-04-036)

File Number: PLN23-050

CEQA: Prior CEQA - 2000 Stanford Community Plan and General Use Permit

(GUP) Program Environmental Impact Report (EIR)

Project Description: Architecture & Site Approval for the construction of a new 41,368 square

feet (sq. ft.) structure to cover the existing Taube South tennis courts, and associated site improvements. The existing tennis courts and precast concrete bleachers will be retained on the site. No protected tree is proposed to be removed. No grading or exterior lighting is proposed as part of this

project.

If you have any questions regarding the following preliminary conditions of approval, call the person whose name is listed as the contact for that agency. They represent a specialty or office and can provide details about the conditions of approval.

Agency	Name	Phone	E-mail
Planning	Lulu Pang	(408) 299-5718	lulu.pang@pln.sccgov.org
Land Development Engineering	Ed Duazo	(408) 299-5733	ed.duazo@pln.sccgov.org
Fire Marshal	Alex Goff	(408) 299-5763	alex.goff@sccfd.org
Environmental Health	Darrin Lee	(408) 573-2464	darrin.lee@cep.sccgov.org
Building Inspection	Building Inspection Office	(408) 299-5700	

STANDARD CONDITIONS OF APPROVAL

Building Inspection

1. For detailed information about the requirements for a building permit, obtain a Building Permit Application Instruction handout from the Office of Building Inspection or visit their website (www.sccbuilding.org).

Planning

- 2. Development and maintenance of the project site shall take place in accordance with approved plans, received by the Planning Department on June 5, 2023. The project allows the construction of the new covering over the existing Taube South tennis courts and associated site improvements. The plans submitted into Plan Check shall be in substantial conformance with the approved plans. Any changes to the approved project included such as (but not limited to) the design, quantity, location or other modifications to the approved plans are required to be submitted for review by the Planning Office and may result in a Modification to the approved ASA may be subject to additional review under the California Environmental Quality Act (CEQA).
- 3. File and obtain demolition and building permits for the project.
- 4. The project shall comply with the Stanford University 2000 General Use Permit Conditions of Approval, and approved Stanford University 2000 GUP Mitigation Monitoring and Reporting Program.
- 5. Stanford shall be responsible for paying all reasonable costs associated with work by the County Planning Department, or with work conducted under the supervision of the County Planning Office, in conjunction with, or in any way related to the conditions of approval identified in this project. This includes but is not limited to costs for staff time, consultant fees, and direct costs associated with report production and distribution.
- 6. In the event that previously unidentified historic or prehistoric archaeological resources are discovered during construction, the contractor shall cease work in the immediate area and the County Planning Office and Campus Archaeologist shall be contacted. An independent qualified archaeologist retained by the County at the expense of Stanford shall assess the significance of the find and make mitigation recommendations.
- 7. If archeological resources are discovered as described above, construction monitoring shall be conducted at any time ground-disturbing activities (greater than 12 inches in depth) are taking place in the immediate vicinity of the identified resources. If monitoring does not produce evidence of significant cultural resources within the project area, further mitigation shall be limited to construction monitoring, unless additional testing or other specific mitigation measures are determined by a qualified archaeologist to be necessary to ensure avoidance of damage to significant archaeological resources. A technical report of findings describing the results of all monitoring shall be prepared in accordance with professional standards. The archaeological monitoring program shall be implemented by an individual meeting the Secretary of Interior Professional Qualifications Standards in Archaeology (36 CFR 61); individual field monitors shall be qualified in the recognition of cultural resources and possess sufficient academic and field training as required to conduct the work effectively and without undue delay.

- 8. In the event that human skeletal remains are encountered, the applicant is required by County Ordinance No. B6-18 to immediately notify the County Coroner. Upon determination by the County Coroner that the remains are Native American, the coroner shall contact the California Native American Heritage Commission, pursuant to subdivision (c) of section 7050.5 of the Health and Safety Code and the County Coordinator of Indian affairs. No further disturbance of the site may be made except as authorized by the County Coordinator of Indian Affairs in accordance with the provisions of state law and this chapter. If artifacts are found on the site a qualified archaeologist shall be contacted along with the County Planning Office. No further disturbance of the artifacts may be made except as authorized by the County Planning Office.
- 9. In the event that a fossilized shell or bone is uncovered during any earth-disturbing operation, contractors shall stop work in the immediate area of the find and notify the Campus Archaeologist and the County Building Inspector assigned to the project. The Campus Archaeologist shall visit the site and make recommendations for treatment of the find (including but not limited to consultation with a paleontologist and excavation, if warranted), which would be sent to the County Building Inspection Office and the County Planning Office. If a fossil find is confirmed, it will be recorded with the United States Geological Survey and curated in an appropriate repository.

Department of Environmental Health

10. All construction activities shall be in conformance with the Santa Clara County Noise Ordinance Section B11-154 and prohibited between the hours of 7:00 p.m. and 7:00 a.m. on weekdays and Saturdays, or at any time on Sundays for the duration of construction.

<u>CONDITIONS OF APPROVAL TO BE COMPLETED PRIOR TO BUILDING PERMIT ISSUANCE</u>

Planning

- 11. Place a construction note on the site plan that states the following: "The Bay Area Air Quality Management District (BAAQMD) has identified a set of feasible PM10 control measures for all construction activities. These control measures, as previously required in the Program EIR, shall be adhered to during all construction activities.
 - A. Water all active construction areas at least twice daily;
 - B. Cover all trucks hauling soil, sand, and other loose materials or require all trucks to maintain at least two feet of freeboard;
 - C. Pave, apply water three times daily, or apply (non-toxic) soil stabilizers on all unpaved access roads, parking areas and staging areas at construction sites;
 - D. Sweep daily (with water sweepers) all paved access roads, parking areas and staging areas at construction sites;
 - E. Sweep streets daily (with water sweepers) if visible soil material is carried onto adjacent public streets;

- F. Hydroseed or apply (non-toxic) soil stabilizers to inactive construction areas (previously graded areas inactive for ten days or more);
- G. Enclose, cover, water twice daily or apply (non-toxic) soil binders to exposed stockpiles (dirt, sand,);
- H. Limit traffic speeds on unpaved roads to 15 mph;
- I. Install fiber rolls, sandbags or other erosion control measures to prevent silt runoff to public roadways;
- J. Replant vegetation in disturbed areas as quickly as possible;
- K. Install wheel washers for all existing trucks, or wash off the tires of tracks of all trucks and equipment leaving the site; and
- L. Suspend excavation and grading activity when winds (instantaneous gusts) exceed 25 mph."
- 12. Place a construction note on the site plan that states the following: "All construction contractors shall properly maintain the equipment and where feasible, use "clean fuel" equipment and emissions control technology (e.g., CNG fired engines, catalytic converters, particulate traps, etc.). Measures to reduce diesel emission would be considered feasible when they are capable of being used on equipment without interfering substantially with equipment performance."
- 13. Submit a site plan that shows all pedestrian and bicycle corridors along with public transit stops adjacent to the project site and indicate how bicycle, pedestrian, and public transit access and circulation will be maintained during construction. Bicycle and pedestrian access onto the campus and around the site (outside construction areas) shall not be substantially limited by construction activities associated with the project. In addition, access to public transit shall not be limited, which could include the relocation or removal of adjacent bus stops.
- 14. Final plans shall include the following construction notes:
 - A. Stanford shall make feasible attempts to limit the number of construction material deliveries from 7:00 a.m. to 9:00 a.m. and from 4:00 p.m. to 6:00 p.m. (peak-hours) on weekdays. Construction material delivery shall not result in reduction in on-street parking; reduction in pedestrian, bicycle, and public transit access; use of non-truck routes by construction traffic; damage to roadways; and interference with special events (This construction note shall be included in the Final permit plans). Stanford shall provide estimated total construction material deliveries, as well as estimated material deliveries, between these peak-hours as part of the Construction Logistics and Management Plan, and provide notice to residents and interested parties for deliveries during peak hours.
 - B. Trucks exporting/importing dirt and building materials for the project shall use approved truck routes shown in the 2000 GUP, as designated by the cities of Palo Alto and Menlo Park.

- 15. Submit a Construction Management and Logistics Plan for approval by Planning and Land Development Engineering, **prior to issuance of any building permits,** that clearly identifies the elements listed below:
 - A. Provide the location, anticipated quantities and time frame for construction staging and earthwork stockpiling associated with this project. Said location is required to be approved by Planning and Land Development Engineering.
 - B. Provide off-street construction related parking. Identify off-street parking location(s) on site plan for all construction related vehicles (employee parking and construction equipment) throughout the construction period. If adequate parking cannot be provided on the construction sites, identify on the site plan or vicinity map the satellite parking location(s) that will be used.
 - C. Prohibit impacts to accessing public transit access and movement of public transit vehicles. Identify on site plan all temporary or permanent access limitations, re-routes, lane closures, or limits to public transit movements or place a note on the site plan stating "No temporary or permanent access limitations, re-routes, lane closures, or limits to public transit movement are permitted."
 - D. Prohibit roadway construction activities from reducing roadway capacity during Stanford major athletic and special events. Stanford shall not limit roadway capacity during special events or during major athletic events, which attract a large number of visitors to the campus.
 - E. Provide written notification to Stanford Police and Palo Alto Fire Department regarding construction location and construction dates. Include in the notices alternate evacuation and emergency route designations to maintain response times during construction periods, if applicable. Provide one copy of the notices to the County.
 - F. Provide written notification to all contractors and subcontractors regarding appropriate routes and weight limits and speed limits for local roads used to access construction sites. Provide one copy of the notices to the County Planning Office.
 - G. Provide notification to the Cities of Palo Alto and Menlo Park of the construction schedule and include a copy of the Santa Clara County approved Construction and Traffic Management Plan. Provide one copy of the notices to the County Planning Office.
- 16. The following tree removal/protection requirements shall apply:
 - A. No tree with a trunk size of 12 inches in diameter at 4.5 feet above grade is authorized for removal with this project (refer to approved plan page L-1.01).
 - B. All trees in the project area shall remain and are protected after the approval of this Architecture and Site Approval, per plan page L-1.01.
 - C. If any trees are proposed to be removed after the approval of the ASA, further review by the Planning Office may be required to assess the visual impact of the tree removal on the project and surrounding area.
 - D. Final plans shall show the size and species of all trees over 12 inches in diameter (at 4.5 feet above grade) within the proposed work area for the project and clearly label all trees proposed for removal. This shall include all trees where construction will occur within the dripline of the tree.

- E. An I.S.A.-certified arborist shall review final plans. The objective shall be to ensure that all the trees adjacent to the improvements will not be damaged or removed.
- F. A certified arborist shall monitor the construction and provide written recommendations to preserve any potentially impacted trees associated with the proposed improvements. Submit a plan-review letter **prior to the issuance of the final Building permit** evaluating consistency of final plans with these mitigations and a construction-observation **letter prior to the issuance of final occupancy** summarizing implementation of these mitigation measures.
 - i. Provide an arborist report that recommends effective tree protection measures for the site's existing trees that have not been slated for removal. Protection measures must be in place prior to construction activity commencing.
- 17. Adequate signs shall be posted along the street frontages or in front of the project site, no smaller than 1,296 square inches in size, containing the name, telephone number, and email address of the appropriate Stanford person the public may contact to register a complaint about construction noise. Additionally, Stanford shall create an outreach and information portal to facilitate information and alerts to be delivered to the immediate neighborhoods on construction activities. Stanford shall keep a written record of all such complaints and shall provide copies of these records to the County Planning Office.
- 18. Preconstruction surveys for nesting raptors and migratory birds shall be conducted by a qualified ornithologist to identify active nests that may be disturbed during project implementation. Between January 1 and April 30, preconstruction surveys shall be conducted no more than 14 days **prior to the initiation of construction activities or tree removal**. Between May 1 and August 31, preconstruction surveys no more than 30 days **prior to the initiation of these activities**. Stanford University shall conduct an additional preconstruction survey within 24 hours of initiation of construction activities, by the Campus Biologist, to verify no new nesting has occurred. If an active nest is found near, or in close proximity to, the construction area where the nest could be disturbed by these activities, the ornithologist or Campus Biologist, shall, in consultation with the California Department of Fish and Game, designate a construction-free buffer zone (typically 250 feet) around the nest.
- 19. Landscape Plan: The requirements of Division B33 of the County Ordinance Code (Sustainable Landscape Ordinance) shall apply. As proposed, if the total landscape area exceeds 2,500 sq. ft., a landscape documentation package shall be included in the plan set submitted for development permits (building permits) **prior to building permit issuance** for review and approval by the Development of Planning and Development. New landscaping shall be similar to existing landscaping on-site and meet all Stanford Community Plan and General Use Permit requirements. The submittal shall include a landscaping plan and irrigation plan, stamped and signed by a licensed landscape architect. Submit two (2) copies of the final landscape plan and associated irrigation systems, prepared and stamped by a licensed landscape architect.

The landscape ordinance and supporting information can be found on the Planning Department web site: https://plandev.sccgov.org/landscape-ordinance

20. Incorporate any applicable water conservation and recycling measures into the project building plans, which may include but not be limited to: water efficient landscape, landscape water management, and public outreach.

Land Development Engineering

- 21. Survey monuments shall be shown on the improvement plan to provide sufficient information to locate the proposed improvements and the property lines. Existing monuments must be exposed, verified and noted on the grading plans. Where existing monuments are below grade, they shall be field verified by the surveyor and the grade shall be restored and a temporary stake shall be placed identifying the location of the found monument. If existing survey monuments are not found, temporary staking delineating the property line may be placed prior to construction and new monuments shall be set prior to final acceptance of the improvements. The permanent survey monuments shall be set pursuant to the State Land Surveyor's Act. The Land Surveyor / Engineer in charge of the boundary survey shall file appropriate records pursuant to Business and Professions Code Section 8762 or 8771 of the Land Surveyors Act with the County Surveyor.
- 22. The improvement plans shall include an Erosion and Sediment Control Plan that outlines seasonally appropriate erosion and sediment controls during the construction period). Include the County's Standard Best Management Practice Plan Sheets BMP-1 and BMP-2 with the Plan Set.
- 23. All new on-site utilities, mains and services shall be placed underground and extended to serve the proposed development. All extensions shall be included in the improvement plans. Off-site work should be coordinated with any other undergrounding to serve other properties in the immediate area.
- 24. In the building plans, include a stormwater management plan that details how the project complies with Provision C.3 of the current NPDES Municipal Regional Permit (MRP). Include C.3 sizing calculations to support the information provided in the stormwater management plan.
- 25. Submit an updated Credit/Usage Capacity Tracking Sheet for the Stanford University East Campus C.3 Regional Stormwater Capture Facility.

Fire Marshal's Office

Note- This review was for Land Use only. A more detailed review will be conducted at Building Permit submittal to include Fire Life Safety.

Fire Protection Water

Important: Fire protection water system shall be installed, functioning and inspected prior to approval of the foundation. System shall be maintained in good working order and accessible

throughout construction. A stop work order may be placed on the project if the required hydrant systems are not installed, accessible, and/or functioning.

- 26. Fire-Flow: The minimum fire-flow to be 2,125 Gallons Per Minute (gpm) at 20 psi per Appendix B of the California Fire Code (CFC). Final flow will be based on the size of the structure and the construction type at Building Permit.
 - A. At the time of plan submittal for building permit, provide written verification from the water company that this condition can be satisfied. The hydrant flow data is to be recorded within 1 year.
 - B. Standard fire hydrant is to be located within 400 feet (ft.) exterior path of travel to all portions of structure.

Fire Department Access

- 27. General Requirements:
 - A. These are minimum Fire Marshal standards. Should these standards conflict with any other local, state or federal requirement, the most restrictive shall apply.
 - B. All required access roads, driveways, turnarounds, and turnouts shall be installed, and serviceable prior to approval of the foundation, and shall be maintained throughout construction. A stop work order may be placed on the project if required driving surfaces are not installed, accessible, and/or maintained at all times.
- 28. Fire Department Access shall comply with the following:
 - A. Width: Access Roads to have a clear drivable width of 20 ft.
 - B. Vertical Clearance: Minimum vertical clearance of 13 ft. 6 in shall be maintained to building site (trim or remove, tree limbs, electrical wires, structures, and similar improvements) for access roads and driveways.
 - C. Curve Radius: Plans to show minimum 30 ft. inside turn radius for curves and 50 ft. exterior turn radius.
 - D. Grade: Maximum grade shall not exceed 15%.
 - E. Surface: All driving surfaces shall be all-weather and capable of sustaining 75,000 pounds gross vehicle weight.
 - F. Address: Numbered address to be easily recognizable from the street.
- 29. Maintenance: Fire protection water systems and equipment shall be accessible and maintained in operable condition at all times and shall be replaced or repaired where defective. Fire protection water shall be made available to the fire department.

Fire department access shall be maintained free, clear, and accessible at all times for fire department use.

<u>CONDITIONS OF APPROVAL TO BE COMPLETED PRIOR TO OCCUPANCY OR</u> FINAL INSPECTION

Planning

- 30. All stockpiled materials shall be removed from the site and disposed of at an approved location.
- 31. Following completion of construction, contact the Planning Department (Lulu Pang at 408-299-5718) at least two weeks in advance to set up an appointment to schedule a site visit to verify the development as per approved plans and as conditioned by this approval.

Land Development Engineering

- 32. The project proposes use of expanded capacity from the East Campus Stormwater Capture Facility (County File No. 11044-17C3) to satisfy MRP requirements. The permit (DEV23-0612) to expand the facility's capacity is in the process of being reviewed/approved. Prior to final sign-off, the facility expansion shall be completed and on-line (i.e., the permit for DEV23-0612 shall have been issued and obtained final sign-off).
- 33. Existing and set permanent survey monuments shall be verified by inspectors prior to final acceptance of the improvements by the County. Any permanent survey monuments damaged or missing shall be reset by a licensed land surveyor or registered civil engineer authorized to practice land surveying and they shall file appropriate records pursuant to Business and Professions Code Section 8762 or 8771 of the Land Surveyors Act with the County Surveyor.
- 34. If there have been any changes to the stormwater management plan (e.g., a change in new/replacement impervious area, change in credit/capacity usage, etc.), submit an updated Credit/Usage Capacity Tracking Sheet with an as-built of the Stormwater Management Plan.


Fire Marshal's Office

35. Fire Sprinkler System: An approved NFPA 13 fire sprinkler system shall be installed throughout the structure.

NOTE: The fire sprinkler system shall be installed and finaled by this office **prior to occupancy.** A separate permit shall be obtained from this office by a state licensed C-16 contractor **prior to installation**. Please allow for a minimum of 30 days for plan review of fire sprinkler plans by this office.

ATTACHMENT C

Location and Vicinity Map

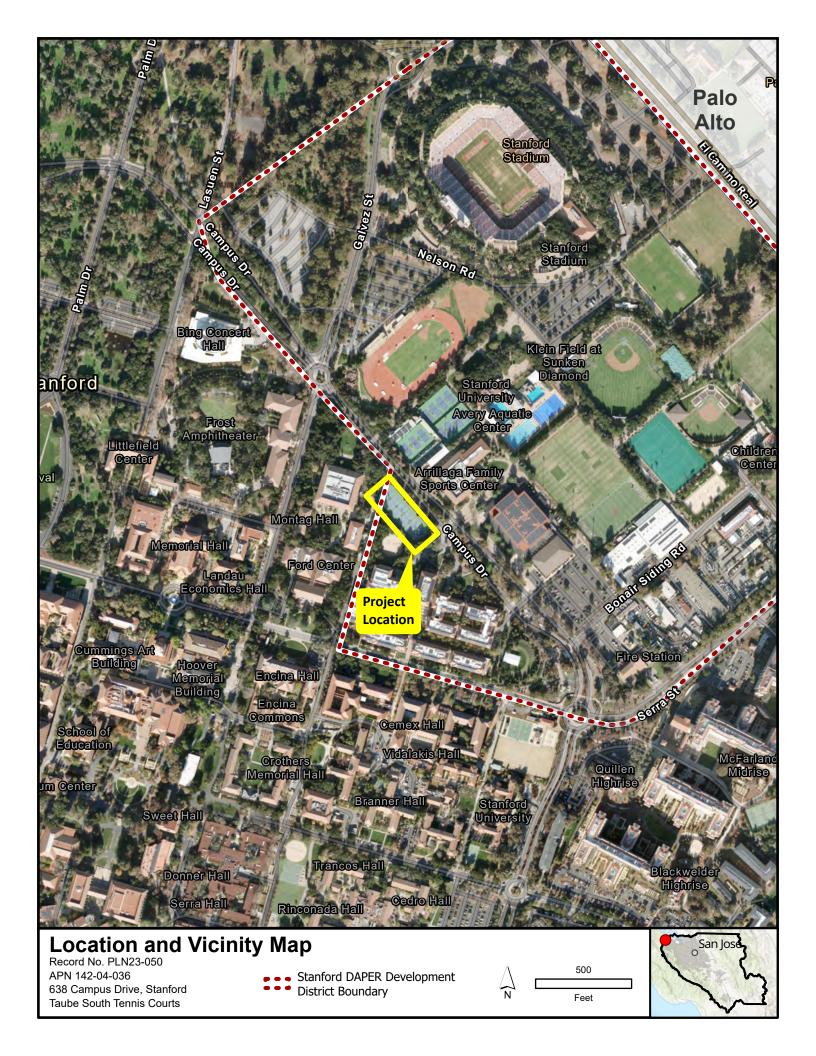

ATTACHMENT D

Proposed Project Plans

ASA RESUBMITTAL SET

STANFORD UNIVERSITY TAUBE SOUTH COVERED TENNIS COURTS

PROJECT 5674

DRAWING STATUS SUBMITTAL DATE: APPROVAL DATE: ASA RESUBMITTAL SET 05/31/2023

ASA RESUBMITTAL SET
ASA COMPLIANCE RE-SUBMITTAL
PERMIT APPLICATION
CONSTRUCTION PERMIT
RECORD DRAWINGS

05/31/2023 638 CAMPUS DRIVE

Stanford, California

Propesed site

VICINITY MAP

DEFERRED SUBMITTALS

- 1. FIRE SPINKLERS
- 2. FIRE ALARM SYSTEM & FA CONTROL PANEL ALARMS SHALL HAVE VOICE ACTIVATION PER CBC 907.5.2.2.

DRAWING INDEX

PL0.0 TITLE SHEET

PL1.2 GUP INFORMATION MAP

A1-0 COVERED TENNIS COURTS DEMO SITE PLAN
A1-1 COVERED TENNIS COURTS PROPOSED SITE PLAN
A1-2 COVERED TENNIS COURTS PROPOSED PLAN & RCP
A3-1 COVERED TENNIS COURTS CONTEXT ELEVATIONS
A3-2 COVERED TENNIS COURTS ELEVATIONS
A3-3 COVERED TENNIS COURTS ELEVATIONS
A3-4 COVERED TENNIS COURTS BUILDING ELEVATIONS
A3-5 COVERED TENNIS COURTS BUILDING ELEVATIONS
A3-6 COVERED TENNIS COURTS SECTIONS
A4-1 COVERED TENNIS COURTS RENDERINGS
A4-2 COVERED TENNIS COURTS RENDERINGS

C-1.0 COVER SHEET

C-1.1 COUNTY CONSTRUCTION NOTES

C-1.2 FIRE SAFETY NOTES

C-2.0 TOPOGRAPHIC SURVEY

C-3.0 DEMOLITION/TREE REMOVAL PLAN

C-3.1 DEMOLITION/TREE REMOVAL NOTES

C-4.0 GRADING AND DRAINAGE PLAN

C-5.0 UTILITY PLAN

C-6.0 STORMWATER MANAGEMENT PLAN

C-7.0 EROSION CONTROL PLAN

C-7.1 COUNTY BMP NOTES C-7.2 COUNTY BMP NOTES

C-8.0 CONSTRUCTION SITE LOGISTICS/

SAFETY PLAN

C-9.0 FIRE ACCESS PLAN

L-1.01 LANDSCAPE PLAN

SITE DATA INFORMATION

GENERAL

APN: 142-04-036 PARCEL SIZE: 580.15 AC

DEVELOPMENT DISTRICT: DAPER AND ADMINISTRATIVE

BUILDING/QUAD: 08-025

LAND USE DESIGNATION: ACADEMIC CAMPUS

SITE AREA: 49,063 SF

PERCENTAGE OF SITE AREA:

LANDSCAPE: 2 % CONCRETE PAVING: 98 %

CBC BUILDING TYPE:

II-B

NUMBER OF NET

NEW PARKING SPACES: NONE

ESTIMATED CUT AND FILL:

CUT: 0 CUBIC YARDS

FILL: 0 CUBIC YARDS

PROJECT DESCRIPTION:

CONSTRUCTION OF NEW COVERING OVER EXISTING TENNIS COURTS AND ASSOCIATED SITE IMPROVEMENTS. NO EXTERIOR LIGHTING IS PROPOSED ON THIS PROJECT. INTERIOR LIGHTING UNDER THE ROOF AND WITHIN THE FACADE WILL BE INCLUDED IN THE PROJECT.

PROJECT MANAGER:
Mark Bonino
340 Bonair Siding Road
Stanford, CA 94304
mbonino@stanford.edu

' PROJECT MANAGI Road

DEPARTMENT OF PROStanford CA 94304


TLE SHEET

STANFORD UNIVERSITY TAUBE SOUTH COVERED TENNIS COURTS

DATE: 05-31-23


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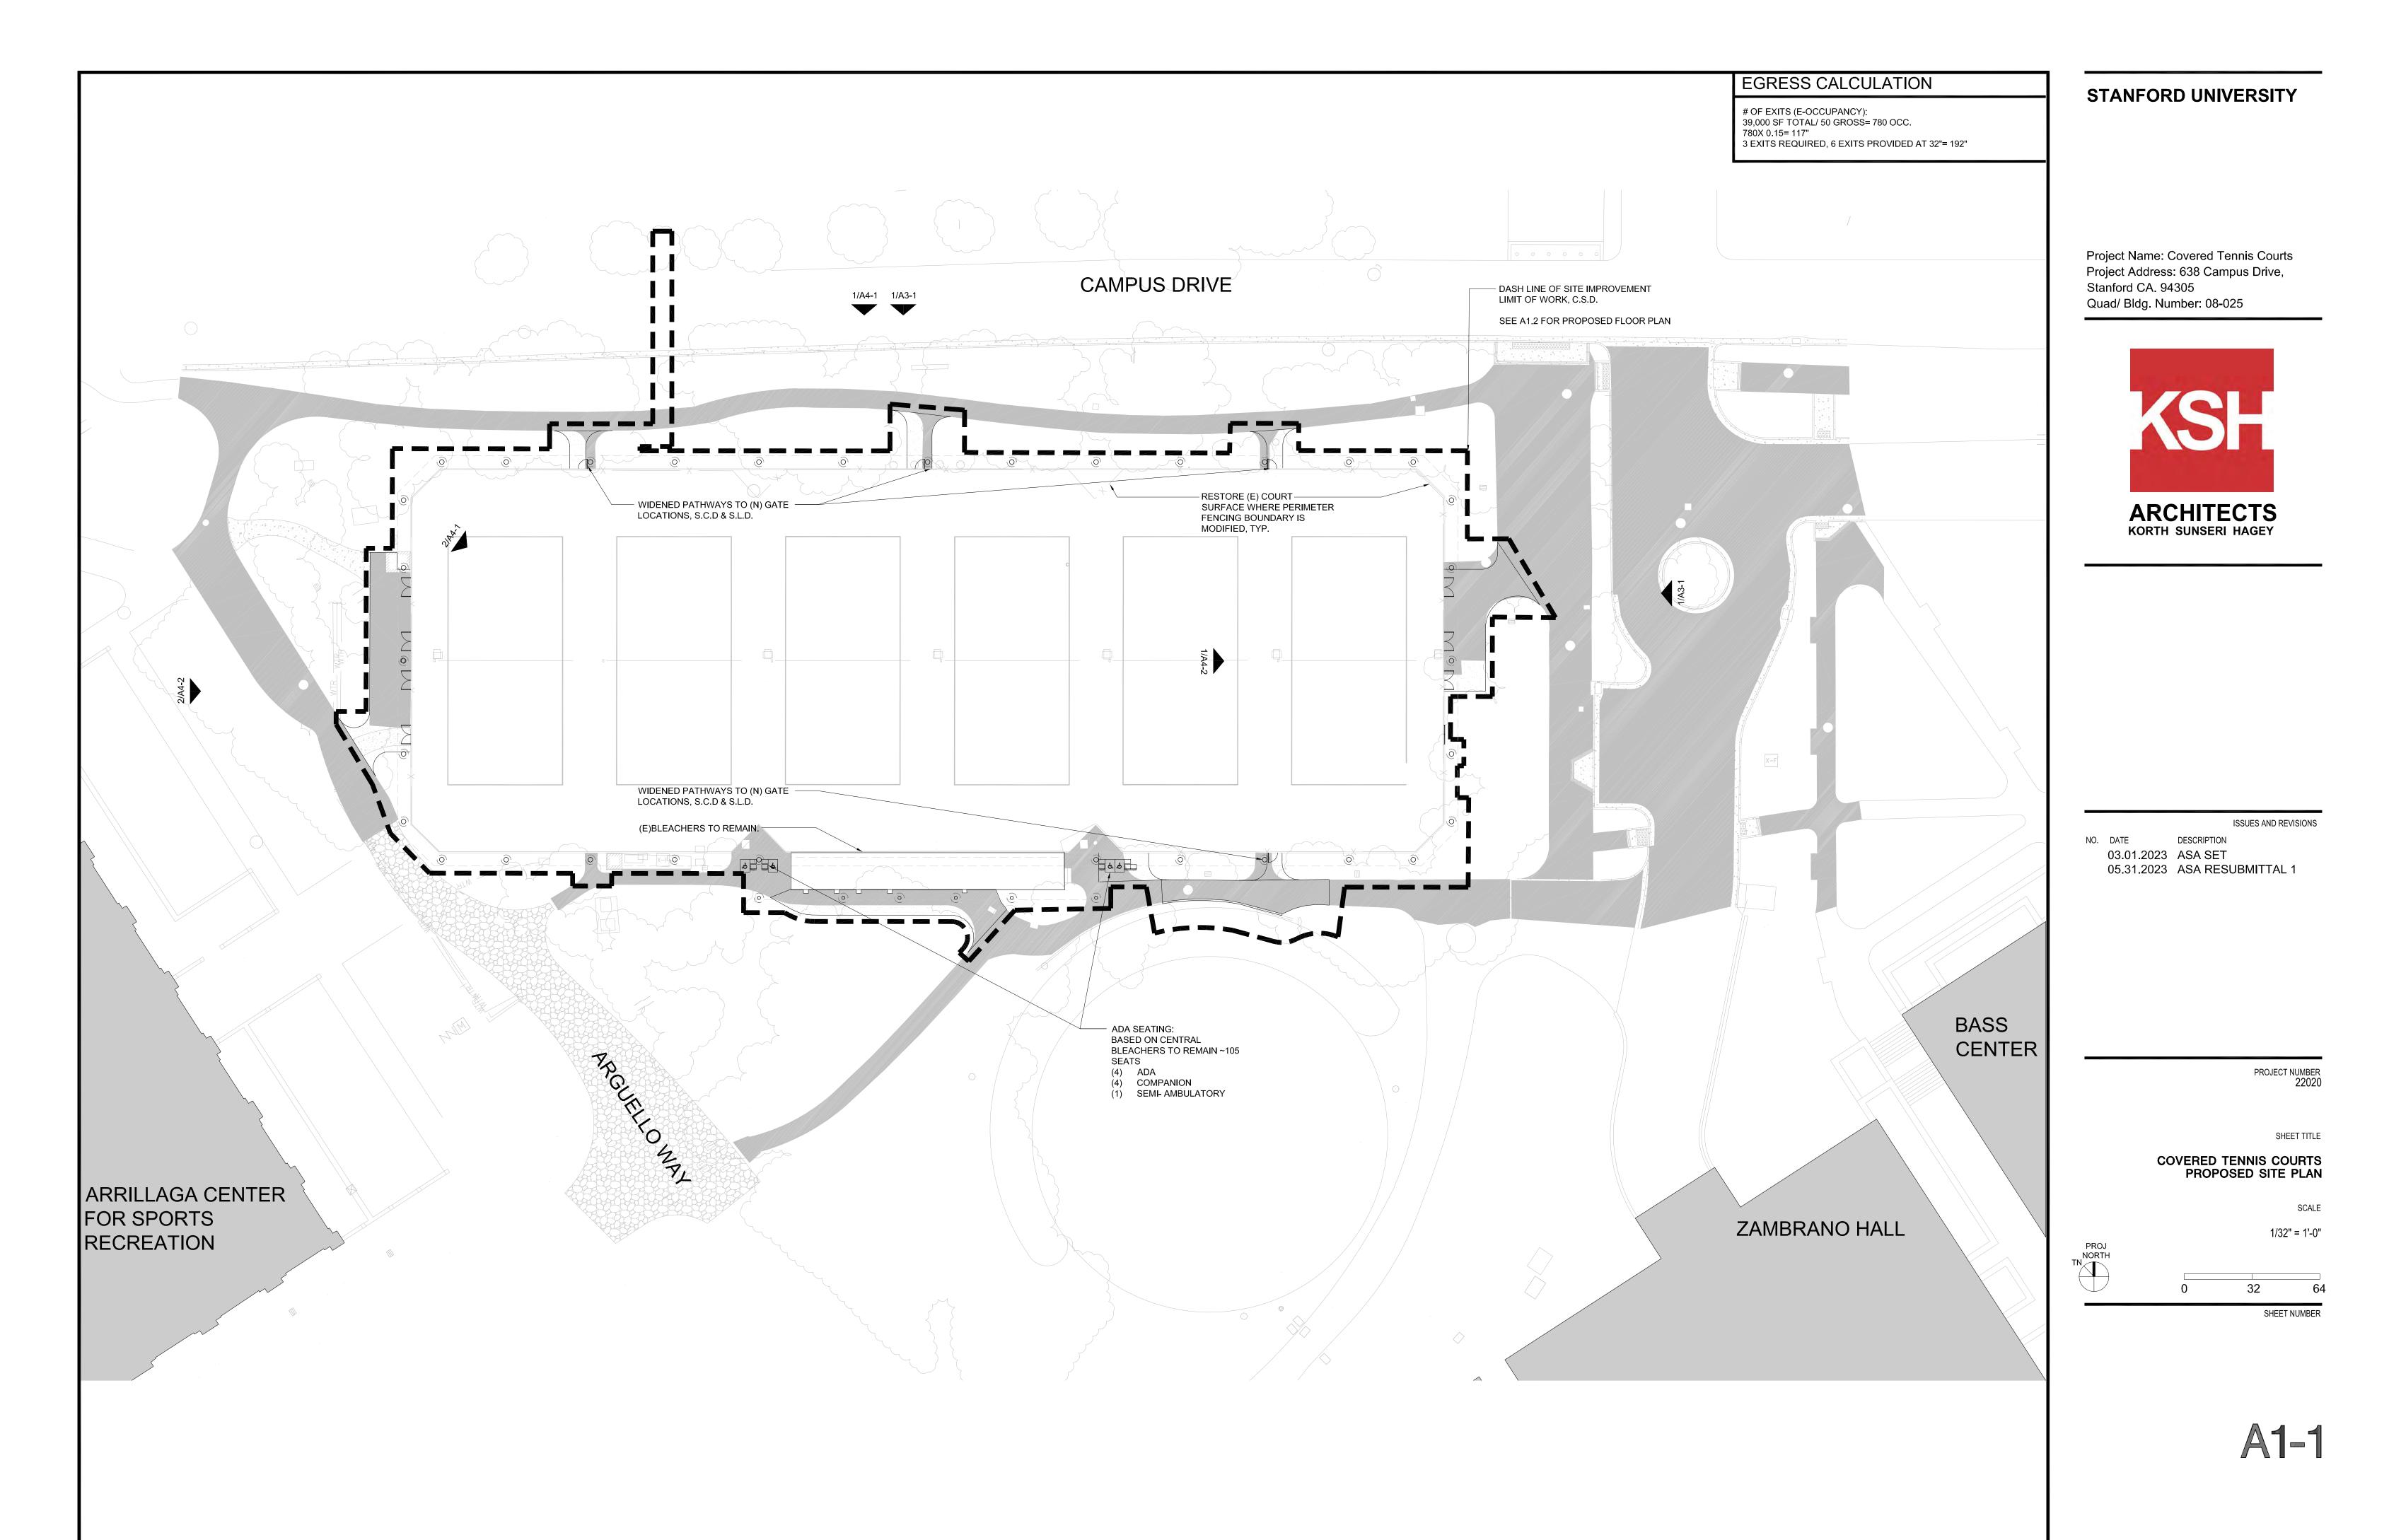
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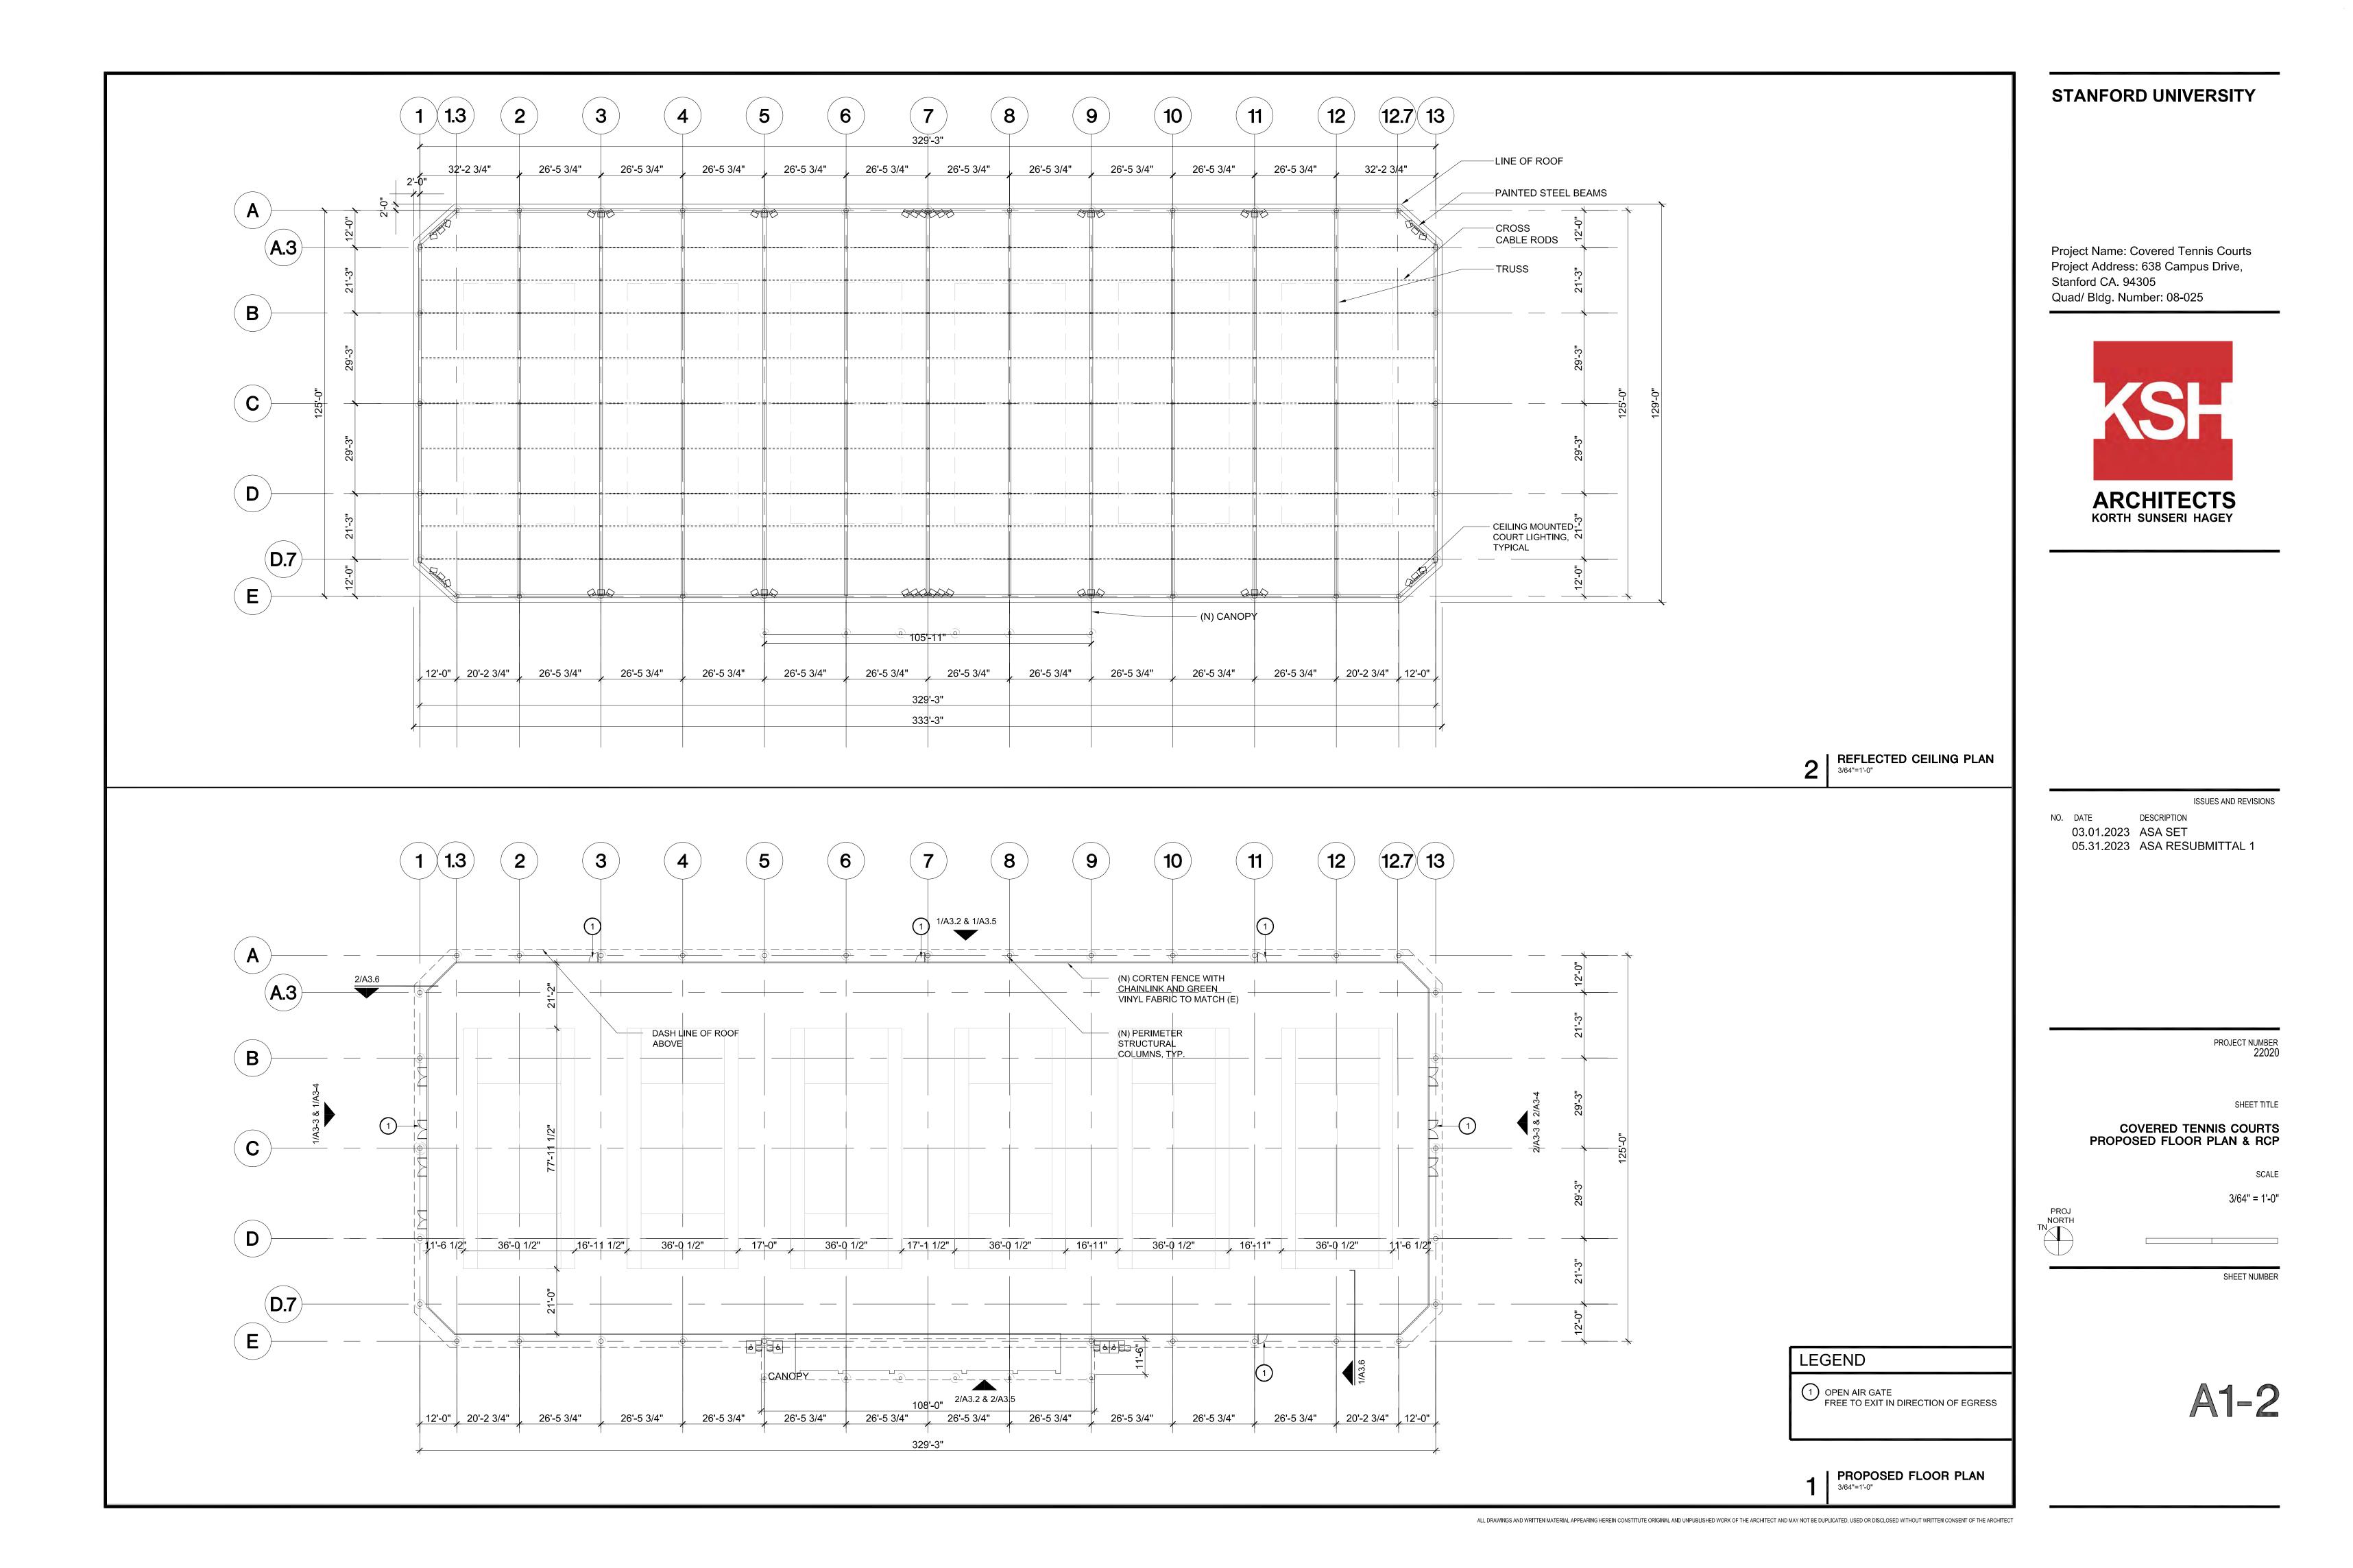



DATE: 05/31/23

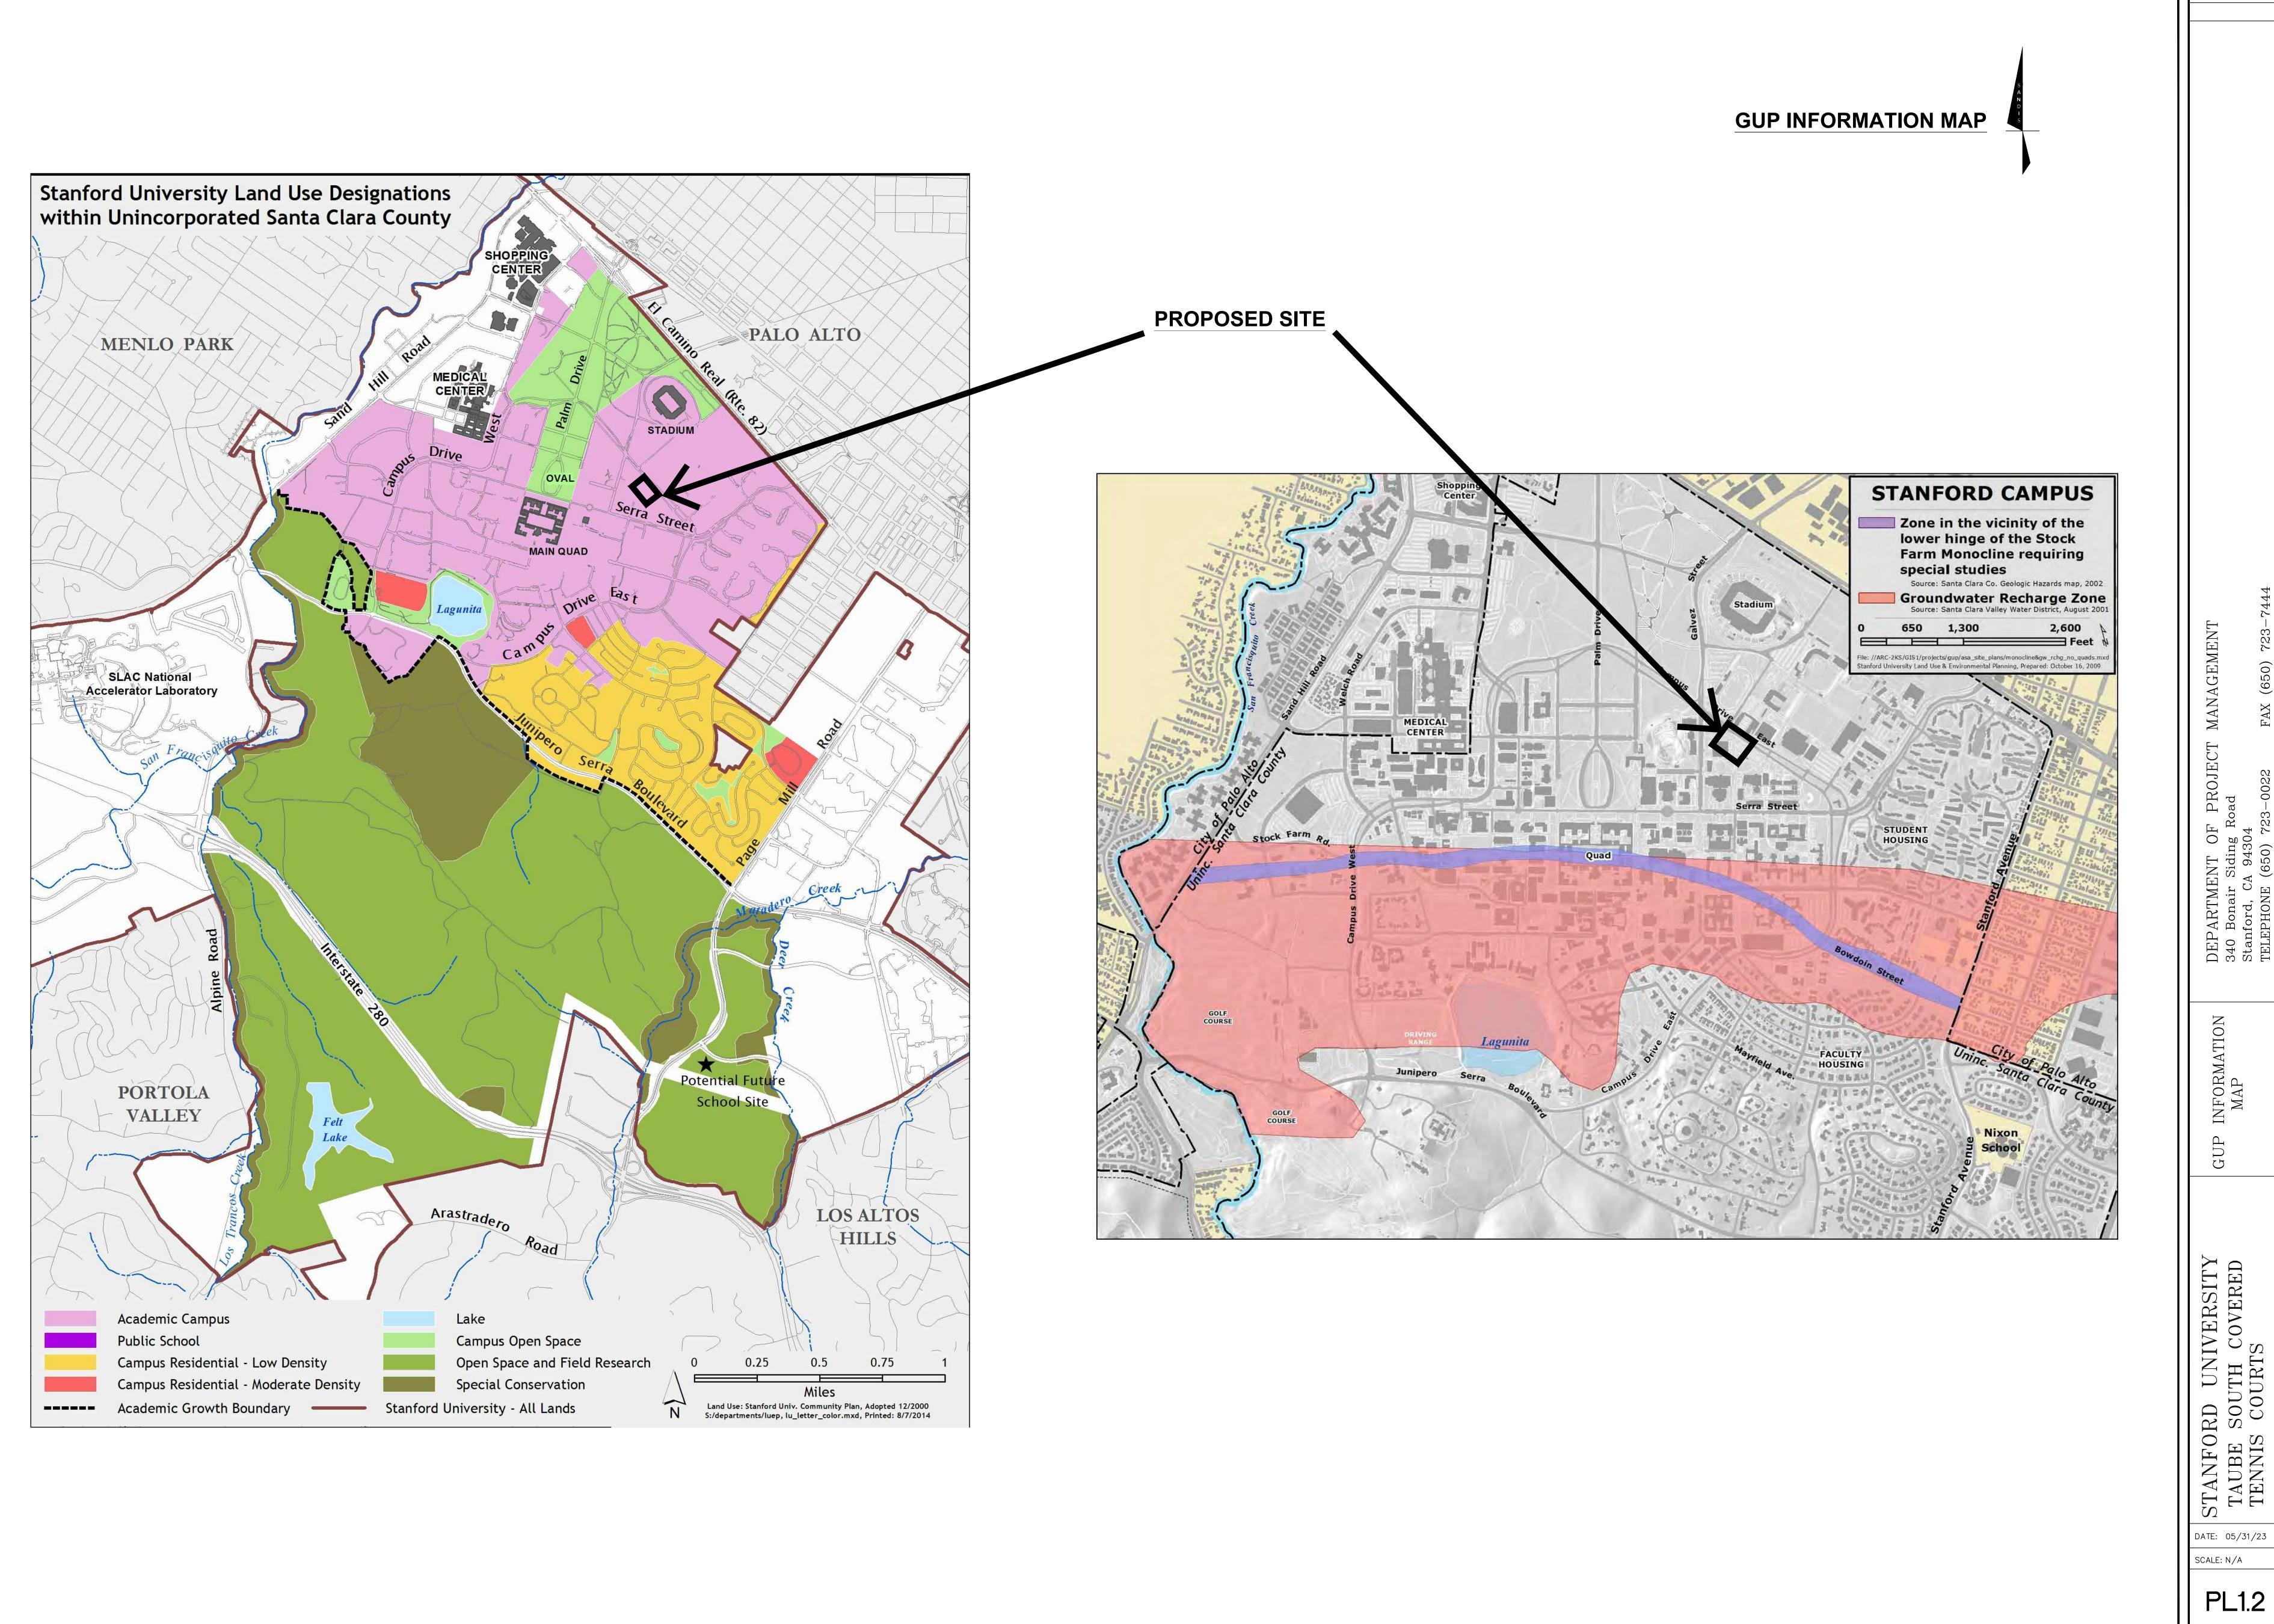PL1.2





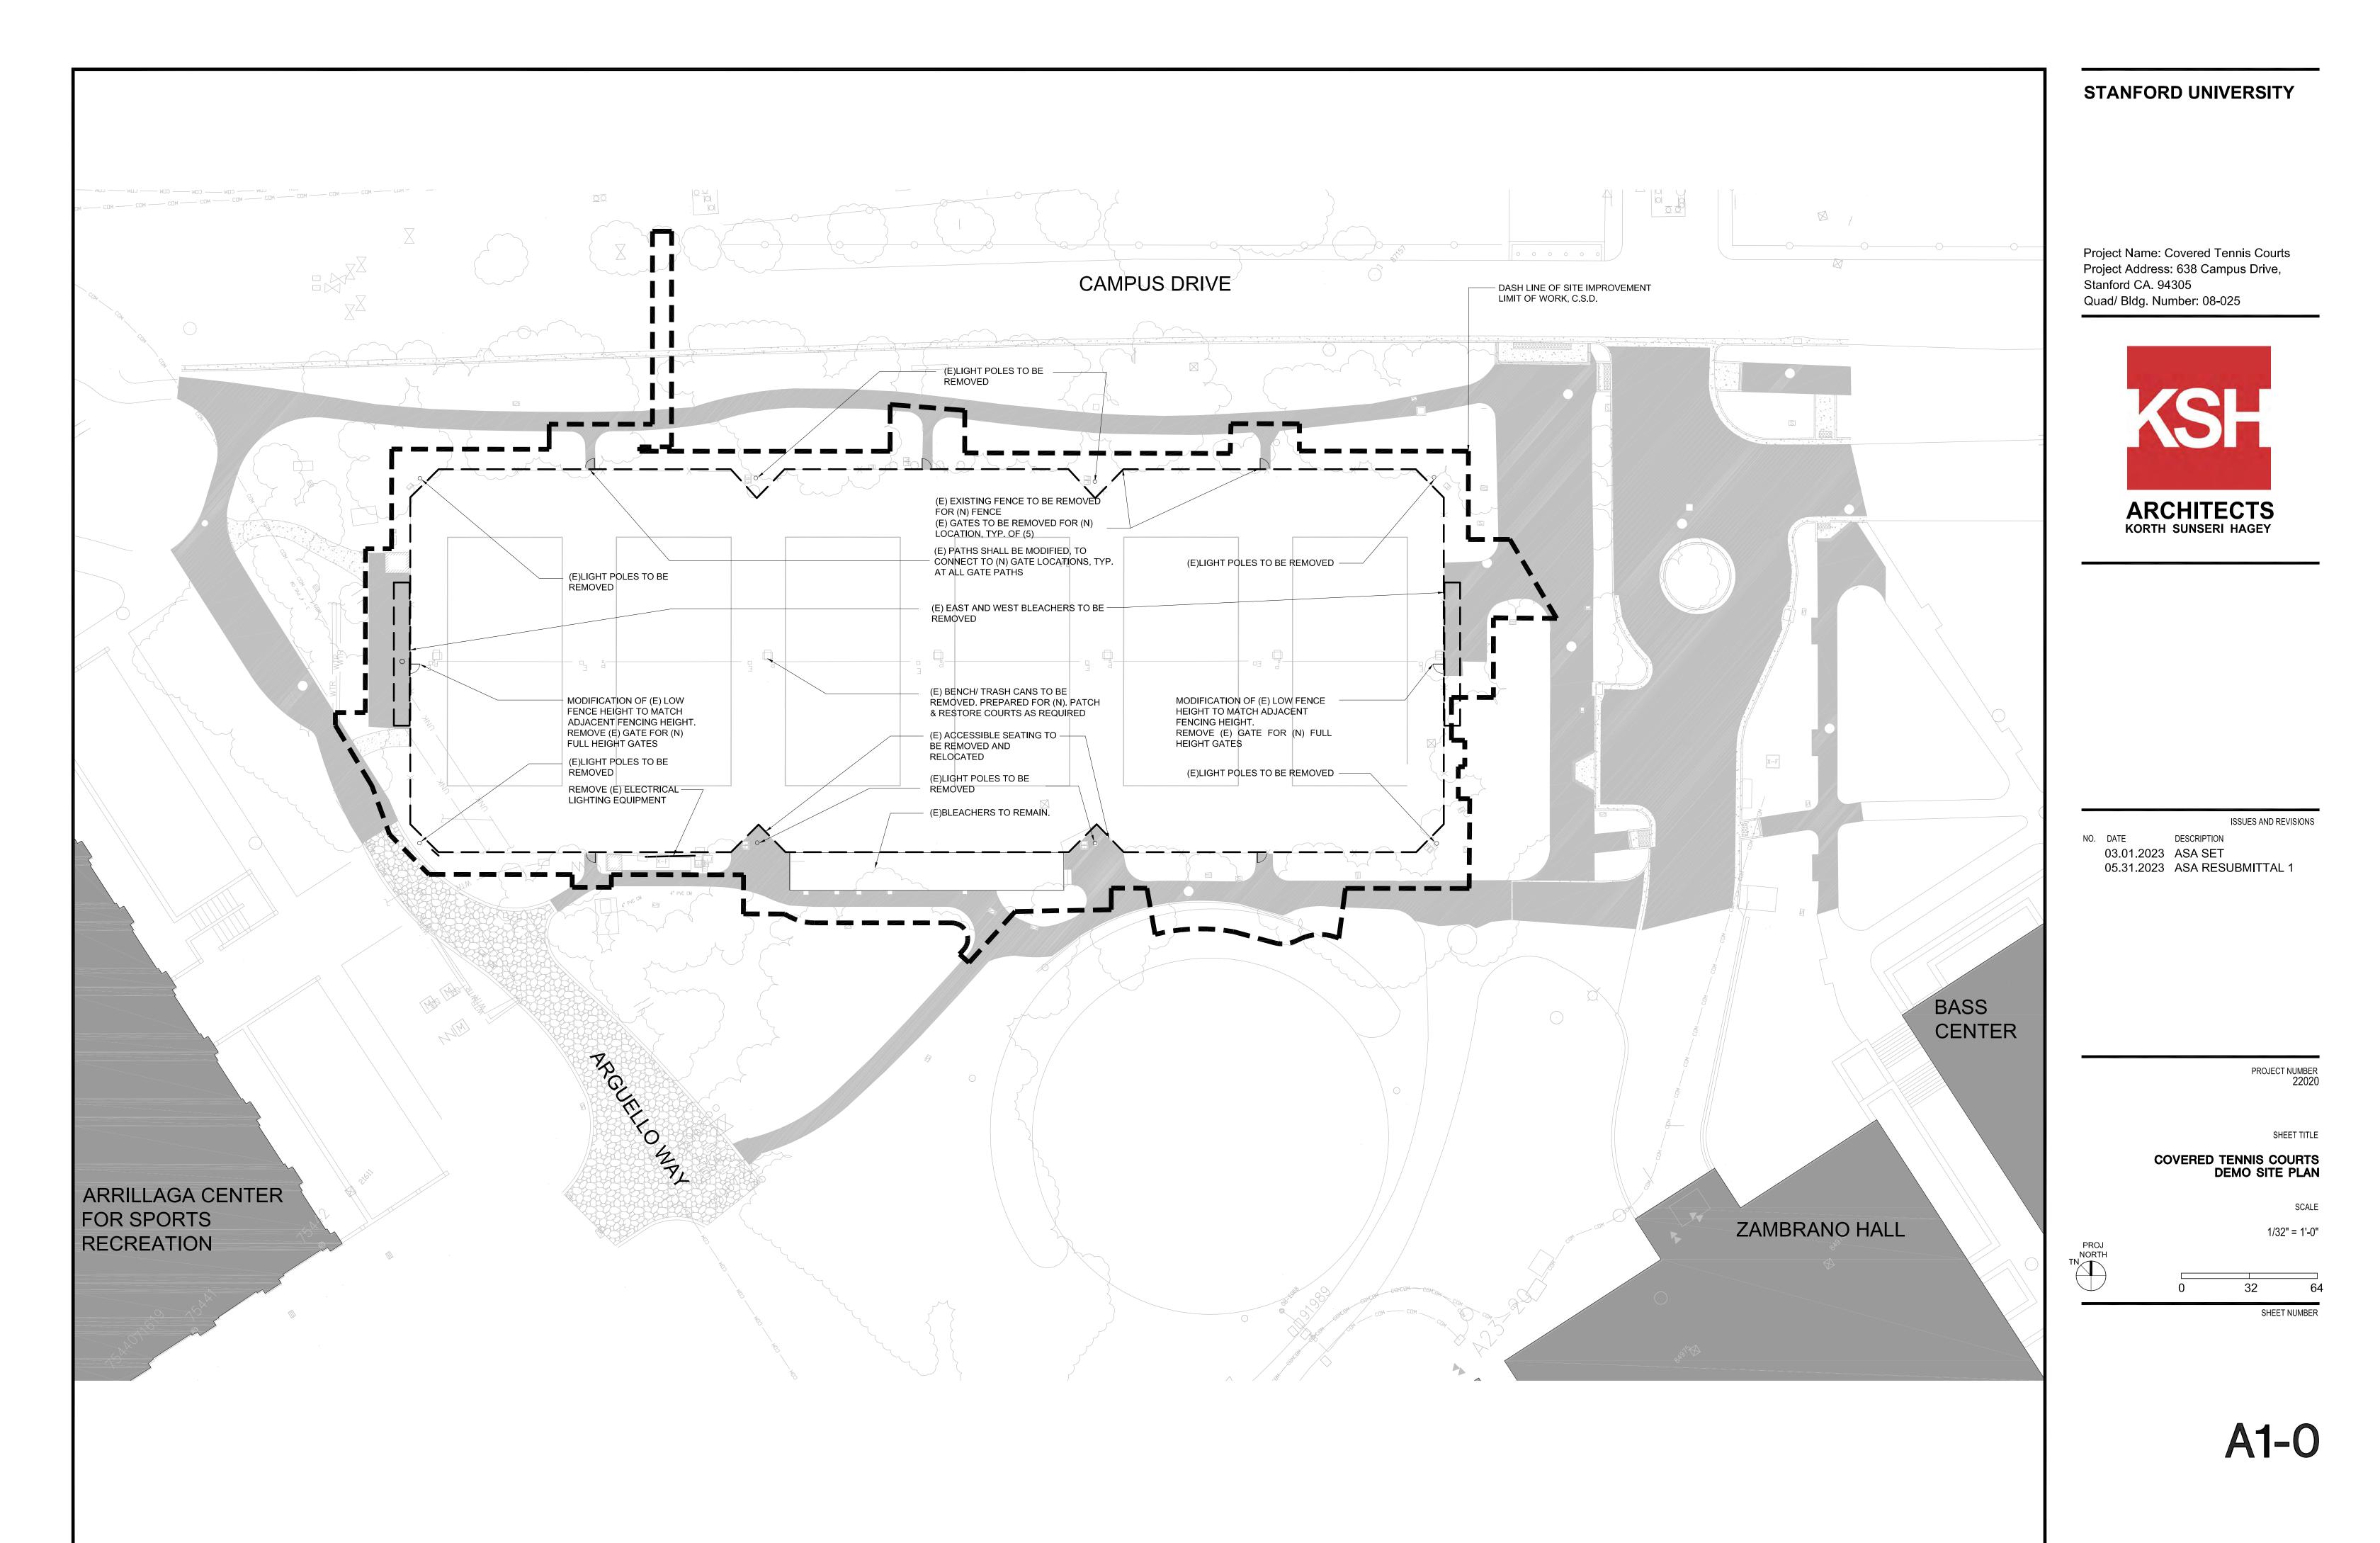

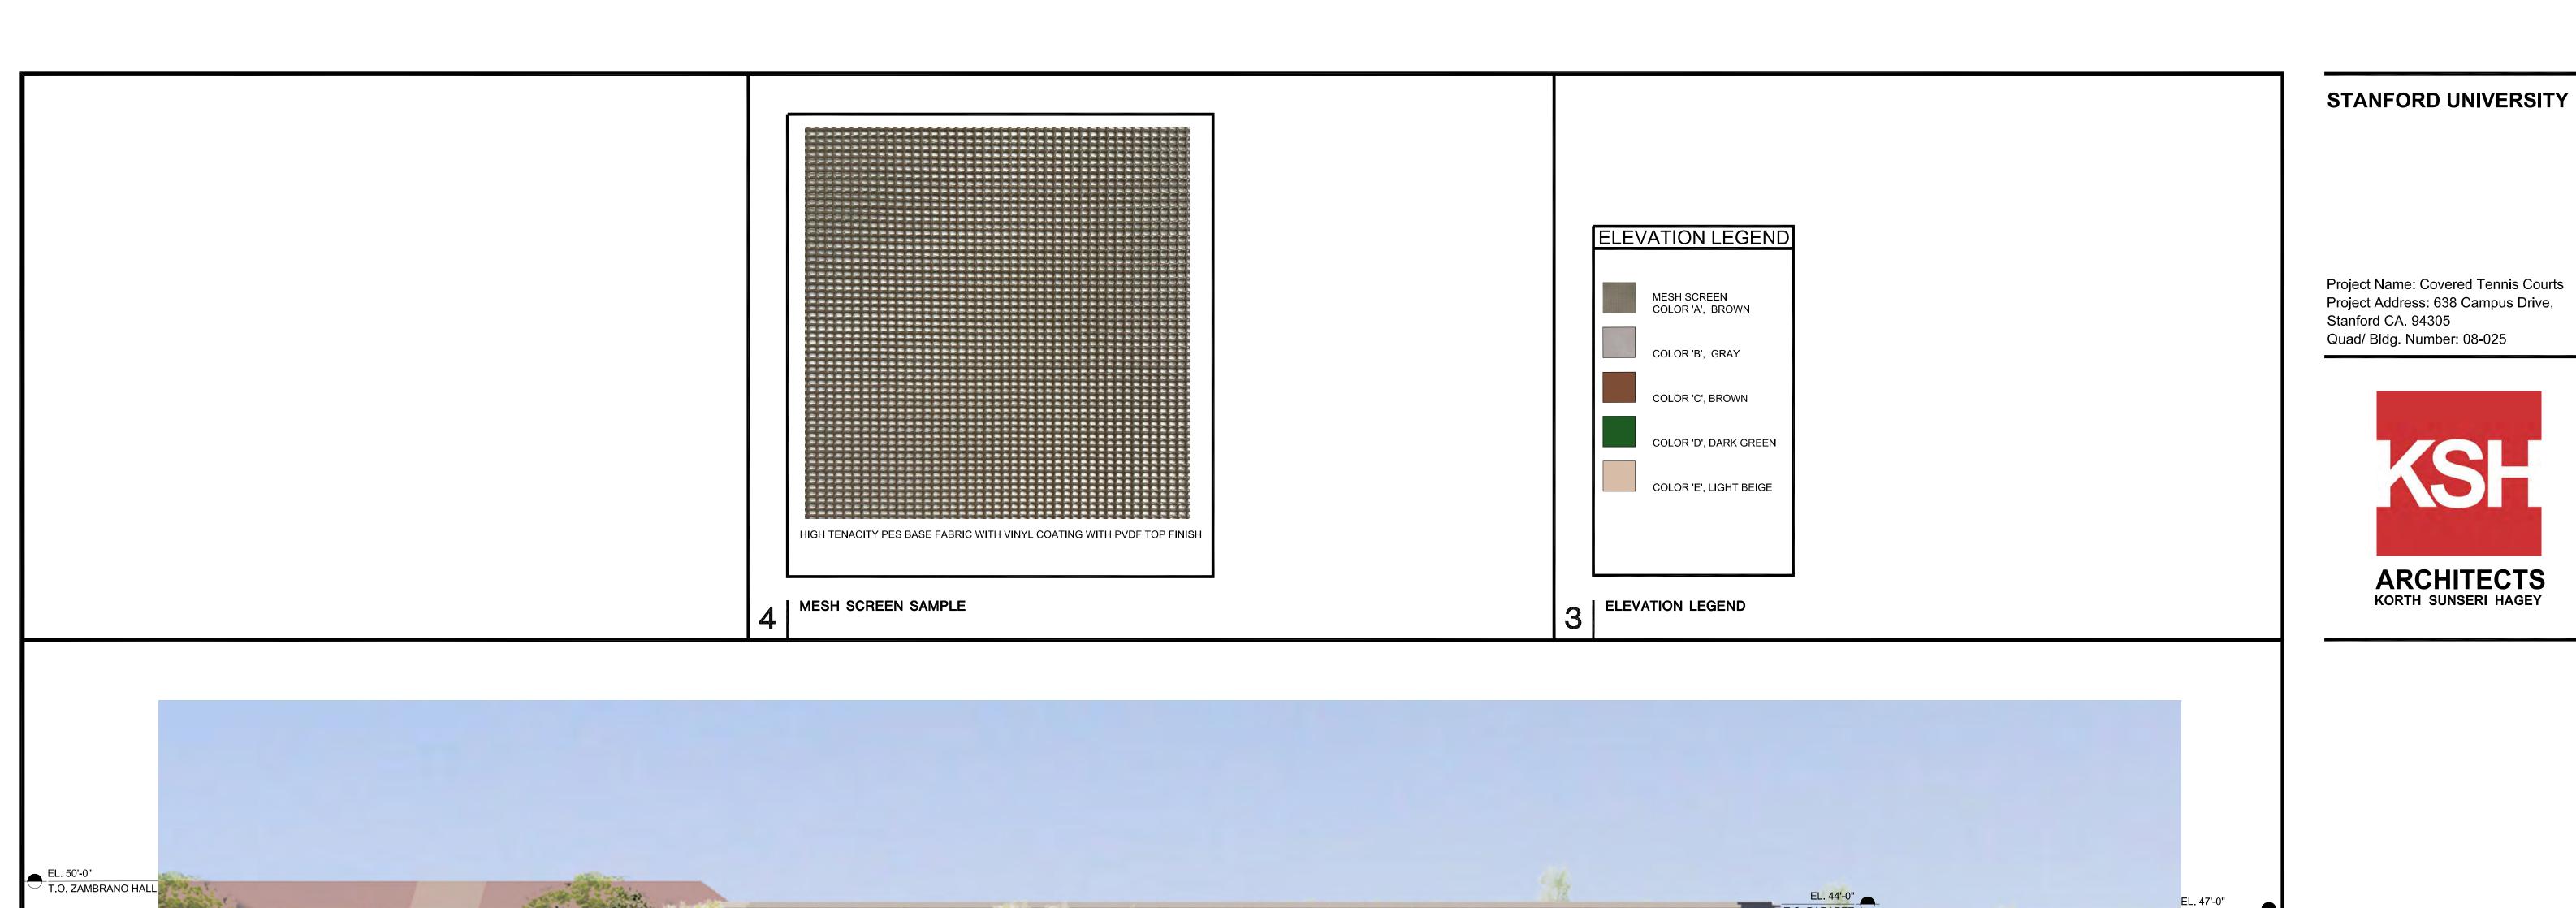

NO. DATE DESCRIPTION 03.01.2023 ASA SET

05.31.2023 ASA RESUBMITTAL 1

T.O. ARRILLAGA CENTER FOR

SPORTS AND RECREATION

ARRILLAGA CENTER
FOR SPORTS AND RECREATION

PROJECT NUMBER 22020

SHEET TITLE

COVERED TENNIS COURTS
CONTEXT ELEVATIONS

PROJ NORTH

SHEET NUMBER

SCALE

A3-

TI. APPALLOSA HALL

ABBIL ACA-ALI

ABBIL ACA-ALI

CONTEXT ELEVATION (KNIGHT MANAGEMENT CENTER)

CONTEXT ELEVATION (CAMPUS DRIVE)

1/32"=1'-0"

PANCE RUN FAME FAME SCHMANS OF THE CODE STATEMENT OF THE CODE STAT



Project Name: Covered Tennis Courts Project Address: 638 Campus Drive, Stanford CA. 94305 Quad/ Bldg. Number: 08-025



2 | SOUTH ELEVATION (VIEW FROM ARRILLAGA HALL)

NO. DATE DESCRIPTION

03.01.2023 ASA SET

05.31.2023 ASA RESUBMITTAL 1

ISSUES AND REVISIONS

PROJECT NUMBER 22020

COVERED TENNIS COURTS ELEVATIONS

SCALE
AS NOTED

PROJ NORTH
TN

SHEET NUMBER



STANFORD UNIVERSITY

Project Name: Covered Tennis Courts Project Address: 638 Campus Drive, Stanford CA. 94305 Quad/ Bldg. Number: 08-025



PANTED ROUND COLORS STRUCTURAL CARLE, COLORS STRUCTURAL HSS MEMBER, COLORS PANTED ROUND FOLIANCE SERVED FOLIANCE S

2 | WEST ELEVATION (VIEW FROM ARRILAGA CENTER FOR SPORTS AND RECREATION)

EAST ELEVATION (VIEW FROM KNIGHT MANAGEMENT CENTER)

1/16"=1'-0"

ISSUES AND REVISIONS

DATE DESCRIPTION

03.01.2023 ASA SET

05.31.2023 ASA RESUBMITTAL 1

PROJECT NUMBER 22020

SHEET TITLE

COVERED TENNIS COURTS ELEVATIONS

AS NOTED


SCALE

PROJ NORTH

SHEET NUMBER

A3-0



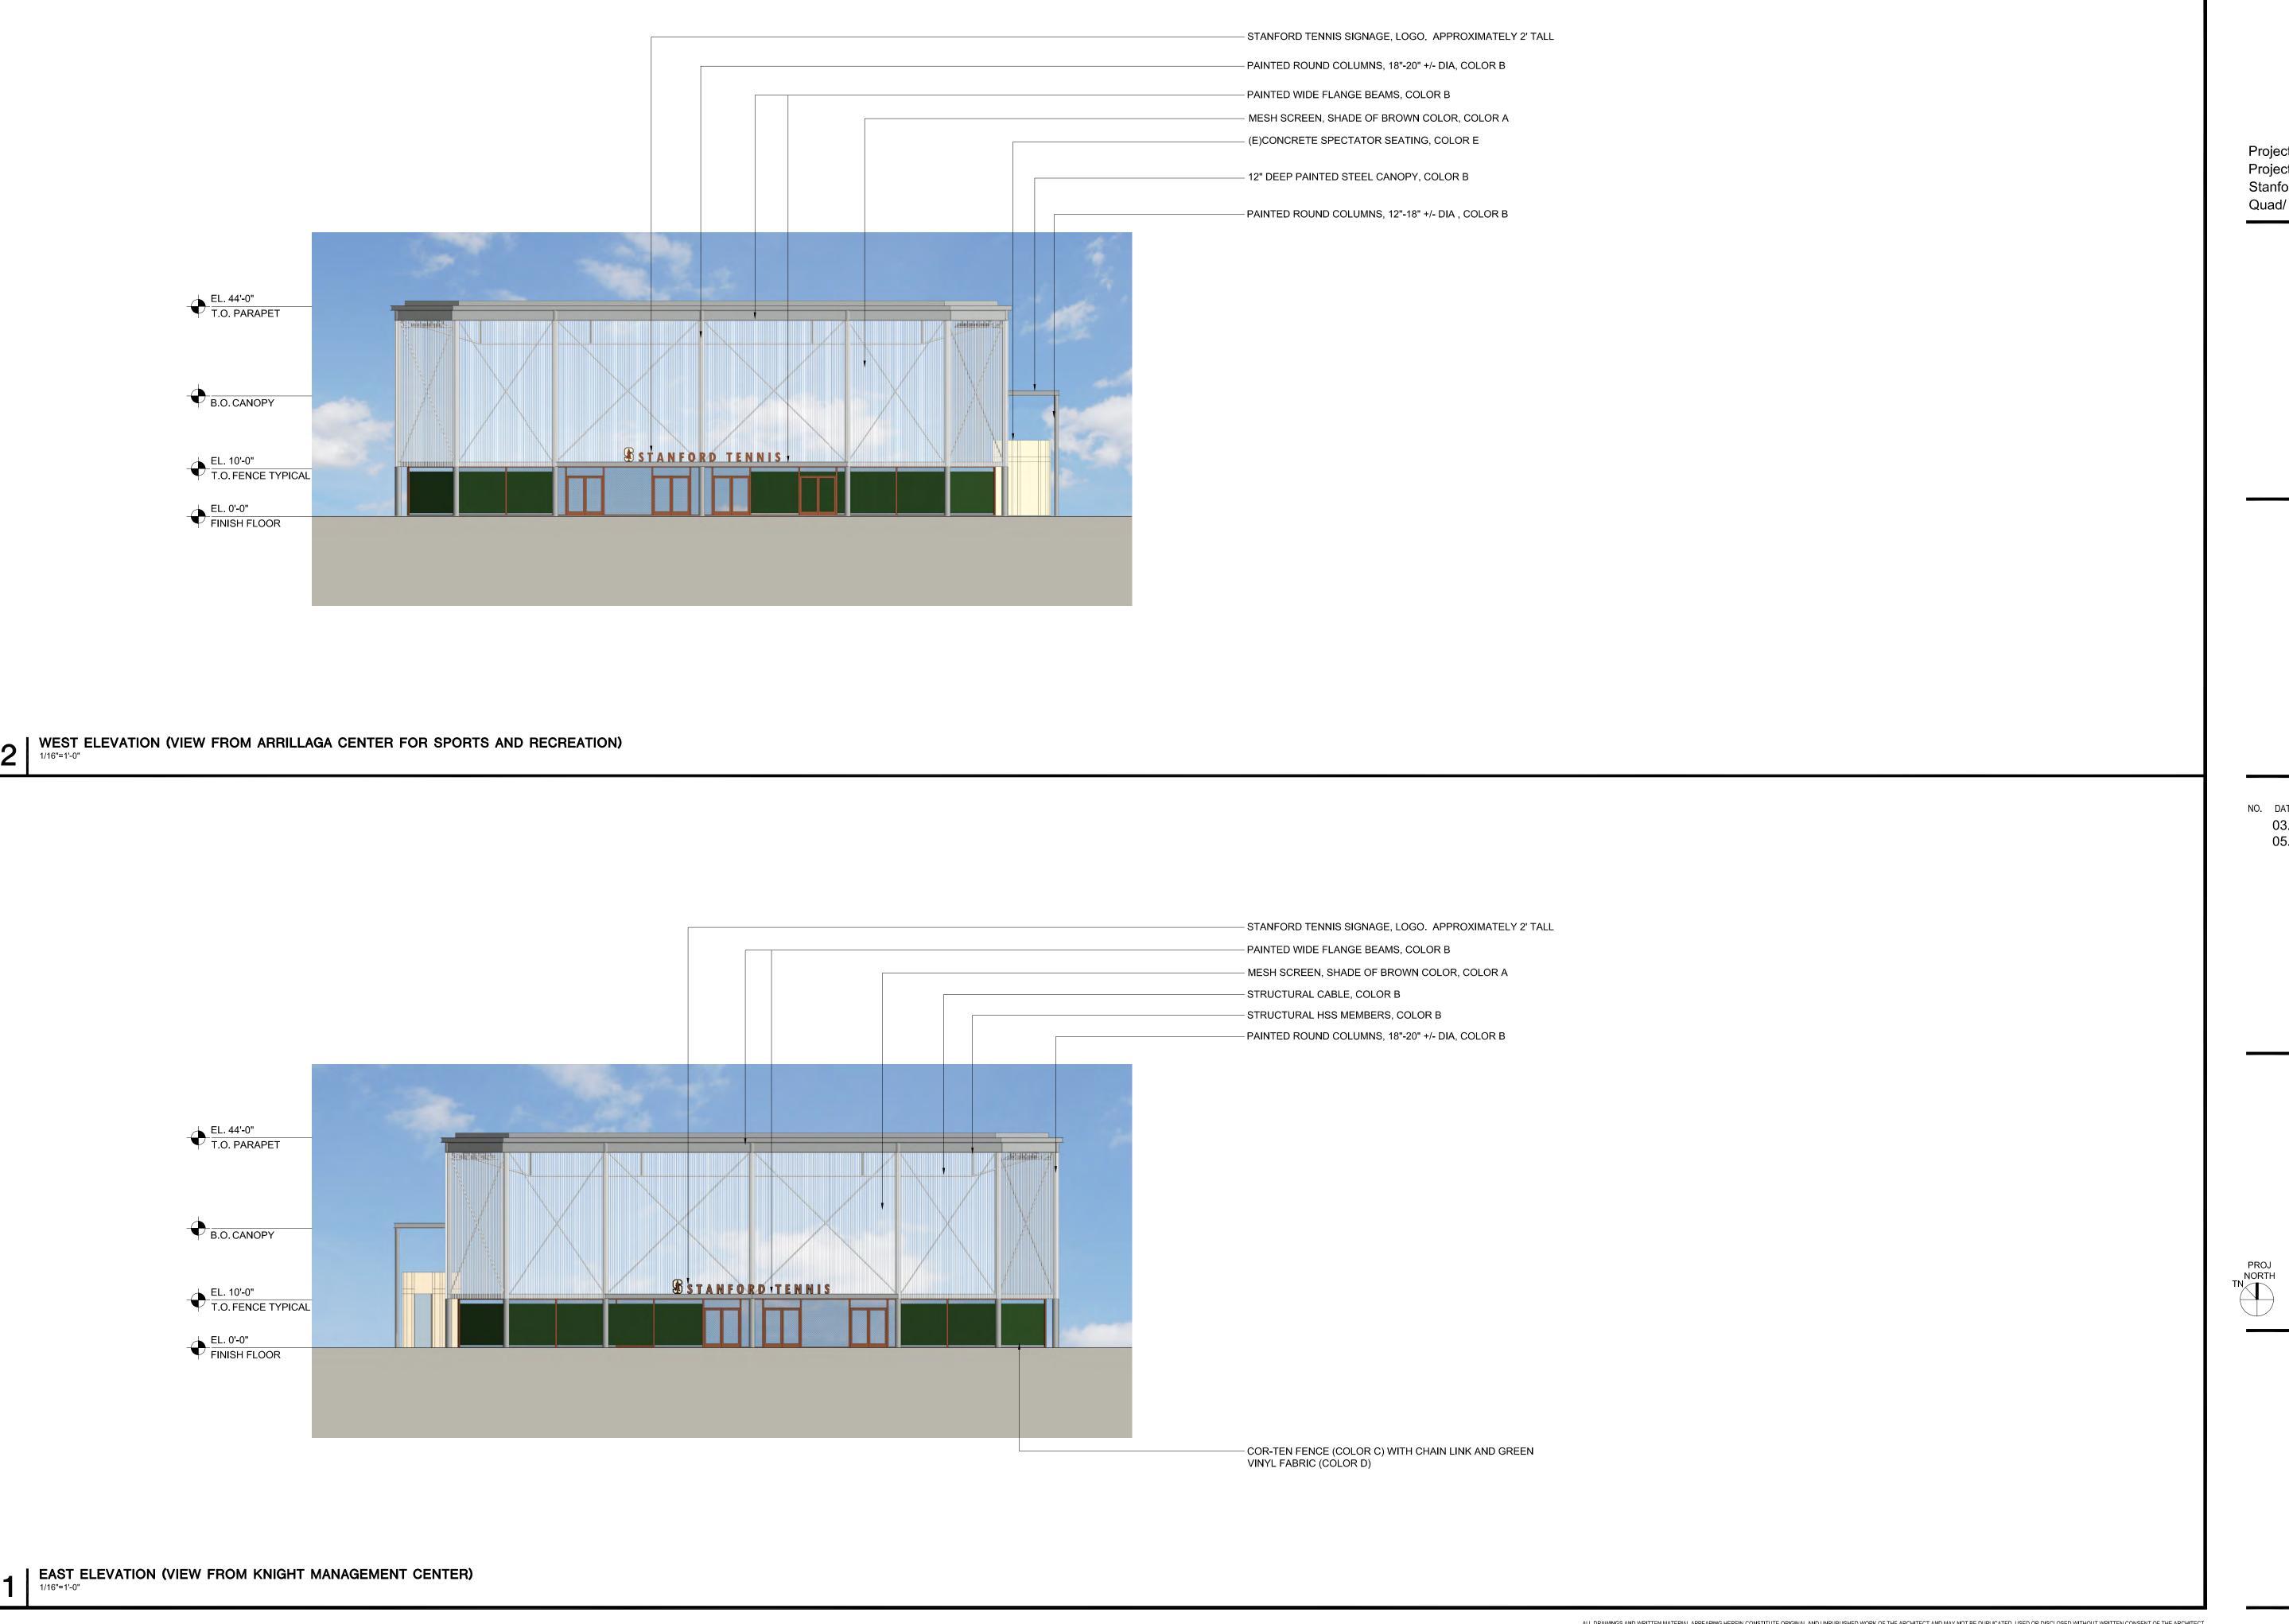

STANFORD UNIVERSITY

Project Name: Covered Tennis Courts Project Address: 638 Campus Drive, Stanford CA. 94305 Quad/ Bldg. Number: 08-025



ARCHITECTS
KORTH SUNSERI HAGEY

ISSUES AND REVISIONS

NO. DATE DESCRIPTION

03.01.2023 ASA SET

05.31.2023 ASA RESUBMITTAL 1

PROJECT NUMBER 22020

COVERED TENNIS COURTS
BUILDING ELEVATIONS

SCALE

AS NOTED

SHEET TITLE

SHEET NUMBER



Project Address: 638 Campus Drive,



ISSUES AND REVISIONS


PROJECT NUMBER 22020

SHEET TITLE

SCALE

AS NOTED

SHEET NUMBER

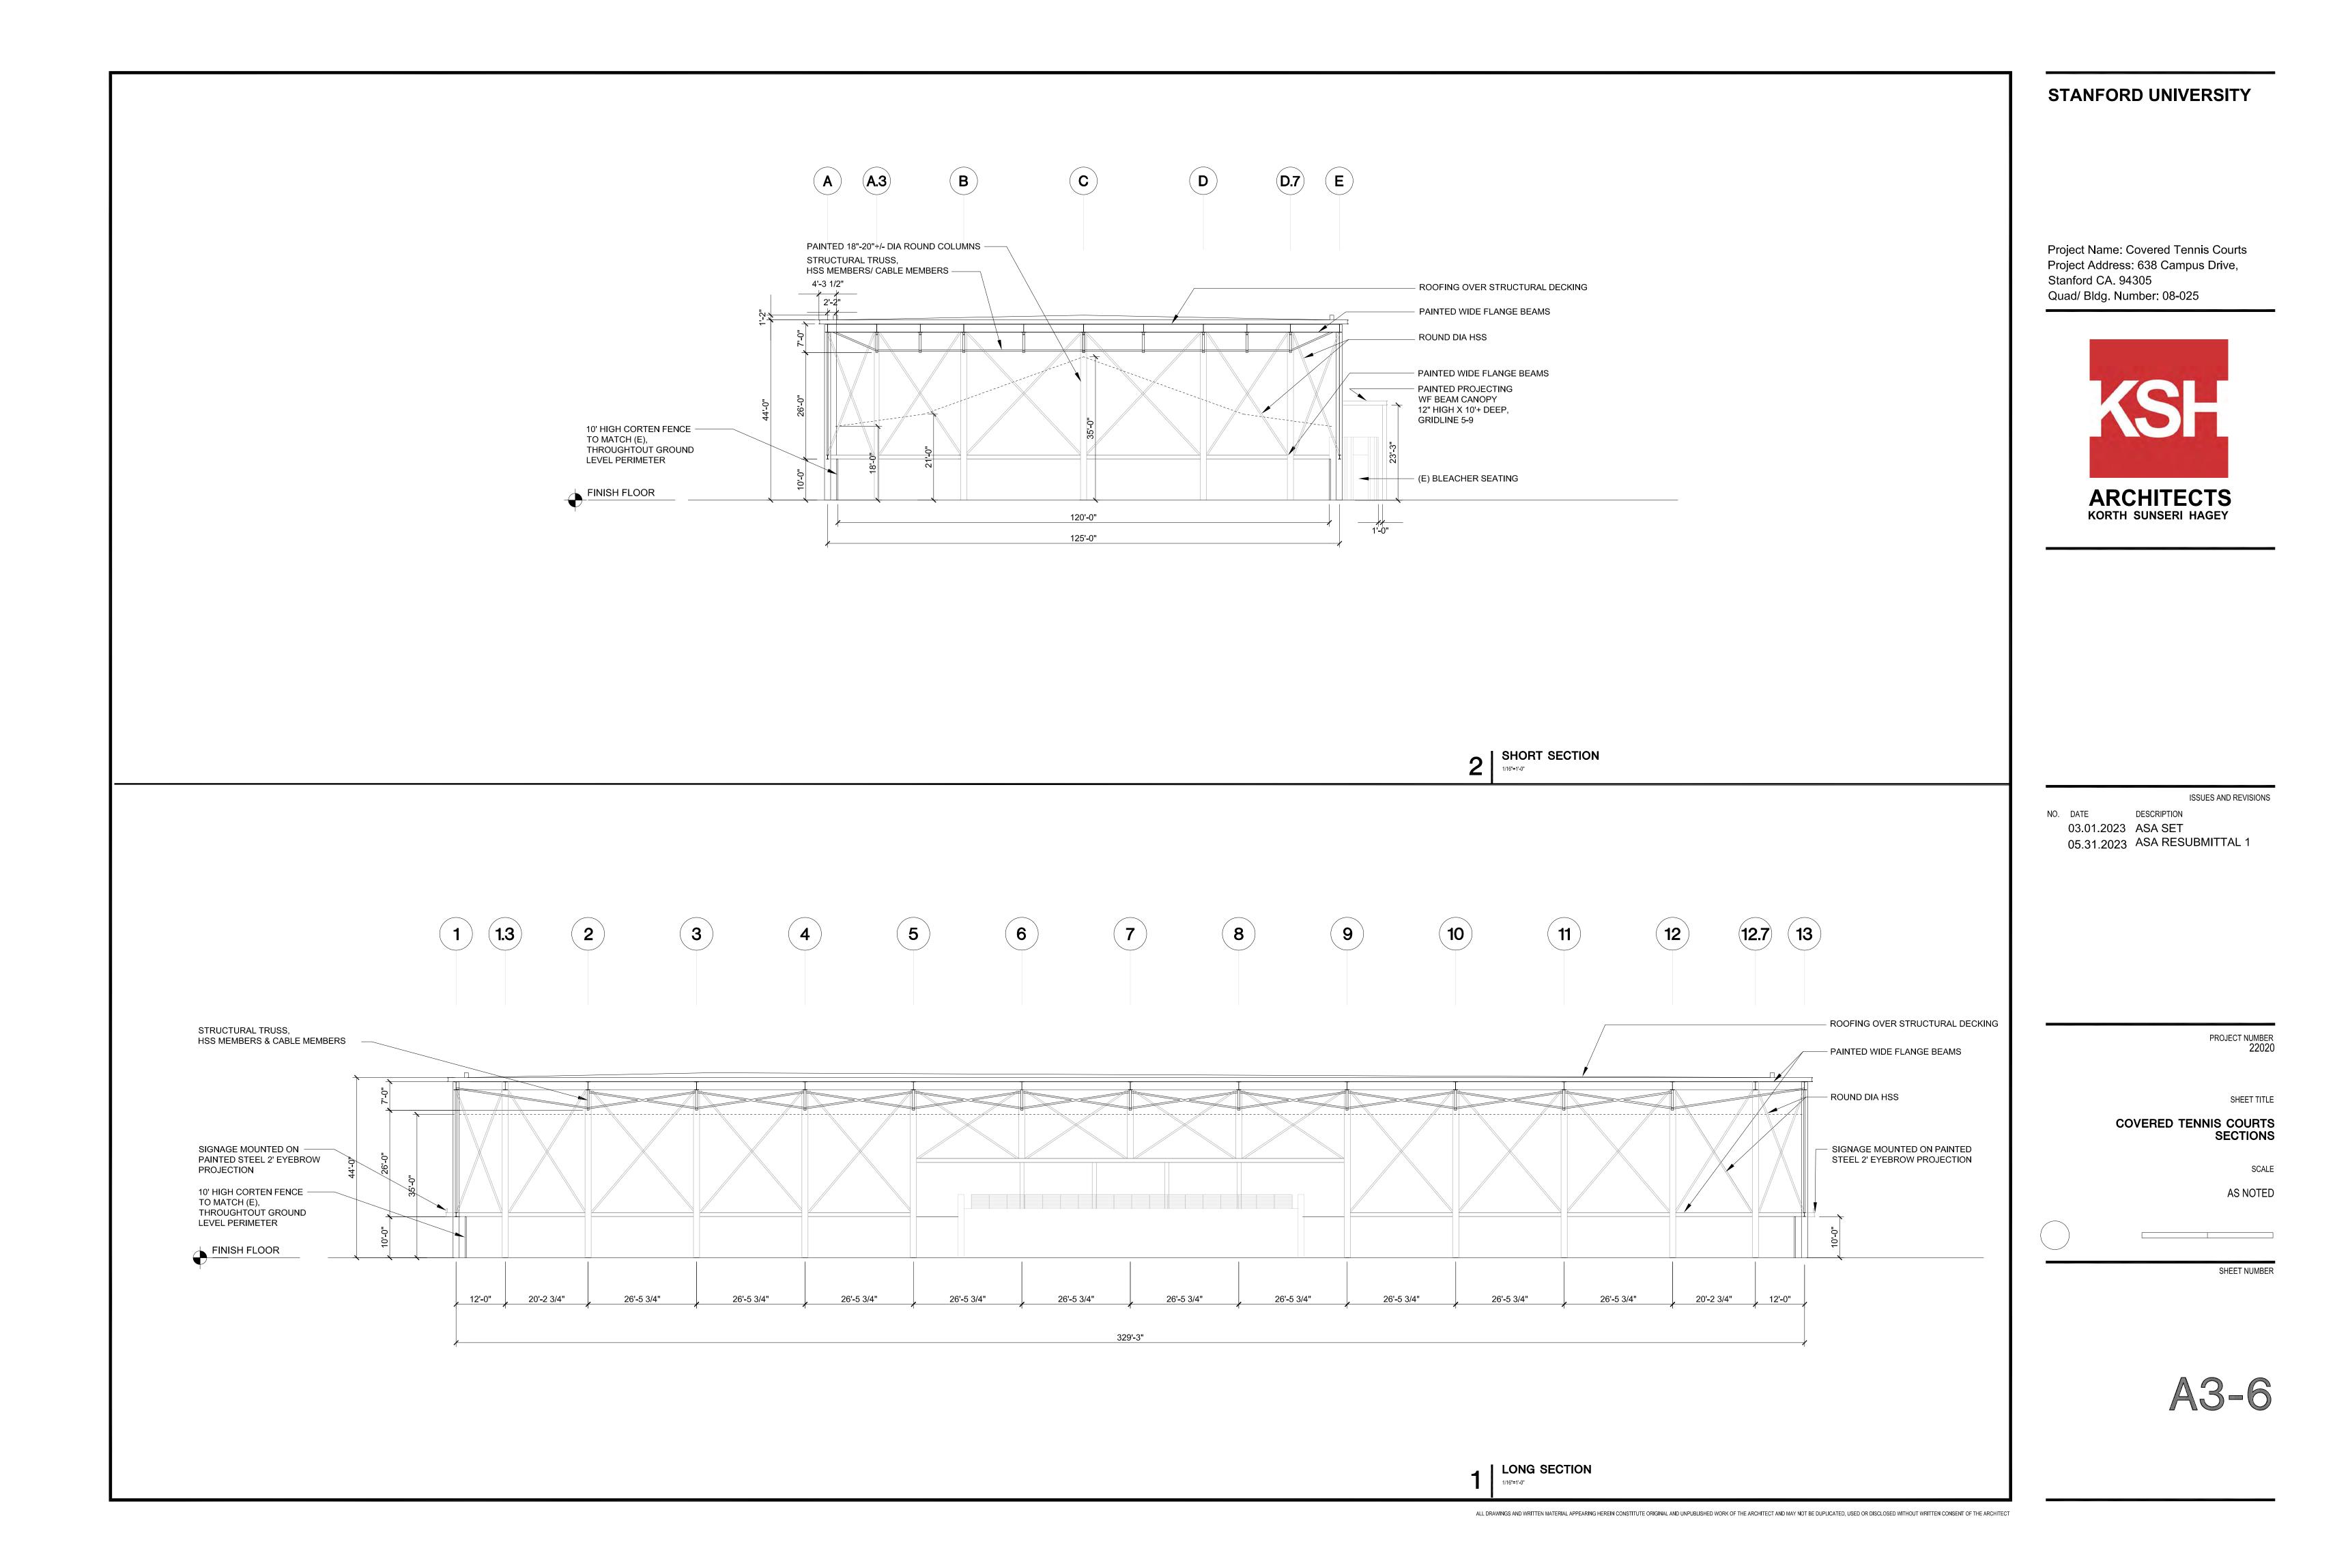



STANFORD UNIVERSITY

Project Name: Covered Tennis Courts Project Address: 638 Campus Drive, Stanford CA. 94305 Quad/ Bldg. Number: 08-025



2 | INTERIOR VIEW FROM EAST COVERED TENNIS COURTS



ISSUES AND REVISIONS

03.01.2023 ASA SET 05.31.2023 ASA RESUBMITTAL 1

03.31.2023 ASA RESOBIVITIAL

PROJECT NUMB 220

SHEET IIIL

COVERED TENNIS COURTS RENDERINGS

00,12

SHEET NUME

A4-1



STANFORD UNIVERSITY

Project Name: Covered Tennis Courts Project Address: 638 Campus Drive, Stanford CA. 94305 Quad/ Bldg. Number: 08-025



| VIEW FROM ARRILLAGA CENTER FOR SPORTS AND RECREATION



ISSUES AND REVISIONS

03.01.2023 ASA SET 05.31.2023 ASA RESUBMITTAL 1

SHEET TITLE

COVERED TENNIS RENDERINGS

AS NOTED

SHEET NUMBER

INTERIOR VIEW OF WEST

ABBREVIATIONS

 AGGREGATE BASE ASPHALT CONCRETE AREA DRAIN - AMERICANS WITH DISABILITIES ACT AGGREGATE SUBBASE

- BEGINNING OF CURVE - BACK FLOW PREVENTOR BUILDING CORNER BLDC **BLDG** BUILDING BOD - BOTTOM OF DOCK BOLLARD

- BOTTOM OF STEP - FG @ BOTTOM OF WALL - BEGIN VERTICAL CURVE BACK OF WALK CONCRETE OR CIVIL CURB AND GUTTER

- CATCH BASIN - COMBINATION INLET - CAST IRON PIPE CENTER LINE OR CLASS CORRUGATED METAL PIPE CLEANOUT - CURB OPENING INLET

CONCRETE

 CONSTRUCTION OR CONSTRUCT CUBIC YARD - DOUBLE CHECK DETECTOR ASSEMBLY DROP INLET - DUCTILE IRON PIPE

DOMESTIC - DOMESTIC WATER DRAWING EAST END OF CURVE EDGE OF PAVEMENT END OF RETURN END VERTICAL CURVE **ELEV** ELEVATION

- FACE OF CURB - FIRE DEPARTMENT CONNECTION FINISHED FLOOR FINISHED GRADE FIRE HYDRANT

FLOW LINE FOUNDATION - FINISHED SURFACE FOOT FIRE WATER - GROUND ELEVATION

EXISTING

EX., EXIST.

GATE VALVE - ACCESSIBLE RAMP - HIGH POINT INVERT ELEVATION - JOINT POLE JOINT TRENCH LIP OF GUTTER - LOW POINT

GRADE BREAK

 LANDSCAPE ARCHITECT MAXMAXIMUM MECHANICAL/ELECTRICAL/PLUMBING MANHOLE MINIMUM - MIDPOINT OF VERTICAL CURVE

MON MONUMENT NORTH NOT IN CONTRACT NUMBER NOT TO SCALE PAVEMENT ELEVATION PCC - PORTLAND CEMENT CONCRETE /

POINT OF CONTINUOUS CURVATURE POST INDICATOR VALVE PROPERTY LINE POWER MANHOLE POINT ON CURVE - POWER POLE

PRC POINT OF REVERSE CURVATURE POLYVINYL CHLORIDE PIPE RADIUS - RELATIVE COMPACTION RCP- REINFORCED CONCRETE PIPE RPPA REDUCED PRESSURE PRINCIPLE ASSEMBLY

- RIGHT OF WAY - SLOPE OR SOUTH SEE ARCHITECTURAL DRAWINGS SEDIMENT BASIN STORM DRAIN

- SEE ELECTRICAL DRAWINGS SILT FENCE SUBGRADE - SEE LANDSCAPE DRAWINGS - SEE MECHANICAL DRAWINGS S.M.D. SIGNAL MANHOLE

S.P.D. - SEE PLUMBING DRAWINGS SANITARY SEWER STATION

STANDARD SIDEWALK TOP OF CURB TRENCH DRAIN - TOP OF DOCK - TOE OF SLOPE

TOP OF STAIR - FG @ TOP OF WALL TOP OF SLAB TYPICAL UON UNLESS OTHERWISE NOTED UNDERGROUND


 VERTICAL CURVE WATER METER WATER VALVE - WEST WELDED WIRE FABRIC

APPROVED FOR ISSUANCE. REFER TO ENCROACHMENT AND / OR CONSTRUCTION PERMIT AND PLAN COVER SHEET FOR SPECIAL CONDITIONS


STANFORD UNIVERSITY

TAUBE SOUTH COVERED TENNIS COURTS **BUILDING 08-025**

CALIFORNIA PALO ALTO

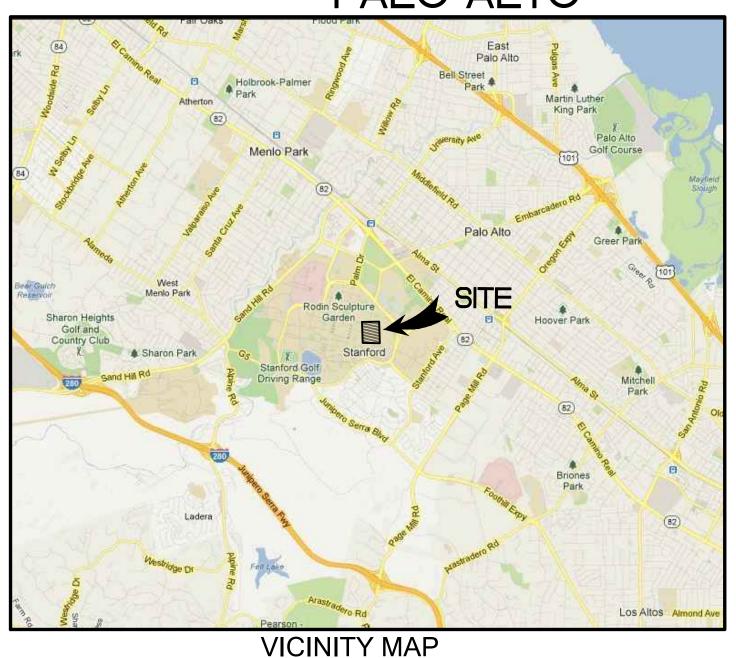

NOT TO SCALE

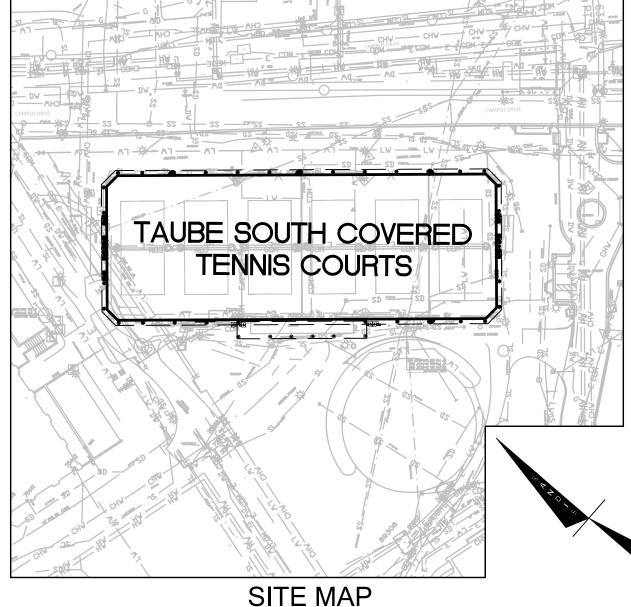

NOT TO SCALE

EARTHWORK FOR CONSTRUCTION NOTE

IT SHALL BE THE CONTRACTOR'S RESPONSIBILITY TO INCLUDE ALL MATERIAL AND LABOR REQUIRED WITHIN THE BID PRICE, FOR EARTHWORK CONSTRUCTION, TO CARRY OUT THE CUT/FILL AND/OR IMPORT/EXPORT AS NECESSARY TO MEET THE DESIGN GRADES SHOWN ON THE PLANS. CONTRACTOR IS TO DELIVER TO OWNER THE PROJECT IN A COMPLETE AND OPERATIONAL MANNER.

TOPOGRAPHIC SURVEY NOTES

TOPOGRAPHIC SURVEY INFORMATION SHOWN HEREON IS BASED UPON MULTIPLE SUPPLEMENTAL TOPOGRAPHIC SURVEYS COMPLETED BY SANDIS, UNDER THE DIRECTION OF LAURA CABRAL, PLS 7756, IN ADDITION TO BASEMAP INFORMATION PROVIDED BY STANFORD UNIVERSITY.

DEMOLITION NOTES

- CONTRACTOR SHALL PROVIDE LABOR, MATERIAL AND EQUIPMENT REQUIRED FOR DEMOLISHING, CUTTING, CAPPING, REMOVING AND DISPOSING OF EXISTING IMPROVEMENTS AS DESIGNATED AND SHOWN ON THE DRAWINGS AND AS REQUIRED, UNLESS OTHERWISE NOTED.
- 2. CONTRACTOR SHALL DEMOLISH, ABANDON OR REROUTE EXISTING UTILITIES AS REQUIRED FOR NEW CONSTRUCTION. UTILITIES AND APPURTENANCES TO REMAIN WITHIN THE PROJECT LIMIT OF WORK SHALL BE PROTECTED.
- 3. CONTRACTOR SHALL MAINTAIN THE EXISTING SITE LIGHTING SYSTEM UNLESS OTHERWISE NOTED.
- 4. CONTRACTOR SHALL COORDINATE ALL UTILITY SHUT-DOWNS WITH THE OWNER'S *REPRESENTATIVE*. 5. ITEMS INDICATED TO BE SALVAGED SHALL BE REMOVED CAREFULLY, CLEANED AND
- DELIVERED TO THE OWNER. COORDINATE WITH THE OWNER'S REPRESENTATIVE. 6. CONTRACTOR SHALL PERFORM WORK IN ACCORDANCE WITH THE PROJECT
- SPECIFICATIONS.

SCOPE OF WORK

CONSTRUCTION OF TENNIS COURT COVERING AND STRUCTURAL COLUMNS, AND ASSOCIATED SITE IMPROVEMENTS.

STREET CLEANING NOTE

THE PRIME CONTRACTOR OR DEVELOPER IS TO HIRE A STREET CLEANING CONTRACTOR TO CLEAN UP DIRT AND DEBRIS FROM UNIVERSITY STREETS THAT ARE ATTRIBUTABLE TO THE DEVELOPMENT'S CONSTRUCTION ACTIVITIES. THE STREET CLEANING CONTRACTOR IS TO HAVE THE CAPABILITY OF WASHING THE STREETS FROM A TANKER TRUCK WITH A HIGH-PRESSURE NOZZLE WITH RECLAIMED WATER, WHERE FEASIBLE, AND/OR SWEEPING THE STREETS WITH BOTH A BROOM-TYPE SWEEPER AND A REGENERATIVE AIR VACUUM SWEEPER, AS DIRECTED BY THE DISTRICT, OR HIS/ HER DESIGNATED REPRESENTATIVE.

SHUT DOWN NOTE

CONTRACTOR SHALL COORDINATE ALL SYSTEM SHUT DOWNS WITH OWNER. NO SHUT DOWNS OF ANY SERVICES WILL BE ALLOWED WITHOUT PRIOR SCHEDULE APPROVAL OF OWNER AND THEIR TENANTS.

DISCREPANCIES

IF THERE ARE ANY DISCREPANCIES BETWEEN THE CONSTRUCTION DOCUMENTS AND EXISTING CONDITIONS WHICH WILL AFFECT THE WORK, THE CONTRACTOR SHALL BRING SUCH DISCREPANCIES TO THE ATTENTION OF THE ENGINEER FOR ADJUSTMENT BEFORE PROCEEDING WITH THE WORK. THE CONTRACTOR SHALL BE RESPONSIBLE FOR THE PROPER FITTING OF ALL WORK AND FOR THE COORDINATION OF ALL TRADES, SUBCONTRACTORS. AND PERSONS ENGAGED UPON THIS CONTRACT.

HYDROMODIFICATION NOTE

THE PROJECT IS EXEMPT FROM HYDROMODIFICATION REQUIREMENTS PER THE SANTA CLARA COUNTY C.3 TECHNICAL GUIDANCE DOCUMENT. THE PROJECT IS EXEMPT FROM HYDROMODIFICATION DUE TO THE SITE BEING LOCATED IN A WATER SHED THAT DISCHARGES TO A TIDAL AREA. HARDENED CHANNEL, OR DIRECTLY TO THE BAY.

FLOODZONE

SITE IS LOCATED WITHIN ZONE D BASED ON FIRM MAP PANEL NUMBER 06085 C0016H, NATED MAY 18 2009. ZONE D IS THE AREA DETERMINED TO BE AREAS FOR WHICH FLOOD HAZARDS ARE UNDETERMINED, BUT POSSIBLE.

UTILITY NOTE

THE TYPES, LOCATIONS, SIZES AND /OR DEPTHS OF EXISTING UNDERGROUND UTILITIES AS SHOWN ON THIS TOPOGRAPHIC SURVEY ARE APPROXIMATE AND WERE OBTAINED FROM SOURCES OF VARYING RELIABILITY. ONLY ACTUAL EXCAVATION WILL REVEAL THE TYPES, EXTENT, SIZES, LOCATIONS AND DEPTHS OF SUCH UNDERGROUND UTILITIES. A REASONABLE EFFORT HAS BEEN MADE TO LOCATE AND DELINEATE ALL KNOWN UNDERGROUND UTILITIES. HOWEVER, THE ENGINEER CAN ASSUME NO RESPONSIBILITY FOR THE COMPLETENESS OR ACCURACY OF ITS DELINEATION OF SUCH UNDERGROUND UTILITIES WHICH MAY BE ENCOUNTERED. BUT WHICH ARE NOT SHOWN ON THIS SURVEY.

FIRE SYSTEM NOTES

THE CONTRACTOR SHALL DESIGN, PREPARE SHOP DRAWINGS FOR, OBTAIN ALL REQUIRED APPROVALS, AND CONSTRUCT THE FIRE SYSTEM FOR THE PROPOSED PROJECT.

- PROJECT LOCATION LOS GATOS

COUNTY LOCATION MAP

ENGINEER'S STATEMENT

I HEREBY STATE THAT THESE PLANS ARE IN COMPLIANCE WITH ADOPTED COUNTY STANDARDS, THE APPROVED TENTATIVE MAP (OR PLAN) AND CONDITIONS OF APPROVAL PERTAINING THERETO DATED

R.C.E. NO.

COUNTY ENGINEER'S NOTE

ISSUANCE OF A PERMIT AUTHORIZING CONSTRUCTION DOES NOT RELEASE THE DEVELOPER, PERMITTEE OF ENGINEER FROM RESPONSIBILITY FOR THE CORRECTION OF ERRORS OR OMISSIONS CONTAINED IN THE PLANS. IF, DURING THE COURSE OF CONSTRUCTION, THE PUBLIC INTEREST REQUIRES A MODIFICATION OF (OR DEPARTURE FROM) THE SPECIFICATIONS OF THE PLANS, THE COUNTY SHALL HAVE THE AUTHORITY TO REQUIRE THE SUSPENSION OF WORK, AND THE NECESSARY MODIFICATION OR DEPARTURE AND TO SPECIFY THE MANNER IN WHICH THE SAME IS TO BE MADE.

SIGNATURE

R.C.E. NO. EXPIRATION DATE COUNTY OF SANTA CLARA LAND DEVELOPMENT ENGINEERING & SURVEYING CONSTRUCTION PERMIT NO. GRADING PERMIT NO. ISSUED BY: _____ DATE:_

CIVIL SHEET INDEX COVER SHEET

C-1.2FIRE SAFETY NOTES C-2.0 TOPOGRAPHIC SURVEY C-3.0 DEMOLITION/TREE REMOVAL PLAN C-3.1DEMOLITION/TREE REMOVAL NOTES C-4.0 GRADING AND DRAINAGE PLAN C-5.0 UTILITY PLAN C-6.0STORMWATER MANAGEMENT PLAN C-7.0 EROSION CONTROL PLAN C-7.1 COUNTY BMP NOTES C-7.2 COUNTY BMP NOTES C-8.0



TRENCH DRAIN CONDENSATE RETURN FLOW LINE CHAIN LINK FENCE —___x —___x —__ GAS MAIN ELECTRIC AND SIGNAL DUCT BANK OVERHEAD ELECTRIC LINE UNDERGROUND ELECTRIC LINE STREET LIGHT CONDUIT CONTOUR ELEVATION LINE FG 95.94 SPOT ELEVATION x 95.94 % DIRECTION OF SLOPE GAS METER GAS VALVE WATER METER WATER VALVE XX +O+ FIRE HYDRANT BACK FLOW PREVENTOR POST INDICATOR VALVE FIRE DEPARTMENT CONNECTION WATER LINE TEE CAP AND PLUG END AIR RELEASE VALVE SIGN ACCESSIBLE RAMP CONCRETE THRUST BLOCK REDUCER SANITARY SEWER MANHOLE SANITARY SEWER CLEANOUT STORM DRAIN MANHOLE \bigcirc STORM DRAIN AREA DRAIN STORM DRAIN CATCH BASIN ☐ CB STORM DRAIN CURB INLET SDCO STORM DRAIN CLEANOUT **ELECTROLIER** •* JOINT POLE OVERLAND RELEASE

LEGEND

RETAINING WALL

A.C. PAVEMENT

CONC. VALLEY GUTTER

6" CURB & GUTTER

6" VERTICAL CURB

SANITARY SEWER MAIN

STORM DRAIN MAIN

PERFORATED PIPE

FIRE WATER MAIN

DOMESTIC WATER MAIN

CHILLED WATER MAIN

HOT WATER SUPPLY & RETURN

IRRIGATION LINE

LAKE WATER LINE

STEAM LINE

WATER MAIN

CENTER LINE

CONC. SIDEWALK OR PAD

EDGE OF A.C. PAVEMENT

SAWCUT AND CONFORM LINE

EXISTING

PROPOSED

EXPIRATION DATE

C-1.1CONSTRUCTION NOTES

CONSTRUCTION SITE LOGISTICS/SAFETY PLAN C-9.0 FIRE ACCESS PLAN

All changes to the plans must be in writing and must be approved by the preparer of the plans. Construction contractor agrees that in accordance with generally accepted construction practices, construction contractor will be required to assume sole and complete responsibility or job site conditions during the course of construction of the project, including safety of all persons and property; that this requirement shall be made to apply continuously and no be limited to normal working hours and construction contractor further agrees to defend, indemnify and hold design professional harmless from any and all liability, real or alleged in connection with the performance of work on this project, excepting liability arising from sole negligence of design professional.

UNAUTHORIZED CHANGES AND USES

CAUTION: The engineer preparing these plans will not be responsible

for, or liable for, unauthorized changes to or uses of these plans.

CONSTRUCTION DETAIL REFERENCE

Consulting Engineers & Land Surveyors of California

DETAIL REFERENC

SHEET REFERENCE

C5.2

STANFORD UNIVERSITY

Project Name: Covered Tennis Courts Project Address: 638 Campus Drive, Stanford CA. 94305 Quad/ Bldg. Number: 08-025





ISSUES AND REVISIONS 03.01.2023 ASA SET

05.31.2023 ASA RESUBMITTAL SET

PROJECT NUMBER

SHEET TITLE

COVER SHEET

SCALE

SHEET NUMBER

COUNTY OF SANTA CLARA GENERAL CONSTRUCTION SPECIFICATIONS **GENERAL CONDITIONS**

- ALL CONSTRUCTION WORK SHALL BE PERFORMED IN ACCORDANCE WITH THE SOILS AND/OR GEOTECHNICAL REPORT PREPARED BY CORNERSTONE EARTH GROUP. THIS REPORT IS SUPPLEMENTED BY:
- 1) THESE PLANS AND SPECIFICATIONS,
- 2) THE COUNTY OF SANTA CLARA STANDARD DETAILS. 3) THE COUNTY OF SANTA CLARA STANDARD SPECS,
- 4) STATE OF CALIFORNIA STANDARD DETAILS. 5) STATE OF CALIFORNIA STANDARD SPECIFICATIONS.
- IN THE EVENT OF CONFLICT THE FORMER SHALL TAKE PRECEDENCE OVER THE LATTER. THE PERFORMANCE AND COMPLETION OF ALL WORK MUST BE TO THE SATISFACTION OF THE COUNTY.
- . DEVELOPER IS RESPONSIBLE FOR INSTALLATION OF THE IMPROVEMENTS SHOWN ON THESE PLANS AND HE OR HIS SUCCESSOR PROPERTY OWNERS ARE RESPONSIBLE FOR THEIR CONTINUED MAINTENANCE.
- DEVELOPER SHALL BE RESPONSIBLE FOR CORRECTION OF ANY ERRORS OR OMISSIONS IN THESE PLANS. THE COUNTY SHALL BE AUTHORIZED TO REQUIRE DISCONTINUANCE OF ANY WORK AND SUCH CORRECTION AND MODIFICATION OF PLANS AS MAY BE NECESSARY TO COMPLY WITH COUNTY STANDARDS OR CONDITIONS OF DEVELOPMENT APPROVAL.
- DEVELOPER SHALL OBTAIN ENCROACHMENT PERMITS FROM THE SANTA CLARA VALLEY WATER DISTRICT AND CALIFORNIA DEPARTMENT OF TRANSPORTATION WHERE NEEDED. COPIES OF THESE PERMITS SHALL BE KEPT AT THE JOB SITE FOR REVIEW BY THE COUNTY'S INSPECTOR.
- DEVELOPER SHALL REMOVE OR TRIM ALL TREES TO PROVIDE AN UNOBSTRUCTED FIFTEEN (15) FOOT VERTICAL CLEARANCE FOR ROADWAY AREA.
- THIS PLAN AUTHORIZES THE REMOVAL OF ONLY THOSE TREES WITH TRUNK DIAMETERS GREATER THAN 12 INCHES MEASURED 4.5 FEET ABOVE THE GROUND THAT ARE SHOWN TO BE REMOVED UNLESS AN AMENDED PLAN IS APPROVED OR A SEPARATE TREE REMOVAL PERMIT IS OBTAINED FROM THE PLANNING OFFICE. IT IS THE CONTRACTOR'S RESPONSIBILITY TO ENSURE THAT REMOVAL OF ADDITIONAL TREES HAS BEEN PERMITTED.
- DEVELOPER SHALL PROVIDE ADEQUATE DUST CONTROL AS REQUIRED BY THE COUNTY INSPECTOR.
- 8. ALL PERSONS MUST COMPLY WITH SECTION 4442 OF THE PUBLIC RESOURCES CODE AND SECTION 13005 OF THE HEALTH AND SAFETY CODE RELATING TO THE USE OF SPARK ARRESTERS.
- UPON DISCOVERING OR UNEARTHING ANY BURIAL SITE AS EVIDENCED BY HUMAN SKELETAL REMAINS OR ARTIFACTS, THE PERSON MAKING SUCH DISCOVERY SHALL IMMEDIATELY NOTIFY THE COUNTY CORONER AT (408) 454-2520 AND LAND DEVELOPMENT ENGINEERING OFFICE AT (408) 299-5730. NO FURTHER DISTURBANCE OF THE SITE MAY BE MADE EXCEPT AS AUTHORIZED BY THE LAND DEVELOPMENT OFFICE IN ACCORD WITH PROVISIONS OF THIS ORDINANCE (COUNTY ORDINANCE CODE SECTION B6-18).
- 10. THESE PLANS ARE FOR THE WORK DESCRIBED IN THE SCOPE OF WORK ONLY. A SEPARATE PERMIT WILL BE REQUIRED FOR THE SEPTIC LINE CONSTRUCTION.
- 11. ANY DEVIATION FROM THESE APPROVED PLANS SHALL BE RE-APPROVED IN WRITING BY THE COUNTY ENGINEER PRIOR TO CONSTRUCTION.
- 12. "THE BAY AREA AIR QUALITY MANAGEMENT DISTRICT (BAAQMD) HAS IDENTIFIED A SET OF FEASIBLE PM10 CONTROL MEASURES FOR ALL CONSTRUCTION ACTIVITIES. THESE CONTROL MEASURES, AS PREVIOUSLY REQUIRED IN THE EIR, SHALL BE ADHERED TO DURING ALL CONSTRUCTION ACTIVITIES.
- A. WATER ALL ACTIVE CONSTRUCTION AREA AT LEAST TWICE DAILY.
- B. COVER ALL TRUCK HAULING SOIL, SAND AND OTHER LOOSE MATERIALS OR REQUIRE ALL TRUCKS TO MAINTAIN AT LEAST TWO FEET OF FREEBOARD.
- C. PAVE. APPLY WATER THREE TIMES DAILY. OR APPLY (NON-TOXIC) SOIL STABILIZERS ON ALL UNPAVED ACCESS ROADS. PARKING AREAS AND STAGING AREAS AT CONSTRUCTION SITES.
- SWEEP DAILY (WITH WATER SWEEPERS) ALL PAVED ACCESS ROADS, PARKING AREAS, AND STAGING AREAS AT CONSTRUCTIONS SITES.
- SWEEP STREETS DAILY (WITH WATER SWEEPERS) IF VISIBLE SOIL MATERIAL ARE CARRIED ONTO ADJACENT PUBLIC STREETS.
- F. HYDROSEED OR APPLY (NON-TOXIC) SOIL STABILIZERS TO INACTIVE CONSTRUCTION AREA (PREVIOUSLY GRADED AREAS INACTIVE FOR TEN DAYS OR MORE).
- G. ENCLOSE, COVER, WATER TWICE DAILY OR APPLY (NON-TOXIC) SOIL BINDERS TO EXPOSED STOCKPILES (DIRT, SAND).
- H. LIMIT TRAFFIC SPEEDS ON UNPAVED ROADS TO 15 MPH.
- I. INSTALL FIBER ROLLS, SAND BAGS OR OTHER EROSION CONTROL MEASURES TO PREVENT SILT RUNOFF TO PUBLIC ROADWAYS.
- J. REPLANT VEGETATIONS DISTURBED AREAS AS QUICKLY AS POSSIBLE.
- K. INSTALL WHEEL WASHERS FOR ALL EXISTING TRUCKS , OR WASH OFF THE TIRES OF TRACKS OF ALL TRUCKS AND EQUIPMENT LEAVING THE SITE AND
- L. SUSPEND EXCAVATION AND GRADING ACTIVITY WHEN WINDS (INSTANTANEOUS GUSTS) EXCEED 25 MPH.
- 13. PLACE A CONSTRUCTION NOTE ON THE SITE PLAN THAT STATES THE FOLLOWING: "ALL CONSTRUCTION CONTRACTORS SHALL PROPERLY MAINTAIN THE EQUIPMENT EQUIPMENT AND EMISSIONS CONTROL " CLEAN FUEL " WHERE FEASIBLE USE TECHNOLOGY (E.G. CNS FIRED ENGINES, CATALYTIC CONVERTERS, PARTICULATE TRAPS, ETC.). MEASURES TO REDUCE DIESEL EMISSION WOULD BE CONSIDERED FEASIBLE WHEN THEY ARE CAPABLE OF BEING USED ON EQUIPMENT, WITHOUT INTERFERING SUBSTANTIALLY WITH EQUIPMENT PERFORMANCE.
- 14. IN THE EVENT THAT PREVIOUSLY UNIDENTIFIED HISTORIC AND PREHISTORIC ARCHAEOLOGICAL RESOURCES ARE DISCOVERED DURING BUILDING CONSTRUCTION, THE CONTRACTOR SHALL CEASE WORK IN THE IMMEDIATE AREA AND THE COUNTY PLANNING OFFICE AND CAMPUS ARCHAEOLOGIST SHALL BE CONTACTED. AN INDEPENDENT QUALIFIED ARCHAEOLOGIST RETAINED BY THE COUNTY AT THE EXPENSE OF STANFORD SHALL ASSESS THE SIGNIFICANCE OF THE FIND AND MAKE MITIGATION RECOMMENDATIONS.

- 15. IF ARCHEOLOGICAL RESOURCES ARE DISCOVERED AS DESCRIBED ABOVE, CONSTRUCTION MONITORING SHALL BE CONDUCTED AT ANY TIME GROUND-DISTURBING ACTIVITIES (GREATER THAN 12 IN DEPTH) ARE TAKING PLACE IN THE IMMEDIATE VICINITY OF THE IDENTIFIED RESOURCES. IF MONITORING DOES NOT PRODUCE EVIDENCE OF SIGNIFICANT CULTURAL RESOURCES WITHIN THE PROJECT AREA, FURTHER MITIGATION SHALL BE LIMITED TO CONSTRUCTION MONITORING, UNLESS ADDITIONAL TESTING OR OTHER SPECIFIC MITIGATION MEASURES ARE DETERMINED BY A QUALIFIED ARCHAEOLOGIST TO BE NECESSARY TO ENSURE AVOIDANCE OR DAMAGE TO SIGNIFICANT ARCHEOLOGICAL RESOURCES. A TECHNICAL REPORT OF FINDINGS DESCRIBING THE RESULTS OF ALL MONITORING SHALL BE PREPARED IN ACCORDANCE WITH PROFESSIONAL STANDARDS. THE ARCHAEOLOGICAL MONITORING PROGRAM SHALL BE IMPLEMENTED BY AN INDIVIDUAL MEETING THE SECRETARY OF INTERIOR PROFESSIONAL QUALIFICATIONS STANDARDS IN ARCHAEOLOGY (36 CFR 61); INDIVIDUAL FIELD MONITORS SHALL BE QUALIFIED IN THE RECOGNITION OF CULTURAL RESOURCES AND POSSESS SUFFICIENT ACADEMIC AND FIELD TRAINING AS REQUIRED TO CONDUCT THE WORK EFFECTIVELY AND WITHOUT UNDUE
- 16. IN THE EVENT THAT HUMAN SKELETAL REMAINS ARE ENCOUNTERED, THE APPLICANT IS REQUIRED BY COUNTY ORDINANCE NO. B6-18 TO IMMEDIATELY NOTIFY THE COUNTY CORONER. UPON DETERMINATION BY THE COUNTY CORONER THAT THE REMAINS ARE NATIVE AMERICAN, THE CORONER SHALL CONTACT THE CALIFORNIA NATIVE AMERICAN HERITAGE COMMISSION, PURSUANT TO SUBDIVISION (C) OF SECTION 7050.5 OF THE HEALTH AND SAFETY CODE AND THE COUNTY COORDINATOR OF INDIAN AFFAIRS. NO FURTHER DISTURBANCE OF THE SITE MAY BE MADE EXCEPT AS AUTHORIZED BY THE COUNTY COORDINATOR OF INDIAN AFFAIRS IN ACCORDANCE WITH THE PROVISIONS OF STATE LAW AND THIS CHAPTER. IF ARTIFACTS ARE FOUND ON THE SITE A QUALIFIED ARCHAEOLOGIST SHALL BE CONTACTED ALONG WITH THE COUNTY PLANNING OFFICE. NO FURTHER DISTURBANCE OF THE ARTIFACTS MAY BE MADE EXCEPT AS AUTHORIZED BY THE COUNTY PLANNING OFFICE.
- 17. IN THE EVENT THAT FOSSILIZED SHELL OR BONE IS UNCOVERED DURING ANY EARTH-DISTURBING OPERATION, CONTRACTORS SHALL STOP WORK IN THE IMMEDIATE AREA OF THE FIND AND NOTIFY THE CAMPUS ARCHAEOLOGIST AND THE COUNTY BUILDING INSPECTOR ASSIGNED TO THE PROJECT. THE CAMPUS ARCHAEOLOGIST SHALL VISIT THE SITE AND MAKE RECOMMENDATIONS FOR TREATMENT OF THE FIND (INCLUDING BUT NOT LIMITED TO CONSULTATION WITH A PALEONTOLOGIST AND EXCAVATION, IF WARRANTED), WHICH WOULD BE SENT TO THE COUNTY BUILDING INSPECTION OFFICE AND THE COUNTY PLANNING OFFICE. IF A FOSSIL FIND IS CONFIRMED, IT WILL BE RECORDED WITH THE UNITED STATES GEOLOGICAL SURVEY AND CURATED IN AN APPROPRIATE REPOSITORY.
- 18. ONE SIGN SHALL BE POSTED ALONG A STREET FRONTAGE OR IN FRONT OF THE PROJECT SITE, NO SMALLER THAN 1,296 SQUARE INCHES IN SIZE, CONTAINING THE NAME, TELEPHONE NUMBER, AND EMAIL ADDRESS OF THE APPROPRIATE STANFORD PERSON THE PUBLIC MAY CONTACT TO REGISTER A COMPLAINT ABOUT CONSTRUCTION NOISE. STANFORD SHALL KEEP A WRITTEN RECORD OF ALL SUCH COMPLAINTS AND SHALL PROVIDE COPIES OF THESE RECORDS TO THE COUNTY PLANNING OFFICE.
- 19. CONSTRUCTION MATERIALS AND FILL DIRT DELIVERED FROM OFF CAMPUS SHALL NOT BE DELIVERED BETWEEN THE HOURS OF 7:00 AM TO 9:00 AM AND 4:00 PM TO 6:00 PM ON WEEKDAYS.
- 20. TRUCKS EXPORTING/IMPORTING FILL DIRT AND BUILDING MATERIALS FOR THE PROJECT SHALL USE APPROVED TRUCK ROUTES SHOWN IN THE 2000 GUP, AS DESIGNATED BY THE CITIES OF PALO ALTO AND MENLO PARK.

CONSTRUCTION STAKING

- 1. THE DEVELOPER'S ENGINEER IS RESPONSIBLE FOR THE INITIAL PLACEMENT AND REPLACEMENT OF CONSTRUCTION GRADE STAKES. THE STAKES ARE TO BE ADEQUATELY IDENTIFIED, LOCATED, STABILIZED, ETC. FOR THE CONVENIENCE OF CONTRACTORS. LATERAL OFFSET OF STAKES SET FOR CURBS AND GUTTERS SHALL NOT EXCEED 2 1/2 FEET FROM BACK OF
- 2. ANY PROPERTY LINE STAKES OR ROAD MONUMENTS DISTURBED DURING CONSTRUCTION SHALL BE REPLACED BY DEVELOPER'S ENGINEER AND LICENSED LAND SURVEYOR.
- PROPERTY LINE STAKING MUST BE PERFORMED BY THE PROJECT ENGINEER OR LAND SURVEYOR TO ESTABLISH OR RE-ESTABLISH THE PROJECT BOUNDARY AND SHALL BE INSPECTED BY THE COUNTY INSPECTOR PRIOR TO THE BEGINNING OF THE WORK.
- 4. PROPER CONSTRUCTION STAKES SHALL BE SET IN THE FIELD BY THE PROJECT ENGINEER OR LAND SURVEYOR AND VERIFIED BY THE COUNTY INSPECTOR PRIOR TO THE COMMENCEMENT OF GRADING.

CONSTRUCTION INSPECTION

- CONTRACTOR SHALL NOTIFY PERMIT INSPECTION UNIT, SANTA CLARA COUNTY PRIOR TO COMMENCING WORK AND FOR FINAL INSPECTION OF WORK AND SITE.
- 2. THE COUNTY REQUIRES A MINIMUM OF 24 HOURS ADVANCE NOTICE FOR GENERAL INSPECTION, 48 HOURS FOR ASPHALT CONCRETE INSPECTION.
- 3. INSPECTION BY SANTA CLARA COUNTY SHALL BE LIMITED TO INSPECTION OF MATERIALS AND PROCESSES OF CONSTRUCTION TO OBSERVE THEIR COMPLIANCE WITH PLANS & SPECIFICATIONS BUT DOES NOT INCLUDE RESPONSIBILITY FOR THE SUPERINTENDENT OF CONSTRUCTION, SITE CONDITIONS, EQUIPMENT OR PERSONNEL. CONTRACTOR SHALL NOTIFY THE COUNTY LAND DEVELOPMENT INSPECTOR AT PHONE (408) 299-6868 AT LEAST 24 HOURS PRIOR TO COMMENCING WORK AND FOR FINAL INSPECTION OF WORK AND SITE.
- 4. DEVELOPER AND/OR HIS AUTHORIZED REPRESENTATIVE MUST SUBMIT WRITTEN REQUEST FOR FINAL INSPECTION AND ACCEPTANCE. SAID REQUEST SHALL BE DIRECTED TO THE INSPECTION OFFICE NOTED ON THE PERMIT FORM.
- 5. THE CONTRACTOR SHALL PROVIDE TO THE COUNTY CONSTRUCTION INSPECTOR WITH PAD ELEVATION AND LOCATION CERTIFICATES, PREPARED BY THE PROJECT ENGINEER OR LAND SURVEYOR, PRIOR COMMENCEMENT OF THE BUILDING FOUNDATION.

SITE PREPARATION (CLEARING AND GRUBBING)

- 1. EXISTING TREES AUTHORIZED FOR REMOVAL, ROOTS, AND FOREIGN MATERIAL IN AREAS TO BE IMPROVED WILL BE REMOVED TO AN AUTHORIZED DISPOSAL SITE AS FOLLOWS:
- A) TO A MINIMUM DEPTH OF TWO FEET BELOW THE FINISHED GRADE OF PROPOSED ROADWAYS (EITHER PRIVATE OR TO BE DEDICATED TO PUBLIC
- B) FROM AREAS AFFECTED BY THE PROPOSED GRADING EXCEPT WHERE NOTED ON THE PLANS.
- 2. IT SHALL BE THE RESPONSIBILITY OF THE DEVELOPER TO MOVE OR RELOCATE UTILITY POLES AND OTHER OBSTRUCTIONS IN THE WAY OF CONSTRUCTION.

UTILITY LOCATION, TRENCHING & BACKFILL

- CONTRACTOR SHALL NOTIFY USA (UNDERGROUND SERVICE ALERT) AT 1-800-277-2600 A MINIMUM OF 24 HOURS BEFORE BEGINNING UNDERGROUND WORK FOR VERIFICATION OF THE LOCATION OF UNDERGROUND UTILITIES.
- 2. ACCURATE VERIFICATION AS TO SIZE. LOCATION, AND DEPTH OF EXISTING UNDERGROUND CONDUITS OR FACILITIES SHALL BE THE INDIVIDUAL CONTRACTORS RESPONSIBILITY. PLAN LOCATIONS ARE APPROXIMATE AND FOR GENERAL INFORMATION ONLY.
- 3. ALL UNDERGROUND INSTALLATIONS SHALL BE IN PLACE AND THE TRENCH BACKFILLED AND COMPACTED BEFORE PLACING AGGREGATE BASE MATERIAL OR SURFACE STRUCTURES. SURFACING MAY BE DONE IF THE UTILITY COMPANY CONCERNED INDICATES BY LETTER THAT IT WILL BORE. UNLESS SPECIFICALLY AUTHORIZED BY THE COUNTY, GAS AND WATER MAINS SHALL BE INSTALLED OUTSIDE THE PAVED AREAS.
- 4. TRENCH BACKFILL IN EXISTING PAVEMENT AREAS SHALL BE SAND MATERIAL IN ACCORDANCE WITH THE APPLICABLE PROVISIONS OF THE STATE SPECIFICATIONS. THE STRUCTURAL SECTION FOR TRENCH REPLACEMENT SHALL CONSIST OF NOT LESS THAN 12 INCHES OF APPROVED AGGREGATE BASE MATERIAL COMPACTED TO A RELATIVE COMPACTION OF AT LEAST 95%% AND 4 INCHES OF HOT ASPHALT CONCRETE PLACED IN TWO LIFTS. TRENCH RESTORATION FOR HIGHER TYPE PAVEMENTS SHALL BE MADE IN KIND OR AS DIRECTED BY THE COUNTY.
- 5. TRENCH BACKFILL IN NEW CONSTRUCTION AREAS SHALL BE SAND MATERIAL COMPACTED TO A RELATIVE COMPACTION OF AT LEAST 90%%. THE REQUIREMENT FOR SELECT MATERIAL MAY BE WAIVED BY COUNTY IF THE NATIVE SOIL IS SUITABLE FOR USE AS TRENCH BACKFILL BUT THE COMPACTION REQUIREMENTS WILL NOT BE THEREBY WAIVED.
- 6. BACKFILL AND TRENCH RESTORATION REQUIREMENTS SHALL APPLY AS MINIMUM STANDARDS TO ALL UNDERGROUND FACILITIES INSTALLED BY OTHER FIRMS OR PUBLIC AGENCIES.

<u>GRADING</u>

- 1. EXCAVATED MATERIAL SHALL BE PLACED IN THE FILL AREAS DESIGNATED OR SHALL BE HAULED AWAY FROM THE SITE. WHERE FILL MATERIAL IS TO BE PLACED ON NATURAL GROUND, IS SHALL BE STRIPPED OF ALL VEGETATION. TO ACHIEVE A PROPER BOND WITH THE FILL MATERIAL, THE SURFACE OF THE GROUND SHALL BE SCARIFIED TO DEPTH OF 6" BEFORE FILL IS PLACED. WHERE NATURAL GROUND IS STEEPER THAN 5:1, IT SHALL BE BENCHED AND THE FILL KEYED IN TO ACHIEVE STABILITY. WHERE NEW FILL IS TO BE PLACED ON EXISTING FILL THE EXISTING FILL SHALL BE REMOVED UNTIL MATERIAL COMPACTED TO 90% RELATIVE COMPACTION IS EXPOSED. THEN THE NEW FILL MATERIAL SHALL BE PLACED AS PER THESE CONSTRUCTION NOTES. FILL MATERIAL SHALL BE PLACED IN UNIFORM LIFTS NOT EXCEEDING 6" IN UNCOMPACTED THICKNESS. BEFORE COMPACTION BEGINS, THE FILL SHALL BE BROUGHT TO A WATER CONTENT THAT WILL PERMIT PROPER COMPACTION BY EITHER 1) AERATING THE FILL IF IT IS TOO WET OR 2) MOISTENING THE FILL WITH WATER IF IT IS TOO DRY. EACH LIFT SHALL BE THOROUGHLY MIXED BEFORE COMPACTION TO ENSURE A UNIFORM DISTRIBUTION OF MOISTURE.
- 2. SURPLUS EARTH FILL MATERIAL SHALL BE PLACED IN A SINGLE (8" MAX) THICK LAYER COMPACTED TO WITHSTAND WEATHERING IN THE AREA(S) DELINEATED ON THE PLAN.
- 3. NO ORGANIC MATERIAL SHALL BE PLACED IN ANY FILL. NO TREES SHALL BE REMOVED OUTSIDE OF CUT, FILL OR ROADWAY AREAS.
- 4. THE UPPER 6" OF SUBGRADE BELOW DRIVEWAY ACCESS ROAD OR

FILL SLOPE SHALL 2 HORIZONTAL TO 1 VERTICAL

MAXIMUM DEPTH OF

PARKING AREA SHALL BE COMPACTED TO 95% OF MAXIMUM DENSITY. 5. MAXIMUM CUT SLOPE SHALL BE 2 HORIZONTAL TO 1 VERTICAL. MAXIMUM

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ESTIMATED	VOLUME (OF SITE (GRADING	0	CUBIC	YARDS	CL
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CUT

FILL

EXCESS MATERIAL SHALL BE OFF HAULED TO A COUNTY APPROVED DUMP

O FEET

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- 6. NOTIFY SOILS ENGINEER TWO (2) DAYS PRIOR TO COMMENCEMENT OF ANY GRADING WORK TO COORDINATE THE WORK IN THE FIELD.
- 7. ALL MATERIALS FOR FILL SHOULD BE APPROVED BY THE SOILS ENGINEER BEFORE IT IS BROUGHT TO THE SITE.
- 8. THE UPPER 6" OF THE SUBGRADE SOIL SHALL BE SCARIFIED, MOISTURE CONDITIONED AND COMPACTED TO A MINIMUM RELATIVE COMPACTION OF
- 9. ALL AGGREGATE BASE MATERIAL SHALL BE COMPACTED TO A MINIMUM 95% RELATIVE COMPACTION.
- 10. THE GEOTECHNICAL PLAN REVIEW LETTER MUST BE REVIEWED AND APPROVED BY THE COUNTY GEOLOGIST PRIOR TO FINAL APPROVAL BY THE COUNTY ENGINEER FOR BUILDING OCCUPANCY.
- 11. THE PROJECT GEOTECHNICAL ENGINEER SHALL PERFORM COMPACTION TESTING AND PRESENT THE RESULTS TO THE COUNTY ENGINEERING INSPECTOR PRIOR TO THE CONSTRUCTION OF ANY PAVED AREA.

1. WATER ALL ACTIVE CONSTRUCTION AREAS AT LEAST TWICE DAILY.

- AIR QUALITY, LANDSCAPING AND EROSION CONTROL
- 2. COVER ALL TRUCKS HAULING SOIL. SAND, AND OTHER LOOSE MATERIALS OR REQUIRE ALL TRUCKS TO MAINTAIN AT LEAST TWO FEET OF FREEBOARD.
- 3. PAVE, APPLY WATER THREE TIMES DAILY, OR APPLY (NON-TOXIC) SOIL STABILIZERS ON ALL UNPAVED ACCESS ROADS, PARKING AREAS AND STAGING AREAS AT CONSTRUCTION SITES.
- 4. SWEEP DAILY (WITH WATER SWEEPERS) ALL PAVED ACCESS ROADS, PARKING AREAS AND STAGING AREAS AT CONSTRUCTION SITES. THE USE OF DRY POWDER SWEEPING IS PROHIBITED.
- 5. SWEEP STREETS DAILY (WITH WATER SWEEPERS) IF VISIBLE SOIL MATERIAL IS CARRIED ONTO ADJACENT PUBLIC STREETS. THE USE OF DRY POWDER SWEEPING IS PROHIBITED.
- 6. ALL CONSTRUCTION VEHICLES, EQUIPMENT AND DELIVERY TRUCKS SHALL HAVE A MAXIMUM IDLING TIME OF 5 MINUTES (AS REQUIRED BY THE CALIFORNIA AIRBORNE TOXIC CONTROL MEASURE TITLE 13, SECTION 2485 OF CALIFORNIA CODE OF REGULATIONS (CCR)). ENGINES SHALL BE SHUT OFF IF CONSTRUCTION REQUIRES LONGER IDLING TIME UNLESS NECESSARY FOR PROPER OPERATION OF THE VEHICLE.

7. ALL VEHICLE SPEEDS ON UNPAVED ROADS SHALL BE LIMITED TO 15 MILES PER HOUR.

8. ALL CONSTRUCTION EQUIPMENT SHALL BE MAINTAINED AND PROPERLY TUNED IN ACCORDANCE WITH MANUFACTURER'S SPECIFICATIONS. ALL EQUIPMENT SHALL BE CHECKED BY A CERTIFIED MECHANIC AND DETERMINED TO BE RUNNING IN PROPER CONDITION PRIOR TO OPERATION.

9. POST A SIGN THAT IS AT LEAST 32 SQUARE FEET MINIMUM 2 INCHES LETTER HEIGHT VISIBLE NEAR THE ENTRANCE OF CONSTRUCTION SITE THAT IDENTIFIES THE FOLLOWING REQUIREMENTS. OBTAIN ENCROACHMENT PERMIT FOR SIGN FROM ROADS DEPARTMENT OR OTHER APPLICABLE AGENCY IF REQUIRED.

- A. 15 MILES PER HOUR (MPH) SPEED LIMIT
- B. 5 MINUTES MAXIMUM IDLING TIME OF VEHICLES C. TELEPHONE NUMBER TO CONTACT THE BAY AREA AIR QUALITY MANAGEMENT DISTRICT REGARDING DUST COMPLAINTS. NOTE PHONE NUMBER OF THE BAY AREA AIR QUALITY MANAGEMENT DISTRICT AIR POLLUTION COMPLAIN HOTLINE OF 1-800-334-6367.
- 10. ALL FILL SLOPES SHALL BE COMPACTED AND LEFT IN A SMOOTH AND FIRM CONDITION CAPABLE OF WITHSTANDING WEATHERING.

11. ALL EXPOSED DISTURBED AREAS SHALL BE SEEDED WITH BROME SEED

- SPREAD AT THE RATE OF 5 LB. PER 1000 SQUARE FEET (OR APPROVED EQUAL). SEEDING AND WATERING SHALL BE MAINTAINED AS REQUIRED TO ENSURE GROWTH. 12. ALL DITCHES SHALL BE LINED PER COUNTY STANDARD SD8.
- 13. ALL STORM DRAINAGE STRUCTURES SHALL BE INSTALLED WITH EFFECTIVE ENTRANCE & OUTFALL EROSION CONTROLS E.G. SACKED CONCRETE RIP-RAP. ENERGY DISSIPATERS SHALL BE INSTALLED AT ALL DITCH OUTFALLS. WHERE OUTFALLS ARE NOT INTO AN EXISTING CREEK OR WATER COURSE, RUNOFF SHALL BE RELEASED TO SHEET FLOW.
- 14. THIS PLAN AUTHORIZES THE REMOVAL OF ONLY THOSE TREES WITH TRUNK DIAMETERS GREATER THAN 12 INCHES MEASURED 4.5 FEET ABOVE THE GROUND WHICH ARE SHOWN TO BE REMOVED. ANY OTHER SUCH TREES ARE NOT TO BE REMOVED UNLESS AMENDED PLAN IS APPROVED OR A SEPARATE TREE REMOVAL PERMIT IS OBTAINED FROM THE PLANNING OFFICE. IT IS THE CONTRACTOR'S RESPONSIBILITY TO ENSURE THAT THE REMOVAL OF ADDITIONAL TREES HAS BEEN PERMITTED.
- 15. PRIOR TO GRADING COMPLETION AND RELEASE OF THE BOND, ALL GRADED AREAS SHALL BE RESEEDED IN CONFORMANCE WITH THE COUNTY GRADING ORDINANCE TO MINIMIZE THE VISUAL IMPACTS OF THE GRADE SLOPES AND REDUCE THE POTENTIAL FOR EROSION OF THE SUBJECT
- 16. PERMANENT LANDSCAPING SHOWN ON THE ATTACHED LANDSCAPE PLAN MUST BE INSTALLED AND FIELD APPROVED BY THE COUNTY PLANNING OFFICE PRIOR TO FINAL APPROVAL BY THE COUNTY ENGINEER, AND FINAL OCCUPANCY RELEASE BY THE BUILDING INSPECTION OFFICE.
- 17. THE OWNER SHALL PREPARE AND PRESENT A WINTERIZATION REPORT TO THE COUNTY INSPECTOR FOR REVIEW PRIOR TO OCTOBER 15TH OF EVERY

ACCESS ROADS AND DRIVEWAYS

- DRIVEWAY LOCATIONS SHALL BE AS SHOWN ON THE IMPROVEMENT PLANS WITH CENTERLINE STATIONING. THE MINIMUM CONCRETE THICKNESS SHALL BE 6 INCHES THROUGHOUT (WITH A MAXIMUM APPROACH SLOPE OF 1 1/4 INCHES PER FOOT).
- 2. ALL DRIVEWAY OR COMMON ACCESS ROAD SECTIONS IN EXCESS OF 15%% LONGITUDINAL SLOPE MUST BE PAVED WITH A MINIMUM 2-INCH ASPHALT LIFT OR FULL DEPTH CONCRETE LIFT PRIOR TO ANY COMBUSTIBLE FRAMING
- 3. ROADWAYS DESIGNATED AS NOT COUNTY MAINTAINED ROADS AS SHOWN ON THE PLAN WILL NOT BE ELIGIBLE FOR COUNTY MAINTENANCE UNTIL THE ROADWAYS ARE IMPROVED (AT NO COST TO THE COUNTY) TO THE PUBLIC MAINTENANCE ROAD STANDARDS APPROVED BY THE BOARD OF SUPERVISORS AND IN EFFECT AT SUCH TIME THAT THE ROADWAYS ARE CONSIDERED FOR ACCEPTANCE INTO THE COUNTY'S ROAD SYSTEM.

<u>RETAINING WALLS</u>

- REINFORCED CONCRETE AND CONCRETE MASONRY UNIT RETAINING WALLS SHALL HAVE FOUNDATION AND REINFORCEMENT INSPECTED BY THE COUNTY ENGINEERING INSPECTOR AND ENGINEER OF RECORD PRIOR TO POURING THE 2. FOUNDATION AND FORMING THE WALL.
- 2. SEGMENTAL BLOCK RETAINING WALLS SHALL HAVE FOUNDATION AND REINFORCEMENT INSPECTED BY THE COUNTY ENGINEERING INSPECTOR.

<u>STREET LIGHTING</u>

1. PACIFIC GAS & ELECTRIC ELECTROLIER SERVICE FEE SHALL BE PAID BY THE DEVELOPER AND/OR HIS AUTHORIZED REPRESENTATIVE.

STORM DRAINAGE

- 1. DEVELOPER IS RESPONSIBLE FOR ALL NECESSARY DRAINAGE FACILITIES WHETHER SHOWN ON THE PLANS OR NOT AND HE OR HIS SUCCESSOR PROPERTY OWNERS ARE RESPONSIBLE FOR THE ADEQUACY AND CONTINUED MAINTENANCE OF THESE FACILITIES IN A MANNER WHICH WILL PRECLUDE ANY HAZARD TO LIFE, HEALTH, OR DAMAGE TO ADJOINING PROPERTY.
- 2. DROP INLETS SHALL BE COUNTY STANDARD TYPE 5 UNLESS OTHERWISE NOTED ON THE PLANS. THE DEVELOPER'S ENGINEER SHALL BE RESPONSIBLE FOR THE PROPER LOCATION OF DROP INLETS. WHERE STREET PROFILE GRADE EXCEEDS 6%% DROP INLETS SHALL BE SET AT 500 ANGLE CURB LINE TO ACCEPT WATER OR AS SHOWN ON THE PLANS.
- WHERE CULVERTS ARE INSTALLED THE DEVELOPER SHALL BE RESPONSIBLE FOR GRADING THE OUTLET DITCH TO DRAIN TO AN EXISTING SWALE OR TO AN OPEN AREA FOR SHEET FLOW.
- UPON INSTALLATION OF DRIVEWAY CONNECTIONS, PROPERTY OWNERS SHALL PROVIDE FOR THE UNINTERRUPTED FLOW OF WATER IN ROADSIDE DITCHES.
- 5. THE COUNTY ENGINEERING INSPECTOR SHALL INSPECT UNDERGROUND DRAINAGE IMPROVEMENTS PRIOR TO BACKFILL.

SANITARY SEWER

ALL MATERIALS AND METHODS OF CONSTRUCTION OF SANITARY SEWERS SHALL CONFORM TO THE SPECIFICATIONS OF THE JURISDICTION INVOLVED. INSPECTION OF SANITARY SEWER WORK SHALL BE DONE BY SAID JURISDICTION.

PORTLAND CEMENT CONCRETE

1. CONCRETE USED FOR STRUCTURAL PURPOSES SHALL BE CLASS "A" (6 SACK PER CUBIC YARD) AS SPECIFIED IN THE STATE STANDARD SPECIFICATIONS. CONCRETE PLACED MUST DEVELOP A MINIMUM STRENGTH FACTOR OF 2800 PSI IN A SEVEN-DAY PERIOD. THE CONCRETE MIX DESIGN SHALL BE UNDER THE CONTINUAL CONTROL OF THE COUNTY INSPECTOR.

<u>AS-BUILT PLANS STATEMENT</u>

THIS IS A TRUE COPY OF THE AS-BUILT PLANS. THERE (___ WERE) (___ WERE NOT) MINOR FIELD CHANGES — MARKED WITH THE SYMBOL (^). THERE (____ WERE) (___ WERE NOT) PLAN REVISIONS INDICATING SIGNIFICANT CHANGES REVIEWED BY THE COUNTY ENGINEER AND MARKED WITH THE SYMBOL

DATE ______ SIGNATURE _____

NOTE: THIS STATEMENT IS TO BE SIGNED BY THE PERSON AUTHORIZED BY THE COUNTY ENGINEER TO PERFORM THE INSPECTION WORK. A REPRODUCIBLE COPY OF THE AS-BUILT PLANS MUST BE FURNISHED TO THE COUNTY ENGINEER AFTER

1. A CONSTRUCTION OBSERVATION LETTER FROM THE RESPONSIBLE GEOTECHNICAL ENGINEER DETAILING CONSTRUCTION OBSERVATIONS AND CERTIFYING THAT THE WORK WAS DONE IN ACCORDANCE WITH THE RECOMMENDATIONS IN THE GEOTECHNICAL REPORTS SHALL BE SUBMITTED PRIOR TO THE GRADING COMPLETION AND RELEASE OF THE

<u>CONSTRUCTION / ENCROACHMENT / GRADING PERMIT</u> FILE(S) NO.:

DATE:

LAND DEVELOPMENT ENGINEERING & SURVEYING DEVELOPMENT SERVICES OFFICE COUNTY OF SANTA CLARA

GENERAL NOTES

OPERATIONS.

ISSUED BY:

CONSTRUCTION.

- THE WATER AND SANITARY UTILITIES SHOWN ON THESE PLANS ARE NOT PART OF THIS GRADING PERMIT AND ARE SHOWN FOR REFERENCE
- THE OWNER AND PRIME CONTRACTOR ARE RESPONSIBLE FOR MAINTAINING PROJECT SITE ACCESS AND NEIGHBORHOOD ACCESS FOR EMERGENCY VEHICLES AND LOCAL RESIDENTS. TREE PROTECTION NOTES
- 1. THE GENERAL CONTRACTOR SHALL TAKE THE FOLLOWING STEPS TO PRESERVE AND PROTECT ALL EXISTING TREES SHOWN TO REMAIN:
- PRIOR TO COMMENCEMENT OF DEMOLITION, GRADING AN CONSTRUCTION, TEMPORARY FENCING SHALL BE INSTALLED AT THE DRIP LINE OF EACH TREE TO BE PRESERVED. REFER TO DETAIL FENCED AREAS SHALL NOT BE VIOLATED DURING CONSTRUCTION.
- B. ALL EXISTING ON SITE TREES INDICATED TO REMAIN SHALL B TRIMMED BY A LICENSED ARBORIST FOUR WEEKS PRIOR T COMMENCEMENT OF DEMOLITION OF GRADING OPERATIONS. AL BROKEN OR BRUISED BRANCHES AND DEAD WOOD SHALL BE REMOVED. ALL CUTS OVER ¾" DIAMETER SHALL BE PAINTED WITH "TREE SEAL" OR APPROVED EQUAL. IN NO CASE SHALL ANY TREE BE TOPPED.
- ALL EXISTING ON SITE TREES INDICATED TO REMAINS SHALL BE FERTILIZED BY ROOT INJECTION BY A LICENSED ARBORIST FOU WEEKS PRIOR TO COMMENCEMENT OF GRADING OR DEMOLITION
- ALL EXISTING ON-SITE TREES INDICATED TO REMAIN SHALL BE PRESERVED AND PROTECTED DURING CONSTRUCTION. NO GRADING IS PERMITTED WITHIN THE DRIP-LINE OF ANY TREE INDICATED TO REMAIN. NO DEBRIS OR MATERIALS SHALL BE STOCKPILED AROUND THE BASE OF THE TREES. NO TRADESMAN SHALL DUMP DEBRIS OR FLUIDS WITHIN THE DRIP-LINE OF ANY TREES (PLASTER, PAINT, THINNER, ETC.). ALL TREES SHALL BE FENCED BY THE GENERAL CONTRACTOR TO AVOID COMPACTION OF THE TREE'S ROOT SYSTEM AND DAMAGE TO THE BARK. THE FENCE SHALL BE SIX FEET HIGH, AND EXTEND OUT TO THE DRIP-LINE OF THE TREE.
- 3. ALL EXISTING ON-SITE TREES INDICATED TO REMAIN SHALL BE WATERED BY THE GENERAL CONTRACTOR CONTINUOUSLY DURING THE COURSE OF CONSTRUCTION. IF POTABLE WATER IS NOT AVAILABLE ON THE SITE, A WATERING TRUCK SHALL BE EMPLOYED TO ACCOMPLISH THE WATERING.
- 4. DO NOT DISTURB SURFACE SOIL WITHIN TREE DRIP-LINE EXCEPT AS MANDATED BY CONSTRUCTION PLANS.
- 5. DURING PERIODS OF EXTENDED DROUGHT, SPRAY WOAK TREES TO REMOVE ACCUMULATED CONSTRUCTION.
- 6. GRADE IN LINES RADIAL TO THE EXISTING TREE RATHER THAN TANGENTIAL. IF ROOTS ARE ENCOUNTERED WHILE GRADING, CUT THEM CLEANLY WITH A SAW. DO NOT RIP THEM WITH GRADING EQUIPMENT.
- 7. DO NOT ATTEMPT DEMOLITION OF TREES WITH GRADING EQUIPMENT WHEN TREES THAT ARE TO BE PRESERVED ARE IN THE VICINITY. TREE REMOVAL NOTES
- 1. THE LOCATION OF ALL SERVICE RUNS SUCH AS WATER SUPPLY, SEWER, ELECTRICITY, TELEPHONES, CABLE, GAS, STORM DRAIN LINES, ETC. SHALL BE ASCERTAINED BEFORE TREE REMOVAL WORK IS STARTED. WHERE SUCH LINES WILL BE AFFECTED BY TREE REMOVAL, OR WHERE TREE REMOVAL MACHINERY WILL BE WORKING NEARBY, LINES SHOULD BE CAREFULLY SEALED OFF, PROTECTED OR DIVERTED. IT IS THE CONTRACTOR'S RESPONSIBILITY TO TAKE NECESSARY PRECAUTIONARY ACTIONS.
- 2. REMOVE ONLY THOSE TREES INDICATED ON THIS PLAN TO BE REMOVED. TREES INDICATED TO BE REMOVED SHALL HAVE ALL ROOTS AND STUMP REMOVED TO A DEPTH OF 24" BELOW GRADE.

STANFORD UNIVERSITY

Project Name: Covered Tennis Courts Project Address: 638 Campus Drive, Stanford CA. 94305 Quad/ Bldg. Number: 08-025





ISSUES AND REVISIONS

NO. DATE DESCRIPTION 03.01.2023 ASA SET 05.31.2023 ASA RESUBMITTAL SET

PROJECT NUMBER

SHEET TITLE

CONSTRUCTION NOTES

SHEET NUMBER

SCALE



FIRE SAFETY NOTES:

PLAN SUBMITTAL REQUIREMENTS:
FIRE ALARMS AND DETECTION SYSTEMS
ATTACHMENT A
CODE, STANDARDS & GUIDES
LIST OF 2022 CALIFORNIA CODE OF REGULATIONS

APPLICABLE CODES AS OF JANUARY 1, 2023:

2022 CALIFORNIA BUILDING STANDARDS ADMINISTRATIVE CODE (PART 1, TITLE 24, CCR)

2022 CALIFORNIA BUILDING CODE, VOLUMES 1, 2 AND 3 (PART 2, TITLE 24, CCR) (BASED ON THE 2012 INTERNATIONAL BUILDING CODE)

2022 CALIFORNIA ELECTRICAL CODE (PART 3, TITLE 24, CCR) (BASED ON 2011 NATIONAL ELECTRICAL CODE)

2022 CALIFORNIA MECHANICAL CODE (PART 4, TITLE 24, CCR) (BASED ON THE 2012 UNIFORM MECHANICAL CODE)

2022 CALIFORNIA PLUMBING CODE (PART 5, TITLE 24, CCR) (BASED ON THE 2012 UNIFORM PLUMBING CODE)

2022 CALIFORNIA ENERGY CODE (PART 6, TITLE 24, CCR)

2022 CALIFORNIA ELEVATOR SAFETY CONSTRUCTION CODE (PART 7, TITLE 24, CCR)

2022 CALIFORNIA FIRE CODE (PART 9, TITLE 24, CCR) (BASED ON THE 2012 INTERNATIONAL FIRE CODE)

2022 CALIFORNIA REFERENCED STANDARDS CODE (PART 12, TITLE 24, CCR)
TITLE 19 C.C.R., PUBLIC SAFETY, STATE FIRE MARSHAL REGULATIONS

PARTIAL LIST OF APPLICABLE STANDARDS:

NFPA 13 - SPRINKLER SYSTEMS - 2022 EDITION

NFPA 14 - STANDPIPES AND HOSE SYSTEMS - 2022 EDITION

NFPA 17A - WET CHEMICAL EXTINGUISHING SYSTEMS - 2022 EDITION

NFPA 24 - PRIVATE FIRE SERVICE MAINS AND THEIR APPURTENANCES - 2022 EDITION

NFPA 72 - NATIONAL FIRE ALARM AND SIGNALING CODE - 2022 EDITION

NFPA 253 — CRITICAL RADIANT FLUX OF FLOOR COVERING SYSTEMS USING A RADIANT HEAT ENERGY SOURCE — 2022 EDITION.

UNDERGROUND FIRE SERVICE TO FIRE HYDRANTS REQUIREMENTS:

NFPA 24 CHAPTER 10.1.3: WHERE EXTERNALLY COATED AND WRAPPED AND INTERNALLY GALVANIZED, STEEL PIPE SHALL BE PERMITTED TO BE USED BETWEEN THE CHECK VALVE AND THE OUTSIDE BASE COUPLING FOR THE FIRE DEPARTMENT CONNECTION.

NFPA 24 CHAPTER 10.1.6.1: UNLESS THE REQUIREMENTS OF 10.1.6.2 ARE MET, ALL FERROUS METAL PIPE SHALL BE LINED IN ACCORDANCE WITH THE APPLICABLE STANDARDS IN TABLE 10.1.1.

NFPA 24 CHAPTER 10.1.6.2: STEEL PIPE UTILIZED IN FIRE DEPARTMENT CONNECTIONS AND PROTECTED IN ACCORDANCE WITH THE REQUIREMENTS OF 10.1.3 SHALL NOT BE ADDITIONALLY REQUIRED TO BE LINED.

NFPA 24 CHAPTER 10.3.5.2: ALL BOLTED JOINT ACCESSORIES SHALL B E CLEANED AND THOROUGHLY COATED WITH ASPHALT OR OTHER CORROSION RETARDING MATERIAL AFTER INSTALLATION.

NFPA 24 CHAPTER 10.8.3.5: AFTER INSTALLATION, RODS, NUTS, BOLTS, WASHERS, CLAMPS, AND OTHER RESTRAINING DEVICES, EXCEPT THRUST BLOCKS, SHALL BE CLEANED AND THOROUGHLY COATED WITH BITUMINOUS OR OTHER ACCEPTABLE CORROSION—RETARDING MATERIAL.

NFPA 24 CHAPTER 10.8.2.2: THRUST BLOCKS SHALL BE OF A CONCRETE MIX NOT LEANER THAN ONE PART CEMENT, TWO AND ONE HALF PARTS SAND, AND FIVE PARTS STONE.

NFPA 24 CHAPTER 10.8.2.3: THRUST BLOCKS SHALL BE PLACED BETWEEN UNDISTURBED EARTH AND THE FITTING TO BE RESTRAINED, AND SHALL BE OF SUCH BEARING AS TO ENSURE ADEQUATE RESISTANCE TO THE THRUST TO BE ENCOUNTERED.

NFPA 24 CHAPTER 10.8.2.4: IN GENERAL THRUST BLOCKS SHALL BE SO PLACED THAT THE JOINTS WILL BE ACCESSIBLE FOR INSPECTION AND REPAIR.

NFPA 24 CHAPTER 10.10.2.1.1: UNDERGROUND PIPING, FROM THE WATER SUPPLY TO THE SYSTEM RISER, AND LEAD—IN CONNECTIONS TO THE SYSTEM RISER SHALL BE COMPLETELY FLUSHED BEFORE THE CONNECTION IS MADE TO DOWNSTREAM FIRE PROTECTION SYSTEM PIPING.

NFPA 24 CHAPTER 10.10.2.1.3: THE MINIMUM RATE OF FLOW SHALL BE NO LESS THAN ONE OF THE FOLLOWING:

- (1) HYDRAULICALLY CALCULATED WATER DEMAND FLOW RATE OF THE SYSTEM, INCLUDING ANY HOSE REQUIREMENTS.
- (2) FLOW NECESSARY TO PROVIDE A VELOCITY OF 10 FT/SEC (3.1 M/SEC) IN ACCORDANCE WITH
- TABLE 10.10.2.1.3.
 (3) MAXIMUM FLOW RATE AVAILABLE TO THE SYSTEM UNDER THE CONDITIONS.

NFPA 24 CHAPTER 10.10.2.2.1*: ALL PIPING AND ATTACHED APPURTENANCES SUBJECTED TO SYSTEM WORKING PRESSURE SHALL BE HYDROSTATICALLY TESTED AT 200 PSI (13.8 BAR) OR 50 PSI (3.5 BAR) IN EXCESS OF THE SYSTEM WORKING PRESSURE, WHICHEVER IS GREATER, AND SHALL MAINTAIN THAT PRESSURE AT + 5 PSI (0.35 BAR) FOR 2 HOURS.

NFPA 24 CHAPTER 10.10.1: THE INSTALLING CONTRACTOR SHALL BE RESPONSIBLE FOR THE FOLLOWING:

- (1) NOTIFYING THE AUTHORITY HAVING JURISDICTION AND THE OWNER'S REPRESENTATIVE OF THE TIME AND DATE TESTING IS TO BE PERFORMED.
- (2) PERFORMING ALL REQUIRED ACCEPTANCE TESTS.
- (3) COMPLETING AND SIGNING THE CONTRACTOR'S MATERIAL AND TEST CERTIFICATE(S) SHOWN IN FIGURE 10.10.1.

CHAPTER 10.4.3: IN THOSE LOCATIONS WHERE FROST IS NOT A FACTOR, THE DEPTH OF COVER SHALL NOT BE LESS THAN 2 ½ FEET (0.8 M) TO PREVENT MECHANICAL DAMAGE.

NFPA 24 CHAPTER 10.4.4: PIPE UNDER DRIVEWAYS SHALL BE BURIED AT A MINIMUM DEPTH OF 3 FT (0.9M).

NFPA 24 CHAPTER 10.6.1: PIPE SHALL NOT BE RUN UNDER BUILDINGS.

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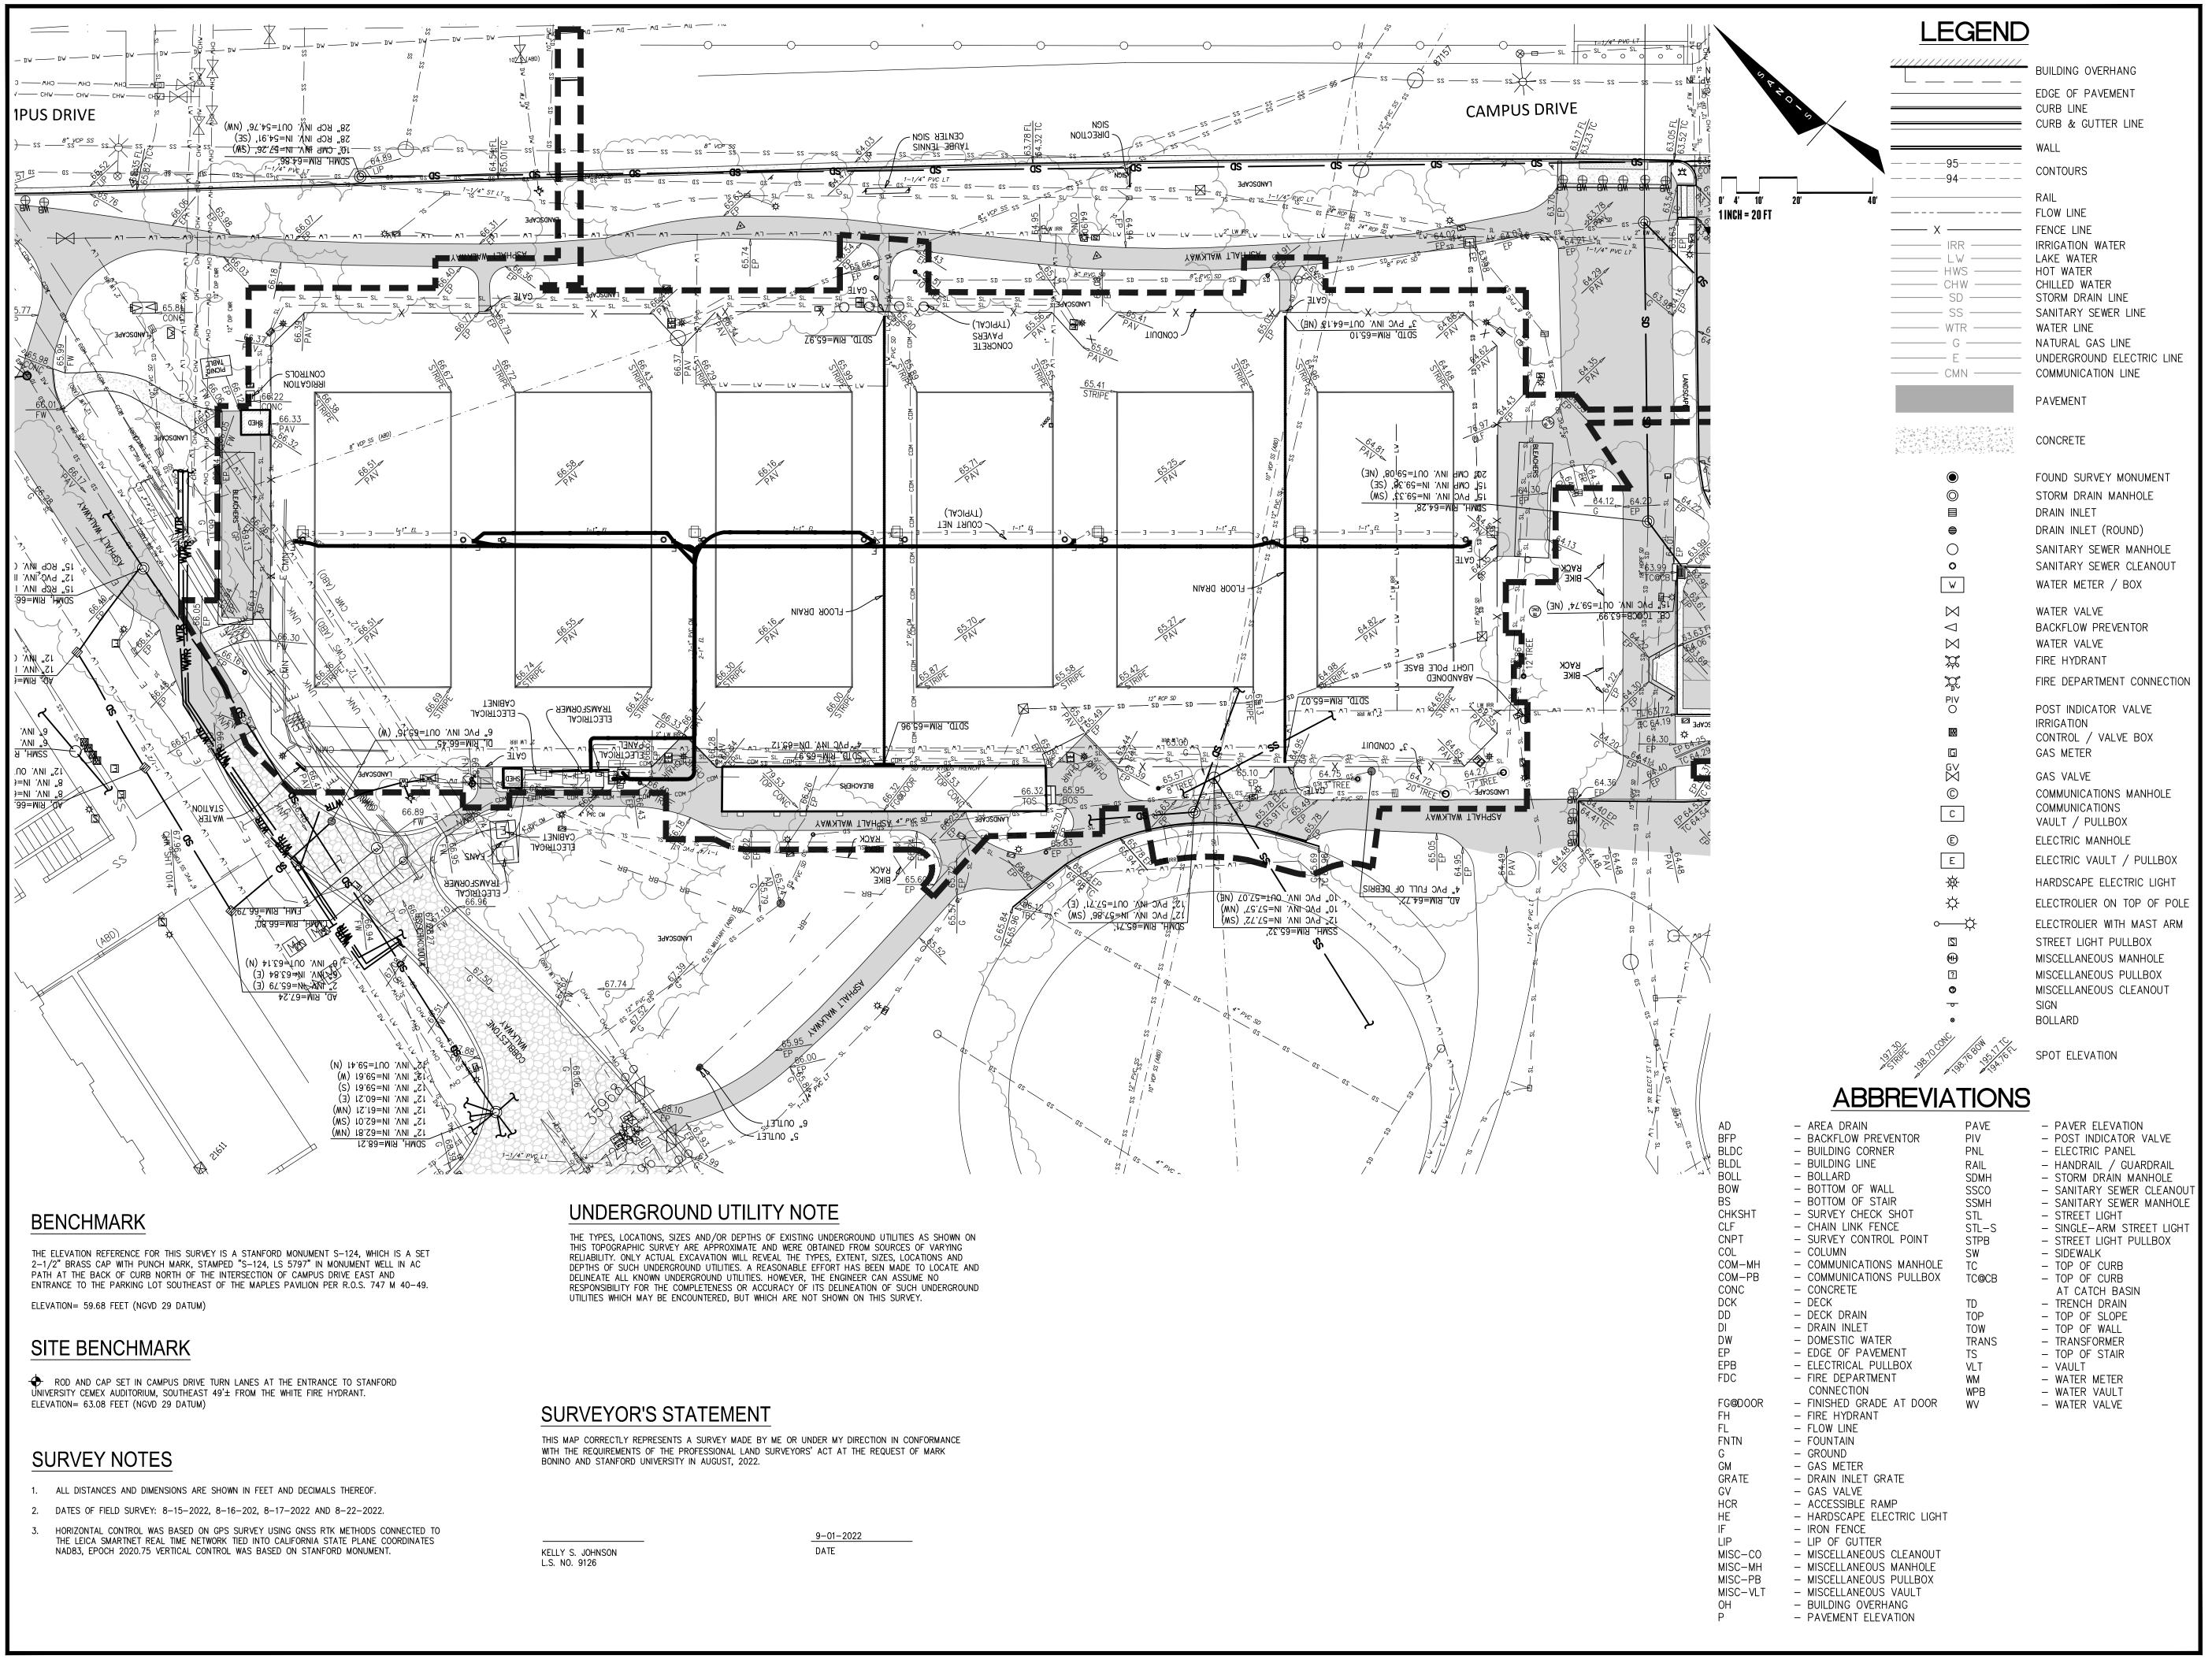
SHEET TITLE

FIRE SAFETY NOTES

SCALE

SHEET NUMBER

C-1 2



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SHEET TITLE


TOPOGRAPHIC SURVEY

SCALE

1"=30'

SHEET NUMBER

C-2.0

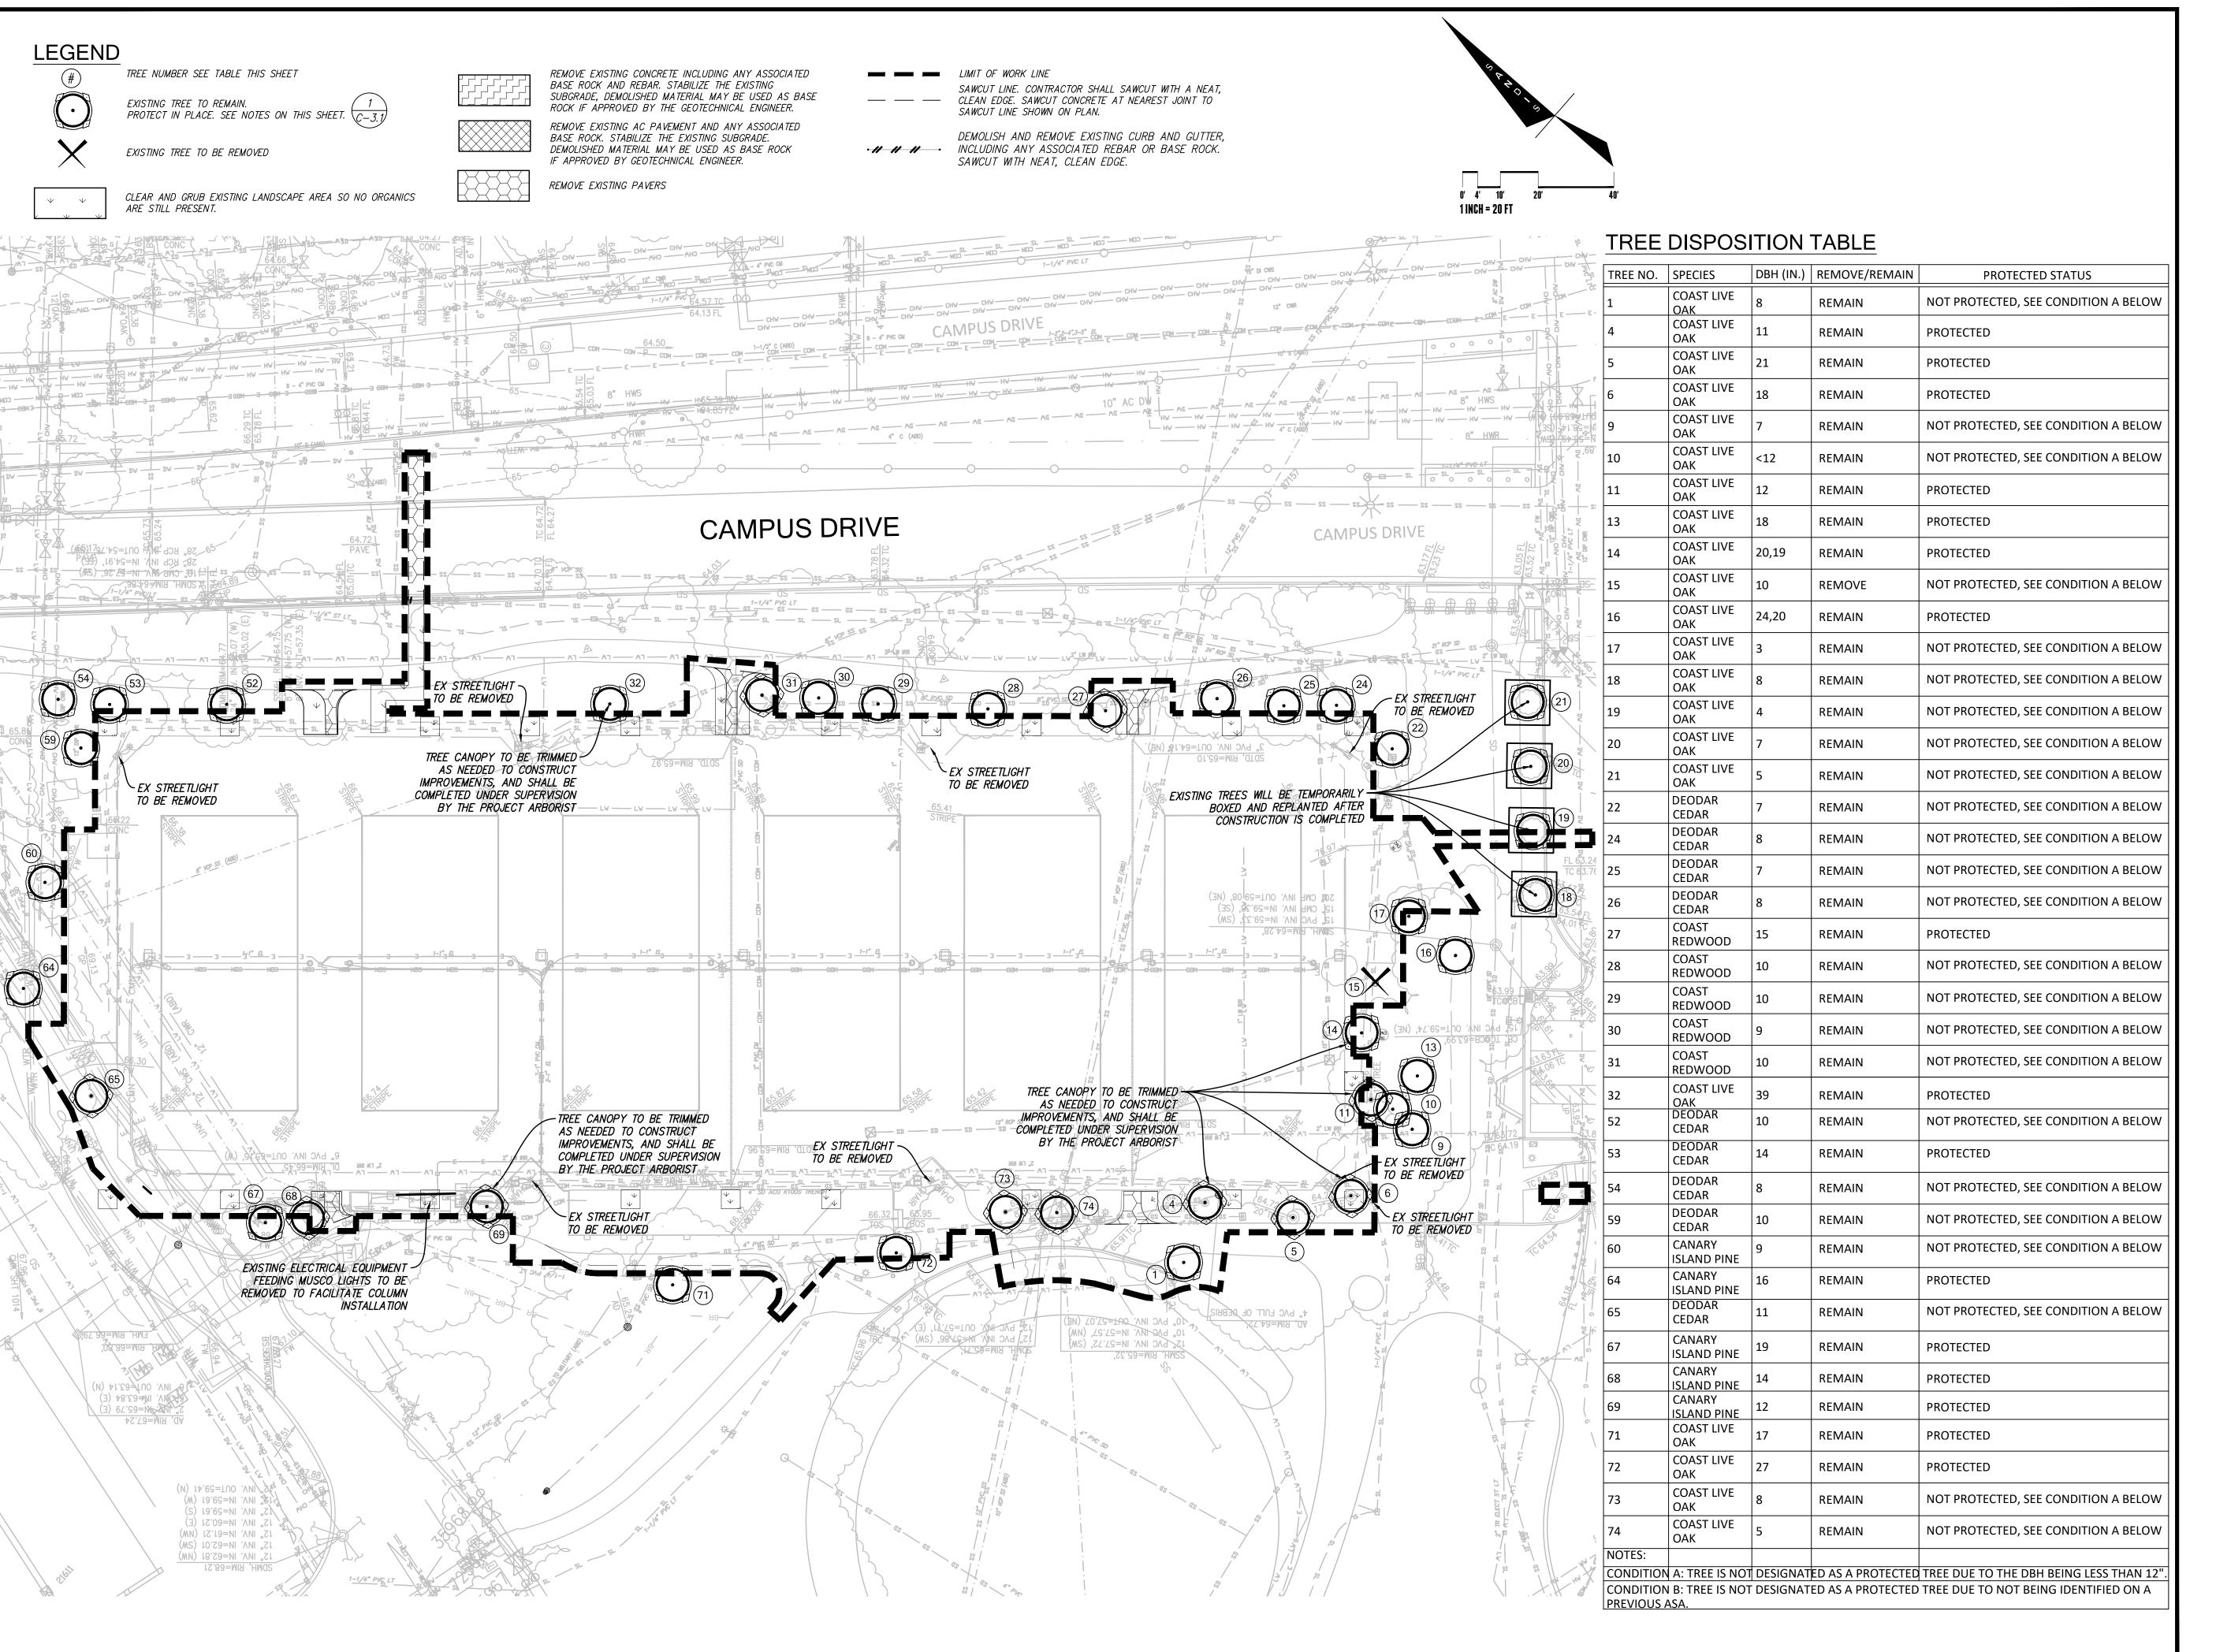

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ISSUES AND REVISIONS

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SHEET TITLE

DEMOLITION/TREE REMOVAL **PLAN**

SCALE

AS NOTED


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STANFORD UNIVERSITY TREE PROTECTION PROCEDURES SUMMARY

- 1. WE HAVE STRICT REQUIREMENTS WHICH INCLUDE THE POINTS LISTED BELOW AND ADDITIONAL PROCEDURES AS DETAILED IN THE FDG SPECIFICATIONS GUIDELINE 01 56 39 TREE AND PLANT PROTECTION.
- 2. THE ROOT ZONE OF ALL TREES MUST BE PROTECTED ON ALL CONSTRUCTION PROJECTS, AS DESCRIBED BELOW. A TREE'S ROOT ZONE IS DEFINED AS LISTED IN DEFINITIONS 1.3B.
- 3. A STANFORD GROUNDS CERTIFIED ARBORIST SHALL BE CONTACTED TO EVALUATE ALL WORK WITHIN ANY TREES ROOT ZONES.
- 4. ALL TREES TO REMAIN ON A PROJECT SHALL HAVE PROTECTIVE FENCING INSTALLED PER THE TREE PROTECTION DRAWING INCLUDED IN THE PLAN SET.
- 5. PROTECTIVE FENCING SHALL BE CHAIN LINK ON SECURE FOOTINGS, OR IMBEDDED AS REQUIRED BY THE CAMPUS PLANNING AND DESIGN OFFICE OR A STANFORD GROUNDS CERTIFIED ARBORIST, THAT WILL NOT
- PROTECTIVE FENCING SHALL BE PLACED AT THE OUTER EDGE OF THE ROOT ZONE, AS PER TREE PROTECTION PLAN 1.7.A.3, AND WHEREVER POSSIBLE AS SHOWN ON THE TREE PROTECTION DRAWING. IF PROJECT CONSTRAINTS DO NOT ALLOW FOR FENCING AT THE OUTER EDGE OF THE ROOT ZONE, FENCING MUST BE PLACED AS CLOSE TO THIS AS POSSIBLE AND APPROVED AFTER IT IS IN PLACE BY A STANFORD UNIVERSITY GROUNDS CERTIFIED ARBORIST.
- 7. LAYDOWN, STAGING AND PARKING AREAS SHALL BE APPROVED BY THE STANFORD UNIVERSITY
 ARCHITECT/CAMPUS PLANNING DEPARTMENT AND SHALL BE SHOWN ON THE PLANS IF WITHIN THE PROJECT
 LIMIT AREA, OR ON THE CONSTRUCTION LOGISTICS PLAN IF OUTSIDE THE PROJECT LIMIT AREA. ALL TREE
 PROTECTION GUIDELINES APPLY TO TREES IN LAYDOWN, STAGING AND PARKING AREAS AS WELL AS TO
 TREES WITHIN THE PROJECT LIMITS.
- 8. CONSTRUCTION MATERIALS/EQUIPMENT/PERSONAL VEHICLES SHALL NOT BE STORED, PARKED OR TEMPORARILY PLACED IN THE ROOT ZONE OF ANY TREES. NOTHING SHALL BE STORED OR PLACED TEMPORARILY WITHIN PROTECTIVE FENCING, TO AVOID SOIL COMPACTION AND SOIL CONTAMINATION UNDER TREES. ROOT ZONES OF TREES SHALL NOT BE DRIVEN OVER. PROVIDE ALTERNATIVE ROUTES FOR CONSTRUCTION TRAFFIC OF ANY KIND INCLUDING CARS, PEOPLE, TRACTORS, EQUIPMENT, CRANES, OR ANY OTHER TRAFFIC AND ALL STAGING OR STORAGE AREAS.
- 9. PROTECT OVERHANGING TREE CANOPIES FROM CONSTRUCTION DAMAGE. IF DRIVE AISLES ARE ANTICIPATED UNDER LOW CANOPIES CALL FOR AN EVALUATION BY A STANFORD GROUNDS CERTIFIED ARBORIST TO DETERMINE APPROPRIATE MEASURES.
- 10. THERE SHALL BE NO GRADE CHANGE WITHIN A MINIMUM OF TEN FEET OF THE TRUNK OF EXISTING TREES, AND PREFERABLY NONE WITHIN THE ENTIRE ROOT ZONE. NATIVE OAKS ARE PARTICULARLY SENSITIVE TO GRADE CHANGES.
- 11. NO RINSING, CLEANING EQUIPMENT OR DUMPING CONSTRUCTION LIQUID MATERIALS SHALL BE ALLOWED IN THE TREE ROOT ZONE, OR IN AN AREA THAT DRAINS INTO THE ROOT ZONE. CARE SHALL BE TAKEN IN CLEANING UP EQUIPMENT. THERE SHALL BE NO STORAGE OF DUMPSTERS OR ACCUMULATED DEBRIS FROM DEMOLITION ON OR AROUND THE ROOT ZONES OF EXISTING TREES AND SHRUBS.
- 12. EXISTING TREES SHALL BE MONITORED WEEKLY AND IRRIGATED AS NEEDED DURING THE COURSE OF CONSTRUCTION.
- 13. NO LIME OR OTHER SOIL TREATMENT SHALL BE APPLIED WITHOUT THE CONSENT OF A STANFORD GROUNDS CERTIFIED ARBORIST.
- 14. ALL TRENCHING SHALL CONFORM TO THE FOLLOWING GUIDELINES.
- A. STANFORD GROUNDS CERTIFIED ARBORIST IS REQUIRED TO BE PRESENT TO SUPERVISE ANY TRENCHING, DIGGING OR EXCAVATION OF ANY KIND WITHIN A TREES' ROOT ZONE.
- B. ROOTS LARGER THAN 2 INCHES IN DIAMETER SHALL NOT BE SEVERED WITHOUT CALLING A STANFORD GROUNDS CERTIFIED ARBORIST FOR CUTTING OR REVIEW.
- C. TUNNELING OR BORING UNDER ROOTS RATHER THAN PRUNING IS PREFERRED.
- D. DIGGING WITHIN A TREE'S ROOT ZONE SHALL BE AVOIDED. IF IT IS NECESSARY, HAND DIGGING SHALL BE USED FOR ANY TRENCHING WITHIN THE TREE'S ROOT ZONE UNLESS OTHERWISE APPROVED BY A STANFORD GROUNDS CERTIFIED ARBORIST.
 - E. ALL ROOTS THAT NEED TO BE CUT SHALL BE PERPENDICULAR PRUNED CLEANLY, NOT TORN.

THE PRECEDING GUIDELINES SHALL BE CONSIDERED MINIMUM REQUIREMENTS. THE GREATER THE DISTANCE OF TREE PROTECTION PROVIDED THE GREATER THE INSTANCE OF TREE SUCCESS IN CONSTRUCTION AREAS.



<u>NOTES:</u>

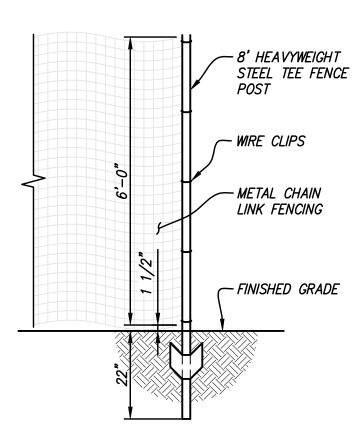- 1. THE DRIPLINE OF EACH TREE TO BE PROTECTED SHALL BE ENCLOSED WITH A 6' HIGH TEMPORARY FENCE. FENCE FABRIC SHALL BE HEAVY DUTY PERFORATATED, BRIGHT COLORED, PLASTIC MESH. FENCE STAKES SHALL BE 8' HEAVY WEIGHT STEEL TEE FENCE POSTS DRIVEN 22" INTO GRADE.
- 2. METAL CHAIN LINK FENCING ON SECURE FOOTINGS IMBEDDED WHERE REQUIRED BY CAMPUS PLANNING AND DESIGN OFFICE OR SGCA SHALL BE USED AT ALL TIMES TO PROTECT TREES EXCEPT IN AREAS WHERE IT WILL NOT PHYSICALLY FIT. ONLY IN AREAS WHERE IT CANNOT PHYSICALLY BE PLACED, WILL ORANGE PLASTIC SNOW FENCING WRAPPED 2" THICK AROUND THE TRUNK BE ALLOWED, AND ONLY AS APPROVED BY AN SGCA.

TREE PROTECTION DETAIL 1

SHEET NOTES

- 1. REMOVAL, PROTECTION, AND RELOCATION OF ELECTRICAL UTILITIES AND WATER LINES ARE SHOWN FOR REFERENCE ONLY AND ARE NOT COVERED BY THE GRADING PERMIT.
- 2. COORDINATE DEMOLITION WORK WITH STANFORD UNIVERSITY'S; ADHERE TO ALL THEIR REQUIREMENTS.
- 3. DEMOLITION AND CONSTRUCTION WORK MAY BE PERFORMED OVER THE TOP OF AND AROUND COMMUNICATION AND POWER SERVICES. CONTRACTOR SHALL WORK BY HAND IN ALL AREAS WHERE THESE SERVICES MIGHT BE HARMED BY LARGER LESS PRECISE EQUIPMENT.
- 4. THE CONTRACTOR SHALL LOCATE AND CLEARLY MARK (AND THEN PRESERVE THESE MARKERS)
 FOR THE DURATION OF CONSTRUCTION OF ALL UNDERGROUND UTILITIES, INCLUDING TELEPHONE,
 DATA, STREET LIGHT, SIGNAL LIGHT AND POWER FACILITIES, LOW TEMPERATURE HOT WATER AND
- 5. CONTRACTOR'S BID IS TO INCLUDE ALL VISIBLE SURFACE AND ALL SUBSURFACE FEATURES IDENTIFIED TO BE REMOVED OR ABANDONED IN THESE DOCUMENTS.

CHILLED HOT WATER LINES THAT ARE IN OR NEAR THE AREA OF DEMOLITION.

- 6. THE CONTRACTOR SHALL BE RESPONSIBLE FOR A SITE INSPECTION TO FULLY ACKNOWLEDGE THE EXTENT OF THE DEMOLITION WORK.
- 7. THE CONTRACTOR SHALL BE RESPONSIBLE FOR OBTAINING ANY AND ALL PERMITS NECESSARY FOR ENCROACHMENT, GRADING, DEMOLITION, AND DISPOSAL OF SAID MATERIALS AS REQUIRED BY PRIVATE, LOCAL AND STATE JURISDICTIONS. THE CONTRACTOR SHALL PAY ALL FEES ASSOCIATED WITH THE DEMOLITION WORK.
- 8. CONTRACTOR SHALL PAY DISPOSAL FEES.
- 9. BACKFILL ALL DEPRESSIONS AND TRENCHES FROM DEMOLITION OF FOUNDATIONS & UTILITIES TO EXISTING GRADE AND TO THE SATISFACTION OF THE GEOTECHNICAL ENGINEER, AND/OR UNIVERSITY FIELD CONSTRUCTION MANAGER (FCM).
- 10. WITHIN LIMITS OF WORK, REMOVE CURBS, GUTTERS, LANDSCAPING, SIGNAGE, TREES, SHRUBS, ASPHALT, UNDERGROUND PIPES, ETC. AS INDICATED ON THE DRAWINGS.
- 11. CONTRACTOR SHALL BE RESPONSIBLE FOR DISPOSING ALL DEMOLITION MATERIALS, OR STORING SELECTED ITEMS BY UNIVERSITY'S REPRESENTATIVE AT DESIGNATED LOCATIONS.
- 12. PRIOR TO BEGINNING DEMOLITION WORK, CONTRACTOR TO NOTIFY AND COORDINATE THE REMOVAL AND/OR ABANDONMENT OF ALL AFFECTED UTILITIES WITH THE FCM.
- 13. CONTRACTOR RESPONSIBLE FOR PREPARING WASTE MANAGEMENT PLAN, TRAINING OF EMPLOYEES & SUBCONTRACTORS, AND ENSURING PROPER REMOVAL AND DISPOSAL OF ALL HAZARDOUS
- 14. THESE DRAWINGS DO NOT ADDRESS CONTRACTOR MEANS, METHODS OR PROCESSES THAT MAY BE ASSOCIATED WITH ANY TOXIC SOILS IF FOUND ON SITE. THE CONTRACTOR IS RESPONSIBLE FOR COMPLYING WITH ALL UNIVERSITY AND COUNTY STANDARDS AND APPROPRIATE REGULATIONS IF TOXIC SOILS ARE ENCOUNTERED. CONTRACTOR MUST NOTIFY THE FCM IMMEDIATELY IF ANY SOILS ARE EVEN SUSPECTED OF BEING CONTAMINATED.
- 15. CONTRACTOR SHALL CONTACT UNDERGROUND SERVICE ALERT, USA, FOR LOCATION AND MARKING OF UNDERGROUND UTILITIES AT LEAST 48 HOURS PRIOR TO COMMENCEMENT OF CONSTRUCTION
- 16. CONTRACTOR SHALL MAINTAIN THE EXISTING SITE AND STREETS IN A SAFE AND USABLE MANNER SUCH THAT EMERGENCY VEHICLE ACCESS IS AVAILABLE AT ALL TIMES. CONTRACTOR TO SUPPLY, INSTALL AND MAINTAIN ALL NECESSARY FENCING, GATES, BARRICADES, SIGNAGE, AND PROVISIONS FOR ENSURING THE PROJECT'S SECURITY AND SAFE PASSAGEWAY AROUND IT.
- 17. CONTRACTOR SHALL GATHER ALL CONSTRUCTION DEBRIS ON A REGULAR BASIS AND PLACE IT IN A DUMPSTER OR OTHER CONTAINER WHICH IS EMPTIED OR REMOVED ON A REGULAR BASIS. WHEN APPROPRIATE, USE TARPS ON THE GROUND TO COLLECT FALLEN DEBRIS OR SPLATTERS THAT COULD CONTRIBUTE TO STORM WATER RUNOFF POLLUTION.
- 18. CONTRACTOR SHALL CLEAR AND GRUB WITHIN LIMIT OF WORK AS NEEDED TO PERFORM DEMOLITION ACTIVITIES.
- 19. SAWCUT & REMOVE HARDSCAPE SUCH AS, BUT NOT LIMITED TO, AC PAVEMENT, CURB, SIDEWALK,
- 20. TAKE ALL NECESSARY PRECAUTIONS NOT TO DAMAGE EXISTING UNDERGROUND UTILITY LINES TO REMAIN DURING DEMOLITION. CONTRACTOR TO HIRE AN INDEPENDENT UNDERGROUND UTILITY LOCATOR SERVICE TO LOCATE & PAINT UTILITIES IN THE FIELD PRIOR TO CONSTRUCTION. ANY DAMAGE TO EXISTING UTILITIES TO REMAIN SHALL BE REPAIRED AT THE CONTRACTOR'S EXPENSE.
- 21. CONTRACTOR TO GRIND/ROUND CONCRETE EDGE AFTER SAWCUTTING TO MAINTAIN APPEARANCE AND SAFETY.
- 22. CONTRACTOR SHALL SCHEDULE MEETING WITH STANFORD ARBORIST AND UA/CPD FOR REVIEW OF THE TREE PROTECTION PRIOR TO START OF CONSTRUCTION.
- 23. CONTRACTOR TO SCHEDULE MEETING WITH HIGH VOLTAGE SHOP PRIOR TO REMOVING ANY EXISTING PULLBOXES.

NOTES

ETC.

- 1. ALL UNDERGROUND UTILITIES, LANDSCAPE FEATURES, AND HARDSCAPE FEATURES IMPACTED OR DAMAGED BY THE CONTRACTOR OR THEIR SUB—CONTRACTORS SHALL BE REMOVED AND REPLACED IN KIND. ITEMS MAY INCLUDE, BUT NOT LIMITED TO, UNDERGROUND UTILITY AND IRRIGATION LINES, CURB, GUTTER, SIDEWALK, PAVEMENT, FENCING, STRIPING AND OTHER PAVEMENT MARKINGS, PLANTING, LANDSCAPING, AND BOLLARDS.
- 2. PROTECT ALL EXISTING UTILITIES IN PLACE UNLESS OTHERWISE NOTED. REPLACE ANY DAMAGED UTILITY TO REMAIN TO KEEP OPERABLE DURING CONSTRUCTION.
- 3. TREES ADJACENT TO THE PROPOSED COVERING SHALL BE TRIMMED AS NEEDED TO CONSTRUCT IMPROVEMENTS. ALL TREE TRIMMING SHALL BE COMPLETED UNDER THE SUPERVISION OF THE PROJECT ARBORIST.

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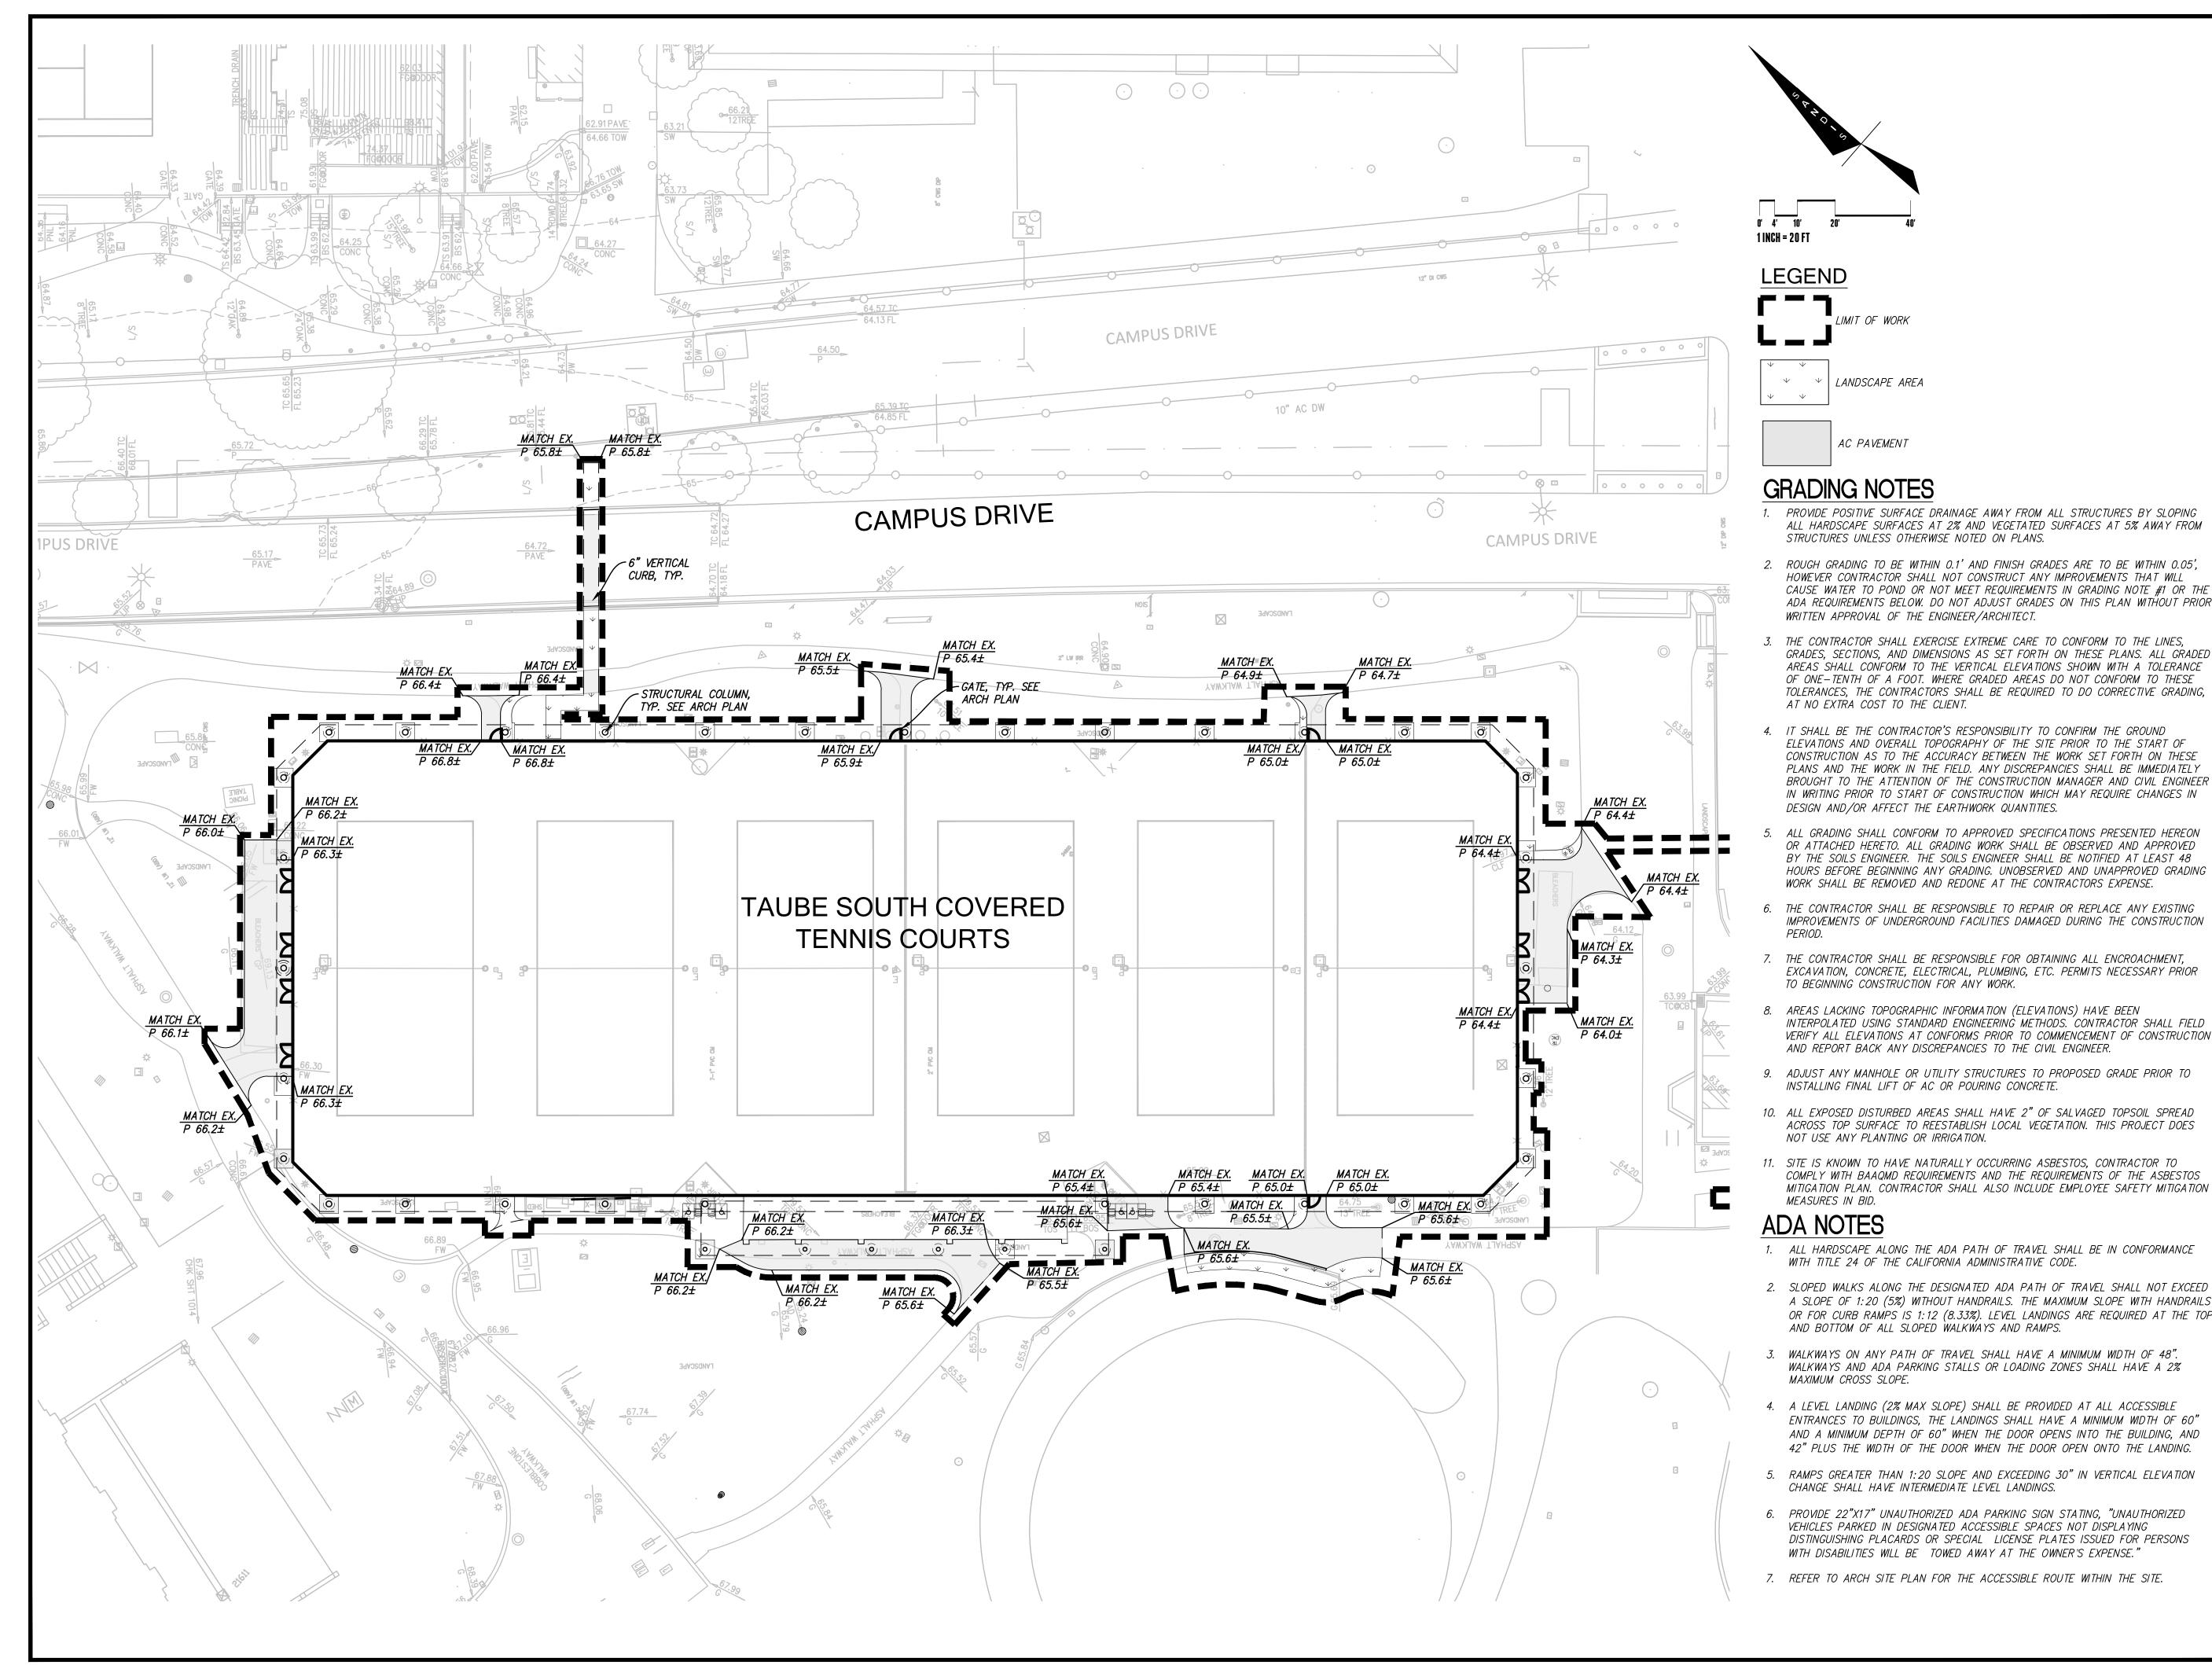
SHEET TITLE

DEMOLITION/TREE REMOVAL NOTES

AS NOTED

SHEET NUMBER

C-3 1



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GRADING AND DRAINAGE

SCALE


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LANDSCAPE AREA

AC PAVEMENT



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UTILITY PLAN


SCALE
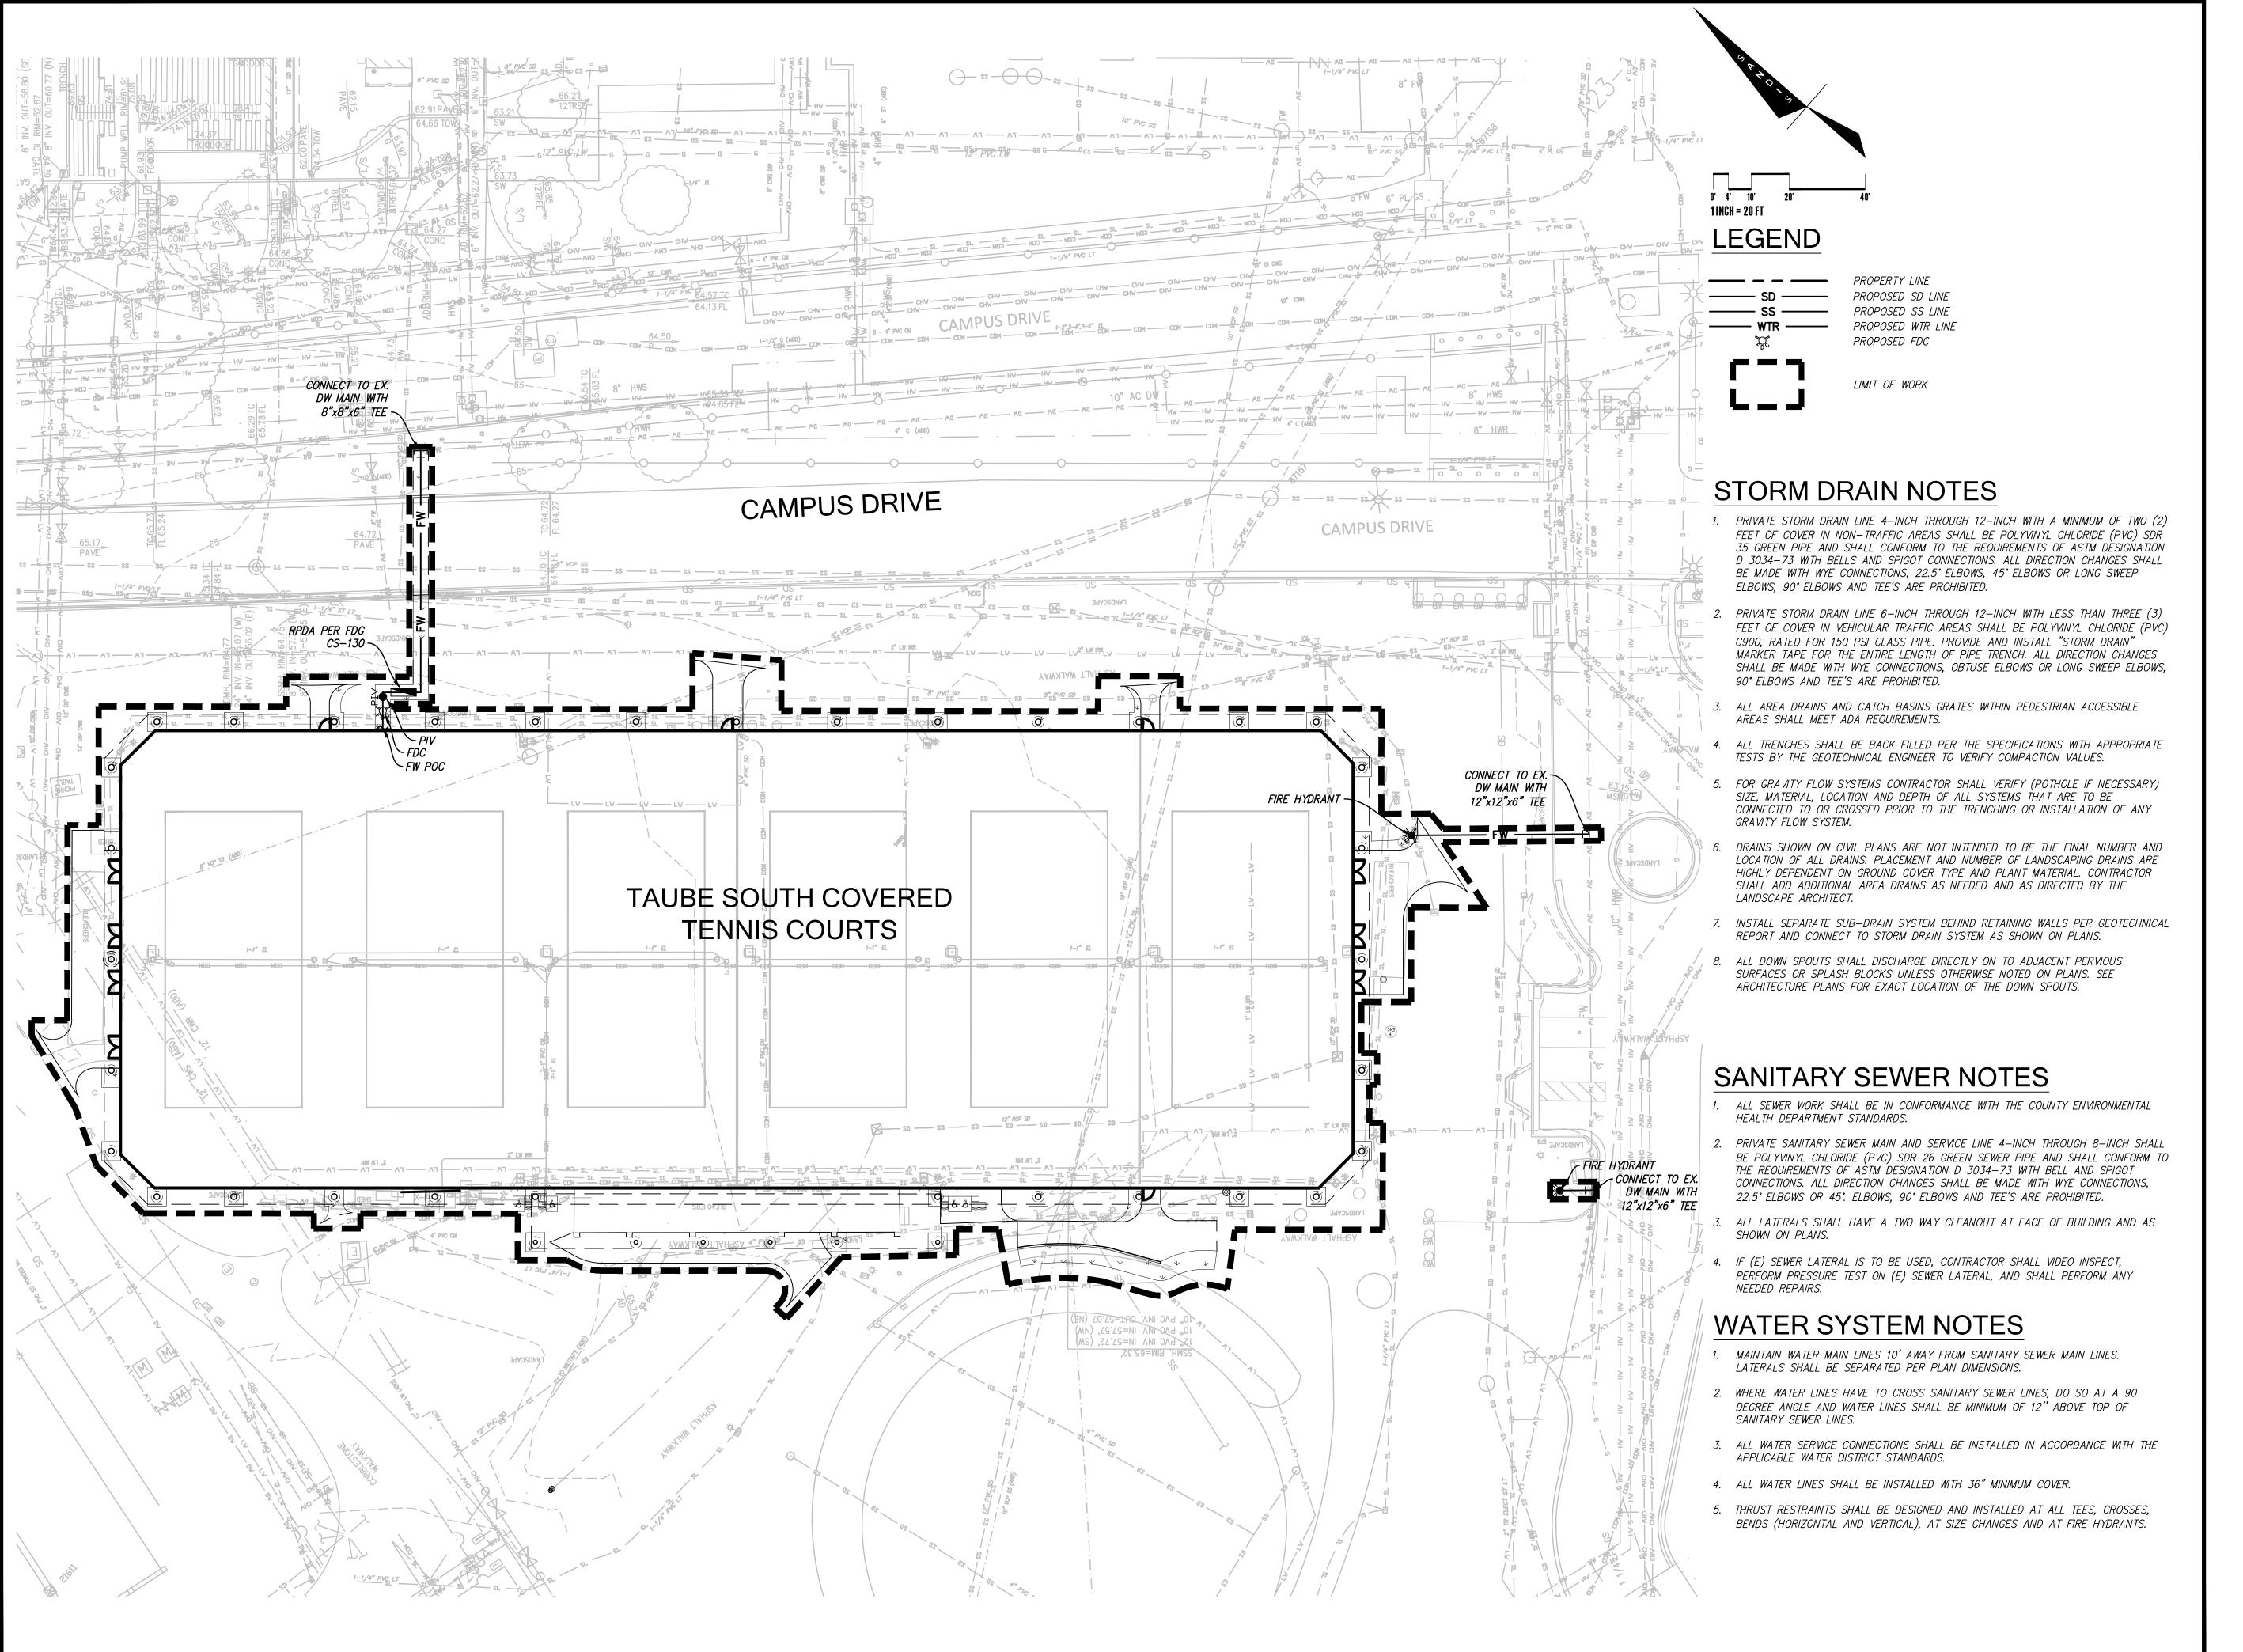
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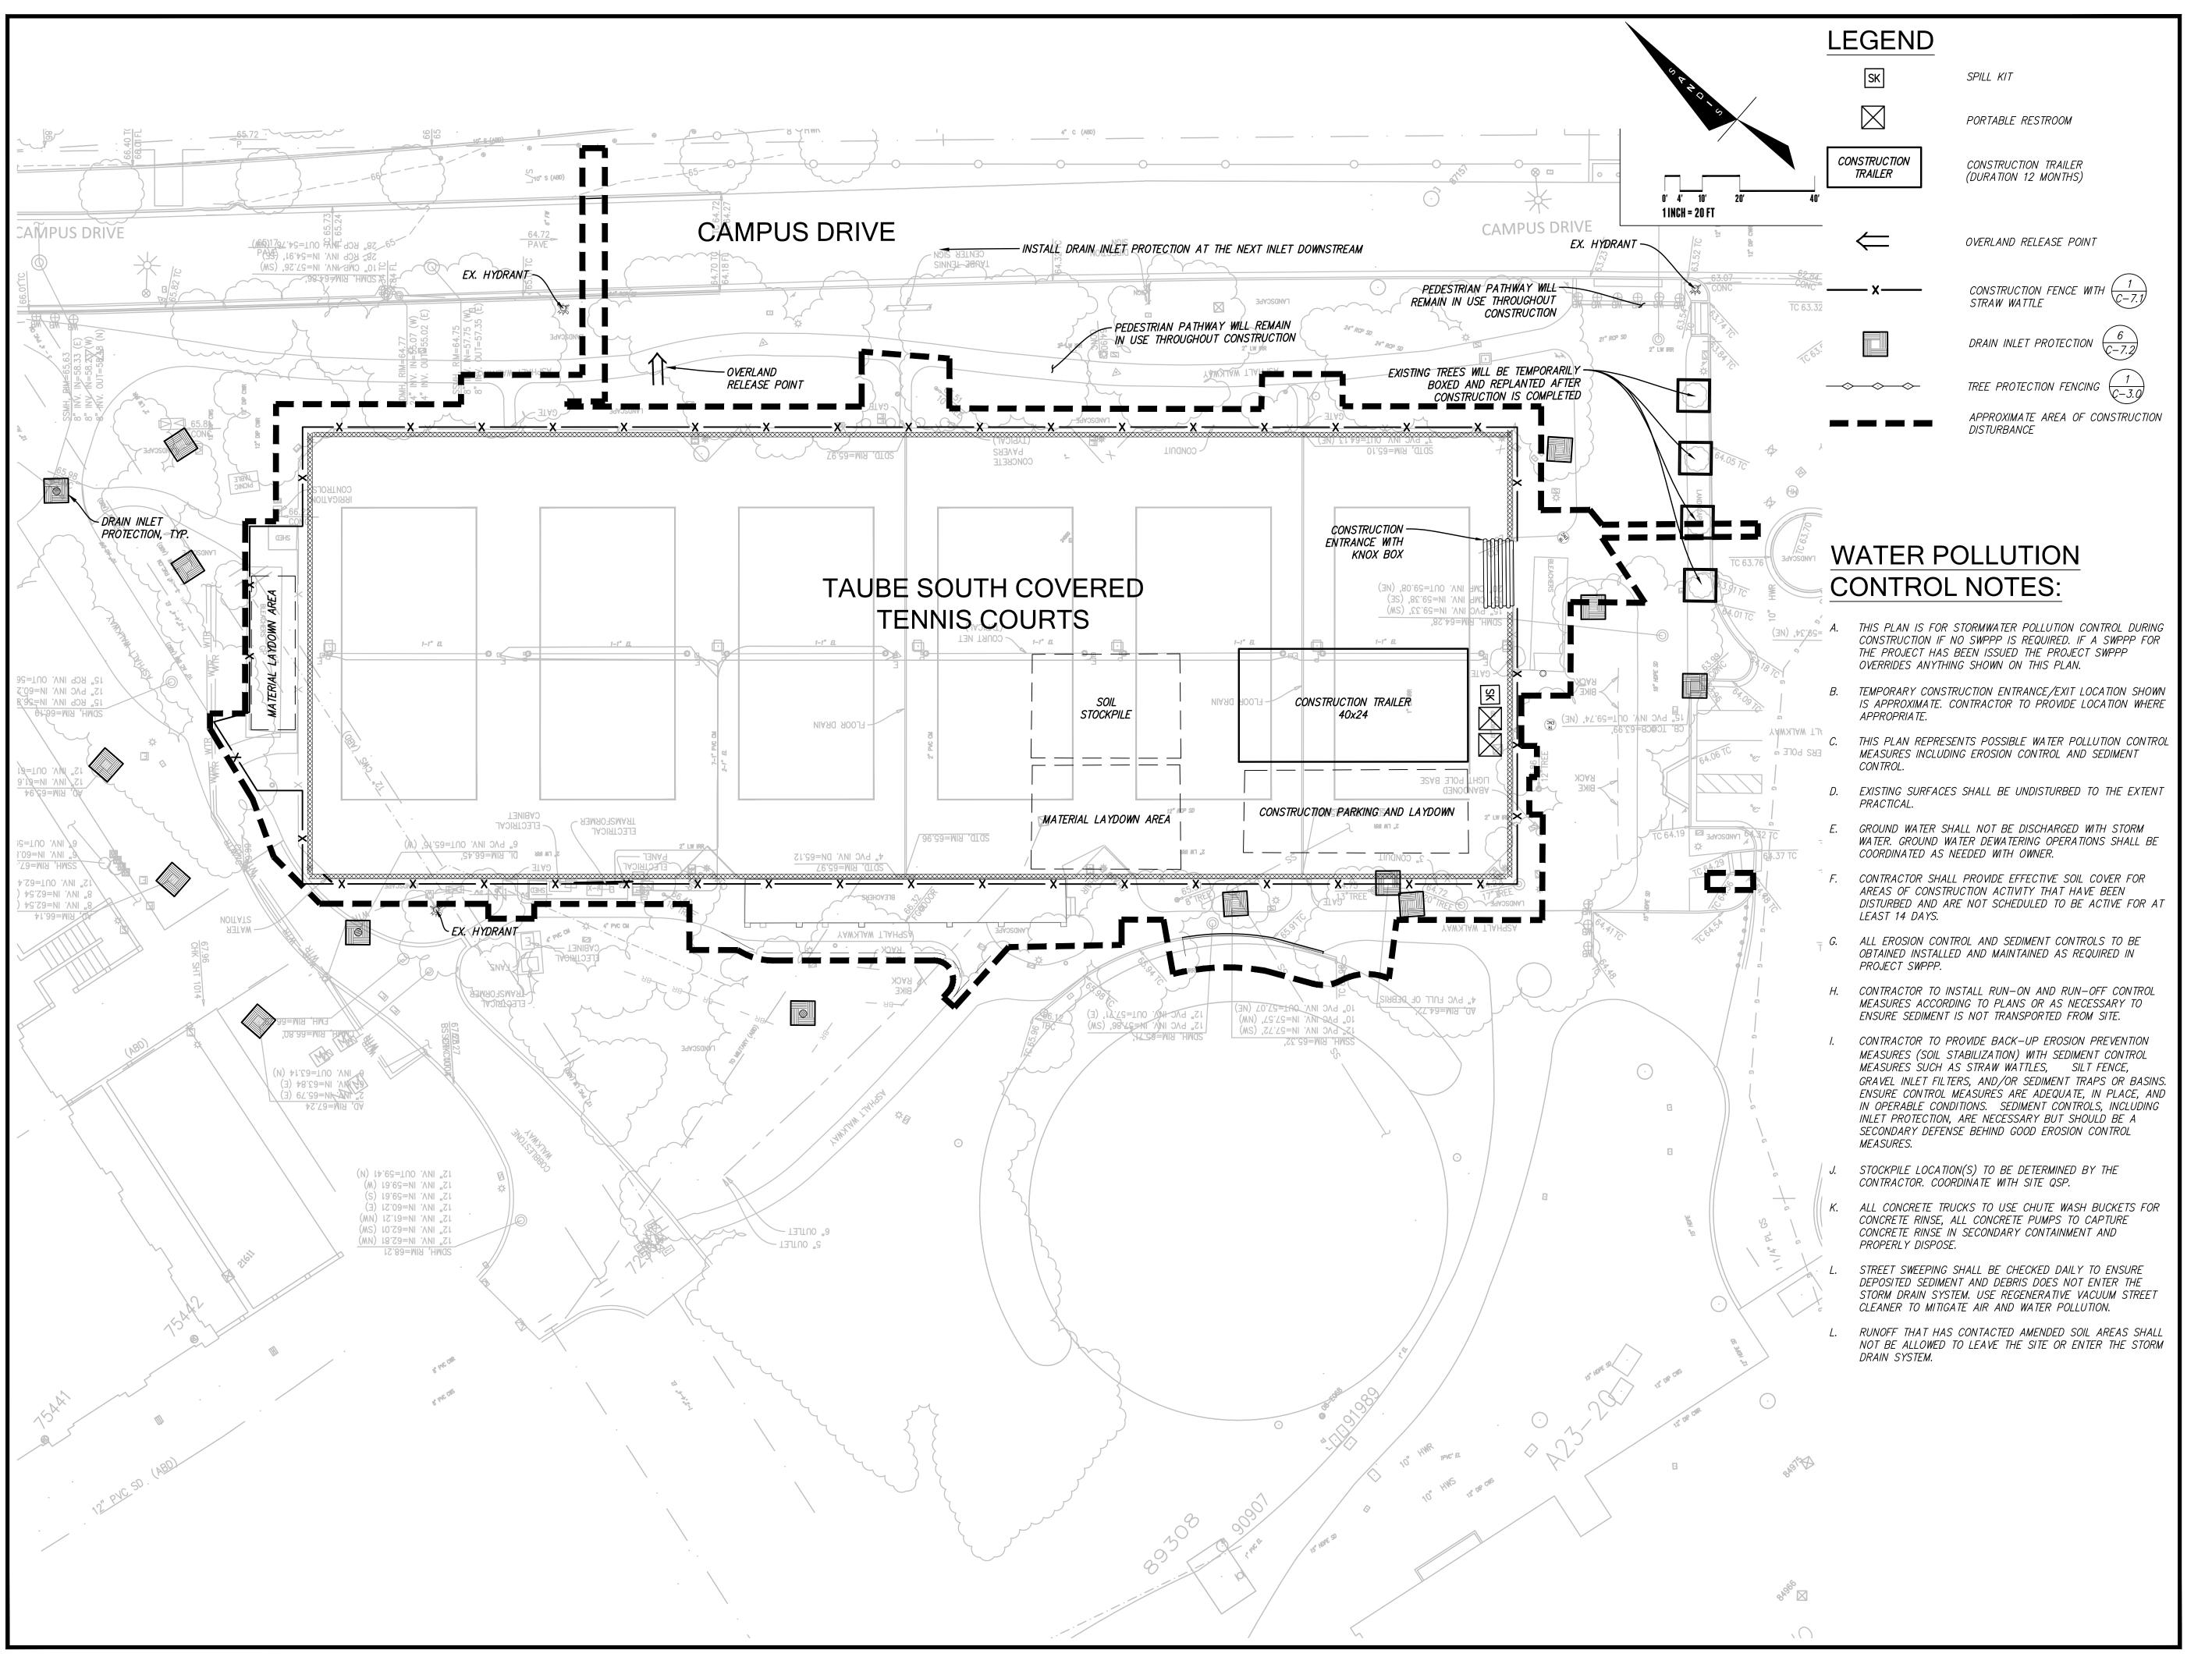
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STORMWATER MANAGEMENT PLAN

AS NOTED

SHEET NUMBER

C - 6.0

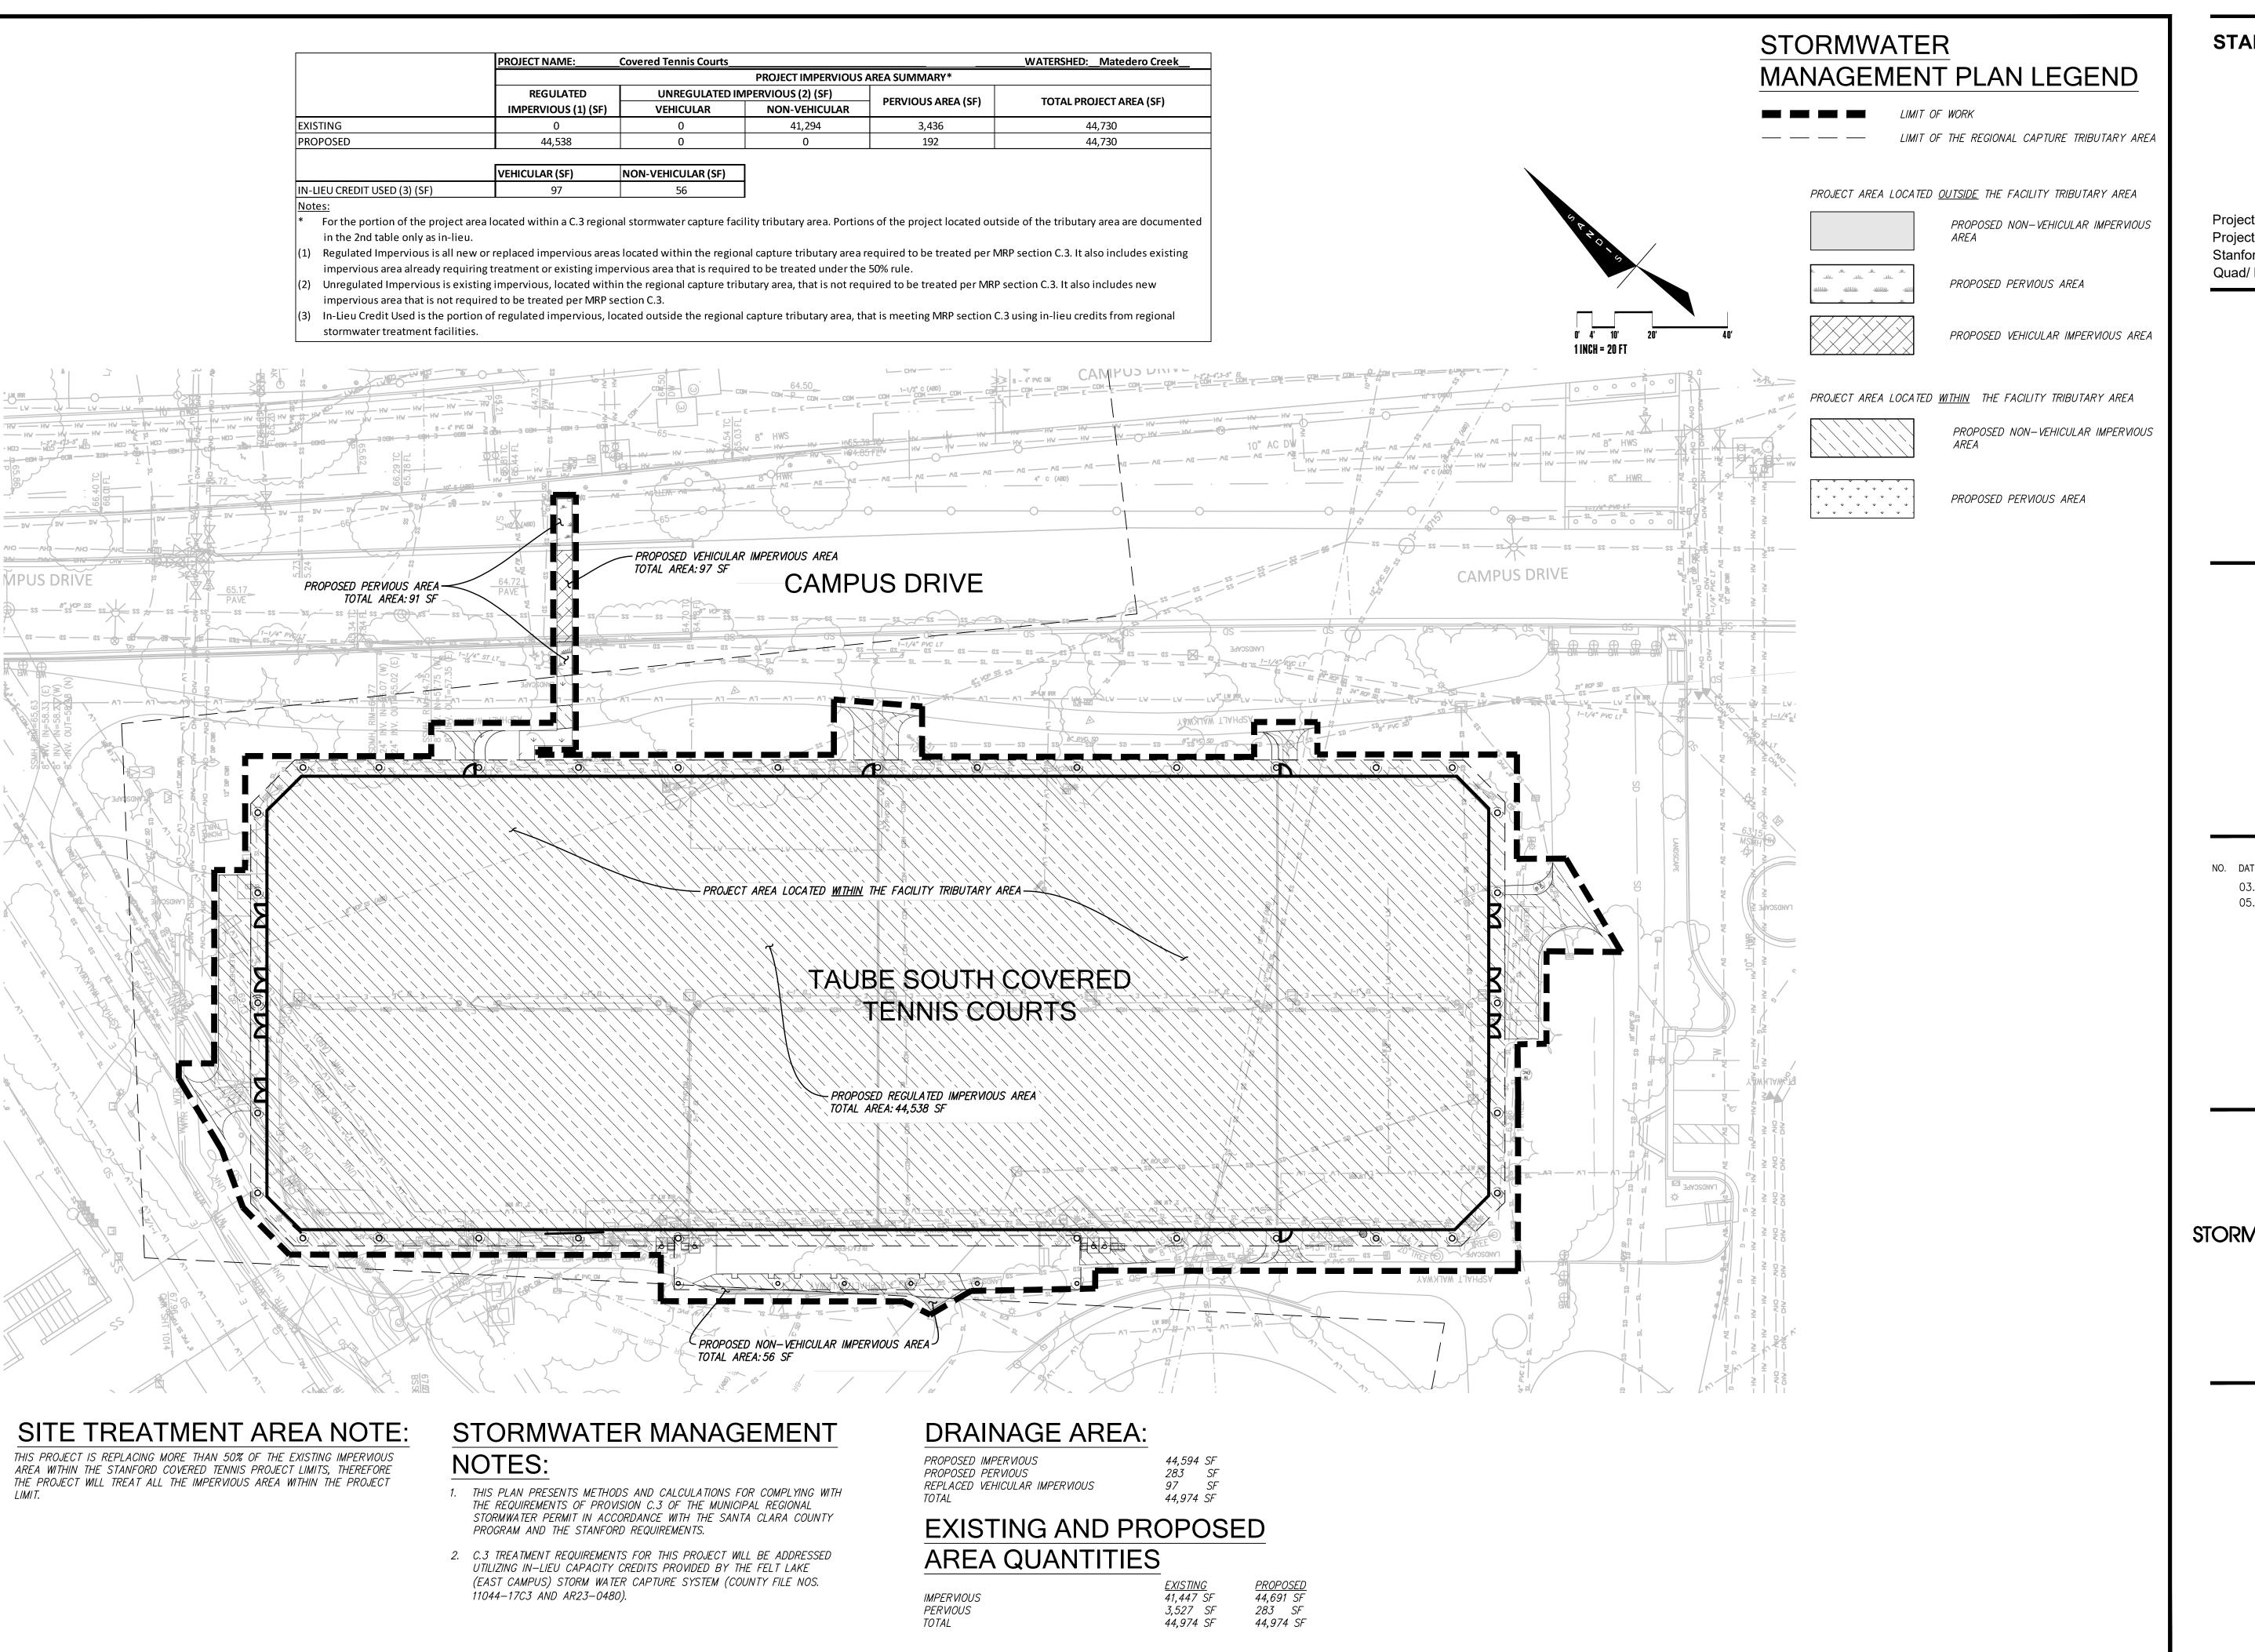

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SHEET TITLE EROSION CONTROL PLAN

SCALE

AS NOTED

SHEET NUMBER

Source for Graphics: California Stormwater BMP Handbook, California

Stormwater Quality Association, January 2003. Available from www.cabmphandbooks.com.

STANDARD BEST MANAGEMENT PRACTICE NOTES

- 1. Solid and Demolition Waste Management: Provide designated waste collection areas and containers on site away from streets, gutters, storm drains, and waterways, and arrange for regular disposal. Waste containers must be watertight and covered at all times except when waste is deposited. Refer to Erosion & Sediment Control Field Manual, 4th Edition (page C3) or
- 2. Hazardona Waste Management: Provide proper handling and disposal of hazardous wastes by a licensed hazardous waste material hauler. Hazardous wastes shall be stored and properly labeled in scaled containers constructed of suitable materials. Refer to Essaion & Sediment Control Field Manual, 4th Edition (pages C-5 to C-6) or latest.
- 3. Spill Presention and Control: Provide proper storage areas for liquid and solid materials, including chemicals and hazardous substances, away from streets, gutters, storm drains, and waterways. Spill control materials must be kept on site where readily accessible. Spills must be cleaned up immediately and contaminated soil disposed properly. Refer to Erosion & Sediment Control Field Manual, 4th Edition (pages C-7 to C-8, C-13 to C-14) or latest.
- 4. Vehicle and Construction Equipment Service and Storage: An area shall be designated for the maintenance, where onsite maintenance is required, and storage of equipment that is protected from stormwater run-on and runoff. Measures shall be provided to capture any waste oils, lubricants, or other potential pollutarits and these wastes shall be properly disposed of off site. Fueling and major maintenance/repair, and washing shall be conducted off-site whenever feasible. Refer to Erosion & Sediment Control Field Manual, 4th Edition (page C9) or
- 5. Material Delivery, Handling and Storage: In general, materials should not be stockpiled on site. Where temporary stockpiles are necessary and approved by the County, they shall be covered with secured plastic sheeting or tarp and located in designated areas near construction entrances and away from drainage paths and waterways. Barriers shall be provided around storage areas where materials are potentially in contact with runoff. Refer to Erosion & Sediment Control Field Manual, 4th Edition (pages C-11 to C-12) or latest.
- 5. Handline and Disposal of Concrete and Cement: When concrete tracks and equipment are washed on-site, concrete wastewater shall be contained in designated containers or in a temporary fined and watertight pit where wasted concrete can harden for later semoval. If possible have concrete contractor remove concrete wash water from site. In no case shall fresh concrete be washed into the road right-of-way. Refer to Erosion & Sediment Control Field Manual, 4th Edition (pages C-15 to C-16) or latest.
- . Payement Construction Management: Prevent or reduce the discharge of pollutants from paying operations, using measures to prevent run-on and runoff pollution and properly disposing of wastes. Avoid paving in the wet season and reschedule paying when rain is in the forecast. Residue from saw-cutting shall be vacuumed for proper disposal. Refer to Erosion & Sediment Control Field Manual, 4th Edition (pages C-17 to C-18) or latest.
- 8. Contaminated Soil and Water Management: Impections to identify contaminated soils should occur prior to construction and at regular intervals during construction. Remediating contaminated soil should occur promptly after identification and be specific to the contaminant identified, which may include hazardous waste removal. Refer to Erosion & Sediment Control Field Manual, 4th Edition (pages C-19 to C-20) or
- Smitary/Septic Water Management: Temporary sanitary facilities should be located away from drainage paths, waterways, and traffic areas. Only licensed sanitary and septic waste haulers should be used. Secondary containment should be provided for all sanitary facilities. Refer to Erosson & Sediment Control Field Manual, 4th Edition (page C-21) or
- 10. Inspection & Maintenance: Areas of material and equipment storage sites and temporary sanitary facilities must be inspected weekly. Problem areas shall be identified and appropriate additional and/or alternative control measures implemented immediately, within 24 hours of the problem being identified.

. Sediment Control Management:

Tracking Prevention & Clean Up Activities shall be organized and measures taken as needed to prevent or minimize tracking of soil onto the public street system. A gravel or proprietary device construction entrance/exit is required for all sites. Clean up of tracked material shall be provided by means of a street sweeper prior to an approaching rain event, or at least once at the end of each workday that material is tracked, or, more frequently as determined by the County Inspector. Refer to Erosion & Sediment Control Field Manual, 4th Edition (pages B-31 to B-33) or latest.

Storm Drain Inlet and Catch Basin Inlet Protection: All inlets within the vicinity of the project and within the project limits shall be protected with gravel bags placed around inlets or other inlet protection. At locations where exposed soils are present, staked fiber roles or staked silt fences can be used. Inlet filters are not allowed due to clogging and subsequent flooding. Refer to Erosion & Sediment Control Field Manual, 4th Edition (pages B-49 to B-51) or latest.

Storm Water Runoff: No storm water runoff shall be allowed to drain in to the existing and/or proposed underground storm drain system or other above ground watercourses until appropriate crosson control measures are fully installed.

control in graded areas as required by providing wet suppression or chemical stabilization of exposed soils, providing for rapid clean up of sediments deposited on passed roads, furnishing construction road entrances and vehicle wash down areas, and limiting the amount of areas disturbed by clearing and earth moving operations by scheduling these activities in phases.

- Erosion Control: During the rainy season, all disturbed areas must include an effective combination of crosion and sediment control. It is required that temporary crossion control measures. are applied to all disturbed soil areas prior to a rain event. During the non-rainy season, crosson control measures must be applied sufficient to control wind crossion at the site.
- Inspection & Maintenance: Disturbed areas of the Project's site, locations where vehicles enter or exit the site, and all crosson and sediment controls that are identified as part of the Erosion Control Plans must be inspected by the Contractor before, during, and after storm events, and at least weekly during seasonal wet periods. Problem areas shall be identified and appropriate additional and/ or alternative control measures implemented immediately, within 24 hours of the problem being
- 4. Project Completion: Prior to project completion and signoff by the County Inspector, all disturbed areas shall be reseeded, planted, or landscaped to minimize the potential for erosion on the subject site.
- 5. It shall be the Owner's/Contractor's responsibility to maintain control of the entire construction operation and to keep the entire site in compliance with the
- Erosion and sediment control best management. practices shall be operable year round or until vegetation is fully established on landscaped

STANDARD EROSION CONTROL NOTES

Quad/ Bldg. Number: 08-025

Dust Control: The contractor shall provide dust

Stockpiling: Excavated soils shall not be placed in streets or on paved areas. Borrow and temporary stockpiles shall be protected with appropriate erosion control measures(tarps, straw bales, silt fences, ect.) to ensure silt does not leave the site or enter the storm drain system or neighboring watercourse.

crossion control plan.

ARCHITECTS

STANFORD UNIVERSITY

Project Name: Covered Tennis Courts

Project Address: 638 Campus Drive,

Stanford CA. 94305

ISSUES AND REVISIONS

DESCRIPTION

03.01.2023 ASA SET

05.31.2023 ASA RESUBMITTAL SET

SANDIS

PROJECT NUMBER

COUNTY BMP NOTES

N.T.S

SHEET NUMBER

Best Management Practices and Erosion Control Details Sheet 1 County of Santa Clara



BMP-1

Ξ.



Project Name: Covered Tennis Courts Project Address: 638 Campus Drive, Stanford CA. 94305 Quad/ Bldg. Number: 08-025





ISSUES AND REVISIONS

DESCRIPTION

03.01.2023 ASA SET

05.31.2023 ASA RESUBMITTAL SET

PROJECT NUMBER 22020


COUNTY BMP NOTES

SCALE


SHEET NUMBER

N.T.S

C-7.2

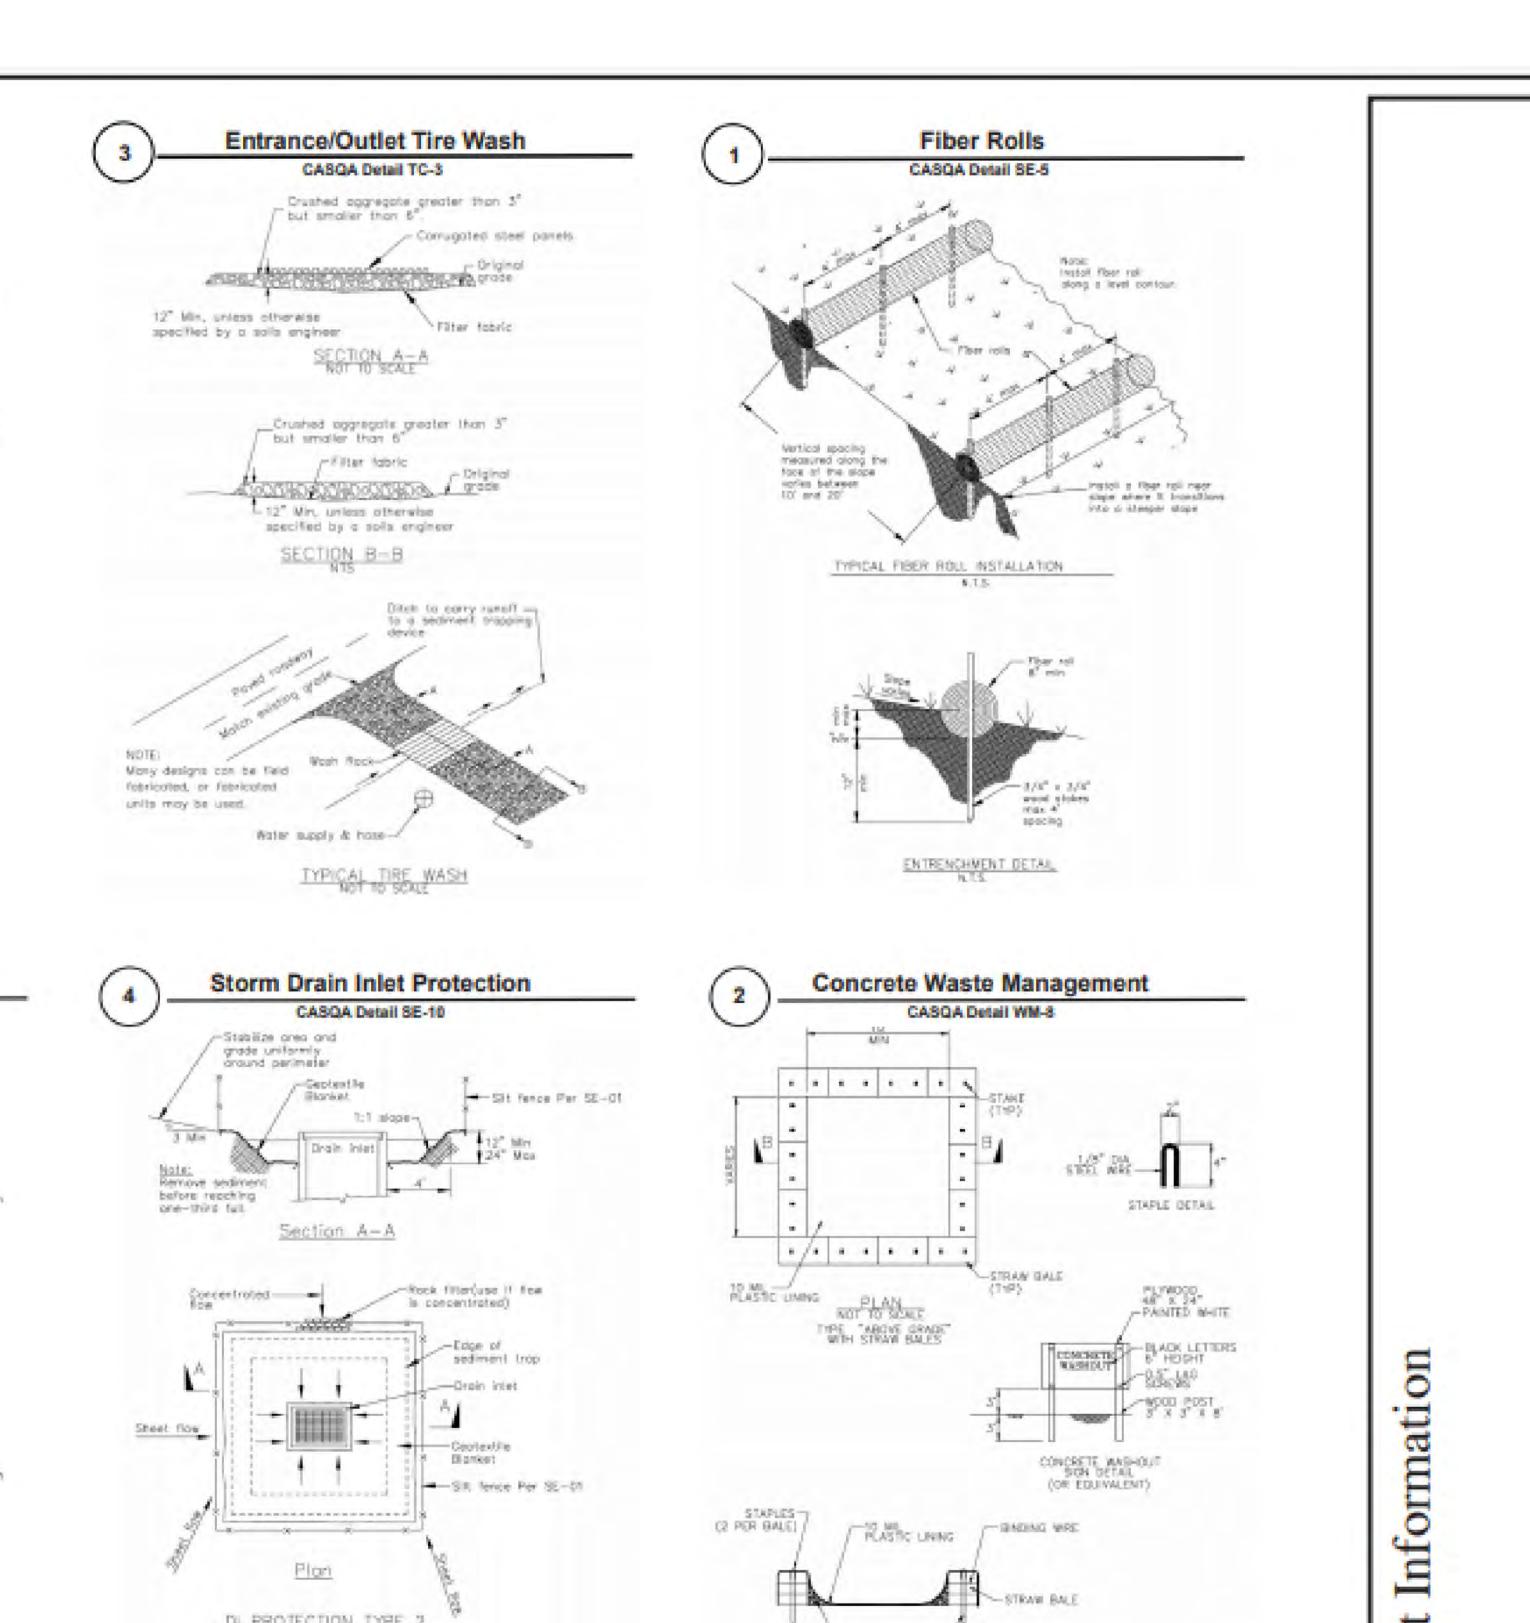

Best Management Practices and Erosion Control Details Sheet 2

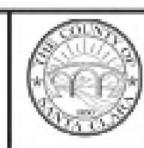

BMP-2

ALL DRAWINGS AND WRITTEN MATERIAL APPEARING HEREIN CONSTITUTE ORIGINAL AND UNPUBLISHED WORK OF THE ARCHITECT AND MAY NOT BE DUPLICATED, USED OR DISCLOSED WITHOUT WRITTEN CONSENT OF THE ARCHITECT

1. ACTUAL LAYOUT DETERMINED IN FIGURE

Available from www.cabmphandbooks.com.

Source for Graphics: California Stormwater BMP Handbook, California

Stormwater Quality Association, January 2003.

Hondware cloth wire mean

DI PROTECTION - TYPE 4

Geotextiles and Mats

CASQA Detail EC-7

TERMINAL SLOPE AND CHANNEL

ISOMETRIC VEW

LONGITUDINAL ANCHOR THENCH NTS

-Fittered actor

ANDHOR TRENOW NTS

INTIAL CHANNEL MYCHOR TRENCH

INTERMITIENT CHECK SLOT

Concrete block lold— Isngthwise on sides © perimeter of opening

-- Runett with sedment

5. Install per monutacturer's recommendations

1. Check sists to be constructed per monutacturers specifications. Stoking or stapling layout per monufacturers specifications.

TYPICAL INSTALLATION DETAIL

Storm Drain Inlet Protection

CASQA Detail SE-10

Geotextiles and Mats

CASQA Detail EC-7

ISOMETRIC VIEW

Slape surface shall be free of rocks, clode, sticks and grass. Vata/blankets shall have good sall contact.

TYPICAL INSTALLATION DETAIL

Storm Drain Inlet Protection

CASQA Detail SE-10

Spillwey, 1-bog high -

TYPICAL PROTECTION FOR INLET ON SUMP

Splittery, 1-bog high

TYPICAL PROTECTION FOR INLET ON GRADE

Allow for proper maintenance and cleanup.
 Bogs must be removed after adjacent operation is completed.
 Not applicable in creas with high sitts and slays without filter fathle.

1. Intended for short-term use:

. Use to hisbit non-storm aster flox.

Les blorkets tessely and stoke or stopic to resintain direct contact with the sail. So not stretch.

5. Install per monufacturer's recommendations

Mots/blankets should be installed vertically

geoleville filter fobric under


WET SLOPE LINING

downstope.

County of Santa Clara

towards direction of flow.

For use in cleaned and grubbed and in graded areas.
 Shape basin so that longest inflaw area foces longest length of tree.
 For concentrated flaws, shape basin in 2:1 ratio with tength oriented.

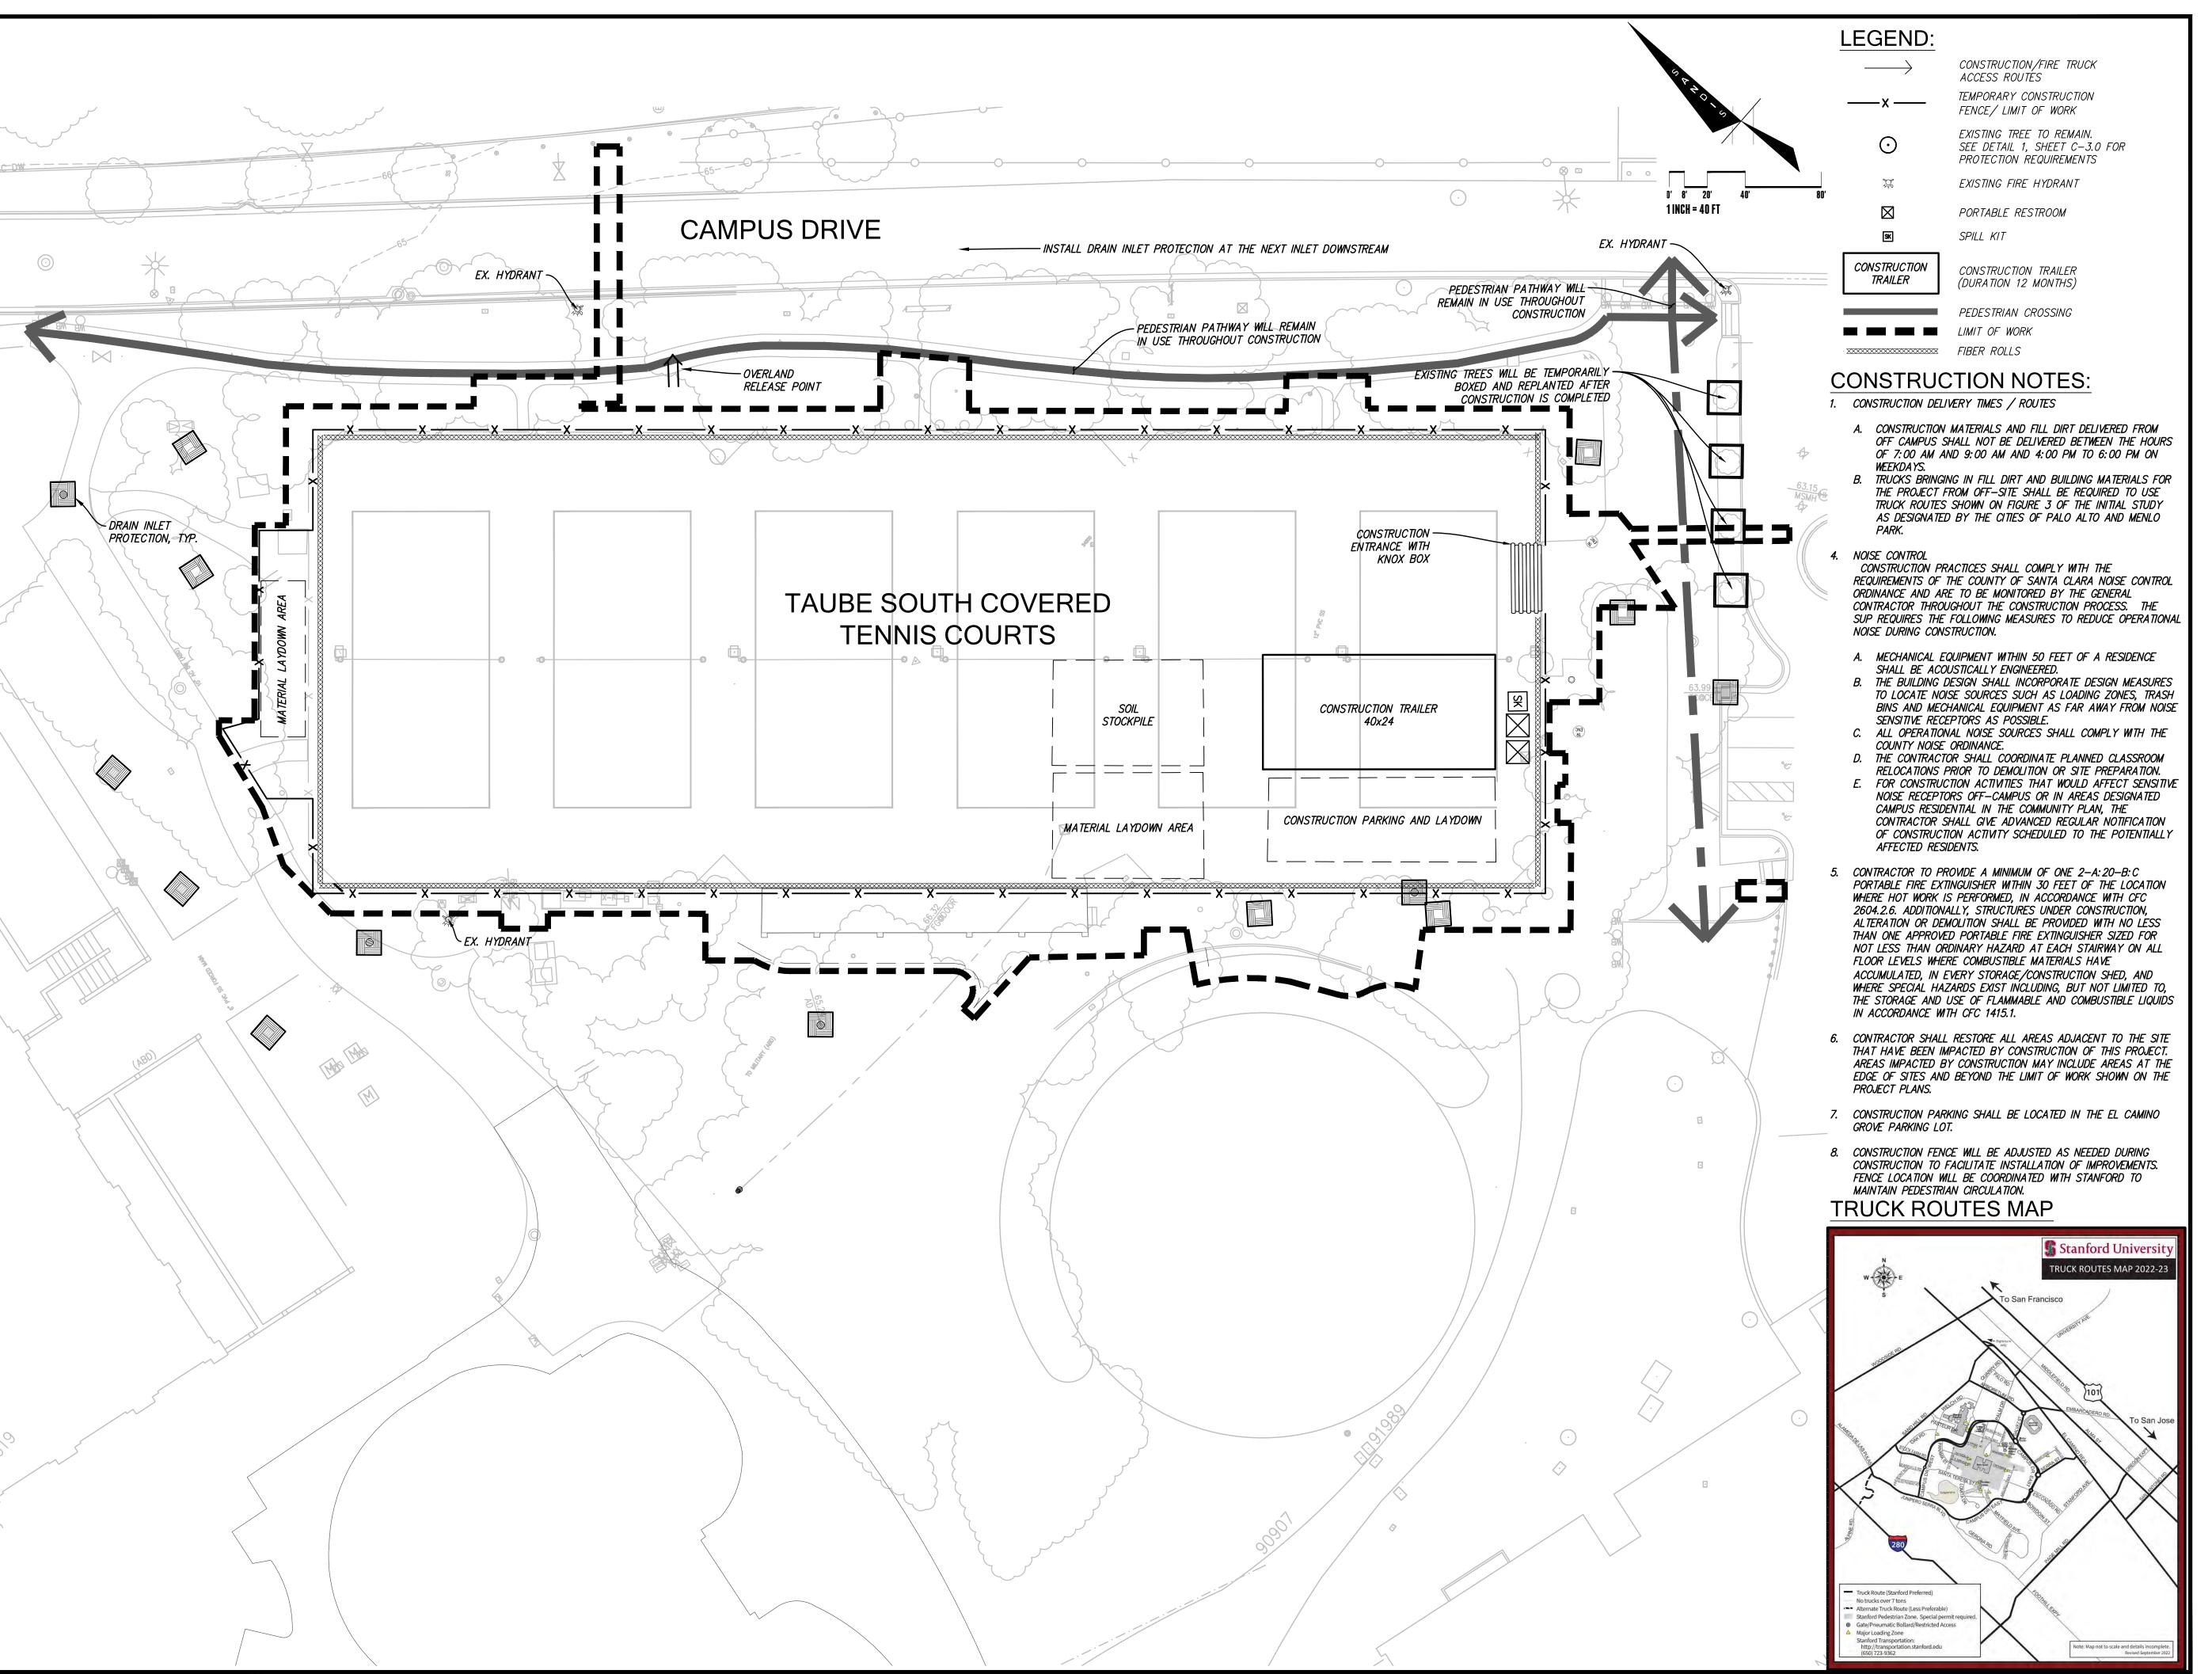

Project Name: Covered Tennis Courts Project Address: 638 Campus Drive, Stanford CA. 94305 Quad/ Bldg. Number: 08-025





ISSUES AND REVISIONS

DESCRIPTION
2023 ASA SET

03.01.2023 ASA SET 05.31.2023 ASA RESUBMITTAL SET

1.2025 ASA NESOBIMITIAL SE

PROJECT NUMBER

SHEET TITLE


CONSTRUCTION SITE LOGISTICS/SAFETY PLAN

AS NOTED

SHEET NUMBER

C-8.0

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Project Name: Covered Tennis Courts Project Address: 638 Campus Drive, Stanford CA. 94305 Quad/ Bldg. Number: 08-025

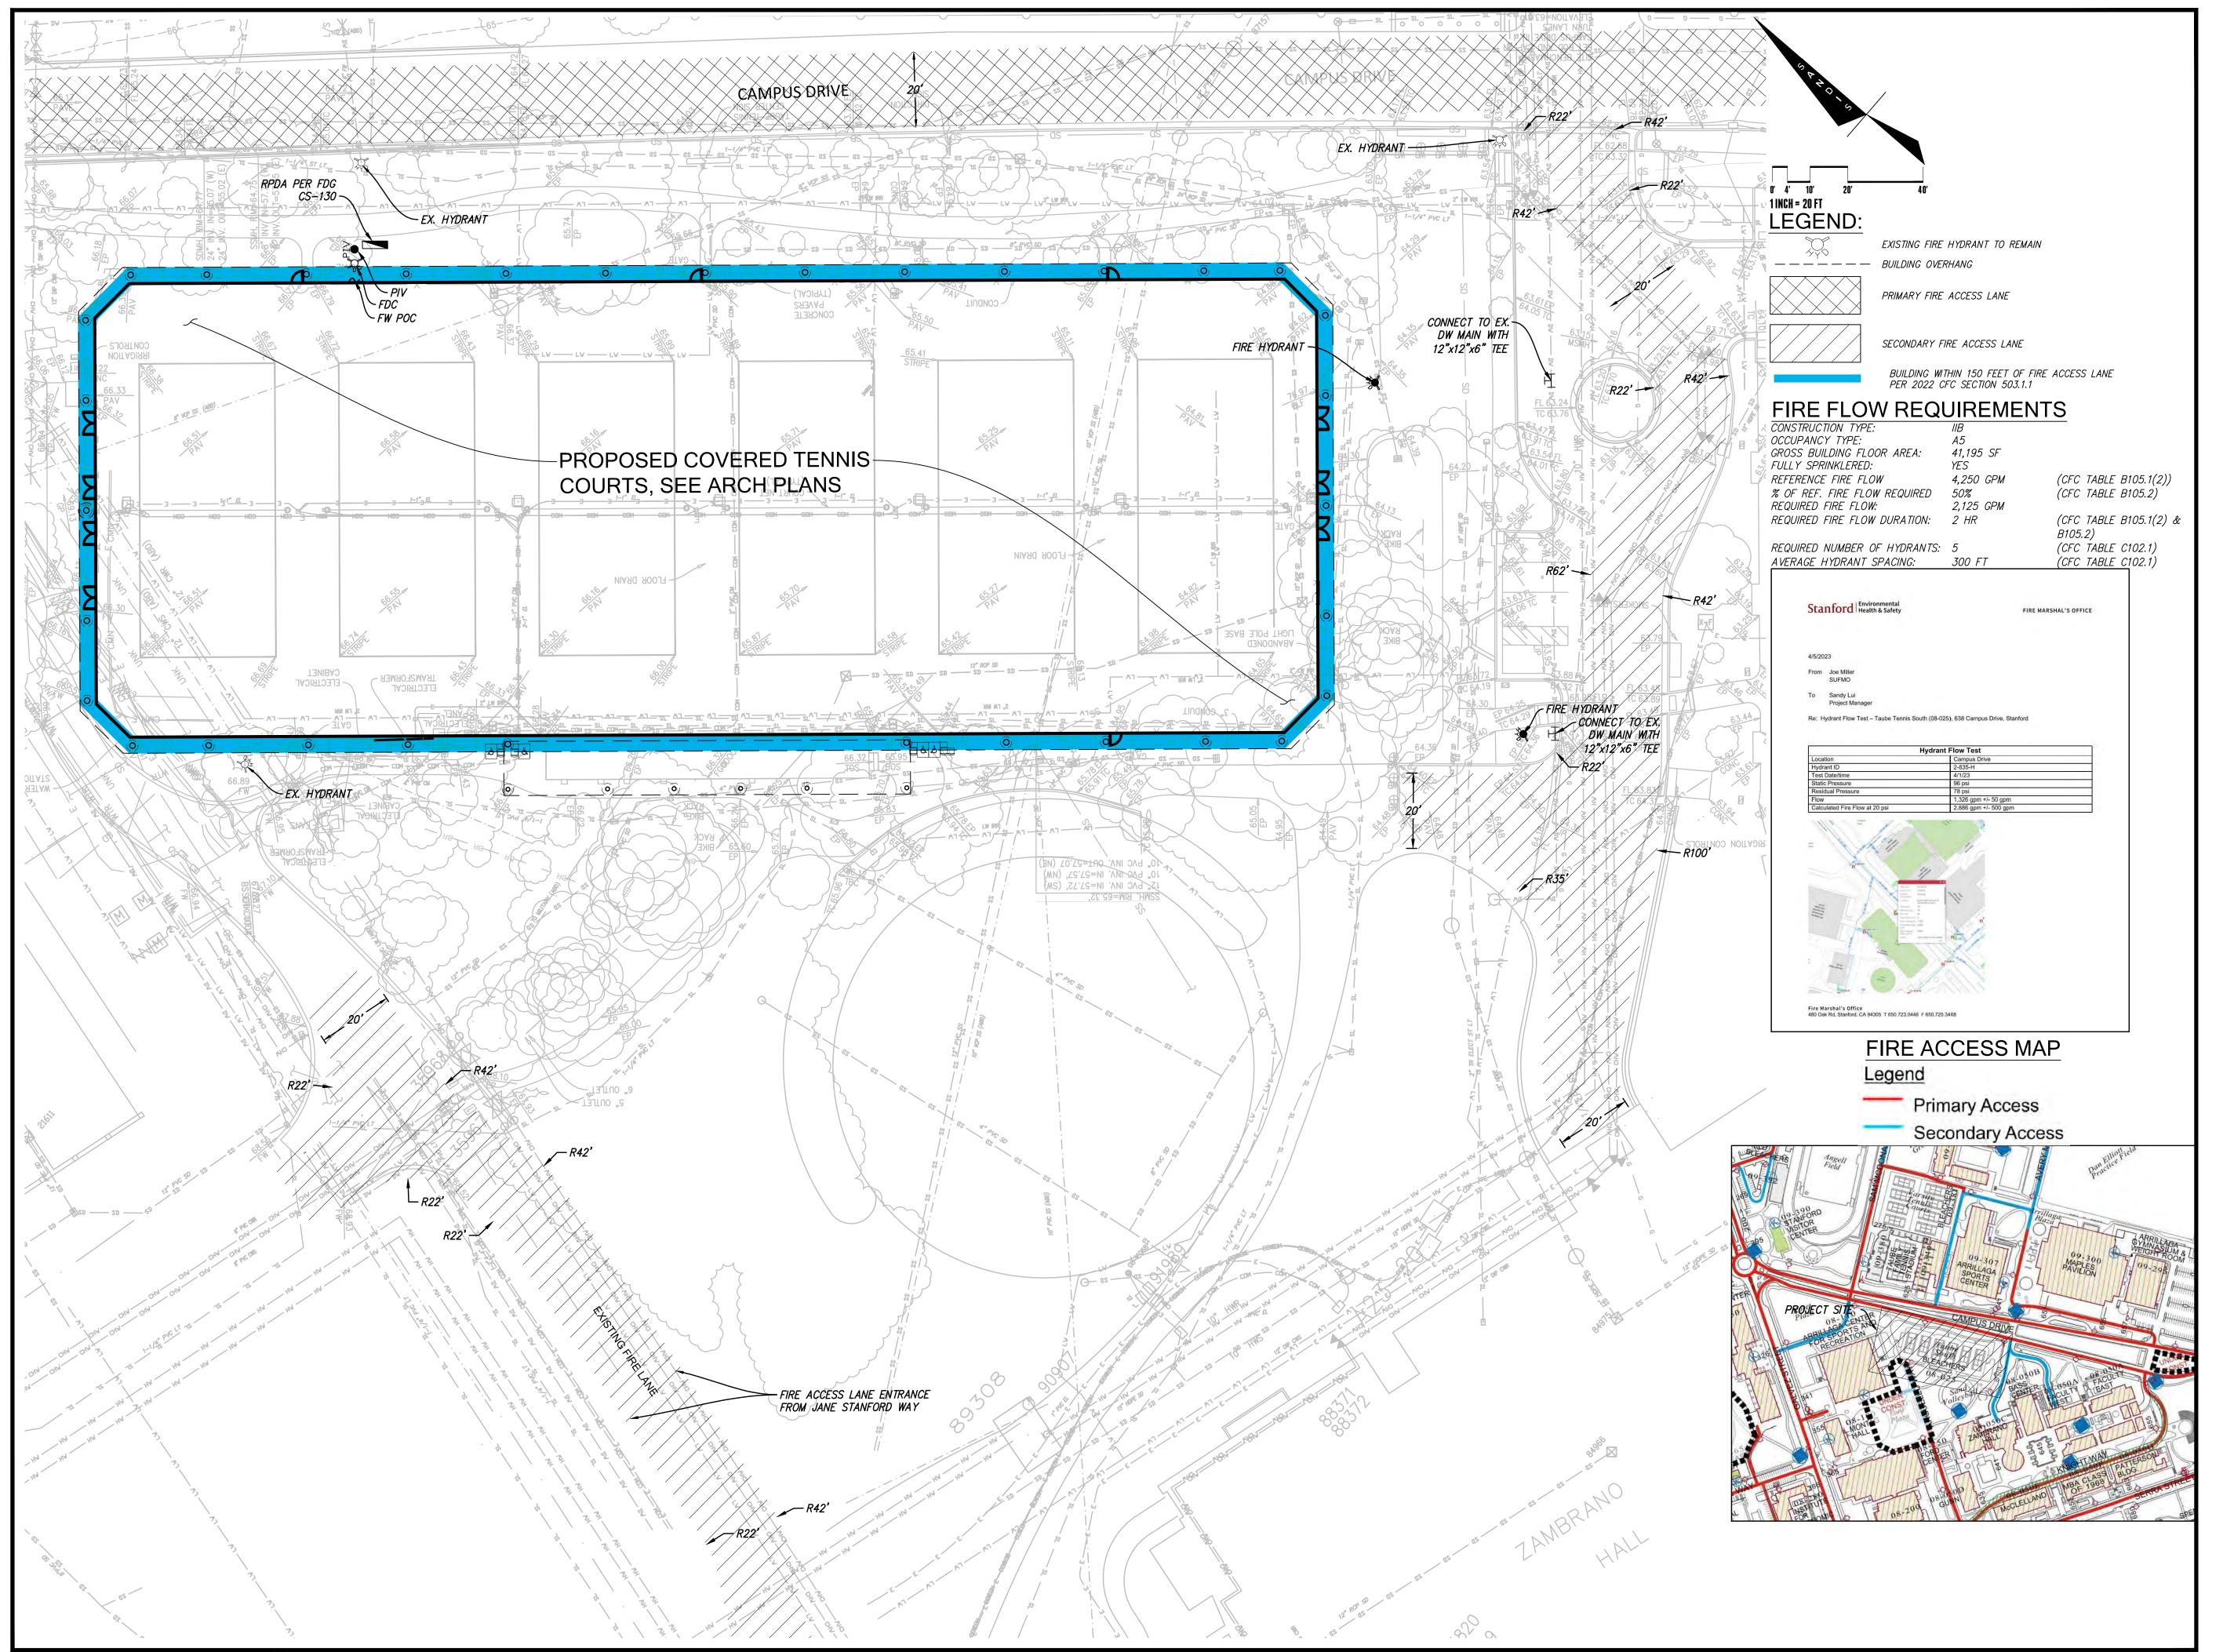



ISSUES AND REVISIONS
E DESCRIPTION

03.01.2023 ASA SET 05.31.2023 ASA RESUBMITTAL SET

> PROJECT NUMB 220

SHEET IIII

FIRE ACCESS PLAN

AS NOTED

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SHEET NUMB

C-9.0

LANDSCAPE DESIGN CONCEPT


THE LANDSCAPE DESIGN FOR THE PROJECT PRESERVES THE EXISTING LANDSCAPING AT THE TENNIS COURTS. PLANTING AREAS ADJACENT TO THE COURTS WILL BE TOP DRESSED WITH BARK MULCH FOLLOWING CONSTRUCTION TO MATCH EXISTING CONDITIONS AROUND THE PROJECT SITE.

TREE PRESERVATION NOTES

- 1. REFER TO THE TREE DISPOSITION TABLE ON THIS SHEET.
- 2. REFER TO SHEETS C-3.0 AND C-3.1 AND TO THE ARBORIST REPORT PREPARED BY DAVID BABBY, CONSULTING ARBORIST, FOR TREES TO BE SAVED AND REMOVED.
- 3. REFER TO TREE PROTECTION NOTES ON SHEET C-3.0 AND C-3.1.

PLANTING NOTES

- 1. THERE IS NO NEW PLANTING PROPOSED FOR THE PROJECT.
- 2. EXISTING PLANTING AREAS ADJACENT TO THE COURTS WILL BE TOP DRESSED WITH BARK MULCH FOLLOWING CONSTRUCTION.
- 3. REFER TO CIVIL DRAWINGS FOR SITE DEMOLITION, PAVING, GRADING AND DRAINAGE AND STORMWATER MANAGEMENT.

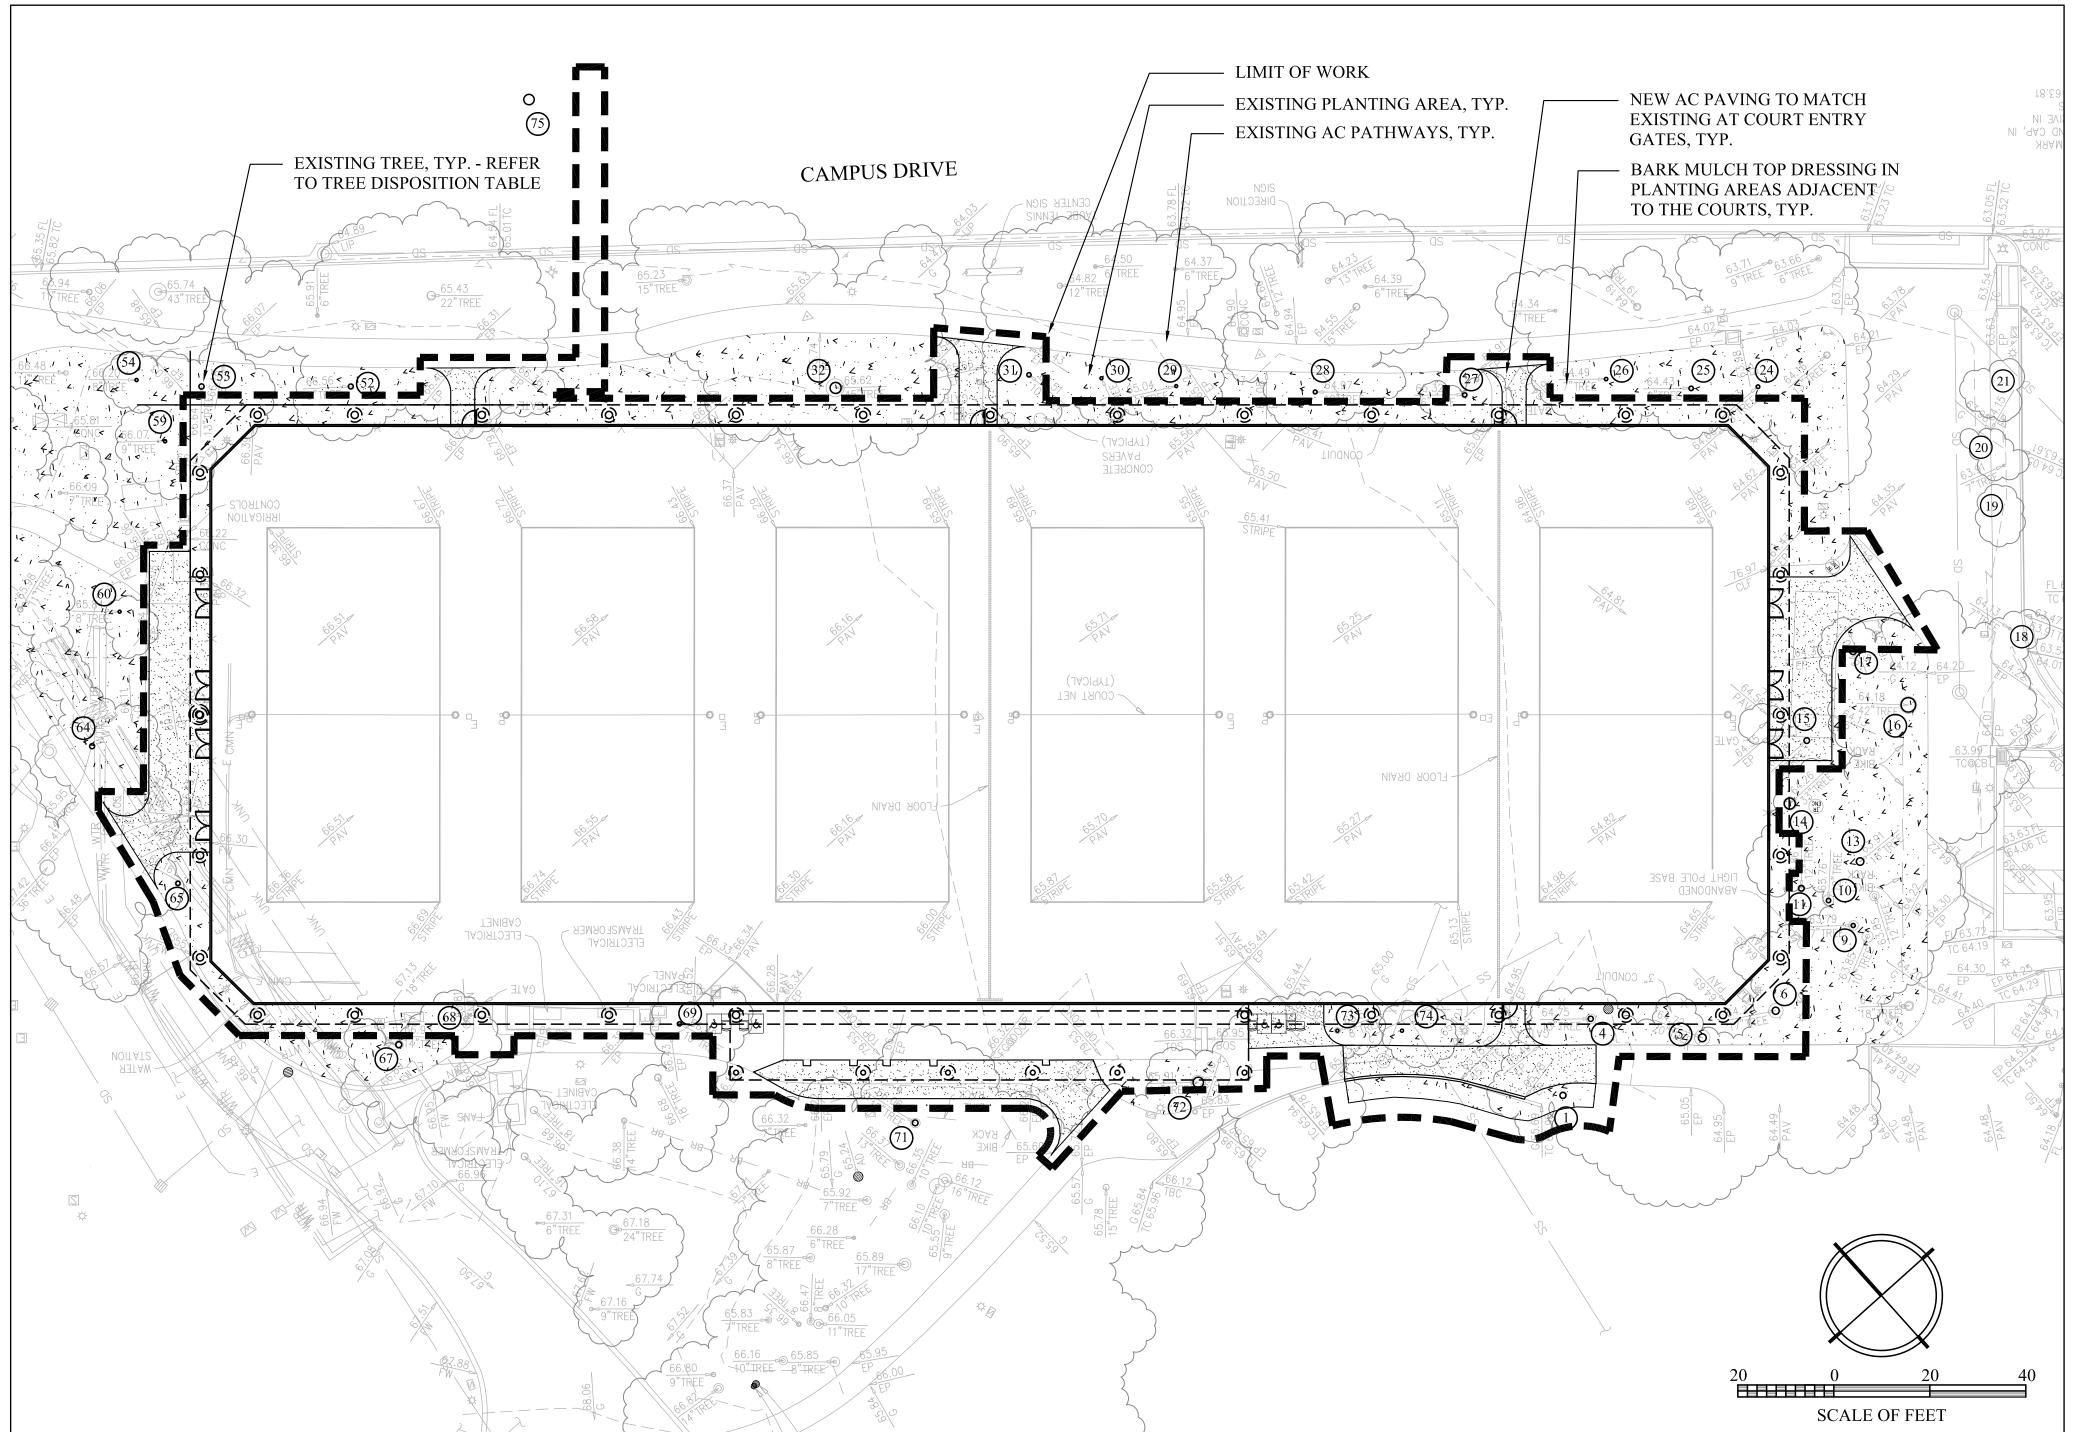

TREE DISPOSITION TABLE

PREVIOUS ASA

TREE NO.	SPECIES	DBH (IN.)	REMOVE/REMAIN	PROTECTED STATUS		
1	COAST LIVE OAK	8	REMAIN	NOT PROTECTED, SEE CONDITION A BELOW		
4	COAST LIVE OAK	11	REMAIN	PROTECTED		
5	COAST LIVE OAK	21	REMAIN	PROTECTED		
6	COAST LIVE OAK	18	REMAIN	PROTECTED		
9	COAST LIVE OAK	7	REMAIN	NOT PROTECTED, SEE CONDITION A BELOW		
10	COAST LIVE OAK	<12	REMAIN	NOT PROTECTED, SEE CONDITION A BELOW		
11	COAST LIVE OAK	12	REMAIN	PROTECTED		
13	COAST LIVE OAK	18	REMAIN	PROTECTED		
14	COAST LIVE OAK	20,19	REMAIN	PROTECTED		
15	COAST LIVE OAK	10	REMOVE	NOT PROTECTED, SEE CONDITION A BELOW		
16	COAST LIVE OAK	24,20	REMAIN	PROTECTED		
17	COAST LIVE OAK	3	REMAIN	NOT PROTECTED, SEE CONDITION A BELOW		
18	COAST LIVE	8	REMAIN	NOT PROTECTED, SEE CONDITION A BELOW		
 19	OAK COAST LIVE			NOT PROTECTED, SEE CONDITION A BELOW		
20	OAK COAST LIVE	7	REMAIN	NOT PROTECTED, SEE CONDITION A BELOW		
21	OAK COAST LIVE	5	REMAIN	NOT PROTECTED, SEE CONDITION A BELOW		
22	OAK DEODAR	7	REMAIN	NOT PROTECTED, SEE CONDITION A BELOW		
	CEDAR DEODAR					
24	CEDAR DEODAR	8	REMAIN	NOT PROTECTED, SEE CONDITION A BELOW		
25	CEDAR DEODAR	7	REMAIN	NOT PROTECTED, SEE CONDITION A BELOW		
26	CEDAR	8	REMAIN	NOT PROTECTED, SEE CONDITION A BELOW		
27	REDWOOD COAST	15	REMAIN	PROTECTED		
28	REDWOOD	10	REMAIN	NOT PROTECTED, SEE CONDITION A BELOW		
29	COAST REDWOOD	10	REMAIN	NOT PROTECTED, SEE CONDITION A BELOW		
30	COAST REDWOOD	9	REMAIN	NOT PROTECTED, SEE CONDITION A BELOW		
31	COAST REDWOOD	10	REMAIN	NOT PROTECTED, SEE CONDITION A BELOW		
32	COAST LIVE OAK	39	REMAIN	PROTECTED		
52	DEODAR CEDAR	10	REMAIN	NOT PROTECTED, SEE CONDITION A BELOW		
53	DEODAR CEDAR	14	REMAIN	PROTECTED		
54	DEODAR CEDAR	8	REMAIN	NOT PROTECTED, SEE CONDITION A BELOW		
59	DEODAR CEDAR	10	REMAIN	NOT PROTECTED, SEE CONDITION A BELOW		
60	CANARY ISLAND PINE	9	REMAIN	NOT PROTECTED, SEE CONDITION A BELOW		
64	CANARY ISLAND PINE	16	REMAIN	PROTECTED		
65	DEODAR CEDAR	11	REMAIN	NOT PROTECTED, SEE CONDITION A BELOW		
67	CANARY ISLAND PINE	19	REMAIN	PROTECTED		
68	CANARY ISLAND PINE	14	REMAIN	PROTECTED		
69	CANARY ISLAND PINE	12	REMAIN	PROTECTED		
71	COAST LIVE OAK	17	REMAIN	PROTECTED		
72	COAST LIVE OAK	27	REMAIN	PROTECTED		
73	COAST LIVE OAK	8	REMAIN	NOT PROTECTED, SEE CONDITION A BELOW		
74	COAST LIVE OAK	5	REMAIN	NOT PROTECTED, SEE CONDITION A BELOW		
NOTES:						
			1	TREE DUE TO THE DBH BEING LESS THAN 12". TREE DUE TO NOT BEING IDENTIFIED ON A		

STANFORD UNIVERSITY

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Stephen Wheeler
Landscape Architects
99 Mississippi Street
Second Floor
San Francisco, CA 94107



ISSUES AND REVISIONS

TE DESCRIPTION

03.01.2023 DRAFT ASA SUBMITTAL 05.31.2023 ASA RESUBMITTAL #1

PROJECT NUMBER

LANDSCAPE PLAN

SCALE 1" = 20'-0"

SHEET NUME

L-1.01