

SOLAR REQUIREMENTS

1. MAIN SERVICE ENTRANCE WITH END FEED BUSSES. [CALIFORNIA ENERGY CODE SECTION 110.0(c) 1 & 2 (NO CENTER FEED BUSB PANELS ALLOWED)].
2. MAIN SERVICE PANEL SHALL RESERVE AS A MINIMUM, A SPACE FOR A DOUBLE POLE CIRCUIT BREAKER AT THE OPPOSITE END OF THE BUSB FROM THE UTILITY FEED POINT AND SHALL BE MARKED "RESERVED FOR SOLAR INVERTERS" (CALIFORNIA ENERGY CODE SECTION 110.0(c) 2 A AND B).
3. ALL BUILDINGS THAT MUST INCLUDE A SOLAR ZONE MUST ALSO INCLUDE A PLAN FOR CONNECTING A PV AND SWH SYSTEM TO THE BUILDING'S ELECTRICAL AND PLUMBING SYSTEM. THE CONSTRUCTION DOCUMENTS SHALL INDICATE:
 - 3.1. A LOCATION FOR INVERTERS AND METERING EQUIPMENT FOR FUTURE SOLAR ELECTRIC SYSTEMS. [CALIFORNIA ENERGY CODE 110.0(f)].
 - 3.2. A PATHWAY FOR ROUTING CONDUIT FROM THE SOLAR ZONE TO THE POINT OF INTERCONNECTION WITH THE ELECTRICAL SERVICE. THERE IS NO REQUIREMENT TO INSTALL ANY CONDUIT. [CALIFORNIA ENERGY CODE 110.0 (g)].
 - 3.2.1. ONE ACCEPTABLE METHOD WOULD BE TO RUN L TYPE NM 10-5 AWG CABLE RUN FROM THE SERVICE ENTRANCE SOLAR RESERVED BREAKER SPACE TO THE ROOF DECK AREA IN THE ATTIC NEAR THE SOLAR READY ROOF ZONE TERMINATED IN A JUNCTION BOX AND LABELED "PHOTOVOLTAIC CIRCUIT".
4. A PATHWAY FOR ROUTING OF PLUMBING FROM THE SOLAR ZONE TO THE WATER HEATING SYSTEM. THERE IS NO REQUIREMENT TO INSTALL ANY PIPING. [CALIFORNIA ENERGY CODE 110.0(f)].
5. ONE ACCEPTABLE METHOD OF MEETING THIS REQUIREMENT WOULD BE TO PROVIDE AN ELECTRICAL OUTLET AT THE WATER TANK LOCATION FOR A 1/2" PIPE RUNS WITH THREADED 1/2" CIRCULAR PUMP AND PROVIDE TWO TERMINATION AT BOTH ENDS IN THE SOLAR RESERVE AREA TO THE WATER HEATING EQUIPMENT AREA.
6. THE SOLAR ZONES MUST BE CLEARLY INDICATED ON THE ROOF PLANS FOR ALL POSSIBLE ORIENTATIONS SHOWING THE MINIMUM 250 SQUARE FEET IN THE 110 TO 270 DEGREES OF "TRUE NORTH" ORIENTATIONS. [CALIFORNIA ENERGY CODE 110.0(b)(1)(A)].
7. FOR THOSE HOMES WHICH WILL BE USING ANY OF THE EXCEPTIONS FROM THE C.E.C. SECTION 110.0(d) L1-T P1 SHALL BE CLEARLY INDICATED ON THE PLANS WHICH EXCEPTION IS TO BE USED FOR COMPLIANCE TO THE SOLAR READY REQUIREMENTS.
8. I & II ARE ONLY GIVEN AS EXAMPLES OF WAYS TO COMPLY W/ THE REQUIREMENTS. IT IS THE DESIGNER'S RESPONSIBILITY TO PROVIDE A PLAN FOR COMPLIANCE W/ THESE REQUIREMENTS.

CLEAN-AIR VEHICLE NOTES	
1.	INSTALL A LISTED RACEWAY(S) TO ACCOMMODATE ELECTRIC VEHICLE (EV) CHARGING. THE RACEWAY(S) SHALL COMPLY AS FOLLOWS: 1.1. ORIGINATE AT THE MAIN SERVICE PANEL SUB-PANEL AND SHALL TERMINATE INTO A LISTED CABINET, BOX, OR 1.2. OTHER ENCLOSURE IN CLOSE PROXIMITY TO THE PROPOSED LOCATION OF AN EV CHARGER.
2.	THE SERVICE PANEL AND/OR SUB-PANEL SHALL PROVIDE CAPACITY TO INSTALL A 40-AMPERE MINIMUM DEDICATED BRANCH CIRCUIT AND SPACE(S) RESERVED TO PERMIT INSTALLATION OF A BRANCH CIRCUIT OVER-CURRENT PROTECTIVE DEVICE
3.	THE SERVICE PANEL OR SUB-PANEL CIRCUIT DIRECTORY SHALL IDENTIFY THE OVER-CURRENT PROTECTIVE DEVICE SPACE(S) RESERVED FOR FUTURE EV CHARGING AS "EV CAPABLE". THE RACEWAY TERMINATION LOCATION SHALL BE PERMANENTLY AND VISIBLY MARKED AS "EV CAPABLE".
DEFERRED SUBMITTALS	
1.	FIRE SPRINKLER AND ALARM SYSTEM SHALL BE A DEFERRED SUBMITTAL.

VICINITY MAP

PALM AVE

DOUGHERTY AVE

PROJECT LOCATION
APN: 712-27-012

N

HATCH LEGEND			
	STEEL		NATIVE SOIL
	MASONRY		ENGINEERED FILL
	AGGREGATE		AC PAVING
	PEDIGICATION		CONCRETE
	TRUNCATED DOMES		LANDSCAPE


BARRIER REQUIREMENT REQUIRED	FLOOD HAZARDS	AIR FREEZING INDEX	MEAN ANNUAL TEMP.
NO	NO	1500	48° F

**PALM AVE AND DOUGHERTY AVE
MORGAN HILLS, CA 95037
APN - 712-27-012**

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A2.1	MAIN SFR ELEVATIONS
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A3.1	PROPOSED FLOOR PLAN - 2ND
A3.2	PROPOSED FLOOR PLAN - 2ND
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MECHANICAL ENGINEER	
ALI NEHME, MECHANICAL ENGINEER 22914 DRY CREEK ROAD DIAMOND BAR, CA 91765 PHONE: 554-1049-3246 EMAIL: al18663@gmail.com	
CONTACT: ALI	
PROJECT DATA	
EX. USE:	VACANT LAND
NEW USE:	SINGLE FAMILY RESIDENCE
APN:	712-2T-043
SITE ADDRESS:	PALM AVE AND DOUGHERTY AVE MORGAN HILL, CA 95031
ZONE:	A-20A
CONSTRUCTION TYPE:	VB
OCCUPANCY:	R-3
CUSTOM RESIDENCE:	R-3
5-CAR GARAGE:	U
PORCH/PATIO:	U
FIRE SPRINKLER SYSTEM:	YES - DEFERRED
FIRE ALARM SYSTEM:	YES - DEFERRED



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
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PROJECT

**NEW SINGLE FAMILY RESIDENCE FOR:
 GURDEEP DHADWAL
 PALM AVE AND DOUGHERTY AVE
 MORGAN HILLS, CA 95037
 APN: 712-27-043**



DATE SIGNED: 5/9/2024


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COVER
SHEET


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SCALE:

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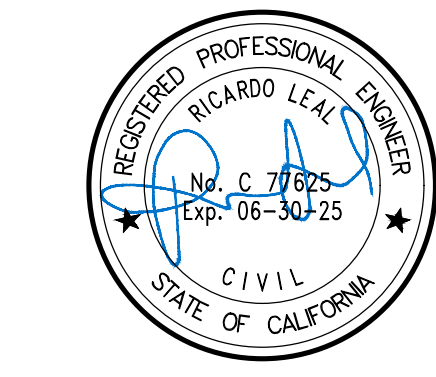
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BLOCK SITE PLAN
SCALE: 1/32"

BLOCK AREA LEGEND (SITE)							
PARCEL (390-051-07)		395,736		SF		9.08	
AREA	QNTY	DIMENSION (FEET)		SF PER AREA			
DEVELOPMENT AREA (2 ACRE OR 87,120 SF MAX.):							
BLOCK AREA	1	1	X	31'	X	24'	744
BLOCK AREA	2	1	X	280'	X	194'	54,320
BLOCK AREA	3	1	X	58'	X	60'	3,480
BLOCK AREA	4	1	X	43'-6"	X	65'-6"	6,124
BLOCK AREA	5	1	X	51'	X	104'-4"	5,342
BLOCK AREA	6	1	X	41'	X	42'	3,822
BLOCK AREA	7	1	X	122'	X	35'	4,270
BLOCK AREA	8	1	X	83'	X	55'	4,565
TOTAL:						82,667	
COYOTE VALLEY CLIMATE RESILIENCE COMBINING DISTRICT REQUIREMENT						2 ACRES MAX.	
AG AREA (60% MINIMUM):						87,120 SF MAX.	
BLOCK AREA	9	1	X	83'	X	87'	7,221
BLOCK AREA	10	1	X	83'	X	332'-4"	27,618
BLOCK AREA	11	1	X	432'	X	474'-4"	205,092
TOTAL:						234,931	
COYOTE VALLEY CLIMATE RESILIENCE COMBINING DISTRICT REQUIREMENT						60 %	
REMAINDER OF PROPERTY:						237,448 SF MIN.	
BLOCK AREA	12	1	X	30'-6"	X	30'-3"	461
BLOCK AREA	13	1	X	30'-6"	X	76'	2,318
BLOCK AREA	14	1	X	32'	X	155'-4"	4,984
BLOCK AREA	15	1	X	158'	X	155'-4"	24,609
BLOCK AREA	16	1	X	60'	X	171'	10,260
BLOCK AREA	17	1	X	71'-3"	X	44'-4"	3,188
BLOCK AREA	18	1	X	91'-3"	X	42'	1,313
BLOCK AREA	19	1	X	122'	X	33'-6"	4,087
TOTAL:						51,220	

PROJECT
NEW SINGLE FAMILY RESIDENCE FOR:
GURDEEP DHADWAL
PALM AVE AND DOUGHERTY AVE
MORGAN HILLS, CA 95037
APN: 712-27-043

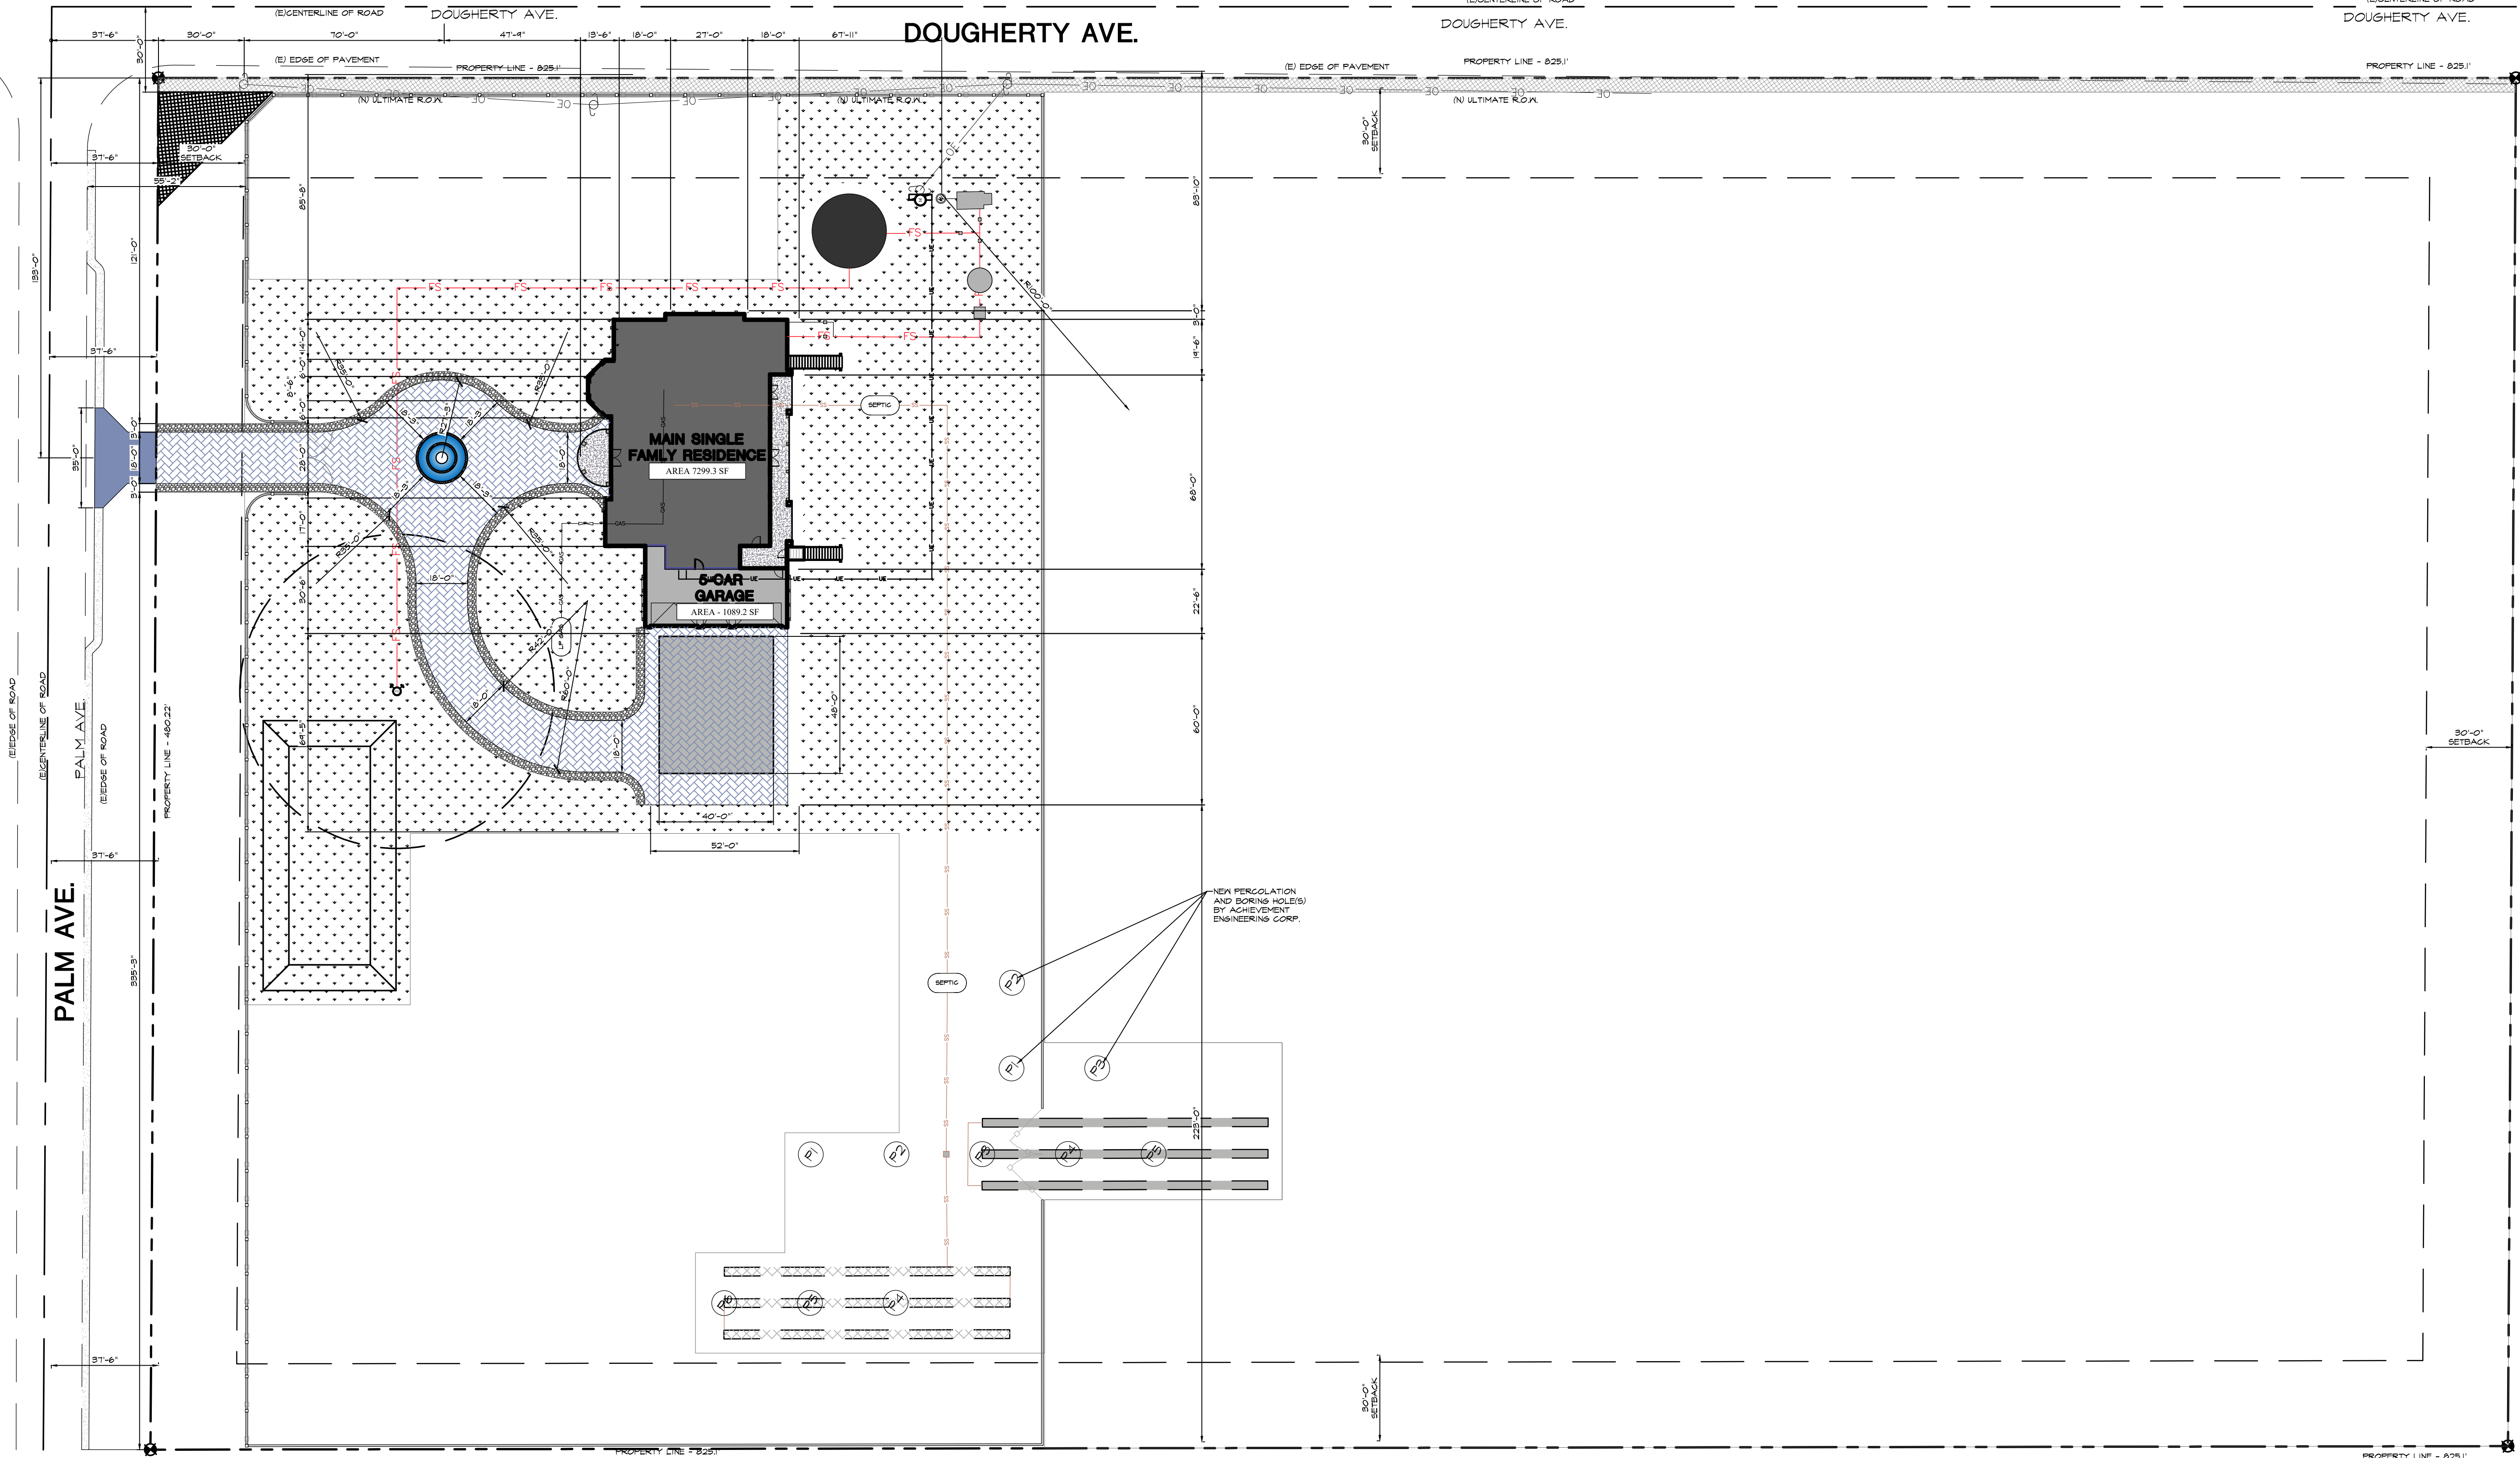

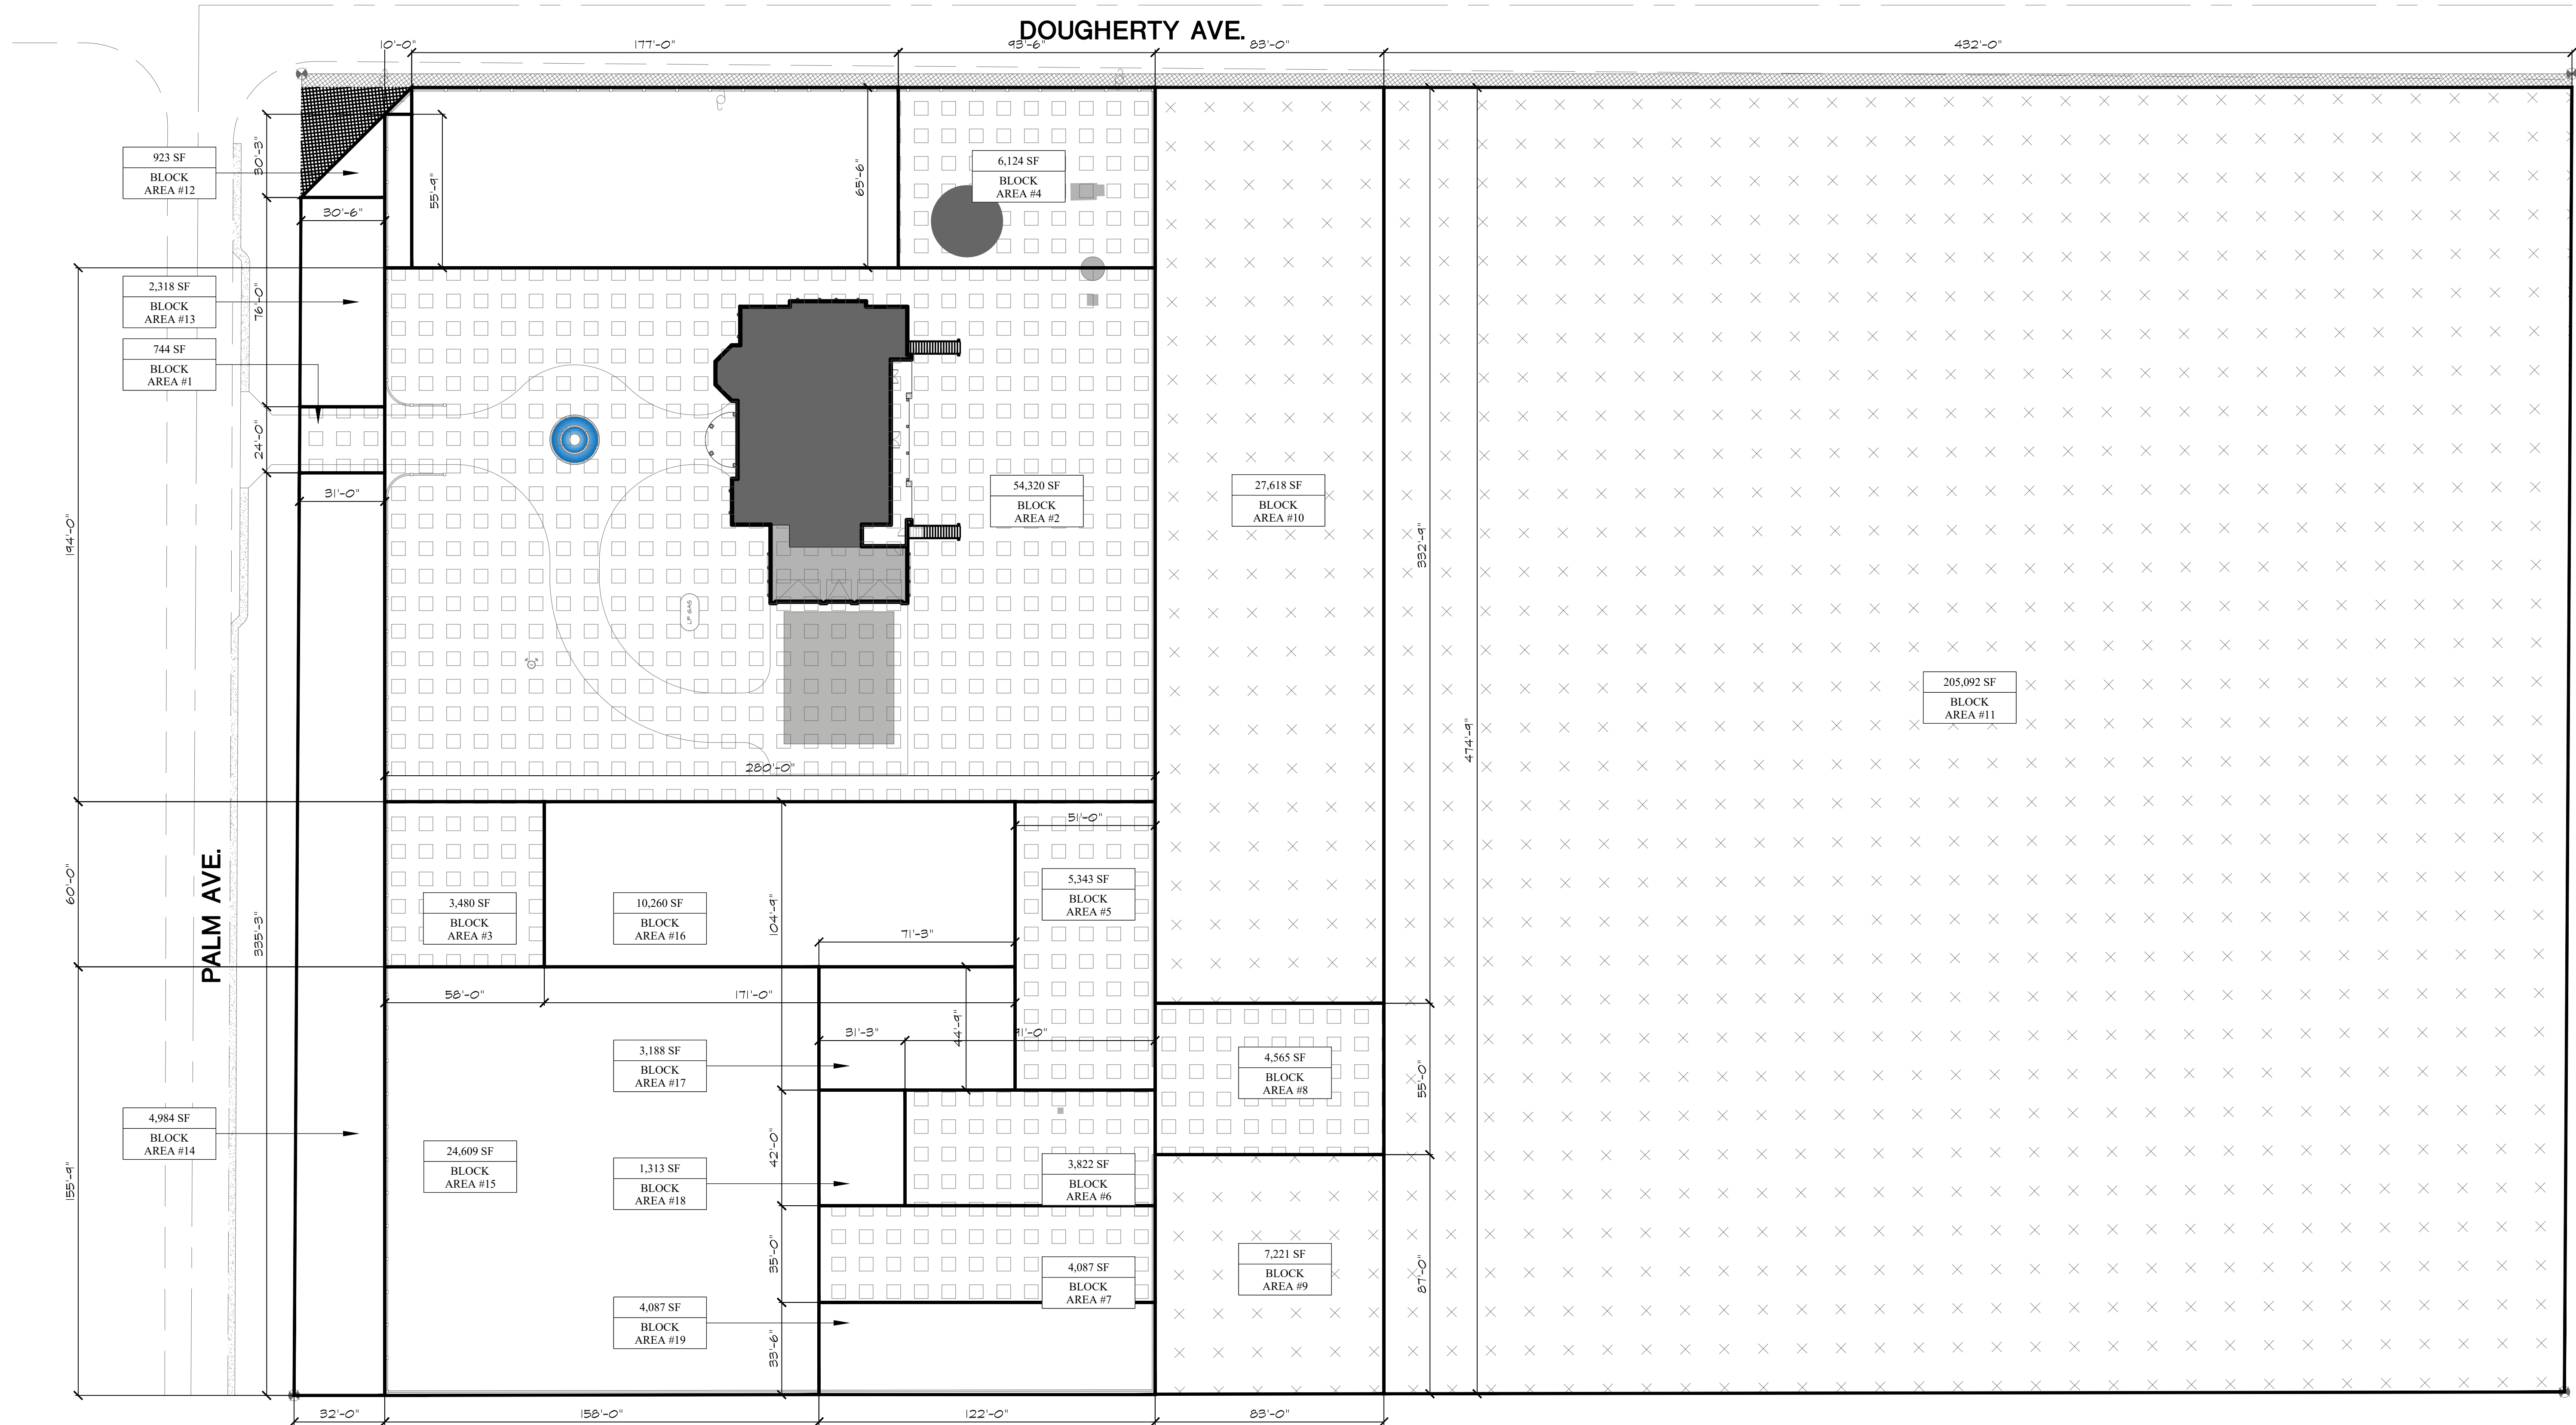DATE SIGNED: 5/9/2024

Revisions	Date

OVERALL
SITE PLAN

CVEAS JOB #:

DATE: 5/9/2024

PLANNING SUBMITTAL #: XX-XXXX

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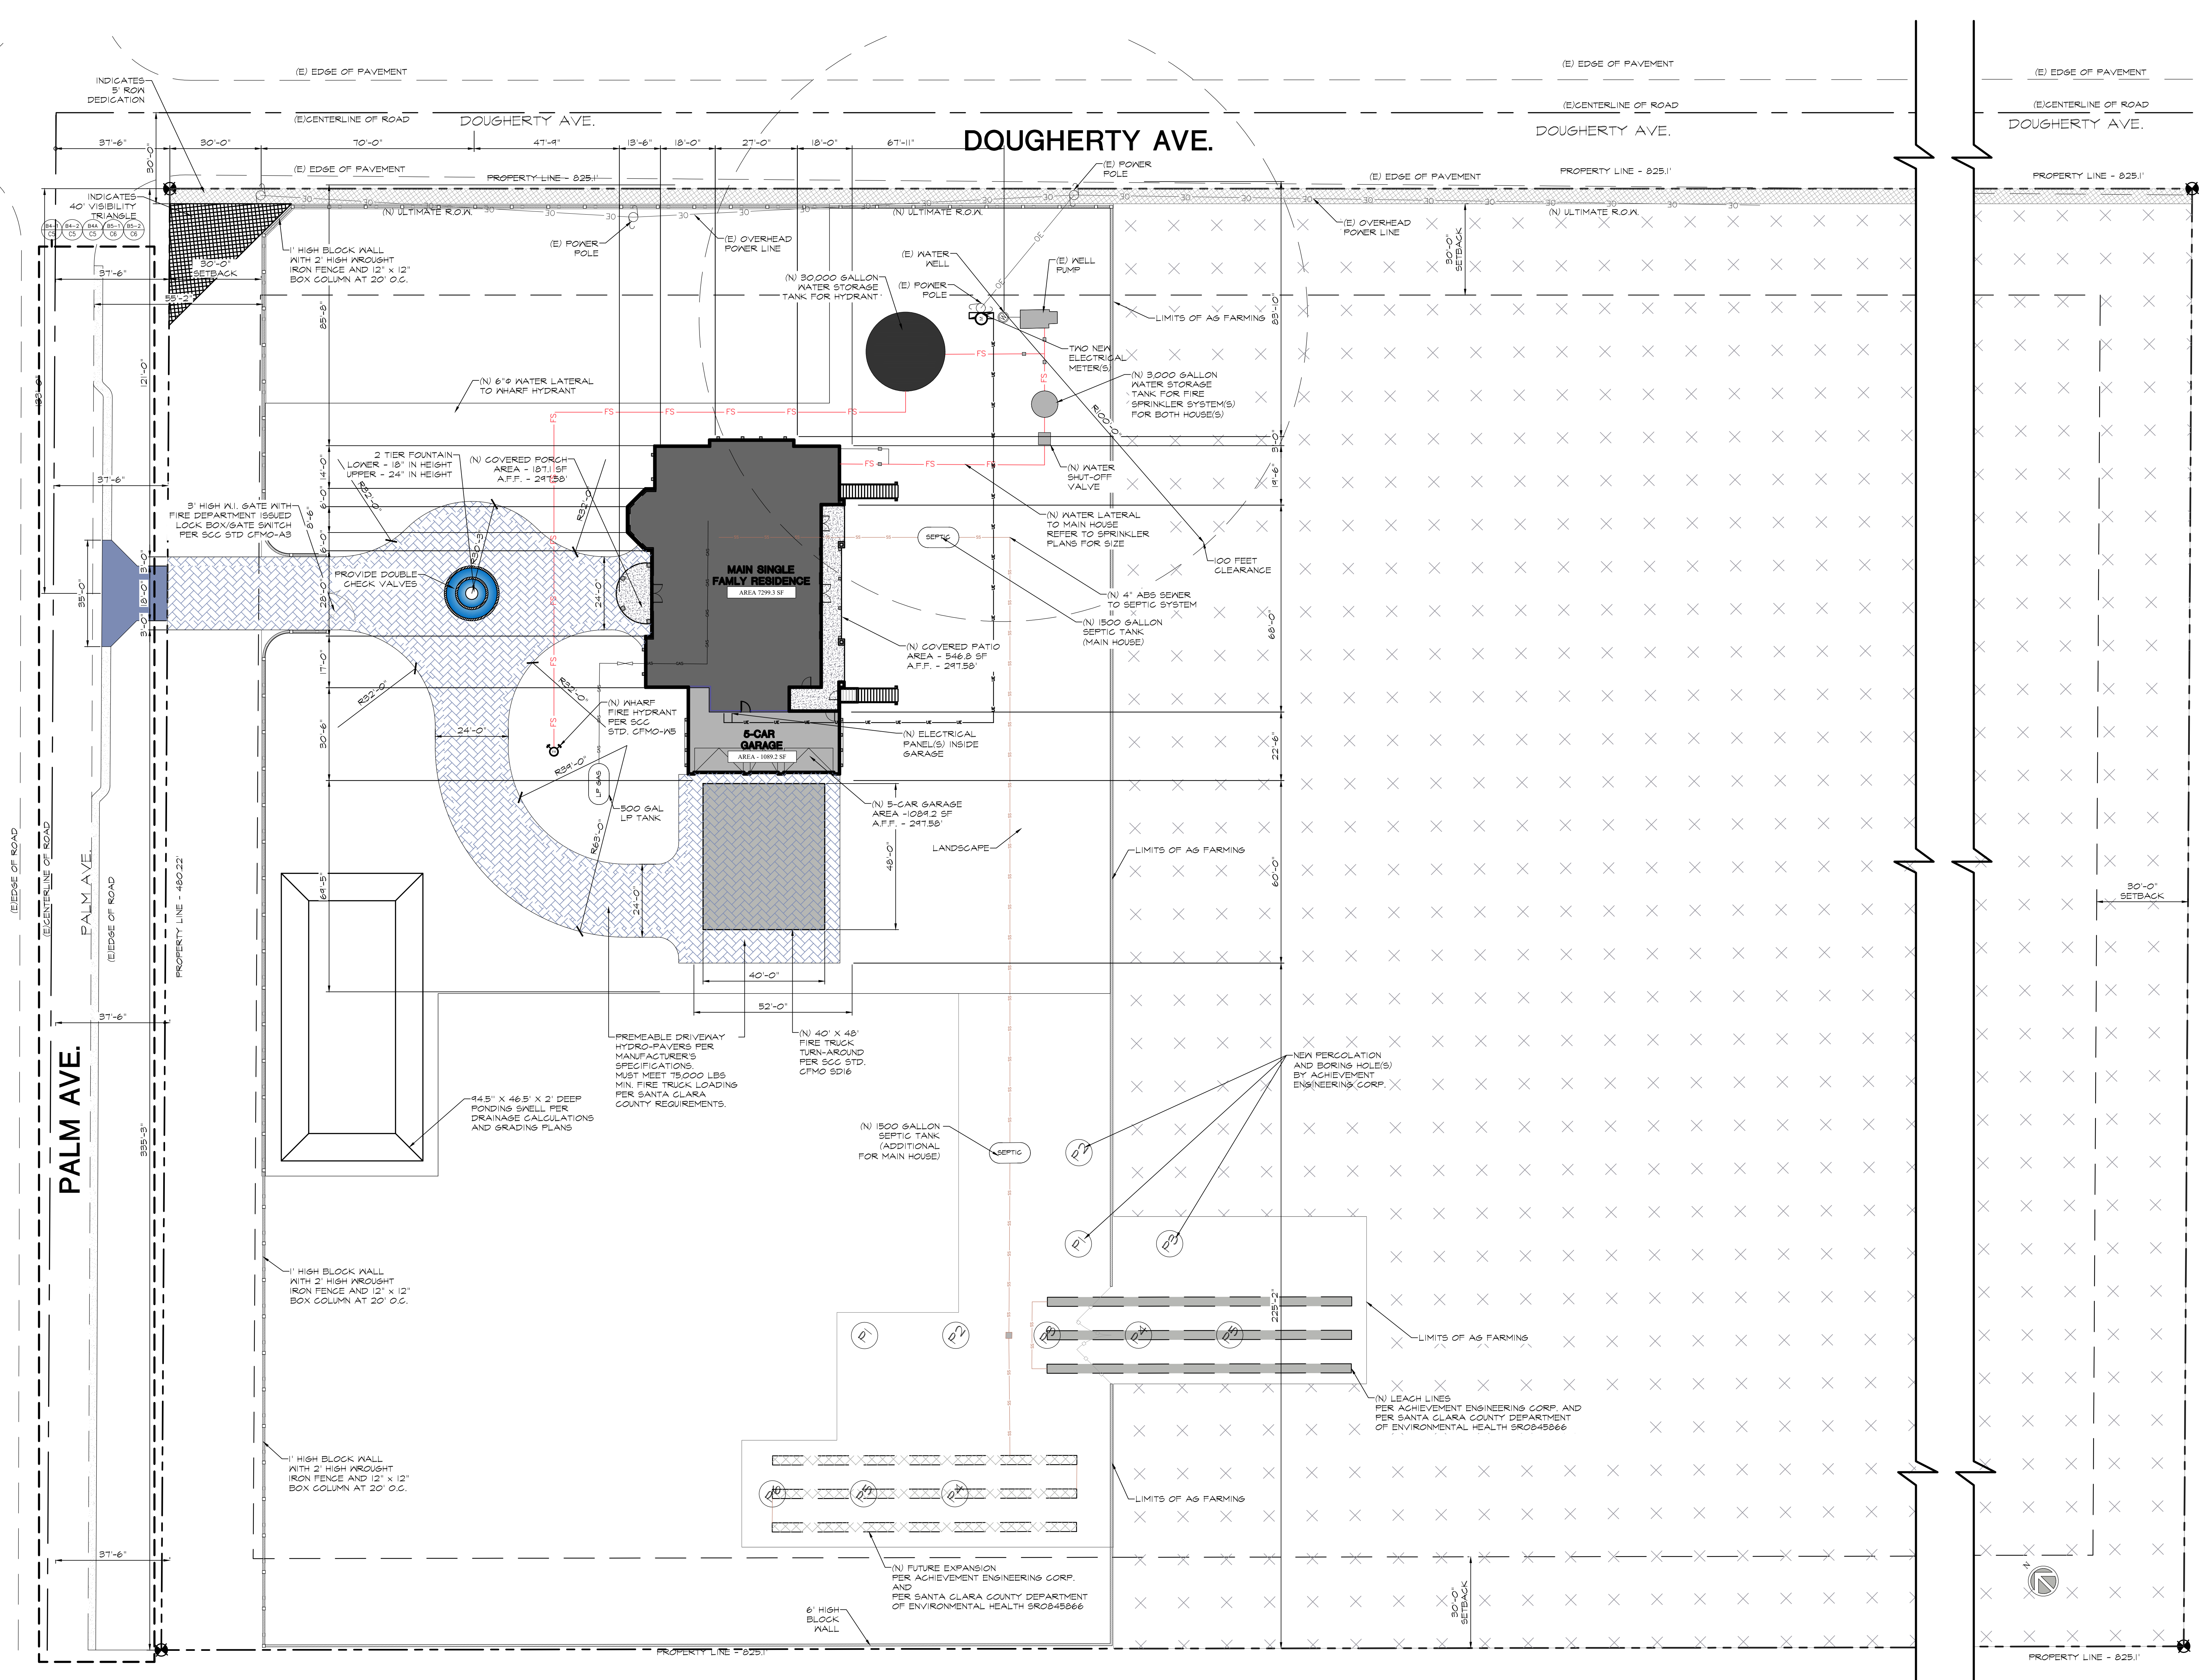
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PROJECT

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GURDEEP DHADWAL
PALM AVE AND DOUGHERTY AVE
MORGAN HILLS, CA 95037
APN: 712-27-043

DATE SIGNED: 5/30/2024

Revisions	Date
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2	
3	
4	

ENLARGED
SITE PLAN

CVEAS JOB #:

DATE: 5/30/2024

PLANNING SUBMITTAL #: XX-XXXX

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ENLARGE SITE PLAN
SCALE: 1/20

A1.2

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- 328.83±
ROOF APEX FROM FINISHED GRADE
- 31'-3"[±]
ROOF APEX FROM AFF
- 31'-9"[±]
ROOF APEX FROM GROUND
- 27'-1"
PLATE HGT AT FOYER TOWER
- 23'-9"
PLATE HGT AT FOYER
- 20'-3"
PLATE HGT AT 2ND FLR
- 14'-0"
PLATE HGT AT LIVING RM
- 11'-0"
PLATE HGT AT TOWER
- 11'-3"
AFF - 2ND
- 10'-0"
PLATE HGT AT 1ST FLR
- 8'-0"
OPENING HGT
- 0'-0"
AFF - 1ST FLR
- 0'-0'-4"
GROUND
- 297.08
FINISHED GRADE PER CIVIL PLANS




- 27'-1"[±]
PLATE HGT - FOYER TOWER
- 23'-9"[±]
PLATE HGT - FOYER
- 21'-9.75"[±]
PLATE HGT - 2ND FLR SIDE TOWER
- 20'-3"
PLATE HGT - 2ND FLR
- 13'-0.5"[±]
PLATE HGT AT GARAGE TOWER
- 12'-0"
PLATE HGT AT GARAGE
- 8'-0"
OPENING HGT
- 0'-0'-2"
AFF - GARAGE FLR
- 0'-0'-6"
GROUND
- 296.91
FINISHED GRADE PER CIVIL PLANS

FRONT ELEVATION - EAST

SCALE: 3/16" = 1'-0"

1

- 23'-9"
PLATE HGT - 2ND FLR REAR TOWER
- 20'-3"
PLATE HGT - 2ND FLR
- 13'-0"
PLATE HGT AT GARAGE TOWER
- 11'-4"
2ND FLR DECK
- 10'-0"
PLATE HGT - 1ST FLR
- 8'-0"
OPENING HGT - 1ST FLR
- 0'-0'-0"
AFF - 1ST FLR
- 0'-0'-6"
GROUND
- 296.91
FINISHED GRADE PER CIVIL PLANS

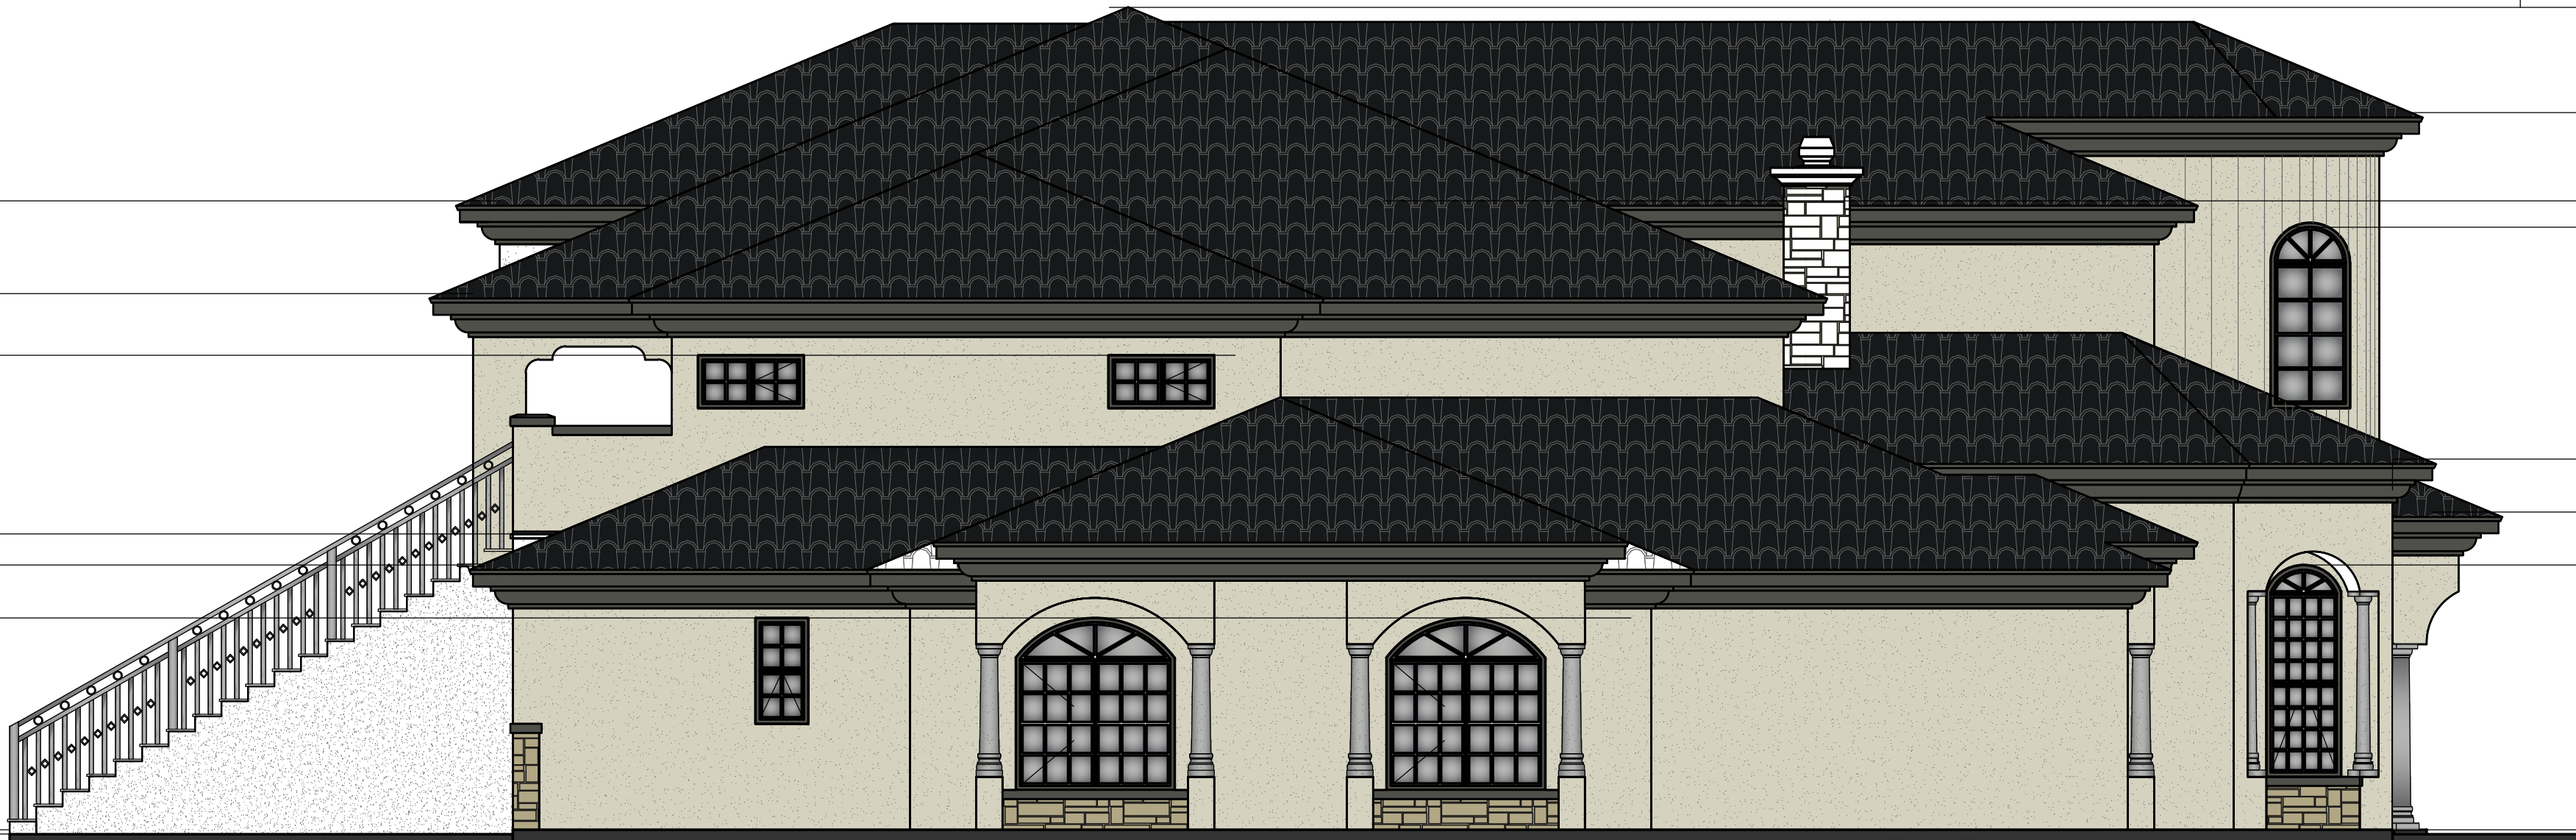

- 328.83
ROOF APEX FROM FINISHED GRADE
- 31'-3"[±]
ROOF APEX FROM AFF
- 31'-9"[±]
ROOF APEX FROM GROUND
- 27'-1"
PLATE HGT AT FOYER TOWER
- 23'-9"
PLATE HGT AT FOYER - 2ND
- 23'-0"
OPENING HGT AT FOYER
- 14'-0"
PLATE HGT AT LVNG RM
- 12'-0"
PLATE HGT AT FOYER - 1ST
- 10'-0"
OPENING HGT AT LVNG RM
- 0'-0"
AFF - 1ST FLR
- 0'-0'-4"
GROUND
- 297.08
FINISHED GRADE PER CIVIL PLANS

LEFT SIDE ELEVATION - SOUTH

SCALE: 3/16" = 1'-0"

2

COLOR SCHEDULE	
A	STUCCO #1: 3-LAYERED STUCCO FINISH COLOR - SATO14 - EIDER WHITE OR EQUAL
B	ROOFING MATERIAL: SPANISH TILE
C	STONE VENEER, EL DORADO STONE VANTAGE 30 COLOR - WHITE ELM
D	METAL SIDING: METAL CLADDING SYSTEM FLATLOCK COLOR - MATTE BLACK STEEL OR EQUAL INSTALL PER MANUFACTURER'S SPECS AND INSTALLATION INSTRUCTIONS. REFER TO DETAILS ON D11.
E	CORNICE FINISH: SHERWIN WILLIAMS SATO20 COLOR - BLACK FOX OR EQUAL
F	TRIM FINISH: SHERWIN WILLIAMS SATO20 COLOR - BLACK FOX OR EQUAL.


ELEVATION KEYED NOTES	
1	3 COAT STUCCO SMOOTH FINISH #1 (4 COLORS): 110' MIN. THICKNESS OVER 1/8" X 1/2" HEXAGONAL PAPER BACKED WIRE LATH OVER 2-LAYERS OF TYPE "D" PAPER UNDER-LAYMENT OVER PLYWOOD.
2	REFER TO KEEP SCREED DETAIL 1/D1 FOR EXTERIOR WALLS. REFER TO KEEP SCREED DETAIL 2/D1 FOR STEM WALLS. REFER TO KEEP SCREED DETAILS 3/D1 FOR BOX COLUMN(S).
3	3 COAT STUCCO SMOOTH FINISH (UNDERSIDE CEILINGS): 110' MIN. THICKNESS OVER W-IRB LATH OVER 2-LAYERS OF TYPE "D" PAPER UNDER-LAYMENT OVER PLYWOOD.
4	DOOR OPENING - REFER TO DOOR SCHEDULE ON SHEET A3.3 AND DETAIL(S) ON SHEET D2.
5	WINDOW OPENING - REFER TO WINDOW SCHEDULE ON SHEET A3.3 AND DETAIL(S) ON SHEET D2.
6	ROOF MATERIAL - SPANISH TILES - INSTALL PER MANUFACTURER'S SPECS AND INSTRUCTIONS. REFER TO DETAILS ON SHEET D10.
7	FOAM CORNICE UNDER FASCIA. REFER TO DETAIL 8/D1.
8	DOUBLE FOAM TRIM. REFER TO DETAIL 5/D1.
9	STONE VENEER AND TRIM. REFER TO DETAIL 7/D1.
10	BUILT-UP CHIMNEY. REFER TO DETAIL 1, 2, AND 3/D8.
11	COMPOSITE COLUMN INSTALL PER MANUFACTURER'S SPECS AND INSTALLATION MANUAL.
12	2X FASCIA. REFER TO DETAIL 8/D1.
13	44" HIGH HALF WALL W/ STUCCO FINISHED. REFER STUCCO NOTE #1 ABOVE.
14	44" HIGH GUARD RAIL(S). MUST RESIST 200 LBS FORCE. REFER TO DETAIL 5/D3.
15	24" X 24" DECK COLUMN WITH FOAM OR WOOD CAP. REFER TO DETAIL 7/D3.

Revisions	Date
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ELEVATIONS MAIN HOUSE	
CVEAS JOB #:	
DATE:	4/24/2024
PLANNING SUBMITTAL #:	XX-XXXX
PLAN CHECK SUBMITTAL #:	XX-XXXX
DRAWN BY:	
CHECKED BY:	
SCALE:	

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- 329.25
ROOF APEX FROM FINISHED GRADE
- 32'-0"±
ROOF APEX FROM AFF
- 32'-2"±
ROOF APEX FROM GROUND
- 27'-1"
PLATE HGT AT FOYER TOWER
- 23'-9"
PLATE HGT AT FOYER - 2ND
- 23'-0"
OPENING HGT AT FOYER
- 12'-0"
PLATE HGT AT FOYER - 1ST
- 8'-0"
OPENING HGT
- 0'-0"
AFF - 1ST FLR
- 0'-4"
GROUND
- 297.08
FINISHED GRADE PER CIVIL PLANS



- 23'-9"
PLATE HGT - 2ND FLR TOWER
- 20'-3"
PLATE HGT - 2ND FLR
- 13'-0"
PLATE HGT AT GARAGE TOWER
- 12'-0"
PLATE HGT AT GARAGE
- 8'-0"
OPENING HGT - 1ST FLR
- 0'-2"
AFF - GARAGE FLR
- 0'-6"
GROUND
- 296.91
FINISHED GRADE PER CIVIL PLANS

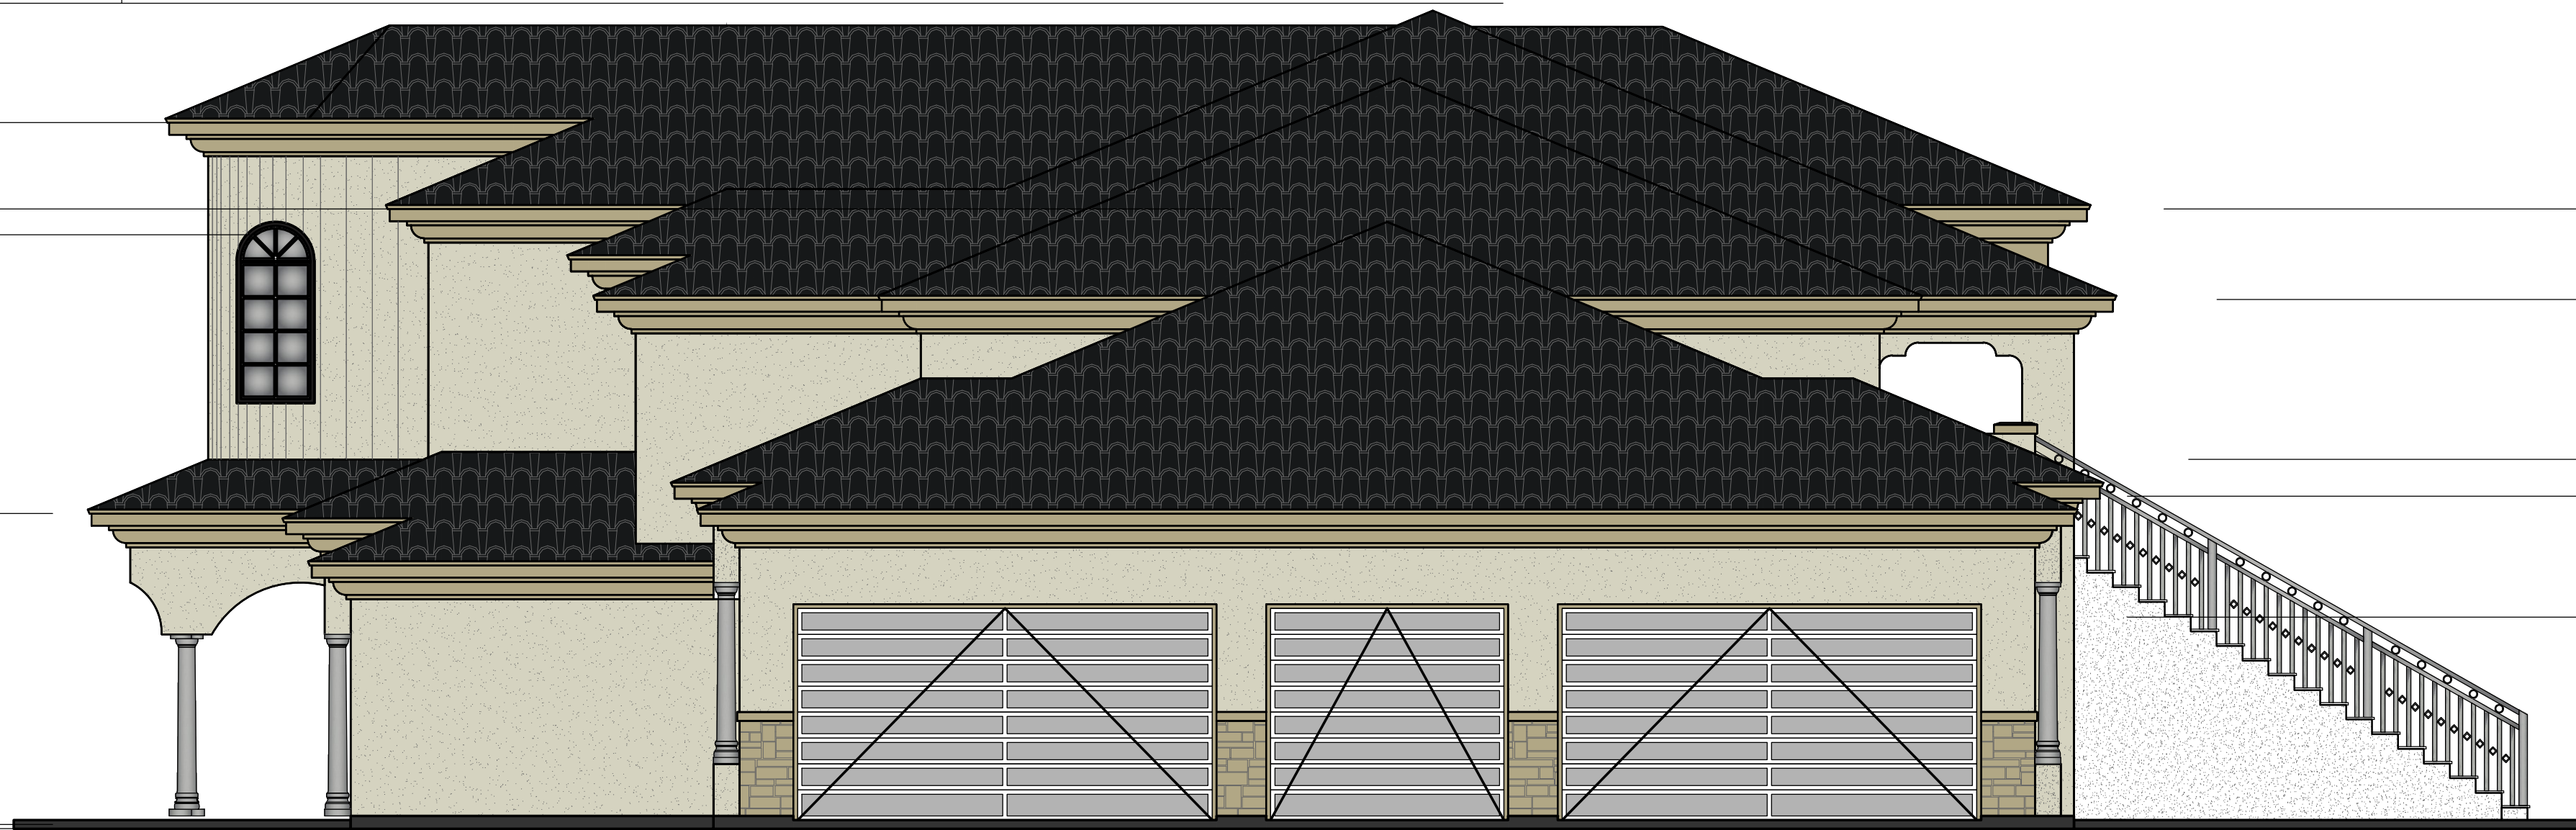RIGHT SIDE ELEVATION - NORTH

SCALE: 3/16" = 1'-0"

3

- 329.25
ROOF APEX FROM FINISHED GRADE
- 32'-0"±
ROOF APEX FROM AFF
- 32'-2"±
ROOF APEX FROM GROUND
- 23'-9"
PLATE HGT AT TOWER
- 20'-3"
PLATE HGT AT 2ND FLR
- 11'-0"
PLATE HGT AT TOWER
- 12'-0"
PLATE HGT AT GARAGE
- 8'-0"
OPENING HGT
- 0'-0"
AFF - 1ST FLR
- 0'-4"
GROUND
- 297.08
FINISHED GRADE PER CIVIL PLANS



- 23'-9"
PLATE HGT - 2ND FLR TOWER
- 20'-3"
PLATE HGT - 2ND FLR
- 18'-11"
OPENING HGT - 2ND FLR
- 11'-3"
AFF - 2ND FLR
- 10'-0"
PLATE HGT - 1ST FLR
- 8'-0"
OPENING HGT - 1ST FLR
- 0'-2"
AFF - GARAGE FLR
- 0'-6"
GROUND
- 296.91
FINISHED GRADE PER CIVIL PLANS

REAR ELEVATION - WEST

SCALE: 3/16" = 1'-0"

4

COLOR SCHEDULE

A		STUCCO #1: 3-LAYERED STUCCO FINISH COLOR - SATO14 - EIDER WHITE OR EQUAL
B		ROOFING MATERIAL: SPANISH TILE
C		STONE VENEER, EL DORADO STONE VANTAGE 30 COLOR - WHITE ELM
D		METAL SIDING, METAL CLADDING SYSTEM FLATLOCK, COLOR - MATTE BLACK STEEL OR EQUAL INSTALL PER MANUFACTURER'S SPECS AND INSTALLATION INSTRUCTIONS. REFER TO DETAILS ON D11.
E		CORNICE FINISH: SHERWIN WILLIAMS SATO20 COLOR - BLACK FOX OR EQUAL
F		TRIM FINISH: SHERWIN WILLIAMS SATO20 COLOR - BLACK FOX OR EQUAL

ELEVATION KEYED NOTES


1	3 COAT STUCCO SMOOTH FINISH #1 (4 COLORS): 1/8" MIN. THICKNESS OVER 1/2" X 1/2" HEXAGONAL PAPER BACKED WIRE LATH OVER 2-LAYERS OF TYPE "D" PAPER UNDER-LAYMENT OVER PLYWOOD.
2	REFER TO KEEP SCREED DETAIL 1/D1 FOR EXTERIOR WALLS. REFER TO KEEP SCREED DETAIL 2/D1 FOR STEM WALLS. REFER TO KEEP SCREED DETAILS 3/D1 FOR BOX COLUMN(S).
3	3 COAT STUCCO SMOOTH FINISH (UNDERSIDE CEILINGS): 1/8" MIN. THICKNESS OVER 1/2" X 1/2" HEXAGONAL PAPER BACKED WIRE LATH OVER 2-LAYERS OF TYPE "D" PAPER UNDER-LAYMENT OVER PLYWOOD.
4	DOOR OPENING - REFER TO DOOR SCHEDULE ON SHEET A3.3 AND DETAIL(S) ON SHEET D2.
5	WINDOW OPENING - REFER TO WINDOW SCHEDULE ON SHEET A3.3 AND DETAIL(S) ON SHEET D2.
6	ROOF MATERIAL - SPANISH TILES - INSTALL PER MANUFACTURER'S SPECS AND INSTRUCTIONS. REFER TO DETAILS ON SHEET D10.
7	FOAM CORNICE UNDER FASCIA. REFER TO DETAIL 8/D1.
8	DOUBLE FOAM TRIM. REFER TO DETAIL 8/D1.
9	STONE VENEER AND TRIM. REFER TO DETAIL 7/D1.
10	BUILT-UP CHIMNEY. REFER TO DETAIL 1, 2, AND 3/D8.
11	COMPOSITE COLUMN INSTALL PER MANUFACTURER'S SPECS AND INSTALLATION MANUAL.
12	2X FASCIA. REFER TO DETAIL 8/D1.
13	44" HIGH HALF WALL W/ STUCCO FINISHED. REFER STUCCO NOTE #1 ABOVE.
14	44" HIGH GUARD RAIL(S). MUST RESIST 200 LBS FORCE. REFER TO DETAIL 5/D3.
15	24" X 24" DECK COLUMN WITH FOAM OR WOOD CAP. REFER TO DETAIL 7/D3.

Revisions	Date
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△	
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△	

ELEVATIONS MAIN HOUSE
CVEAS JOB #:
DATE: 4/24/2024
PLANNING SUBMITTAL #: XX-XXXX
PLAN CHECK SUBMITTAL #: XX-XXXX
DRAWN BY:
CHECKED BY:
SCALE:

A2.1

ALL IDEAS, DESIGNS, ARRANGEMENTS AND PLANS INDICATED BY THIS DRAWING ARE OWNED BY AND THE PROPERTY OF CVEAS OR CONSULTANTS, AND WERE CREATED, EVOLVED AND DEVELOPED FOR USE ON AND IN CONNECTION WITH THE SPECIFIED PROJECT. NONE OF SUCH IDEAS, DESIGNS, ARRANGEMENTS OR PLANS SHALL BE REPRODUCED OR COPIED IN ANY MANNER WITHOUT THE WRITTEN PERMISSION OF CVEAS. ANY REPRODUCTION OR COPIING OF THIS DRAWING WITHOUT THE WRITTEN PERMISSION OF CVEAS IS PROHIBITED. ANY REPRODUCTION OR COPIING OF THIS DRAWING WITHOUT THE WRITTEN PERMISSION OF CVEAS IS PROHIBITED. ANY REPRODUCTION OR COPIING OF THIS DRAWING WITHOUT THE WRITTEN PERMISSION OF CVEAS IS PROHIBITED.

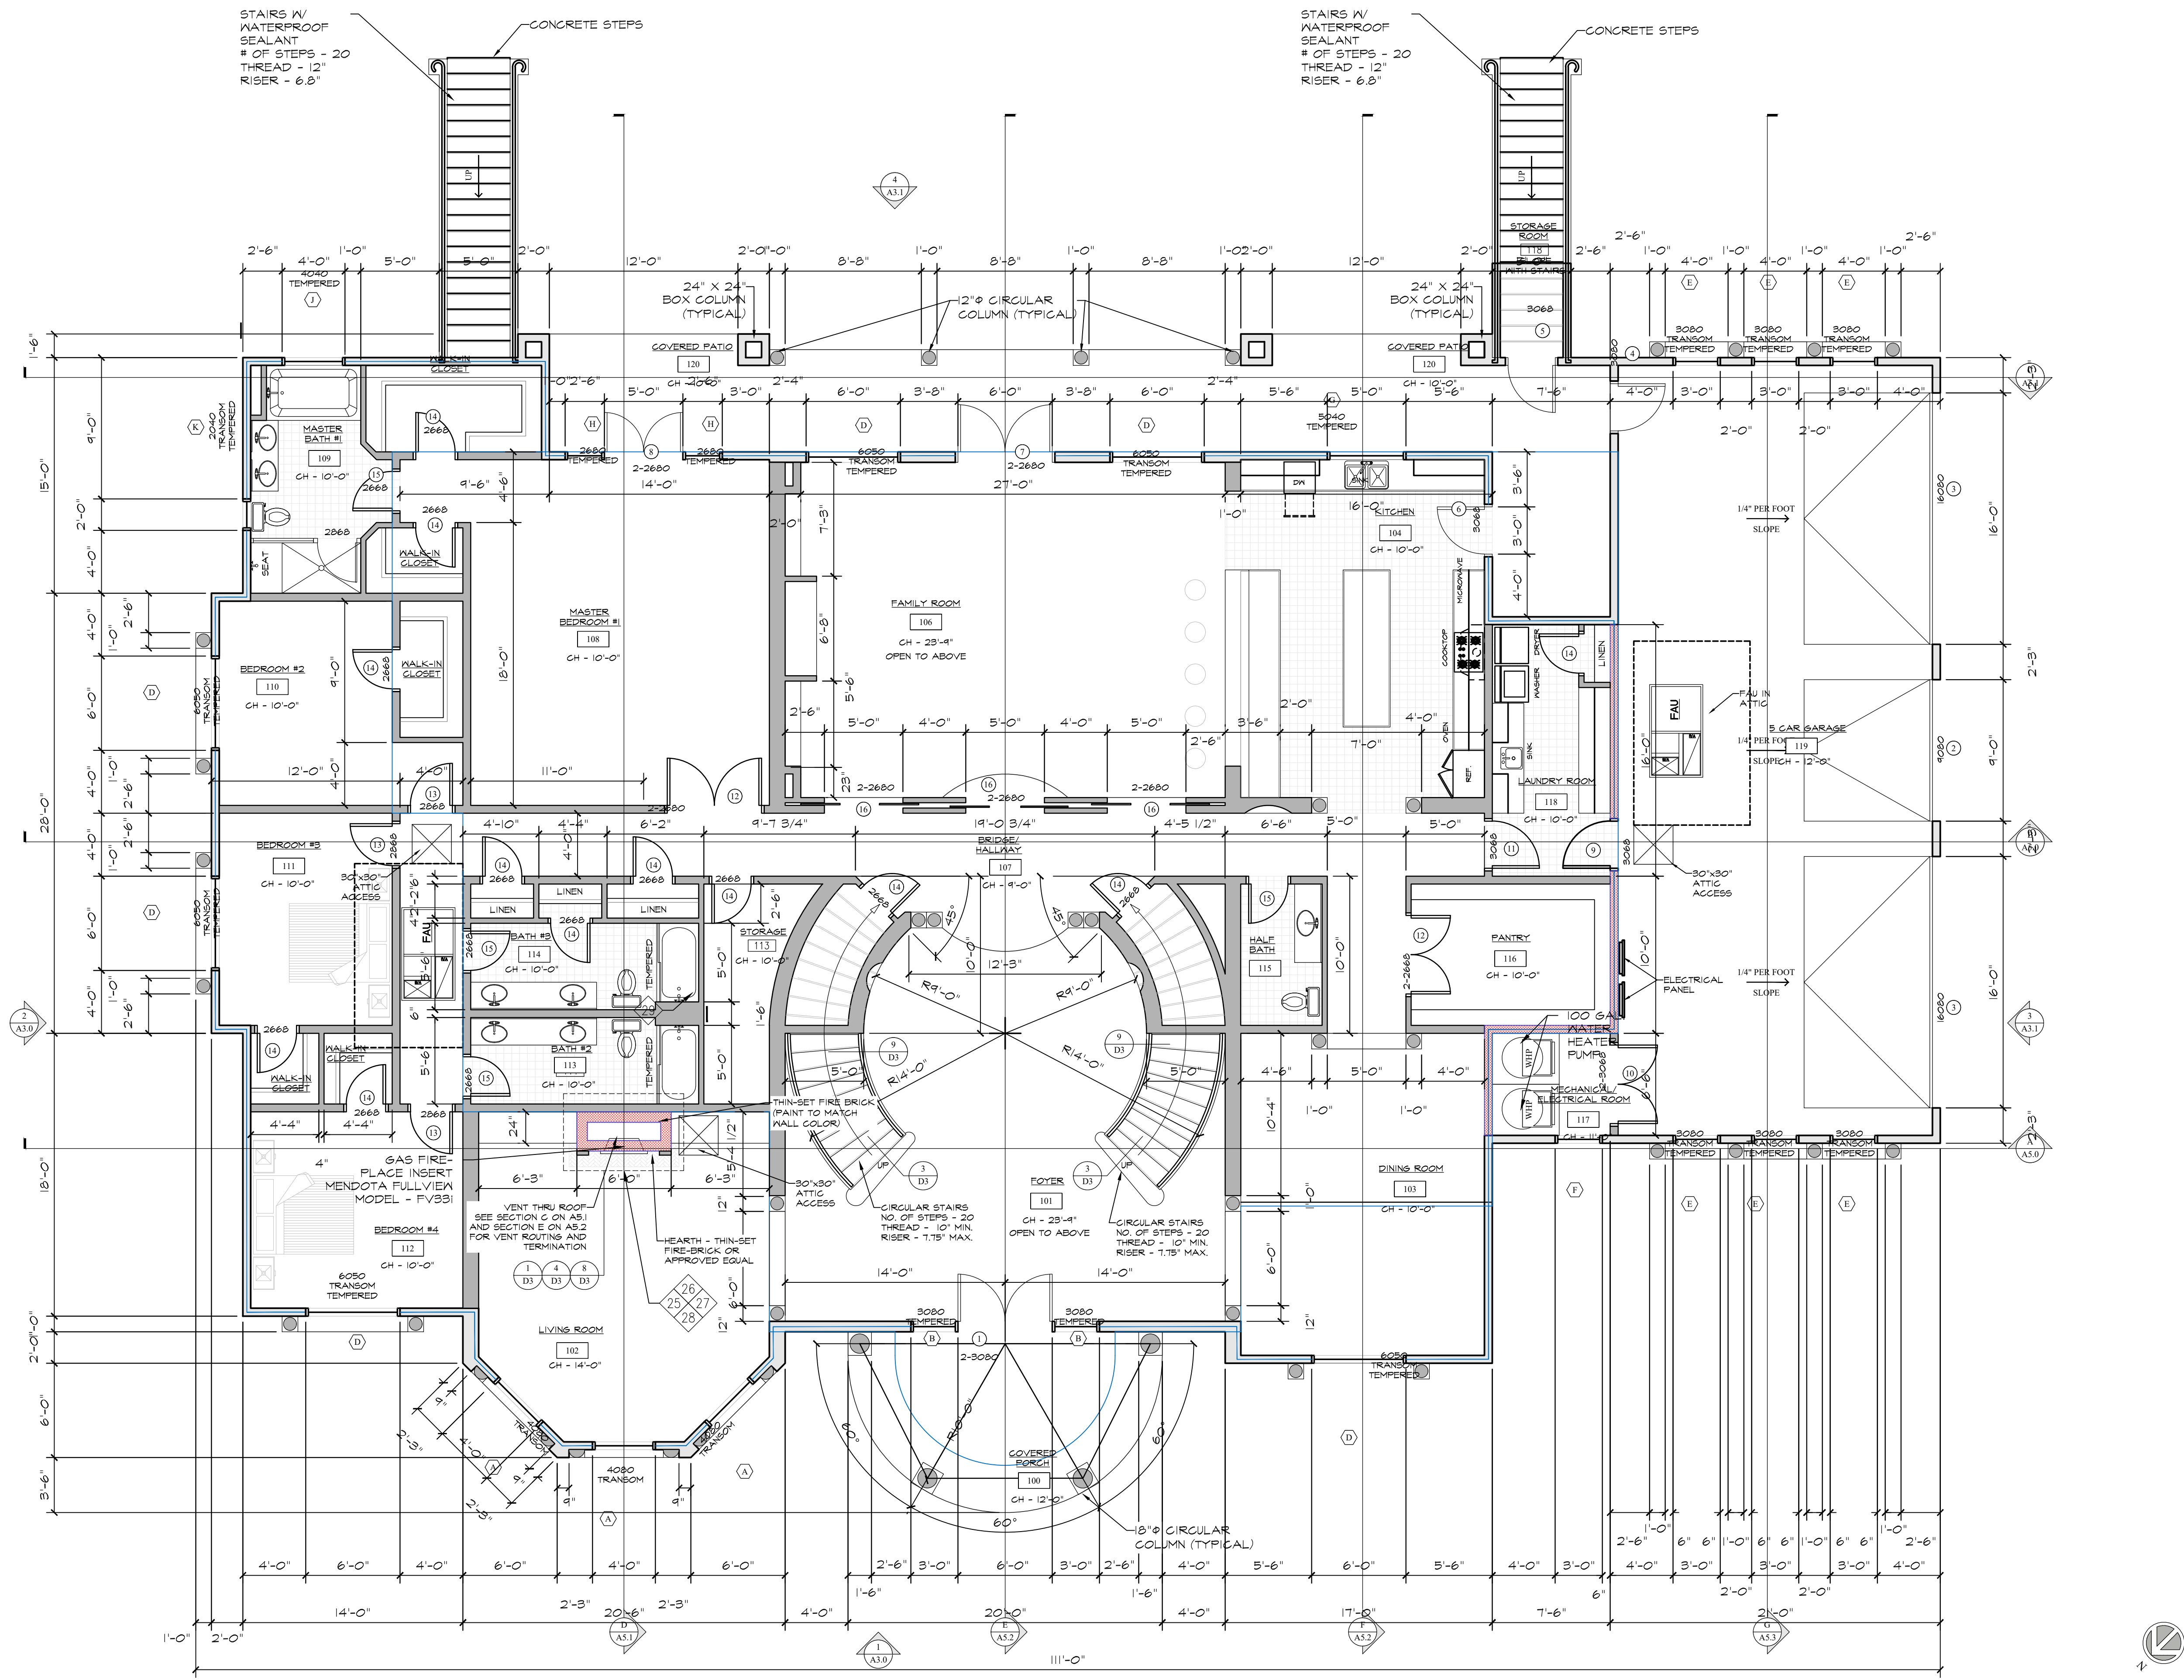

FLOOR PLAN - 1ST FLOOR
SCALE: 3/16" = 1'-0"

INSULATION LEGEND	
DESCRIPTION	TYPE
WALL INSULATION	R-19
ROOF INSULATION	R-30

- ### GENERAL NOTES
- INSTALL 12-INCH HIGH ADDRESS POSTING FROM THE STREET. THE SIGN SHALL BE TACTILE WITH SUITE NUMBERS IN RAISED NUMBERS AND BRAILLE AT THE MAIN ENTRY.
 - THERE SHALL BE NO VERTICAL OFFSET GREATER THAN 1/2 INCH ALONG THE ENTIRE PATH OF TRAVEL FROM THE PUBLIC WAY.
 - FINGER JOINTED STUDS IN STRUCTURAL WALLS (BEARING OR SHEAR) SHALL BE APPROVED AND ARE NOT ALLOWED IN HOLDOWN LOCATIONS.
 - PROVIDE THE FOLLOWING FOR FLOORS AND WALLS IN WATER CLOSET COMPARTMENTS AND SHOWERS:
 - FLOORS: TOILET ROOM FLOORS SHALL HAVE A SMOOTH, HARD ABSORBENT SURFACE SUCH AS PORTLAND CEMENT, CONCRETE, CERAMIC TILE OR OTHER APPROVED MATERIAL THAT EXTENDS UPWARD ONTO THE WALLS AT LEAST 5 INCHES.
 - WALLS: WALLS WITHIN 2 FEET OF THE FRONT AND SIDES OF URINALS AND WATER CLOSETS SHALL HAVE SMOOTH, HARD ABSORBENT SURFACE OF PORTLAND CEMENT, CONCRETE, CERAMIC TILE OR OTHER SMOOTH, HARD NON-ABSORBENT SURFACE TO A HEIGHT OF 4 FEET. THE MATERIALS USED IN SUCH WALLS SHALL BE OF A TYPE THAT IS NOT ADVERSELY AFFECTED BY MOISTURE.
 - ACCESSORIES PROVIDED ON OR WITHIN RESTROOM WALLS SHALL BE INSTALLED AND SEALED TO PROTECT THE STRUCTURAL ELEMENTS FROM MOISTURE.
 - FASTENERS IN PRESERVATIVE-TREATED WOOD SHALL BE APPROVED SILICON BRONZE OR COPPER, STAINLESS STEEL OR HOT-DIPPED ZINC-COATED GALVANIZED STEEL.
 - ALL FINISHED MATERIALS (ADHESIVE, SEALANTS, CAULKS, PAINTS, CARPETS, RESILIENT FLOORING, COMPOSITE WOOD PRODUCTS) SHALL COMPLY WITH CAL-GREEN 5.50.4.
 - THIS PROJECT HAS BEEN DESIGNATED WITH A UNIFORM LOAD OF 15 POUNDS PER SQUARE-FOOT TO SUPPORT THE ADDED LOADS OF A FIRE-SPRINKLER SYSTEM. THE MAIN FRAMING MEMBERS HAVE BEEN DESIGNED TO SUPPORT THE CONCENTRATED LOADS OF A SPRINKLER SYSTEM.
 - PROVIDE FIRE BLOCKING AT ALL FLOOR AND CEILING LEVELS AND AT TEN-FOOT INTERVALS.
 - THE ATTIC ACCESS SHALL BE WEATHER STRIPPED & INSULATED TO R-30, ON THE ACCESS PANEL.
 - CEILING HEIGHT SHALL BE 8'-0" MIN. UNLESS NOTED OTHERWISE.
 - 1/2" SHEET ROCK @ ALL WALLS, CEILINGS, AND GARAGE. FOR NAILING, REFER TO NAILING SCHEDULE ON SHEET -----.
 - ALL WEATHER STRIPPING, CAULKING, AND SEALING OF EXTERIOR DOOR(S), WINDOW(S), AND BUILDING ENVELOPE OPENINGS, AS REQUIRED BY STANDARDS. SHALL BE SUBJECT FIELD INSPECTION.
 - OPEN-ABLE WINDOW AREA SHALL BE GREATER THAN OR EQUAL TO ONE-SIXTEENTH (1/16) OF THE FLOOR AREA. (CBC 1203.3).
 - POWER DRIVEN FASTENERS RAMJET PINS NO. 3930 @ BEARING WALLS 18" O.C. & NON-BEARING WALLS.
 - ALL WINDOW/DOOR FLASHING REFER TO FLASHING DETAIL #1 ON SHEET D1.
 - PROVIDE A 12"x12" MIN. OPENING FOR TUB EQUIPMENT ACCESS PANEL.
 - SHOWERS MUST HAVE THE FOLLOWING:
 - A MIN. INSIDE CLEAR DIMENSION OF 30 INCHES WITHIN A MINIMUM TOTAL AREA OF 1024 SQ. IN.
 - MUST HAVE WATERPROOF WALL FINISH UP @ 10 INCHES ABOVE THE SHOWER DRAIN.
 - SHOWER CURTAINS OR ENCLOSURES ARE REQUIRED.
 - SHOWER DOORS MUST BE AT LEAST 22 INCHES WIDE.
 - PROVIDE A PEDESTRIAN EXIT FROM THE GARAGE OF THE SIZE TO PERMIT THE INSTALLATION OF A 36"x80" DOOR AND THE HARDWARE MAY NOT BE LOCKABLE.
 - PROVIDE 5/8" TYPE "X" GYPSUM BOARD ON GARAGE SIDE OF FIREWALL BETWEEN THE GARAGE AND THE DWELLING UNIT AND ITS ATTIC FROM FLOOR TO ROOF. SHEATHING: PROVIDE 5/8" TYPE "X" GYPSUM BOARD ON GARAGE SIDE OF THE CEILING/FLOOR SYSTEM WHEN THERE IS HABITABLE AREA ABOVE GARAGE. THE FIRE BARRIER MAY TERMINATE AT THE CEILING WHERE FIRE BARRIER IS HORIZONTAL AND ALL STRUCTURAL JOINTS/WEBSHIMS SUPPORT FIRE BARRIER ARE PROTECTED BY FIRE RESISTANT CONSTRUCTION NOT LESS THAN 5/8" GYPSUM BOARD OR EQUIVALENT.
 - ALL DROP-IN TUBS SHALL BE JETTED OR SOAKING TUB ONLY.
 - UPPER CABINETS SHALL BE A MINIMUM OF 18 INCHES ABOVE FINISHED DECK OR THE HOOD IS TO BE INSTALLED PER MANUFACTURER'S REQUIREMENTS WITH CLEARANCES AS REQUIRED BY THE RANGE/COOKTOP MANUFACTURER'S INSTALLATION INSTRUCTIONS.
 - ALL GLASS IN DOORS MUST BE LABELED SAFETY GLASS OR TEMPERED GLASS.
 - ALL TUB/SHOWER ENCLOSURE AND GLAZING WITHIN 60 INCHES FROM BOTTOM OF TUB/SHOWER MUST BE LABELED SAFETY GLASS OR TEMPERED GLASS.
 - GAS APPLIANCE INSERT WITH STANDING PILOT SHALL COMPLY WITH TABLE 4-2 OF THE 2023 CBC.
 - PROVIDE MANUFACTURER'S INSTALLATION INSTRUCTIONS AT JOB SITE FOR INSPECTION FOR THE FIREPLACE/WOODSTOVE.
 - PROPANE LOG LIGHTERS ARE NOT ALLOWED.
 - WOOD-BURNING, OPEN-HEARTH FIREPLACES (WHICH INCLUDES ALL SOLID-FUEL, WOOD-BURNING FIREPLACES, FIRE-PITS, AND BARBECUES) ARE NOT ALLOWED IF PROPERTY IS BELOW 3000 FEET IN ELEVATION.
 - SHOWER DOORS MUST BE AT LEAST 32 INCHES IN WIDTH.

WALL LEGEND

	NEW EXTERIOR WALL - 2x6 DFR2 WOOD STUD WALL @ 16" O.C. EXTERIOR SIDE - 3-LAYERED STUCCO FINISH 1/8" MIN THICKNESS OVER 1/2" GA. X 1/2" HEXAGONAL PAPER-BACKED WIRE LATH OVER 2-LAYERS OF TYPE "D" PAPER UNDER-LAYMENT OVER FLYWOOD. INTERIOR SIDE - 1/2" GYPSUM BD. INSULATION - R-19 REFER TO T24 FOR ADDTNL INFO.
	NEW 1 HOUR FIRE-RATED WALL - 2x6 DFR2 WOOD STUD WALL @ 16" O.C. EACH SIDE - 5/8" GYPSUM TYPE "X" CEILING - 1/2" GYPSUM BD. INSULATION - R-19 REFER TO T24 FOR ADDTNL INFO.
	NEW DOUBLE EXTERIOR WALL - 2x6 DFR2 WOOD STUD WALL @ 16" O.C. EXTERIOR SIDE - 3-LAYERED STUCCO FINISH 1/8" MIN THICKNESS OVER 1/2" GA. X 1/2" HEXAGONAL PAPER-BACKED WIRE LATH OVER 2-LAYERS OF TYPE "D" PAPER UNDER-LAYMENT OVER FLYWOOD. INTERIOR SIDE - 1/2" GYPSUM BD. INSULATION - R-19 REFER TO T24 FOR ADDTNL INFO.
	NEW INTERIOR WALL - 2x4 DFR2 WOOD STUD WALL @ 16" O.C. EACH SIDE - 1/2" GYPSUM BD.
	NEW INTERIOR WALL - 2x6 DFR2 WOOD STUD WALL @ 16" O.C. EACH SIDE - 1/2" GYPSUM BD.
	NEW DOUBLE INTERIOR WALL - 2x6 DFR2 WOOD STUD WALL @ 16" O.C. EACH SIDE - 1/2" GYPSUM BD.
	NEW 1 HOUR FIRE-RATED GARAGE WALL - 2x6 DFR2 WOOD STUD WALL @ 16" O.C. GARAGE SIDE - 5/8" GYPSUM TYPE "X" DWELLING SIDE - 5/8" GYPSUM BD. CEILING - 5/8" GYPSUM TYPE "X" ON CEILING IF HABITABLE SPACE ABOVE. INSULATION - R-19 REFER TO T24 FOR ADDTNL INFO.

CVEAS
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2511 LOGAN STREET Tel: (559) 841-8811
SELMA, CA 93662 Fax: (559) 841-8815
WWW.CVEAS.COM Email: info@cveas.com

PROJECT

NEW SINGLE FAMILY RESIDENCE FOR:
GURDEEP DHADWAL
PALM AVE AND DOUGHERTY AVE
MORGAN HILLS, CA 95037
APN: 712-27-043

DATE SIGNED: 5/9/2024

Revisions	Date

FLOOR PLAN
FIRST FLOOR

CVEAS JOB #:

DATE: 5/9/2024

PLANNING SUBMITTAL #: XX-XXXX

PLAN CHECK SUBMITTAL #: XX-XXXX

DRAWN BY:

CHECKED BY:

SCALE:

A3.0

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BLOCK AREA PLAN
FIRST FLOOR

CVEAS JOB #:

DATE: 5/9/2024

PLANNING SUBMITTAL #:


PLAN CHECK SUBMITTAL #:	XX-XXXX
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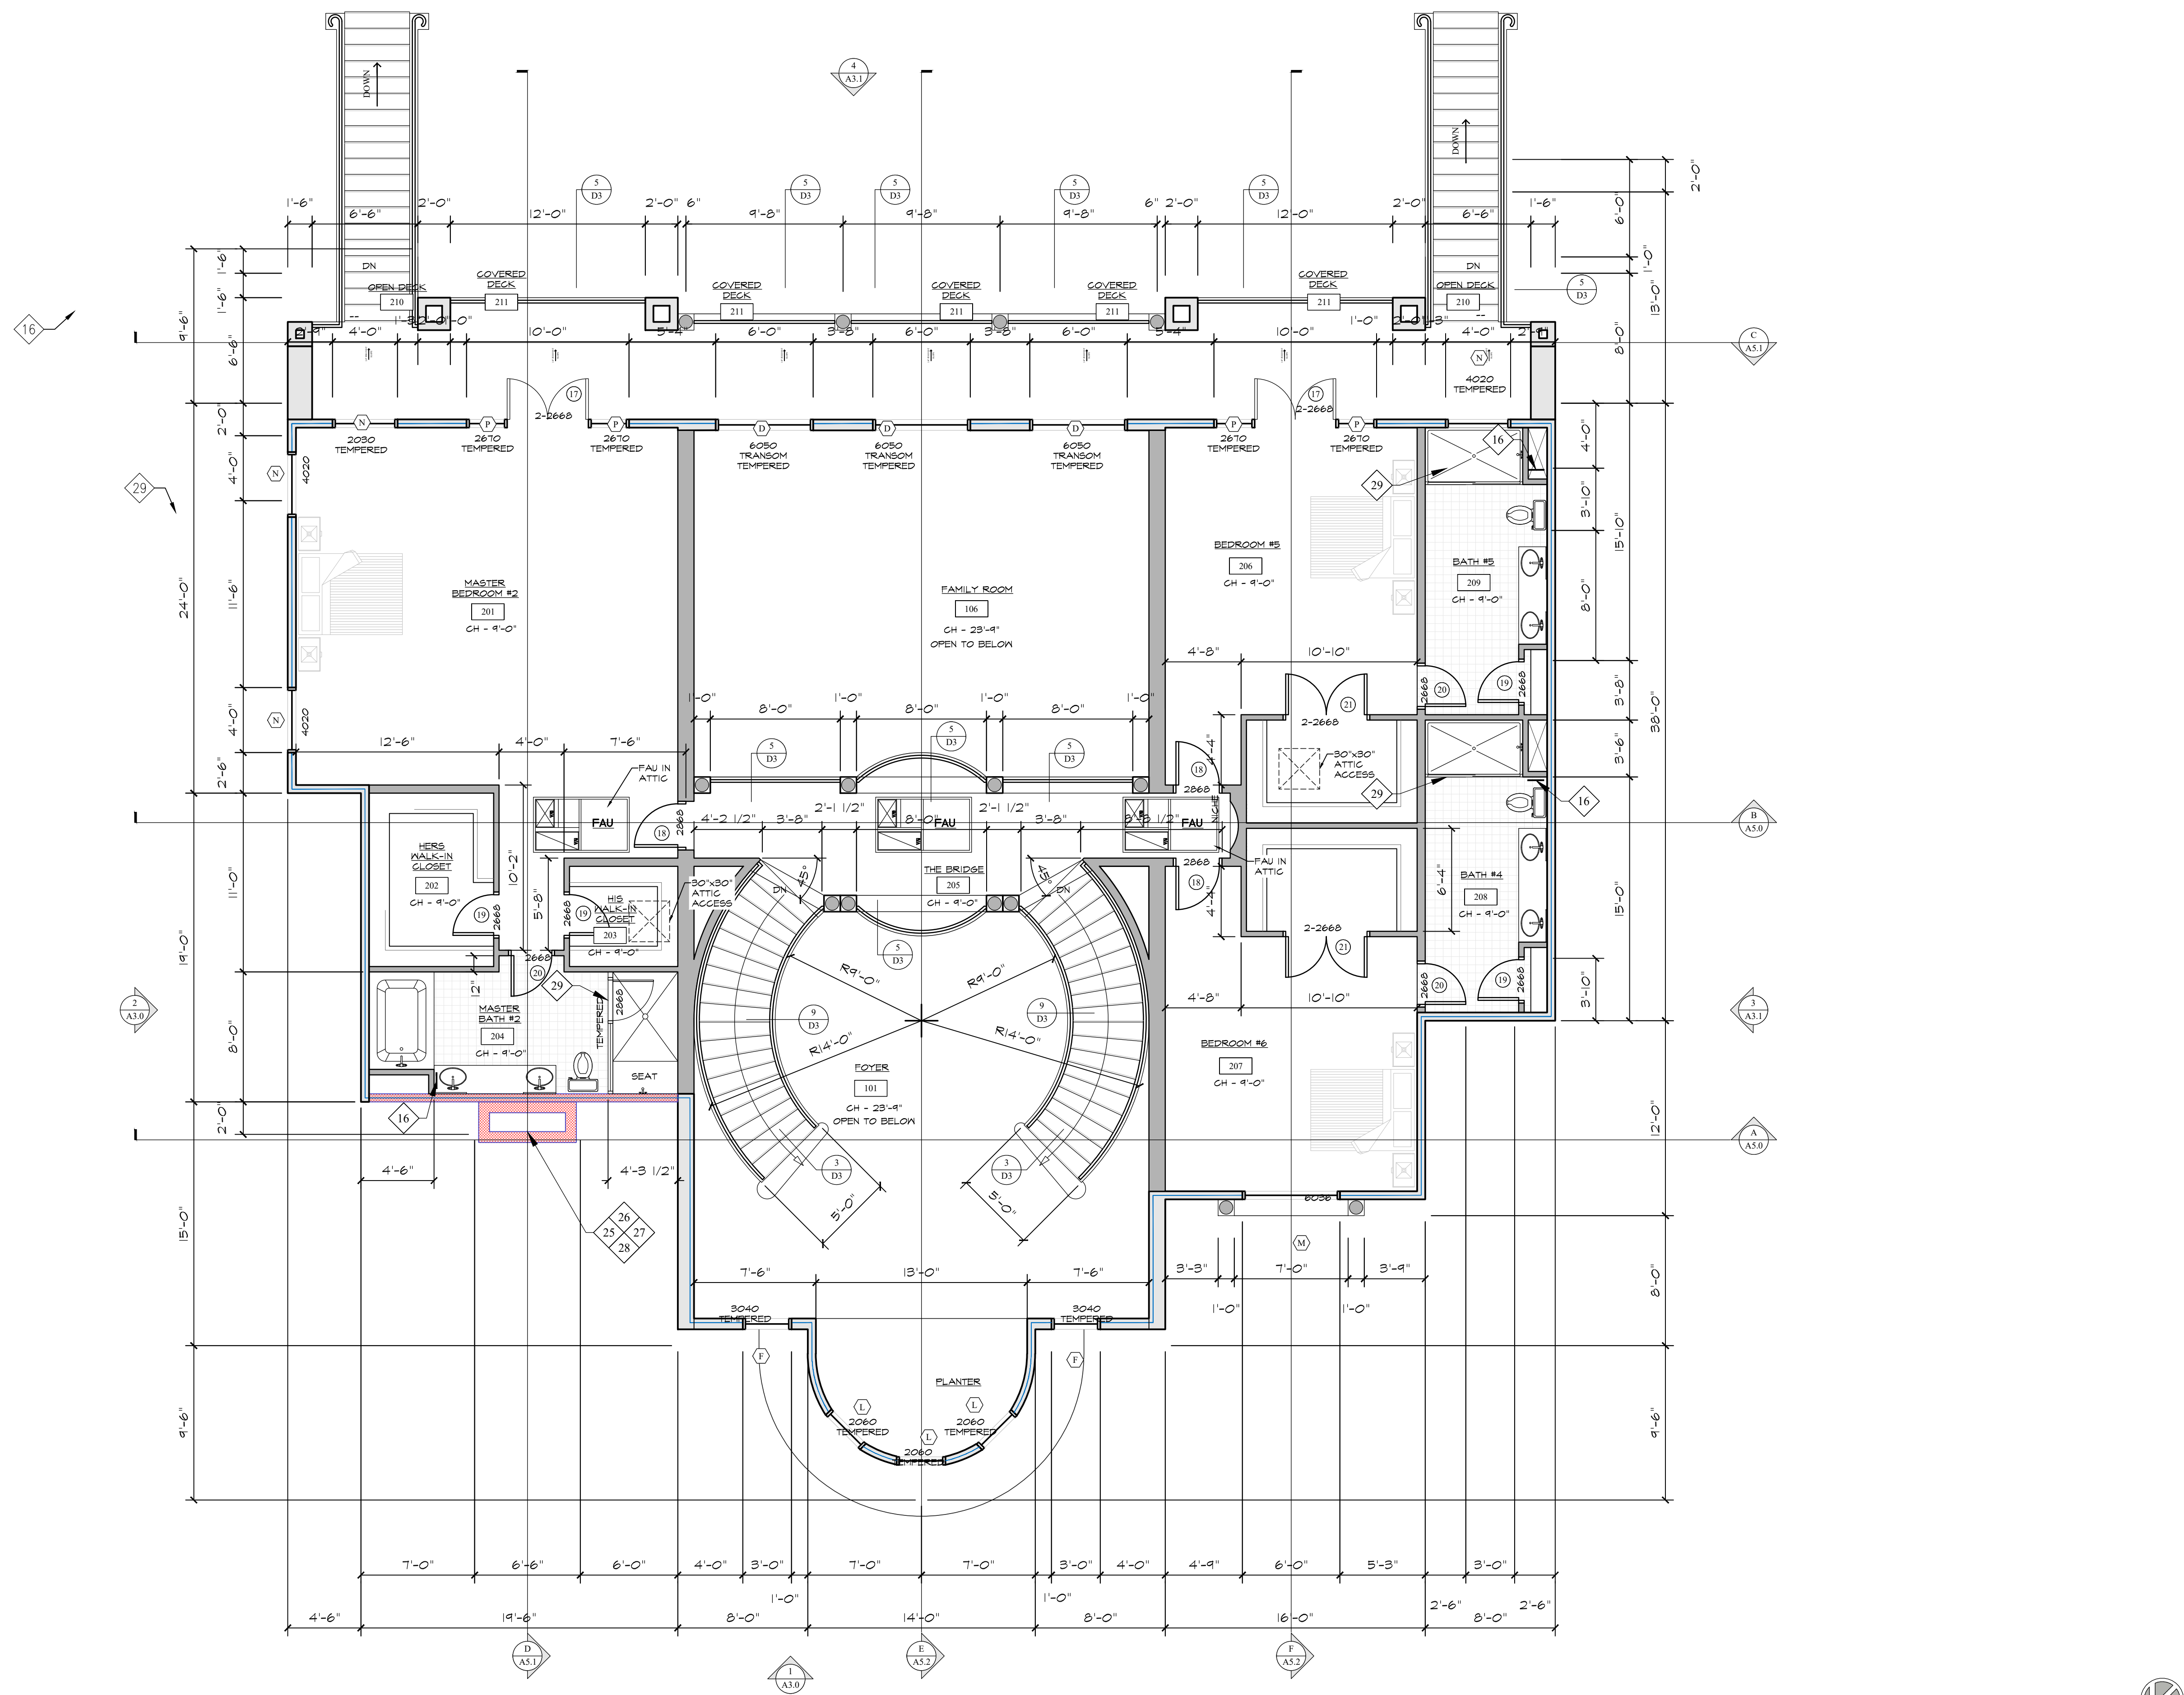
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SCALE:

A3.0A



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FLOOR PLAN - SECOND FLOOR
SCALE: 3/16" = 1'-0"

INSULATION LEGEND	
DESCRIPTION	TYPE
WALL INSULATION	R-19
ROOF INSULATION	R-38

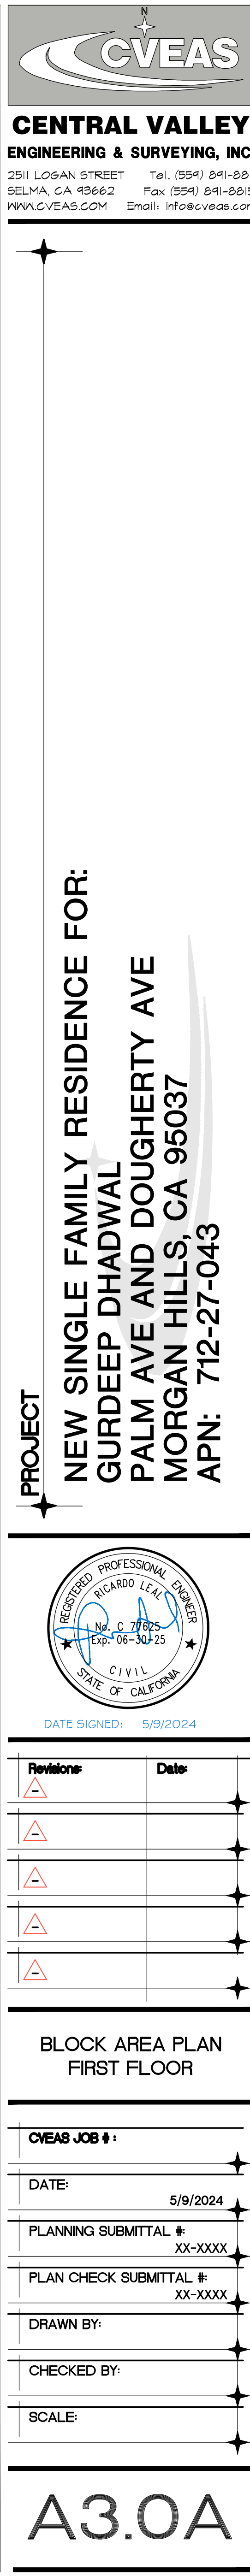SITE DATA	
PARCEL # (340-051-07):	7,480.3 SF
CUSTOM SINGLE FAMILY RESIDENCE (BOTH FLOORS):	5,144.0 SF
1ST FLOOR:	2,331.3 SF
2ND FLOOR:	1,155.2 SF
5-CAR GARAGE:	187.1 SF
COVERED PORCH:	681.8 SF
COVERED PATIO:	559.0 SF
COVERED DECK:	313.2 SF
STAIR CASES:	128.0 SF
OPEN DECK:	7,486.3 SF
TOTAL CUSTOM SFR GROUND COVER:	7,500.0 SF
COTYOTE VALLEY CLIMATE RESILIENCE COMBING DISTRICT (COVERED)	
TOTAL LOT COVERAGE REQUIREMENT:	

- ### GENERAL NOTES
- INSTALL 12-INCH HIGH ADDRESS POSTING FROM THE STREET. THE SIGN SHALL BE TACTILE WITH SUITE NUMBERS IN RAISED NUMBERS AND BRAILLE AT THE MAIN ENTRY.
 - THERE SHALL BE NO VERTICAL OFFSET GREATER THAN 1/2 INCH ALONG THE ENTIRE PATH OF TRAVEL FROM THE PUBLIC WAY.
 - FINGER JOINTED STUDS IN STRUCTURAL WALLS (BEARING OR SHEAR) SHALL BE APPROVED AND ARE NOT ALLOWED IN HOLDOWN LOCATIONS.
 - PROVIDE THE FOLLOWING FOR FLOORS AND WALLS IN WATER CLOSET COMPARTMENTS AND SHOWERS:
 - FLOORS: TOILET ROOM FLOORS SHALL HAVE A SMOOTH, HARD ABSORBENT SURFACE SUCH AS PORTLAND CEMENT, CONCRETE, CERAMIC TILE OR OTHER APPROVED MATERIAL THAT EXTENDS UPWARD ONTO THE WALLS AT LEAST 5 INCHES.
 - WALLS: WALLS WITHIN 2 FEET OF THE FRONT AND SIDES OF URINALS AND WATER CLOSETS SHALL HAVE SMOOTH, HARD ABSORBENT SURFACE OF PORTLAND CEMENT, CONCRETE, CERAMIC TILE OR OTHER SMOOTH, HARD NON-ABSORBENT SURFACE TO A HEIGHT OF 4 FEET. THE MATERIALS USED IN SUCH WALLS SHALL BE OF A TYPE THAT IS NOT ADVERSELY AFFECTED BY MOISTURE.
 - ACCESSORIES PROVIDED ON OR WITHIN RESTROOM WALLS SHALL BE INSTALLED AND SEALED TO PROTECT THE STRUCTURAL ELEMENTS FROM MOISTURE.
 - FASTENERS IN PRESERVATIVE-TREATED WOOD SHALL BE APPROVED SILICON BRONZE OR COPPER, STAINLESS STEEL OR HOT-DIPPED ZINC-COATED GALVANIZED STEEL.
 - ALL FINISHED MATERIALS (ADHESIVE, SEALANTS, CAULKS, PAINTS, CARPETS, RESILIENT FLOORING, COMPOSITE WOOD PRODUCTS) SHALL COMPLY WITH CAL-GREEN 5.504.4.
 - THIS PROJECT HAS BEEN DESIGNATED WITH A UNIFORM LOAD OF 15 POUNDS PER SQUARE-FOOT TO SUPPORT THE ADDED LOADS OF A FIRE-SPRINKLER SYSTEM. THE MAIN FRAMING MEMBERS HAVE BEEN DESIGNED TO SUPPORT THE CONCENTRATED LOADS OF A SPRINKLER SYSTEM.
 - PROVIDE FIRE BLOCKING AT ALL FLOOR AND CEILING LEVELS AND AT TEN-FOOT INTERVALS.
 - THE ATTIC ACCESS SHALL BE WEATHER STRIPPED & INSULATED TO R-38, ON THE ACCESS PANEL.
 - CEILING HEIGHT SHALL BE 8'-0" MIN, UNLESS NOTED OTHERWISE.
 - 1/2" SHEET ROCK @ ALL WALLS, CEILINGS, AND GARAGE. FOR NAILING, REFER TO NAILING SCHEDULE ON SHEET -----.
 - ALL WEATHER STRIPPING, CAULKING, AND SEALING OF EXTERIOR DOOR(S), WINDOW(S), AND BUILDING ENVELOPE OPENINGS, AS REQUIRED BY STANDARDS, SHALL BE SUBJECT FIELD INSPECTION.
 - OPEN-ABLE WINDOW AREA SHALL BE GREATER THAN OR EQUAL TO ONE-SIXTEENTH (1/16) OF THE FLOOR AREA. (CBC 1203.3).
 - POWER DRIVEN FASTENERS RAMJET PINS NO. 3930 @ BEARING WALLS 18" O.C. & NON-BEARING WALLS.
 - ALL WINDOW/DOOR FLASHING REFER TO FLASHING DETAIL #1 ON SHEET D1.
 - PROVIDE A 12"x12" MIN. OPENING FOR TUB EQUIPMENT ACCESS PANEL.
 - SHOWERS MUST HAVE THE FOLLOWING:
 - A MIN. INSIDE CLEAR DIMENSION OF 30 INCHES WITHIN A MINIMUM TOTAL AREA OF 1024 SQ. IN.
 - MUST HAVE WATERPROOF WALL FINISH UP @ 10 INCHES ABOVE THE SHOWER DRAIN.
 - SHOWER CURTAINS OR ENCLOSURES ARE REQUIRED.
 - SHOWER DOORS MUST BE AT LEAST 22 INCHES WIDE.
 - PROVIDE A PEDESTRIAN EXIT FROM THE GARAGE OF THE SIZE TO PERMIT THE INSTALLATION OF A 36"x80" DOOR AND THE HARDWARE MAY NOT BE LOCKABLE.
 - PROVIDE 5/8" TYPE 'X' GYPSUM BOARD ON GARAGE SIDE OF FIREWALL BETWEEN THE GARAGE AND THE DWELLING UNIT AND ITS ATTIC FROM FLOOR TO ROOF. SHEATHING: PROVIDE 5/8" TYPE 'X' GYPSUM BOARD ON GARAGE SIDE OF THE CEILING/FLOOR SYSTEM WHEN THERE IS HABITABLE AREA ABOVE GARAGE. THE FIRE BARRIER MAY TERMINATE AT THE CEILING WHERE FIRE BARRIER IS HORIZONTAL AND ALL STRUCTURAL MEMBERS THAT SUPPORT FIRE BARRIER ARE PROTECTED BY FIRE RESISTANT CONSTRUCTION NOT LESS THAN 5/8" GYPSUM BOARD OR EQUIVALENT.
 - ALL DROP-IN TUBS SHALL BE JETTED OR SOAKING TUB ONLY.
 - UPPER CABINETS SHALL BE A MINIMUM OF 18 INCHES ABOVE FINISHED DECK OR THE HOOD IS TO BE INSTALLED PER MANUFACTURER'S REQUIREMENTS WITH CLEARANCES AS REQUIRED BY THE RANGE/COOKTOP MANUFACTURER'S INSTALLATION INSTRUCTIONS.
 - ALL GLASS IN DOORS MUST BE LABELED SAFETY GLASS OR TEMPERED GLASS.
 - ALL TUB/SHOWER ENCLOSURE AND GLAZING WITHIN 60 INCHES FROM BOTTOM OF TUB/SHOWER MUST BE LABELED SAFETY GLASS OR TEMPERED GLASS.
 - GAS APPLIANCE INSERT WITH STANDING PILOT SHALL COMPLY WITH TABLE 4-2 OF THE 2023 CBC.
 - PROVIDE MANUFACTURER'S INSTALLATION INSTRUCTIONS AT JOB SITE FOR INSPECTION FOR THE FIREPLACE/WOODSTOVE.
 - PROPANE LOG LIGHTERS ARE NOT ALLOWED.
 - WOOD-BURNING, OPEN-HEARTH FIREPLACES (WHICH INCLUDES ALL SOLID-FUEL, WOOD-BURNING FIREPLACES, FIRE-PITS, AND BARBEQUES) ARE NOT ALLOWED IF PROPERTY IS BELOW 3000 FEET IN ELEVATION.
 - SHOWER DOORS MUST BE AT LEAST 32 INCHES IN WIDTH.

WALL LEGEND

	NEW EXTERIOR WALL - 2x6 DF#2 WOOD STUD WALL @ 16" O.C. EXTERIOR SIDE - 3-LAYERED STUCCO FINISH 7/8" MIN THICKNESS OVER 1" GA. X 1/2" HEXAGONAL PAPER-BACKED WIRE LATH OVER 2-LAYERS OF TYPE 'D' PAPER UNDER-LAYMENT OVER PLYWOOD. INTERIOR SIDE - 1/2" GYPSUM BD. INSULATION - R-19 REFER TO T24 FOR ADDTNL INFO.
	NEW 1 HOUR FIRE-RATED WALL - 2x6 DF#2 WOOD STUD WALL @ 16" O.C. EACH SIDE - 5/8" GYPSUM TYPE 'X' CEILING - 1/2" GYPSUM BD. INSULATION - R-19 REFER TO T24 FOR ADDTNL INFO.
	NEW DOUBLE EXTERIOR WALL - 2x6 DF#2 WOOD STUD WALL @ 16" O.C. EXTERIOR SIDE - 3-LAYERED STUCCO FINISH 7/8" MIN THICKNESS OVER 1" GA. X 1/2" HEXAGONAL PAPER-BACKED WIRE LATH OVER 2-LAYERS OF TYPE 'D' PAPER UNDER-LAYMENT OVER PLYWOOD. INTERIOR SIDE - 1/2" GYPSUM BD. INSULATION - R-19 REFER TO T24 FOR ADDTNL INFO.
	NEW INTERIOR WALL - 2x4 DF#2 WOOD STUD WALL @ 16" O.C. EACH SIDE - 1/2" GYPSUM BD.
	NEW INTERIOR WALL - 2x6 DF#2 WOOD STUD WALL @ 16" O.C. EACH SIDE - 1/2" GYPSUM BD.
	NEW DOUBLE INTERIOR WALL - 2x6 DF#2 WOOD STUD WALL @ 16" O.C. EACH SIDE - 1/2" GYPSUM BD.
	NEW 1 HOUR FIRE-RATED GARAGE WALL - 2x6 DF#2 WOOD STUD WALL @ 16" O.C. GARAGE SIDE - 5/8" GYPSUM TYPE 'X' DWELLING SIDE - 5/8" GYPSUM BD. CEILING - 5/8" GYPSUM TYPE 'X' ON CEILING IF HABITABLE SPACE ABOVE. INSULATION - R-19 REFER TO T24 FOR ADDTNL INFO.

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SELMA, CA 93662 Fax: (559) 841-8815
WWW.CVEAS.COM Email: info@cveas.com

PROJECT
NEW SINGLE FAMILY RESIDENCE FOR:
GURDEEP DHADWAL
PALM AVE AND DOUGHERTY AVE
MORGAN HILLS, CA 95037
APN: 712-27-043

DATE SIGNED: 4/24/2024

Revisions	Date

FLOOR PLAN
SECOND FLOOR

CVEAS JOB #:

DATE: 4/24/2024

PLANNING SUBMITTAL #: XX-XXXX

PLAN CHECK SUBMITTAL #: XX-XXXX



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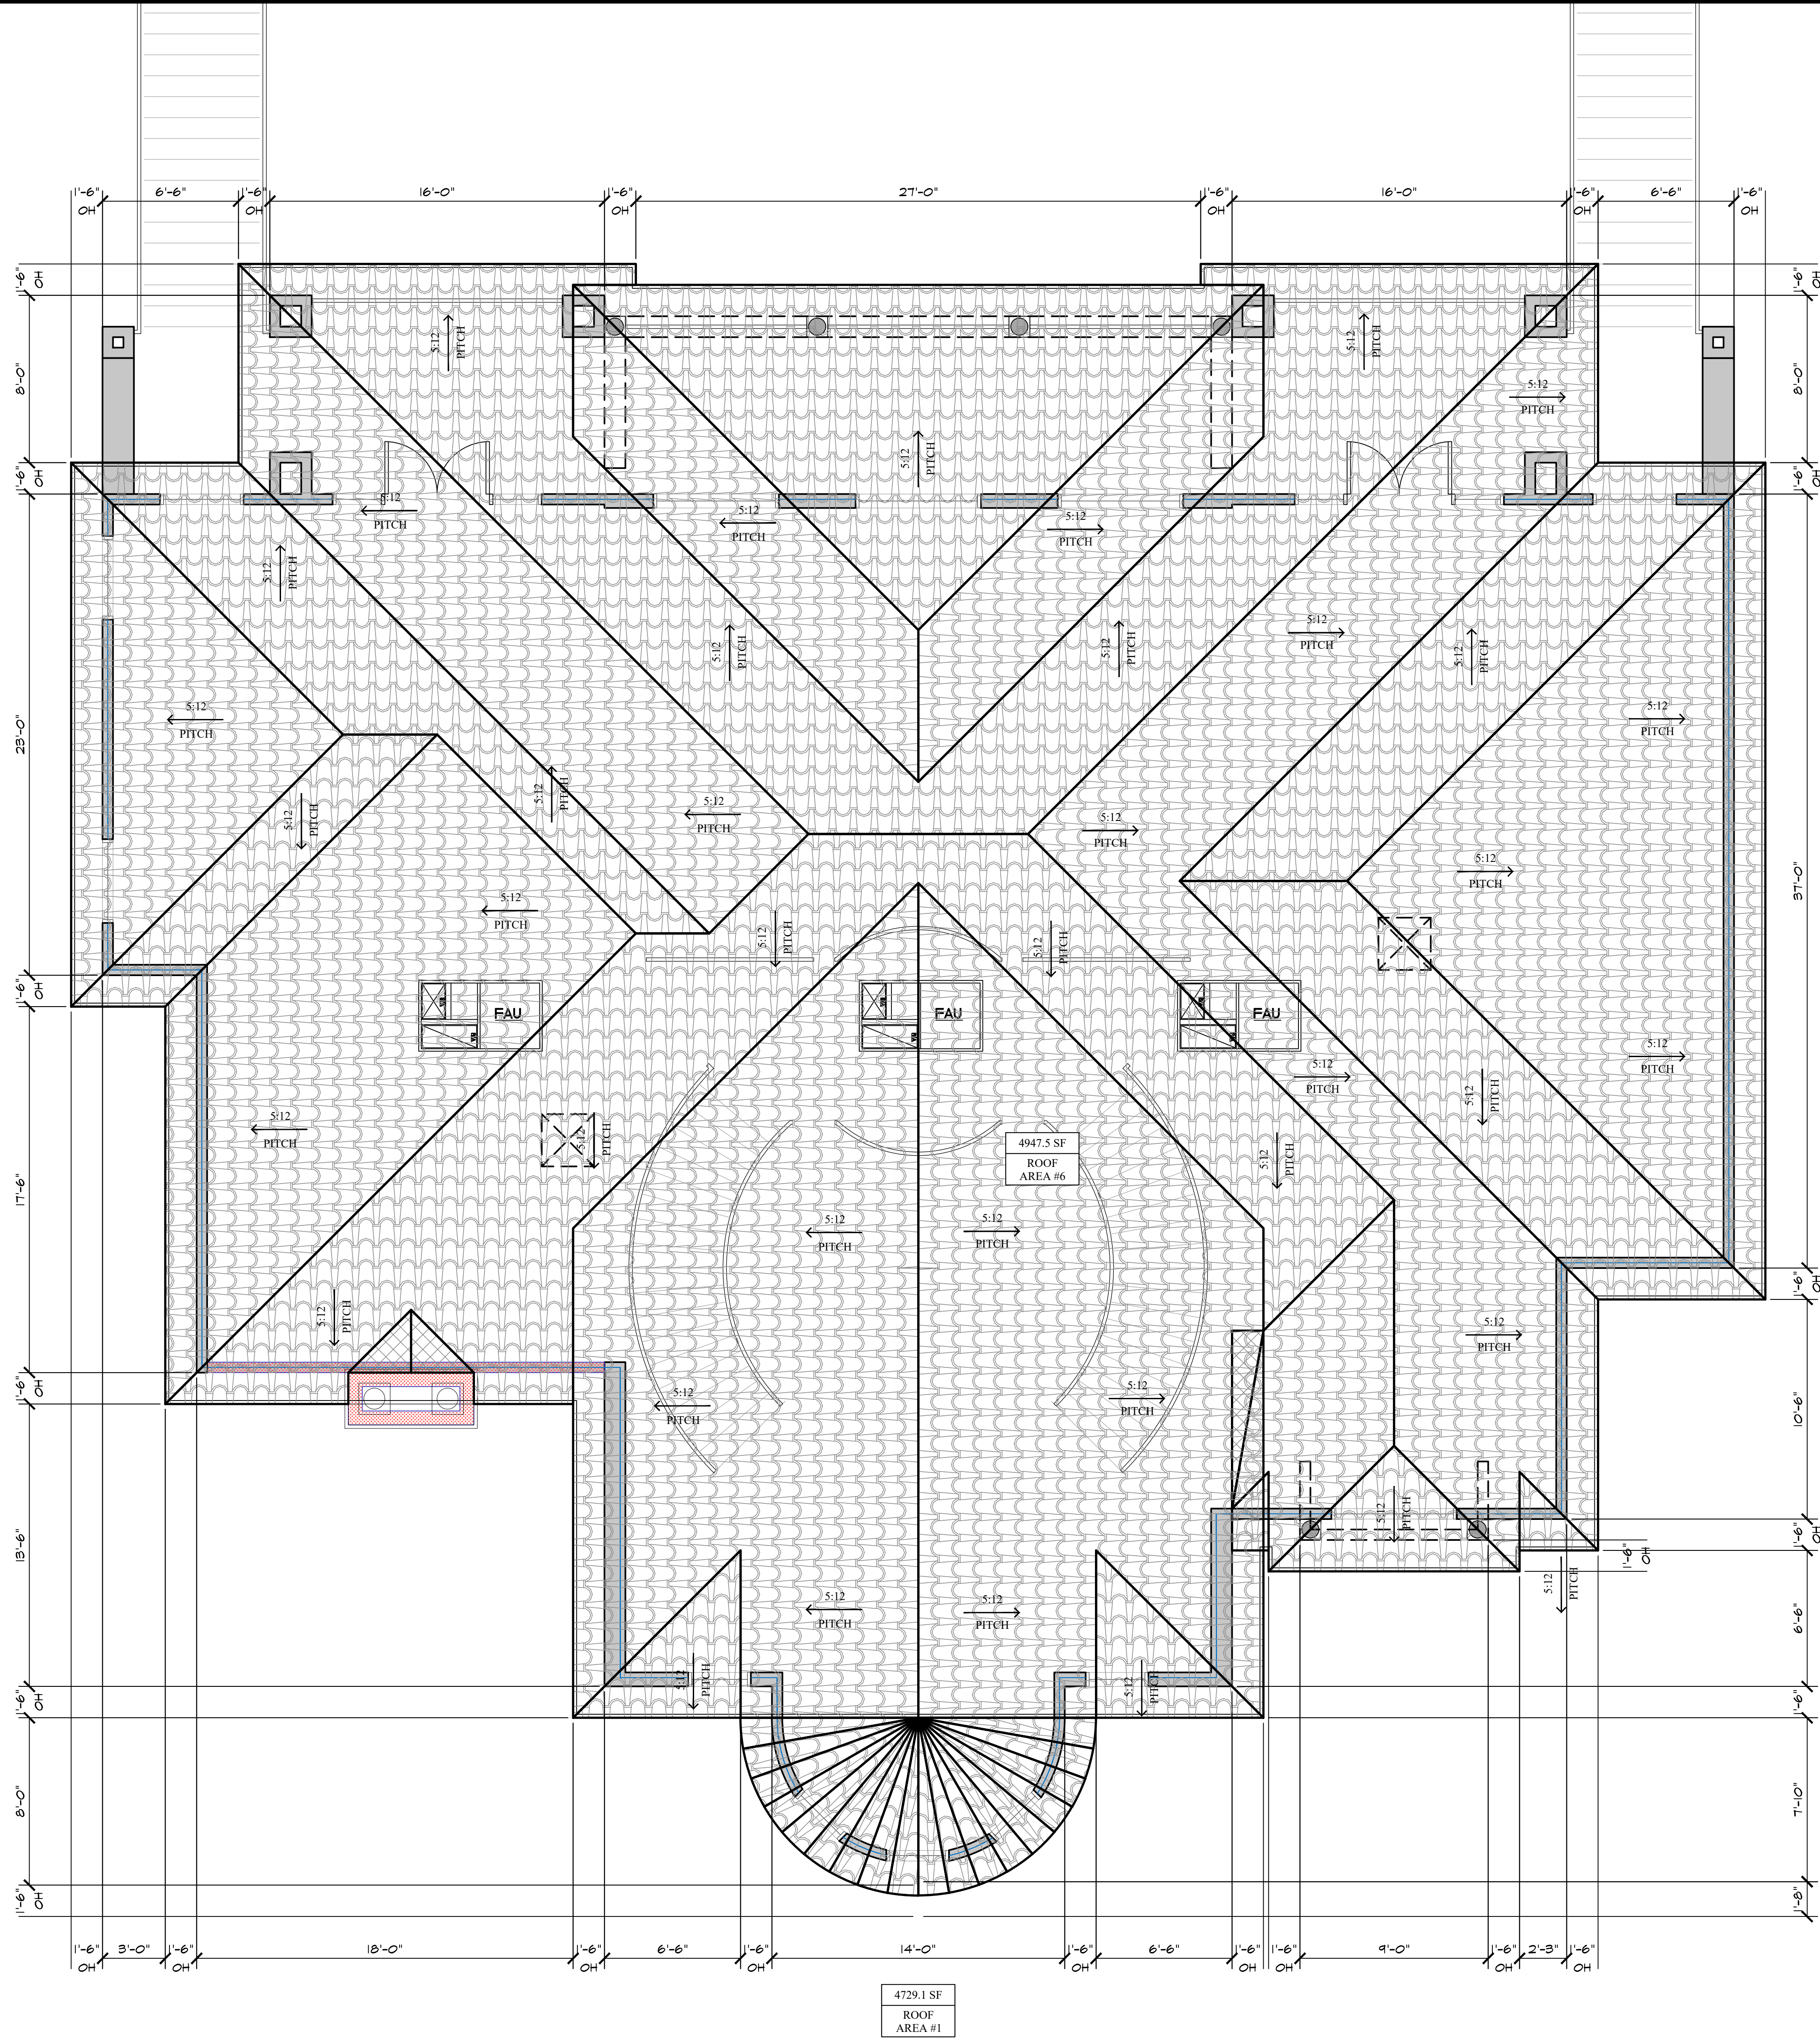
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 CVEAS	
CENTRAL VALLEY ENGINEERING & SURVEYING, INC.	
2511 LOGAN STREET Tel: (954) 841-8911 SELMA, CA 93662 Fax: (954) 841-0015 WWW.CVEAS.COM Email: info@cveas.com	
<div style="display: flex; justify-content: space-between;"><div style="writing-mode: vertical-rl; transform: rotate(180deg);">PROJECT</div><div><p>NEW SINGLE FAMILY RESIDENCE FOR:</p><p>GURDEEP DHADWAL</p><p>PALM AVE AND DOUGHERTY AVE</p><p>MORGAN HILLS, CA 95037</p><p>APN: 712-27-043</p></div></div>	
	
DATE SIGNED: 4/24/2024	
Revisions	Date
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ROOF DRAINAGE PLAN FIRST FLOOR	
CVEAS JOB #:	
DATE: 4/24/2024	
PLANNING SUBMITTAL #: XX-XXXX	
PLAN CHECK SUBMITTAL #: XX-XXXX	
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ROOF DRAINAGE PLAN - MAIN - 2ND FLOOR

SCALE 1/4" = 1'-0"

RADIANT BARRIER NOTES

- 1 LP TECHSHIELD RADIANT BARRIER (ESR 2586) BY LP BUILDING PRODUCTS, CA-1370 (TN).
- 2 RADIANT BARRIER TO COVER ALL VERTICAL SURFACES OF ATTIC SPACE SUCH AS GABLE END WALLS.

ROOF MATERIAL SCHEDULE

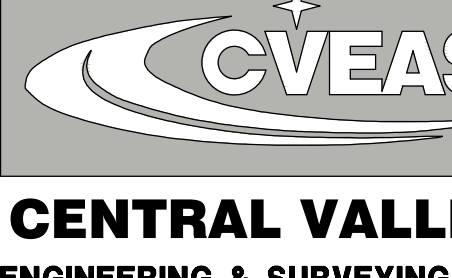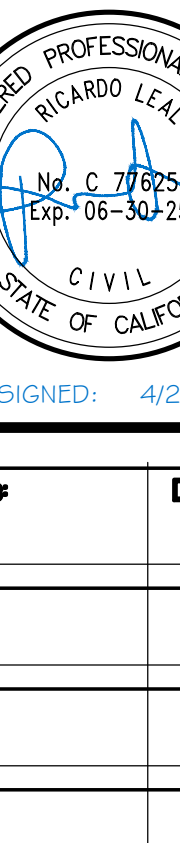ROOFING LOCATION	ROOFING MATERIAL	SHEET	DESCRIPTION
ROOF AREA #1	SPANISH TILE	D10	REFER TO RADIANT BARRIER NOTE




HATCH LEGEND

- INDICATED ROOF AREA FIRST FLOOR
- INDICATE ROOF AREA SECOND FLOOR
- INDICATES CRICKET FRAMING
- INDICATES CATWALK IN ATTIC
- INDICATES SOLAR AREA

ROOF AND ATTIC NOTES

- 1 IF 1/200TH METHOD IS USED, A R-36 BATT INSULATION MUST BE INSTALLED ON THE WARM SIDE OF THE ATTIC INSULATION.
- 2 ALL VENTS, INCLUDING CONTINUOUS VENTS MUST HAVE AN 1/8-INCH MIN. AND 1/4-INCH MAX. MESH.
- 3 INSULATION SHALL BE PLACED IN DIRECT CONTACT WITH THE CEILING.
- 4 AN ANTI-PONDING DEVICE IS REQUIRED AT THE BOTTOM COURSE OF ALL TILE ROOFS WHERE RAISED FASCIA BOARD IS USED.
- 5 PROVIDE 1" MINIMUM AIR SPACE BETWEEN INSULATION AND ROOF SHEATHING WHERE EAVE OR CORNICE VENTS ARE INSTALLED.
- 6 PROVIDE 4' FEET LONG BAFFLES MINIMUM.

ATTIC VENTILATION CALCULATIONS

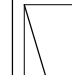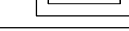ROOF AREA - 6				
ROOF AREA	4729 SF	FORMULA		
METHOD	300 TH	(ROOF AREA / METHOD) * 144		
VENTILATION REQUIRED	2269.97 SQ. IN.			
SYMBOL	QNTY.	DESCRIPTION	NET FREE AREA	TOTAL NFA
	12	HALF ROUND DORMER VENT 14" x 12"	63	756
	12	SOFFIT VENT 9"x22"	60	720
	14	RIDGE VENT 15.5" x 48"	64	896
TOTAL VENTILATION PROVIDED:				2372

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PROJECT
NEW SINGLE FAMILY RESIDENCE FOR:
GURDEEP DHADWAL
PALM AVE AND DOUGHERTY AVE
MORGAN HILLS, CA 95037
APN: 712-27-043



Revisions:	Date:

ROOF DRAINAGE PLAN
SECOND FLOOR

CVEAS JOB # :
DATE: 2/26/2024
PLANNING SUBMITTAL #: XX-XXXX
PLAN CHECK SUBMITTAL #: XX-XXXX
DRAWN BY:
CHECKED BY:
SCALE:

COUNTY OF SANTA CLARA
General Construction
Specifications

GENERAL CONDITIONS

- ALL CONSTRUCTION WORK SHALL BE PERFORMED IN ACCORDANCE WITH THE SOILS AND/OR GEOTECHNICAL REPORT PREPARED BY EARTH SYSTEMS PACIFIC AND DATED APRIL 7, 2015. THIS REPORT IS SUPPLEMENTED BY: 1) THESE PLANS AND SPECIFICATIONS, 2) THE COUNTY OF SANTA CLARA STANDARD DETAILS, 3) THE COUNTY OF SANTA CLARA STANDARD SPECS, 4) STATE OF CALIFORNIA STANDARD DETAILS, 5) STATE OF CALIFORNIA STANDARD SPECIFICATIONS, IN THE EVENT OF CONFLICT THE FORMER SHALL TAKE PRECEDENCE OVER THE LATTER, THE PERFORMANCE AND COMPLETION OF ALL WORK MUST BE TO THE SATISFACTION OF THE COUNTY.
- DEVELOPER IS RESPONSIBLE FOR INSTALLATION OF THE IMPROVEMENTS SHOWN ON THESE PLANS AND HIS OR HIS SUCCESSOR PROPERTY OWNERS ARE RESPONSIBLE FOR THEIR CONTINUED MAINTENANCE.
- DEVELOPER SHALL BE RESPONSIBLE FOR CORRECTION OF ANY ERRORS OR OMISSIONS IN THESE PLANS. THE COUNTY SHALL BE AUTHORIZED TO REQUIRE DISCONTINUANCE OF ANY WORK AND SUCH CORRECTION AND MODIFICATION OF PLANS AS MAY BE NECESSARY TO COMPLY WITH COUNTY STANDARDS OR CONDITIONS OF DEVELOPMENT APPROVAL.
- DEVELOPER SHALL OBTAIN ALL NECESSARY PERMITS FROM THE SANTA CLARA VALLEY WATER DISTRICT AND CALIFORNIA DEPARTMENT OF TRANSPORTATION WHERE NEEDED. COPIES OF THESE PERMITS SHALL BE KEPT AT THE JOB SITE FOR REVIEW BY THE COUNTY'S INSPECTOR.
- DEVELOPER SHALL REMOVE ALL TREES TO PROVIDE AN UNOBSTRUCTED FIFTEEN (15) FOOT VERTICAL CLEARANCE FOR ROADWAY AREA.
- THIS PLAN AUTHORIZES THE REMOVAL OF ONLY THOSE TREES WITH TRUNK DIAMETERS GREATER THAN 12 INCHES MEASURED 4.5 FEET ABOVE THE GROUND THAT ARE SHOWN TO BE REMOVED UNLESS AN AMENDED PLAN IS APPROVED OR A SEPARATE TREE REMOVAL PERMIT IS OBTAINED FROM THE PLANNING OFFICE. IT IS THE CONTRACTOR'S RESPONSIBILITY TO ENSURE THAT REMOVAL OF ADDITIONAL TREES HAS BEEN PERMITTED.
- DEVELOPER SHALL PROVIDE ADEQUATE DUST CONTROL AS REQUIRED BY THE COUNTY INSPECTOR.
- ALL PERSONS MUST COMPLY WITH SECTION 4442 OF THE PUBLIC RESOURCES CODE AND SECTION 13005 OF THE HEALTH AND SAFETY CODE RELATING TO THE USE OF SPARK ARRESTERS.
- UPON DISCOVERING OR UNEARTHING ANY BURIAL SITE AS EVIDENCED BY HUMAN SKELETAL REMAINS OR ARTIFACTS, THE PERSON MAKING SUCH DISCOVERY SHALL IMMEDIATELY NOTIFY THE COUNTY CORNER AT (4008) 454-2520 AND LAND DEVELOPMENT ENGINEERING OFFICE AT (408) 299-5730. NO FURTHER DISTURBANCE OF THE SITE MAY BE MADE EXCEPT AS AUTHORIZED BY THE LAND DEVELOPMENT OFFICE IN ACCORD WITH PROVISIONS OF THIS ORDINANCE (COUNTY ORDINANCE CODE SECTION 86-18).
- THESE PLANS ARE FOR THE WORK DESCRIBED IN THE SCOPE OF WORK ONLY. A SEPARATE PERMIT WILL BE REQUIRED FOR THE SEPTIC TANK INSTALLATION.
- ANY DEVIATION FROM THESE APPROVED PLANS SHALL BE RE-APPROVED IN WRITING BY THE COUNTY ENGINEER PRIOR TO CONSTRUCTION.

CONSTRUCTION STAKING

- THE DEVELOPER'S ENGINEER IS RESPONSIBLE FOR THE INITIAL PLACEMENT AND REPLACEMENT OF CONSTRUCTION GRADE STAKES. THE STAKES ARE TO BE ADEQUATELY IDENTIFIED, LOCATED, STABILIZED, ETC. FOR THE CONVENIENCE OF CONTRACTORS. LATERAL OFFSET OF STAKES SET FOR CURBS AND GUTTERS SHALL NOT EXCEED 2 1/2 FEET FROM BACK OF CURB.
- ANY PROPERTY LINE STAKES OR ROAD MONUMENTS DISTURBED DURING CONSTRUCTION SHALL BE REPLACED BY DEVELOPER'S ENGINEER AND LICENSED LAND SURVEYOR.
- PROPERTY LINE STAKING MUST BE PERFORMED BY THE PROJECT ENGINEER OR LAND SURVEYOR TO ESTABLISH OR RE-ESTABLISH THE PROJECT BOUNDARY AND SHALL BE INSPECTED BY THE COUNTY INSPECTOR PRIOR TO THE BEGINNING OF THE WORK.
- PROPER CONSTRUCTION STAKES SHALL BE SET IN THE FIELD BY THE PROJECT ENGINEER OR LAND SURVEYOR AND VERIFIED BY THE COUNTY INSPECTOR PRIOR TO THE COMMENCEMENT OF GRADING.

CONSTRUCTION INSPECTION

- CONTRACTOR SHALL NOTIFY PERMIT INSPECTION UNIT, SANTA CLARA COUNTY PRIOR TO COMMENCING WORK AND FOR FINAL INSPECTION OF WORK AND SITE. THE COUNTY REQUIRES A MINIMUM OF 24 HOURS ADVANCE NOTICE FOR GENERAL INSPECTION, 48 HOURS FOR ASPHALT CONCRETE INSPECTION.
- INSPECTION BY SANTA CLARA COUNTY SHALL BE LIMITED TO INSPECTION OF MATERIALS AND PROCESSES OF CONSTRUCTION TO OBSERVE THEIR COMPLIANCE WITH PLANS & SPECIFICATIONS BUT DOES NOT INCLUDE RESPONSIBILITY FOR THE SUPERINTENDENT OF CONSTRUCTION, SITE CONDITIONS, EQUIPMENT OR PERSONNEL. CONTRACTOR SHALL NOTIFY THE COUNTY LAND DEVELOPMENT INSPECTOR AT PHONE (408) 299-6868 AT LEAST 24 HOURS PRIOR TO COMMENCING WORK AND FOR FINAL INSPECTION OF WORK AND SITE.
- DEVELOPER AND/OR HIS AUTHORIZED REPRESENTATIVE MUST SUBMIT WRITTEN REQUEST FOR FINAL INSPECTION AND ACCEPTANCE. SAID REQUEST SHALL BE DIRECTED TO THE INSPECTION OFFICE NOTED ON THE PERMIT FORM.
- THE CONTRACTOR SHALL PROVIDE TO THE COUNTY CONSTRUCTION INSPECTOR WITH PAD ELEVATION AND LOCATION CERTIFICATES, PREPARED BY THE PROJECT ENGINEER OR LAND SURVEYOR, PRIOR TO COMMENCEMENT OF THE BUILDING FOUNDATION.

SITE PREPARATION (CLEARING AND GRUBBING)

- EXISTING TREES AUTHORIZED FOR REMOVAL, ROOTS, AND FOREIGN MATERIAL IN AREAS TO BE IMPROVED WILL BE REMOVED TO AN AUTHORIZED DISPOSAL SITE AS FOLLOWS:
 - TO A MINIMUM DEPTH OF TWO FEET BELOW THE FINISHED GRADE OF PROPOSED ROADWAYS (EITHER PRIVATE OR TO BE DEDICATED TO PUBLIC USE)
 - FROM AREAS AFFECTED BY THE PROPOSED GRADING EXCEPT WHERE NOTED ON THE PLANS.
- IT SHALL BE THE RESPONSIBILITY OF THE DEVELOPER TO MOVE OR RELOCATE UTILITY POLES AND OTHER OBSTRUCTIONS IN THE WAY OF CONSTRUCTION.

UTILITY LOCATION, TRENCHING & BACKFILL

- CONTRACTOR SHALL NOTIFY USA (UNDERGROUND SERVICE ALERT) AT 1-800-277-2600 A MINIMUM OF 24 HOURS BEFORE BEGINNING UNDERGROUND WORK FOR VERIFICATION OF THE LOCATION OF UNDERGROUND UTILITIES.
- ACCURATE VERIFICATION AS TO SIZE, LOCATION, AND DEPTH OF EXISTING UNDERGROUND CONDUITS OR FACILITIES SHALL BE THE INDIVIDUAL CONTRACTORS RESPONSIBILITY. PLAN LOCATIONS ARE APPROXIMATE AND FOR GENERAL INFORMATION ONLY.
- ALL UNDERGROUND INSTALLATIONS SHALL BE IN PLACE AND THE TRENCH BACKFILLED AND COMPACTED BEFORE PLACING AGGREGATE BASE MATERIAL OR SURFACE STRUCTURES. SURFACING MAY BE DONE IF THE UTILITY COMPANY CONCERNED INDICATES BY LETTER THAT IT WILL BORE, UNLESS SPECIFICALLY AUTHORIZED BY THE COUNTY, GAS AND WATER MAINS SHALL BE INSTALLED OUTSIDE THE PAVED AREAS.
- TRENCH BACKFILL IN EXISTING PAVEMENT AREAS SHALL BE SAND MATERIAL IN ACCORDANCE WITH THE APPLICABLE PROVISIONS OF THE STATE SPECIFICATIONS. THE STRUCTURAL SECTION FOR TRENCH REPLACEMENT SHALL CONSIST OF NOT LESS THAN 12 INCHES OF APPROVED AGGREGATE BASE MATERIAL COMPACTED TO A RELATIVE COMPACTION OF AT LEAST 95% AND 4 INCHES OF HOT ASPHALT CONCRETE PLACED IN TWO LIFTS. TRENCH RESTORATION FOR HIGHER TYPE PAVEMENTS SHALL BE MADE IN KIND OR AS DIRECTED BY THE COUNTY.
- TRENCH BACKFILL IN NEW CONSTRUCTION AREAS SHALL BE SAND MATERIAL COMPACTED TO A RELATIVE COMPACTION OF AT LEAST 90% THE REQUIREMENT FOR SELECT MATERIAL MAY BE WAIVED BY COUNTY IF THE NATIVE SOIL IS SUITABLE FOR USE AS TRENCH BACKFILL BUT THE COMPACTION REQUIREMENTS WILL NOT BE THEREBY WAIVED.
- BACKFILL AND TRENCH RESTORATION REQUIREMENTS SHALL APPLY AS MINIMUM STANDARDS TO ALL UNDERGROUND FACILITIES INSTALLED BY OTHER FIRMS OR PUBLIC AGENCIES.

RETAINING WALLS

- REINFORCED CONCRETE AND CONCRETE MASONRY UNIT RETAINING WALLS SHALL HAVE FOUNDATION AND REINFORCEMENT INSPECTED BY THE COUNTY ENGINEERING INSPECTOR AND ENGINEER OF RECORD PRIOR TO POURING THE FOUNDATION AND FORMING THE WALL.
- SEGMENTAL BLOCK RETAINING WALLS SHALL HAVE FOUNDATION AND REINFORCEMENT INSPECTED BY THE COUNTY ENGINEERING INSPECTOR.

GRADING

- EXCAVATED MATERIAL SHALL BE PLACED IN THE FILL AREAS DESIGNATED OR SHALL BE HAULED AWAY FROM THE SITE TO A COUNTY APPROVED DISPOSAL SITE. WHERE FILL MATERIAL IS TO BE PLACED ON NATURAL GROUND, IT SHALL BE STRIPPED OF ALL VEGETATION. TO ACHIEVE A PROPER BOND WITH THE FILL MATERIAL, THE SURFACE OF THE GROUND SHALL BE SCARIFIED TO DEPTH OF 6" BEFORE FILL IS PLACED. WHERE NATURAL GROUND IS STEEPER THAN 5:1, IT SHALL BE BENCHED AND THE FILL KEYED IN TO ACHIEVE STABILITY. WHERE NEW FILL IS TO BE PLACED ON EXISTING FILL, THE EXISTING FILL SHALL BE REMOVED UNTIL MATERIAL COMPACTED TO 90% RELATIVE COMPACTION IS EXPOSED. THEN THE NEW FILL MATERIAL SHALL BE PLACED AS PER THESE CONSTRUCTION NOTES. FILL MATERIAL SHALL BE PLACED IN UNIFORM LIFTS NOT EXCEEDING 6" IN UNCOMPACTED THICKNESS. BEFORE COMPACTION BEGINS, FILL SHALL BE BROUGHT TO A WATER CONTENT THAT WILL PERMIT PROPER COMPACTION BY EITHER 1) AERATING THE FILL IF IT IS TOO WET OR 2) MOISTENING THE FILL WITH WATER IF IT IS TOO DRY. EACH LIFT SHALL BE THOROUGHLY MIXED BEFORE COMPACTION TO ENSURE A UNIFORM DISTRIBUTION OF MOISTURE.
- EXCESS CUT MATERIAL SHALL NOT BE SPREAD OR STOCKPILED ON THE SITE.
- SURPLUS EARTH FILL MATERIAL SHALL BE PLACED IN A SINGLE (8" MAX) THICK LAYER COMPACTED TO WITHSTAND WEATHERING IN THE AREA(S) DELINEATED ON THE PLAN.
- NO ORGANIC MATERIAL SHALL BE PLACED IN ANY FILL. NO TREES SHALL BE REMOVED OUTSIDE OF CUT, FILL OR ROADWAY AREAS.
- THE UPPER 6" OF SUBGRADE BELOW DRIVEWAY ACCESS ROAD OR PARKING AREA SHALL BE COMPACTED TO 95% OF MAXIMUM DENSITY.
- MAXIMUM CUT SLOPE SHALL BE 2 HORIZONTAL TO 1 VERTICAL. MAXIMUM FILL SLOPE SHALL BE 2 HORIZONTAL TO 1 VERTICAL.

LOCATION	CUT (C.Y.)	FILL (C.Y.)	VERT. DEPTH
RESIDENCE	0	1465	2.0'
PONDING BASIN	90	0	3.0'
POOL/YARDSIDE	0	0	0.5'
LANDSCAPE	0	0	0.5'
DRIVEWAY	3	7	0.75'
OFF SITE IMPROVEMENTS	30	5	0.75'
TOTAL	123	1477	0.5"-3.0"

NOTE: FILL VOLUMES INCLUDE 10% SHRINKAGE.

- EXCESS MATERIAL SHALL BE OFF HAULED TO A COUNTY APPROVED DUMP SITE.
- NOTIFY SOILS ENGINEER TWO (2) DAYS PRIOR TO COMMENCEMENT OF ANY GRADING WORK TO COORDINATE THE WORK WITH THE SOILS ENGINEER.
- ALL MATERIALS FOR FILL SHOULD BE APPROVED BY THE SOILS ENGINEER BEFORE IT IS BROUGHT TO THE SITE.
- THE UPPER 6" OF THE SUBGRADE SOIL SHALL BE SCARIFIED, MOISTURE CONDITIONED AND COMPACTED TO A MINIMUM RELATIVE COMPACTION OF 95%.
- ALL AGGREGATE BASE MATERIAL SHALL BE COMPACTED TO A MINIMUM 95% RELATIVE COMPACTION.
- THE GEOTECHNICAL PLAN REVIEW LETTER MUST BE REVIEWED AND APPROVED BEFORE THE STARTING OF THE BUILDING INSPECTION BY THE COUNTY ENGINEER FOR BUILDING OCCUPANCY.
- THE PROJECT GEOTECHNICAL ENGINEER SHALL PERFORM COMPACTION TESTING AND PRESENT THE RESULTS TO THE COUNTY ENGINEERING INSPECTOR PRIOR TO THE CONSTRUCTION OF ANY PAVED AREA.
- GRADING WORK BETWEEN OCTOBER 15TH AND APRIL 15TH IS AT THE DISCRETION OF THE SANTA CLARA COUNTY GRADING OFFICIAL.
- TOTAL DISTURBED AREA FOR THE PROJECT 32.54 SF.
- WDO NO.(N/A).
- THE INSPECTOR MAY VERIFY THAT A VALID NOTICE OF INTENT (NOI) HAS BEEN ISSUED BY THE STATE AND THAT A CURRENT AND UP TO DATE STORM WATER POLLUTION PREVENTION PLAN (SWPPP) IS AVAILABLE ON SITE.

TREE PROTECTION

- FOR ALL TREES TO BE RETAINED WITH A CANOPY IN THE DEVELOPMENT AREA OR INTERIORITY OF THE DEVELOPMENT, THE LIMITS OF GRADING AND PROJECT DEVELOPMENT ON SITE, THE TREES SHALL BE PROTECTED BY THE PLACEMENT OF RIGID TREE PROTECTIVE FENCING, CONSISTENT WITH THE COUNTY INTEGRATED LANDSCAPE GUIDELINES, AND INCLUDE THE FOLLOWING:
 - FENCING SHOULD BE PLACED ALONG THE OUTSIDE EDGE OF THE DRIPLINE OF THE TREE OR GROVE OF TREES.
 - THE FENCING SHALL BE MAINTAINED THROUGHOUT THE SITE CONSTRUCTION PERIOD AND SHALL BE INSPECTED PERIODICALLY FOR DAMAGE AND PROPER FUNCTION.
 - FENCING SHALL BE REPAIRED, AS NECESSARY, TO PROVIDE A PHYSICAL BARRIER FROM CONSTRUCTION ACTIVITIES.
 - SIGNAGE STATING, "WARNING- THIS FENCING SHALL NOT BE REMOVED WITHOUT PERMISSION FROM THE SANTA CLARA COUNTY PLANNING OFFICE (408) 299-5770. COUNTY OF SANTA CLARA TREE PROTECTION MEASURES MAY BE FOUND AT <http://www.sccplanning.gov>." SHALL BE PLACED ON THE TREE PROTECTIVE FENCING UNTIL FINAL OCCUPANCY.
- PRIOR TO COMMENCEMENT OF ANY CONSTRUCTION ACTIVITY, TREE PROTECTIVE FENCING SHALL BE SECURELY IN PLACED AND INSPECTED BY THE LAND DEVELOPMENT ENGINEERING INSPECTOR.
- SEE EXISTING TREE PROTECTION DETAILS FOR MORE INFORMATION.

ACCESS ROADS AND DRIVEWAYS

- DRIVEWAY LOCATIONS SHALL BE AS SHOWN ON THE IMPROVEMENT PLANS WITH CENTERLINE STATIONING. THE MINIMUM CONCRETE THICKNESS SHALL BE 6 INCHES THROUGHOUT (WITH A MAXIMUM APPROACH SLOPE OF 1 1/4 INCHES PER FOOT).
- ALL DRIVEWAY OR COMMON ACCESS ROAD SECTIONS IN EXCESS OF 15 LONGITUDINAL SLOPE MUST BE PAVED WITH A MINIMUM 2-INCH ASPHALT LIFT OR FULL DEPTH CONCRETE LIFT PRIOR TO ANY COMBUSTIBLE FRAMING. THE OWNER AND PRIME CONTRACTOR ARE RESPONSIBLE FOR MAINTAINING PROJECT SITE ACCESS AND NEIGHBORHOOD ACCESS FOR EMERGENCY VEHICLES AND LOCAL RESIDENTS.
- ROADWAYS DESIGNATED AS NOT COUNTY MAINTAINED ROADS AS SHOWN ON THE PLAN WILL NOT BE ELIGIBLE FOR COUNTY MAINTENANCE UNTIL THE ROADWAYS ARE IMPROVED (AT NO COST TO THE COUNTY) TO THE PUBLIC MAINTENANCE ROAD STANDARDS APPROVED BY THE BOARD OF SUPERVISORS AND IN EFFECT AT SUCH TIME THAT THE ROADWAYS ARE CONSIDERED FOR ACCEPTANCE INTO THE COUNTY'S ROAD SYSTEM.
- ALL WORK IN THE COUNTY ROAD RIGHT-OF-WAY REQUIRES AN ENCROACHMENT PERMIT FROM THE ROADS AND AIRPORTS DEPARTMENT. EACH INDIVIDUAL ACTIVITY REQUIRES A SEPARATE PERMIT - I.E. CABLE, ELECTRICAL, GAS, SEWER, WATER, RETAINING WALLS, DRIVEWAY APPROACHES, FENCES, LANDSCAPING, TREE REMOVAL, STORM DRAINAGE IMPROVEMENTS, ETC.

STREET LIGHTING

- PACIFIC GAS & ELECTRIC ELECTROLIER SERVICE FEE SHALL BE PAID BY THE DEVELOPER AND/OR HIS AUTHORIZED REPRESENTATIVE.

SANITARY SEWER

- THE SANITARY SEWER AND WATER UTILITIES SHOWN ON THESE PLANS ARE NOT PART OF THIS GRADING PERMIT AND ARE SHOWN FOR REFERENCE ONLY.
- ALL MATERIALS AND METHODS OF CONSTRUCTION OF SANITARY SEWERS SHALL CONFORM TO THE SPECIFICATIONS OF THE JURISDICTION INVOLVED. INSPECTION OF SANITARY SEWER WORK SHALL BE DONE BY SAID JURISDICTION.

PORTLAND CEMENT CONCRETE

- CONCRETE USED FOR STRUCTURAL PURPOSES SHALL BE CLASS "A" (6 SACK PER CUBIC YARD) AS SPECIFIED IN THE STATE STANDARD SPECIFICATIONS. CONCRETE PLACED MUST DEVELOP A MINIMUM STRENGTH FACTOR OF 2800 PSI IN A SEVEN-DAY PERIOD. THE CONCRETE MIX DESIGN SHALL BE UNDER THE CONTINUAL CONTROL OF THE COUNTY INSPECTOR.

AIR QUALITY, LANDSCAPING AND EROSION CONTROL

- WATER ALL ACTIVE CONSTRUCTION AREAS AT LEAST TWICE DAILY.
- COVER ALL TRUCKS HAULING SOIL, SAND, AND OTHER LOOSE MATERIALS OR REQUIRE ALL TRUCKS TO MAINTAIN AT LEAST TWO FEET OF FREEBOARD.
- PAVE, APPLY WATER THREE TIMES DAILY, OR APPLY (NON-TOXIC) SOIL STABILIZERS ON ALL UNPAVED ACCESS ROADS, PARKING AREAS AND STAGING AREAS AT CONSTRUCTION SITES.
- SWEEP DAILY (WITH WATER SWEEPERS) ALL PAVED ACCESS ROADS, PARKING AREAS AND STAGING AREAS AT CONSTRUCTION SITES. THE USE OF DRY POWDER SWEEPING IS PROHIBITED.
- SWEEP STREETS DAILY (WITH WATER SWEEPERS) IF VISIBLE SOIL MATERIAL IS CARRIED ONTO ADJACENT PUBLIC STREETS. THE USE OF DRY POWDER SWEEPING IS PROHIBITED.
- ALL CONSTRUCTION VEHICLES, EQUIPMENT AND DELIVERY TRUCKS SHALL HAVE A MAXIMUM IDLING TIME OF 5 MINUTES (AS REQUIRED BY THE CALIFORNIA AIRBORNE TOXIC CONTROL MEASURE TITLE 13, SECTION 2485 OF CALIFORNIA CODE OF REGULATIONS (CCR)). ENGINES SHALL BE SHUT OFF IF CONSTRUCTION REQUIRES LONGER IDLING TIME UNLESS NECESSARY FOR PROPER OPERATION OF THE VEHICLE.
- ALL VEHICLE SPEEDS ON UNPAVED ROADS SHALL BE LIMITED TO 15 MILES PER HOUR.
- ALL CONSTRUCTION EQUIPMENT SHALL BE MAINTAINED AND PROPERLY TUNED IN ACCORDANCE WITH MANUFACTURER'S SPECIFICATIONS. ALL EQUIPMENT SHALL BE CHECKED BY A CERTIFIED MECHANIC AND DETERMINED TO BE RUNNING IN PROPER CONDITION PRIOR TO OPERATION.
- POST A SIGN THAT IS AT LEAST 32 SQUARE FEET MINIMUM 2 INCHES LETTER HEIGHT VISIBLE NEAR THE ENTRANCE TO CONSTRUCTION SITE THAT IDENTIFIES THE FOLLOWING REQUIREMENTS. OBTAIN ENCROACHMENT PERMIT FOR SIGN FROM ROADS DEPARTMENT OR OTHER APPLICABLE AGENCY IF REQUIRED.
 - 15 MILES PER HOUR (MPH) SPEED LIMIT
 - 5 MINUTES MAXIMUM IDLING TIME OF VEHICLES
 - TELEPHONE NUMBER TO CONTACT THE BAY AREA AIR QUALITY MANAGEMENT DISTRICT REGARDING DUST COMPLAINTS. NOTE PHONE NUMBER OF THE BAY AREA AIR QUALITY MANAGEMENT DISTRICT AIR PROPER OPERATION OF THE VEHICLE.

- ALL FILL SLOPES SHALL BE COMPACTED AND LEFT IN A SMOOTH AND FIRM CONDITION CAPABLE OF WITHSTANDING WEATHERING.
- ALL EXPOSED DISTURBED AREAS SHALL BE SEEDED WITH BROME SEED SPREAD AT THE RATE OF 5 LB. PER 1000 SQUARE FEET (OR APPROVED EQUAL). SEEDING AND WATERING SHALL BE MAINTAINED AS REQUIRED TO ENSURE GROWTH.
- ALL DITCHES SHALL BE LINED PER COUNTY STANDARD SDB.
- ALL STORM DRAINAGE STRUCTURES SHALL BE INSTALLED WITH EFFECTIVE ENTRANCE & OUTFALL EROSION CONTROLS E.G. SACKED CONCRETE RIP-RAP. ENERGY DISSIPATORS SHALL BE INSTALLED AT ALL DITCH OUTFALLS. WHERE OUTFALLS ARE NOT INTO AN EXISTING CREEK OR WATER COURSE, RUNOFF SHALL BE RELEASED TO SHEET FLOW.
- PRIOR TO GRADING COMPLETION AND RELEASE OF THE BOND, ALL GRADED AREAS SHALL BE RESEEDED IN CONFORMANCE WITH THE COUNTY GRADING ORDINANCE TO MINIMIZE THE VISUAL IMPACTS OF THE GRADE SLOPES AND REDUCE THE POTENTIAL FOR EROSION OF THE SUBJECT SITE.
- PERMANENT LANDSCAPING SHOWN ON THE ATTACHED LANDSCAPE PLAN MUST BE INSTALLED AND FIELD APPROVED BY THE COUNTY PLANNING OFFICE PRIOR TO FINAL APPROVAL BY THE COUNTY ENGINEER, AND FINAL OCCUPANCY RELEASE BY THE BUILDING INSPECTION OFFICE.
- THE OWNER SHALL PREPARE AND PRESENT A WINTERIZATION REPORT TO THE COUNTY INSPECTOR FOR REVIEW PRIOR TO OCTOBER 15TH OF EVERY YEAR.
- THE OWNER, CONTRACTOR, AND ANY PERSON PERFORMING CONSTRUCTION ACTIVITIES SHALL INSTALL AND MAINTAIN CONSTRUCTION BEST MANAGEMENT PRACTICES (BMPs) ON THE PROJECT SITE AND WITHIN THE SANTA CLARA COUNTY ROAD RIGHT-OF-WAY THROUGHOUT THE DURATION OF THE CONSTRUCTION AND UNTIL THE ESTABLISHMENT OF PERMANENT STABILIZATION AND SEDIMENT CONTROL TO PREVENT THE DISCHARGE OF POLLUTANTS INCLUDING SEDIMENT, CONSTRUCTION MATERIALS, EXCAVATED MATERIALS, AND WASTE INTO THE SANTA CLARA COUNTY RIGHT-OF-WAY, STORM SEWER WATERWAYS, ROADWAY INFRASTRUCTURE. BMPs SHALL INCLUDE, BUT NOT BE LIMITED TO THE FOLLOWING:
 - PREVENTION OF POLLUTANTS IN STORM WATER DISCHARGES FROM THE CONSTRUCTION SITE AND THE CONTRACTOR'S MATERIAL AND EQUIPMENT LAYDOWN / STAGING AREAS.
 - PREVENTION OF TRACKING OF MUD, DIRT, AND CONSTRUCTION MATERIALS ONTO THE PUBLIC ROAD RIGHT-OF-WAY.
 - PREVENTION OF DISCHARGE OF WATER RUN-OFF DURING DRY AND WET WEATHER CONDITIONS ONTO THE PUBLIC ROAD RIGHT-OF-WAY.
- THE OWNER, CONTRACTOR, AND ANY PERSON PERFORMING CONSTRUCTION ACTIVITIES SHALL ENSURE THAT ALL TEMPORARY CONSTRUCTION FACILITIES, INCLUDING BUT NOT LIMITED TO CONSTRUCTION MATERIALS, DELIVERIES, HAZARDOUS AND NON-HAZARDOUS MATERIAL STORAGE, EQUIPMENT, TOOLS, PORTABLE TOILETS, CONCRETE WASHOUT, GARBAGE CONTAINERS, LAYDOWN YARDS, SECONDARY CONTAINMENT AREAS, ETC. ARE LOCATED OUTSIDE THE SANTA CLARA COUNTY ROAD RIGHT-OF-WAY.
- EROSION CONTROL PLAN IS A GUIDE AND SHALL BE AMENDED AS NECESSARY TO PREVENT EROSION AND ILLICIT DISCHARGES ON A YEAR AROUND BASIS, DEPENDING ON THE SEASON, WEATHER, AND FIELD CONDITIONS. EROSION CONTROL MEASURES IN ADDITION TO THOSE NOTED IN THE PERMITTED PLANS MAY BE NECESSARY. FAILURE TO INSTALL SITE SITE AND SITUATIONALLY APPROPRIATE EROSION CONTROL MEASURES MAY RESULT IN VIOLATIONS, FINES, AND A STOPPAGE OF WORK.

STORM DRAINAGE AND STORMWATER MANAGEMENT

- DEVELOPER IS RESPONSIBLE FOR ALL NECESSARY DRAINAGE FACILITIES WHETHER SHOWN ON THE PLANS OR NOT AND HE OR HIS SUCCESSOR PROPERTY OWNERS ARE RESPONSIBLE FOR THE ADEQUACY AND CONTINUED MAINTENANCE OF THESE FACILITIES IN A MANNER WHICH WILL PRECLUDE ANY HAZARD TO LIFE, HEALTH, OR DAMAGE TO ADJOINING PROPERTY, CONSISTENT WITH NPDES PERMIT CAS612008 / ORDER NO. R2-2009-0047 AND NPDES PERMIT CAS000004 / ORDER NO. 2015-001-DWG.
- DROP INLETS SHALL BE COUNTY STANDARD TYPE 5 UNLESS OTHERWISE NOTED ON THE PLANS. THE DEVELOPER'S ENGINEER SHALL BE RESPONSIBLE FOR THE PROPER LOCATION OF DROP INLETS. WHERE STREET PROFILE GRADE EXCEEDS 6% DROP INLETS SHALL BE SET AT 500 ANGLE CURB LINE TO ACCEPT WATER OR AS SHOWN ON THE PLANS.
- WHERE CULVERTS ARE INSTALLED THE DEVELOPER SHALL BE RESPONSIBLE FOR GRADING THE OUTLET DITCH TO DRAIN TO AN EXISTING SWALE OR TO AN OPEN AREA FOR SHEET FLOW.
- UPON INSTALLATION OF DRIVEWAY CONNECTIONS, PROPERTY OWNERS SHALL PROVIDE FOR THE UNINTERRUPTED FLOW OF WATER IN ROADSIDE DITCHES.
- THE COUNTY SHALL INSPECT UNDERGROUND DRAINAGE IMPROVEMENTS AND STORMWATER MANAGEMENT FEATURES PRIOR TO BACKFILL.

AS-BUILT PLANS STATEMENT

THIS IS A TRUE COPY OF THE AS-BUILT PLANS. THERE (____) WERE (____) WERE NOT) MINOR FIELD CHANGES - MARKED WITH THE SYMBOL (____) THERE (____) WERE (____) WERE NOT) PLAN REVISIONS INDICATING SIGNIFICANT CHANGES REVIEWED BY THE COUNTY ENGINEER AND MARKED WITH THE SYMBOL Δ.


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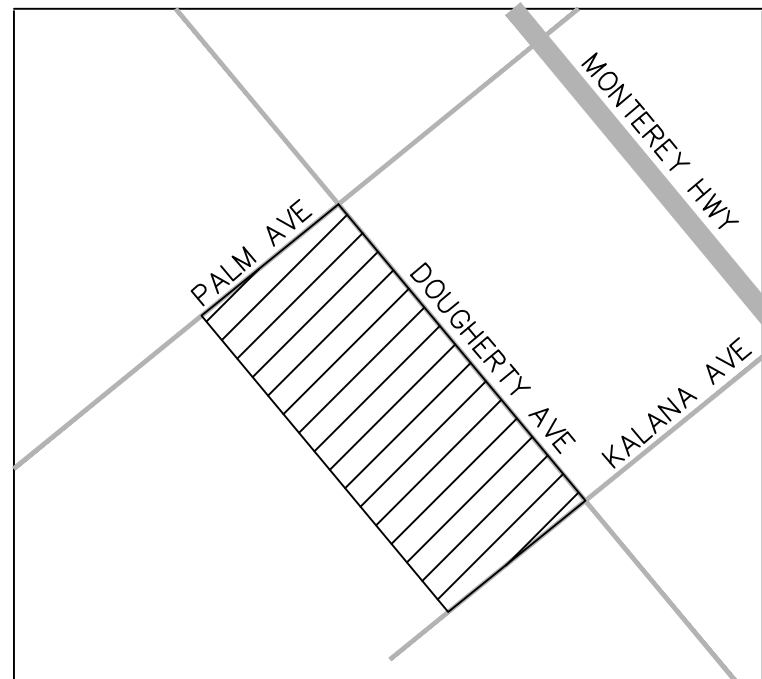
NOTE: THIS STATEMENT IS TO BE SIGNED BY THE PERSON AUTHORIZED BY THE COUNTY ENGINEER TO PERFORM THE INSPECTION WORK. A REPRODUCIBLE COPY OF THE AS-BUILT PLANS MUST BE FURNISHED TO THE COUNTY ENGINEER AFTER CONSTRUCTION.

GEOTECHNICAL ENGINEER OBSERVATION

- A CONSTRUCTION OBSERVATION LETTER FROM THE RESPONSIBLE GEOTECHNICAL ENGINEER AND ENGINEERING GEOLOGIST DETAILING CONSTRUCTION OBSERVATIONS AND CERTIFYING THAT THE WORK WAS DONE IN ACCORDANCE WITH THE RECOMMENDATIONS IN THE GEOTECHNICAL AND GEOLOGIC REPORTS SHALL BE SUBMITTED PRIOR TO THE GRADING COMPLETION AND RELEASE OF THE BOND.




COUNTY LOCATION
MAP

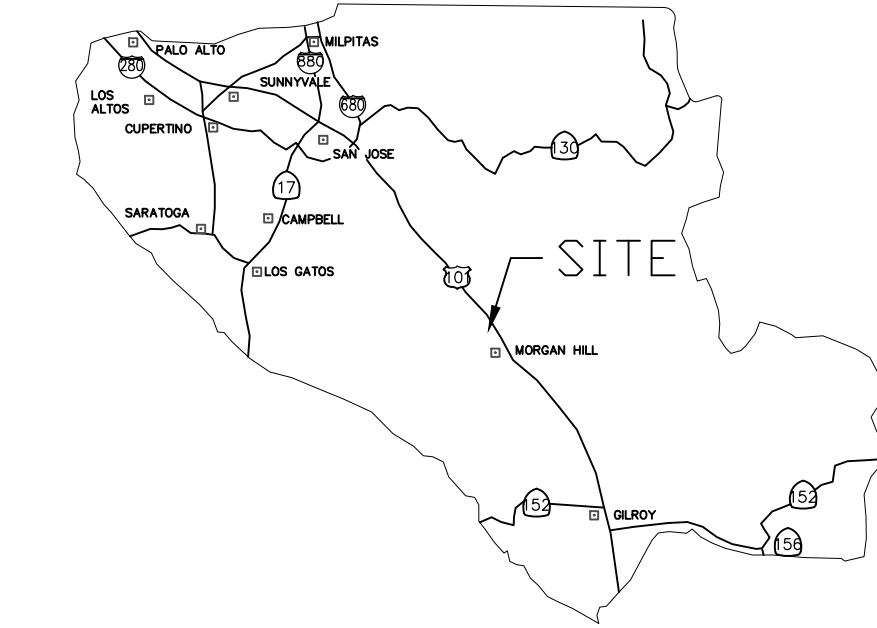

VICINITY MAP

SURVEY MONUMENT PRESERVATION

- THE LANDOWNER / CONTRACTOR MUST PROTECT AND ENSURE THE PERPETUATION OF SURVEY MONUMENTS AFFECTED BY CONSTRUCTION ACTIVITIES.
- PRIOR TO THE START OF CONSTRUCTION, THE CONTRACTOR SHALL LOCATE, STAKE, AND FLAG OR OTHERWISE IDENTIFY WITH PAINT OR OTHER MARKINGS ALL PERMANENT SURVEY MONUMENTS OF RECORD AND ANY UNRECORDED MONUMENTS THAT ARE DISCOVERED THAT ARE WITHIN 50 FEET OF THE CONSTRUCTION ACTIVITY.
- THE LANDOWNER, CONTRACTOR AND/OR ANY PERSON PERFORMING CONSTRUCTION ACTIVITIES SHALL BE RESPONSIBLE FOR THE PROTECTION OF SURVEY MONUMENTS, CORNER STAKE, OR ANY OTHER PERMANENT SURVEYED MONUMENT SHALL CAUSE TO HAVE A LICENSED LAND SURVEYOR OR CIVIL ENGINEER, AUTHORIZED TO PRACTICE SURVEYING, ENSURE THAT A CORNER RECORD AND/OR RECORD OF SURVEY ARE FILED WITH THE COUNTY SURVEYOR'S OFFICE PRIOR TO DISTURBING SAID MONUMENTS AND RESET PERMANENT MONUMENT(S) IN THE SURFACE OF THE NEW CONSTRUCTION OR SET A WITNESS MONUMENT(S) TO PERPETUATE THE LOCATION IF ANY PERMANENT MONUMENT COULD BE DESTROYED, DAMAGED, COVERED, OR OTHERWISE OBLITERATED. THE LICENSED LAND SURVEYOR OR CIVIL ENGINEER SHALL FILE A CORNER RECORD OR RECORD OF SURVEY WITH COUNTY SURVEYOR PRIOR TO FINAL ACCEPTANCE OF THE PROJECT BY THE LAND DEVELOPMENT ENGINEERING INSPECTOR.

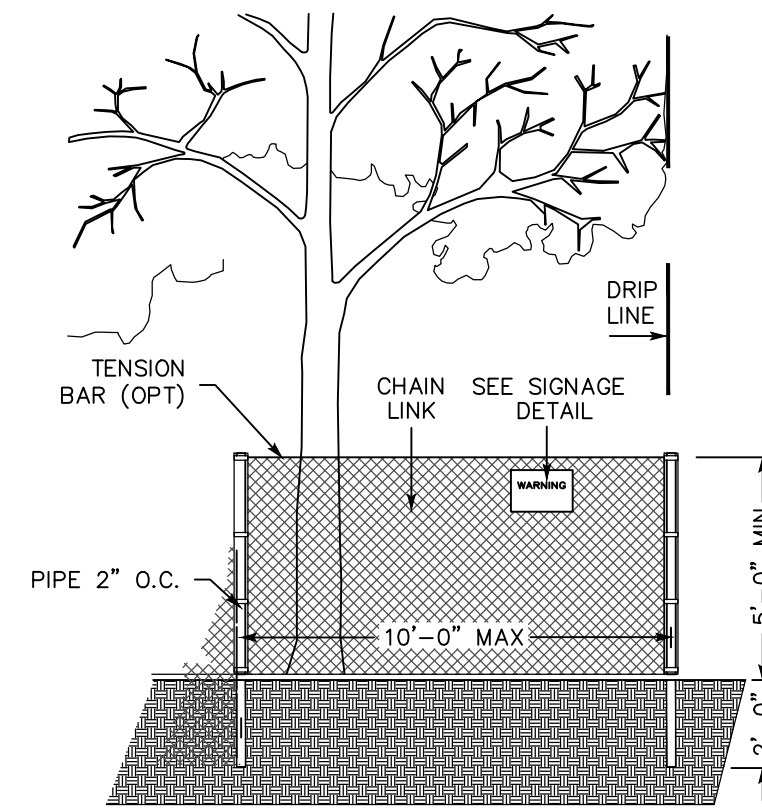

EXISTING TREE PROTECTION DETAILS

- PRIOR TO THE COMMENCEMENT OF ANY GRADING, TREE PROTECTIVE FENCING SHALL BE IN PLACE IN ACCORDANCE WITH THE TREE PRESERVATION PLAN AND INSPECTED BY A CERTIFIED ARBORIST. THE ARBORIST SHALL MONITOR CONSTRUCTION ACTIVITY TO ENSURE THAT THE TREE PROTECTION MEASURES ARE MAINTAINED AND ADHERED TO DURING CONSTRUCTION. THIS CONDITION SHALL BE INCORPORATED INTO THE GRADING PLANS.
- FENCE SHALL BE MINIMUM 5 FEET TALL CONSTRUCTED OF STURDY MATERIAL (CHAIN-LINK OR EQUIVALENT STRENGTH/ DURABILITY).
- FENCE SHALL BE SUPPORTED BY VERTICAL POSTS DRIVEN 2 FEET (MIN) INTO THE GROUND AND SPACED NOT MORE THAN 10 FEET APART.
- TREE FENCING SHALL BE MAINTAINED THROUGHOUT THE SITE DURING THE CONSTRUCTION PERIOD, INSPECTED PERIODICALLY FOR DAMAGE AND PROPER FUNCTION, REPAIRED AS NECESSARY TO PROVIDE A PHYSICAL BARRIER FROM CONSTRUCTION ACTIVITIES, AND REMAIN IN PLACE UNTIL THE FINAL INSPECTION.
- A SIGN THAT INCLUDES THE WORDS, "WARNING: THIS FENCE SHALL NOT BE REMOVED WITHOUT THE EXPRESSED PERMISSION OF THE SANTA CLARA COUNTY PLANNING OFFICE," SHALL BE SECURELY ATTACHED TO THE FENCE IN A VISUALLY PROMINENT LOCATION.

APPROVED FOR ISSUANCE REFER TO ENCROACHMENT AND/OR CONSTRUCTION PERMIT AND PLAN COVER SHEET FRO SPECIAL CONDITIONS AND PERMIT NUMBERING

ENGINEER'S CERTIFICATION:

THIS PLAN WILL NOT IMPOSE A DRAINAGE, GRADING OR FLOODING HAZARD TO SURROUNDING PROPERTIES.

Peter P. Moua
PETER PAO MOUA, P.E.
LIC. NO. C61918

4/15/24
DATE

SHEET INDEX

1	COVER SHEET
2	GRADING PLAN
3	GRADING PLAN
4	OFFSITE STREET IMPROVEMENT
5	EROSION CONTROL PLAN
6	DETAILS
7	DETAILS
8	DETAILS
9	STANDARD TRAFFIC CONTROL PLANS
10	STANDARD TRAFFIC CONTROL PLANS

ENGINEER'S NAME: PETER P. MOUA, PE/LS
CENTRAL VALLEY ENGINEERING AND SURVEYING
2132 HIGH STREET
SELMA, CA 93662
PHONE NO.(559) 891-8811


Revision	1	3/21/18	APN	712-27-012	Sheet
Revision	2	5/24/18	Co. File		1 of 10
Revision	3	7/26/18			

APPLICANT: GURDEEP DHADWAL

ROAD: PALM AVENUE

COUNTY FILE NO.: 9470-14B

ALL IDEAS, DESIGNS, APPROPRIATIONS AND PLANS INDICATED OR REPRESENTED BY THIS DRAWING ARE OWNED BY AND THE PROPERTY OF CVEAS OR CONSULTANTS, AND HAVE BEEN CREATED, EVOLVED AND DEVELOPED FOR USE ON AND IN CONNECTION WITH THE SPECIFIC PROJECT HAVE OF SUCH IDEAS, DESIGNS, APPROPRIATIONS OR PLANS SHALL BE USED BY OR DISCLOSED TO ANY PERSON, FIRM OR CORPORATION FOR ANY PURPOSE WHATSOEVER WITHOUT THE WRITTEN PERMISSION OF CVEAS. ANY REPRODUCTION OR USE THEREOF IS PERMISSIBLE WITHOUT THE CONSENT OF CVEAS.

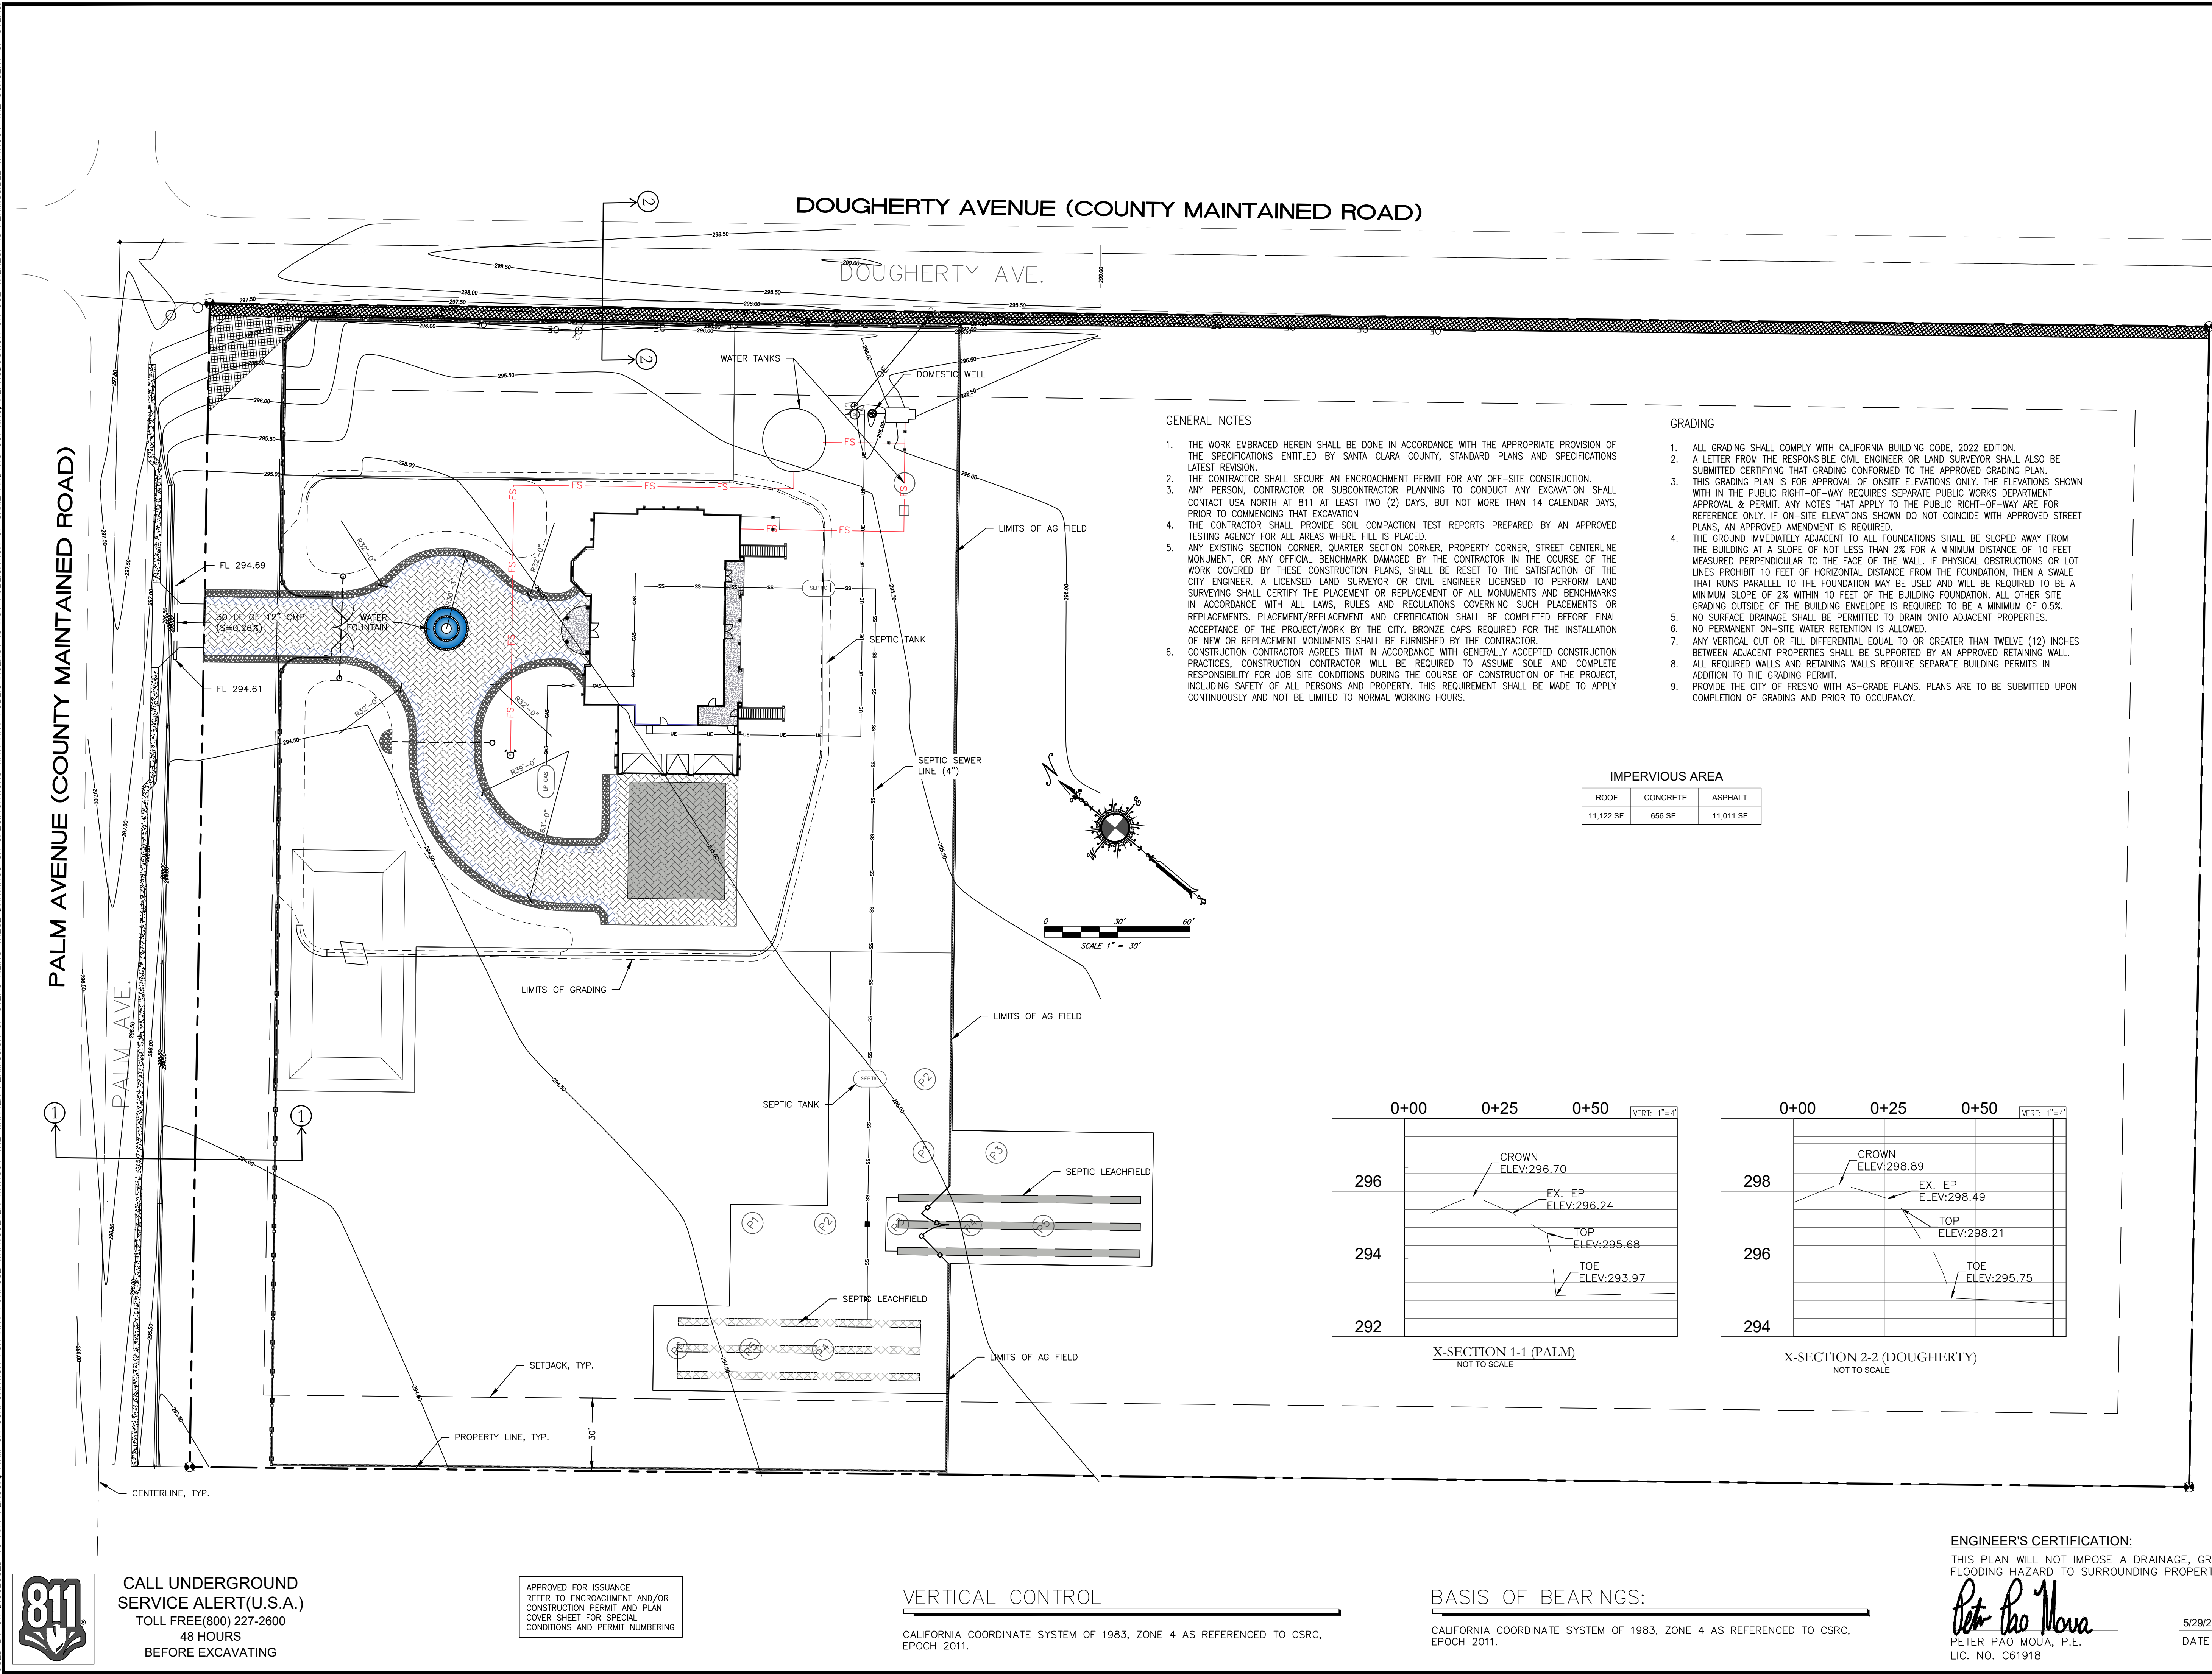

Revisions:	Date:
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GRADING PLAN

CVEAS Job #:	16067
Current Release Date:	xxxx
Drawn By:	PM
Planning Submittal Date:	xxxx
P.C. Submittal Date:	
Checked By:	RL
Scale:	AS NOTED







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CVEAS Job # :	16067
Current Release Date:	xxxx
Drawn By:	PM
Planning Submittal Date:	xxxx
F.C. Submittal Date:	
Checked By:	RL
Scale:	AS NOTED


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OF
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1. SAWCUT AND REPAVE A MINIMUM OF 1-FT OF PLAM AVENUE ALONG DRIVEWAY AND PROPERTY FRONTAGE.
2. RESTRIPE FOG LINE IN SAWCUT AREA IN KIND WITH 4-INCH WHITE REFLECTIVE PAVEMENT MARKINGS AND AS REQUESTED BY COUNTY INSPECTOR AND/OR ENGINEER.
3. ALL SAWCUT SPOILS SHALL BE VACUUMED.
4. OFF HAUL ALL CONSTRUCTION SPOILS AND DEBRIS TO AN APPROPRIATE DUMP FACILITY.
5. INSTALL AND MAINTAIN PROPER BMPs THROUGHOUT THE DURATION OF CONSTRUCTION.
6. INSTALL AND MAINTAIN TRAFFIC CONTROL IN ACCORDANCE WITH THE MUTCD.




5/29/2024
DATE

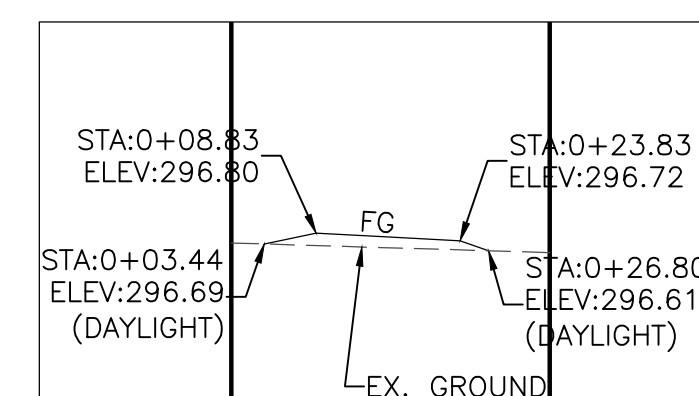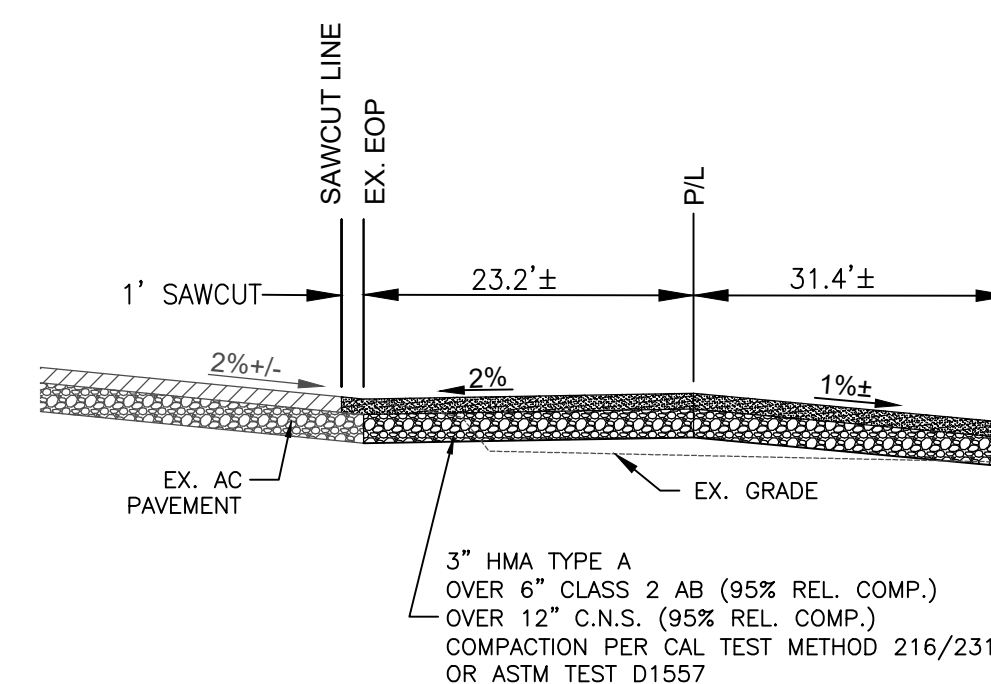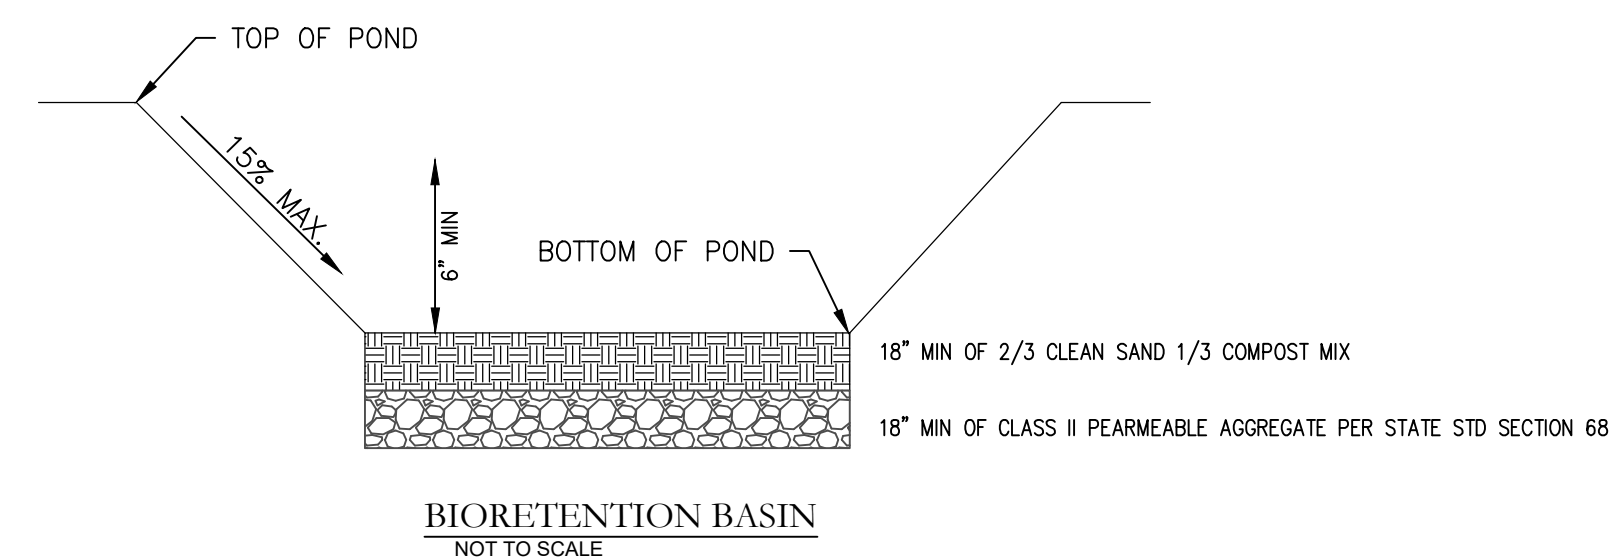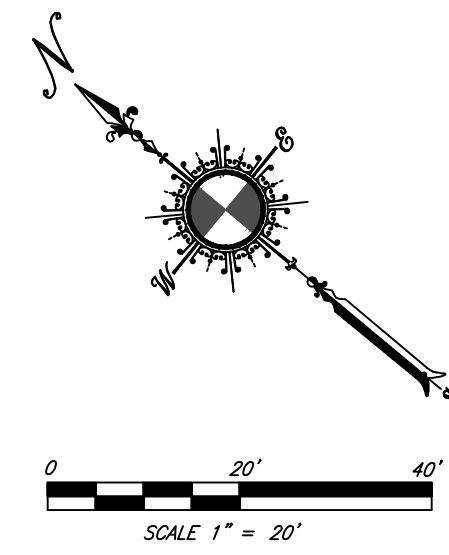CUT = 90 CUBIC YARDS
FILL = 1465 CUBIC YARDS
NET FILL = 1375 CUBIC YARDS
DISTURBED AREA = 43,745 SF

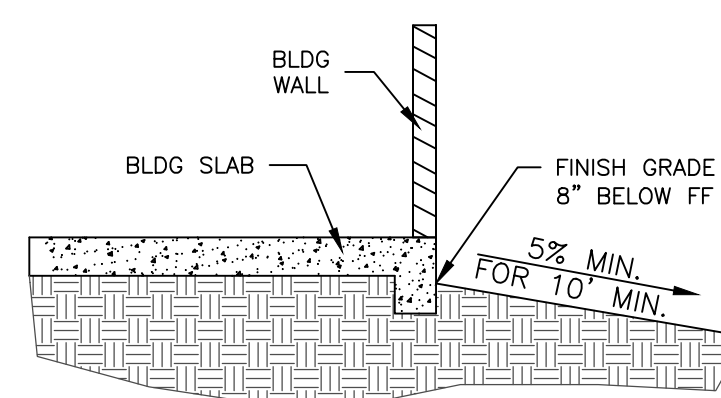

DRAIN AWAY FROM BLDG
NTS

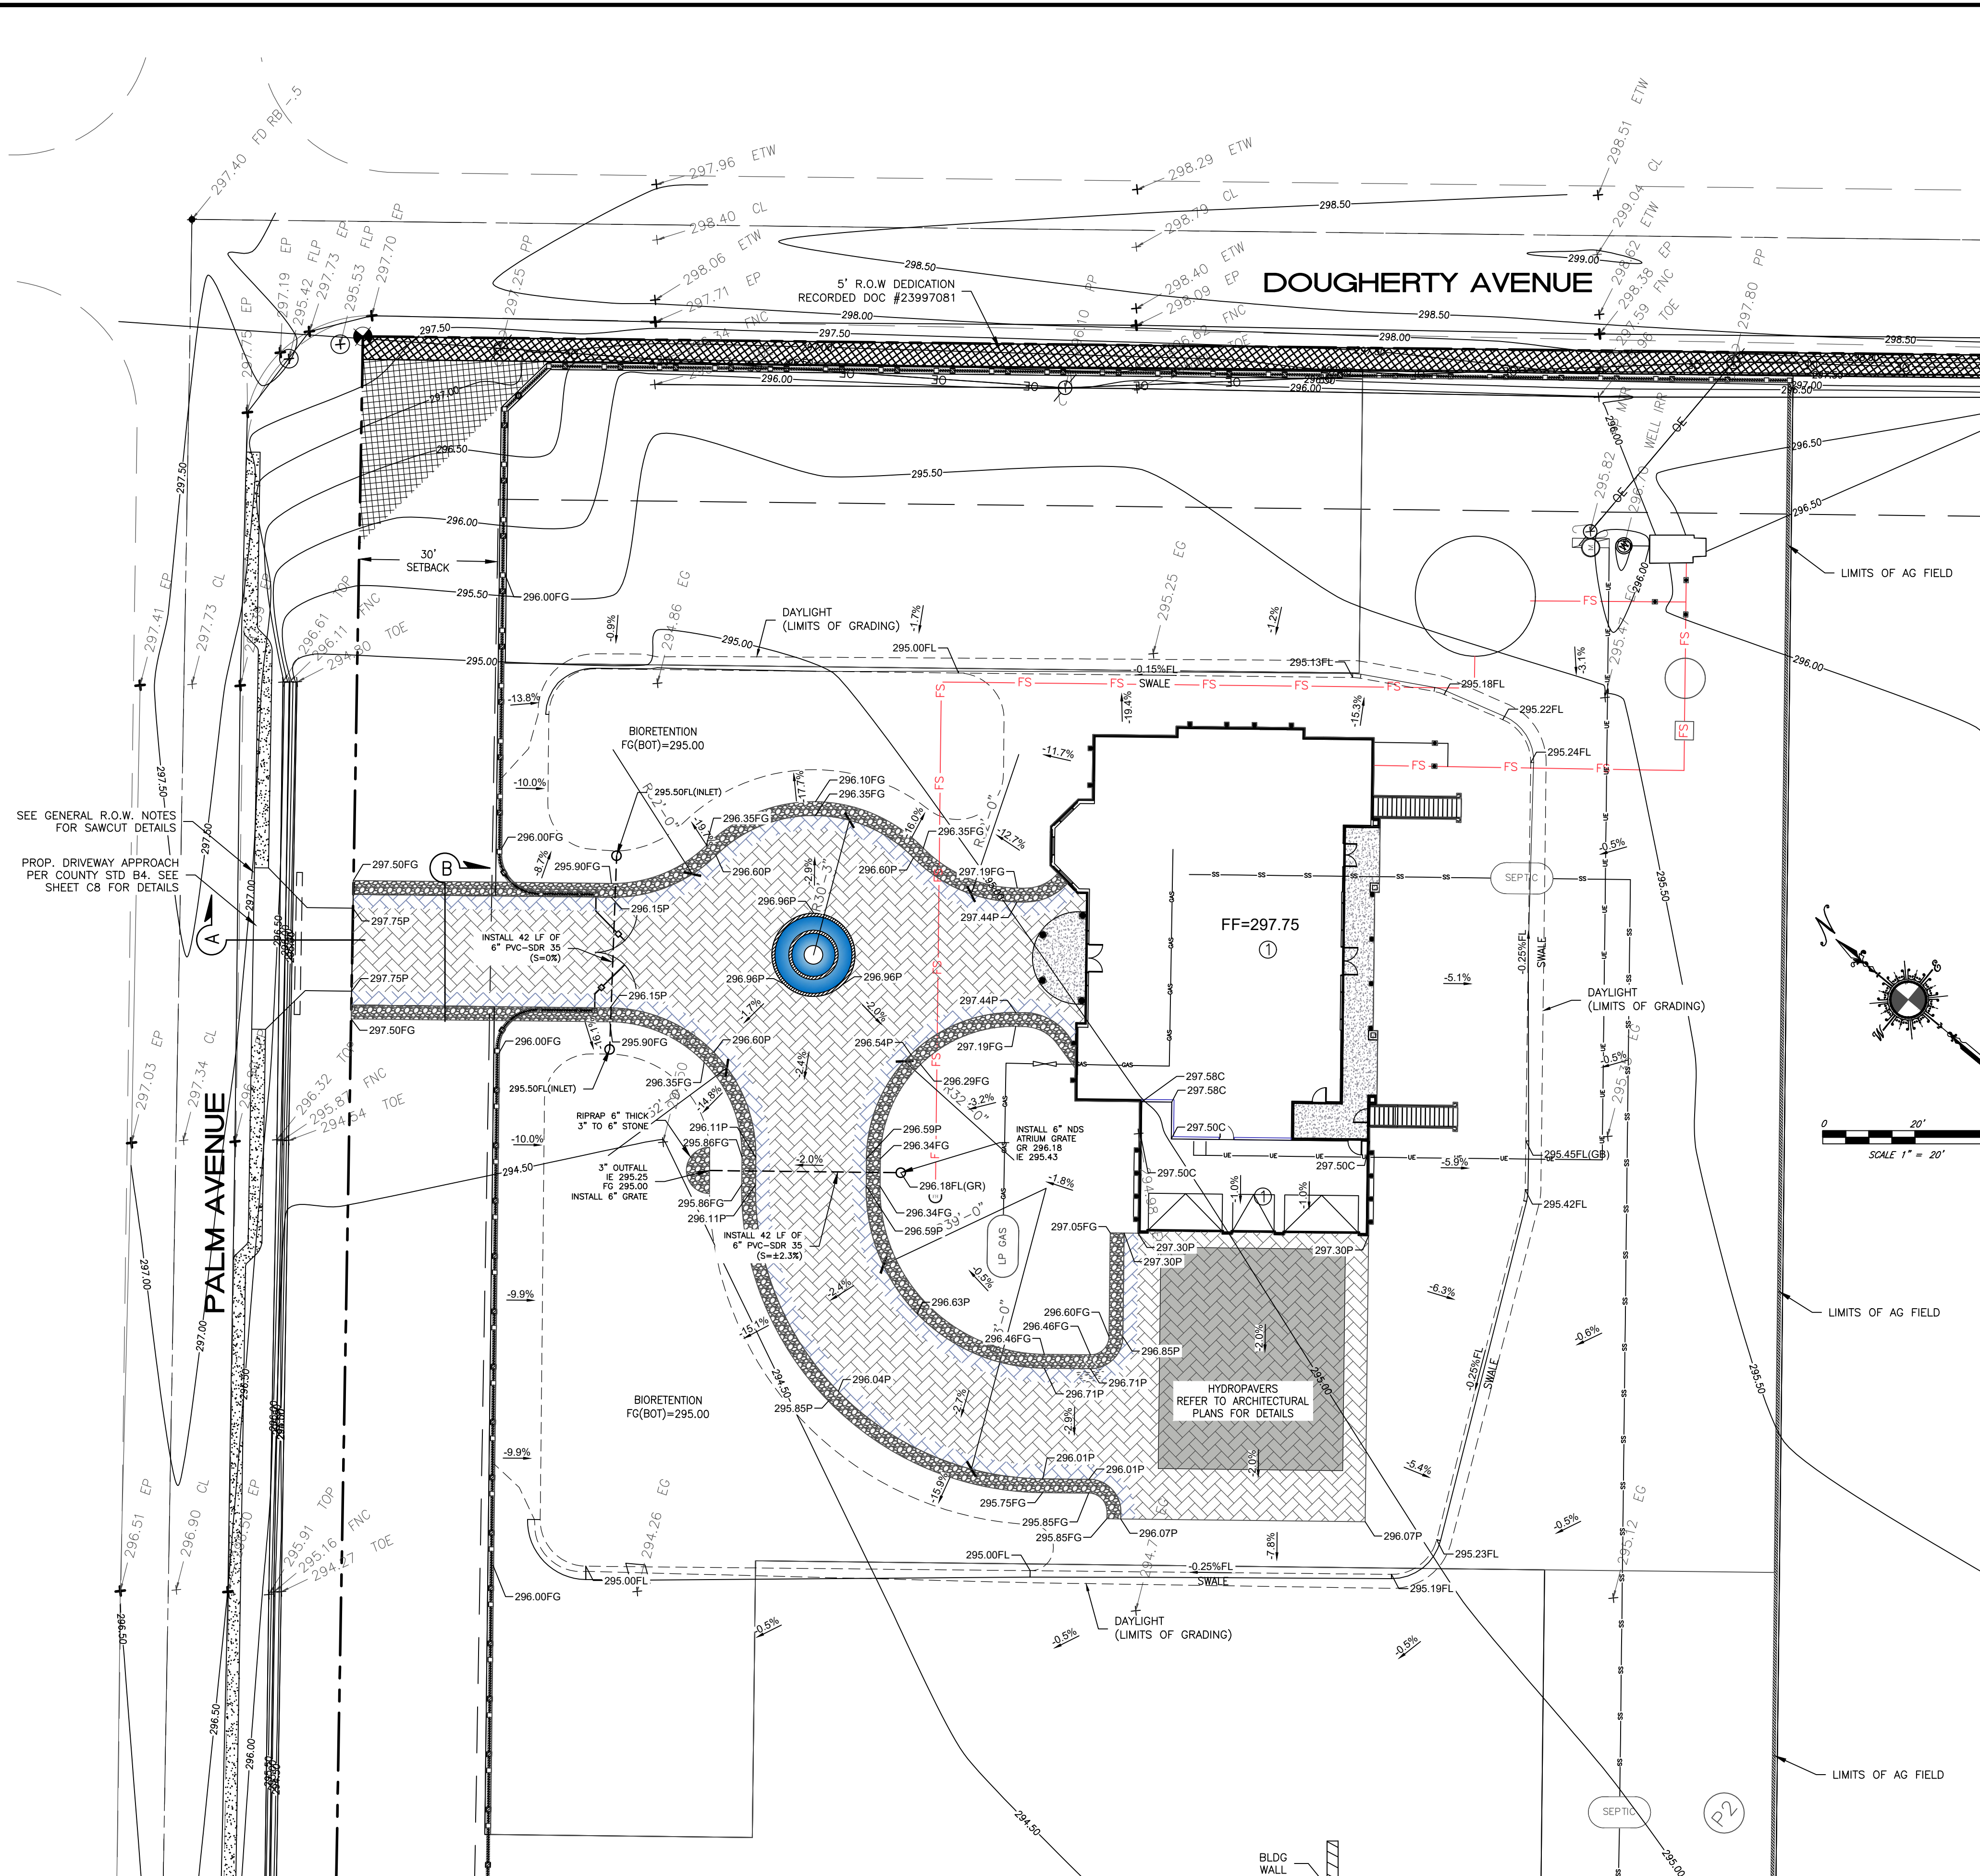

**CALL UNDERGROUND
SERVICE ALERT(U.S.A.)
TOLL FREE(800) 227-2600
48 HOURS
BEFORE EXCAVATING**

C:\USERS\PETER\DROPBOX\ME20\ME-453 MORGAN HILL\MORGAN HILL GRADING C2-3 V4.DWG

COUNTY FILE NO.: 9470-14B

FILE LAST MODIFIED 5/29/2024

ALL IDEAS, DESIGNS, APPROPRIATIONS AND PLANS INDICATED OR REPRESENTED BY THIS DRAWING ARE OWNED BY AND THE PROPERTY OF CVEAS OR CONSULTANTS, AND WERE CREATED, EVOLVED AND DEVELOPED FOR USE ON AND IN CONNECTION WITH THE SPECIFIED PROJECT. HAVE OF SUCH IDEAS, DESIGNS, APPROPRIATIONS OR PLANS SHALL BE USED BY OR DISCLOSED TO ANY PERSON, FIRM OR CORPORATION FOR ANY PURPOSE WHATSOEVER WITHOUT THE WRITTEN PERMISSION OF CVEAS. ANY VIOLATION OF THIS PERMISSION SHALL BE PUNISHED BY LAW. NO PART OF THIS DRAWING IS TO BE REPRODUCED, COPIED, REPRODUCED OR USED THEREOF IS PERMISSIBLE WITHOUT THE CONSENT OF CVEAS.



CALL UNDERGROUND
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CVEAS
CENTRAL VALLEY
ENGINEERING & SURVEYING, INC.
2132 HIGH STREET
SELMA, CA 93662
WWW.CVEAS.COM

Tel. (559) 891-8811
Fax (559) 891-8815
Email: info@cveas.com

PROJECT



NEW RESIDENCE FOR:
GURDEEP DHADWAL
PALM AVE AND DOUGHERTY AVE
MORGAN HILL, CA 95037
APN: 712-27-012

Revisions:	Date:

HALF STREET
IMPROVEMENT

CVEAS Job #:	16067
Current Release Date:	xxxx
Drawn By:	PM
Planning Submittal Date:	xxxx
P.C. Submittal Date:	
Checked By:	RL
Scale:	AS NOTED


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ENGINEER'S CERTIFICATION:
THIS PLAN WILL NOT IMPOSE A DRAINAGE, GRADING OR
FLOODING HAZARD TO SURROUNDING PROPERTIES.

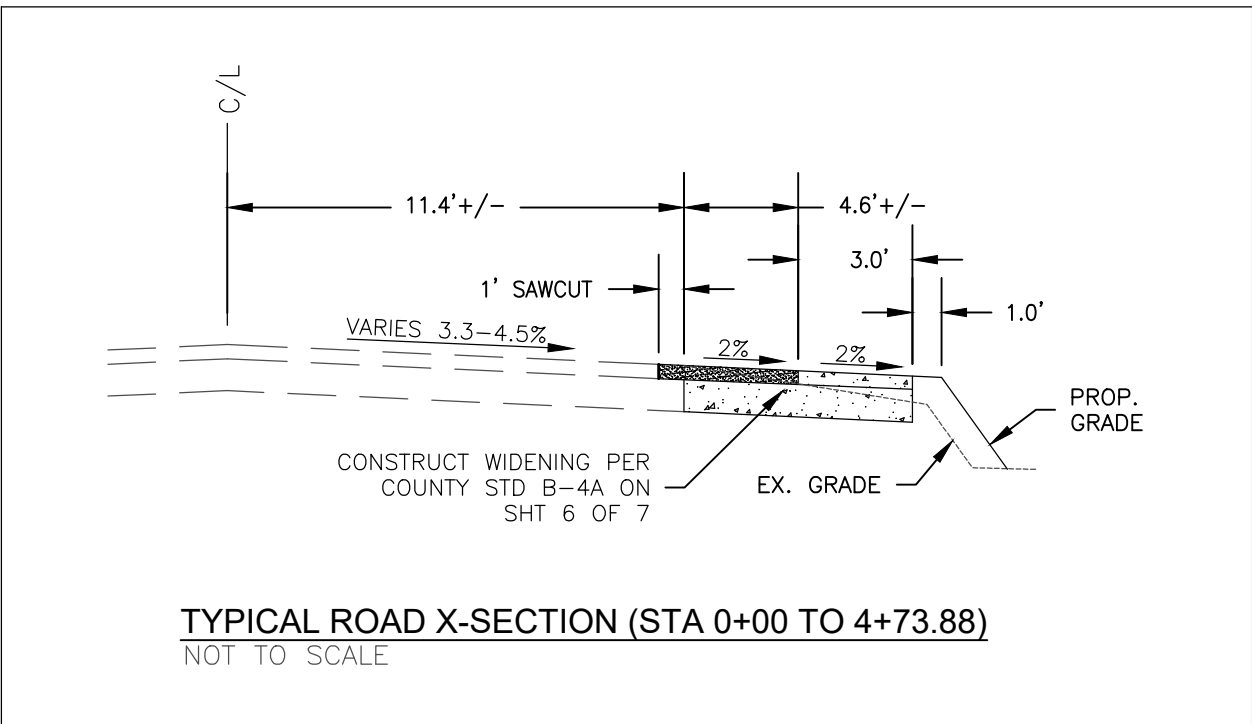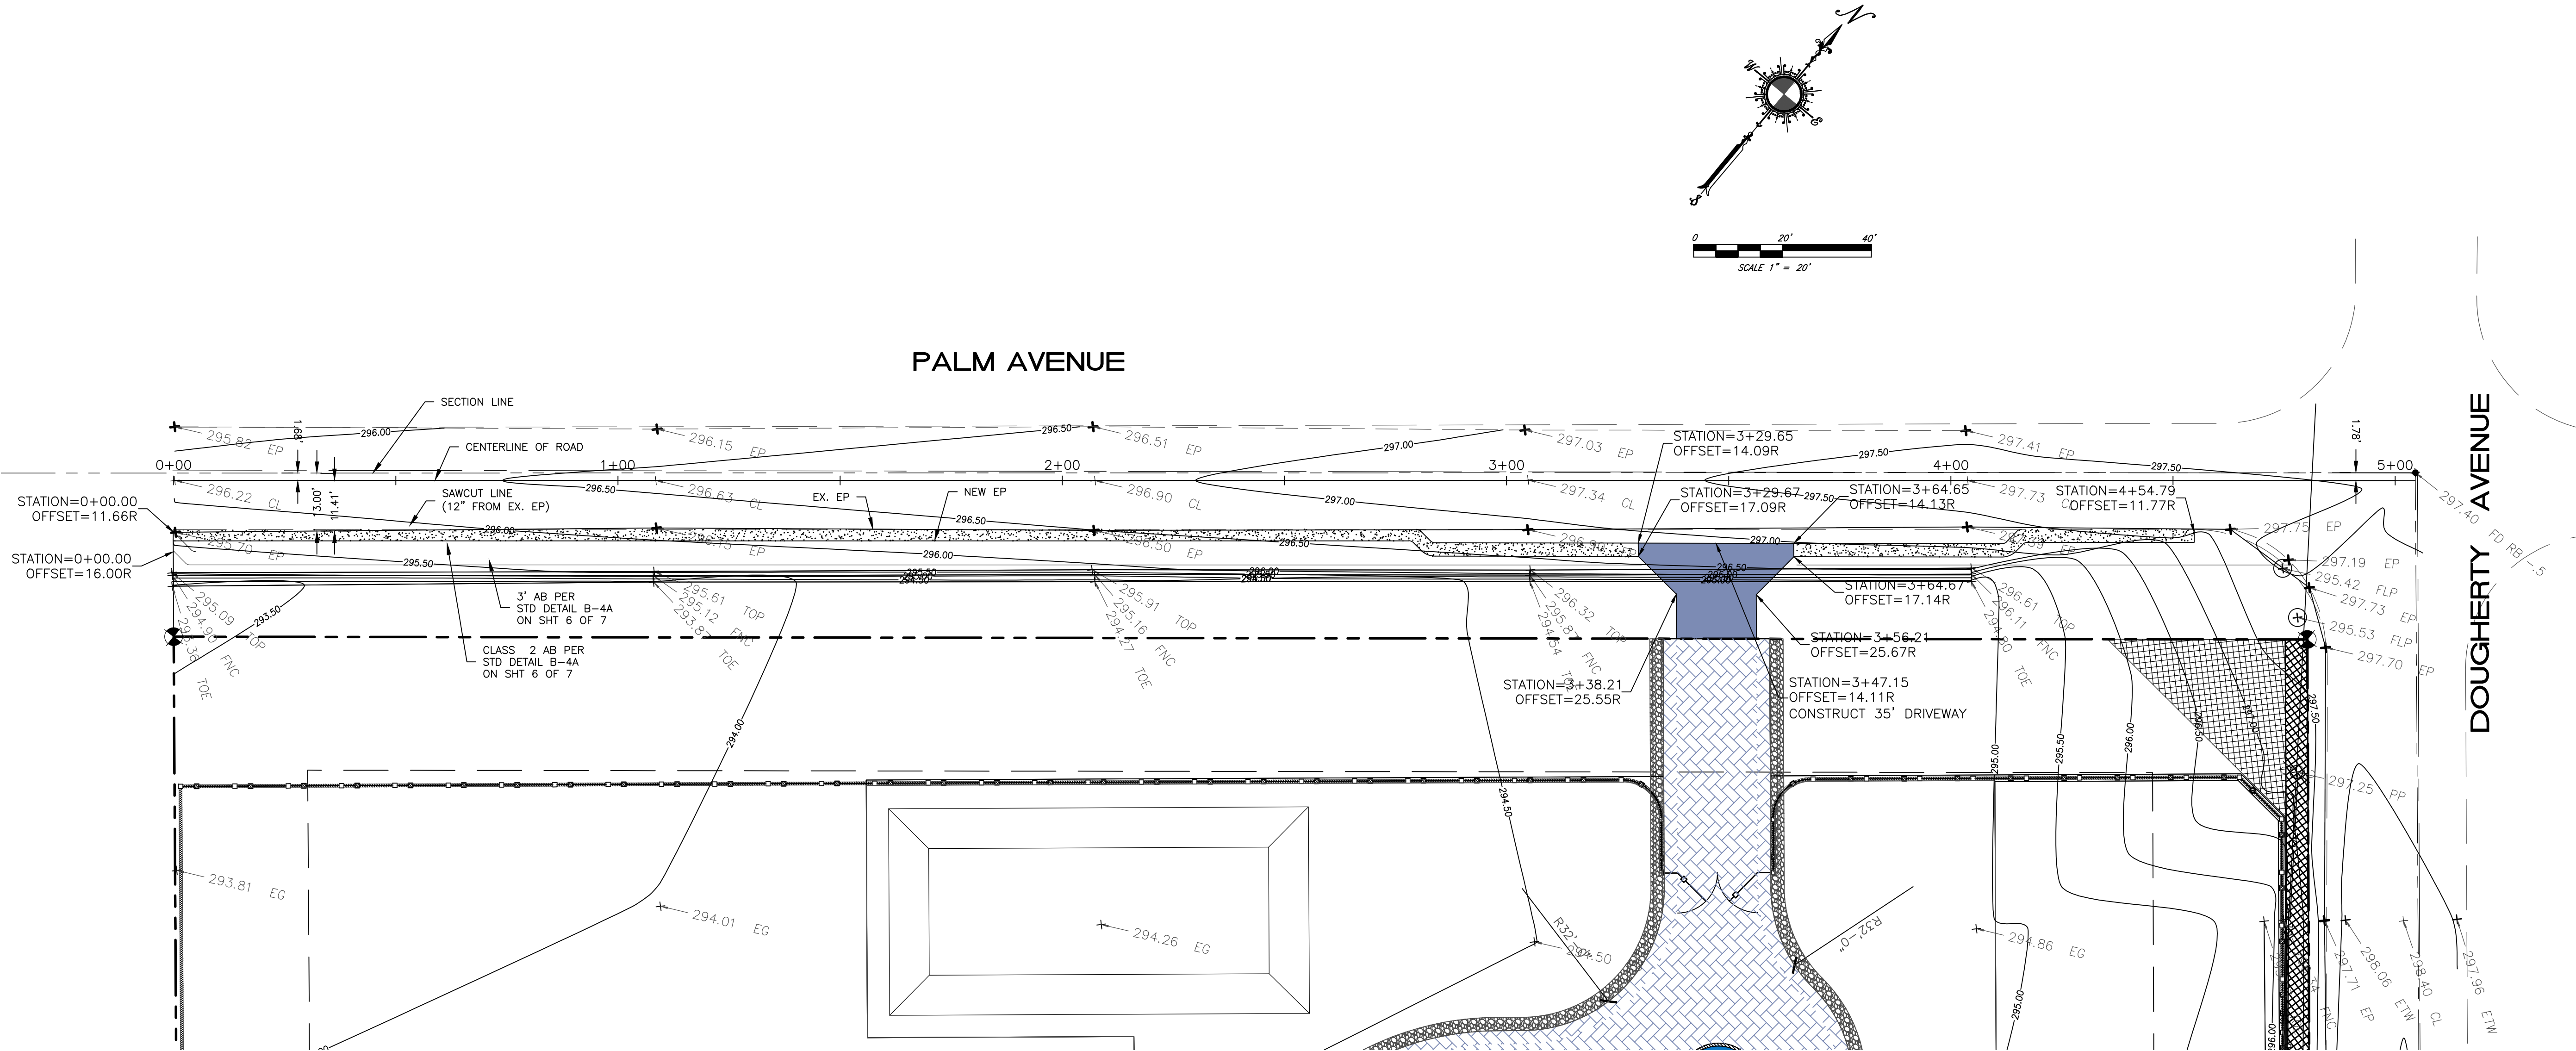
PETER PAO MOUA, P.E.
LIC. NO. C61918
4/15/2024
DATE

ALL UTILITIES, INCLUDING, BUT NOT LIMITED TO, WATER, GAS, ELECTRIC, AND TELEPHONE, SHALL BE LOCATED AND DEPTH INDICATED ON THIS PLAN. ANY CHANGES TO THE LOCATION OR DEPTH OF UTILITIES SHALL BE INDICATED ON THE PLAN. THE CONTRACTOR SHALL BE RESPONSIBLE FOR VERIFYING THE LOCATION AND DEPTH OF UTILITIES PRIOR TO CONSTRUCTION. ANY CHANGES TO THE LOCATION OR DEPTH OF UTILITIES SHALL BE INDICATED ON THE PLAN. THE CONTRACTOR SHALL BE RESPONSIBLE FOR VERIFYING THE LOCATION AND DEPTH OF UTILITIES PRIOR TO CONSTRUCTION.




1 EROSION CONTROL PLAN

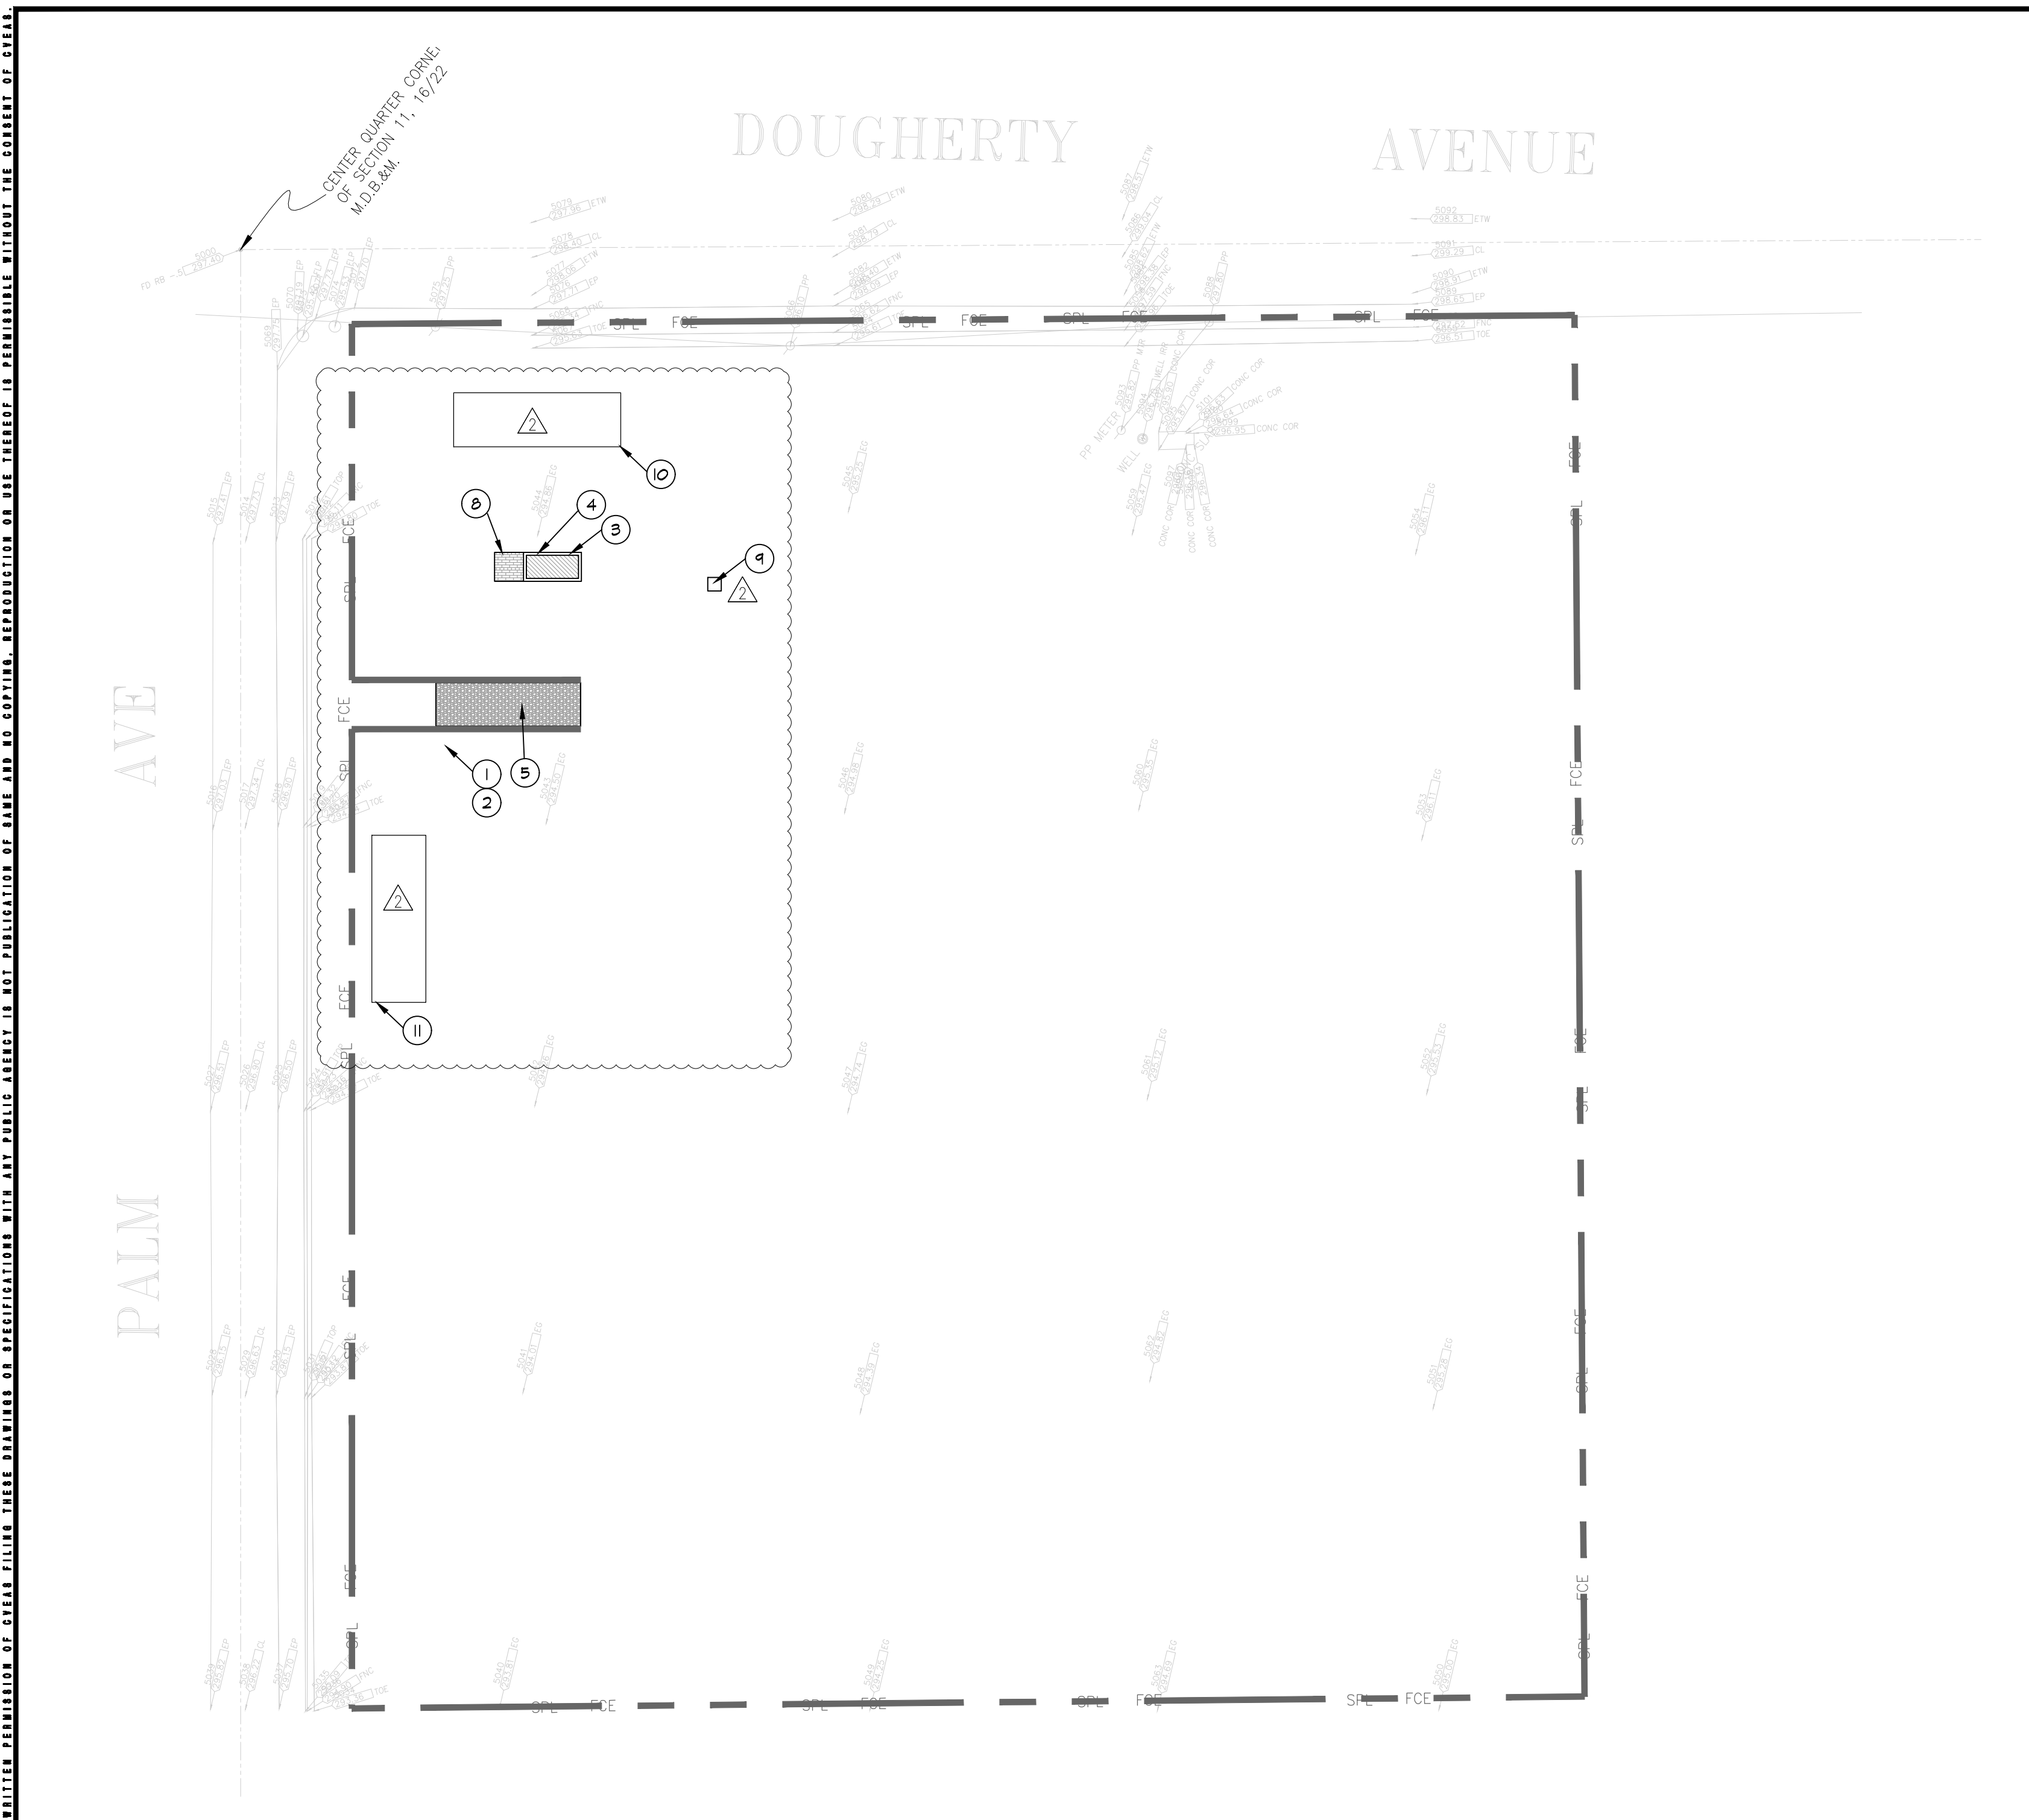SCALE: 1"=40'

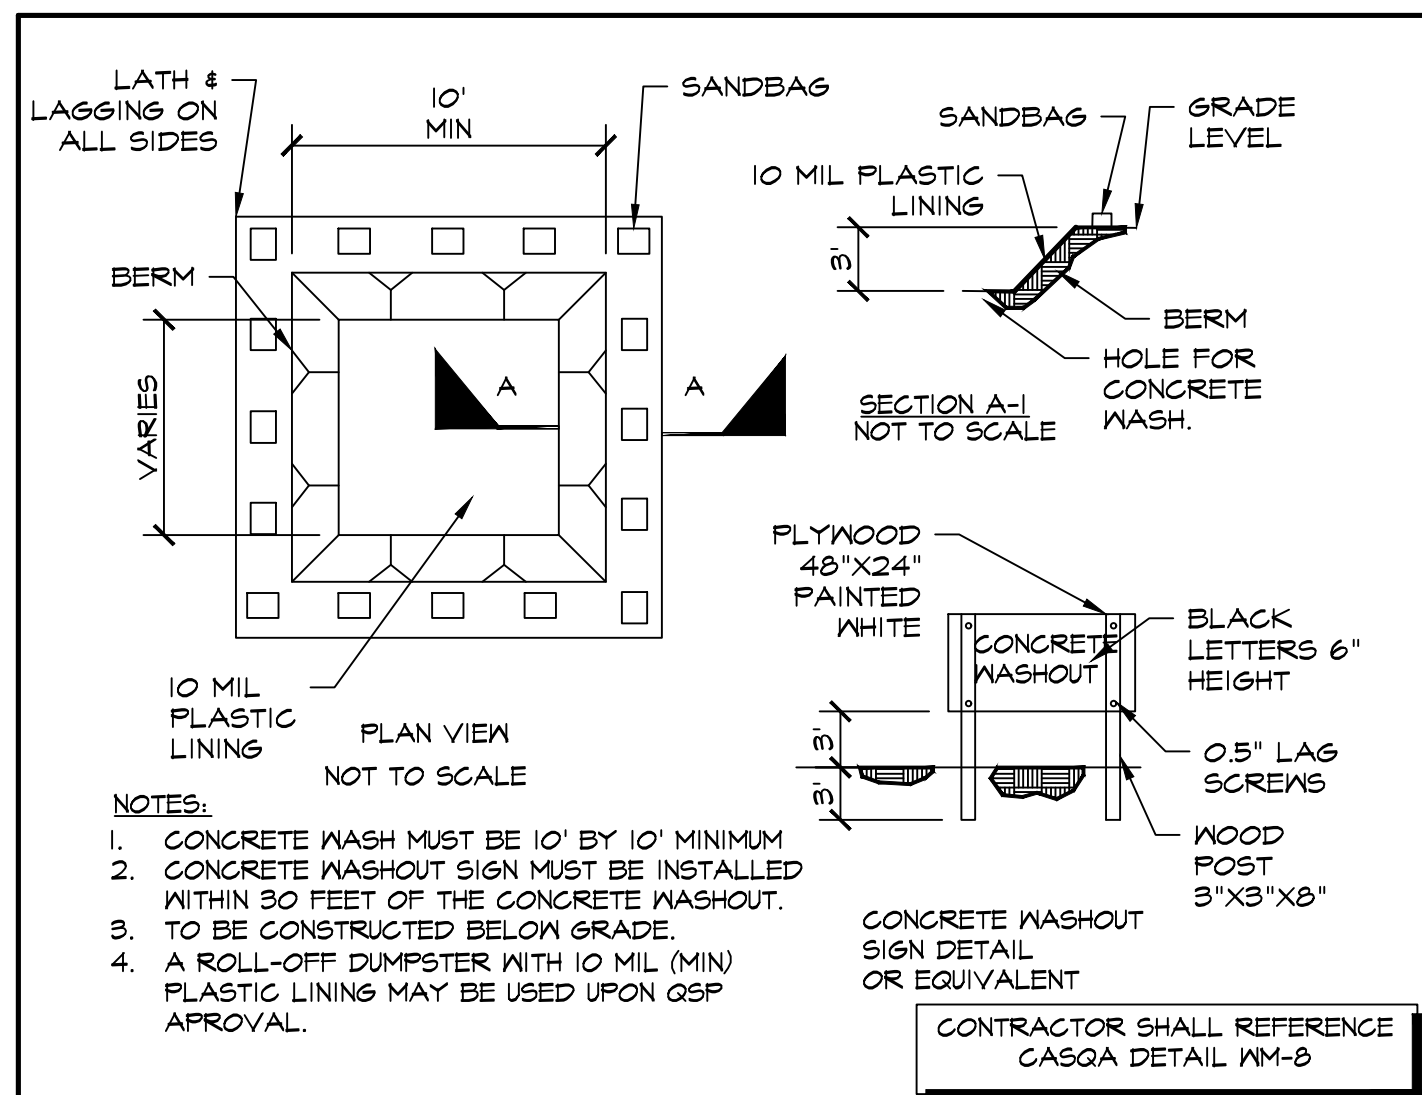



E GRAVEL INLET PROTECTION

NOT TO SCALE

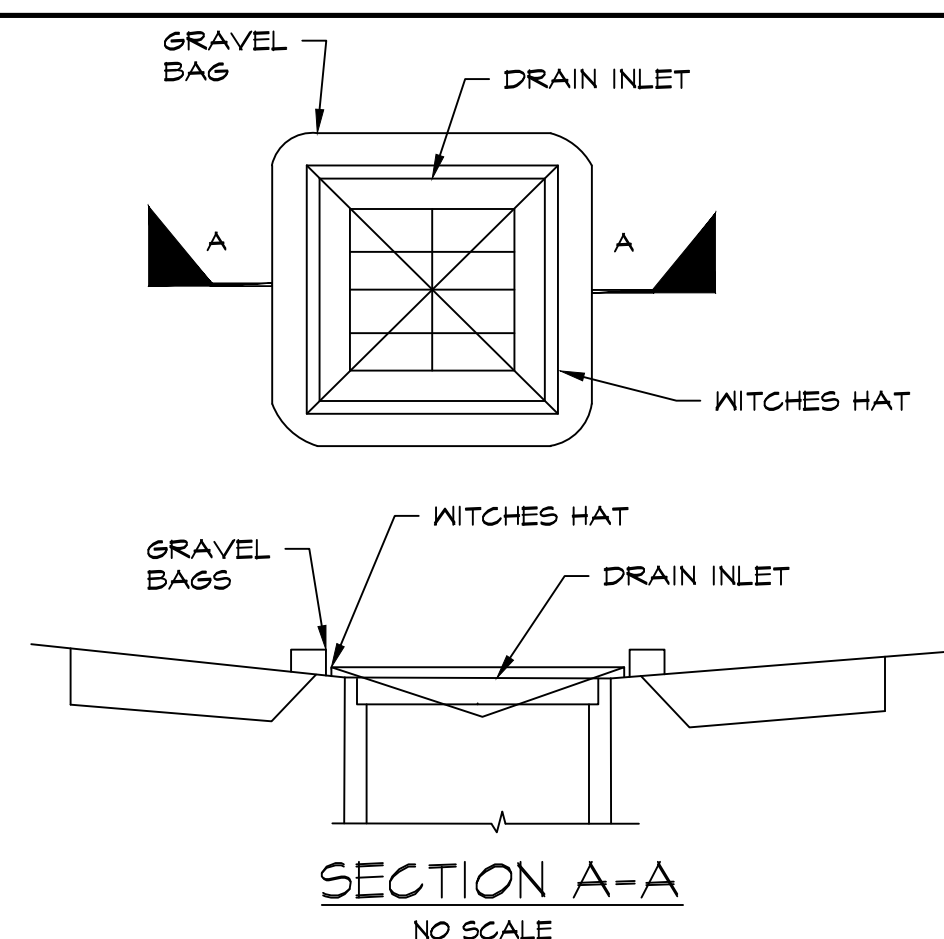


D GRATE INLET PROTECTION

NOT TO SCALE

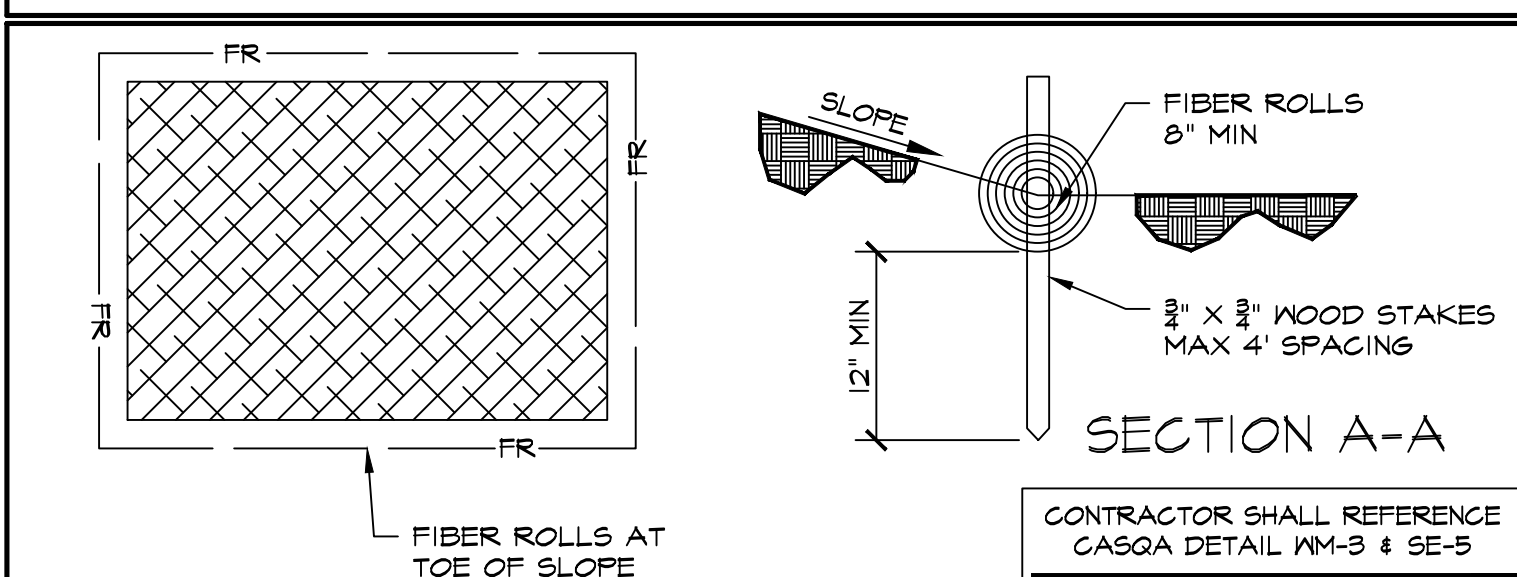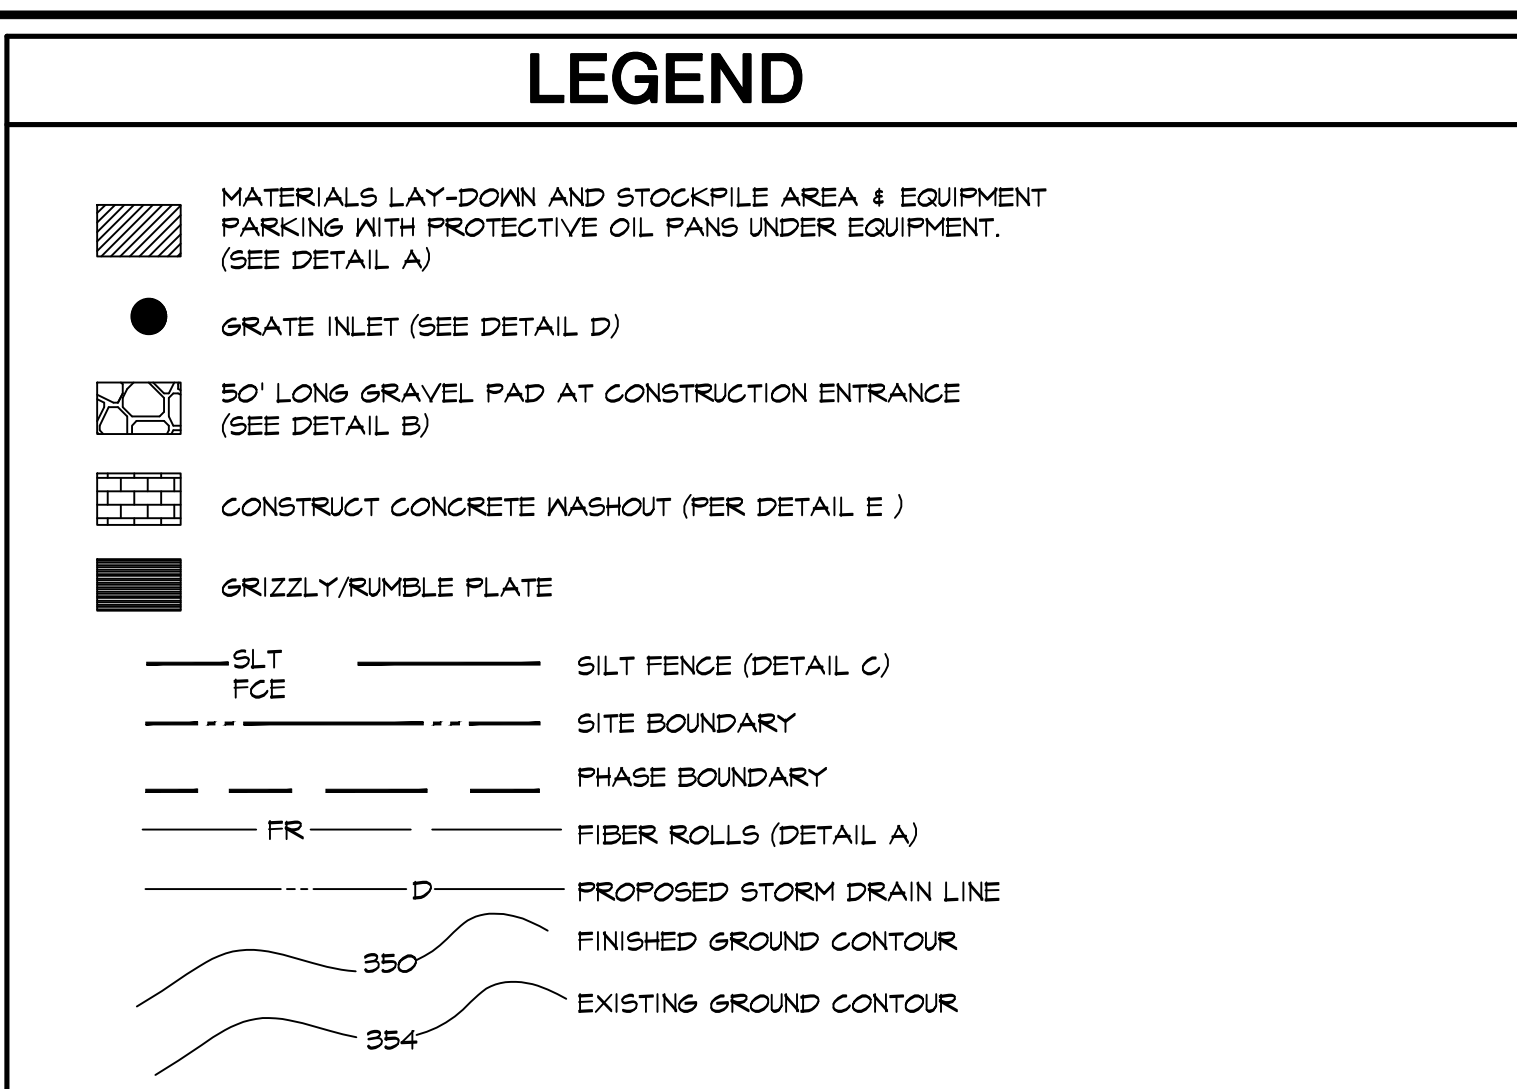


A STOCKPILE WITH FIBER ROLLS

NOT TO SCALE

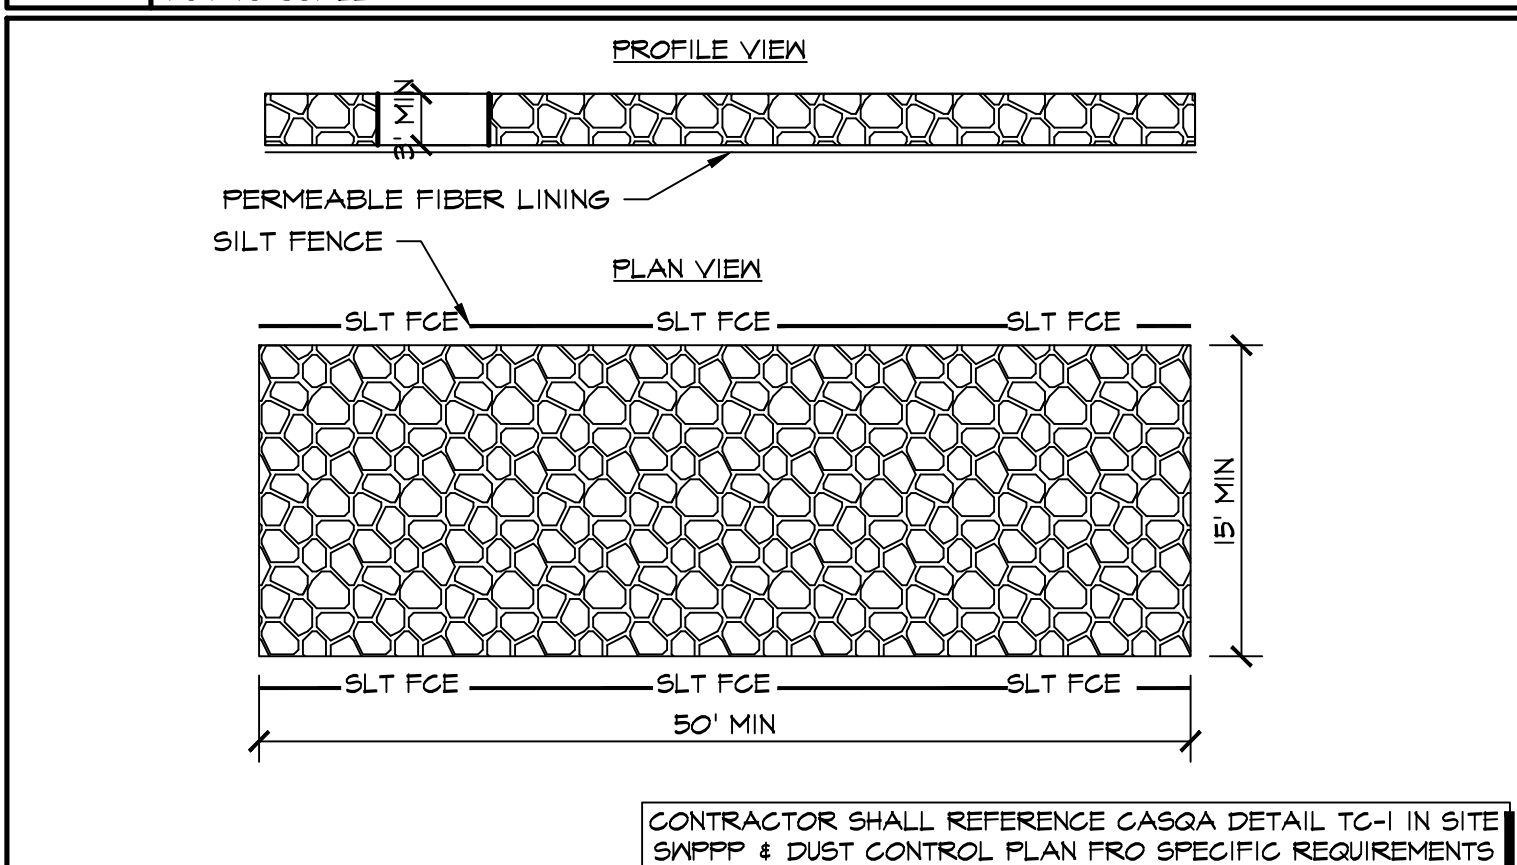

B GRAVEL APRON AT CONST. ENTRANCE

NOT TO SCALE

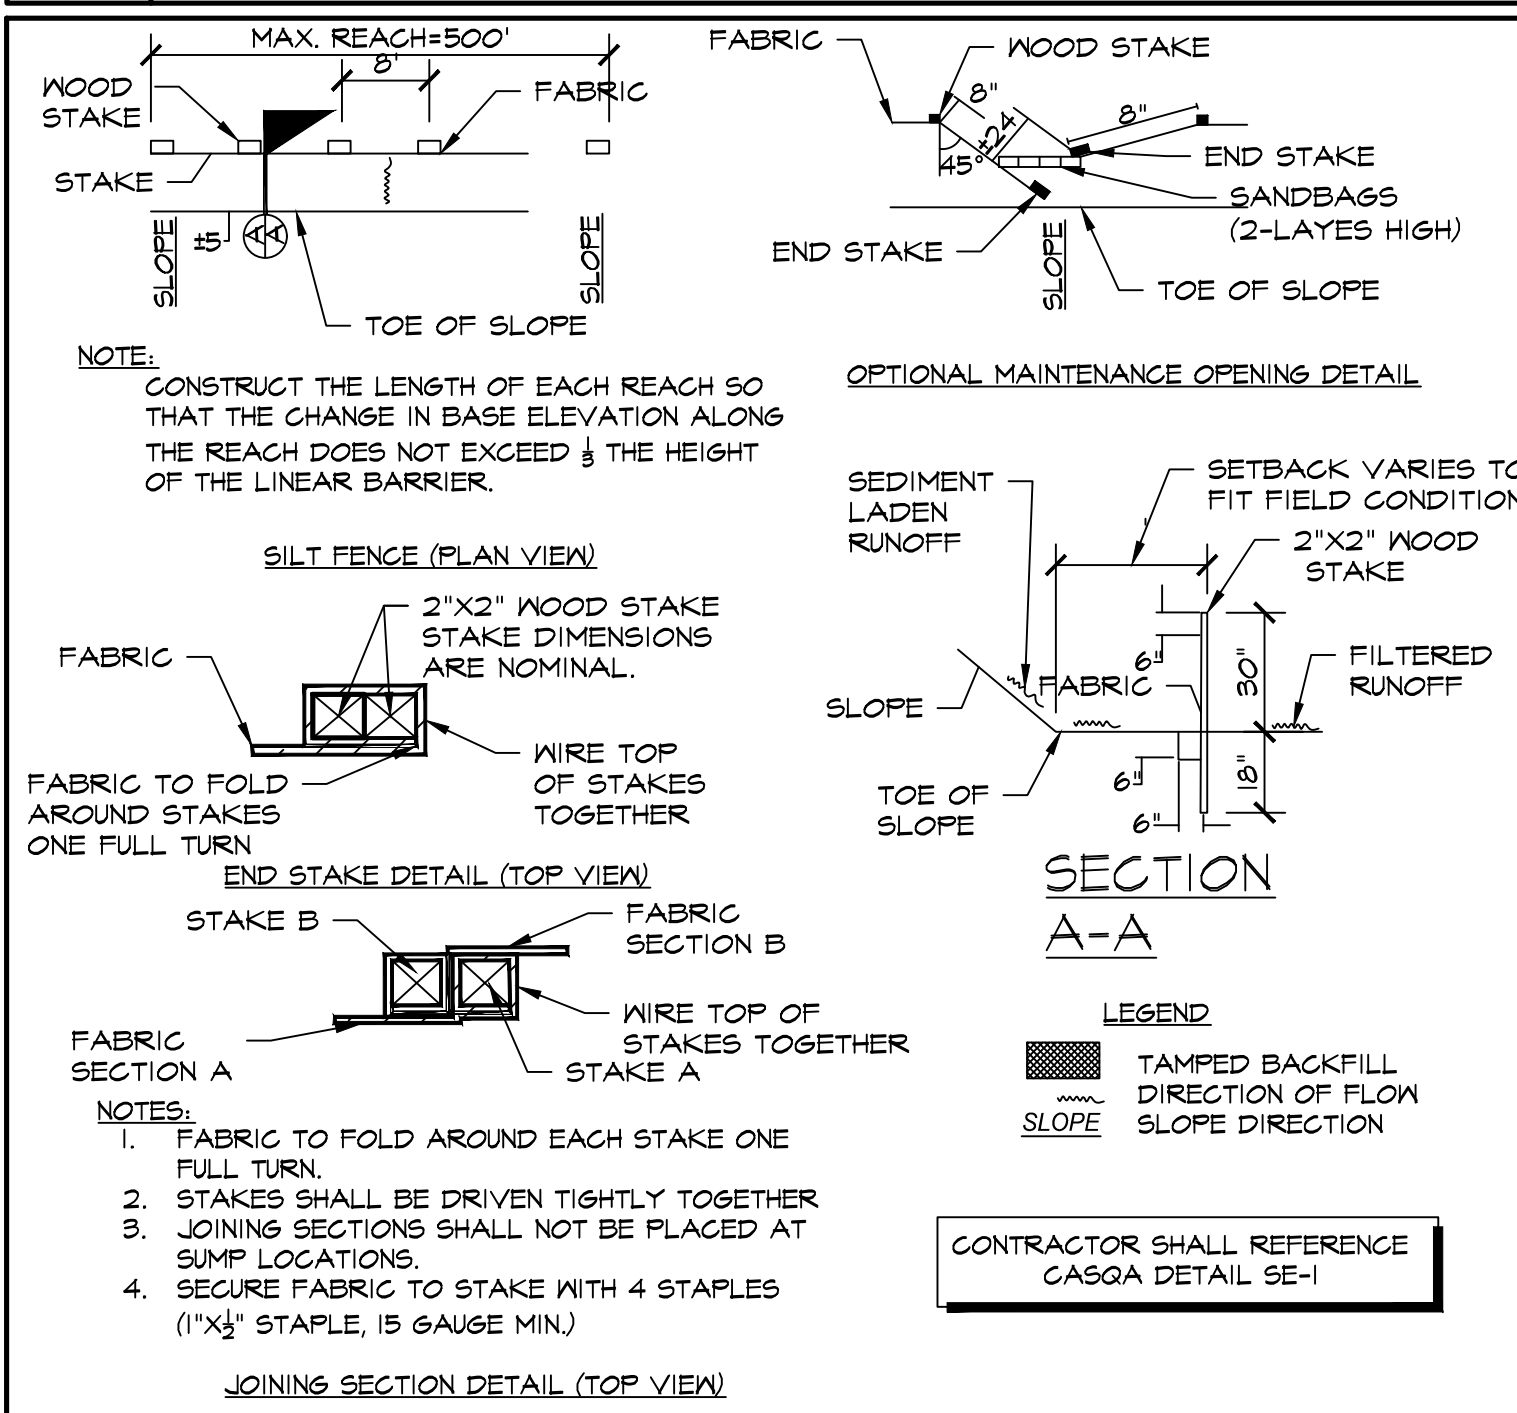

C SILT FENCE

NOT TO SCALE

STORMWATER POLLUTION PREVENTION NOTES:


- EROSION CONTROL DEVICES SHOWN ON THIS PLAN MAY BE REMOVED WHEN APPROVED BY THE QUALIFIED SWPPP DEVELOPER (GSD) OR THE QUALIFIED SWPPP PRACTITIONER (GSP).
- GRADED AREAS ADJACENT TO FILL SLOPES LOCATED AT THE SITE PERIMETER MUST DRAIN AWAY FROM THE TOP OF THE SLOPE AT THE COMPLETION OF EACH WORKING DAY OR EROSION CONTROL BMP'S MUST BE IN PLACE. (EG1-EG13)
- THE USE OF A GRAVEL BLANKET AT CONSTRUCTION ENTRANCES WITH PUBLIC ROADS IS REQUIRED AT ALL TIMES DURING CONSTRUCTION. (TC-1)
- THE CONTRACTOR SHALL RESTRICT TRAFFIC AND POST 15 MPH SPEED LIMITS ON THE SITE TO REDUCE DUST. (NE-1)
- CONTRACTOR SHALL WATER THE SITE AS NEEDED TO ELIMINATE DUST. (MINIMUM OF 650 GALLONS/AC. AND ONCE DAILY, (NE-1))
- CONSTRUCTION EQUIPMENT SHALL BE PARKED, WHEN NOT IN USE AND FOR MAINTENANCE, IN DESIGNATED AREA (NS-8/10).
- SILT FENCING, STRAW BALES AND SANDBAGS WILL BE INSTALLED AS DIRECTED BY THE GSD/GSP, AS NEEDED. (SE-1/SE-1SE-6/SE-9/SE-11)
- EXCEPT AS OTHERWISE APPROVED BY THE GSD/GSP, ALL REMOVABLE PROTECTIVE DEVICES SHOWN SHALL BE IN PLACE AT THE END OF EACH WORKING DAY OR ON WEEKENDS WHEN THE 48-HOUR RAIN PROBABILITY FORECAST EXCEEDS 50%.
- ALL LOOSE SOIL AND DEBRIS, WHICH MAY CREATE A POTENTIAL HAZARD TO OFFSITE PROPERTY, SHALL BE REMOVED FROM THE SITE AS DIRECTED BY THE GSP.
- THE PLACEMENT OF ADDITIONAL DEVICES TO REDUCE EROSION DAMAGE WITHIN THE SITE IS AT THE DISCRETION OF THE GSP.
- EROSION CONTROL DEVICES WILL BE MODIFIED AS NEEDED AS THE PROJECT PROGRESSES AND PLANS OF THESE CHANGES SUBMITTED FOR APPROVAL AS REQUIRED.
- ALL SILT AND DEBRIS SHALL BE REMOVED FROM ALL DEVICES WITHIN 24 HOURS AFTER EACH RAINSTORM.
- THIS PLAN HAS BEEN CREATED AS A BEGINNING CONCEPT ONLY. IF BMP'S SHOWN ARE DEEMED INEFFECTIVE OR UNNECESSARY, GSP IS TO REMOVE OR SELECT ALTERNATIVE BMP'S FROM CASQA'S HANDBOOK AND REDLINE THIS PLAN AS NEEDED.
- WHILE NOT ALL THE LISTED BMP'S ARE NOT INCLUDED IN THE SPECIFIC TEXT OF THE EROSION CONTROL PLAN, MANY OF THESE ITEMS ARE STILL NECESSARY TO ADDRESS SPECIFIC CONSTRUCTION PROCESSES THE CONTRACTOR PLANS IMPLEMENT. THESE ITEMS SUCH AS REFUELING STATIONS, BATCH PLANTS, WASTE FACILITIES AND THE LIKE ARE NOT SPECIFICALLY SITED ON THE PLAN BUT STILL ARE REQUIRED TO BE ADDRESSED BY THE CONTRACTORS BASED ON THE CONTRACTORS PLANNED LOCATIONS.
- ALL BMP'S MAY NOT BE LISTED ON THIS EROSION CONTROL PLAN. THE CONTRACTOR IS REFERRED TO BE FAMILIAR WITH THE SWPPP DOCUMENT FOR THIS SITE, AS IT MAY INCLUDE ADDITIONAL NECESSARY BMP'S.

DUST CONTROL NOTES:

- CONSTRUCTION OF THE PROJECT REQUIRES THE IMPLEMENTATION OF CONTROL MEASURES RECOMMENDED BY THE SAN JOAQUIN VALLEY AIR POLLUTION CONTROL DISTRICT THAT CAN REDUCE FUGITIVE DUST EMISSIONS ASSOCIATED WITH THIS PROJECT:
- ALL DISTURBED AREAS, INCLUDING STORAGE PILES, WHICH ARE NOT BEING ACTIVELY UTILIZED FOR CONSTRUCTION PURPOSES, SHALL BE EFFECTIVELY STABILIZED OF DUST EMISSIONS USING WATER, COVERED WITH A TARP OR OTHER SUITABLE COVER, OR VEGETATIVE GROUND COVER.
 - ALL ONSITE UNPAVED ROADS AND OFFSITE UNPAVED ACCESS ROADS SHALL BE EFFECTIVELY STABILIZED OF DUST EMISSIONS USING WATER.
 - ALL LAND CLEARING, GRUBBING, SCRAPING, EXCAVATION, LAND LEVELING, GRADINGS, CUT & FILL, AND DEMOLITION ACTIVITIES SHALL BE EFFECTIVELY CONTROLLED OF FUGITIVE DUST EMISSIONS UTILIZING APPLICATION OF WATER OR BY FREESKINING.
 - WHEN MATERIALS ARE TRANSPORTED OFFSITE, ALL MATERIALS SHALL BE COVERED, OR EFFECTIVELY METTED TO LIMIT VISIBLE DUST EMISSIONS, AND AT LEAST SIX INCHES OF FREEBOARD SPACE FROM TOP OF THE CONTAINER SHALL BE MAINTAINED.
 - ALL OPERATIONS SHALL LIMIT OR EXPEDITIOUSLY REMOVE THE ACCUMULATION OF MUD OR TRACKOUT FROM ADJACENT PUBLIC STREETS AT THE END OF EACH WORKDAY. (USING A PM10-EFFICIENT METHOD SE-7).
 - FOLLOWING THE ADDITION OF MATERIALS TO, OR THE REMOVAL OF MATERIALS FROM, THE SURFACE OF OUTDOOR STORAGE PILES, SAID PILES SHALL BE EFFECTIVELY STABILIZED OF FUGITIVE DUST EMISSIONS UTILIZING SUFFICIENT WATER AND COVERINGS.
 - ASPHALT-CONCRETE PAVING SHALL COMPLY WITH BMP THAT PREVENT INFILTRATION OF PAVING MATERIALS AND RUNOFF INTO STORM DRAIN SYSTEMS (NS-3).
 - CEASE GRADINGS ACTIVITIES DURING PERIODS OF HIGH WINDS (GREATER THAN 20 MPH OVER A ONE-HOUR PERIOD).
 - LIMIT CONSTRUCTION RELATED VEHICLE SPEEDS TO 15 MPH ON ALL UNPAVED AREAS AT THE CONSTRUCTION SITE.
 - ALL DUST CONTROL MEASURES ARE NOT NECESSARY LISTED HERE ON THIS PLAN. THE CONTRACTOR IS REFERRED TO THE DUST CONTROL PLAN FOR THIS PROJECT AND/OR SAN JOAQUIN VALLEY AIR POLLUTION CONTROL DISTRICT RULES TO CHECK COMPLIANCE.


CONSTRUCTION NOTES:

- POST 'NO TRESPASSING' SIGN AT PROJECT ENTRANCE(S)
- POST 'CONSTRUCTION TRAFFIC 15 MPH' SIGN AT PROJECT ENTRANCE(S)
- MATERIAL LAY-DOWN AND STOCKPILE AREA. (DETAIL A)
- EQUIPMENT PARKING WITH PROTECTIVE OIL PANS UNDER EQUIPMENT.
- GRAVEL PAD AT CONSTRUCTION ENTRANCE MIN. 50' LONG (SEE DETAIL B)
- INLET PROTECTION WITH GRAVEL BAGS. (SEE DETAIL D)
- STOCKPILE FOR ALL PHASES [PLACE FIBER ROLLS AT TOE OF SLOPE & ALL THE WAY AROUND THE STOCKPILE] (SEE DETAIL A)
- CONSTRUCT CONCRETE WASHOUT (PER DETAIL E)
- LOCATION OF PORT-O-LET (PORTABLE TOILET)
- HAZARDOUS MATERIAL STORAGE AREA
- CONSTRUCTION PARKING AREA

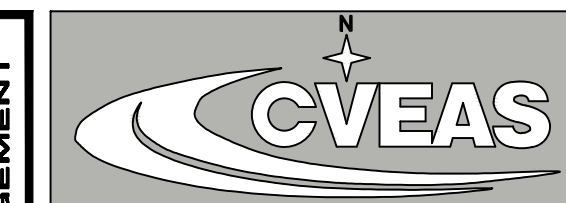

CENTRAL VALLEY
ENGINEERING & SURVEYING, INC.
2511 LOS AN STREET Tel. (559) 841-0811
SELMA, CA 95662 Fax (559) 841-0915
WWW.CVEAS.COM Email: info@cveas.com

PROJECT
NEW SINGLE FAMILY RESIDENCE FOR:
GURDEEP DHADWAL
PALM AND DOUGHERTY AVE.
MORGAN HILLS, CA 95037
APN: 712-27-043

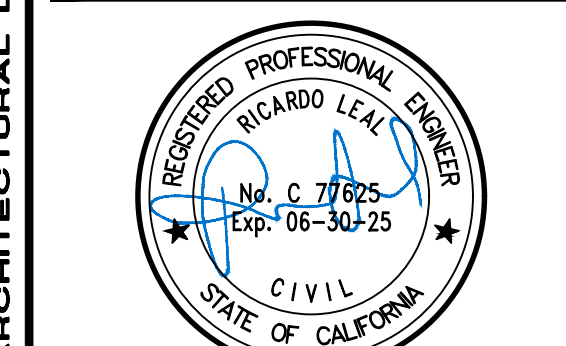

DATE SIGNED: 2/26/2024


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EROSION CONTROL PLAN


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DATE:	2/26/2024
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PLAN CHECK SUBMITTAL #:	XX-XXXX
DRAWN BY:	KX
CHECKED BY:	RL
SCALE:	NOTE ON PLANS

C5


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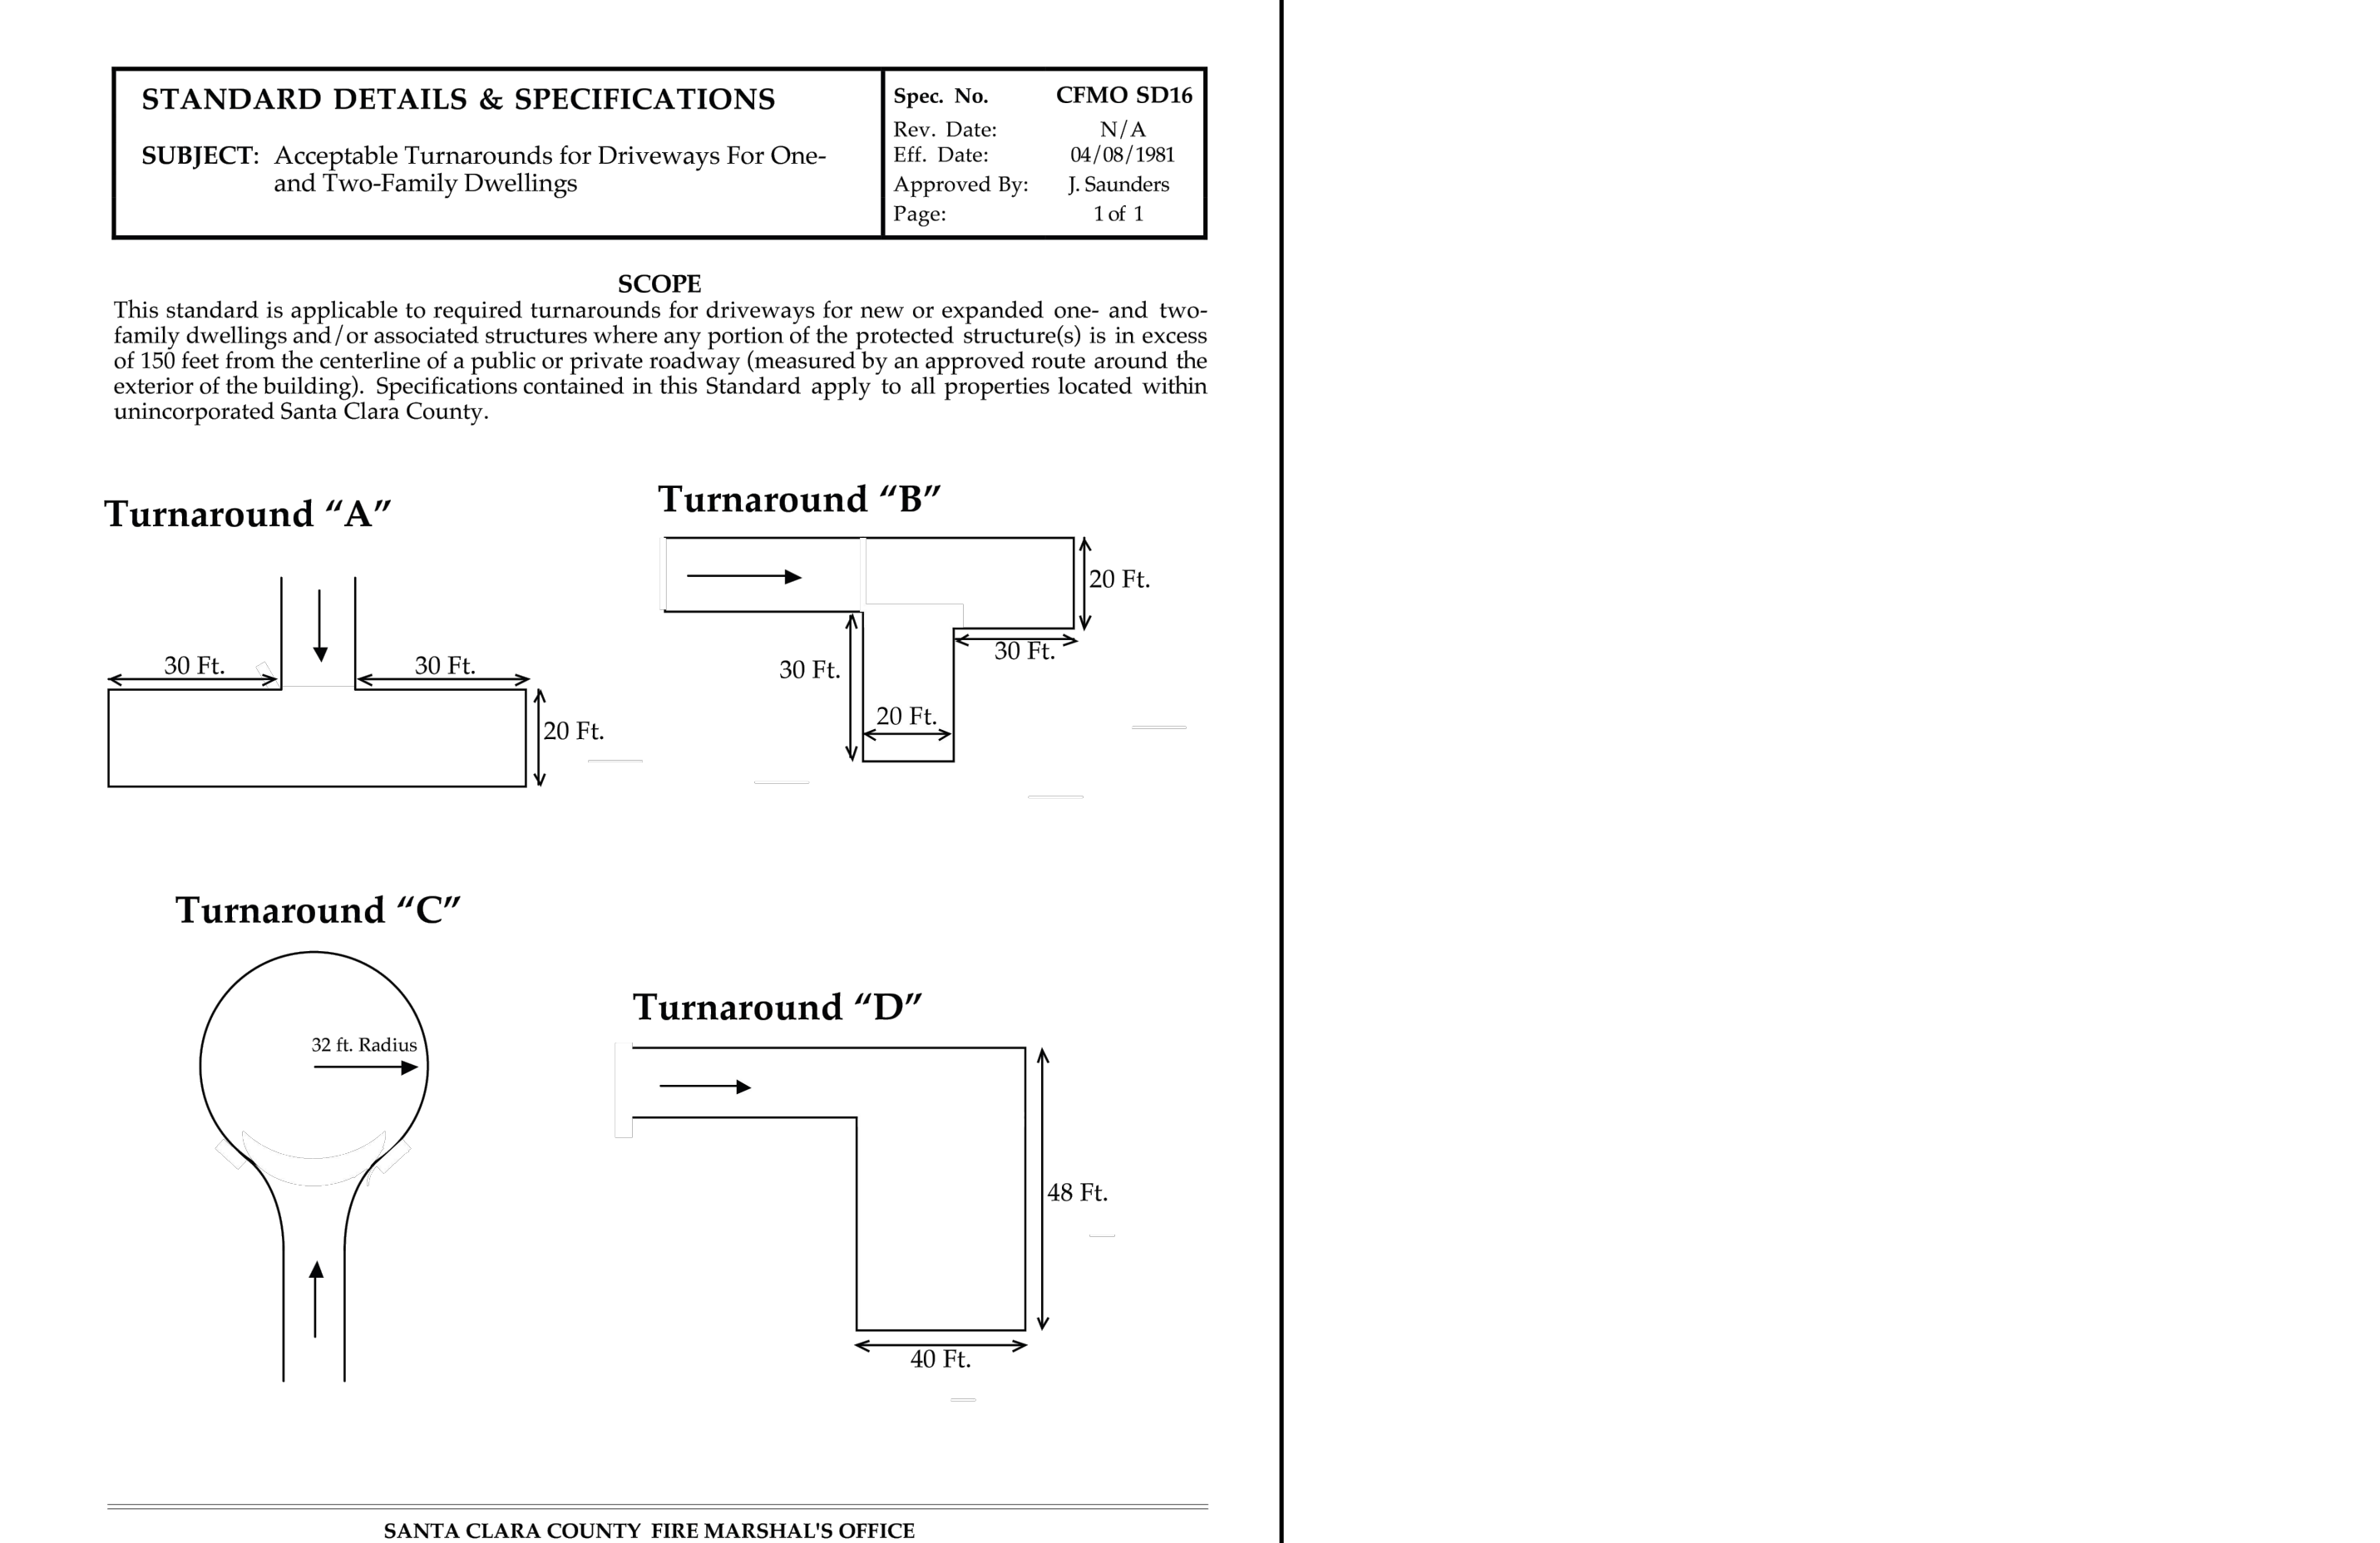
B4-1 SANTA CLARA COUNTY ROADS AND AIRPORTS DEPARTMENT STANDARD DWG.
SCALE: N.T.S.

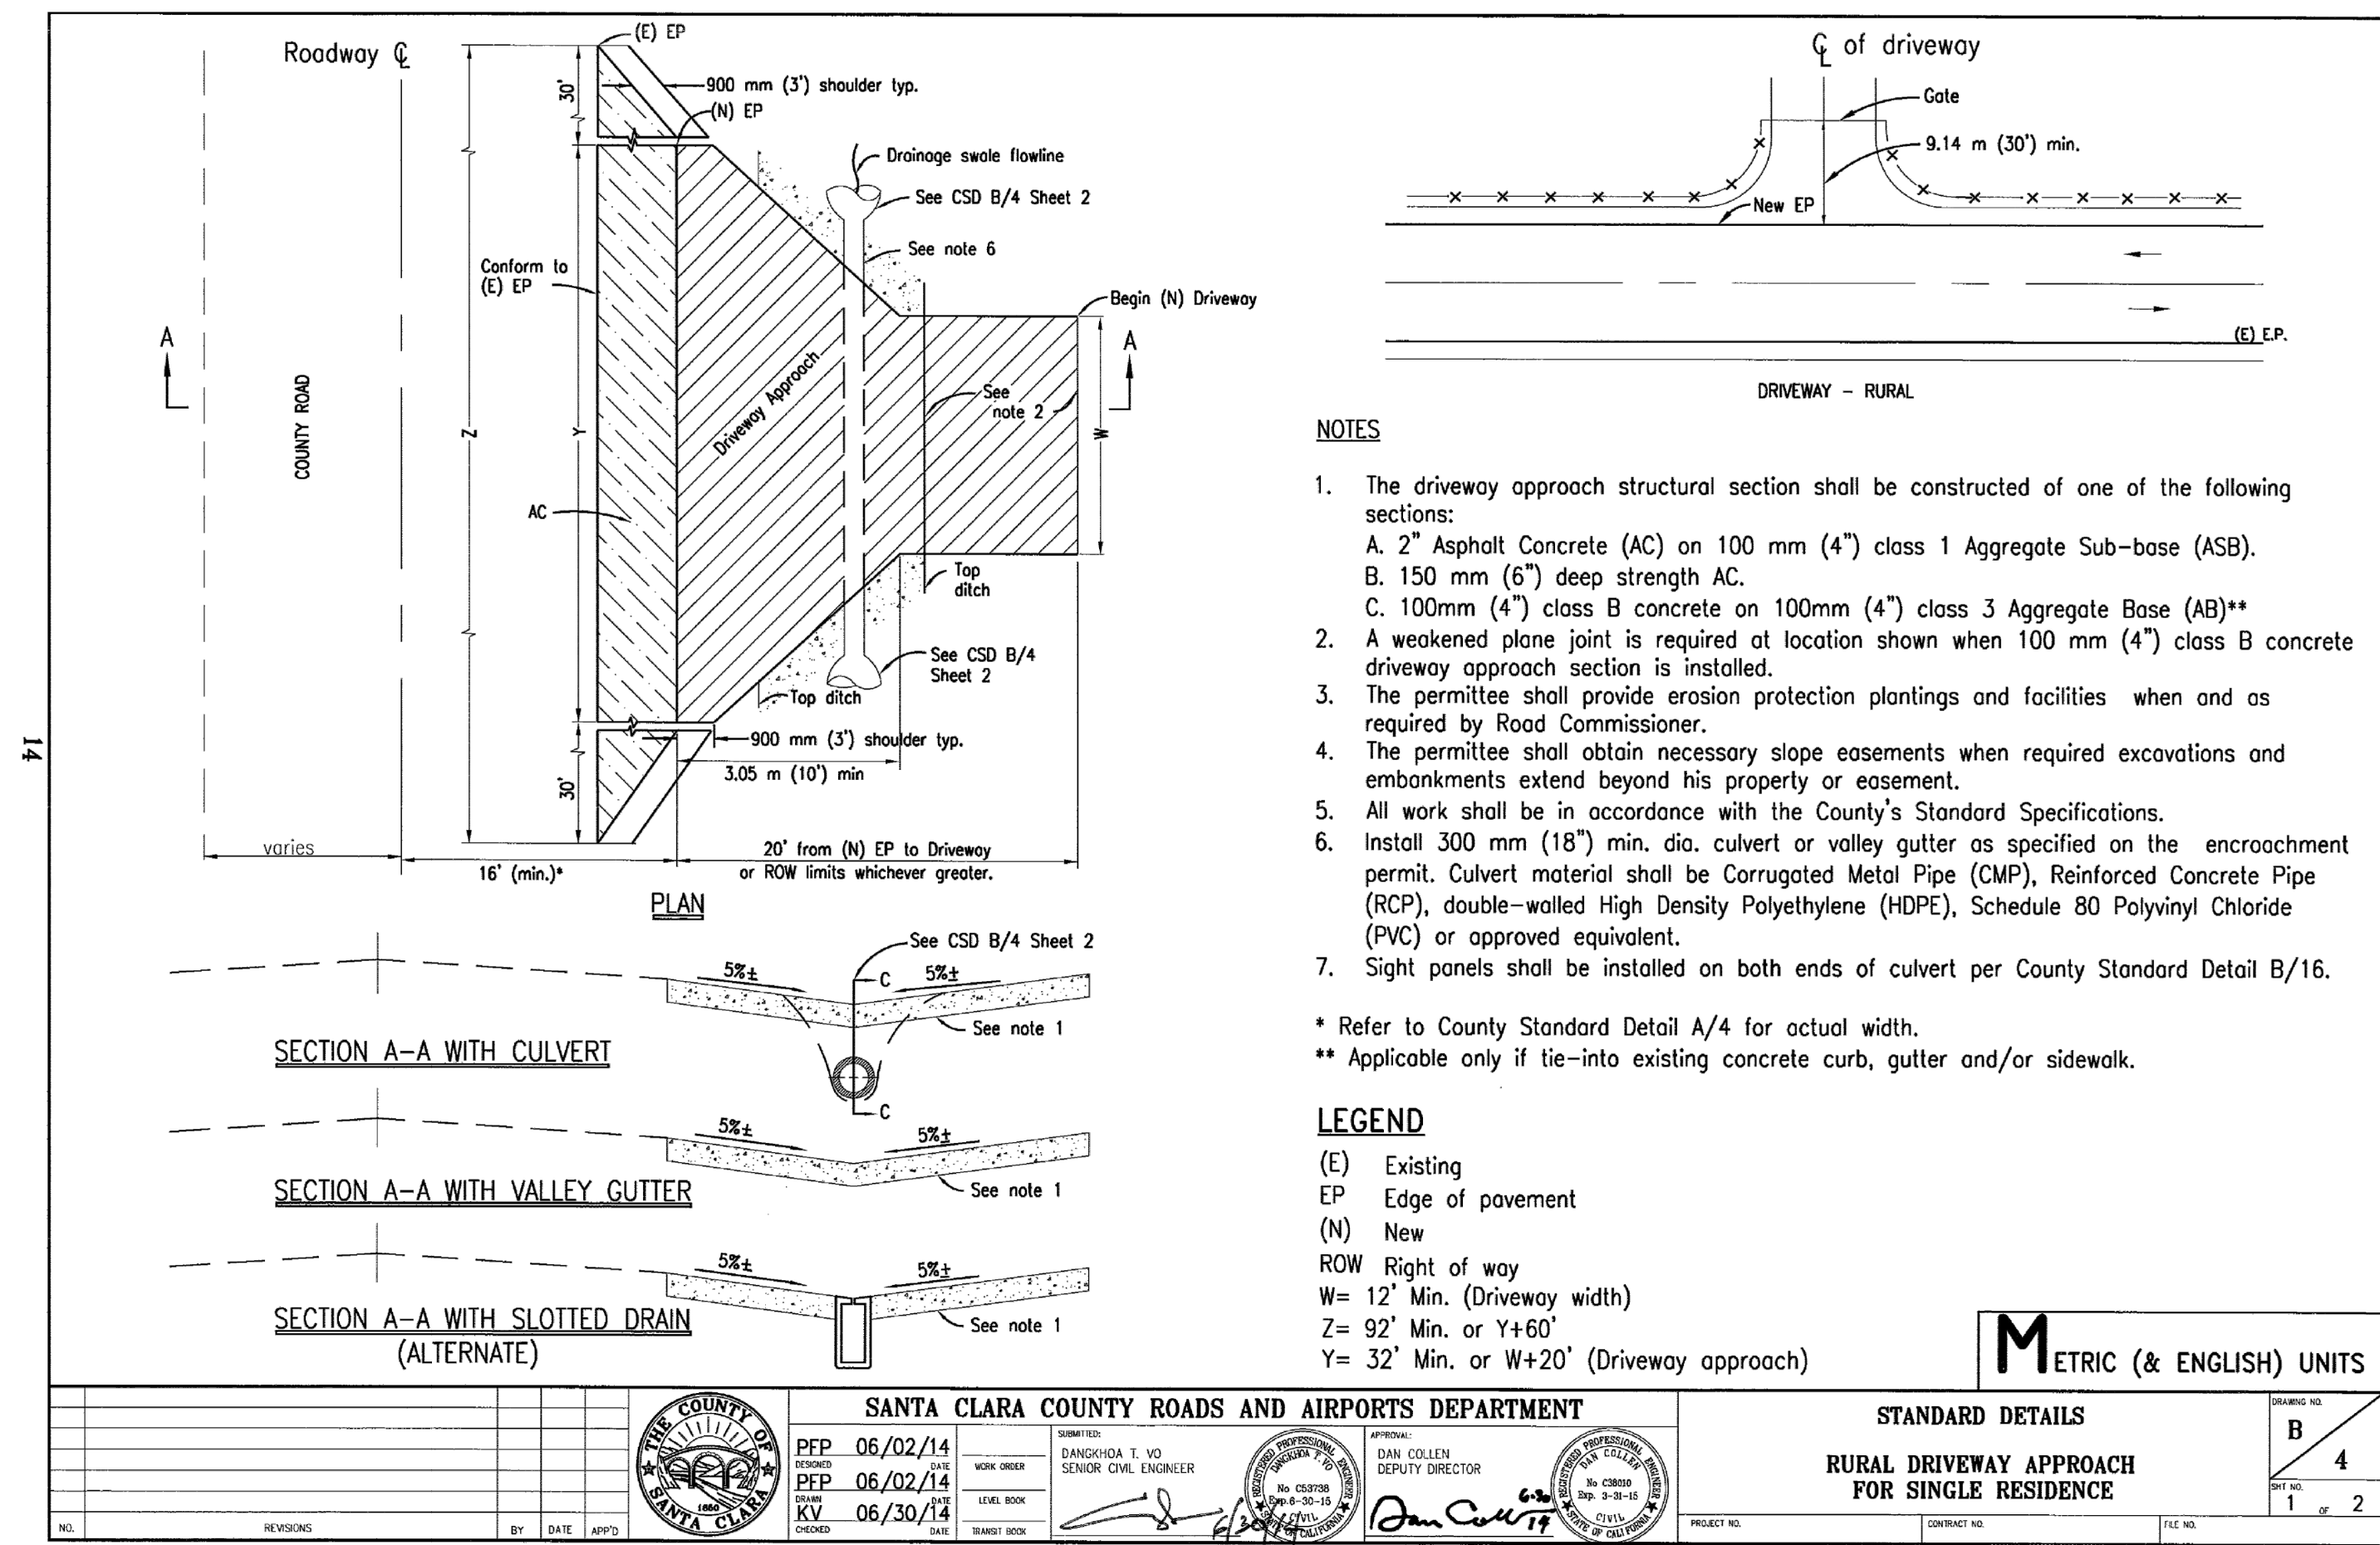


B4-2 SANTA CLARA COUNTY ROADS AND AIRPORTS DEPARTMENT STANDARD DWG.
SCALE: N.T.S.

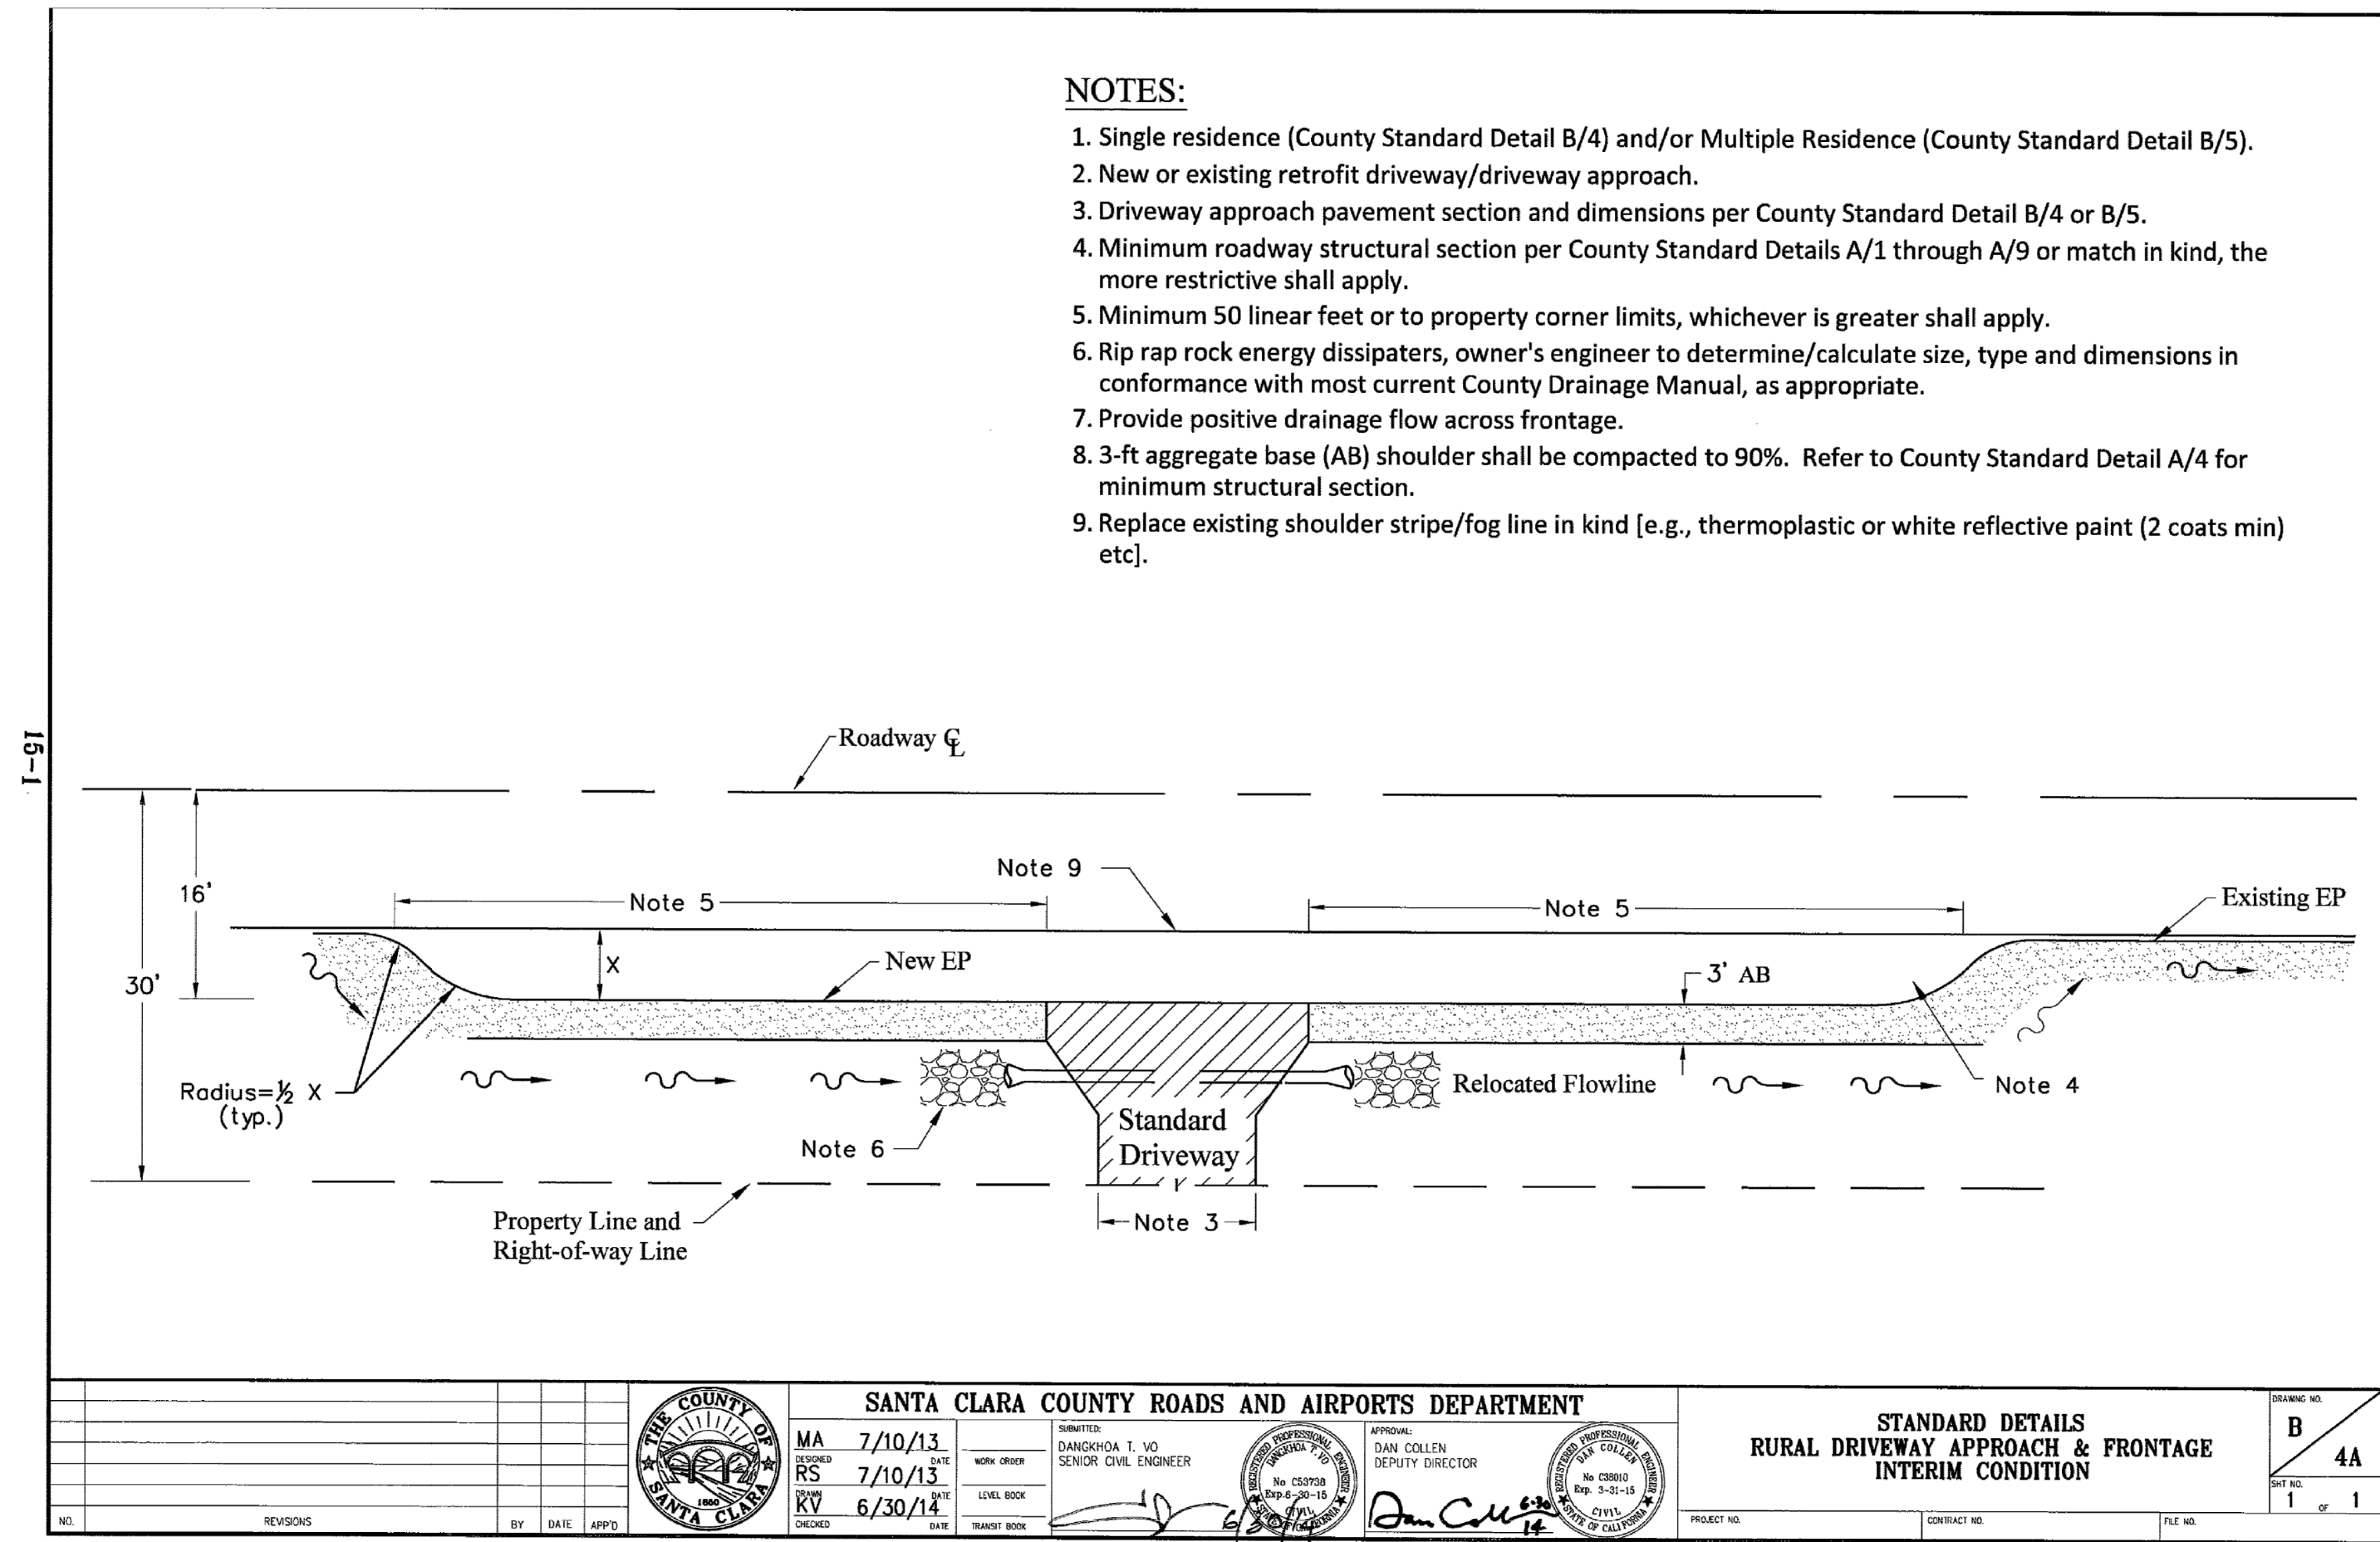

B4-3 SANTA CLARA COUNTY ROADS AND AIRPORTS DEPARTMENT STANDARD DWG.
SCALE: N.T.S.

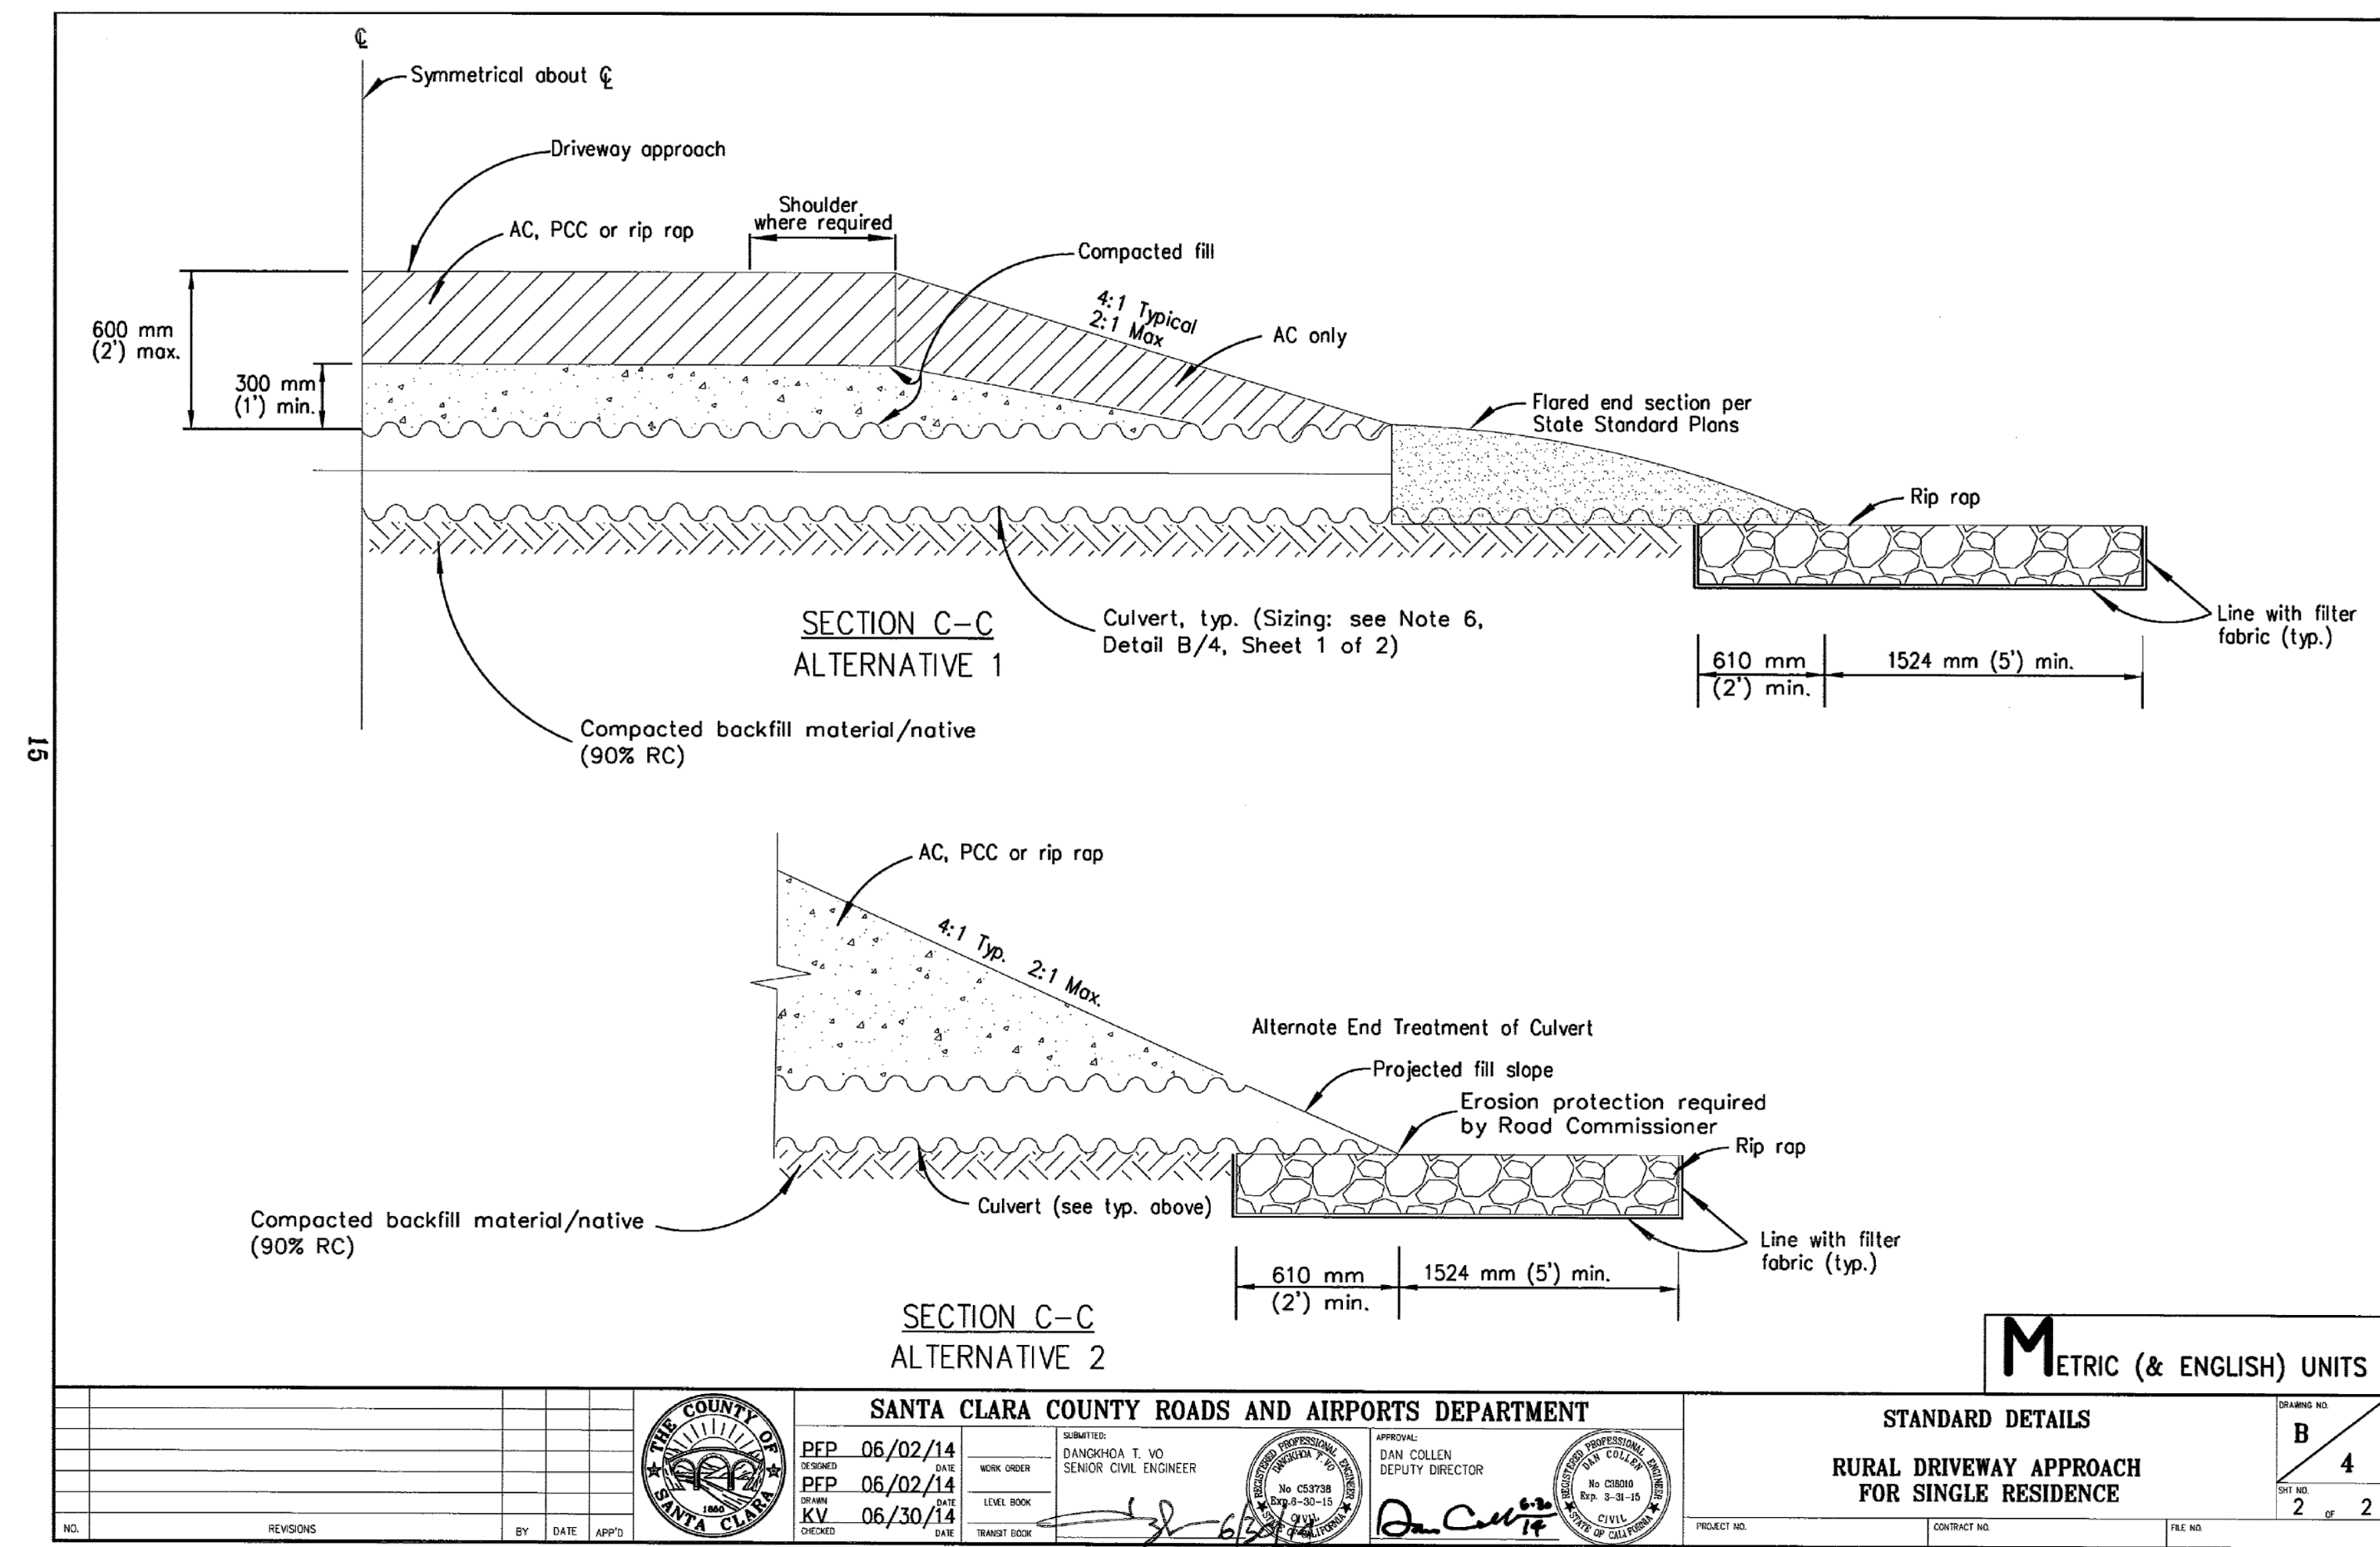


SD-16 SCMO - FIRE TRUCK TURN-AROUND
SCALE: N.T.S.

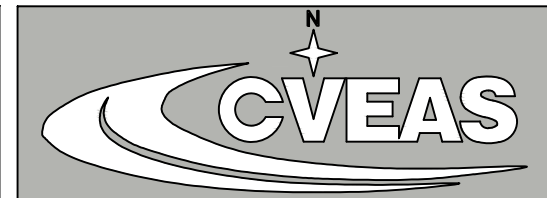

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PROJECT
NEW SINGLE FAMILY RESIDENCE FOR:
GURDEEP DHADWAL
PALM AND DOUGHERTY AVE.
MORGAN HILLS, CA 95037
APN: 712-27-043

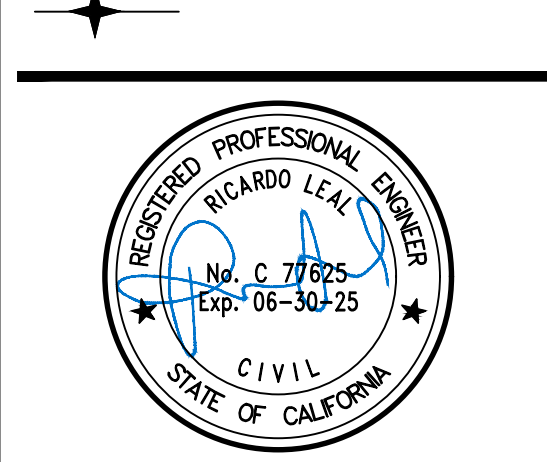

Revisions	Date
1	-
2	-
3	-
4	-
5	-
6	-

SANTA CLARA COUNTY ROAD AND AIRPORT STANDARDS	
CVEAS JOB #:	2246
DATE:	2/26/2024
PLANNING SUBMITTAL #:	XX-XXXX
PLAN CHECK SUBMITTAL #:	XX-XXXX
DRAWN BY:	KX
CHECKED BY:	RL
SCALE:	NOTE ON PLANS

C8

APPROVED FOR ISSUANCE
REFER TO ENCROACHMENT
AND/OR CONSTRUCTION
PERMIT AND PLAN COVER
SHEET FOR SPECIAL
CONDITIONS AND PERMIT
NUMBERING.

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Table 6H-2. Meaning of Symbols on Typical Application Diagrams	
	Arrow board
	Arrow board support or trailer (shown facing down)
	Changeable message sign or support trailer
	Channelizing device
	Crash cushion
	Direction of temporary traffic detour
	Direction of traffic
	Flagger
	High-level warning device (Flag tree)
	Longitudinal channelizing device
	Luminaire
	Pavement markings that should be removed for a long-term project
	Shadow vehicle
	Sign (shown facing left)
	Surveyor
	Temporary barrier
	Temporary barrier with warning light
	Traffic or pedestrian signal
	Truck-mounted attenuator
	Type 3 barricade
	Warning light
	Work space
	Work vehicle

Table 6E-101(CA). Stopping Sight Distance as a Function of Speed on Downgrades.
(Used as suggested longitudinal buffer space length or location for flagger station)

Speed (mph)	% Downgrade (Buffer Space)		
	-3% (feet)	-6% (feet)	-9% (feet)
20	116	120	126
25	158	165	173
30	205	215	227
35	257	271	287
40	315	333	354
45	378	400	427
50	446	474	507
55	520	553	593
60	598	638	686
65	682	728	785
70	771	825	891
75	866	927	1003

* Exhibit 3-2. A Policy on Geometric Design of Highways and Streets, AASHTO, 2001, p.115.

- Use appropriate TCP as needed during construction depending on type of work (for example, to block a lane, block the shoulder, or work off of the shoulder without blocking it).
- See the County Road Book at www.countyroads.org to confirm "Local Road" classification ("Local Urban", "Local Rural" as shown in note 5a on intro page of County Road Book)
- These TCP sheets for use on Local Roads only. All other classifications require an engineered site-specific plan.

					COUNTY OF SANTA CLARA ROADS AND AIRPORTS DEPARTMENT				STANDARD TRAFFIC CONTROL PLANS - LOCAL				DRAWING No.	
									NOTES & LEGEND				TCP	
													SHT No.	
													OF	
													Scale	

Option:

- Guidance:*

Standard:

Standard:

Guidance:


10. Early coordination with the railroad company or light rail transit agency should occur before work starts.

Option:

- Support:

Note: 1. See Tables 6H-2 and 6H-3 for the meaning of the symbols and/or letter codes used in this figure.


2. See Tables 6E-1 and 6E-101 (CA) for buffer space to determine location of flagger stations.

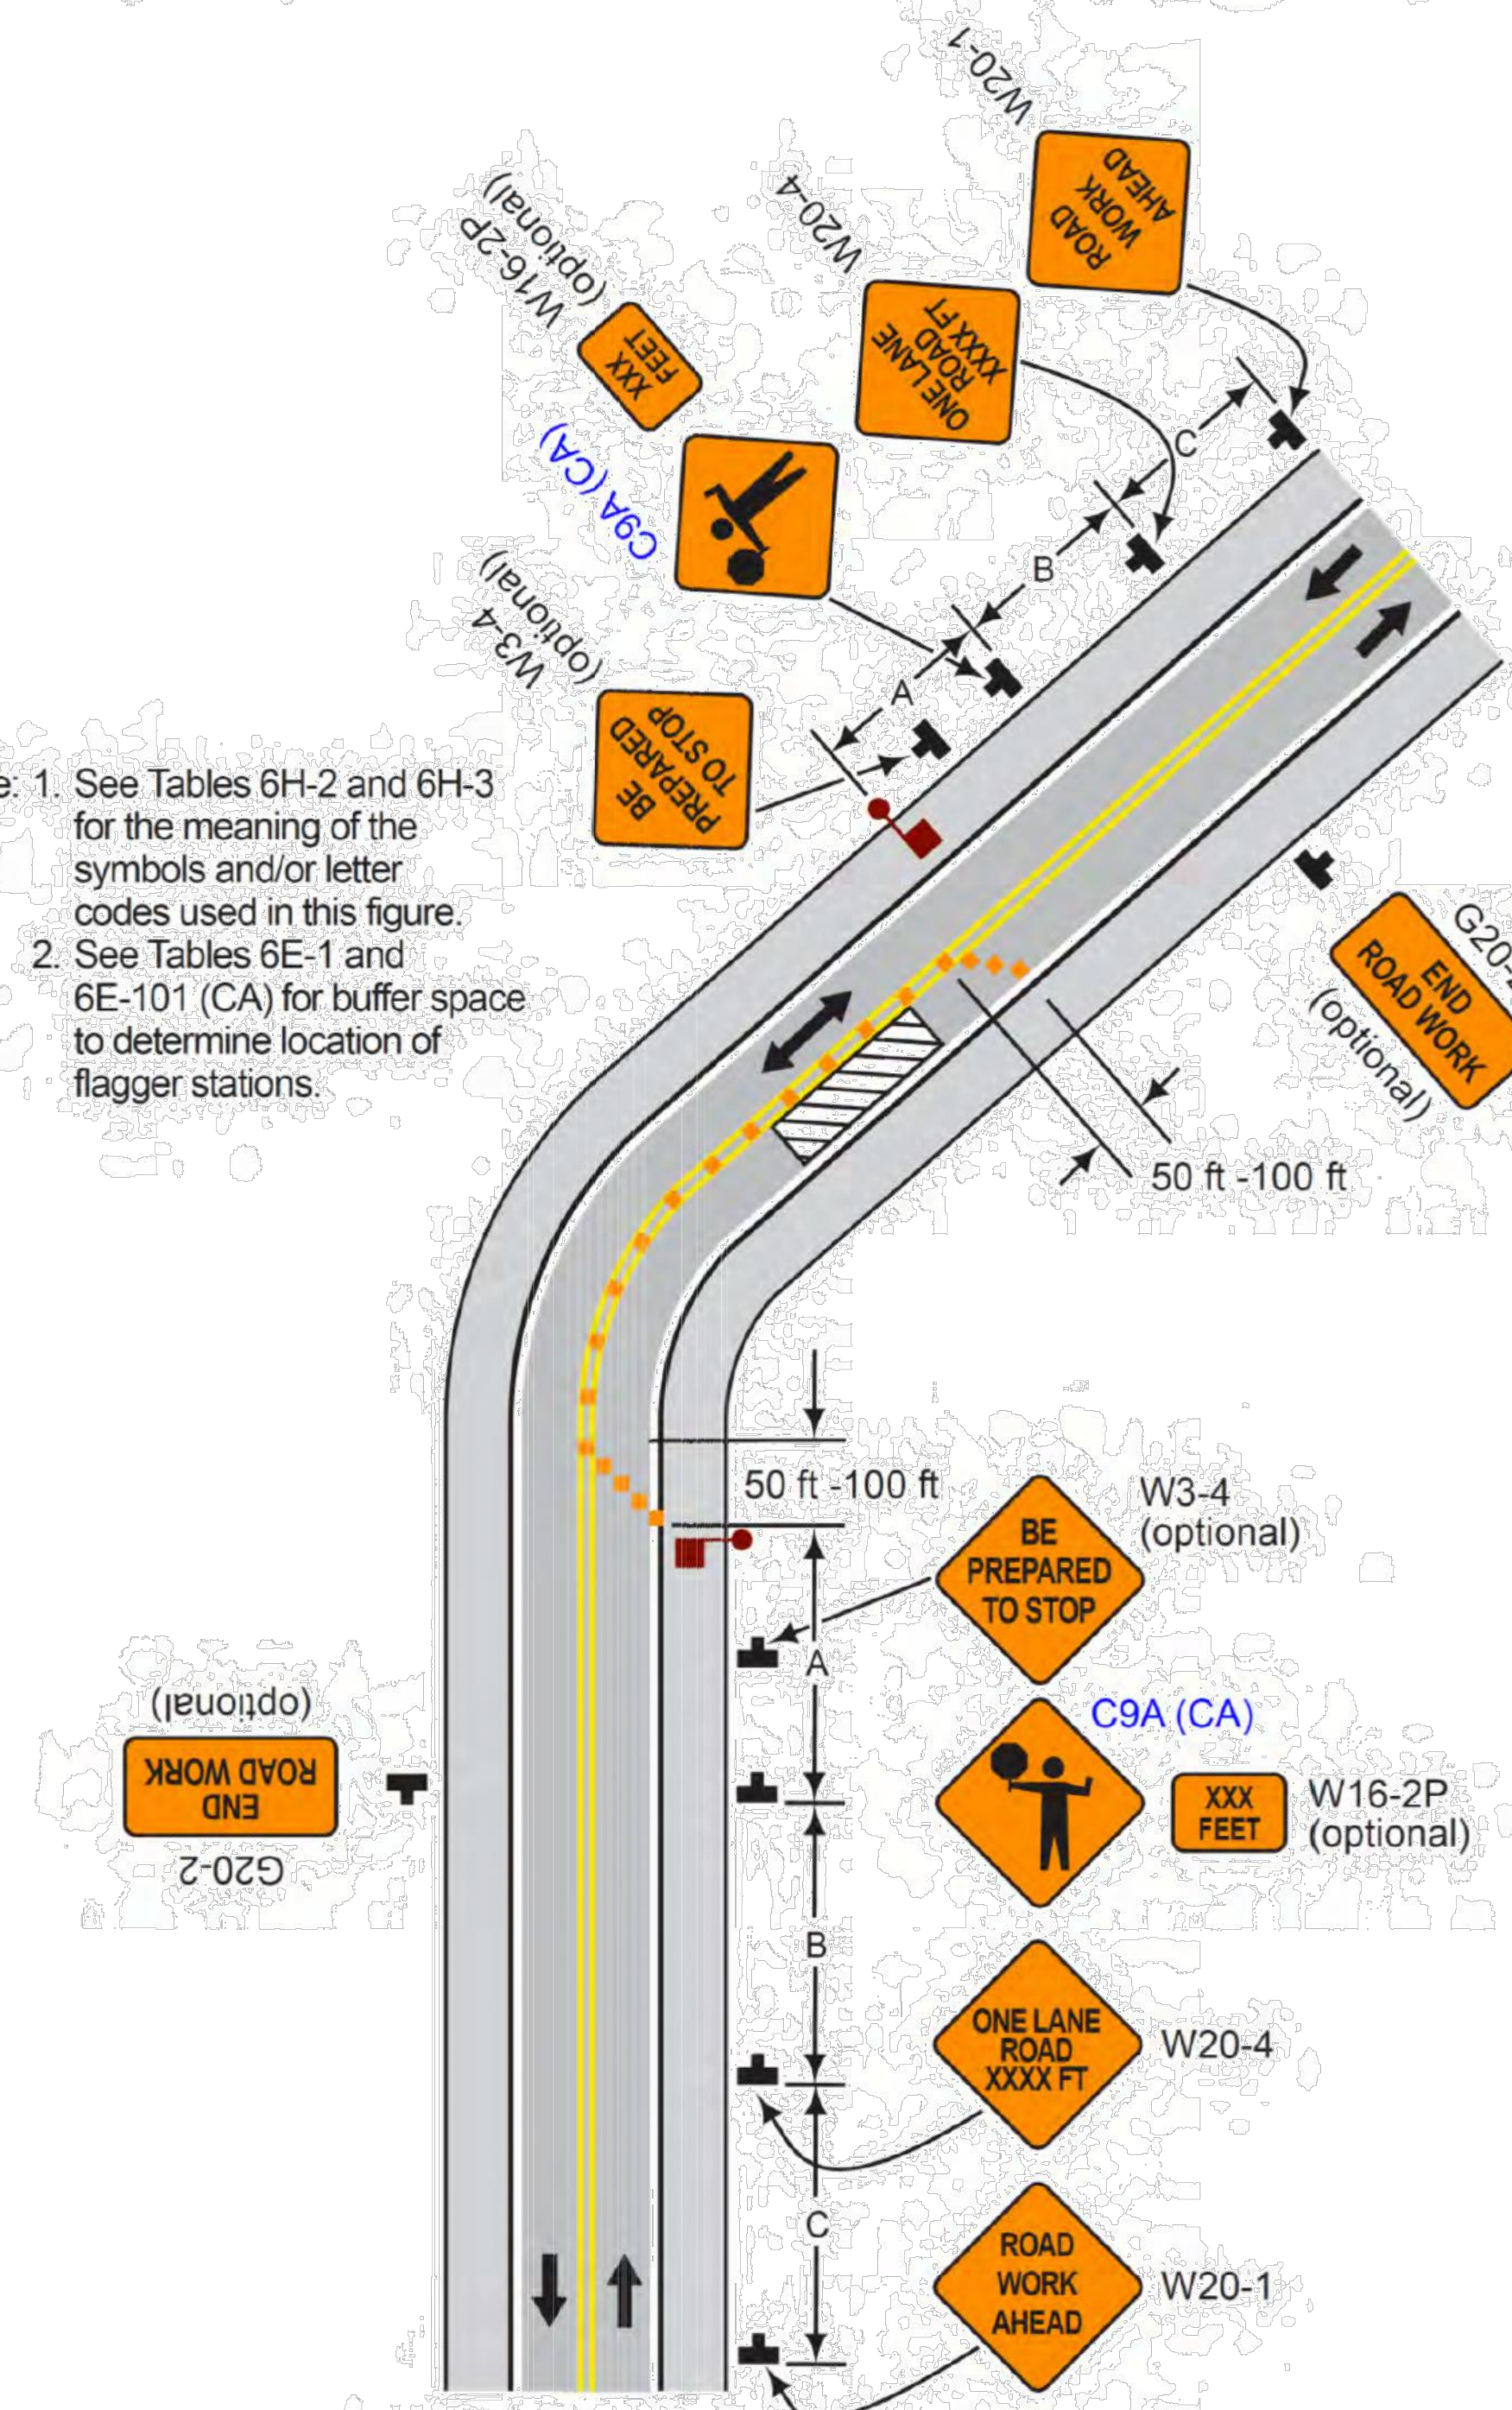

Typical Application 10

[illegible]

APPROVED FOR ISSUANCE
REFER TO ENCROACHMENT
AND/OR CONSTRUCTION
PERMIT AND PLAN COVER
SHEET FOR SPECIAL
CONDITIONS AND PERMIT
NUMBERING.

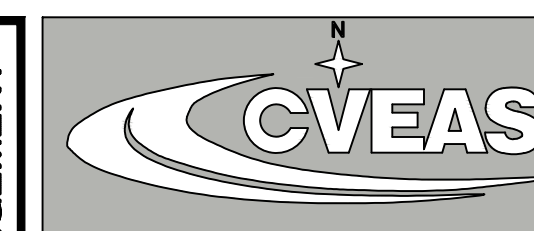
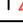

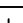



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APN: 712-27-043



DATE SIGNED: 2/26/202

Revisions:	Date:
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SANTA CLARA
COUNTY ROAD AND
AIRPORT STANDARDS

CVEAS JOB # : 22146

DATE: 2/26/2024

PLANNING SUBMITTAL #: XX-XXXX

PLAN CHECK SUBMITTAL #:
XX-XXXX

DRAWN BY: KX

CHECKED BY: _____ RL

SCALE: _____

NOTE ON PLANS _____

C10