



NOTE:
 "A" WHERE EAVE OR CORNICE VENTS ARE INSTALLED,
 INSULATION SHALL NOT BLOCK THE FREE FLOW AIR. (CRC R806.3)

WINDOWS SILL HEIGHT


44" MAXIMUM SILL HEIGHT MEASURED
 TO BOTTOM OF CLEAR OPENING AT FINISH FLOOR

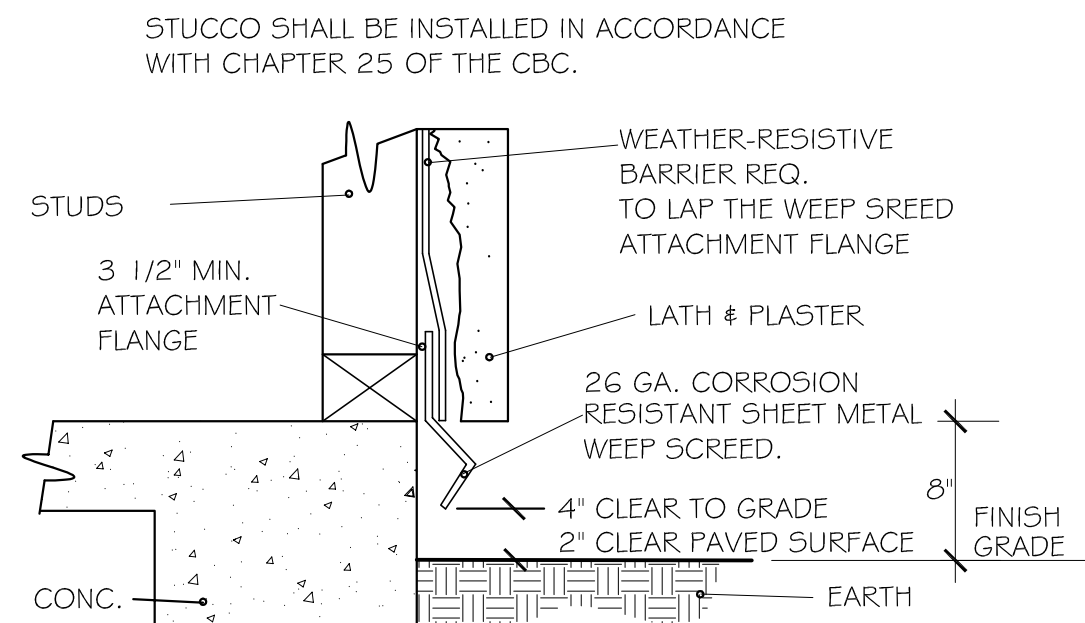

WEEP SCREED DETAIL (TYPICAL)

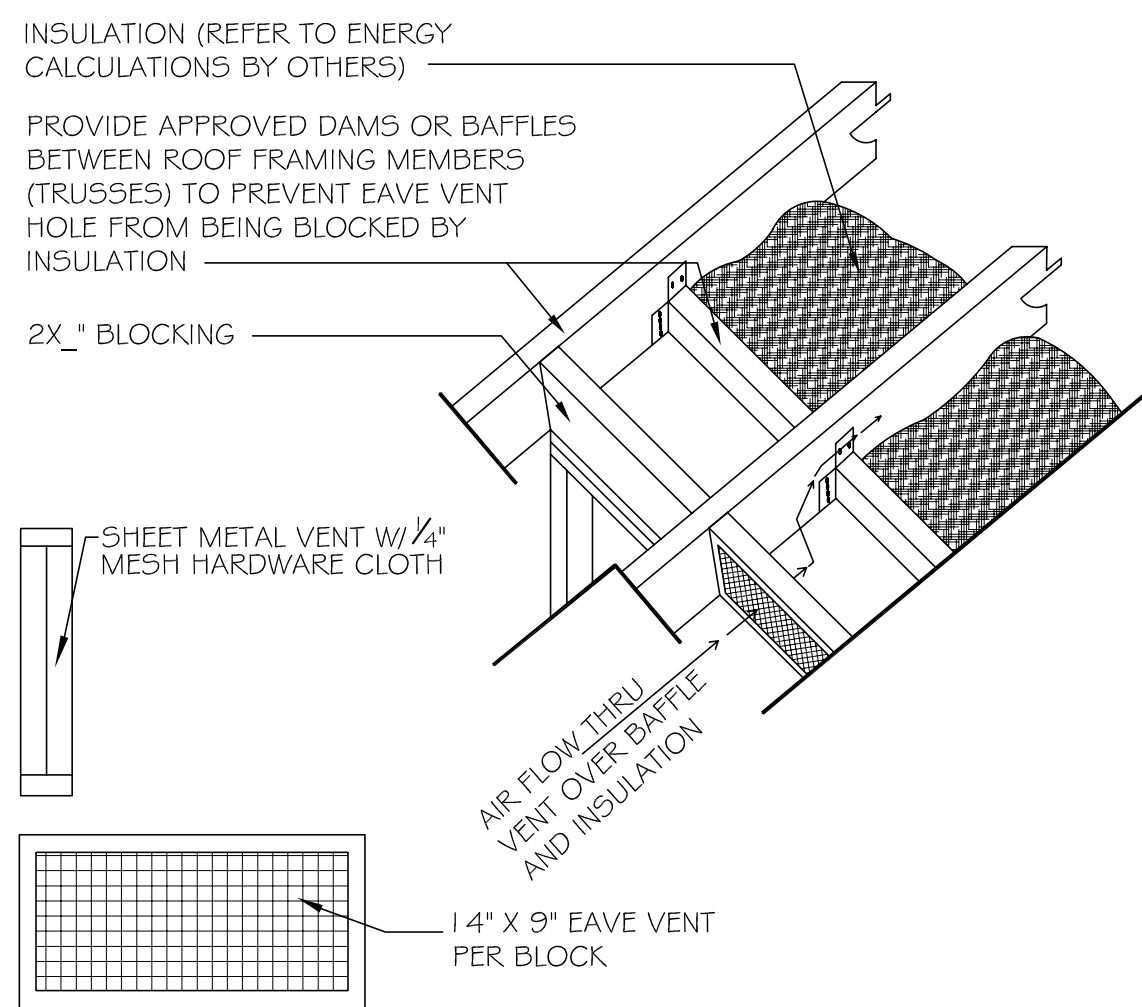

EAVE VENT BLOCK DETAIL

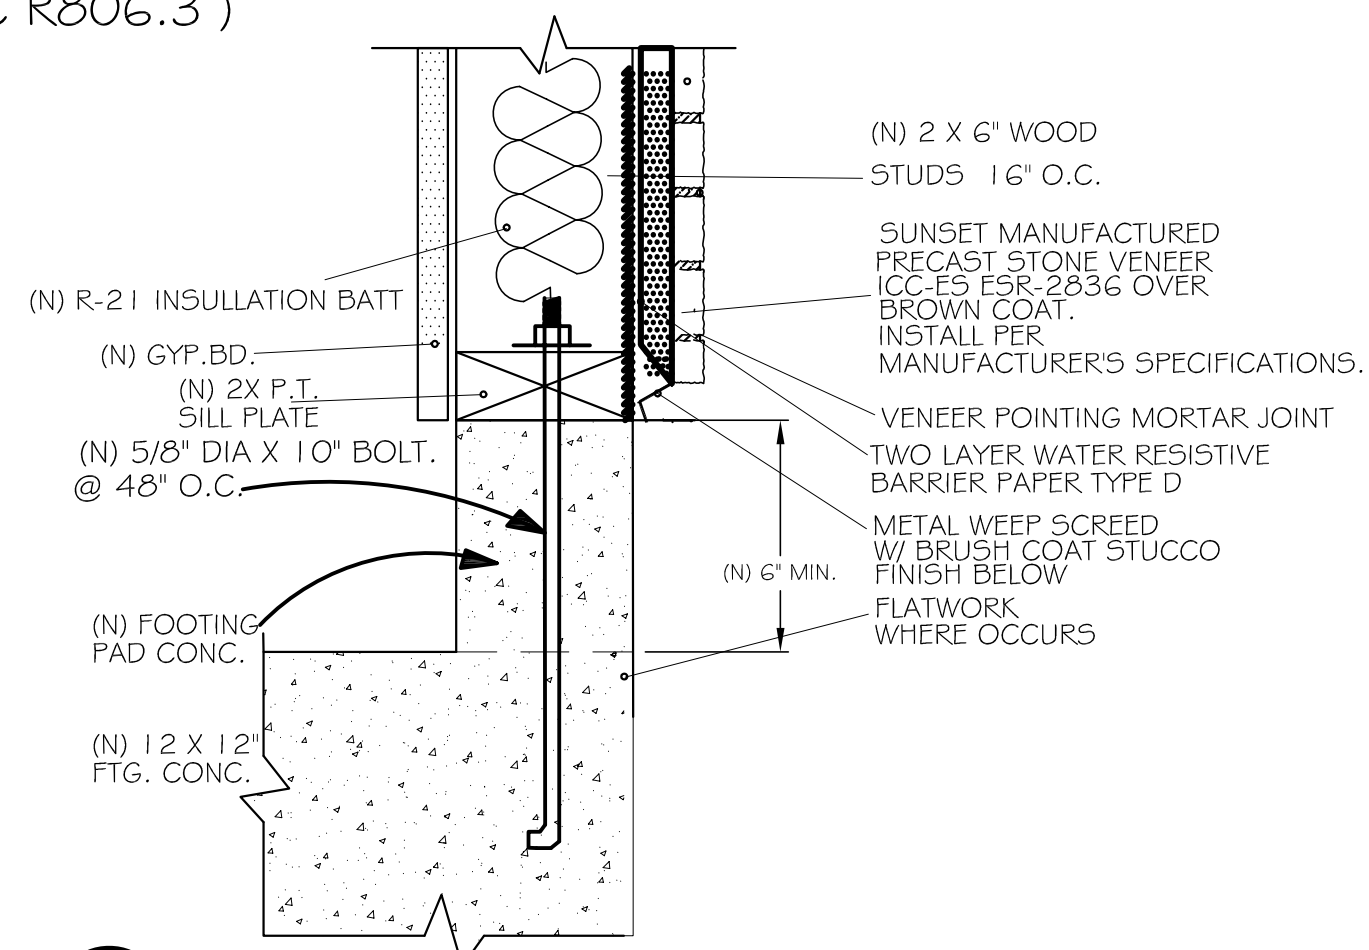

EXTERIOR WALL W/STONE VENEER @ GRADE

ELEVATION NOTES

- 1 EAGLE-LIGHT WEIGHT ROOF TILE PONDEROSA ER-1900 ASTM C1492 WEIGHT 9.7 (PSF) 17 X 12 3/8 SHALL BE MATCH W/ EXISTING ROOF TILE 2016 CBC, CRC REF. 15 EMI 91 A, SRI: 15 CRRC: 0918-0028387 BROWN GRAY RANGE 88.5 TILE PER 100 SQ. FT. W/ 3\"/>
- 2 (N) 7/8\"/>
- 3 (N) STUCCO PLASTER (3-COATS) OVER 2-LAYERS BACKED PAPER.
- 4 (N) FOOTING PER FOUNDATION PLAN.
- 5 (N) WINDOW PER SCHEDULE.
- 6 (N) DOOR PER SCHEDULE.
- 7 (N) 7:12 PITCH
- 8 (N) BUILDING LINE
- 9 (N) ROOF LINE
- 10 6X14\"/>
- 11 (N) 14X24\"/>
- 12 (N) 5:12 PITCH
- 13 (N) 6:12 PITCH

S.F.D. ATTIC VENTILATION CALCS.

ATTIC AREA : A = 1,857.00 SQ. FT.
 A SQ. FT. x 1/150 x 144 = 1,782.72 SQ. IN.

AREA	AREA Type: # A
A ATTIC AREA : (UNIT = SQ. FT.)	A = 1,857.00 SQ. FT.
B CALCULATED REQ'D. NET FREE AREA (UNIT = SQ. INCHES)	1,782.72 SQ. IN.

PROVIDE NET FREE VENTINGS # MODELS #

QUA.	NAME # SIZE	NET FREE Area	MANUF. CO. # MODEL No.
10	6X14\"/>	84 sq. in. Area Each One	
10	14X9\"/>	63 sq. in. Area Each One	
2	14 in. x 24 in. Galv. 5th. LOUVER Gable RoofTop	187.2 sq. in. Area Each One	
TOTAL VENTING AREA PROVIDED		1,844.4 SQ.IN.	

a) INSTALL A VAPOR RETARDER HAVING A TRANSMISSION RATE NOT EXCEEDING ONE PERM ON THE WARM SIDE OF THE ATTIC INSULATION PRIOR TO APPLICATION OF CEILING GYPSUM BOARD-TYPICAL ABOVE ALL CONDITIONED LIVING SPACES.

b) ROOF SLOPE: TYPICAL = 7 : 12\"/>

c) ROOF OVERHANG : 18\"/>

d) ROO MATERIALS : ROOF TILE


GARAGE ATTIC VENTILATION CALCS.

ATTIC AREA : A = 620.00 SQ. FT.
 A SQ. FT. x 1/150 x 144 = 595.2 SQ. IN.


AREA	AREA Type: # A
A ATTIC AREA : (UNIT = SQ. FT.)	A = 620.00 SQ. FT.
B CALCULATED REQ'D. NET FREE AREA (UNIT = SQ. INCHES)	595.2 SQ. IN.

PROVIDE NET FREE VENTINGS # MODELS #


QUA.	NAME # SIZE	NET FREE Area	MANUF. CO. # MODEL No.
4	6X14\"/>	84 sq. in. Area Each One	
5	14X9\"/>	63 sq. in. Area Each One	
TOTAL VENTING AREA PROVIDED		651.00 SQ.IN.	

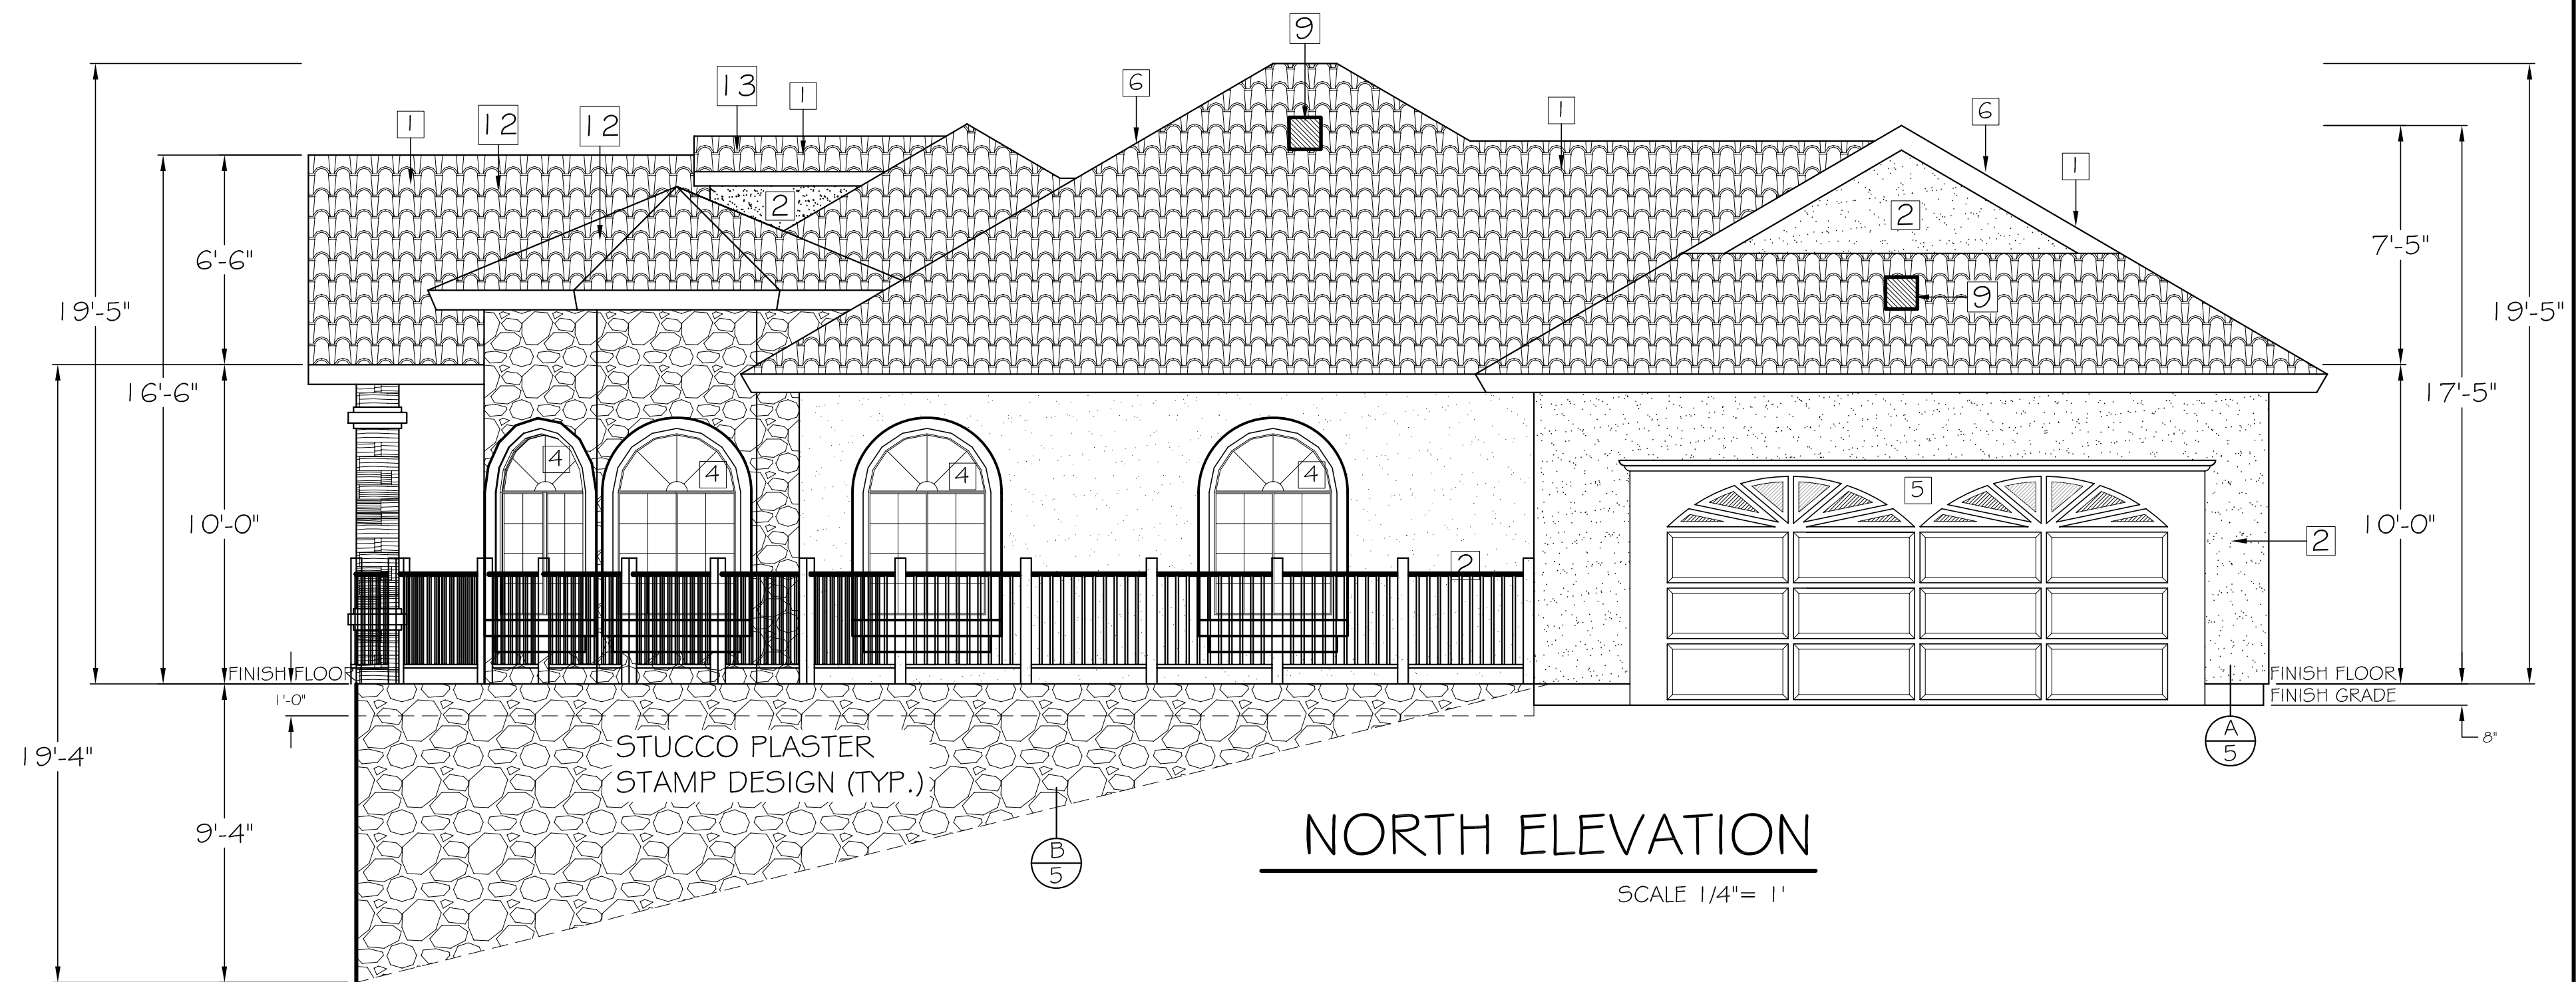

NORTH ELEVATION
 SCALE 1/4" = 1'

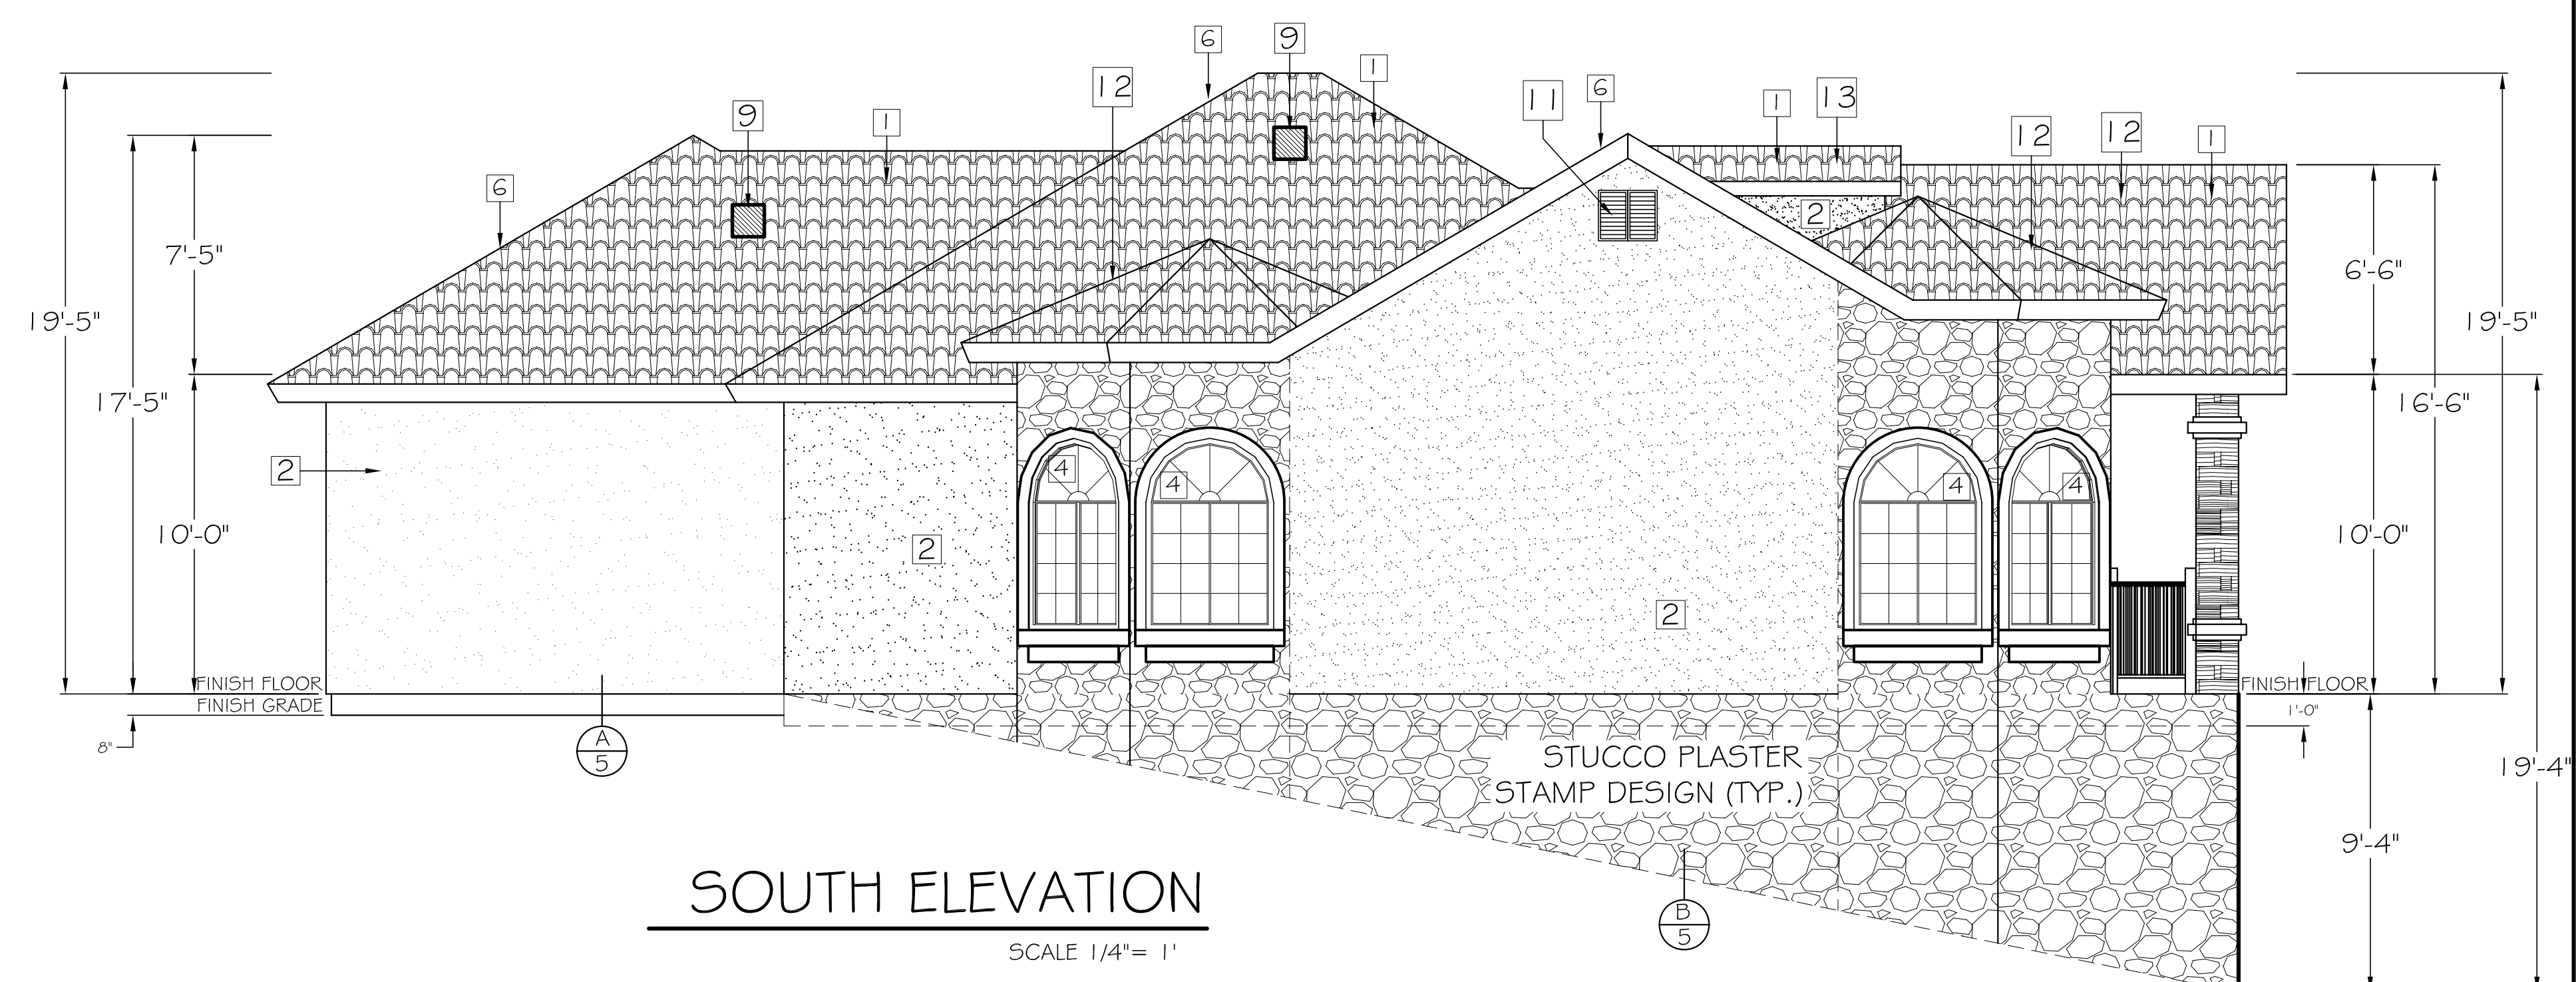

SOUTH ELEVATION
 SCALE 1/4" = 1'

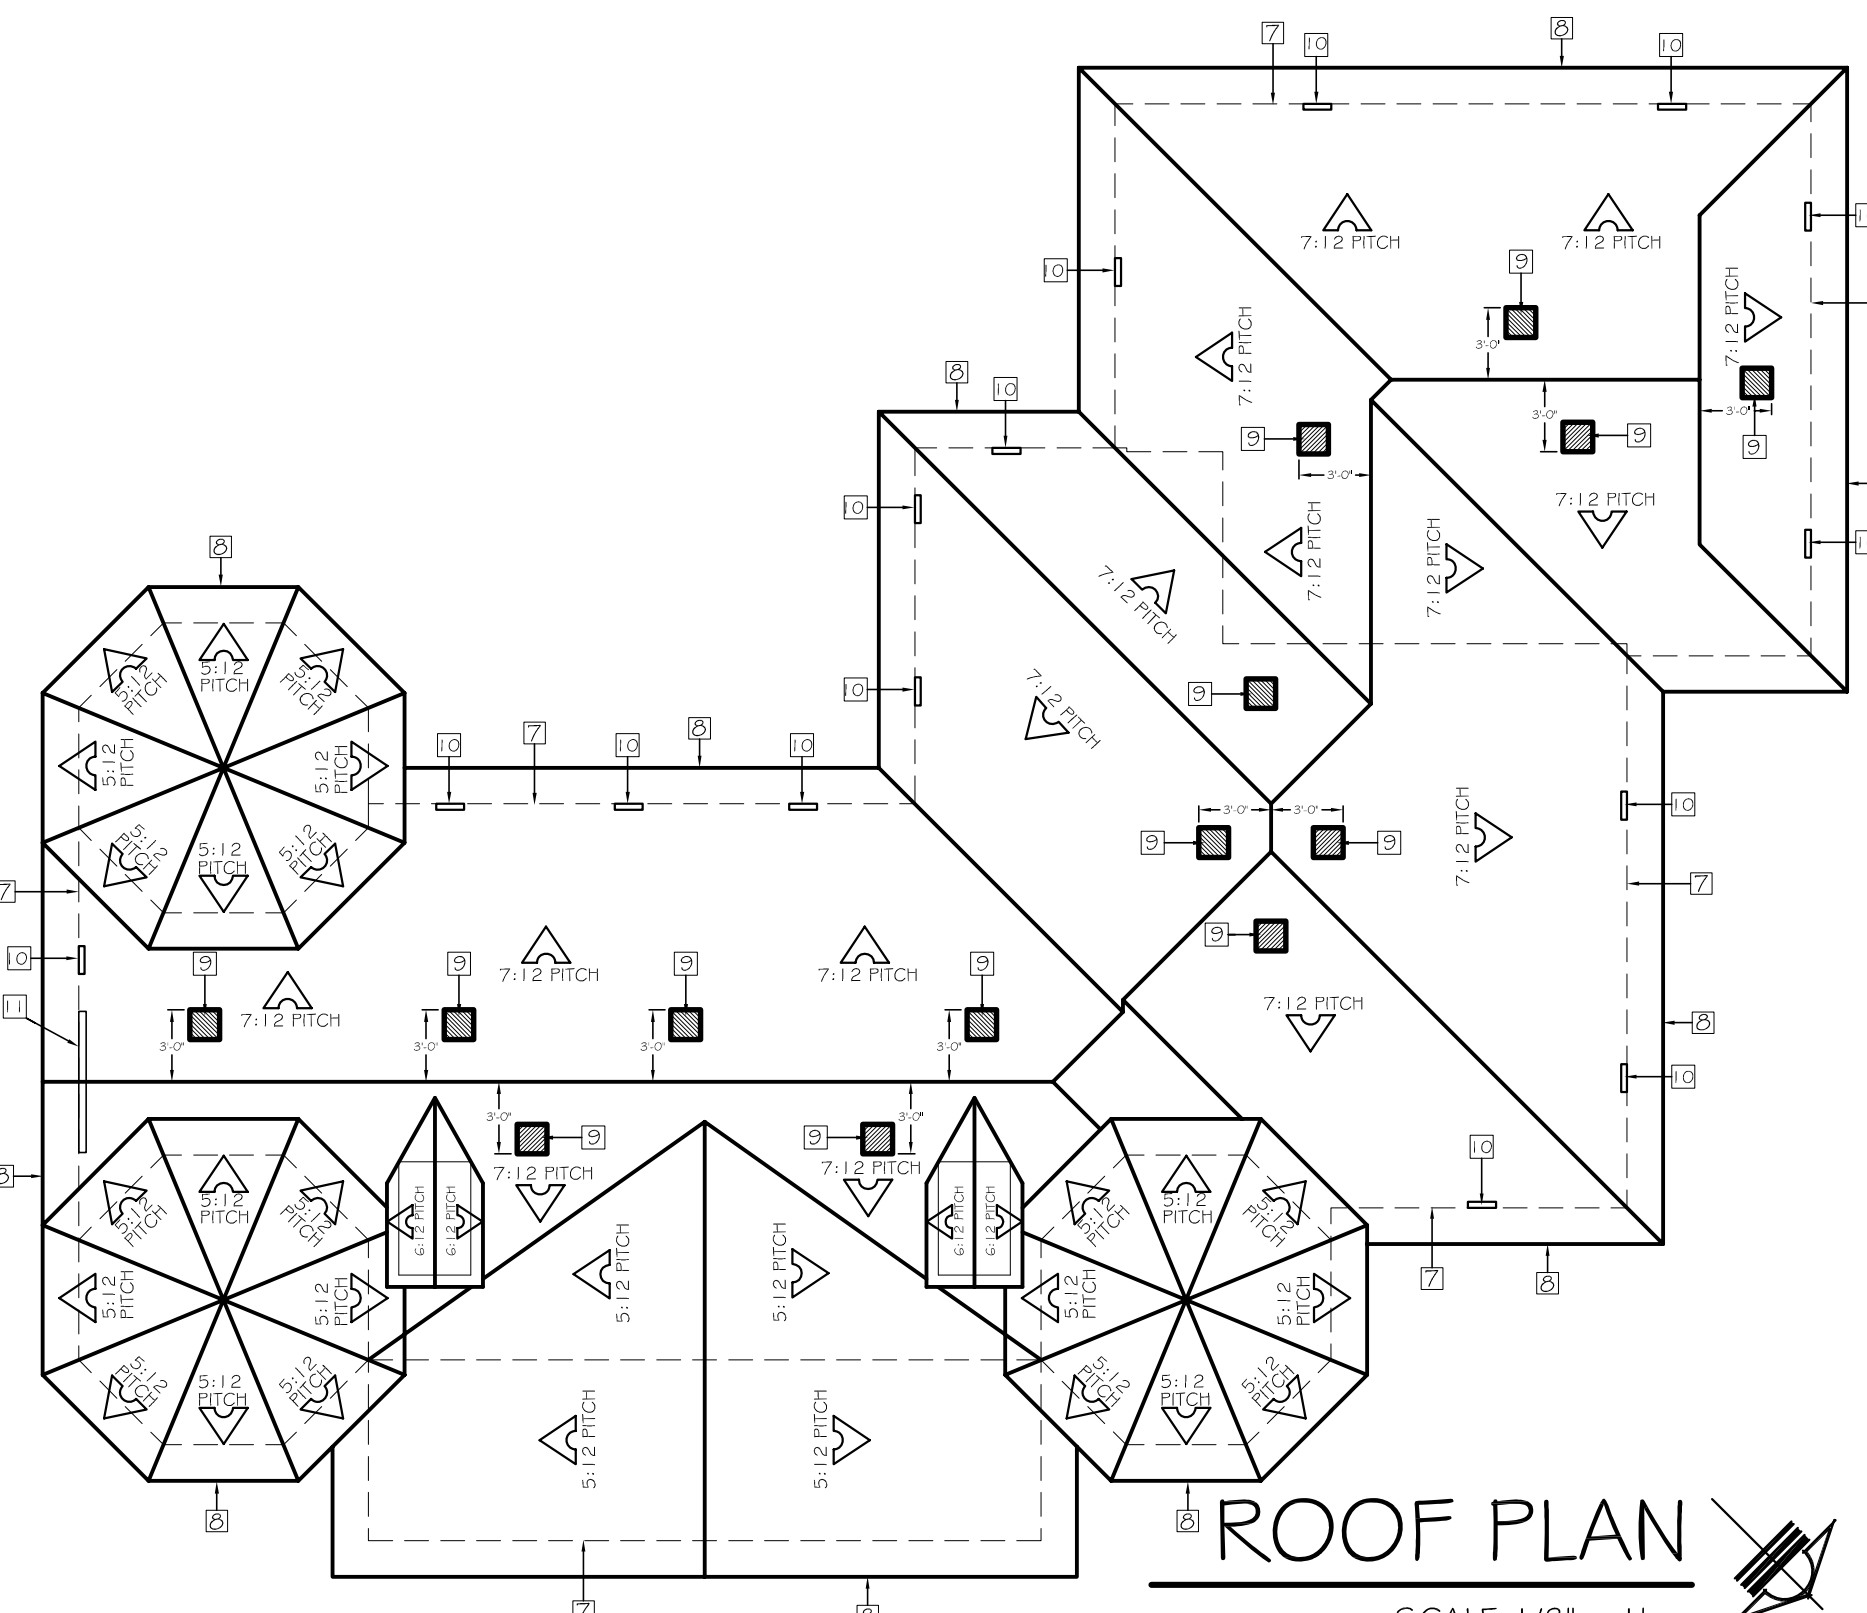

ROOF PLAN
 SCALE 1/8" = 1'

DESIGNED BY :

DRAFTING FOR ALL

DRAFTING FOR ALL
 Business Lic. HO-44660
 18455 YUCCA ST.
 HESPERIA CA 92345
 JAIME MEJIA A.
 Cell. Ph. (909) 534-3310
 E-mail: draftingforall@gmail.com

SIGNATURE: *Jaime Mejia*

REVISIONS:

DATE: BY:

S.F.D. (1-STORY) 1,857.00 SQ. FT.
2-CAR GARAGE 620.00 SQ. FT.
PORCH 211.00 SQ. FT.

CONSTRUCTION: **TOMAS RODRIGUEZ**

OWNER: **FABIOLA RODRIGUEZ MARTINEZ & FRANCISCO LOPEZ CRISOSTO**

PHONE: _____
 E-mail: crnsostof@yahoo.com

A PROJECT ADDRESS: _____
 CHESBRO LAKE DR.
 MORGAN HILL CA, 95037

DRAWN BY: JOSE LOPEZ
 CHECKED BY: JAIME M.
 SCALE: AS SHOWN

PROJECT INFO.
 PROJECT # 023-2020
 DATE: 02-08-2021
 APN: 776-33-004

DESIGNER & CONTRACTOR SHALL CHECK AND VERIFY ALL DIMENSIONS BEFORE PROCEEDING WITH THE WORK. REPORT DISCREPANCIES THE DESIGNER. ALL CONSTRUCTION SHALL CONFORM TO THE C.B.C.

SHEET: A-4 OF 16

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