

APN: 575-20-037
97.54 AC.


SHEET INDEX

- TM-01 EXISTING CONDITIONS
- TM-02 TREE REMOVAL
- TM-03 OVERALL VESTING TENTATIVE SUBDIVISION MAP
- TM-04 DEVELOPMENT AREA VESTING TENTATIVE SUBDIVISION MAP
- TM-05 AFFORDABLE HOUSING PLAN
- TM-06 PRELIMINARY GRADING, DRAINAGE, AND UTILITY PLAN
- TM-07 PRELIMINARY STORMWATER CONTROL PLAN
- TM-08 PRELIMINARY FIRE ACCESS PLAN
- WW-1 WASTEWATER FACILITIES LAYOUT
- WW-2 WASTEWATER TREATMENT DETAILS
- WW-3 WASTEWATER DISPOSAL DETAILS
- WW-4 WASTEWATER SITE EVALUATION DATA

EXISTING CONDITIONS
TM-01

CIRCLE HILL ESTATES
Santa Clara County, CA
November 24, 2024


Michael LaBarbera Legacy Trust - Winery Land Development
873 Blossom Hill Road San Jose, CA 95123
408.947.1166

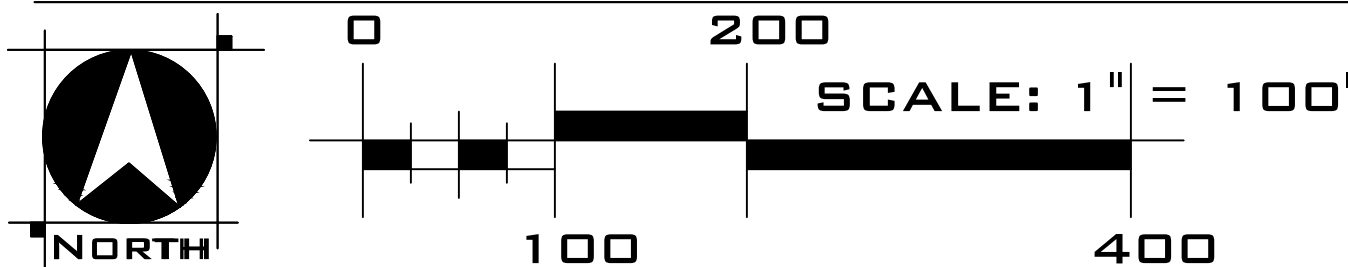

Anderson Architects INC

- Kurt B. Anderson, ASA
Principal
- 120 W. Campbell Ave, Suite D
Campbell, CA 95008
- Tel. 408.371.1269
- kbanderson@andersoninc.com
Cell: 408.202.5462

WOOD RODGERS
BUILDING RELATIONSHIPS ONE PROJECT AT A TIME
3875 HOPYARD ROAD, SUITE 345 Tel 925.847.1558
Pleasanton, CA. 94568 Fax 925.847.1557

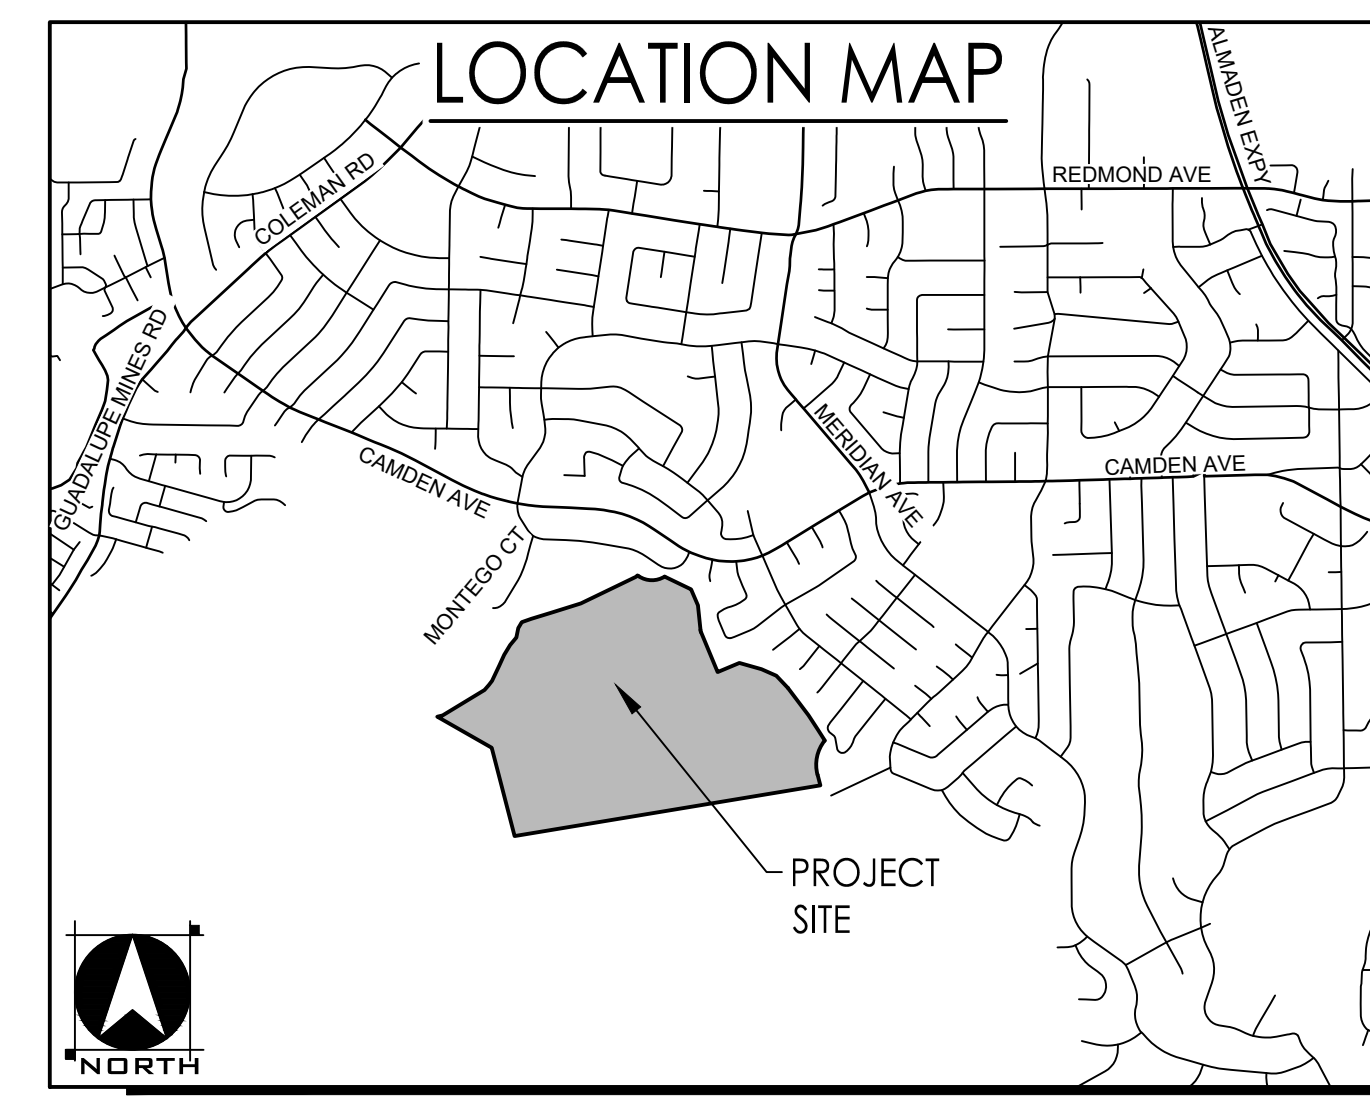


TREE REMOVAL LEGEND*

- REMAIN
- ✕ REMOVE

*SEE ARBORIST REPORT FOR DETAILS.

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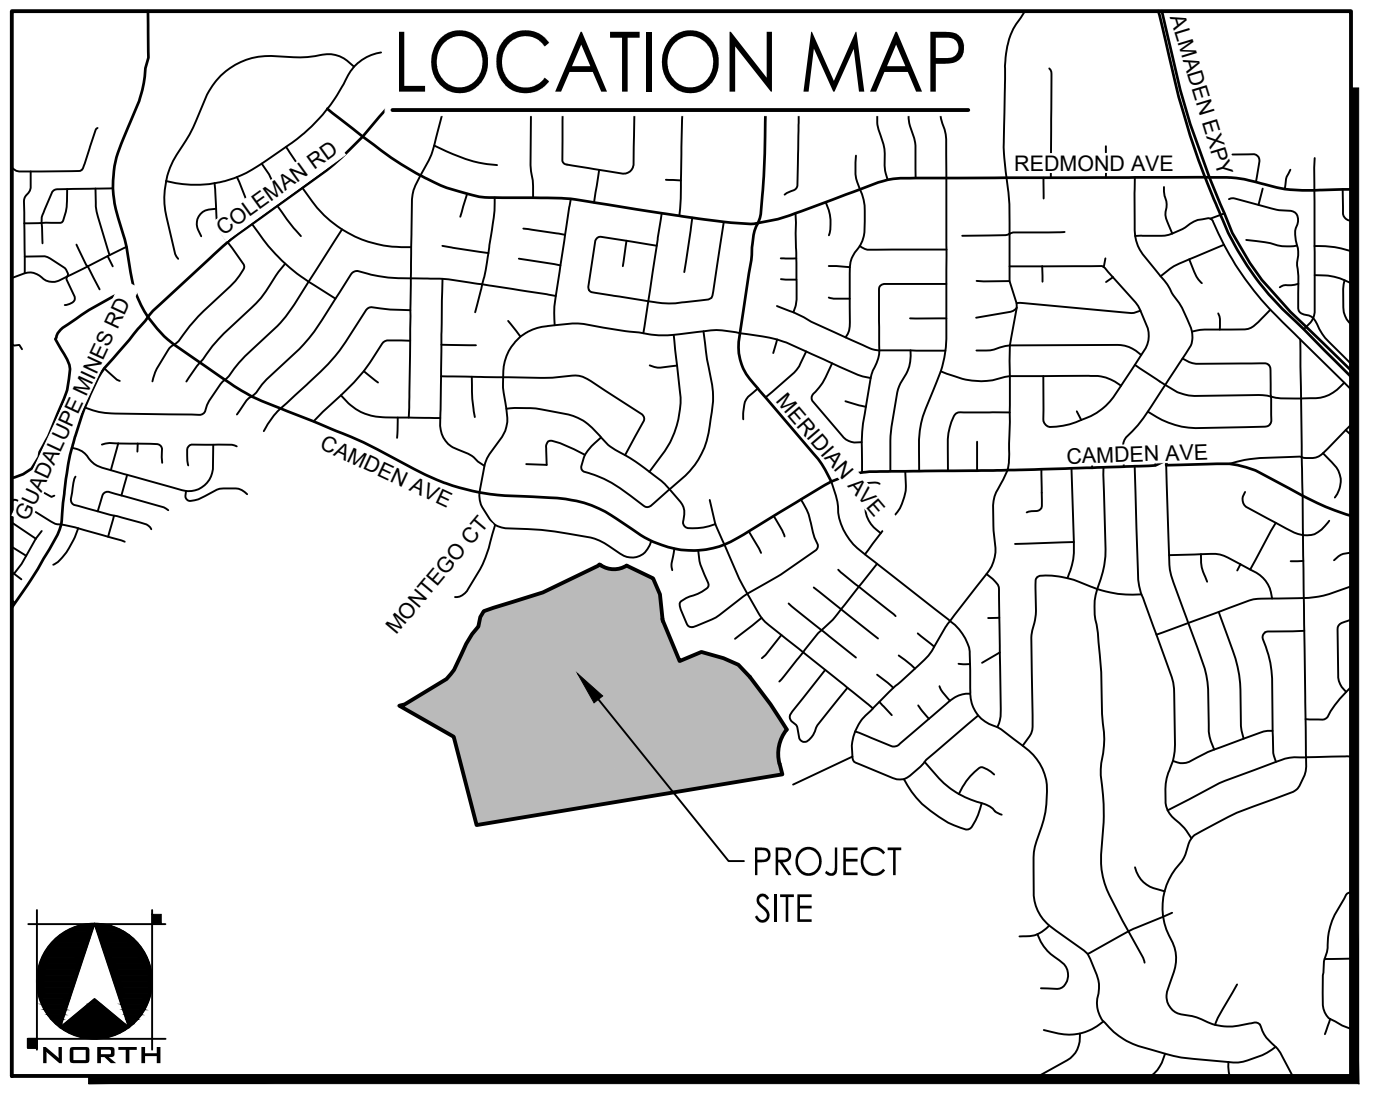
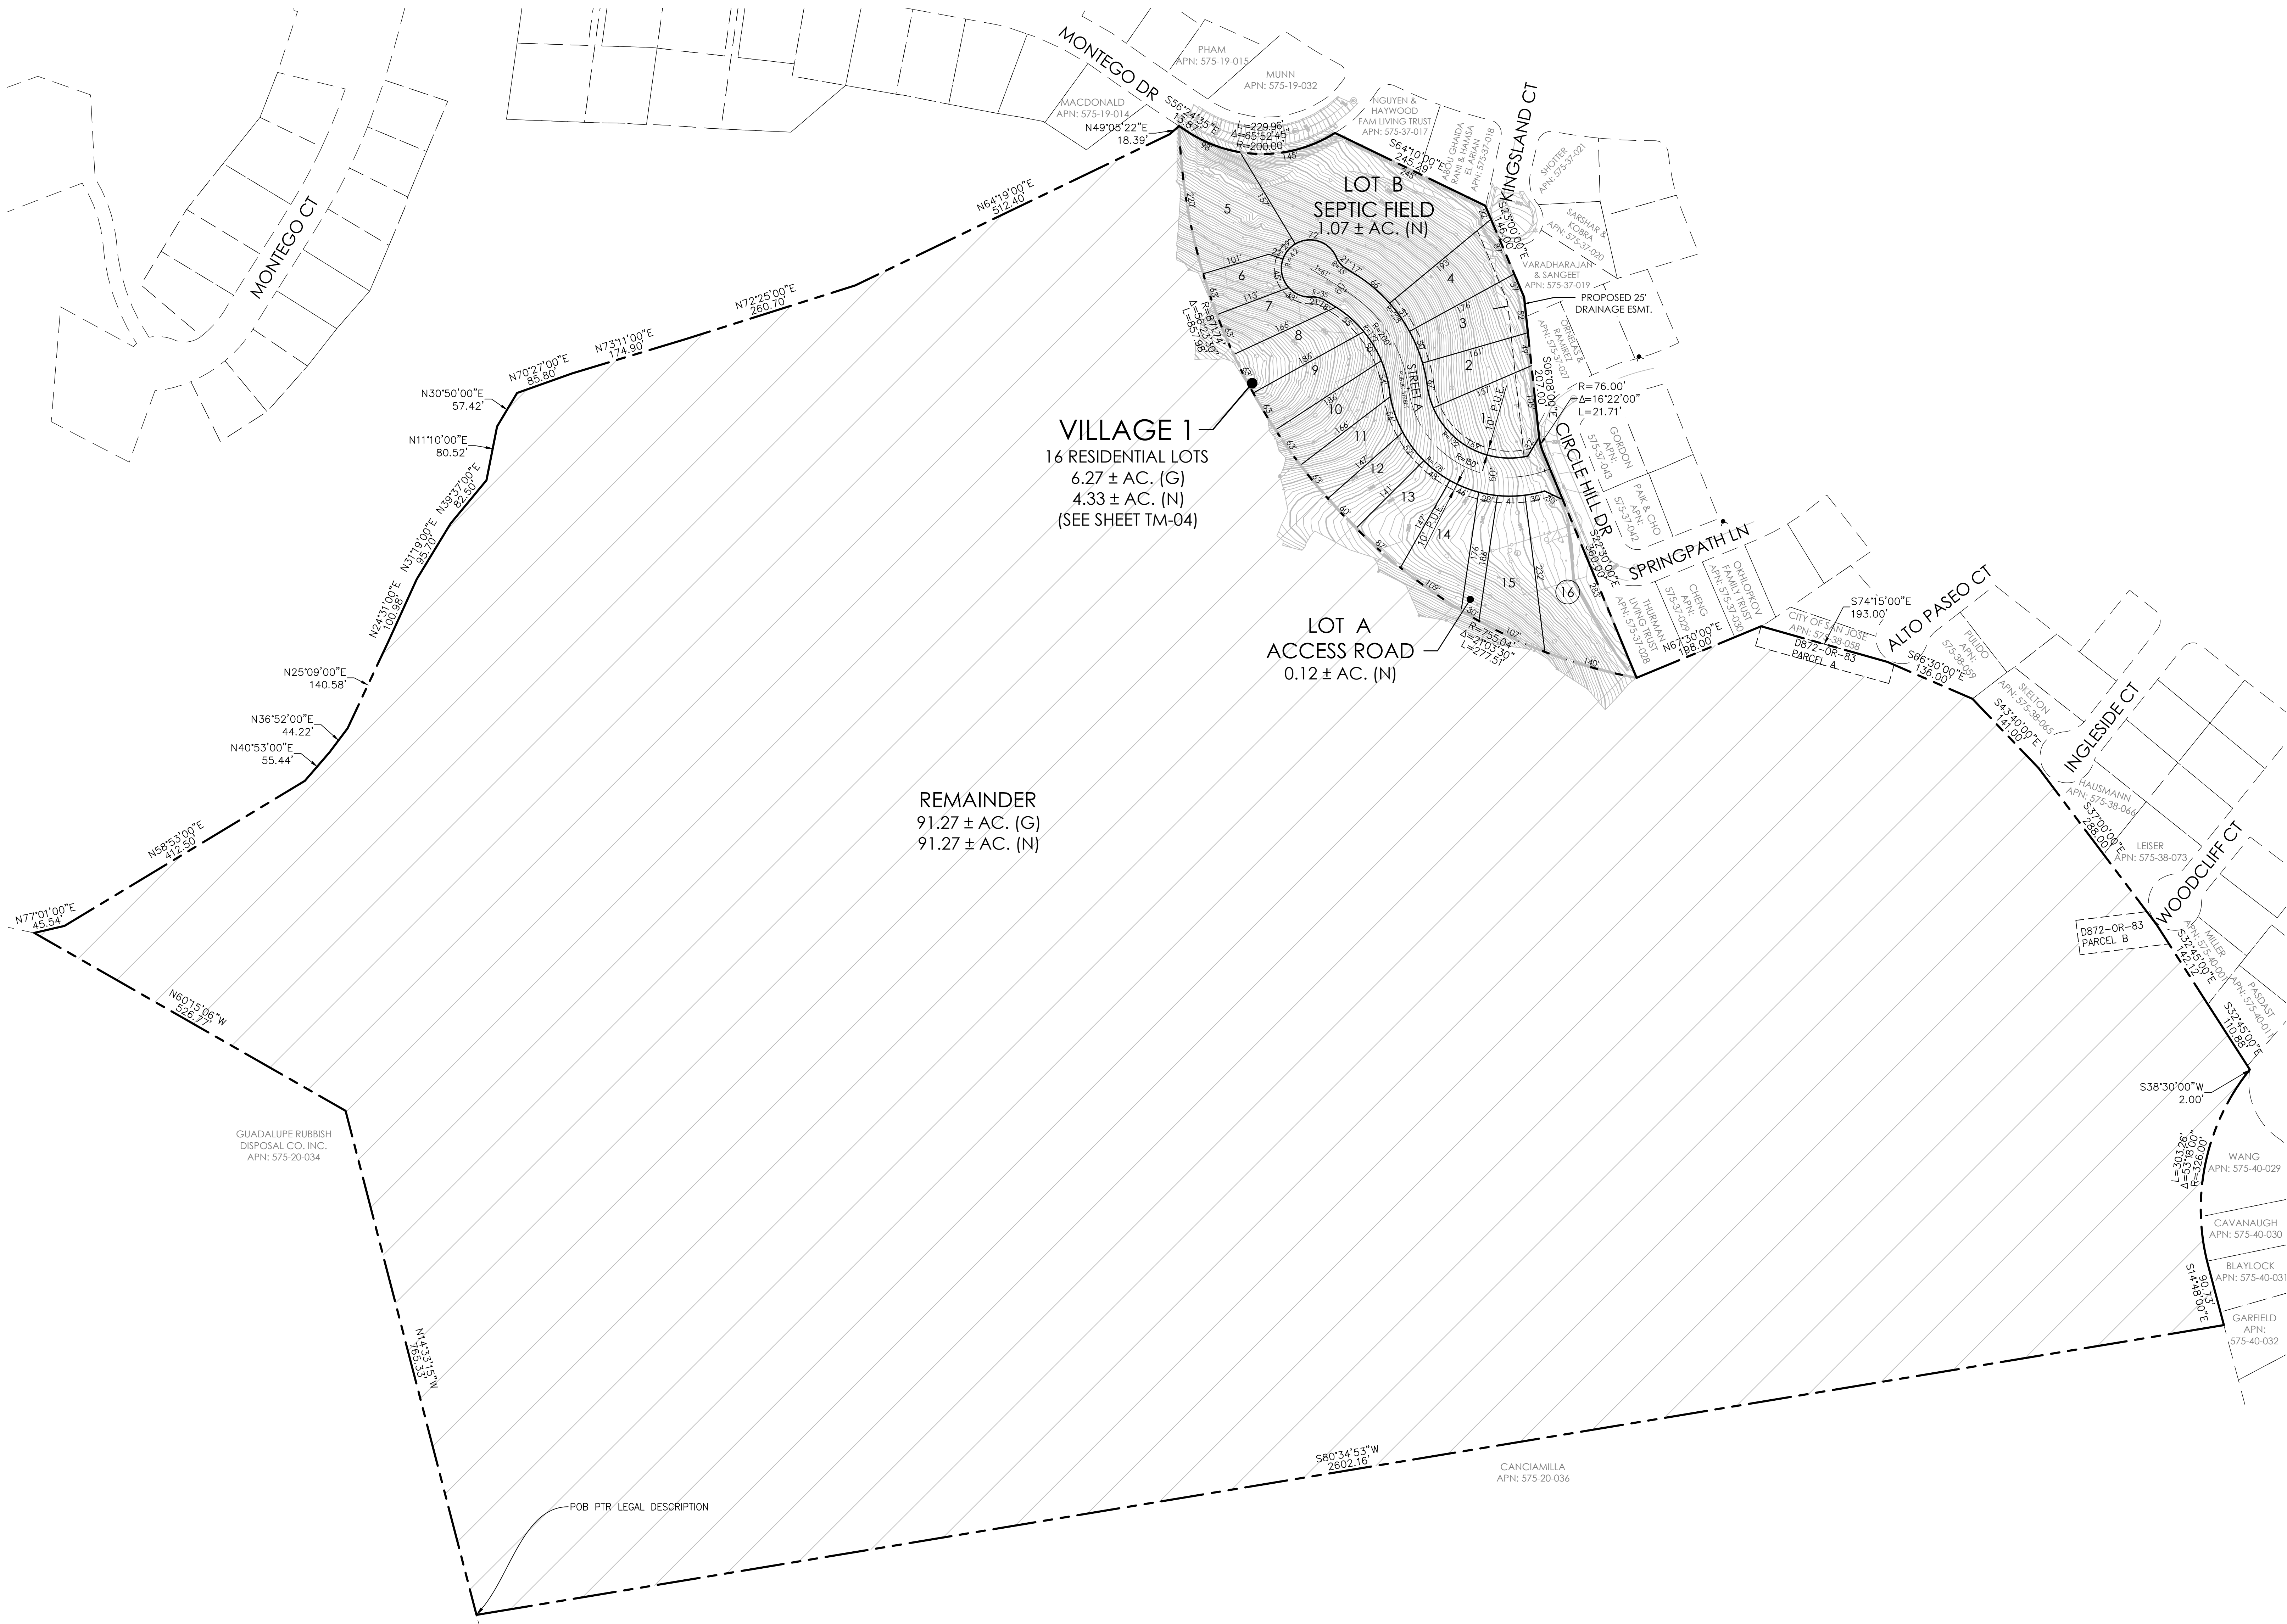

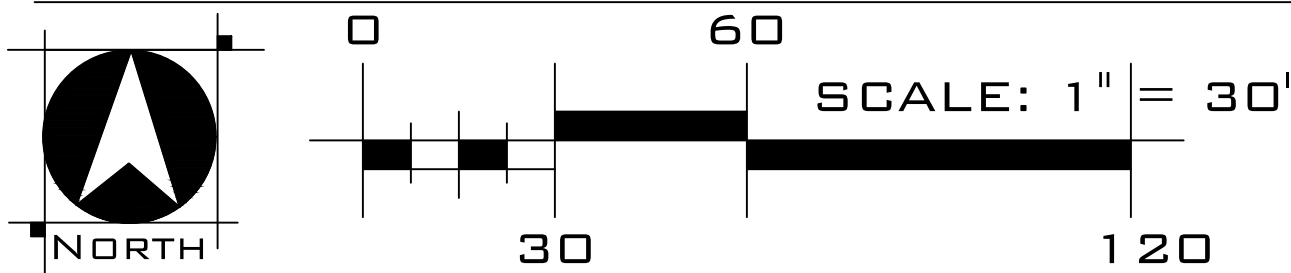
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 Pleasanton, CA. 94568 Fax 925.847.1557

TREE REMOVAL
 TM-02
CIRCLE HILL ESTATES
 Santa Clara County, CA
 November 24, 2024



PROJECT NOTES

APPLICANT/OWNER
 MIKE LABARBERA
 873 BLOSSOM HILL ROAD
 SAN JOSE, CA 95123
 CONTACT: MIKE LABARBERA
 PHONE: (408) 947-1166

PLANNER/ENGINEER
 WOOD RODGERS INC.
 3875 HOPYARD ROAD, SUITE 345
 PLEASANTON, CA 94588
 CONTACT: PAUL MEUSER | COLT ALVERNAZ
 PHONE: (925) 847-1549 | (925) 398-7915

ASSESSOR'S PARCEL NO.
 575-20-037

AREA
 97.54 ± ACRES GROSS

PROPOSED DEVELOPMENT SUMMARY
 16 SINGLE FAMILY RESIDENTIAL LOTS
 1 ACCESS ROAD LOT
 1 SEPTIC FIELD LOT
 1 REMAINDER LOT

DENSITY
 3.18 D.U./AC. GROSS

EXISTING USE
 VACANT

PROPOSED USE
 RESIDENTIAL

EXISTING ZONING
 HILLSIDE-D1

EXISTING GENERAL PLAN
 SANTA CLARA COUNTY

PARK DISTRICT
 SANTA CLARA COUNTY

FIRE PROTECTION
 SANTA CLARA COUNTY

SCHOOL DISTRICT
 SANTA CLARA COUNTY

SEWER
 PRIVATE

STORM DRAIN
 PRIVATE

WATER
 SAN JOSE WATER COMPANY


ELECTRICITY
 PG & E

GAS
 PG & E

NOTES
 1. SUBDIVIDER RESERVES THE RIGHT TO FILE MULTIPLE FINAL MAPS.
 2. THIS IS AN APPLICATION FOR A DEVELOPMENT PERMIT.
 3. PURSUANT TO SECTION 66434(G) OF THE SUBDIVISION MAP ACT, EASEMENTS TO BE ABANDONED ARE MARKED ON THE MAP.
 4. PUBLIC STREETS WILL BE DEDICATED TO THE COUNTY OF SANTA CLARA WITH THE FINAL SUBDIVISION MAP AND DESIGNED AND CONSTRUCTED IN ACCORDANCE WITH SANTA CLARA COUNTY DESIGN AND CONSTRUCTION STANDARDS. PUBLIC STREETS WILL BE INSPECTED AFTER CONSTRUCTION AND PRIOR TO FINAL ACCEPTANCE BY THE COUNTY.

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VESTING TENTATIVE SUBDIVISION MAP
 TM-03

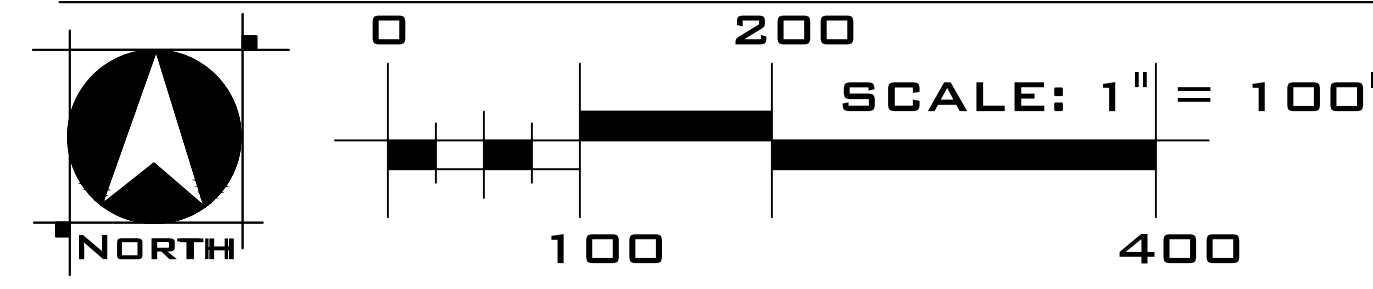



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WOOD RODGERS
 BUILDING RELATIONSHIPS ONE PROJECT AT A TIME

4670 WOODLAND ROAD, SUITE 1285 TEL 925.847.1556
 PLEASANTON, CA. 94588 FAX 925.847.1557

CIRCLE HILL ESTATES
 Santa Clara County, CA
 November 24, 2024



LEGEND

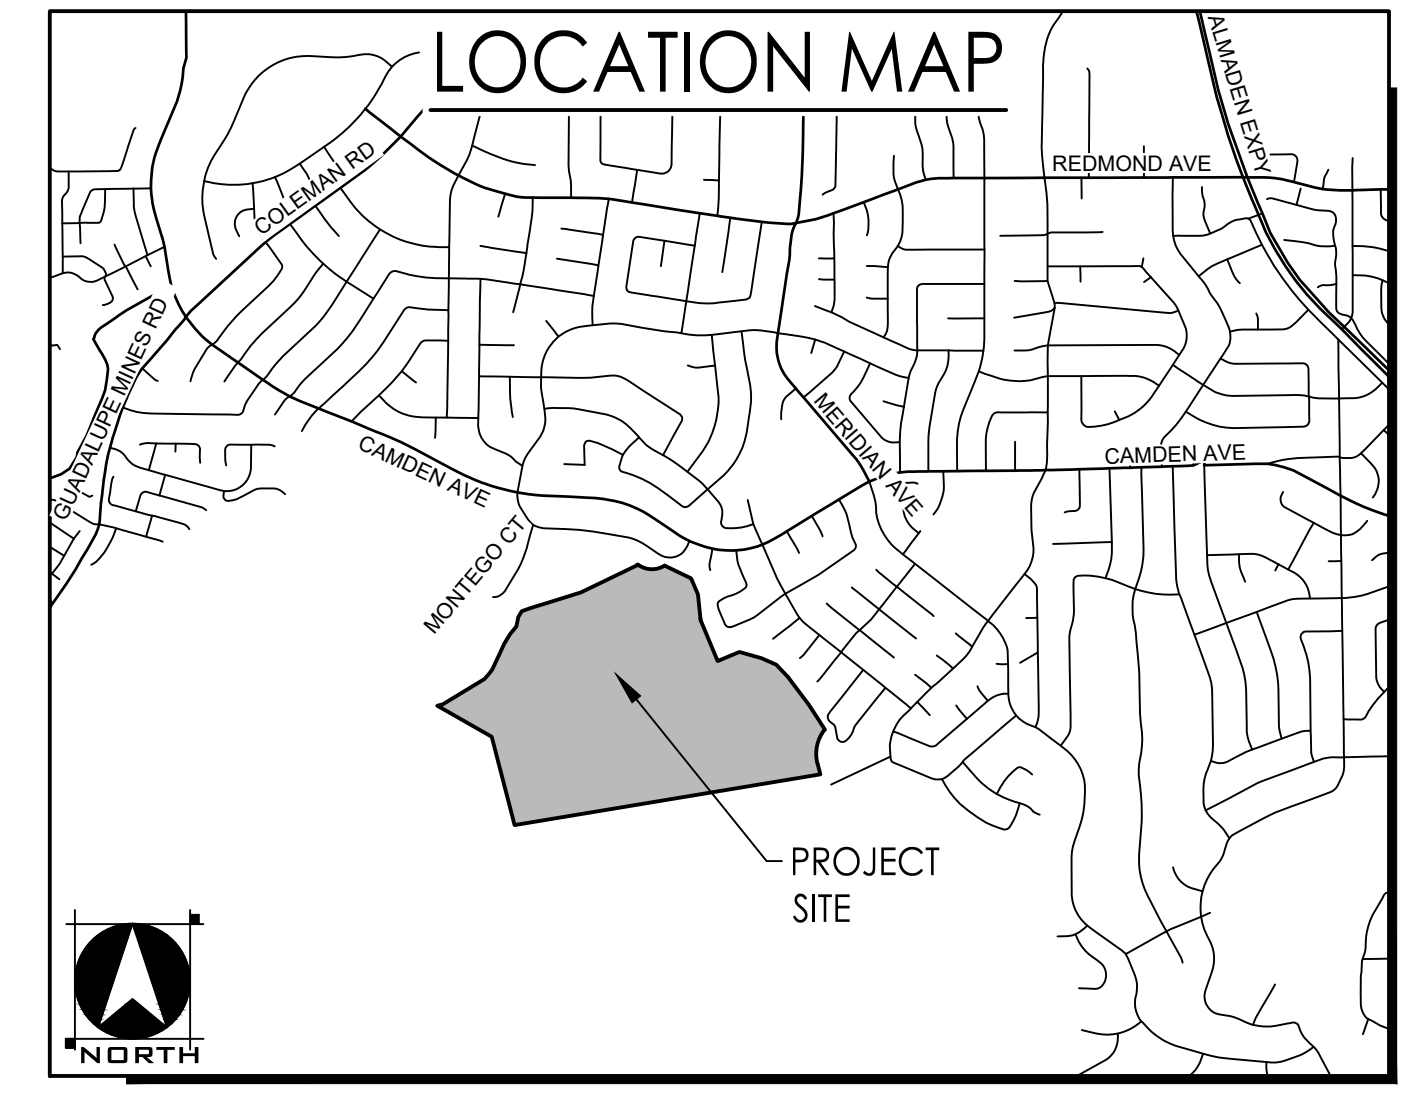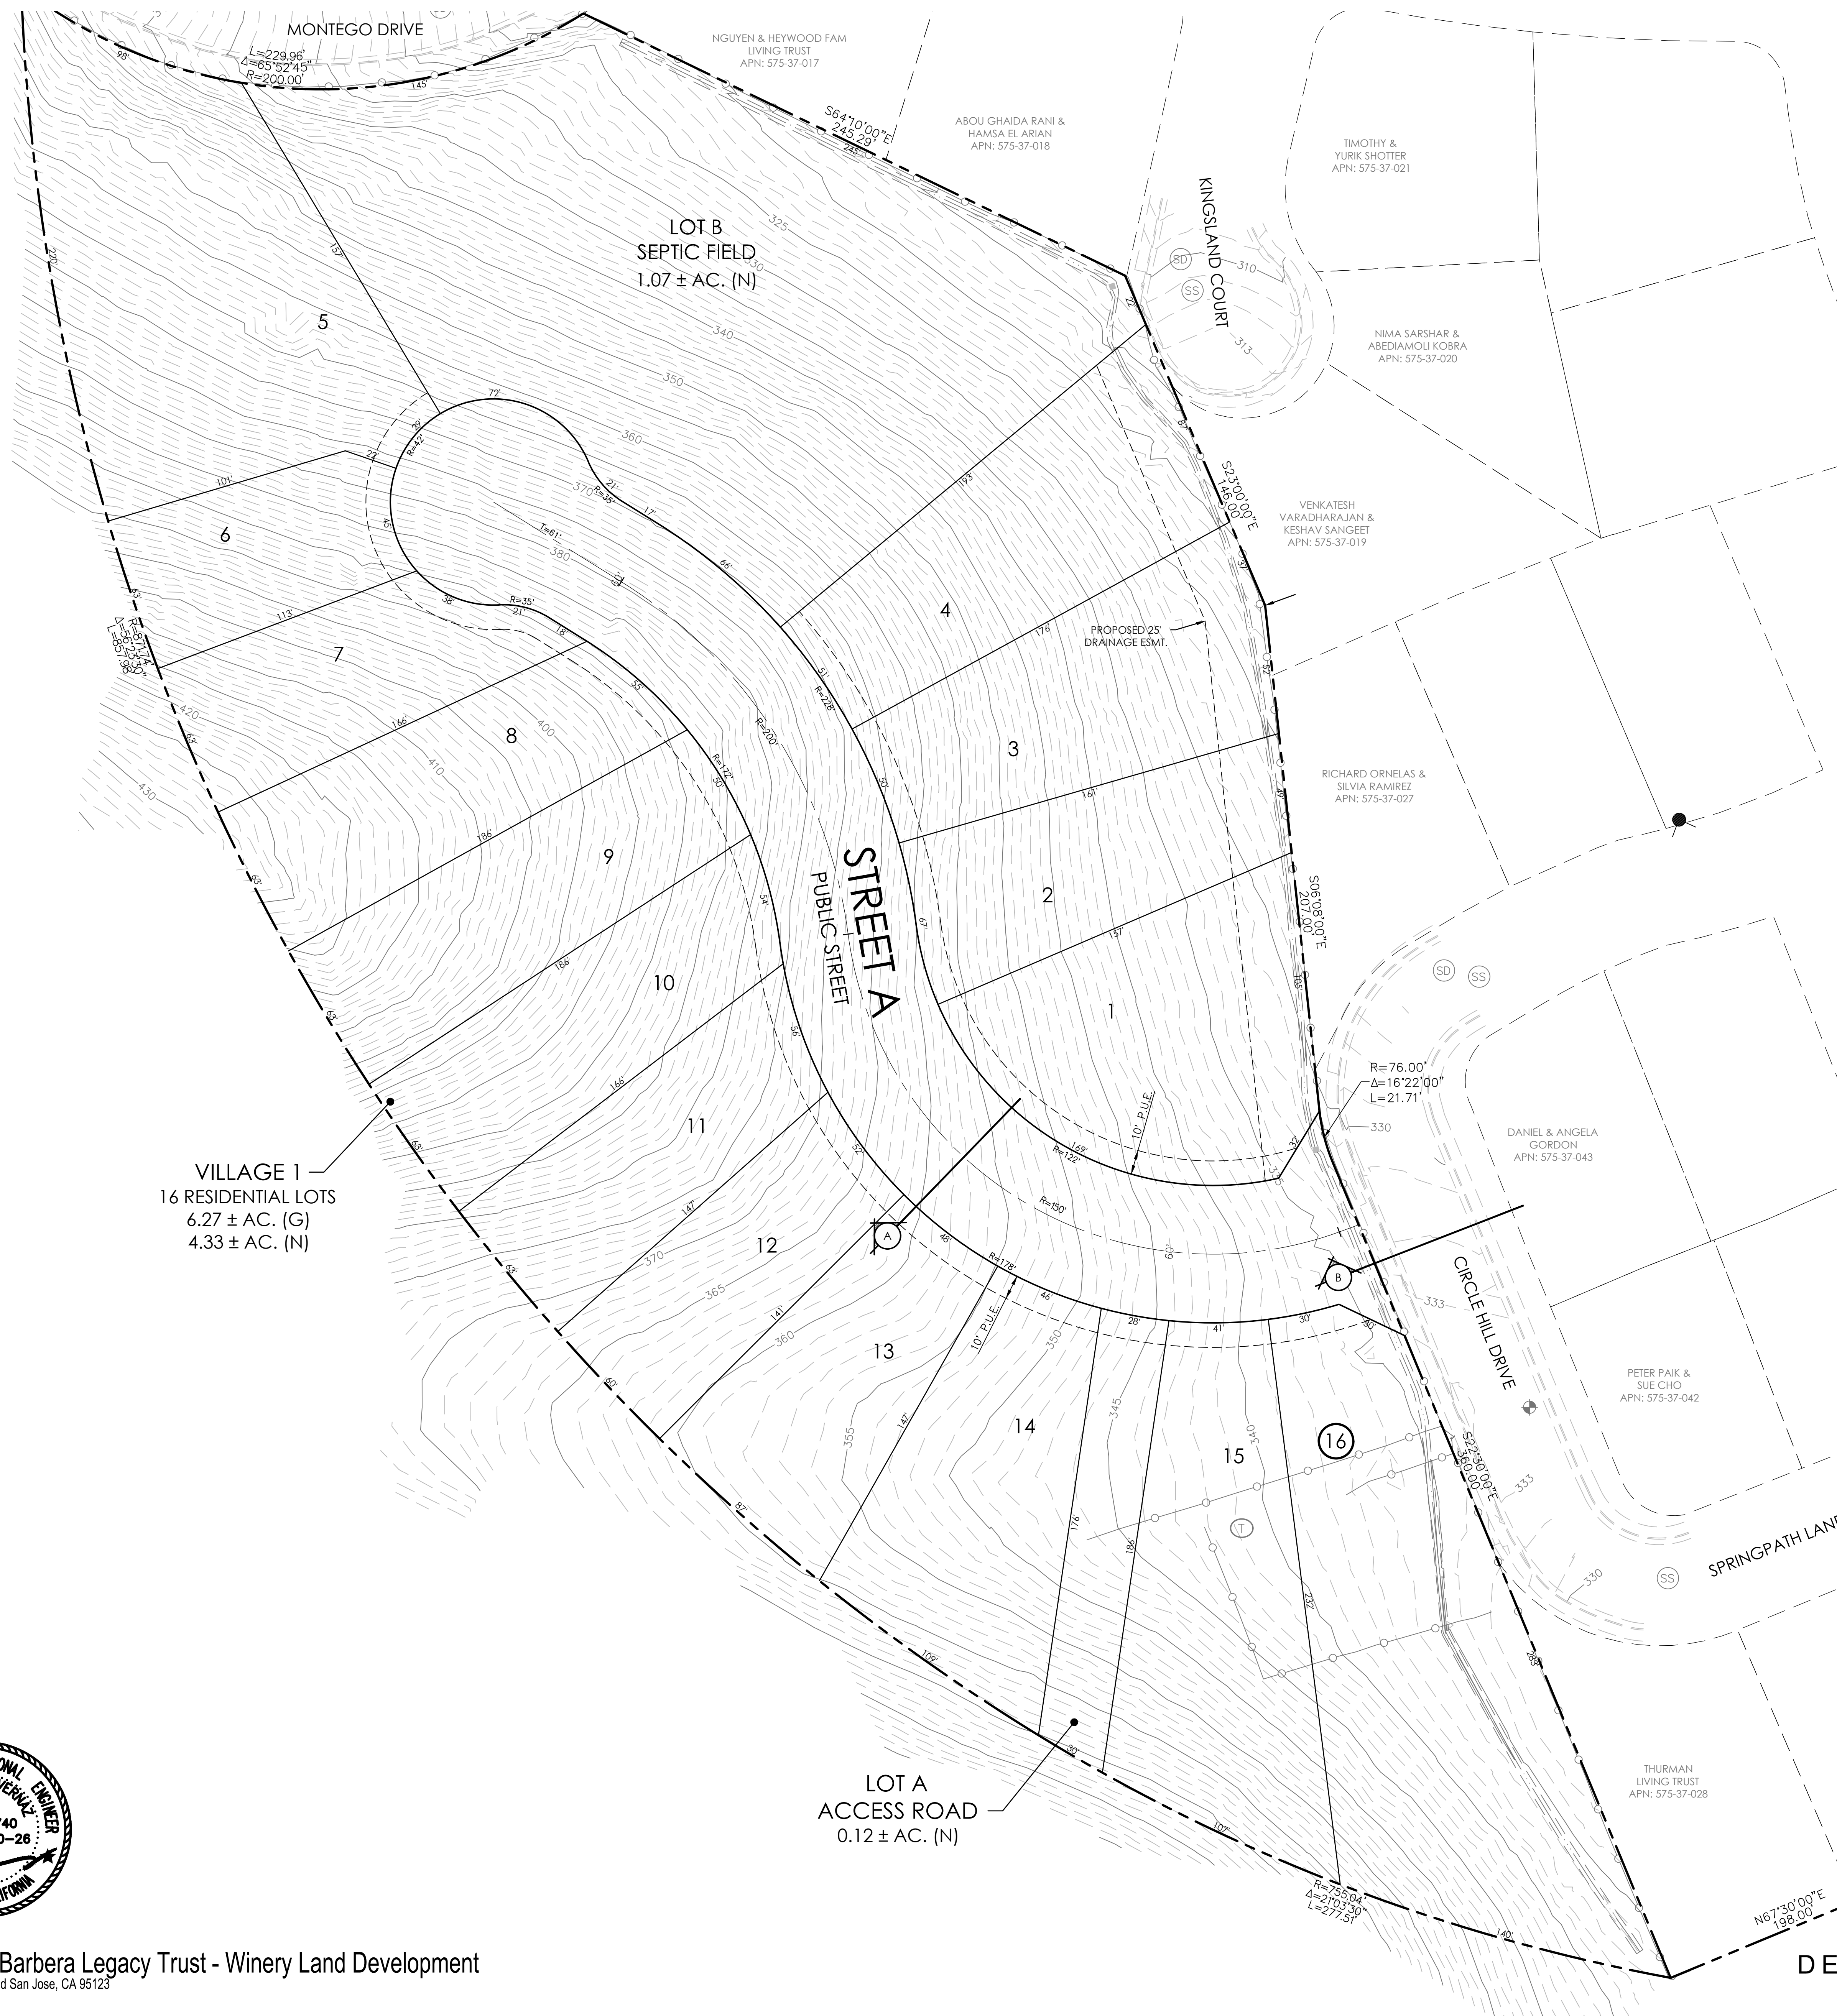- BENCH MARK (SET PK NAIL)
EL=333.5'
- FIRE HYDRANT
- 4" ABS PERC TEST RISER
- STORM DRAIN INLET
- STORM DRAIN MANHOLE
- SANITARY SEWER MANHOLE
- METAL STOCK WATER TROUGH
- WATER METER
- STREET LIGHT
- GATE

PROPERTY LINE: _____

ELEVATION CONTOUR (6' INTERVAL): _____

ELEVATION CONTOUR (1' INTERVAL): _____

FENCE: _____

EDGE OF PAVEMENT: _____


CONCRETE VEE DITCH: _____

LAND USE SUMMARY


LAND USE	AREA (NET)	DENSITY (NET)	DENSITY (GROSS)
16 SINGLE-FAMILY RESIDENTIAL LOTS	4.33 AC.		
1 ACCESS ROAD LOT	0.12 AC.		
1 SEPTIC FIELD LOT	1.07 AC.		
PUBLIC ROADS	0.75 AC.		
TOTAL	6.27 AC.	4.61 DU/AC.	3.18 DU/AC.

VILLAGE 1
16 RESIDENTIAL LOTS
6.27 ± AC. (G)
4.33 ± AC. (N)

LOT A
ACCESS ROAD
0.12 ± AC. (N)

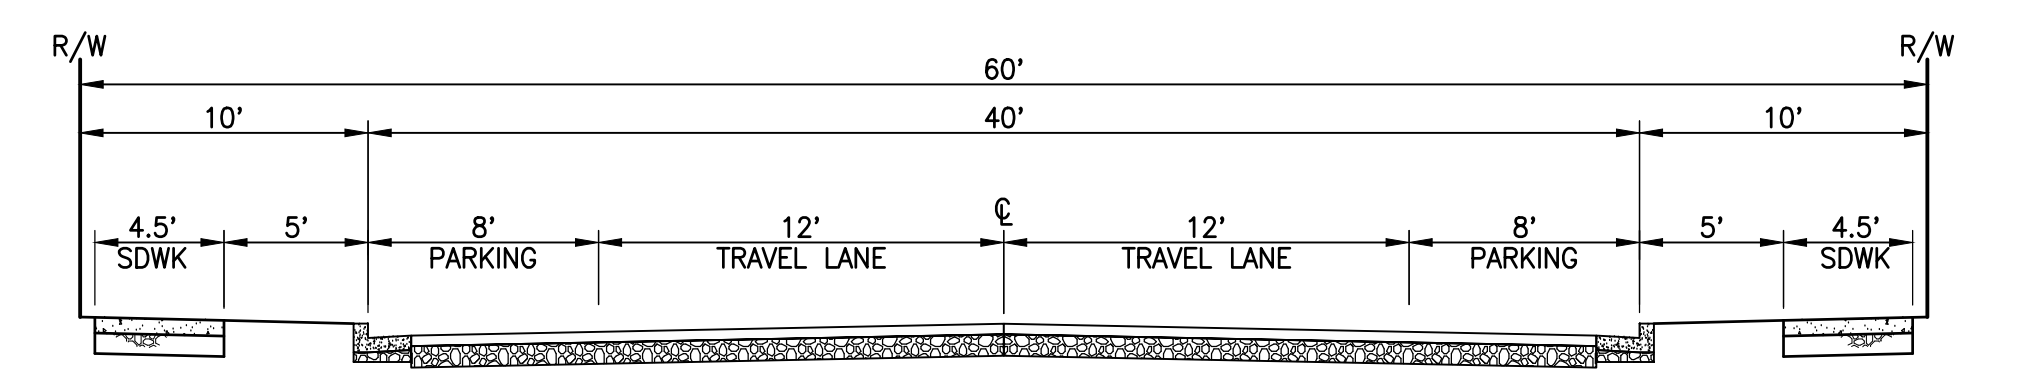


A RESIDENTIAL STREET
PROPOSED PUBLIC STREET SECTION
N.T.S.

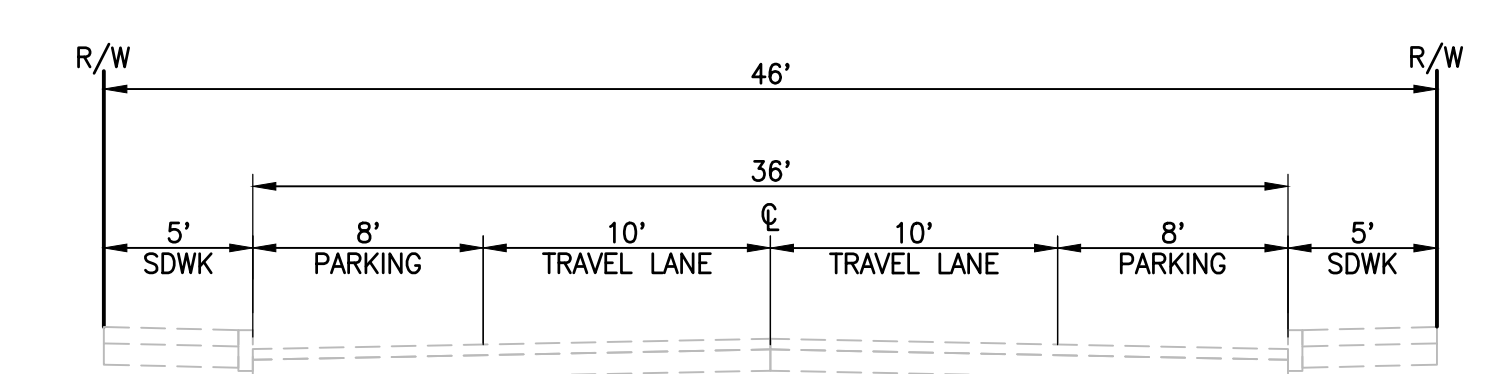

B EXISTING CIRCLE HILL DRIVE
EXISTING STREET SECTION
N.T.S.



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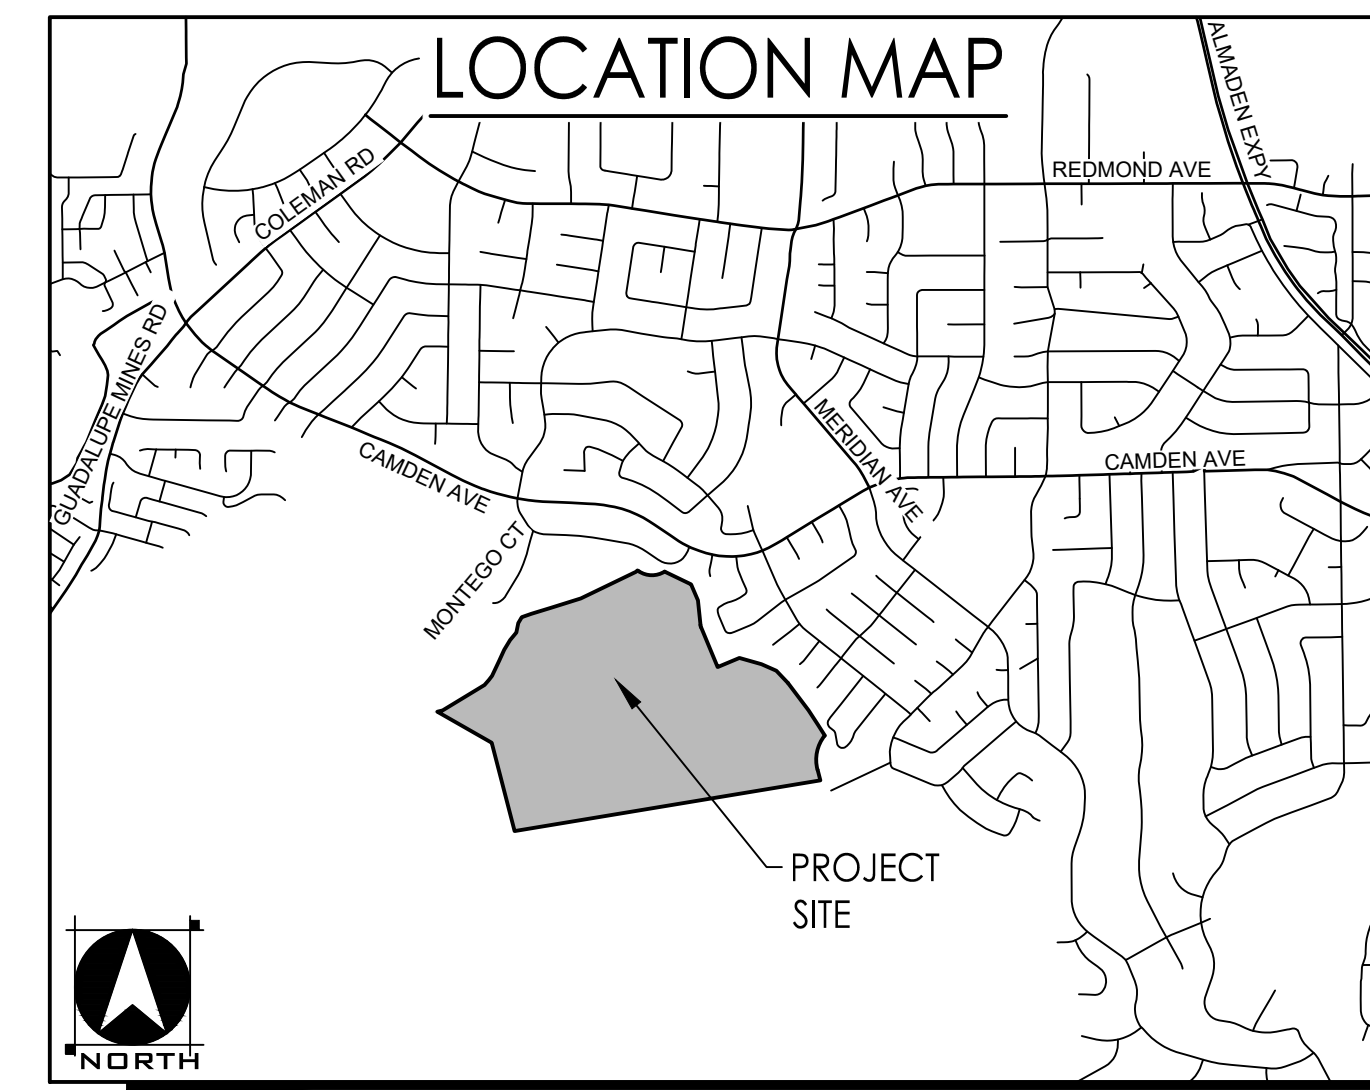
- Kurt B. Anderson, ASA
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- kbanderson@andarchinc.com
Cell: 408.202.5462
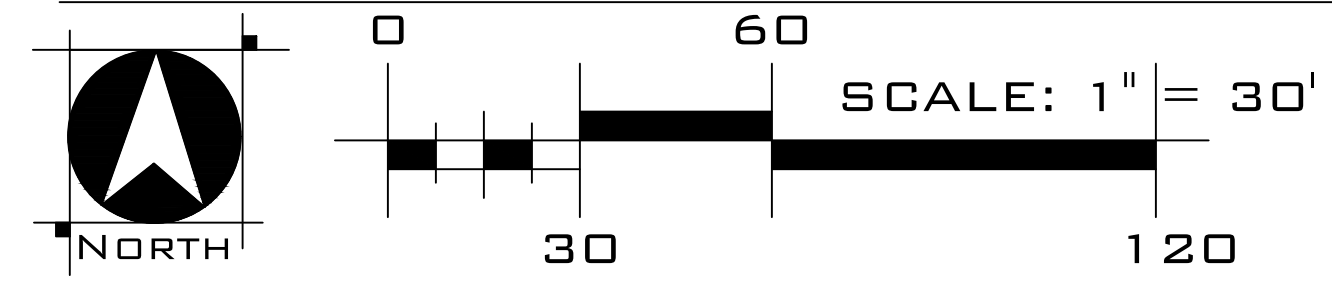
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DEVELOPMENT AREA VESTING TENTATIVE SUBDIVISION MAP
TM-04

CIRCLE HILL ESTATES
Santa Clara County, CA
November 24, 2024

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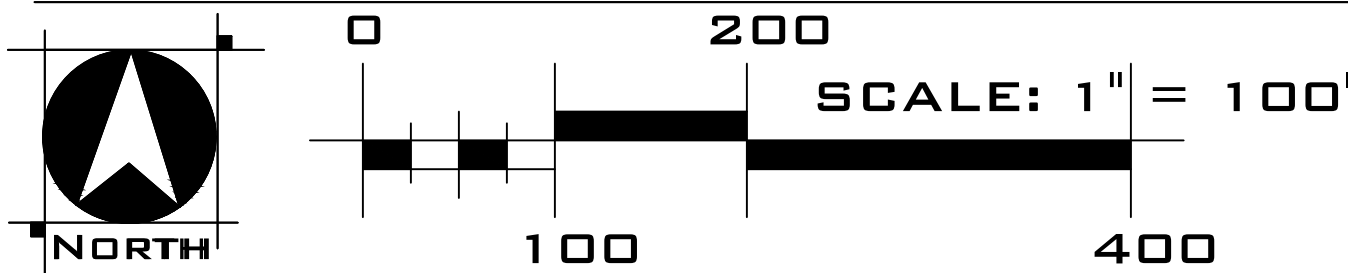


HOUSING SUMMARY

	INCOME LEVEL	UNIT COUNT	PERCENT MIX
*	LOW INCOME	4	20
■	NOT RESTRICTED	16	80
TOTAL		20	100

*LOW INCOME UNITS WILL BE PROVIDED AS ACCESSORY DWELLING UNITS, DEED RESTRICTED AS AFFORDABLE, ON THE SAME LOT AS A SINGLE FAMILY HOME WITH NO AFFORDABILITY RESTRICTIONS. THE LOCATION OF THE FOUR ACCESSORY DWELLING UNITS IS CONCEPTUAL. SUCH THAT THESE 4 UNITS CAN BE LOCATED ON ANY OF THE PROPOSED 16 LOTS.

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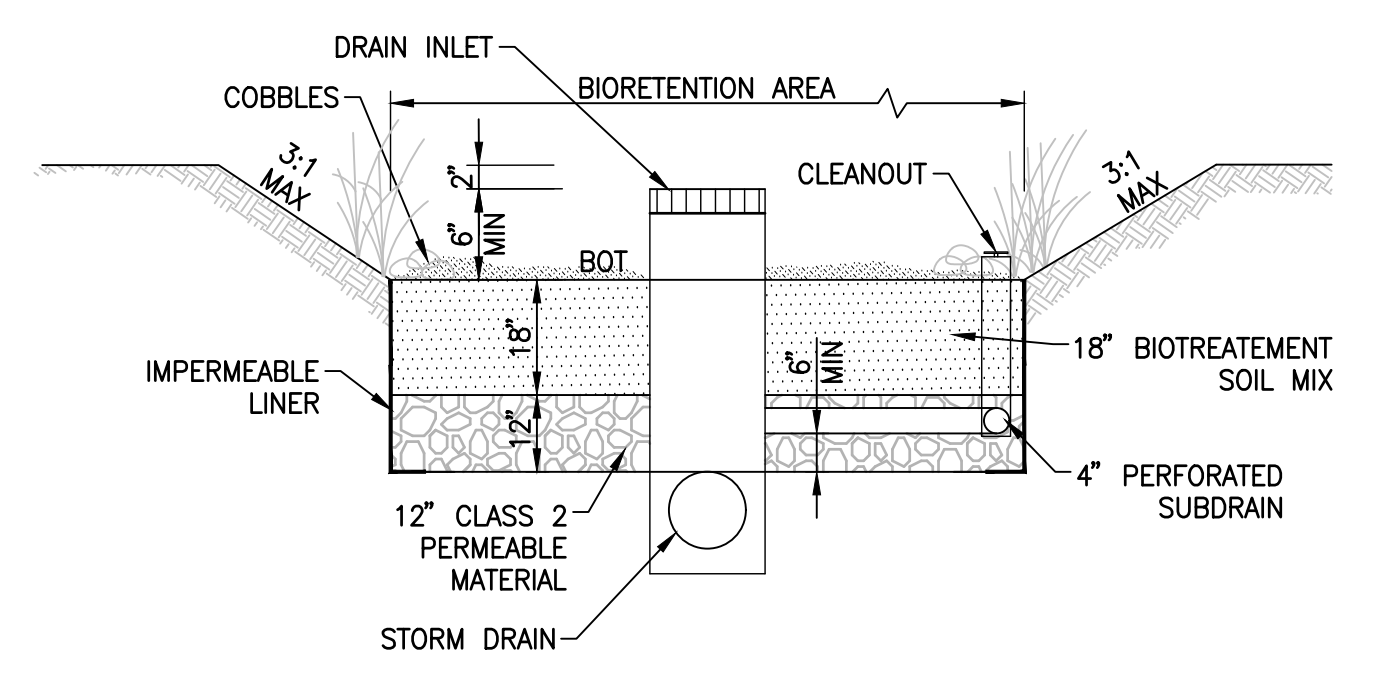
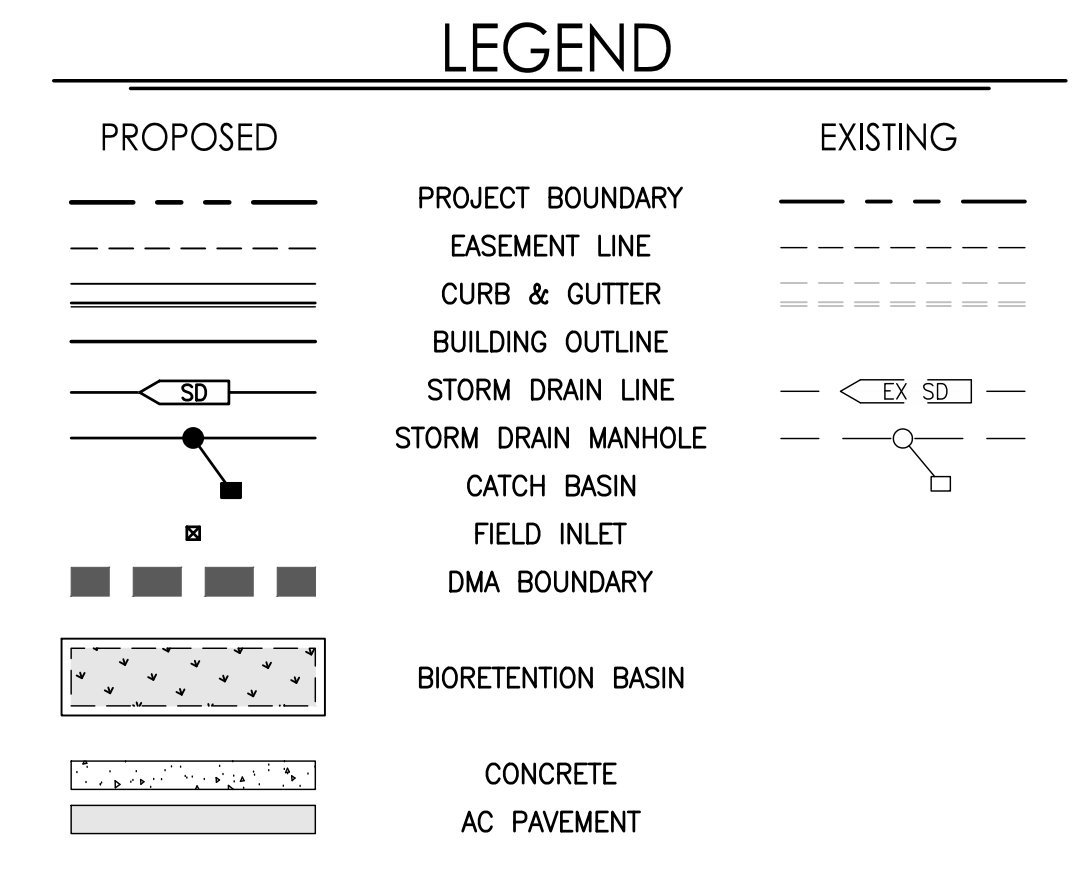
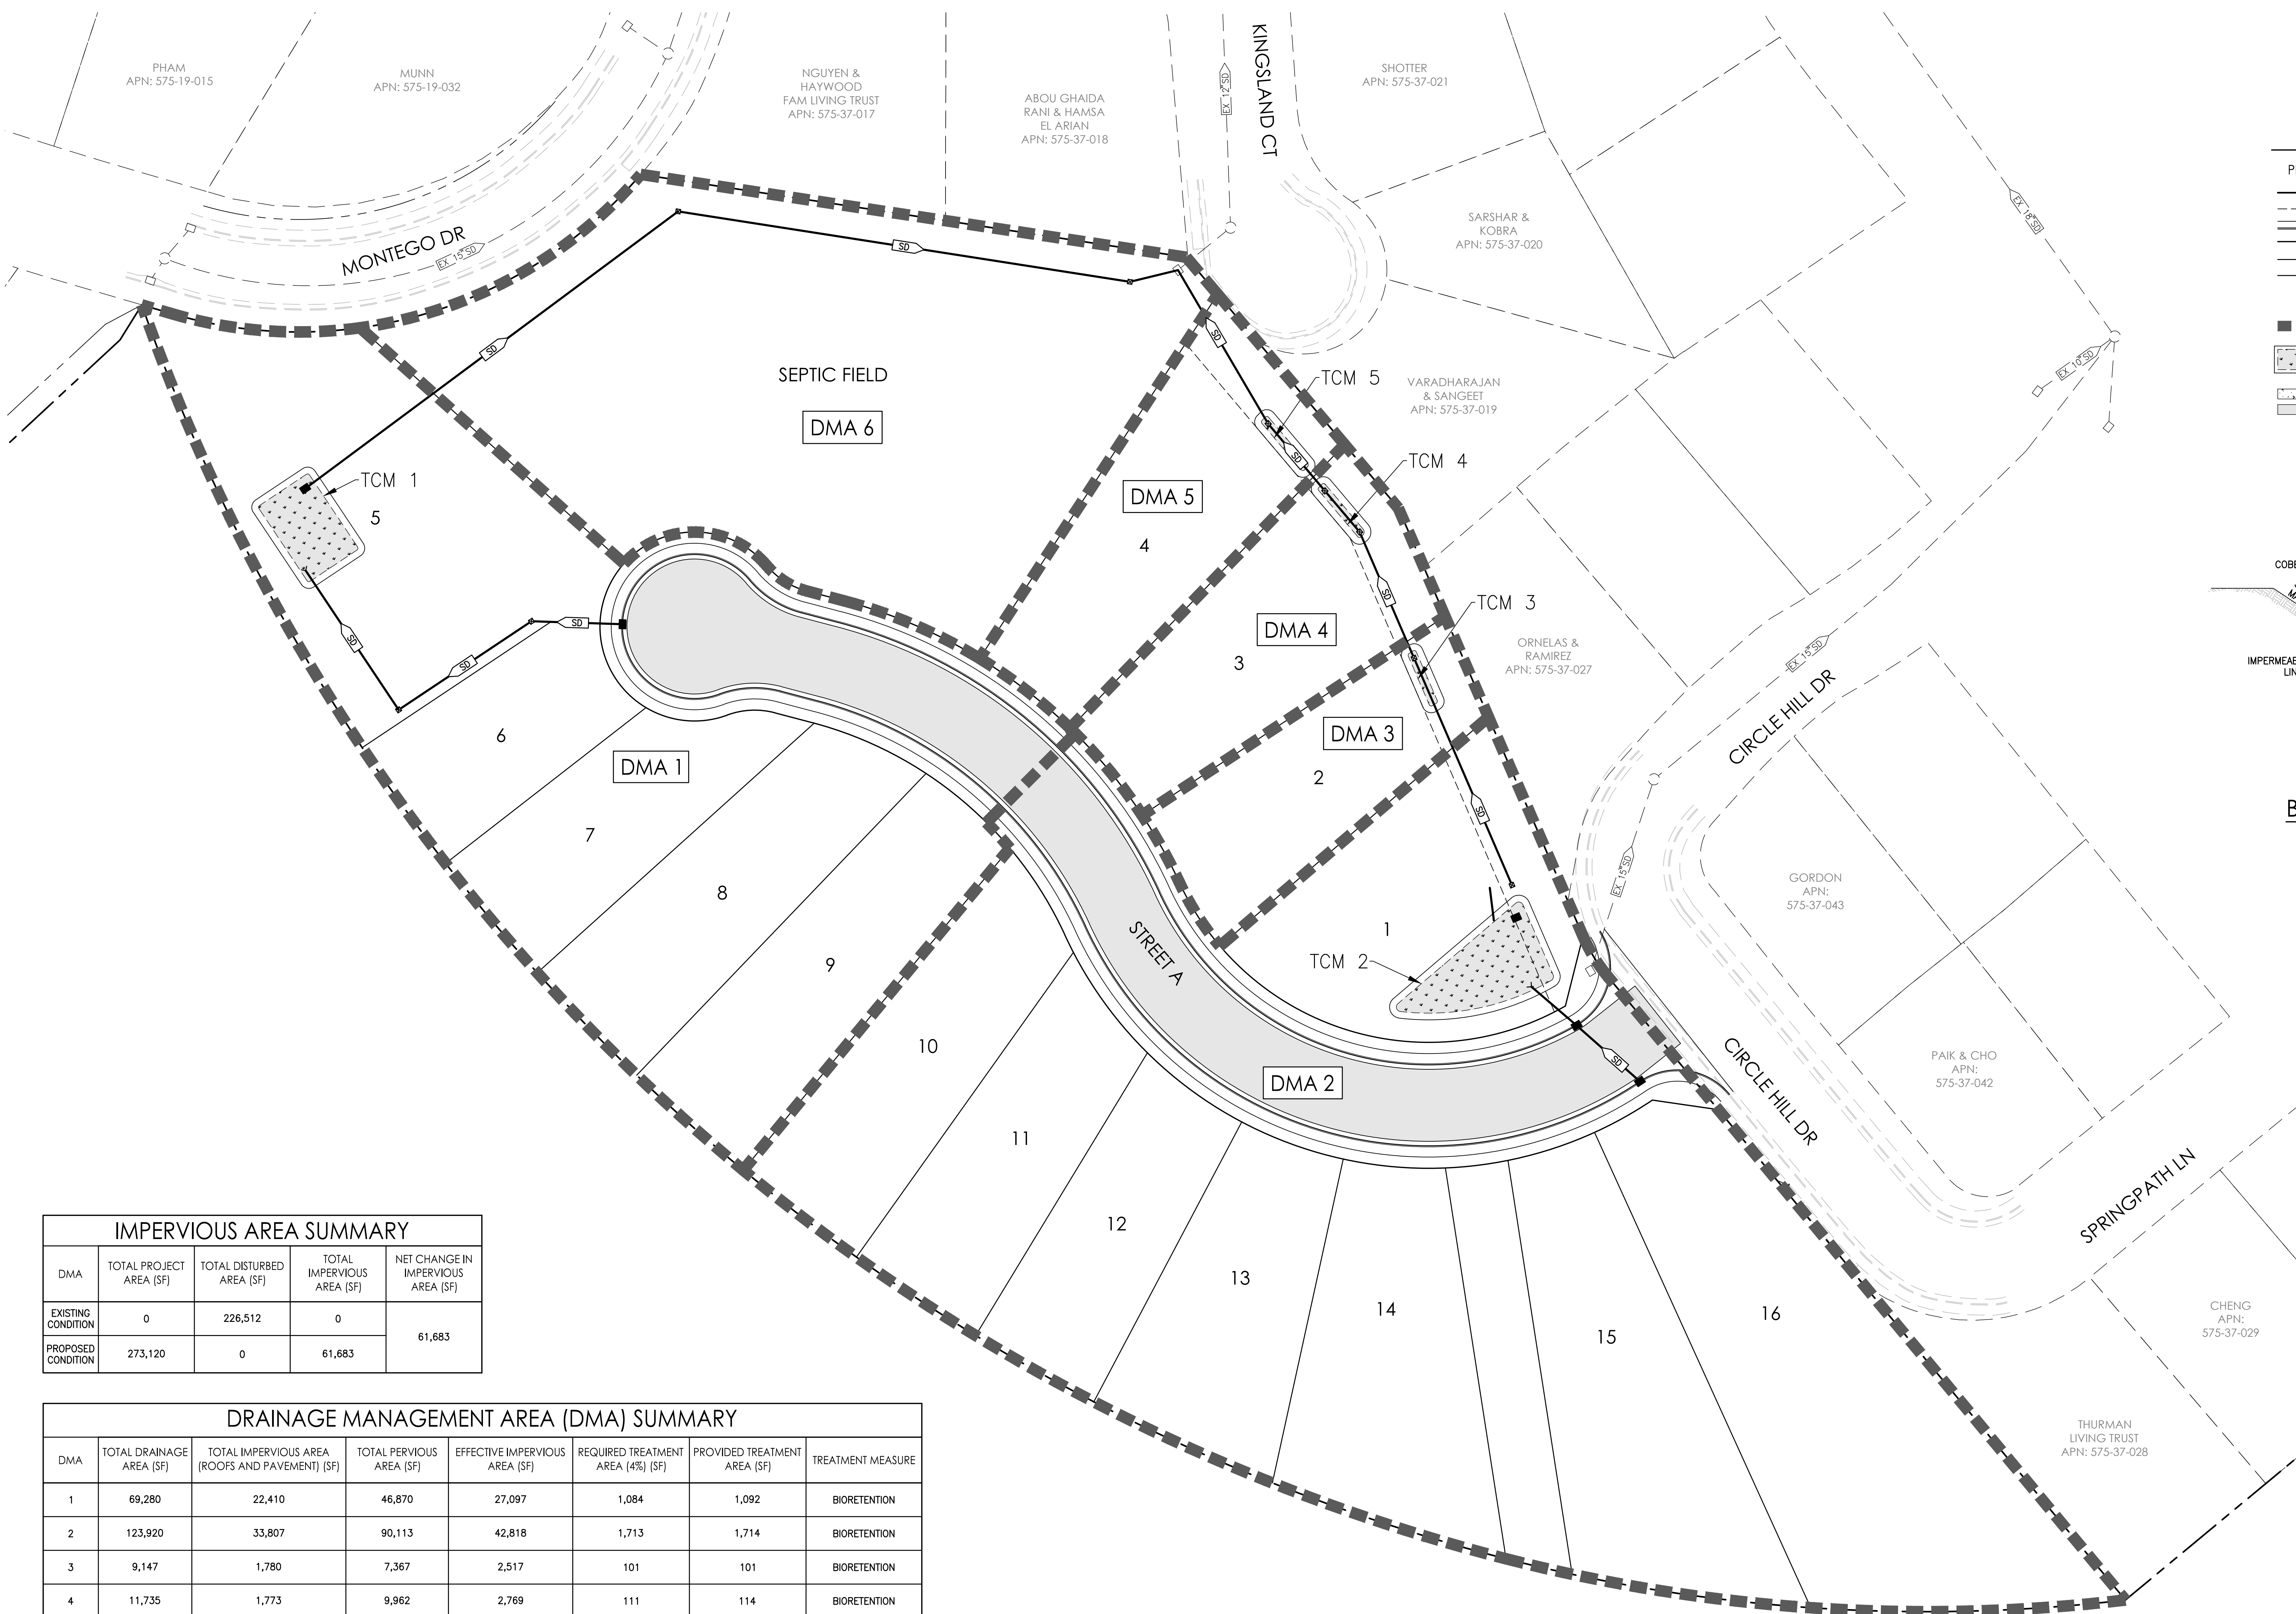


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 ■ kbanderson@andersoninc.com
 Call 408.202.5462



AFFORDABLE HOUSING PLAN
 TM-05

CIRCLE HILL ESTATES
 Santa Clara County, CA
 November 24, 2024



BIORETENTION BASIN DETAIL
NTS

ABBREVIATIONS

BOT	BOTTOM
DMA	DRAINAGE MANAGEMENT AREA
EX	EXISTING
MAX	MAXIMUM
MIN	MINIMUM
SD	STORM DRAIN
SF	SQUARE FEET
TCM	TREATMENT CONTROL MEASURE


IMPERVIOUS AREA SUMMARY

DMA	TOTAL PROJECT AREA (SF)	TOTAL DISTURBED AREA (SF)	TOTAL IMPERVIOUS AREA (SF)	NET CHANGE IN IMPERVIOUS AREA (SF)
EXISTING CONDITION	0	226,512	0	61,683
PROPOSED CONDITION	273,120	0	61,683	

DRAINAGE MANAGEMENT AREA (DMA) SUMMARY

DMA	TOTAL DRAINAGE AREA (SF)	TOTAL IMPERVIOUS AREA (ROOFS AND PAVEMENT) (SF)	TOTAL PERVIOUS AREA (SF)	EFFECTIVE IMPERVIOUS AREA (SF)	REQUIRED TREATMENT AREA (4%) (SF)	PROVIDED TREATMENT AREA (SF)	TREATMENT MEASURE
1	69,280	22,410	46,870	27,097	1,084	1,092	BIORETENTION
2	123,920	33,807	90,113	42,818	1,713	1,714	BIORETENTION
3	9,147	1,780	7,367	2,517	101	101	BIORETENTION
4	11,735	1,773	9,962	2,769	111	114	BIORETENTION
5	12,484	1,777	10,707	2,848	114	115	BIORETENTION
6	46,554	136	46,418	—	—	—	SELF-TREATING

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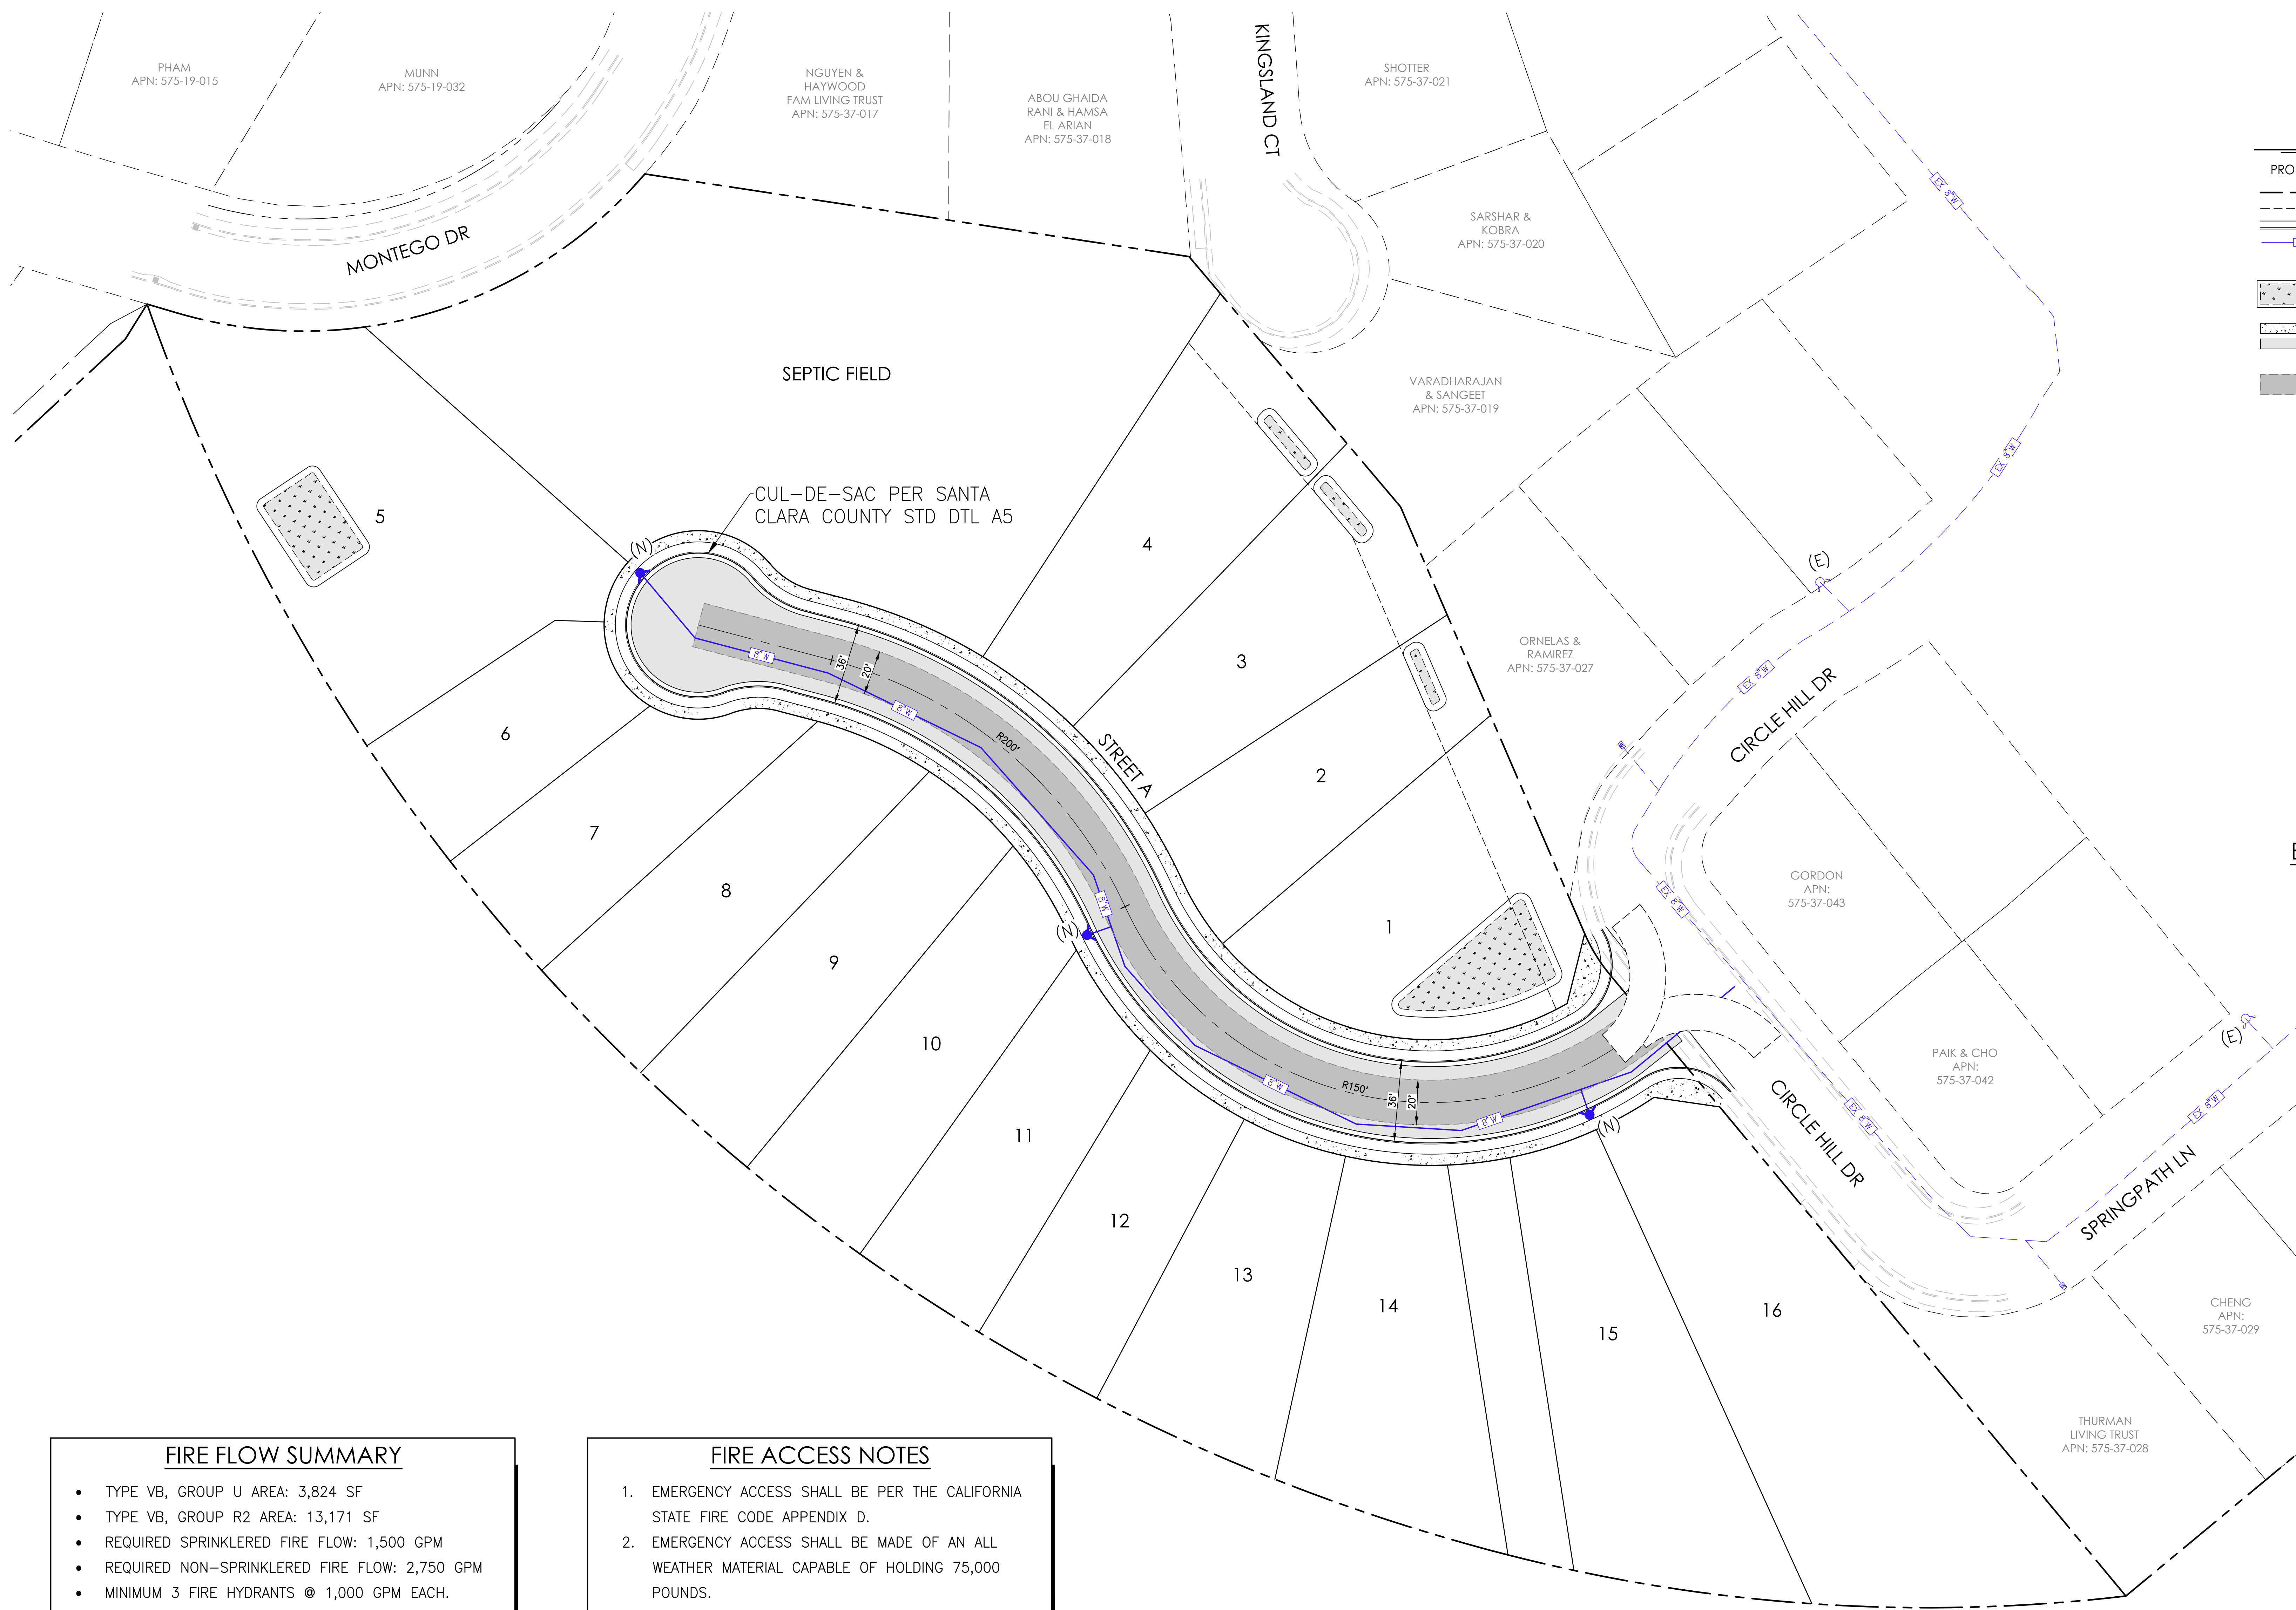
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3875 HOPYARD ROAD, SUITE 345 TEL 925.847.1556
Pleasanton, CA. 94588 Fax 925.847.1557

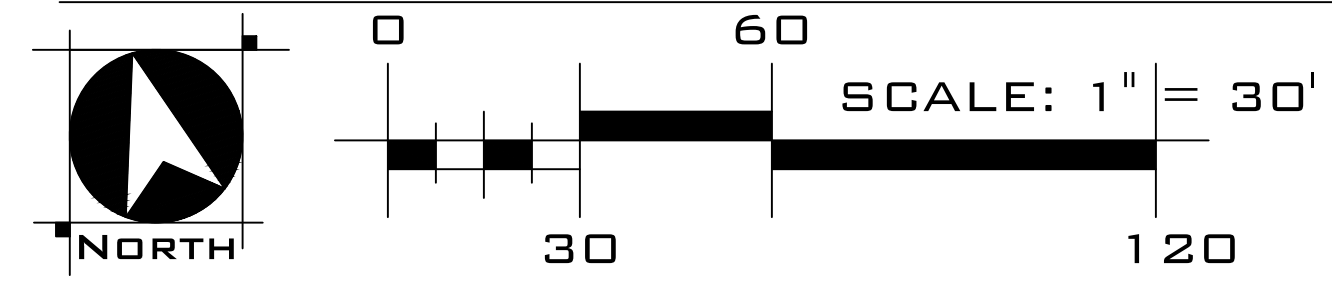PRELIMINARY STORMWATER CONTROL PLAN
TM-07


CIRCLE HILL ESTATES
Santa Clara County, CA
November 24, 2024

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LEGEND	
PROPOSED	EXISTING

ABBREVIATIONS	
EX	EXISTING
DTL	DETAIL
STD	STANDARD
W	WATER



EMERGENCY APPARATUS TURNING DETAIL
NTS

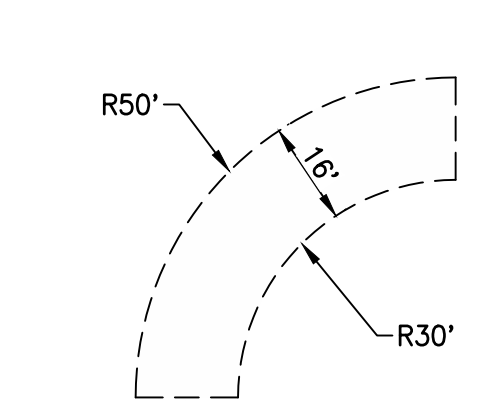FIRE FLOW SUMMARY


- TYPE VB, GROUP U AREA: 3,824 SF
- TYPE VB, GROUP R2 AREA: 13,171 SF
- REQUIRED SPRINKLERED FIRE FLOW: 1,500 GPM
- REQUIRED NON-SPRINKLERED FIRE FLOW: 2,750 GPM
- MINIMUM 3 FIRE HYDRANTS @ 1,000 GPM EACH. AVERAGE SPACING 450 FEET. MAXIMUM DISTANCE FROM ANY POINT ON A STREET OR ROAD FRONTAGE TO HYDRANT IS 225 FEET.

FIRE ACCESS NOTES

1. EMERGENCY ACCESS SHALL BE PER THE CALIFORNIA STATE FIRE CODE APPENDIX D.
2. EMERGENCY ACCESS SHALL BE MADE OF AN ALL WEATHER MATERIAL CAPABLE OF HOLDING 75,000 POUNDS.

Michael LaBarbera Legacy Trust - Winery Land Development
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PRELIMINARY FIRE ACCESS PLAN
TM-08

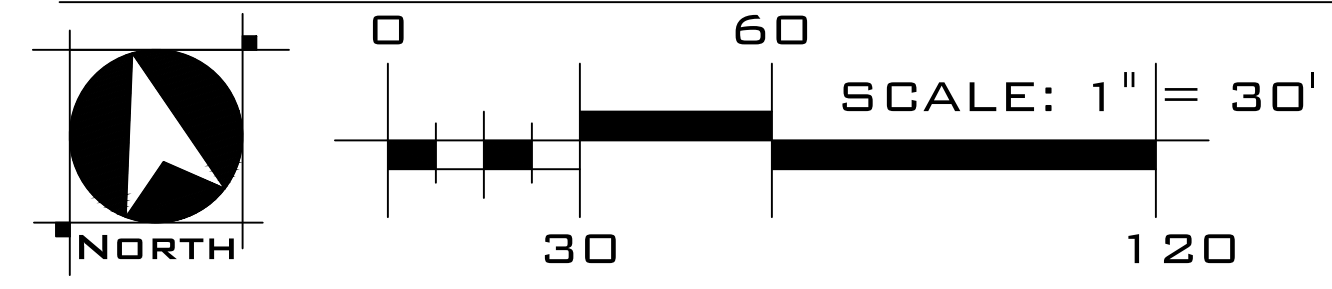


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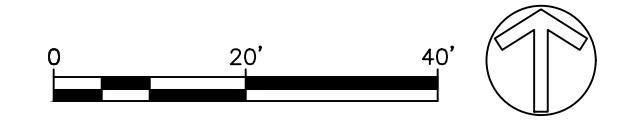
CIRCLE HILL ESTATES
Santa Clara County, CA
November 24, 2024

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CIRCLE HILL ESTATES WASTEWATER FACILITIES SUMMARY

DESIGN FLOW, 30-DAY AVERAGE: 4,200 GPD (20 UNITS AT 210 GPD/UNIT)
WASTEWATER COLLECTION: CONVENTIONAL GRAVITY SEWERS
PRIMARY TREATMENT: 12,000 GAL SEPTIC TANK; 2.9 DAYS HRT AT DESIGN FLOW
SECONDARY TREATMENT: 5,000 GPD RECIRCULATING TEXTILE FILTER, (2) AX-100 (OSI)
EFFLUENT LIMITS: BOD: 30 MG/L; TSS: 30 MG/L; TOTAL N: 30MG/L (50% REMOVAL)
DOSING SYSTEM: 8,000-GAL DOSING TANK, W/ DUPLEX LIFT PUMPS;
 2,500-GAL TANK W/ DUPLEX DOSING SIPHONS, 160 GPM FLOW RATE
EFFLUENT DISPERSAL: 200% PRESSURE-DISTRIBUTION LEACHFIELD
 PRIMARY & SECONDARY FIELDS, EACH WITH 875 LF, (2) ZONES

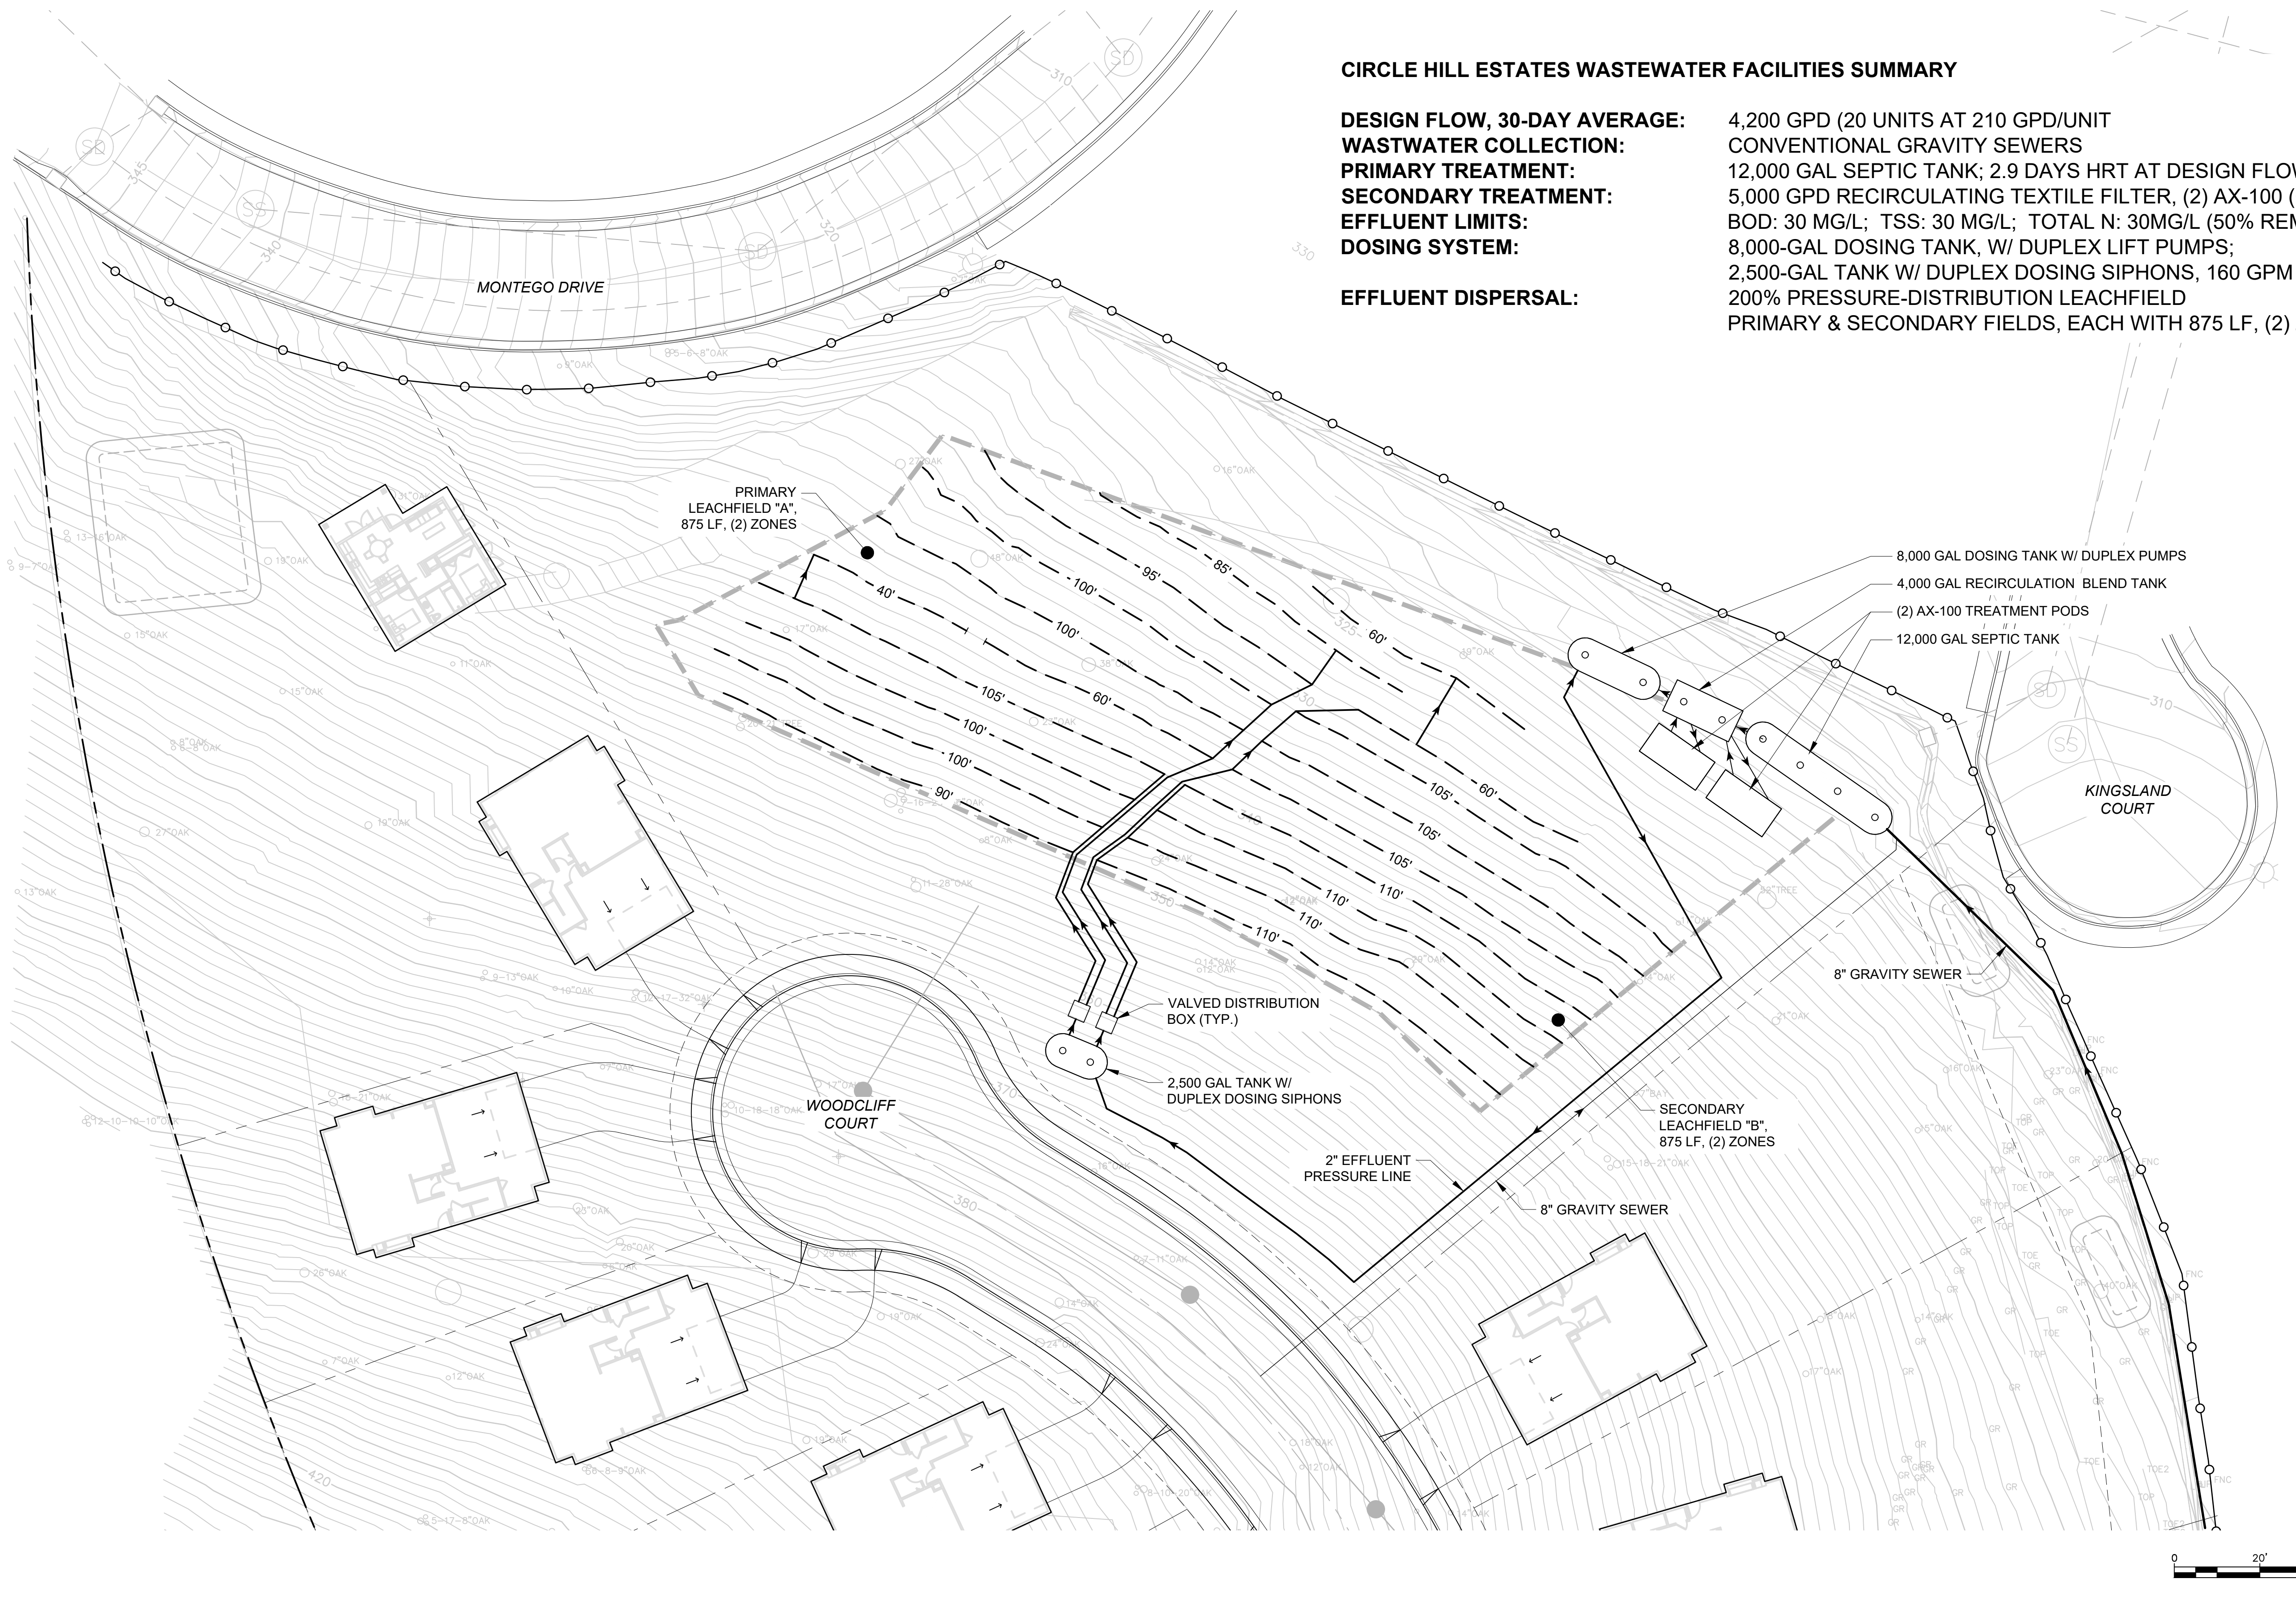

**CIRCLE HILL ESTATES
 WASTEWATER TREATMENT SYSTEM**
 SAN JOSE, CALIFORNIA

QUESTA
 ENGINEERING CORP.
 Civil Environmental & Water Resources
 (510) 236-6114
 P.O. Box 70356 1220 Brickyard Cove Road Point Richmond, CA 94807




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 Drawn: MN
 Checked: NH
 App'd: NH


WASTEWATER FACILITIES LAYOUT

Size D
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 Date: 3/29/2024
 Sheet: WW-1


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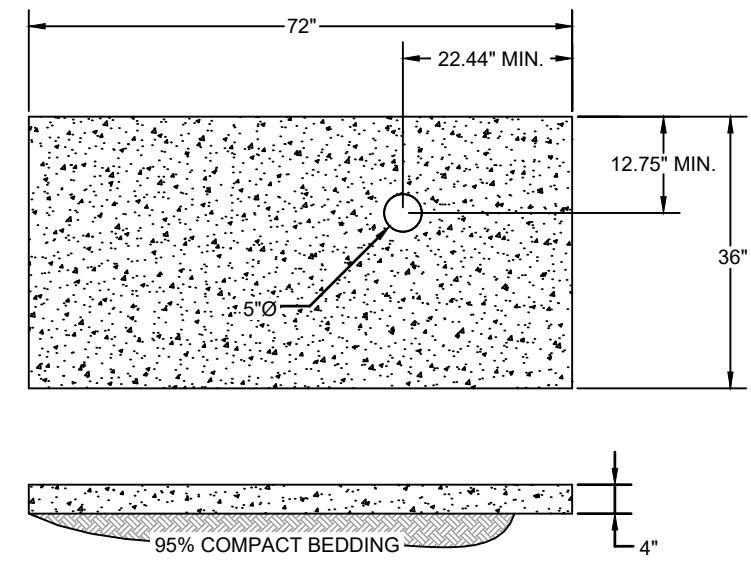
Pod Detail
Scale: 1" = 2'-0"
DIMENSIONS OF AX-100 POD: 3.5'D X 15.9'L X 7.9"W

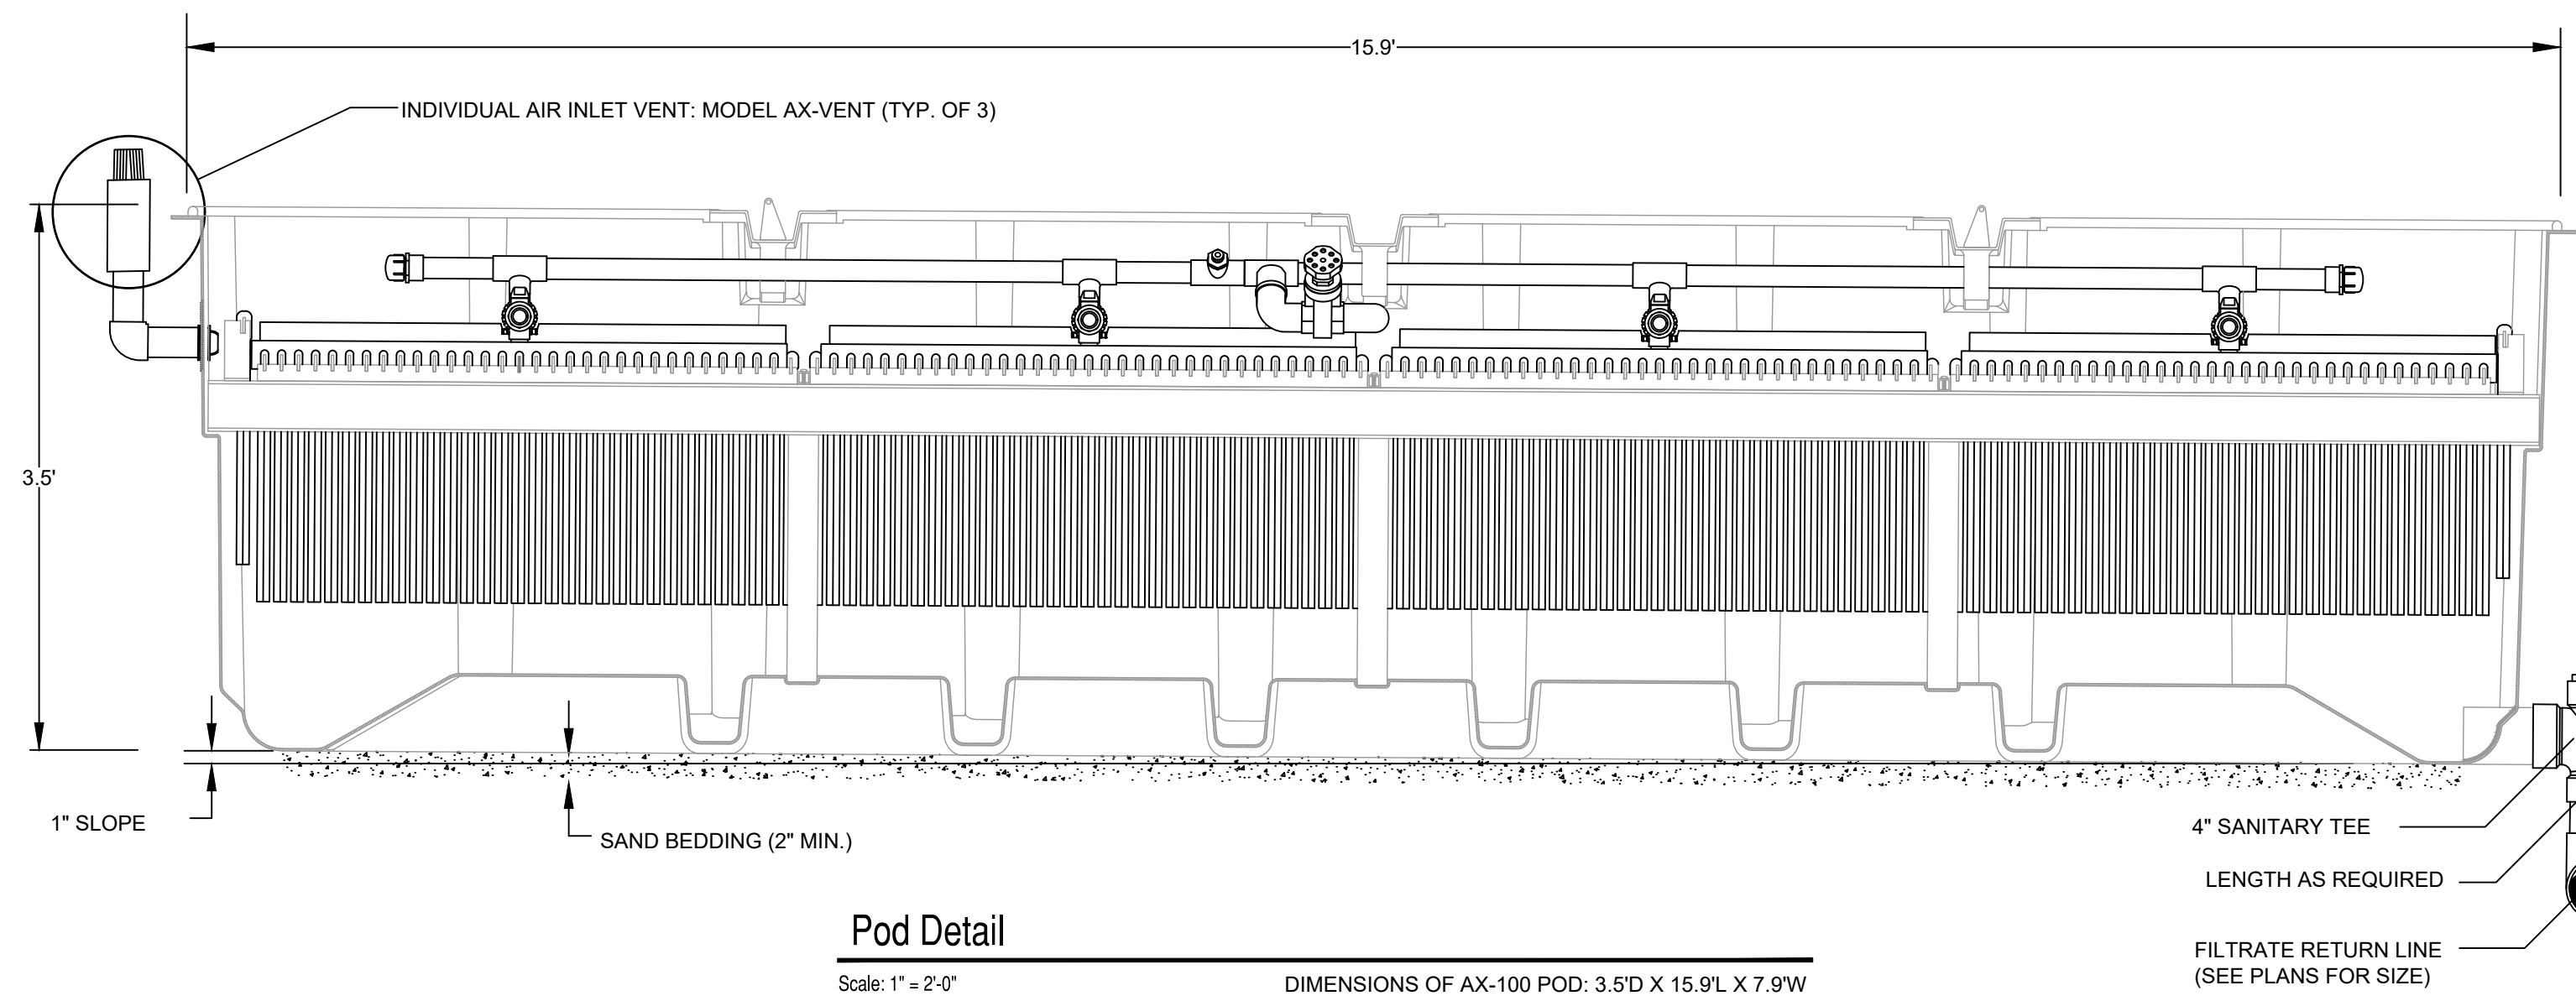


2 12,000 GALLON SEPTIC TANK
NOT TO SCALE. 4 ACCESS RISERS AND BAFFLE (NOT SHOWN)

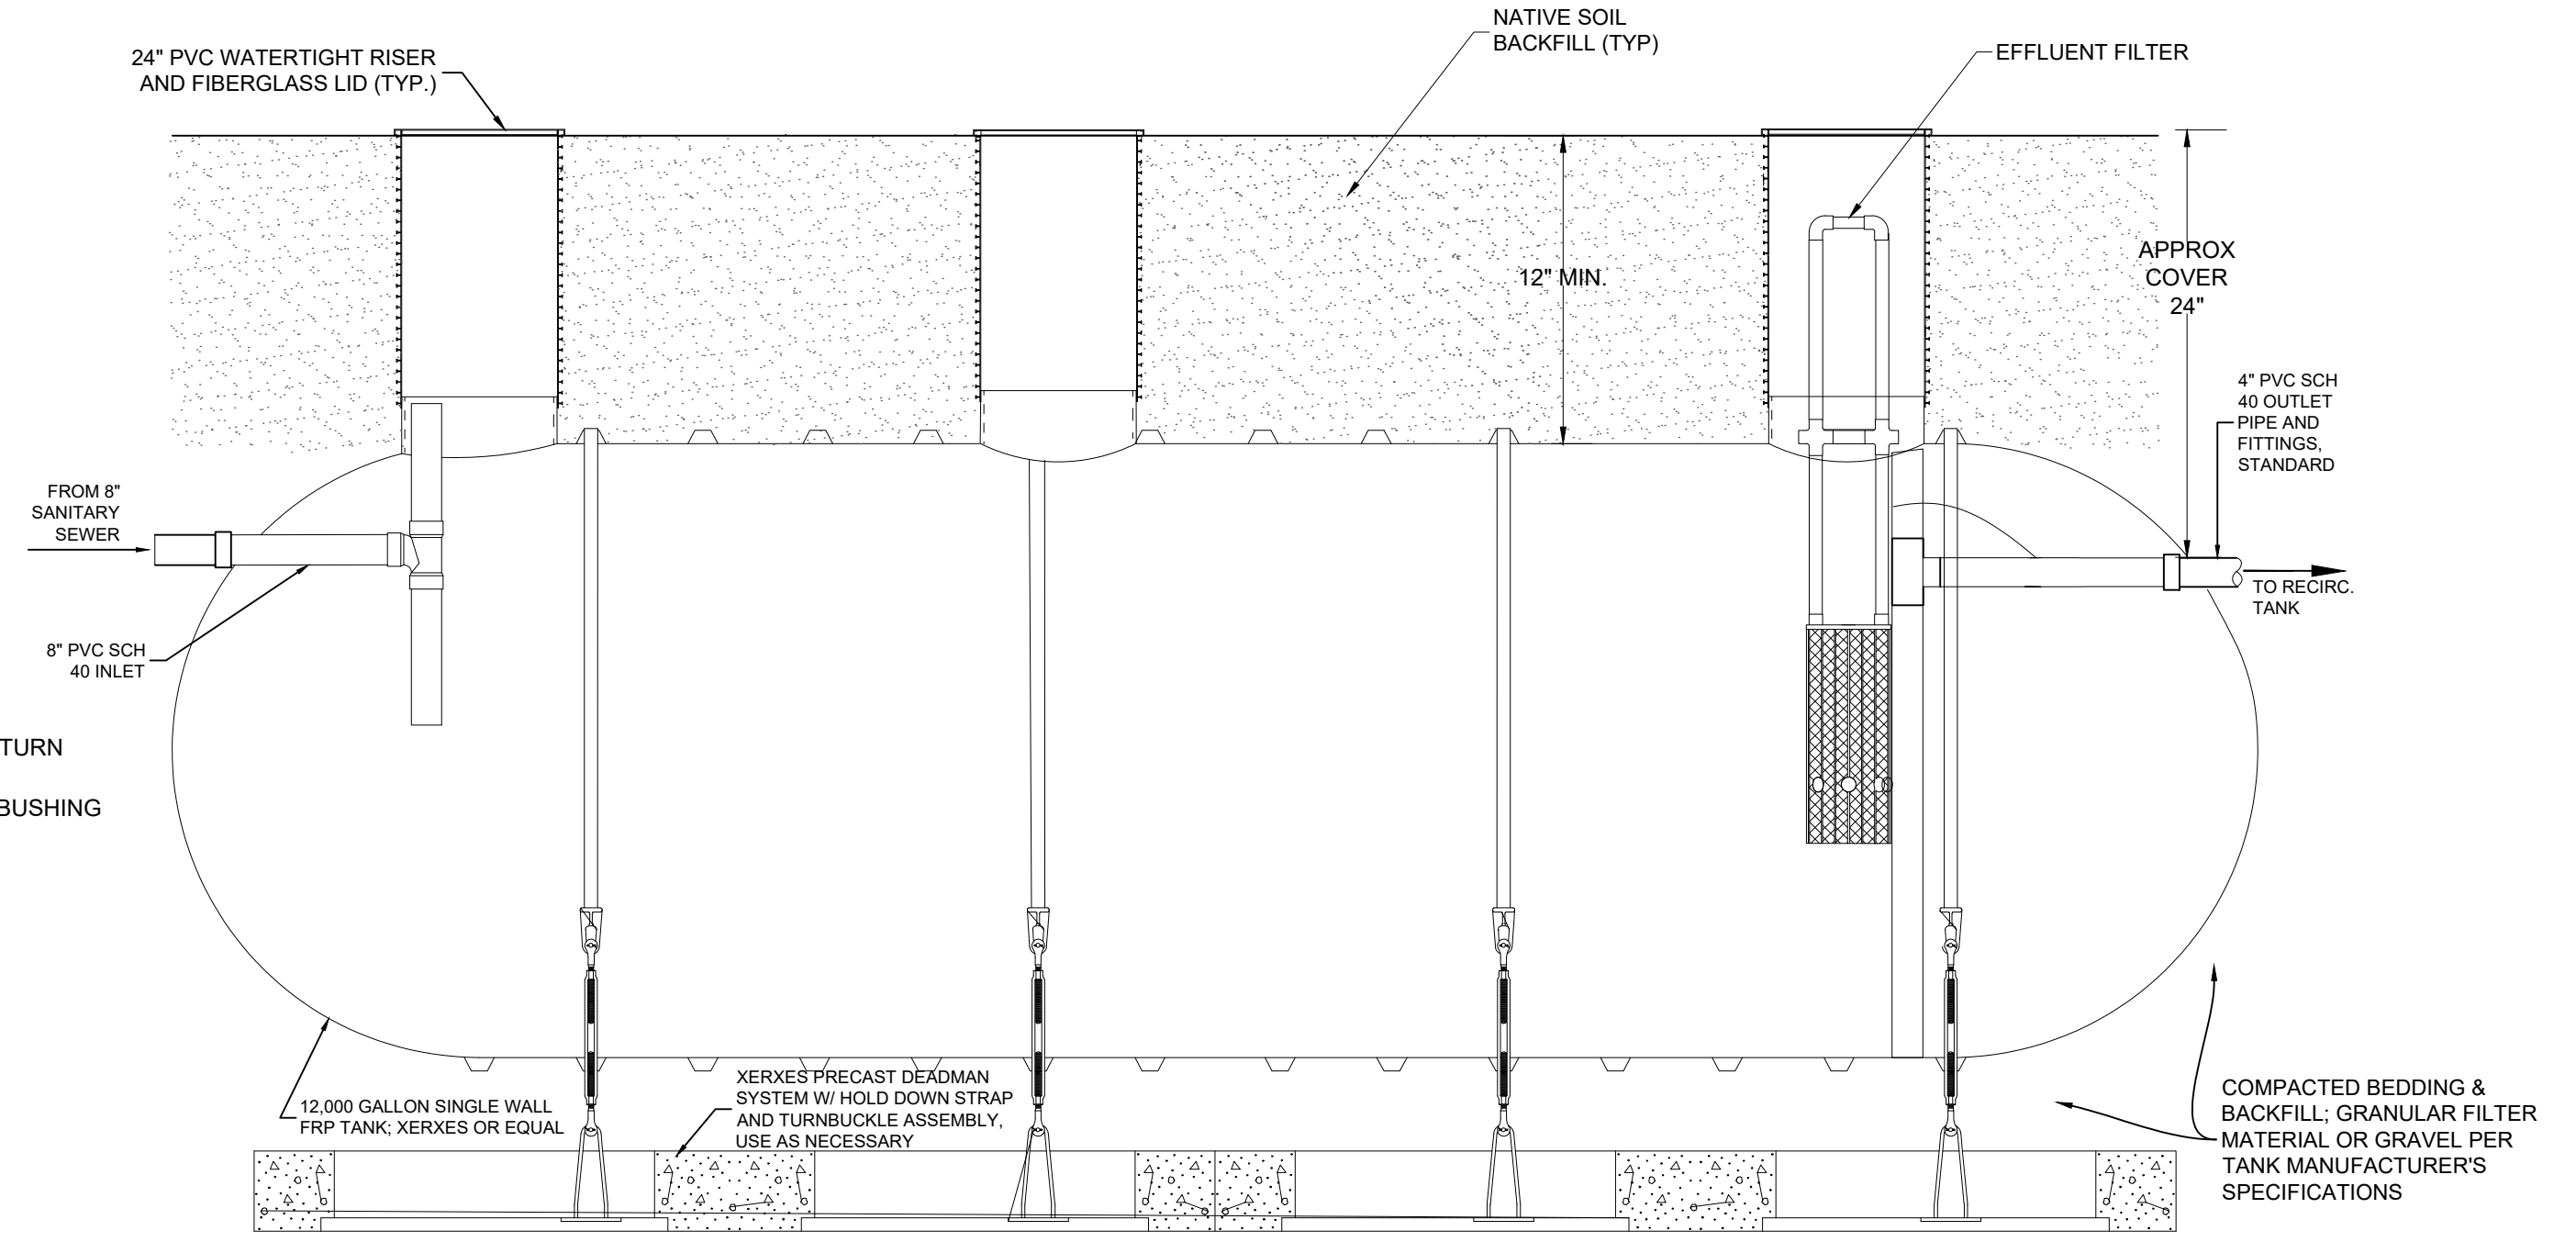


TYPICAL POD INLET CONNECTION
NTS

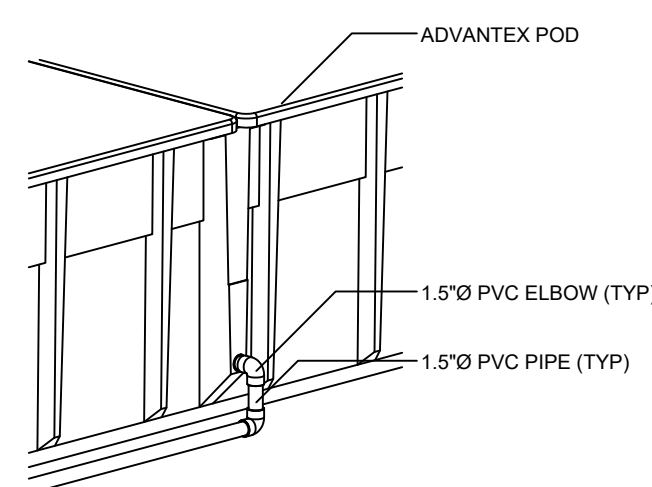

FAN ASSEMBLY PAD DETAIL

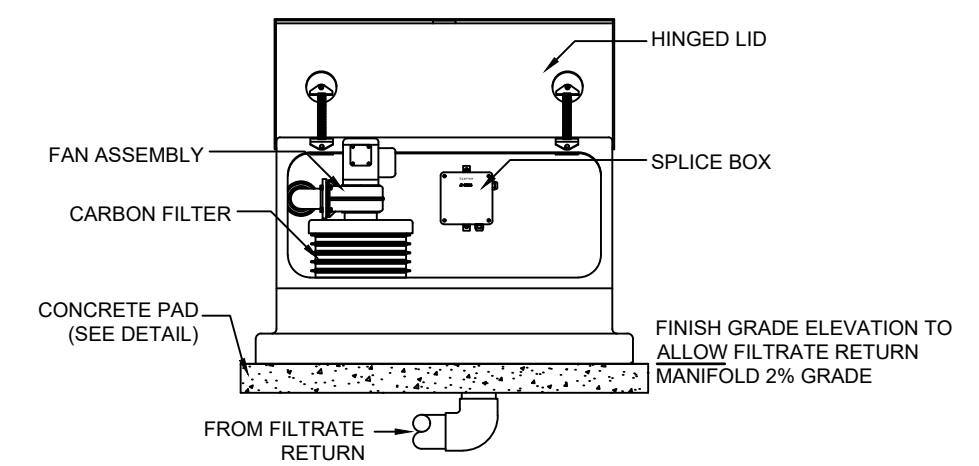


ABOVE GROUND FAN ASSEMBLY, MODEL AX-VENT

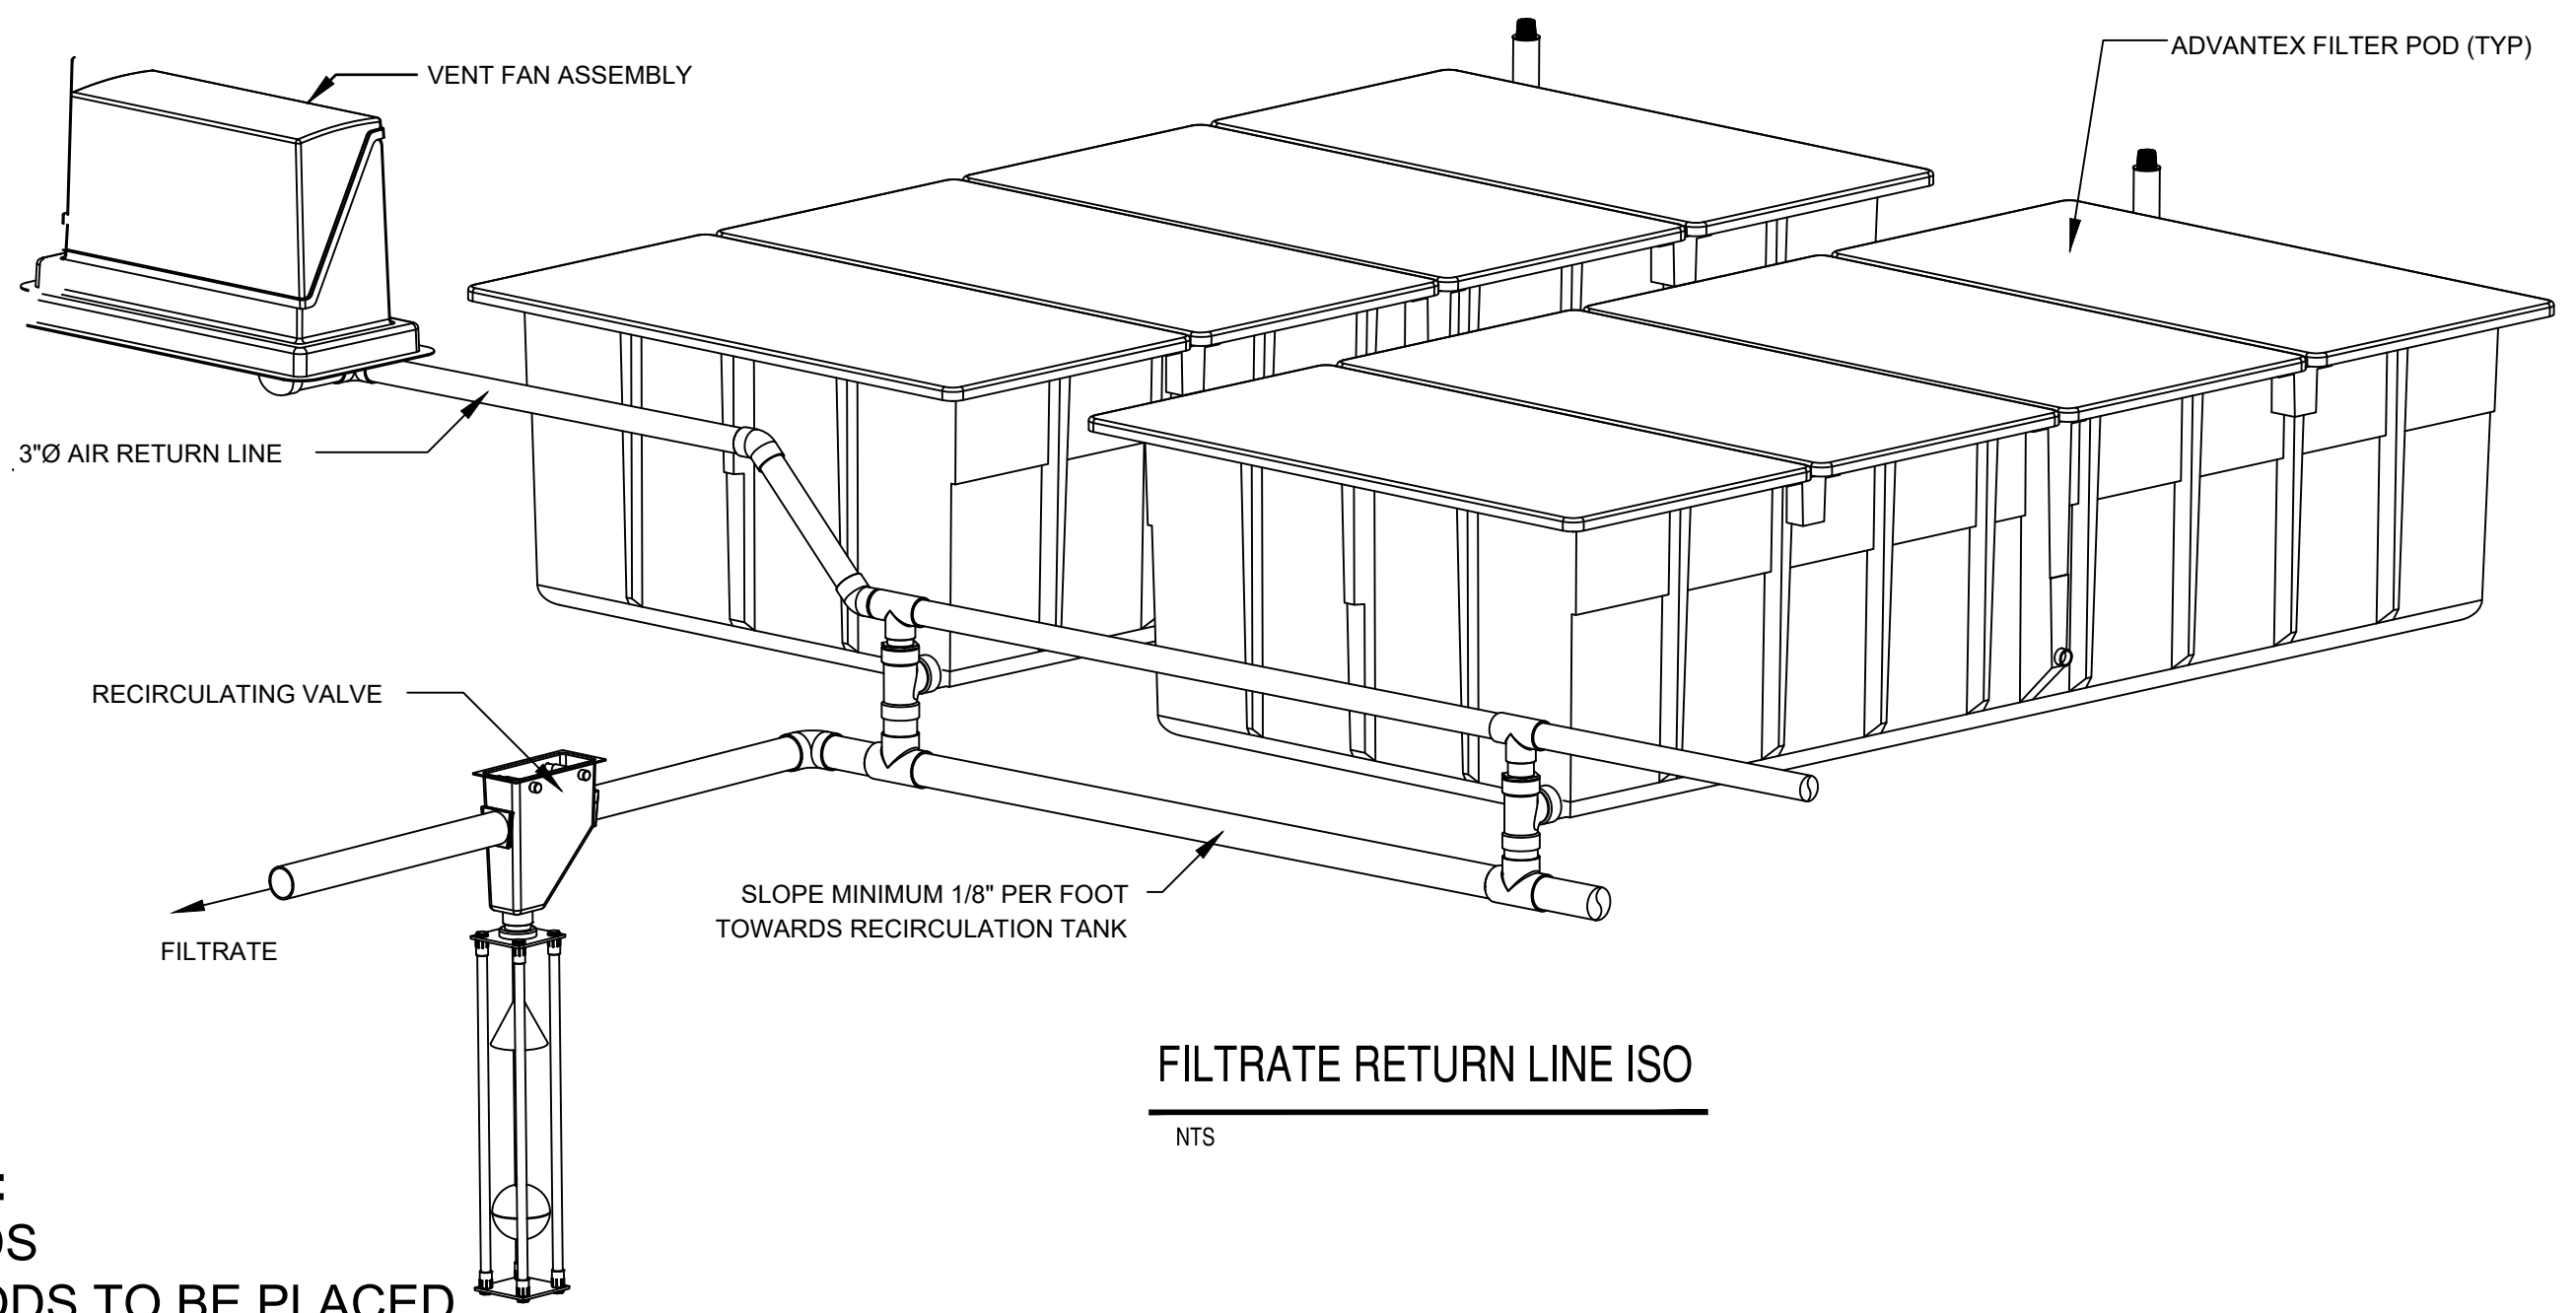

FILTRATE RETURN LINE ISO
NTS

1 ADVANTEK AX-100 TEXTILE FILTER
NOT TO SCALE

NOTE:
2 PODS
AX PODS TO BE PLACED
ON EXCAVATED PAD,
PARTIALLY BURIED.

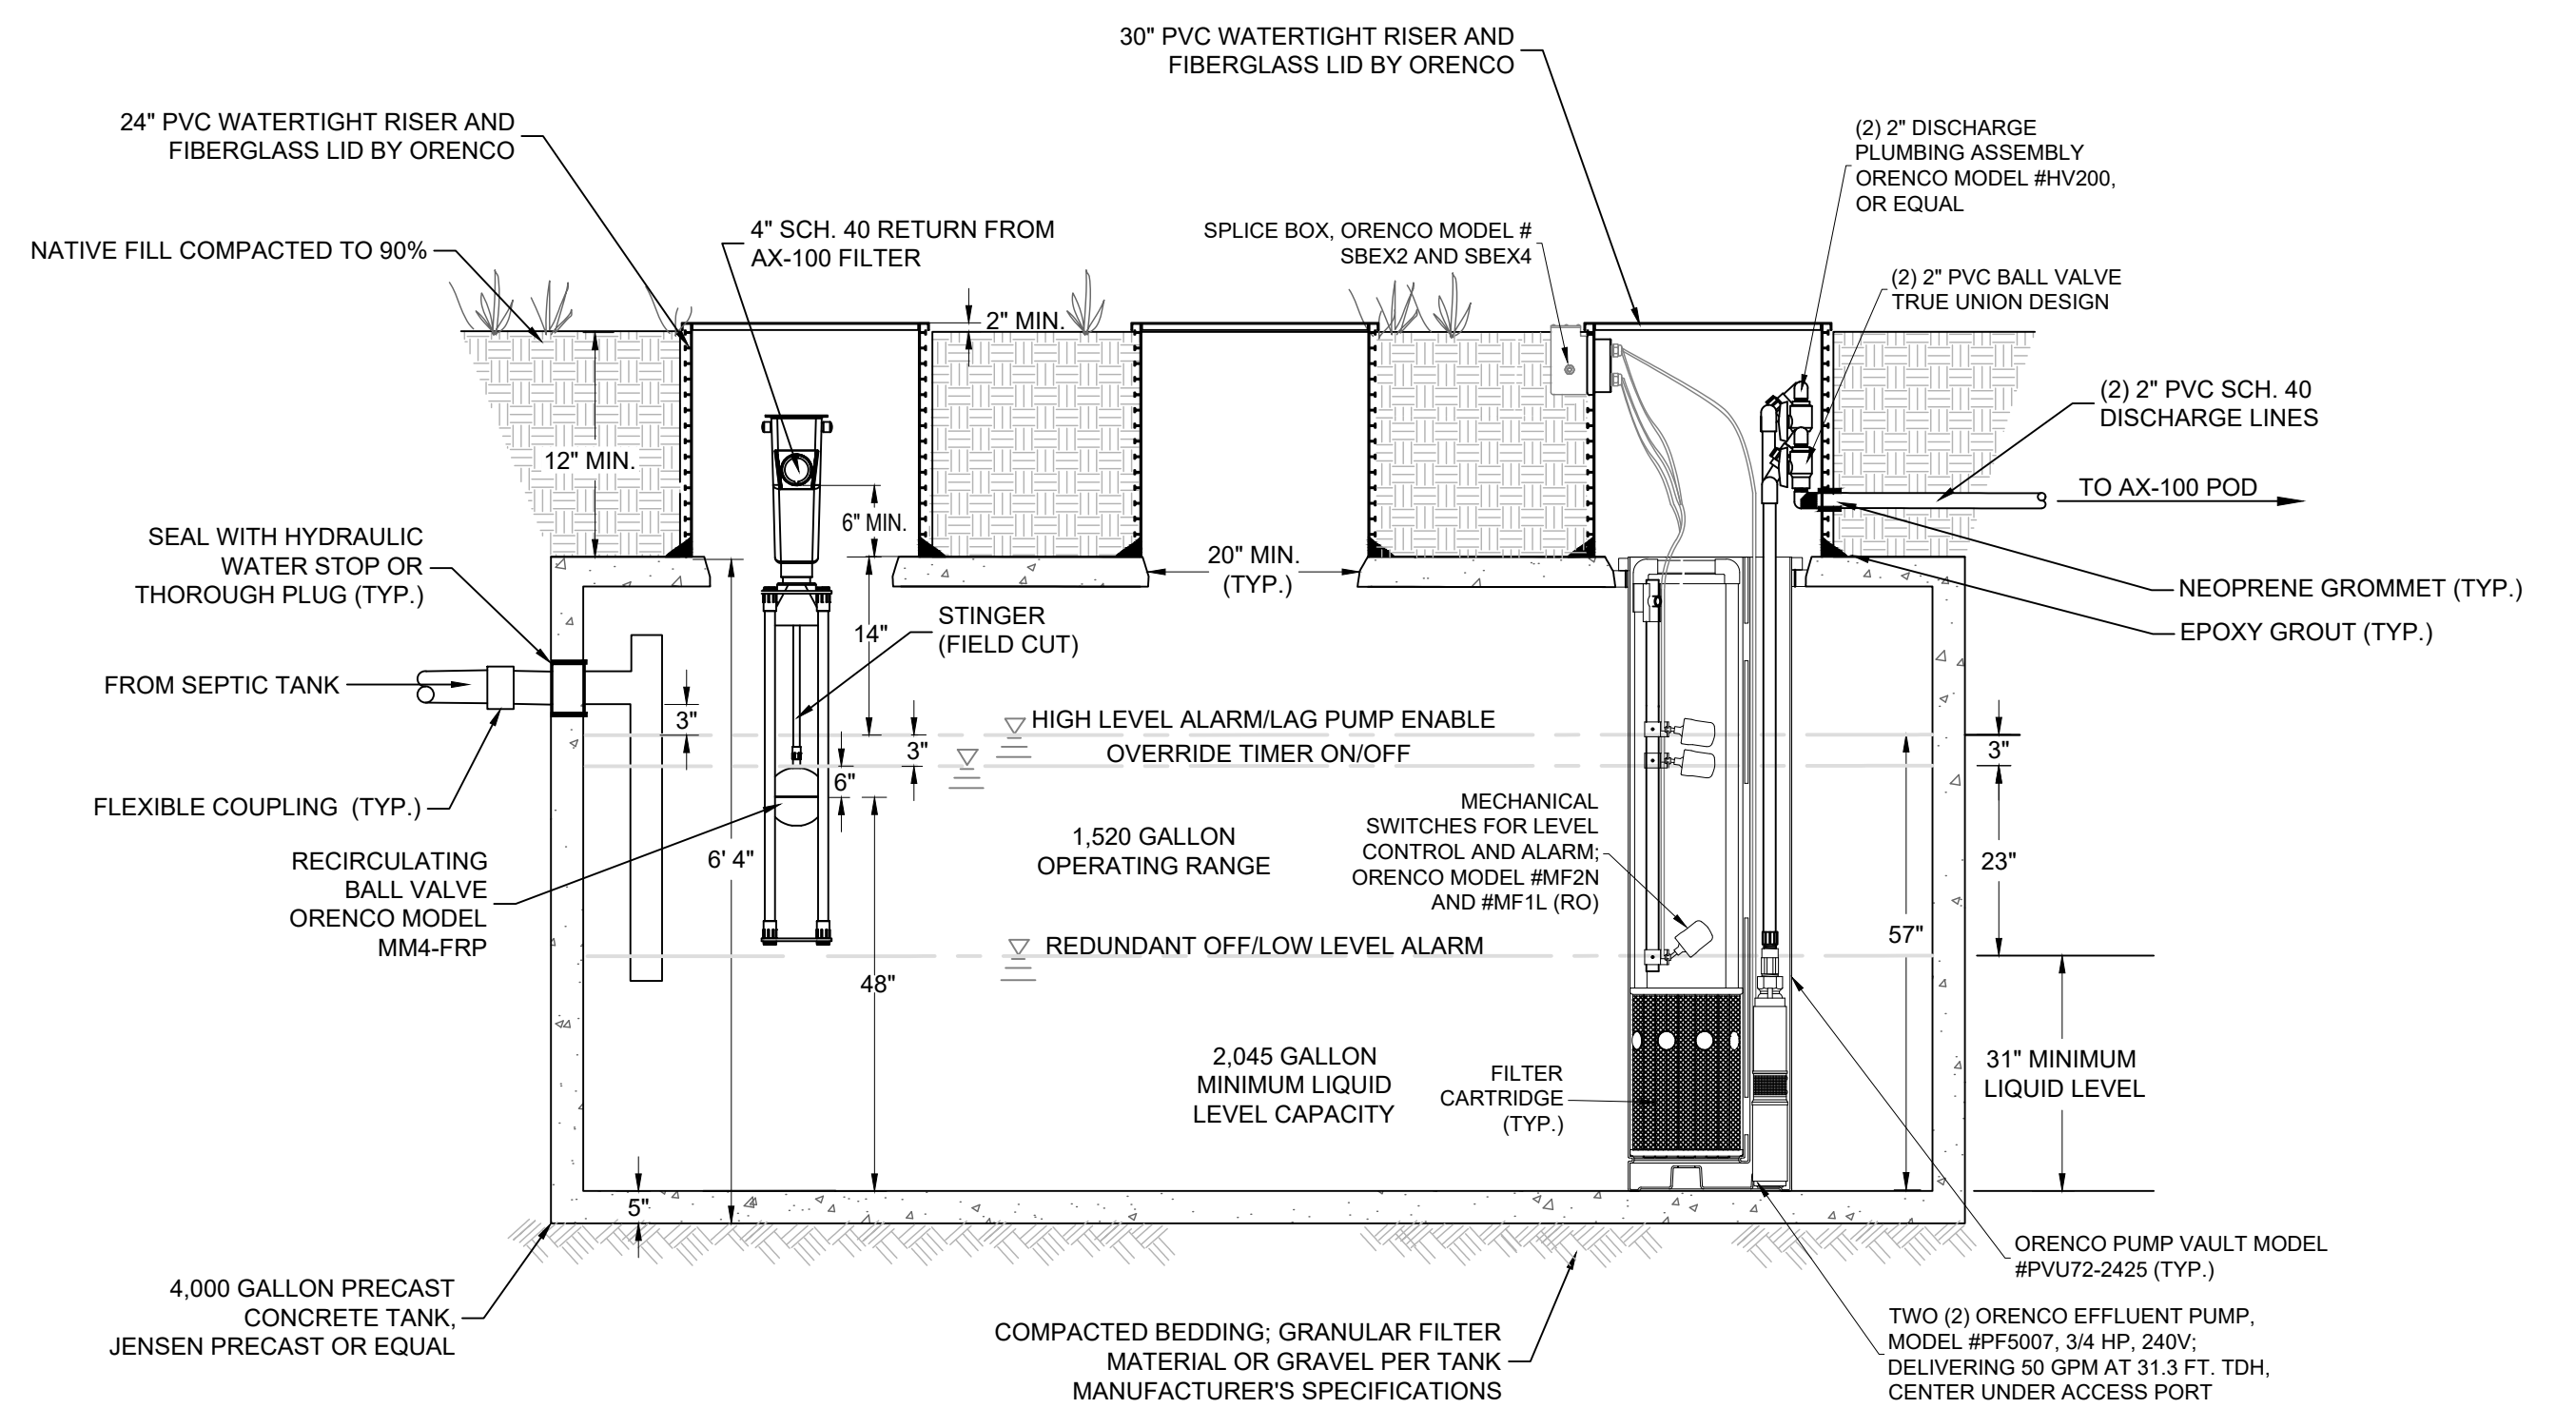

3 4,000 GALLON RECIRCULATION TANK
SIDE VIEW, NTS. PUMPS TO AX-100 TEXTILE FILTERS (RECIRC)

CIRCLE HILL ESTATES
WASTEWATER TREATMENT SYSTEM
SAN JOSE, CALIFORNIA

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Civil Environmental & Water Resources
(510) 236-6114
FAX (510) 236-2423
questa@questaac.com
P.O. Box 70356 1220 Brickyard Cove Road Point Richmond, CA 94807




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Design: NH
Drawn: MN
Checked: NH
App'd: NH

WASTEWATER TREATMENT DETAILS

Size D Project 2300152
Scale: NOT TO SCALE
Date: 3/29/2024
Sheet: WW-2

PA\2023\2300152 WOODCLIFF CT-LABARRERA\CAD\SHEETS\WASTEWATER TREATMENT SET\2300152_WOODCLIFF CT_LW-2.DWG LAST SAVED: 4/2/2024 PLOT DATE: 4/2/2024 PLOT STYLE: ----- IF BAR DOES NOT MEASURE, 1" DRAWING IS NOT TO SCALE - ADJUST ACCORDING

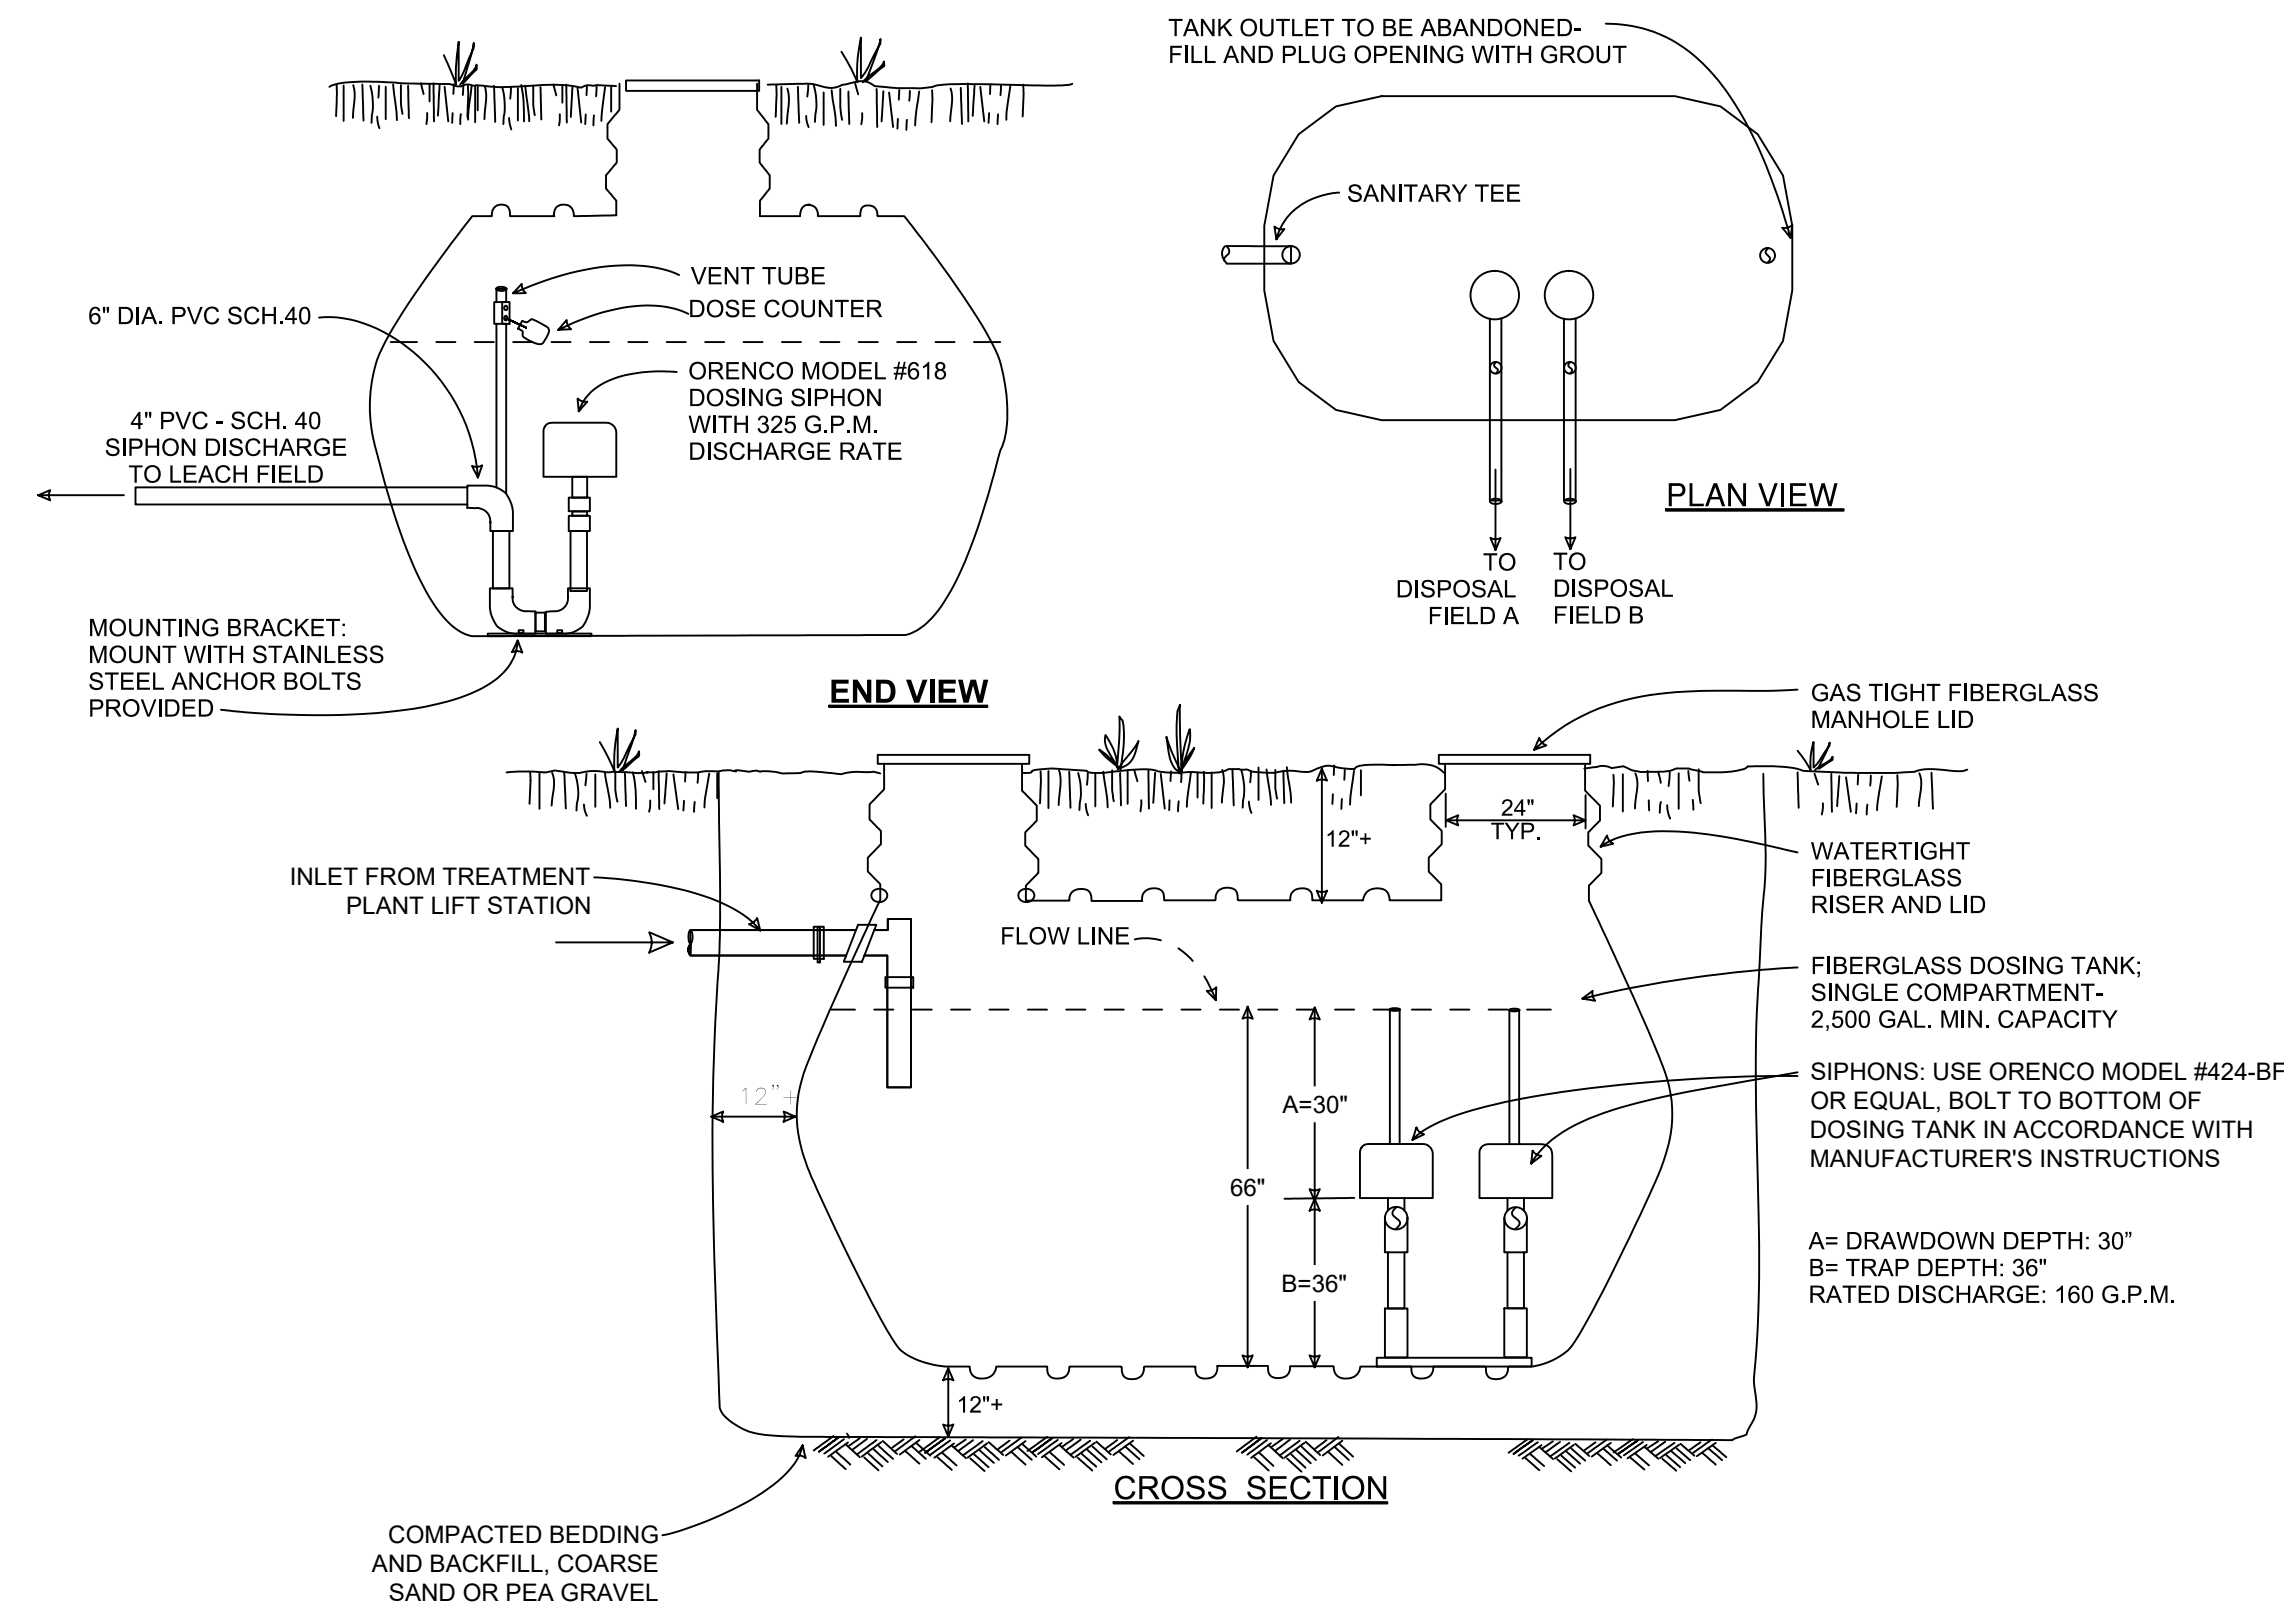


4 2,500 GALLON DOSING TANK
NOT TO SCALE


DISPOSAL SYSTEM DESIGN

PRESSURE-DISTRIBUTION LEACHING TRENCHES

- DESIGN FLOW: 4,200 GPD
- TRENCH DIMENSIONS: 2-FT' WIDE X 2.5-FT DEEP
- EFFECTIVE INFILTRATIVE AREA: 4 SQ FT PER LF
- AVERAGE PERCOLATION RATE: 18 MPI
- APPLICATION RATE: 1.2 GPD PER SQ FT (SECONDARY TREATED WASTEWATER)
- TRENCH LOADING RATE: $(4) \times (1.2) = 4.8$ GPD PER LF
- TOTAL REQUIRED TRENCH LENGTH: $4,200 \text{ GPD} / 4.8 \text{ GPD/LF} = 875$ LF PER FIELD
- PROPOSED TRENCH LENGTHS:
 - PRIMARY FIELD A: 875 LF W/(2) ZONES
 - SECONDARY FIELD B: 875 LF W/(2) ZONES
- PRESSURE-DISTRIBUTION CALCULATIONS PER ZONE;
 - MAX ZONE LENGTH: 440 LF
 - 1/4 INCH DISCHARGE HOLES AT 4' O.C.
 - 440 LF/4-FT SPACING = 110 HOLES PER ZONE
 - MIN DISCHARGE RATE: 1/4" HOLE AT 2 FT HEAD = 1.04 GPM/HOLE
 - TOTAL DISCHARGE PER ZONE = $110 \times 1.04 = 114$ GPM
 - PROPOSED DOSING SIPHON DISCHARGE: 160 GPM, OK

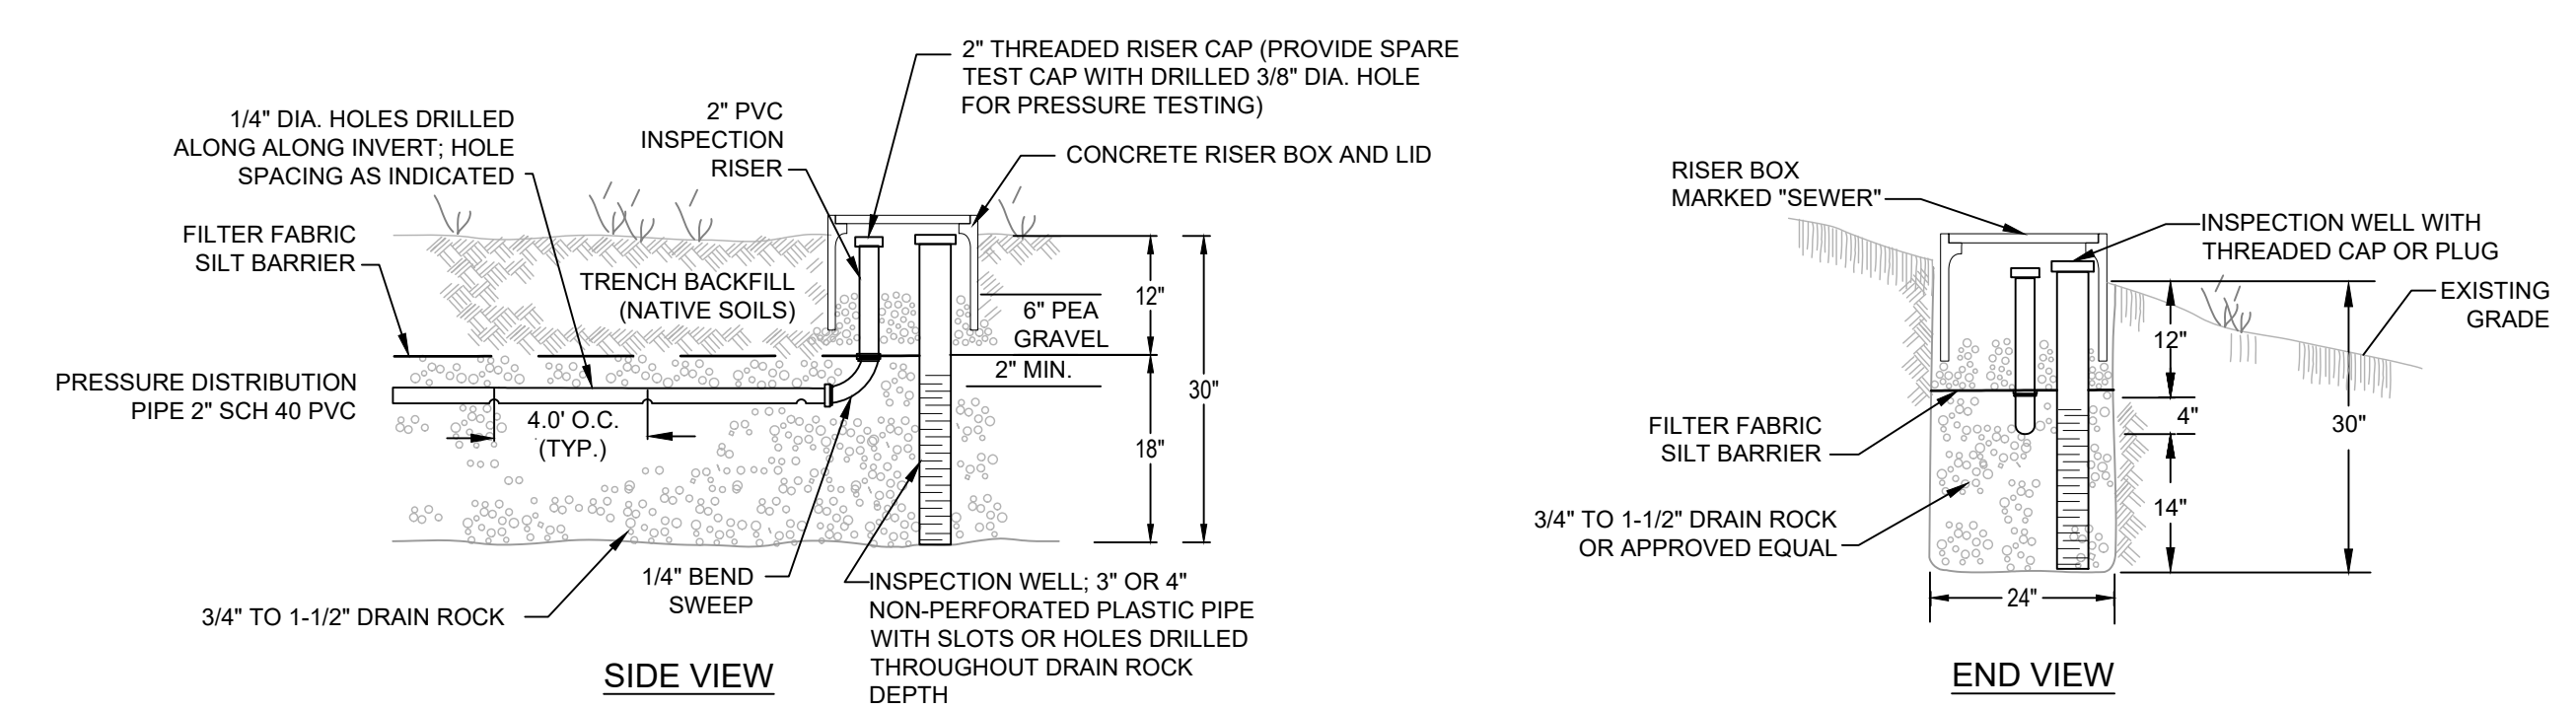

5 PRESSURE DISTRIBUTION LEACHING TRENCH
NOT TO SCALE

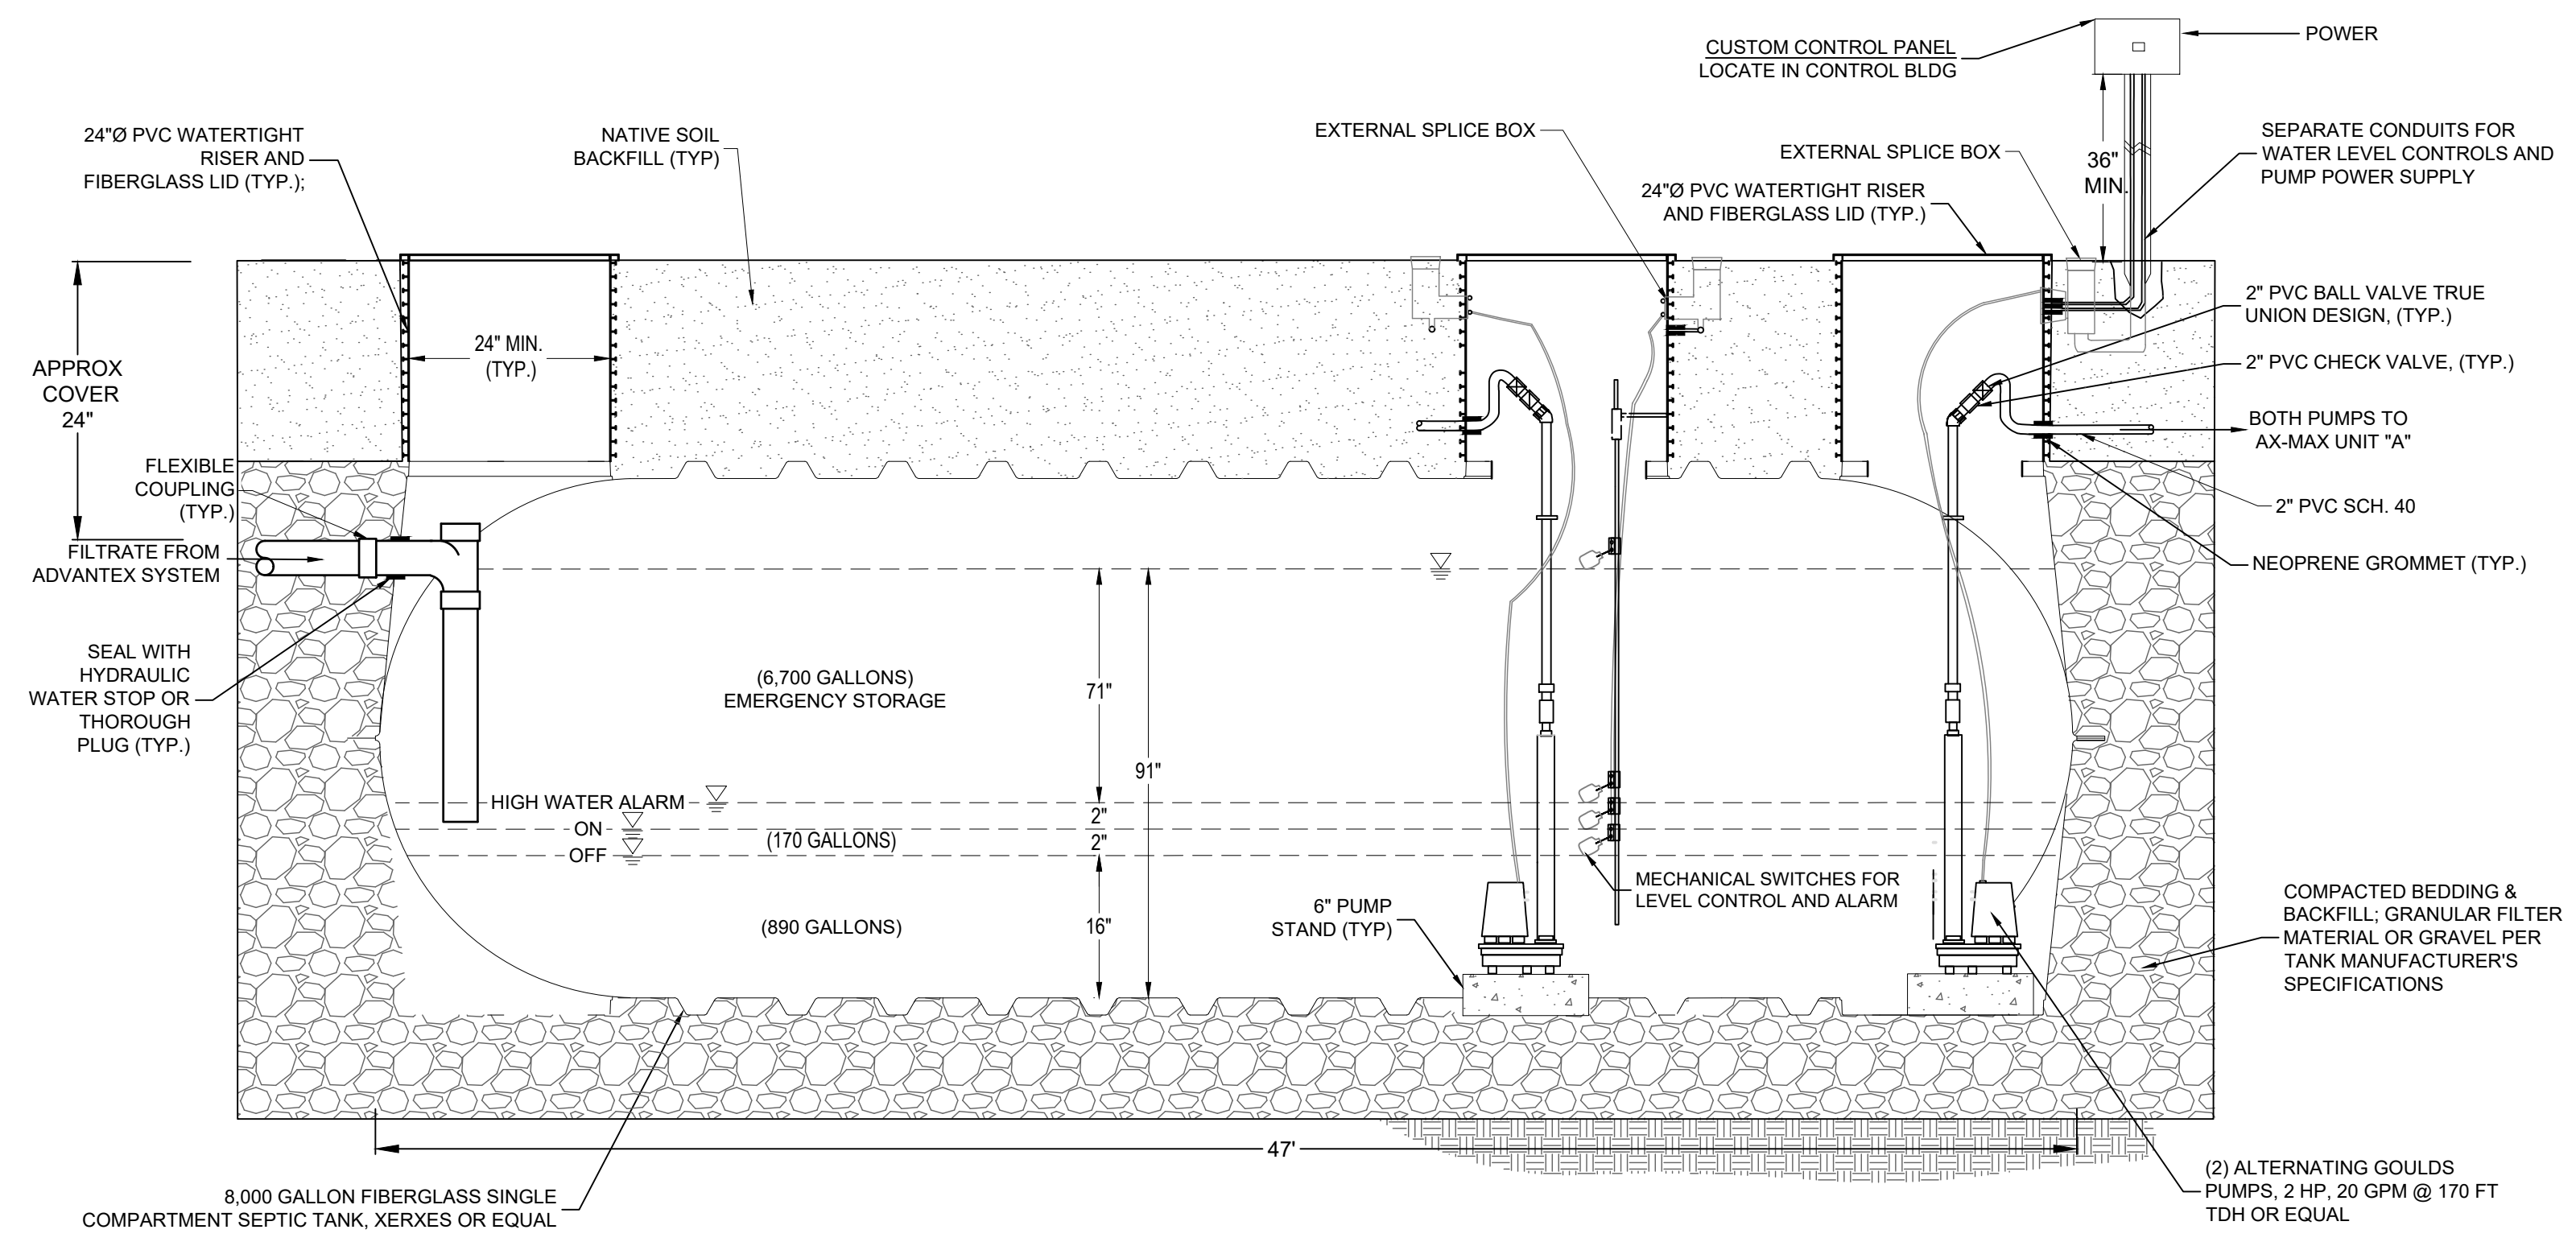

6 8,000 GALLON EFFLUENT DOSING TANK
NOT TO SCALE

CIRCLE HILL ESTATES
WASTEWATER TREATMENT SYSTEM
SAN JOSE, CALIFORNIA

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ENGINEERING CORP.
Civil Environmental & Water Resources
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questa@questaac.com
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Sht	Rev	Date	By	Description	App'd

Design: NH
Drawn: MN
Checked: NH
App'd: NH

WASTEWATER DISPOSAL DETAILS

Size D Project 2300152
Scale: NOT TO SCALE
Date: 3/29/2024
Sheet: WW-3




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 LAST SAVED: 4/2/2024 10:58:11 AM
 PLOT DATE: 4/2/2024
 PLOT STYLE:

SOIL PROFILE FIELD LOG
 Job Number/Name: LaBarbera Condos Location Circle Hill Drive APN 575-20-037
 Date Soil Sampled: 3-28-24 Time AM Vegetation Sparse Oaks
 Elevation: Slope Gradient 10-20% Aspect North East Geomorphic Surface Base of Rolling Hills
 Parent Material(s) Silstone Described by AB/DQ

DEPTH (ft)	MOISTURE	STRUCTURE	PORES	MOTTLES	CLAY FILLS	ROOTS	CONSISTENCE	TEXTURE	COLOR	HORIZON	CONTACTS
0-1.5	dry	loose	open	none	none	none	loose	loose	Dark Brown	Munsell (moist)	distinct top
1.5-3.5	dry	loose	open	none	none	none	loose	loose	Dark Brown	Munsell (moist)	distinct top
3.5-6.5	dry	loose	open	none	none	none	loose	loose	Dark Brown	Munsell (moist)	distinct top
6.5-9.5	dry	loose	open	none	none	none	loose	loose	Light Yellowish Brown	Munsell (moist)	distinct top
9.5-14	dry	loose	open	none	none	none	loose	loose	Light Yellowish Brown	Munsell (moist)	distinct top

SOIL PROFILE FIELD LOG
 Job Number/Name: LaBarbera Condos Location Circle Hill Drive APN 575-20-037
 Date Soil Sampled: 3-14-24 Time AM Vegetation Sparse Oaks
 Elevation: Slope Gradient 20% Aspect North East Geomorphic Surface Base of Rolling Hills
 Parent Material(s) Silstone Described by AB/DQ

DEPTH (ft)	MOISTURE	STRUCTURE	PORES	MOTTLES	CLAY FILLS	ROOTS	CONSISTENCE	TEXTURE	COLOR	HORIZON	CONTACTS
0-2.5	dry	loose	open	none	none	none	loose	loose	Very Dark Brown	Munsell (moist)	distinct top
2.5-6	dry	loose	open	none	none	none	loose	loose	Dark Brown	Munsell (moist)	distinct top
6-9	dry	loose	open	none	none	none	loose	loose	Medium Brown	Munsell (moist)	distinct top
9-13	dry	loose	open	none	none	none	loose	loose	Light Yellowish Brown	Munsell (moist)	distinct top
13-14	dry	loose	open	none	none	none	loose	loose	Light Yellowish Brown	Munsell (moist)	distinct top

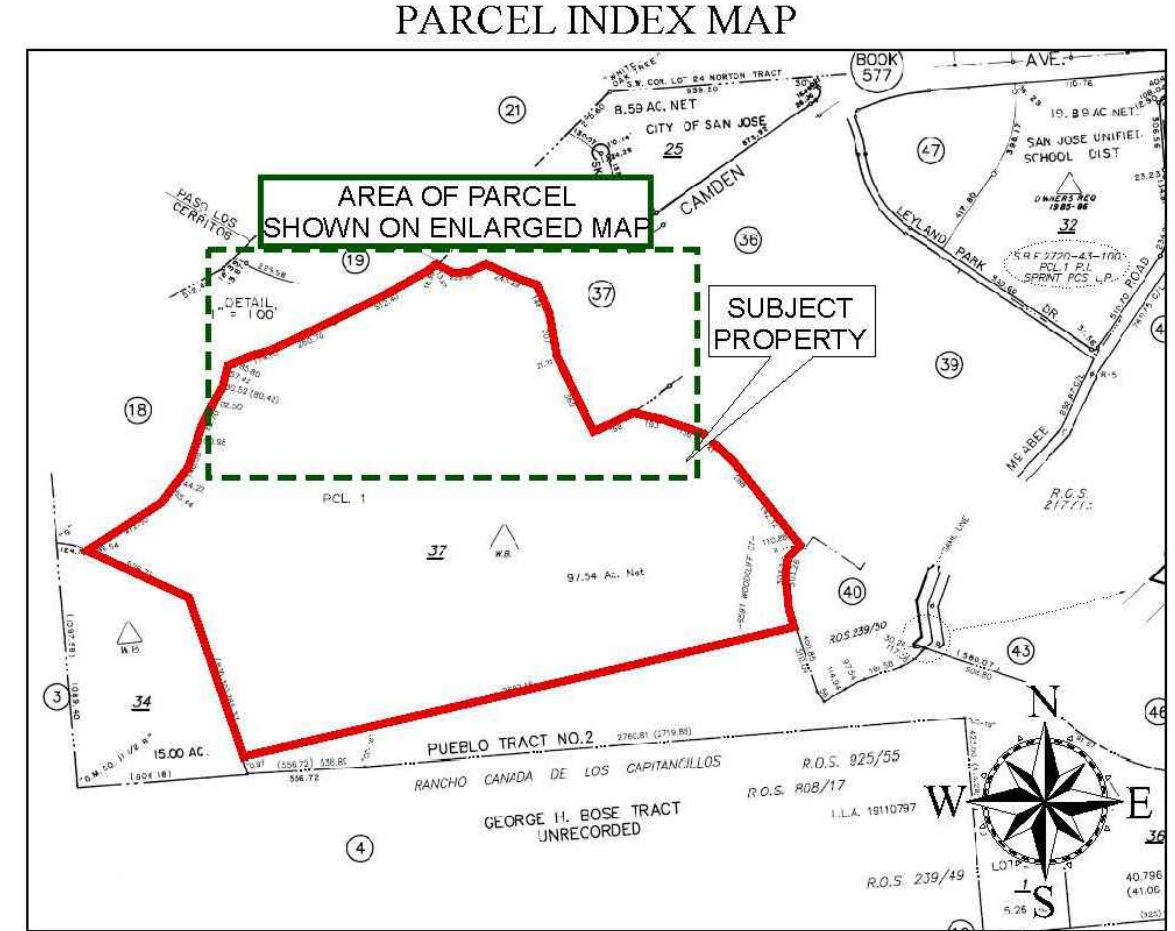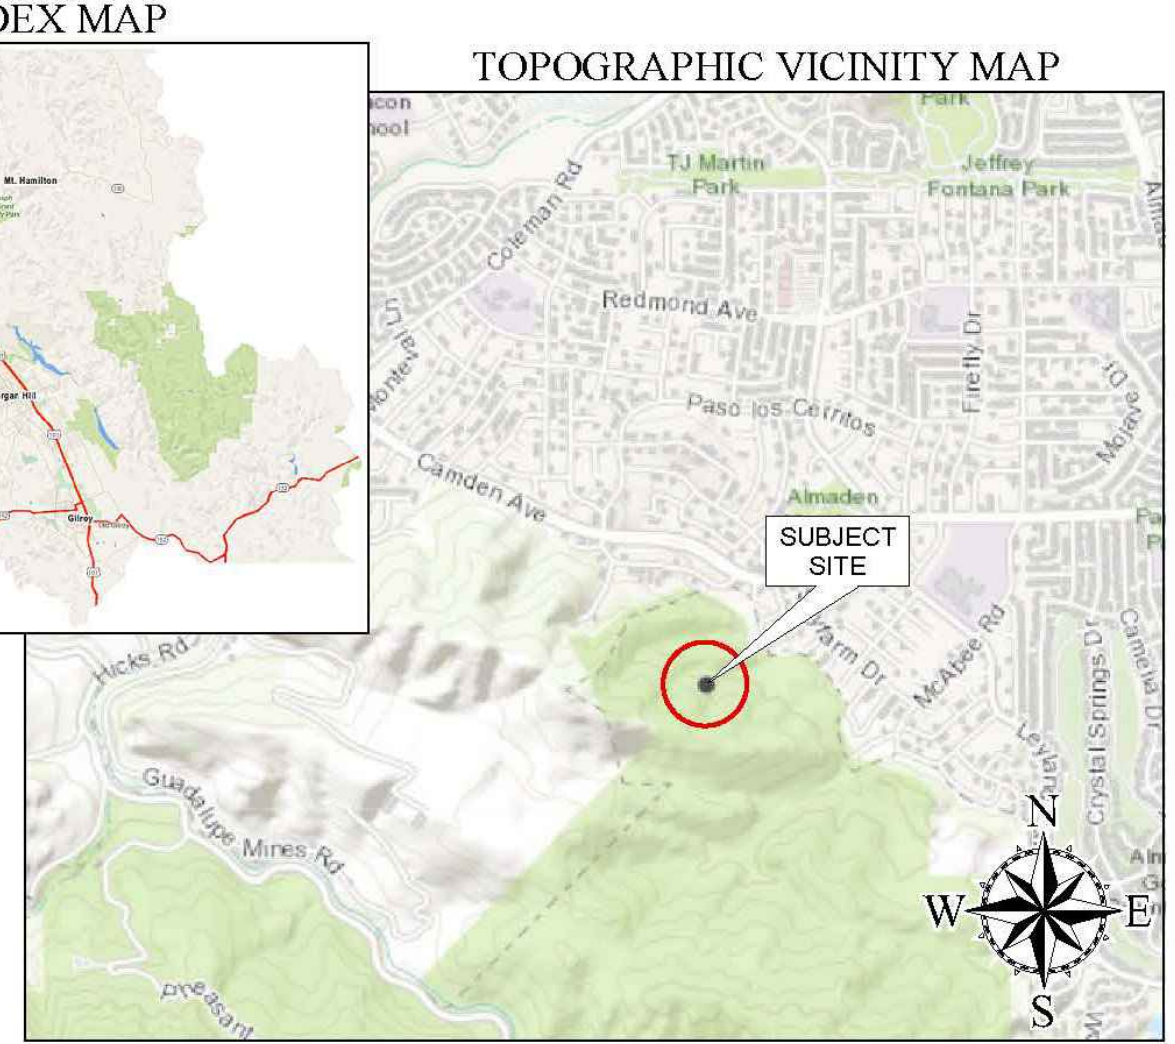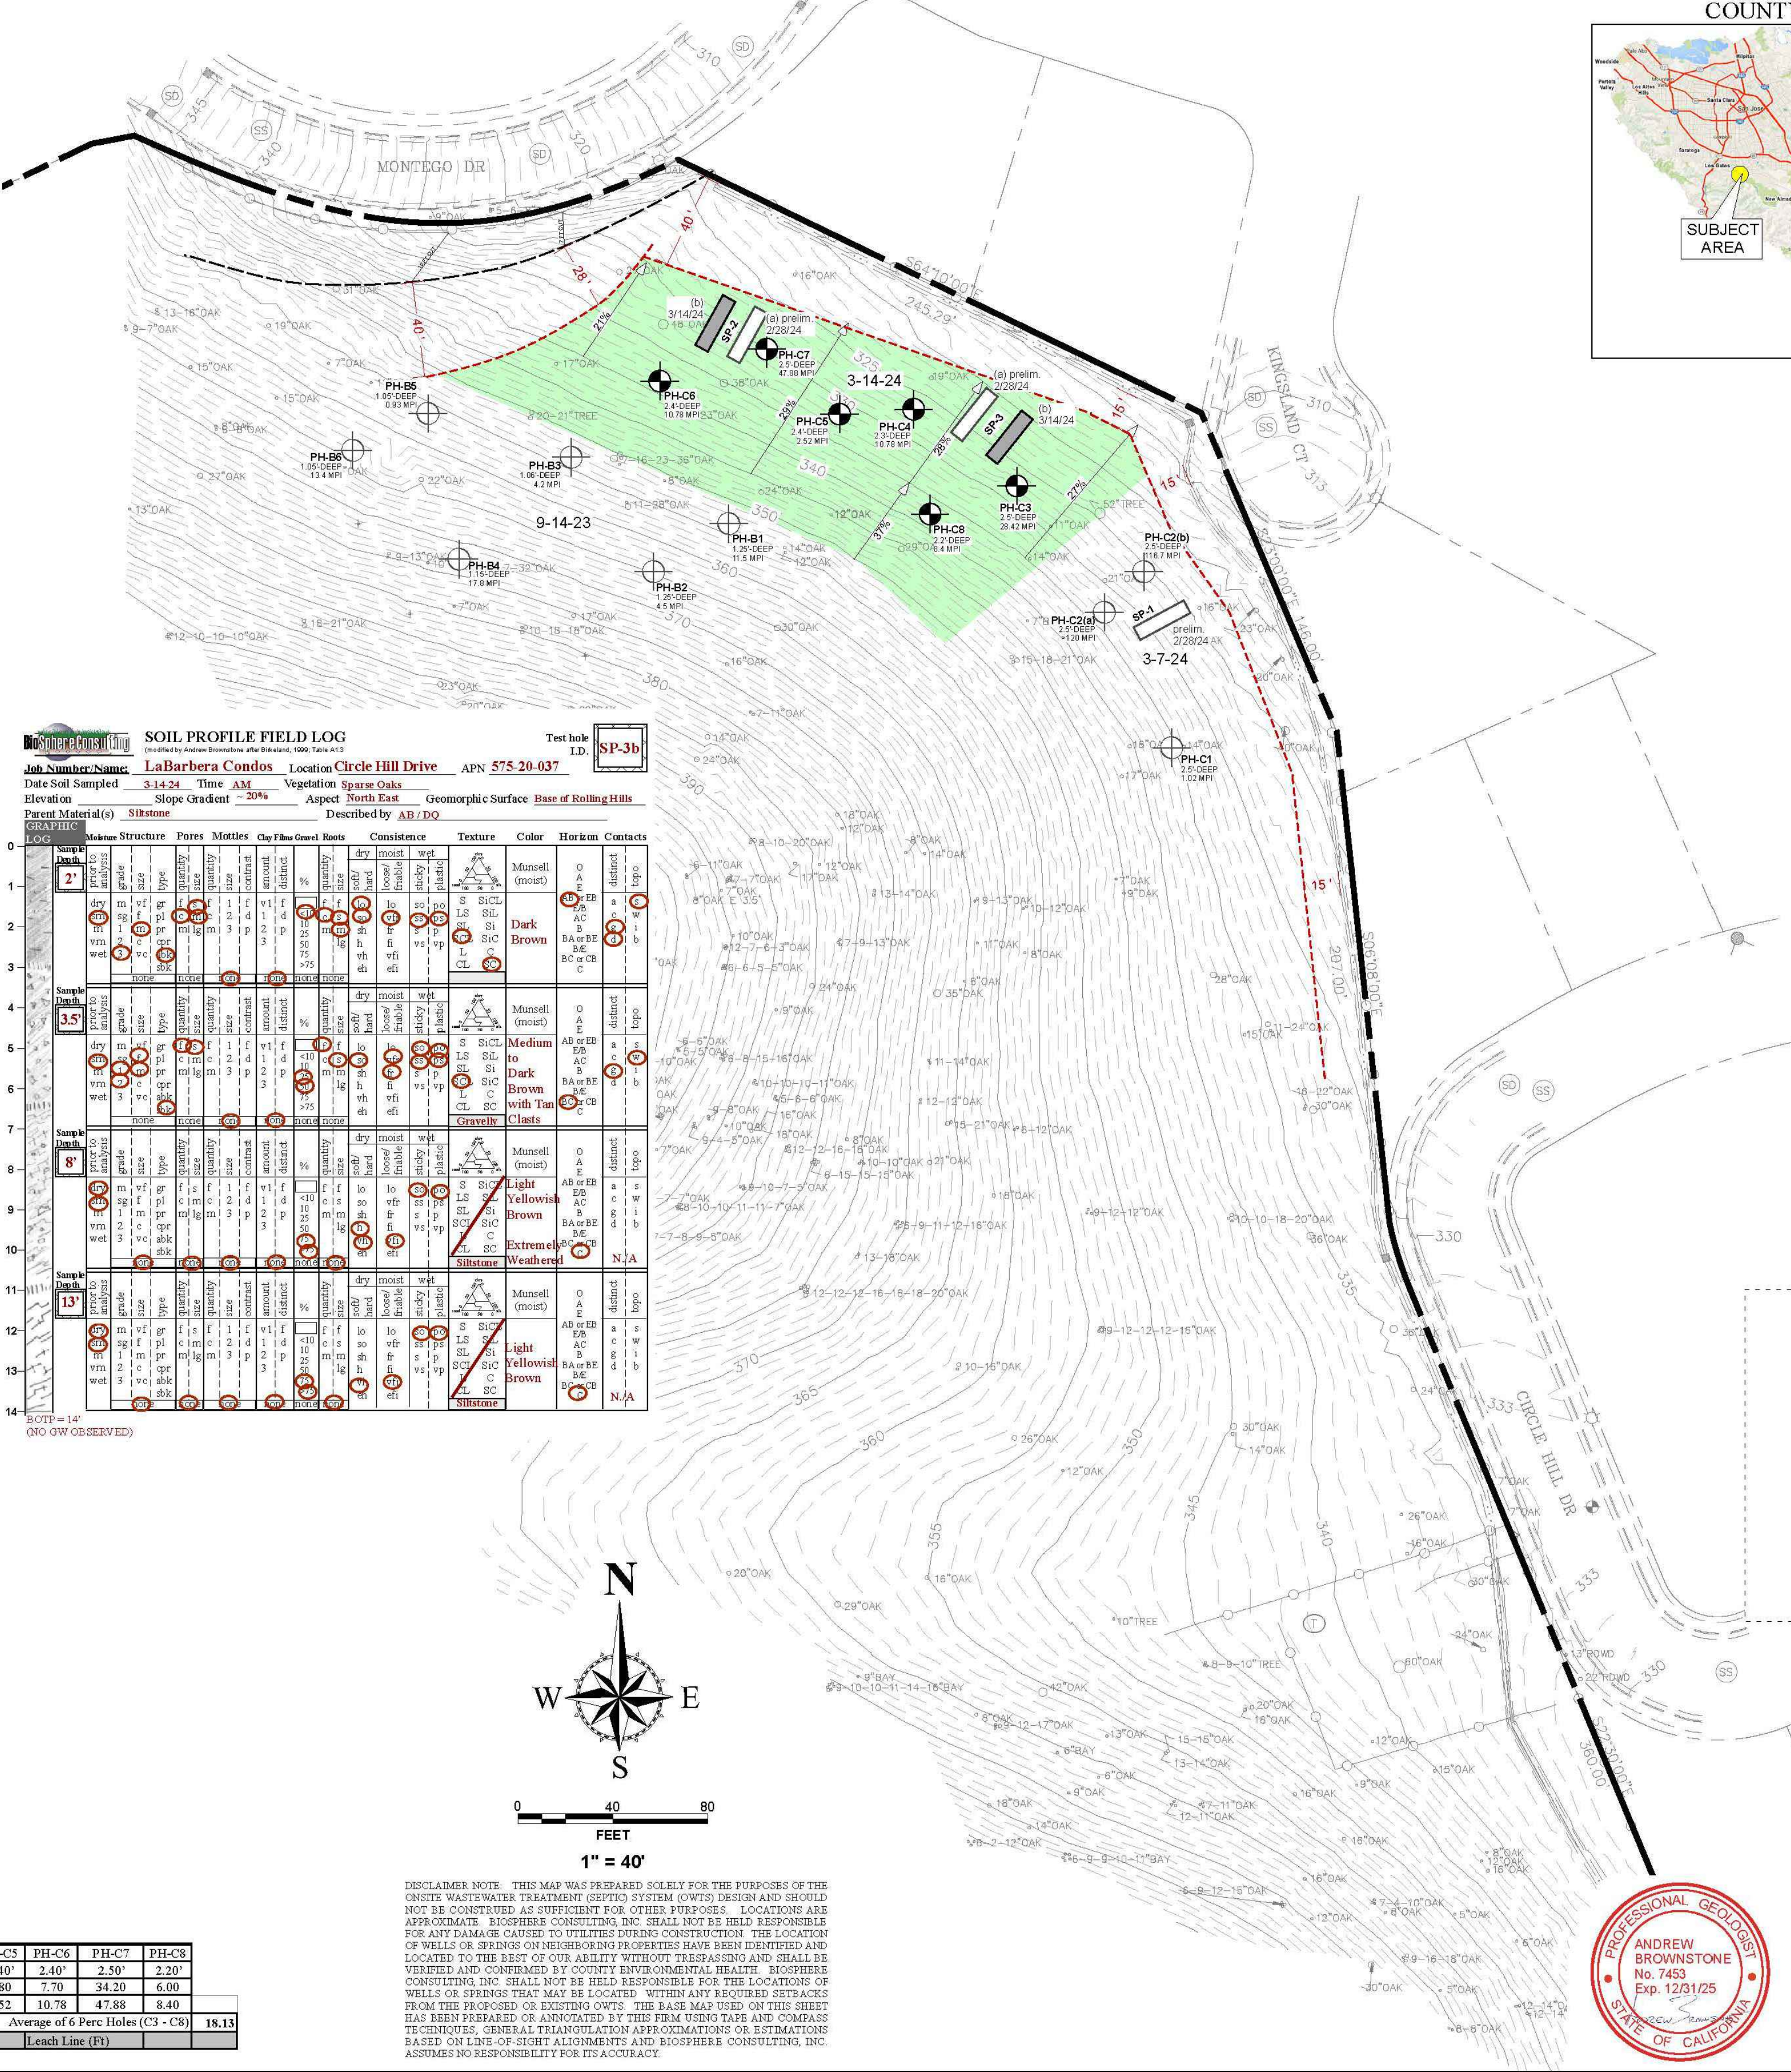

SOIL PROFILE FIELD LOG
 Job Number/Name: LaBarbera Condos Location Circle Hill Drive APN 575-20-037
 Date Soil Sampled: 3-14-24 Time AM Vegetation Sparse Oaks
 Elevation: Slope Gradient 20% Aspect North East Geomorphic Surface Base of Rolling Hills
 Parent Material(s) Silstone Described by AB/DQ

DEPTH (ft)	MOISTURE	STRUCTURE	PORES	MOTTLES	CLAY FILLS	ROOTS	CONSISTENCE	TEXTURE	COLOR	HORIZON	CONTACTS
0-2	dry	loose	open	none	none	none	loose	loose	Dark Brown	Munsell (moist)	distinct top
2-3.5	dry	loose	open	none	none	none	loose	loose	Dark Brown	Munsell (moist)	distinct top
3.5-8	dry	loose	open	none	none	none	loose	loose	Medium Brown	Munsell (moist)	distinct top
8-11	dry	loose	open	none	none	none	loose	loose	Light Yellowish Brown	Munsell (moist)	distinct top
11-13	dry	loose	open	none	none	none	loose	loose	Light Yellowish Brown	Munsell (moist)	distinct top
13-14	dry	loose	open	none	none	none	loose	loose	Light Yellowish Brown	Munsell (moist)	distinct top

SOIL PERCOLATION SUMMARY TABLE -- 03/14/24


Percolation Hole (PH)	PH-C3	PH-C4	PH-C5	PH-C6	PH-C7	PH-C8
Depth	2.50'	2.30'	2.40'	2.40'	2.50'	2.20'
Stabilized MPI	20.30	7.70	1.80	7.70	34.20	6.00
Adjusted Stabilized MPI	R = R x 1.4					
Avg. Adj. Stabilized MPI	28.42	10.78	2.52	10.78	47.88	8.40
# Bedrooms:	FOR OFFICE USE ONLY		TANK SIZE (Gal)			
			Leach Line (Ft)			
			18.15			

DISCLAIMER NOTE: THIS MAP WAS PREPARED SOLELY FOR THE PURPOSES OF THE ON-SITE WASTEWATER TREATMENT (SEPTIC) SYSTEM DESIGN AND SHOULD NOT BE CONSTRUED AS SUFFICIENT FOR OTHER PURPOSES. LOCATIONS ARE APPROXIMATE. BIOSPHERE CONSULTING, INC. SHALL NOT BE HELD RESPONSIBLE FOR ANY DAMAGE CAUSED TO UTILITIES DURING CONSTRUCTION. THE LOCATION OF WELLS OR SPRINGS ON NEIGHBORING PROPERTIES HAVE BEEN IDENTIFIED AND LOCATED TO THE BEST OF OUR ABILITY WITHOUT TRESPASSING AND SHALL BE VERIFIED AND CONFIRMED BY COUNTY ENVIRONMENTAL HEALTH. BIOSPHERE CONSULTING, INC. SHALL NOT BE HELD RESPONSIBLE FOR THE LOCATIONS OF WELLS OR SPRINGS THAT MAY BE LOCATED WITHIN ANY REQUIRED SETBACKS FROM THE PROPOSED OR EXISTING OWTS. THE BASE MAP USED ON THIS SHEET HAS BEEN PREPARED OR ANNOTATED BY THIS FIRM USING TAPE AND COMPASS TECHNIQUES. GENERAL TRIANGULATION APPROXIMATIONS OR ESTIMATIONS BASED ON LINE-OF-SIGHT ALIGNMENTS AND BIOSPHERE CONSULTING, INC. ASSUMES NO RESPONSIBILITY FOR THE ACCURACY.

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 1315 King Street
 Santa Cruz, CA 95060
 Tel: (831) 430-9116
 www.biosphere-consulting.com

SITE EVALUATION RESULTS MAP FOR PROPOSED OWTS

Project Location:	6591 Woodcliff Court, San Jose, California	(Santa Clara County)
Property Owner:	Mike LaBarbera	
Mailing Address:	6107 Black Pool Court, San Jose, CA 95138	
Owner Phone #:	(408) 529-2017	
Date:	03/15/24	By: David Quinn / Andrew Brownstone
REVISIONS:		Sheet: 1 of 1
	Job No.: 23021	APN: 575-20-037

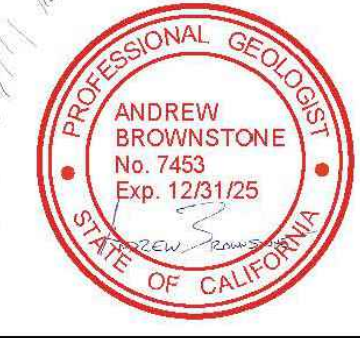

CIRCLE HILL ESTATES
 WASTEWATER TREATMENT SYSTEM
 SAN JOSE, CALIFORNIA

QUESTA
 Environmental & Water Resources
 (510) 236-6114
 P.O. Box 70356 1220 Brickyard Cove Road Point Richmond, CA 94807



Sht.	Rev.	Date:	By:	Description:	App'd:	Design:
						NH
						MN
						NH
						NH

WASTEWATER SITE EVALUATION DATA

Size D	Project 2300152
Scale:	NOT TO SCALE
Date:	3/29/2024
Sheet:	WW-4