

CHEN RESIDENCE

SHEET INDEX DATA CONTACT INFORMATION APPROVALS ABREVIATIONS -A.P.N.: 830-29-003 -AT THE TIME OF FINAL INSPECTION, PROVIDE AN FOOTING USE: SINGLE FAMILY RESIDENCE OWNER: MINGWEI CHEN OPERATION AND MAINTENANCE MANUAL, ACCEPTABLE TO THE 22602 BIRDS EYE DRIVE GAUGE ENFORCING AGENCY SHALL BE PROVIDED TO THE BUILDING OCCUPANCY CLASSIFICATION: A-O COVER SHEET DIAMOND BAR, CA 91765 GALVANIZED OCCUPANT OR OWNER, PER CGBS SECTION 4.410 CENTERLINE A-1 SITE PLAN DWELLING: R-3 (909) 860-8216GYPSUM BOARD NUMBER/POUND A-2 FLOOR PLAN -THE BUILDER/CONTRACTOR TO PROVIDE THE OWNER AND JENIFER WALLER A-3 ATTIC PLAN PROPERTY LINE DESIGNER: THE CITY BUILDING DEPARTMENT WITH A COPY OF THE HEADER TYPE OF CONSTRUCTION: V-B)/1 1400 SANTA ANA VALLEY ROAD A-4 EXTERIOR ELEVATIONS CF-6R INSTALLATION CERTIFICATE AT THE TIME OF FINAL DRAWN BY: J.R.W. EXISTING HOLLISTER, CA 95023 HORIZONTAL A-5 EXTERIOR ELEVATIONS 831-801-5094 A-6 BUILDING SECTIONS CHECKED BY: J.R.W. RELOCATED E-1 ELECTRICAL PLAN SPRINKLERED: YES INTERIOR **ENGINEER:** MAX CHENG & ASSOCIATES, INC. E-2 UTILITY NOTES ALUMINUM CAL GREEN MANDATORY MEASURES **DWELLING:** 5,720 S.F. MAXIMUM MORGAN HILL, CA 95037 G-2 CAL GREEN MANDATORY MEASURES SPECIAL FEATURES:
-INDOOR AIR QUALITY, BALANCED FAN APPROX APPROXIMATELY ATTIC: 1,931 S.F. 408-782-6898 MECHANICAL ARCHITECTURAL (HABITABLE) R.J.W. MINIMUM -COOL ROOF GARAGE: 1,258 S.F. ВҰ ASPHALT NRG COMPLIANCE TITLE 24: -WINDOW OVERHANGS AND/OR FINS MISCELLANEOUS PORCH: 171 S.F. SANTA ROSA, CA BOTTOM CURB -NORTHWEST ENERGY EFFICIENCY ALLIANCE (NEEA) RATED \simeq NORTH 707-237-6957 HEAT PUMP WATER HEATER; SPECIFIC BRAND/MODEL, OR BUILDING NOM NOMINAL S-1 GENERAL NOTES TOTAL: 9,080 S.F. EQUIVALENT, MUST BE INSTALLED BLOCK S-2 FOUNDATION PLAN SOILS REPORT: CONSTRUCTION TESTING SERVICE NOT TO SCALE 2022 ВМ BEAM HERS VERIFICATION: S-3ROOF PLAN 2118 RHEEM DRIVE, OC ON CENTER CLG CEILING PLEASANTON, CA 94588 SHEAR WALL & HEADER PLAN PAIR BUILDING-LEVEL VERIFICATIONS: DATE 925-462-5151 **CLOSET** SF-1 FOUNDATION DETAILS CLO RADIUS -INDOOR AIR QUALITY VENTILATION 5, SD-1 STRUCTURAL DETAILS CLR CLEAR -KITCHEN RANGE HOOD REFR REFRIGERATOR THIS PROJECT INCLUDES: COOLING SYSTEM VERIFICATIONS: C.O. CASED OPENING REINF REINFORCED CONSTRUCTION OF 5 BEDROOM AND 5.5 -MINIMUM AIRFLOW Ö CONC CONCRETE BATH SINGLE FAMILY RESIDENCE WITH -VERIFIED SEER REQUIRED CONN CONNECTION ATTACHED GARAGE IN SANTA CLARA COUNTY. -FAN EFFICACY WATTS/CFM ATTACHED: ROOM APN 830-29-003 DEFERRED SUBMITTALS CONST CONSTRUCTION HEATING SYSTEM VERIFICATIONS: S -STRUCTURAL CALCULATIONS RWD REDWOOD -VERIFIED HSPF CONT CONTINUOUS BY DESIGN EVEREST, INC., **Foothill Avenue** SOUTH -VERIFIED HEAT PUMP RATED HEATING CAPACITY DBL DOUBLE -BUILDING ENERGY ANALYSIS REPORT HVAC DISTRIBUTION SYSTEM VERIFICATIONS: SHT SHEET 37.0729 N 121.5707 W -FIRE SPRINKLER DESIGN COMIN 2022 DF DOUGLAS FIR -DUCT LEAKAGE TESTING PLANCHECK COMI on July 15, 2021 PLANCHECK COMI on Sept. 20, 2022 BY NRG COMPLIANCE SPECIFICATION -LOW-LEAKAGE AIR HANDLING UNIT NO PROPOSED LANDSCAPE. 2 **~~~~~** DIA DIAMETER -GEOTECHNICAL ENGINEERING RECOMMENDATIONS 🤇 SQUARE DOMESTIC HOT WATER SYSTEM VERIFICATIONS: -PV SYSTEMS DIM DIMENSION BY REDWOOD GEOTECHNICAL ENGINEERING -PIPE INSULATION, ALL LINES SS STAINLESS STEEL _____ DN COOL ROOF VERIFICATIONS: DOWN STD STANTARD -CRRC RATED PRODUCT DWG DRAWING TOP OF CURB EAST GENERAL NOTES TP TELEPHONE POLE FΑ FACH T&G TOUNGE AND GROOVE ELECTRICAL TYP TYPICAL Construction means constructing, clearing, grading or excavation that result in soil disturbance. Construction includes structure teardown (demolition). It 1. THE CONTRACT DOCUMENTS INCLUDE THESE DRAWINGS AND THE SPECIFICATIONS. VERIFY ALL DIMENSIONS AND CONDITIONS IN FIELD TO CONFIRM THAT WORK EXT EXTERIOR does not include routine maintenance to maintain original line and grade, hydraulic capacity, or original purpose of facility; emergency construction UNLESS OTHERWISE NOTED IS BUILDABLE AS SHOWN. ANY CONFLICTS OR OMISSIONS, ETC., SHALL BE IMMEDIATELY REPORTED TO THE DESIGNER FOR CLARIFICATION PRIOR TO THE FLOOR DRAIN FD activities required to immediately protect public health and safety; interior remodeling with no outside exposure of construction material or construction VERTICAL PERFORMANCE OF ANY WORK IN QUESTION. FINISH FLOOR waste to storm water; mechanical permit work; or sign permit work. WEST 2. DO NOT SCALE DRAWINGS. FLR FLOOR 1. Eroded sediments and pollutants shall be retained on site and shall not be transported from the site via sheet flow, swales, area drains, natural 3. WRITTEN DIMENSIONS GOVERN ALL PARTITION LOCATIONS. ALL DOOR AND OPENING LOCATIONS SHALL BE SHOWN ON FLOOR PLAN. IN CASE OF CONFLICT, WITH FLOUR FLOURESCENT drainage or wind. NOTIFY THE ARCHITECT. FLOOR PLAN BY DESIGNER SUPERCEDES OTHER PLANS. ALL DIMENSIONS MARKED "CLEAR" SHALL BE MAINTAINED AND SHALL ALLOW FOR 2. Stockpiles of earth and other construction—related materials shall be covered and/or protected from being transported from the site by wind or water. SCALE: 3/16"=1'-0" THICKNESS OF ALL FINISHES.

CODE COMPLIANCE

ALL CONSTRUCTION SHALL CONFORM TO ALL GOVERNING LAWS, CODES AND ORDINANCES INCLUDING BUT NOT LIMITED TO THE FOLLOWING: A. 2018 INTERNATIONAL BUILDING CODE AS AMENDED

- BY 2019 CALIFORNIA BUILDING CODE B. 2018 INTERNATIONAL RESIDENTIAL CODE AS AMENDED
- BY 2019 CALIFORNIA RESIDENTIAL CODE. C. 2018 UNIFORM MECHANICAL CODE AS AMENDED BY 2019 CALIFORNIA MECHANICAL CODE.
- D. 2018 UNIFORM PLUMBING CODE AS AMENDED BY 2019 CALIFORNIA PLUMBING CODE E. 2018 NATIONAL ELECTRICAL CODE AS AMENDED
- BY 2019 CALIFORNIA ELECTRICAL CODE F. 2019 CALIFORNIA ENERGY CODE
- (2019 BUILDING ENERGY EFFICIENCY STANDARDS). G. 2019 CALIFORNIA GREEN BUILDING STANDARDS CODE. H. SAN BENITO COUNTY LOCAL CODES & ORDINANCES

- 4. THESE DRAWINGS ARE THE EXCLUSIVE PROPERTY OF THE DESIGNER AND MUST NOT BE REPRODUCED, ALTERED OR AMENDED WITHOUT PERMISSION. 5. THE RESIDENCE WILL BE INSULATED TO CONFORM TO THE FOLLOWING:
- A. ROOF- NONE, CEILING- R-30 BATT OR BLOWN IN, B. EXTERIOR WALLS R-15, C. FLOORS N/A, D. INTERIOR WALLS N/A 6. CHANGES FROM THE APPROVED PLANS DURING CONSTRUCTION OTHER THAN 1.) CABINET CHANGES WHEN NOT BEING SUPPORTED ENTIRELY BY THE ROOF STRUCTURE, 2.) INTERIOR DOOR AND FIREPLACE RELOCATION SHOWN ON THE APPROVED PLAN, 3.) A SINGLE NON-BEARING WALL RELOCATION WHEN NOT CREATING AN ADDITIONAL ROOM, AND 4.) INTERIOR NON-STRUCTURAL WALL FINISHES; SHALL CAUSE PLAN APPROVAL AND CONSTRUCTION TO BE SUSPENDED. A NEW PLAN CHECK (FOR A NEW PLAN) SHOWING CHANGES WILL BE SUBMITTED FOR REVIEW AND APPROVAL THROUGH THE NORMAL PLAN CHECK PROCESS. 7. ALL EARTHWORK AND SITE DRAINAGE, INCLUDING FOUNDATION EXCAVATION AND CONSTRUCTION, PREPARATION OF SUBGRADE BENEATH SLABS-ON-GRADE
- 8. THE HOME SHALL ACHIEVE A 'BUILD IT GREEN' ELEMENTS RATING AS OUTLINED IN THE 'GREEN BUILDING REQUIREMENTS' ON THIS SHEET 9. ADDRESS SIGN SHALL BE INSTALLED ON THE FRONT OF THE BUILDING IN A CONSPICUOUS POSITION. LETTERS TO BE 5" TALL MIN AND CONTRASTING WITH THEIR BACKGROUND.
- 10. PROVIDE A MINIMUM 5% GRADE SLOPE AWAY FROM THE FOUNDATION FOR A MINIMUM OF 6 INCHES OF FALL WITHIN THE FIRST 10 FEET MEASURED PERPENDICULAR TO THE FACE OF THE WALL. A) IF BUILDING SITE DOES NOT ALLOW 10 FEET OF SLOPE, PROVIDE DRAINS OR SWALES TO ENSURE DRAINAGE AWAY FROM THE STRUCTURE OR B) FOR IMPERVIOUS SURFACES WITHIN 10 FEET OF THE FOUNDATION PROVIDE A MINIMUM 2% SLOPE AWAY FROM THE BUILDING..

11. THESE PLANS AND RELATED DOCUMENTS MUST BE AVAILABLE AT THE JOB SITE DURING ANY INSPECTION.

AND FINAL SURFACE DRAINAGE INSTALLATION SHOULD BE PERFORMED IN ACCORDANCE WITH LOCAL CODES & ORDINANCES.

- 3. Fuels, oils, solvents and other toxic materials must be stored in accordance with their listing and shall not contaminate the soil nor the surface waters. All approved toxic storage containers are to be protected from the weather. Spills must be cleaned up immediately and disposed of properly and shall not be washed into the drainage system.
- 4. Non-storm water runoff from equipment and vehicle washing and any other activity shall be contained on the project site.
- 5. Excess or waste concrete may not be washed into the public way or any drainage system. Provisions shall be made to retain concrete waste on—site until it can be appropriately disposed of or recycled.
- 6. Trash and construction —related solid wastes must be deposited into a covered receptacle to prevent contamination of storm water and dispersal by
- 7. Sediments and other materials shall not be tracked from the site by vehicle traffic. The construction entrance roadways must be stabilized so as to inhibit sediments from being deposited into the street/public ways. Accidental depositions must be swept up immediately and may not be washed down by rain or by any other means.
- 8. Retention basins of sufficient size shall be provided to retain storm water runoff on—site and shall be properly located to collect all tributary site
- 9. Where retention of storm water runoff on—site is not feasible due to site constraints, runoff may be conveyed to the street and the storm drain system provided that an approved filtering system is installed and maintained on—site during the construction duration.

P: (831) 801-5094 Maller

400 SANTA ANA VLY RD HOLLISTER, CA

JW JENIFER WALLER

PROJECT:

CHEN NEW RESIDENCE

PROJECT AT:


Foothill Avenue Gilroy, CA

CONSULTANT:

PROJECT #: 1989

DATE: March 16, 2021

COVER SHEET

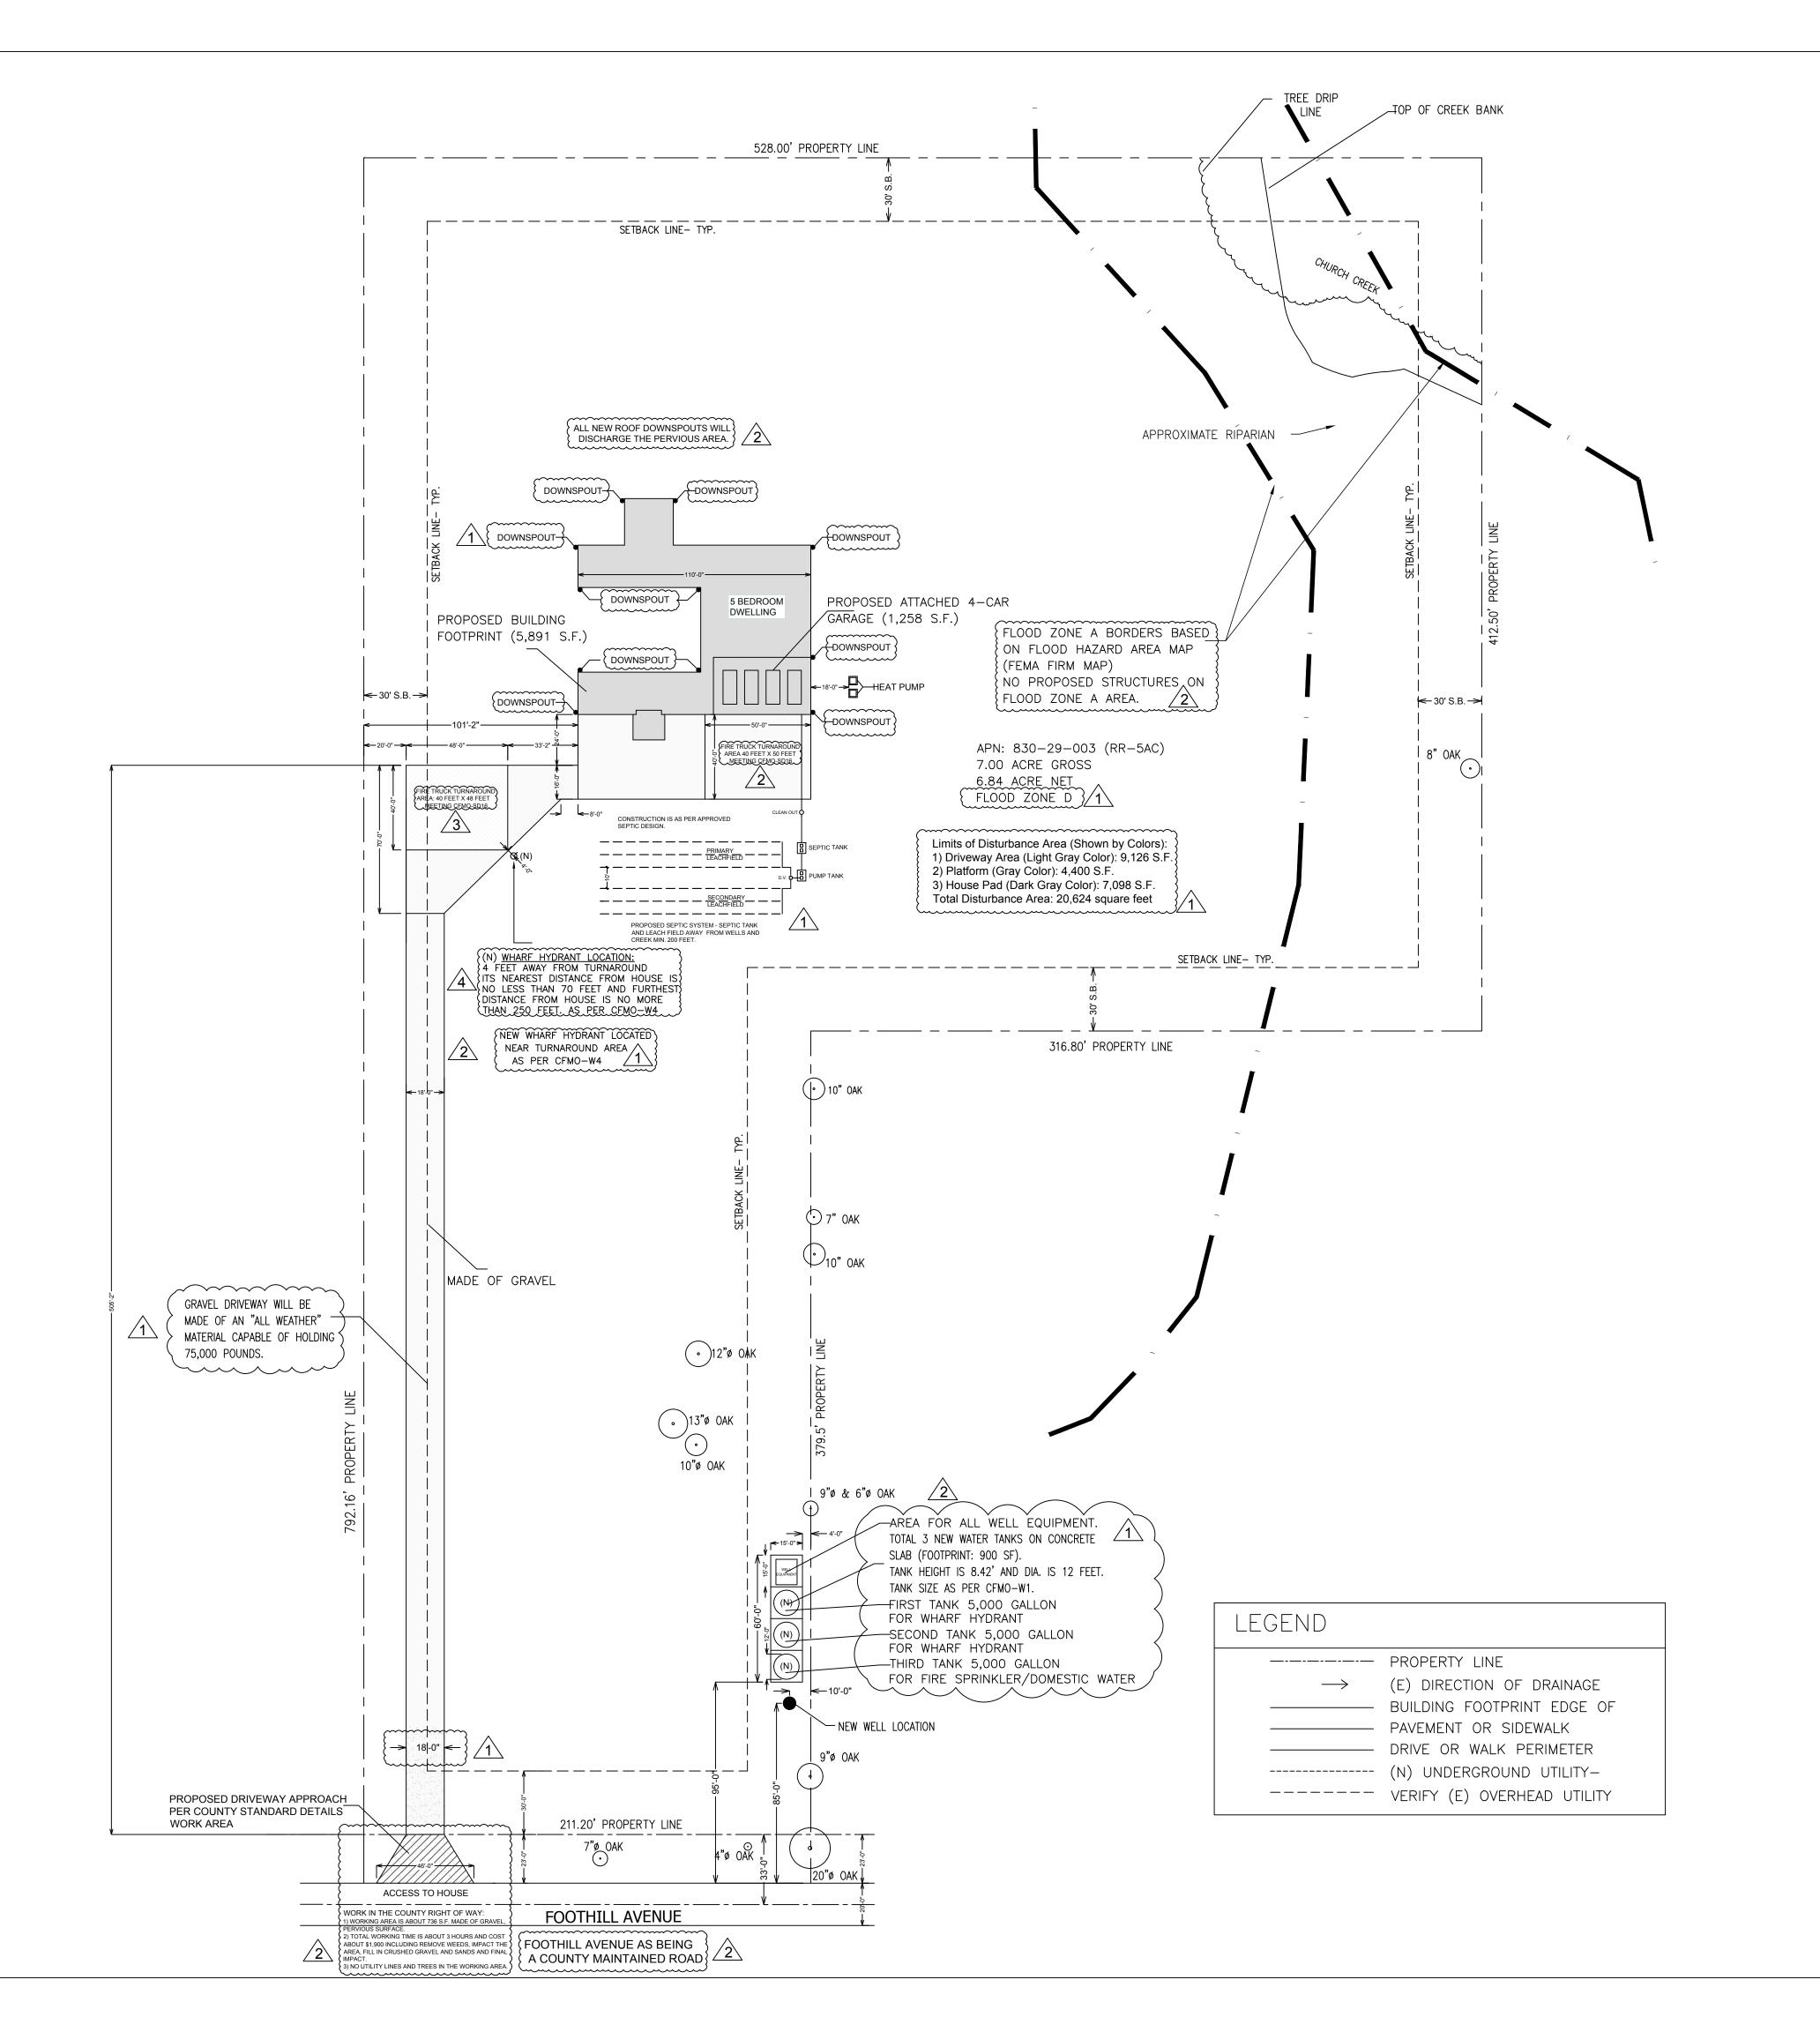

JW JENIFER WALLER

1400 SANTA ANA VLY RD

HOLLISTER, CA P: (831) 801-5094

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PROJECT:

CHEN NEW RESIDENCE

PROJECT AT:

Foothill Avenue Gilroy, CA

CONSULTANT:

A.P.N.: 830-29-003

DRAWN BY: J.R.W.
CHECKED BY: J.R.W.


SCALE: 1"= 40'


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ВУ	R.J.W.	R.J.W.	R.J.W.	R.J.W.
DATE	Jan. 31, 2022	Oct. 23, 2022	Jan. 19, 2024	April. 06, 2024
REVISION	PLANCHECK COMMENTS on July 15, 2021	PLANCHECK COMMENTS on Sept. 20, 2022	PLANCHECK COMMENTS on Dec. 19, 2023	PLANCHECK COMMENTS on April. 03, 2024
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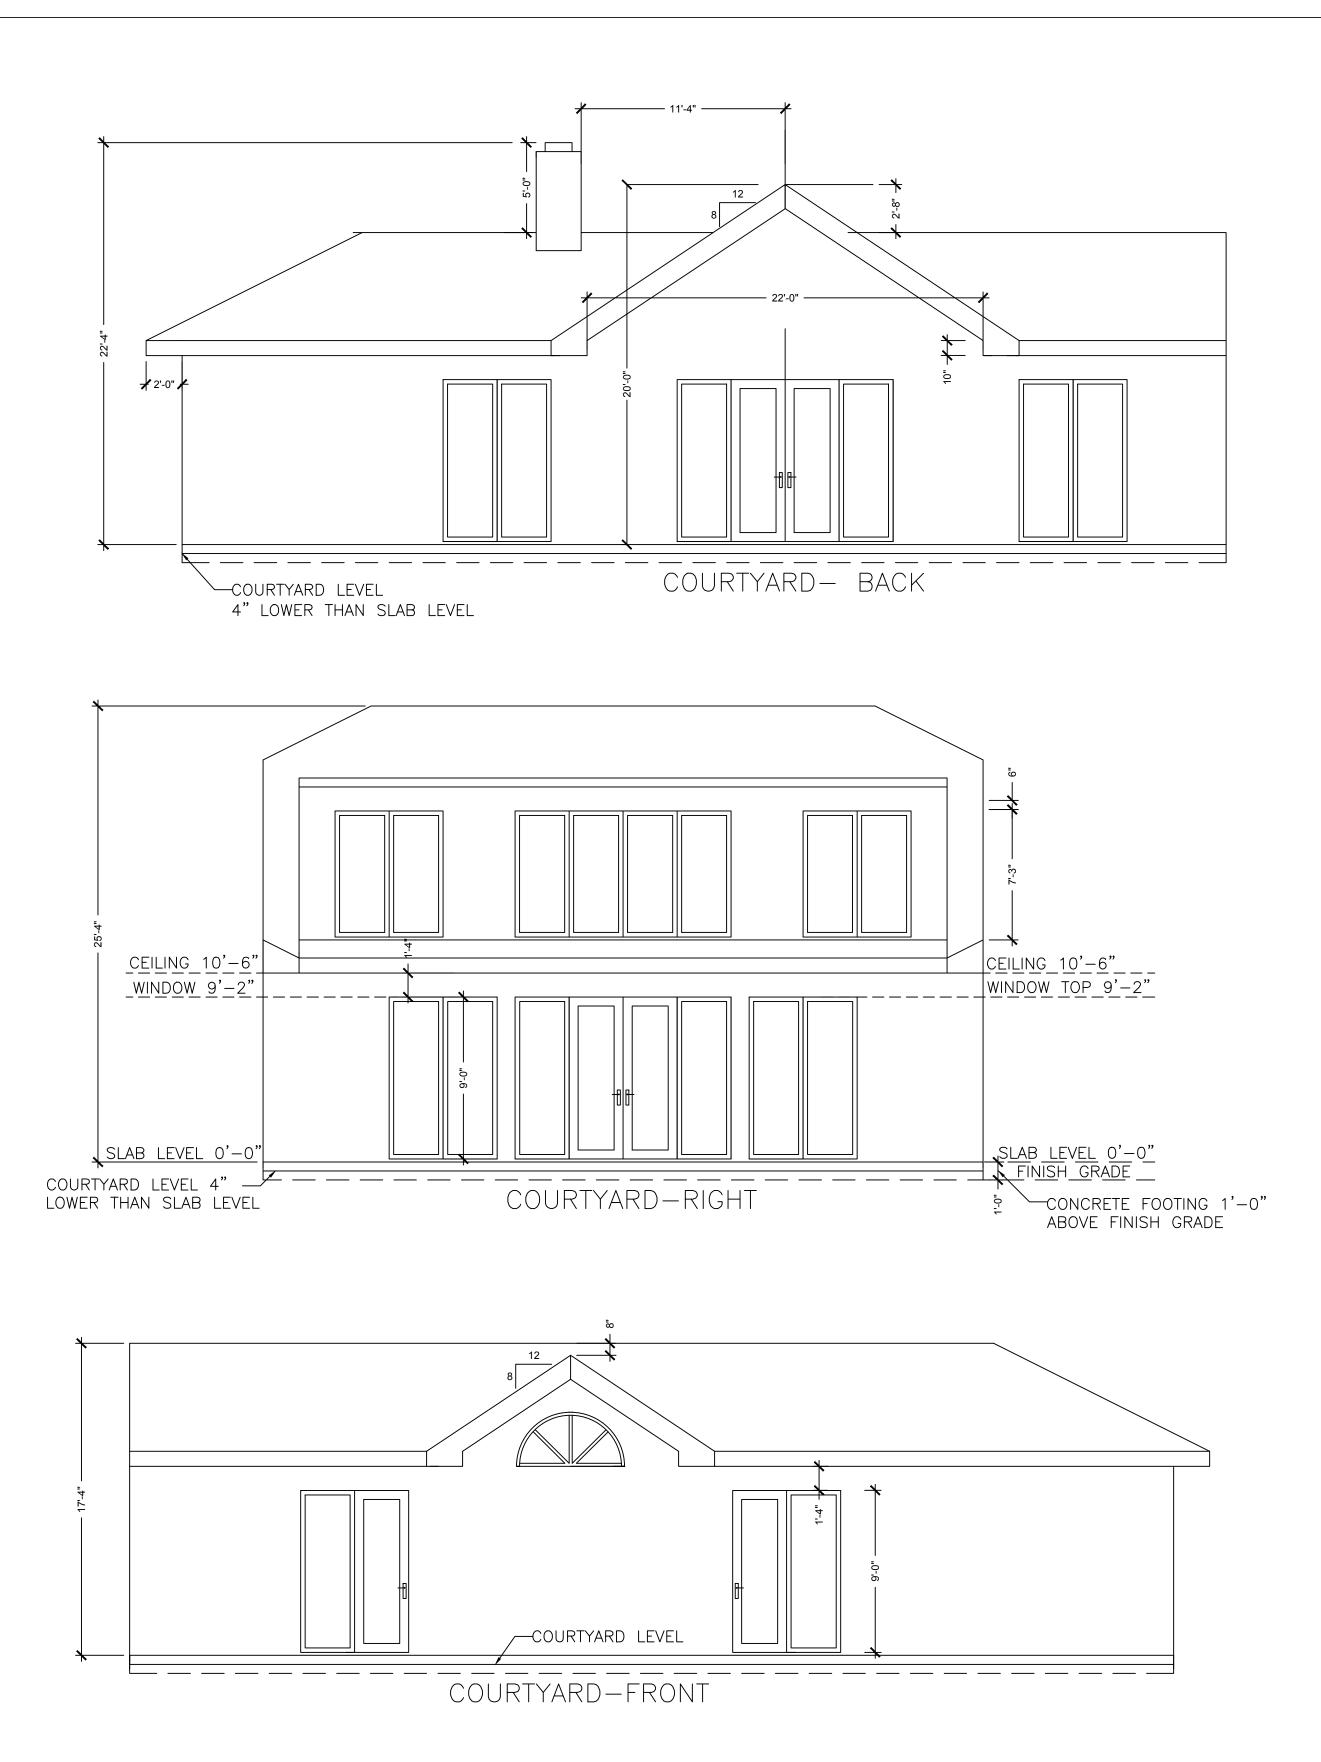
SITE PLAN





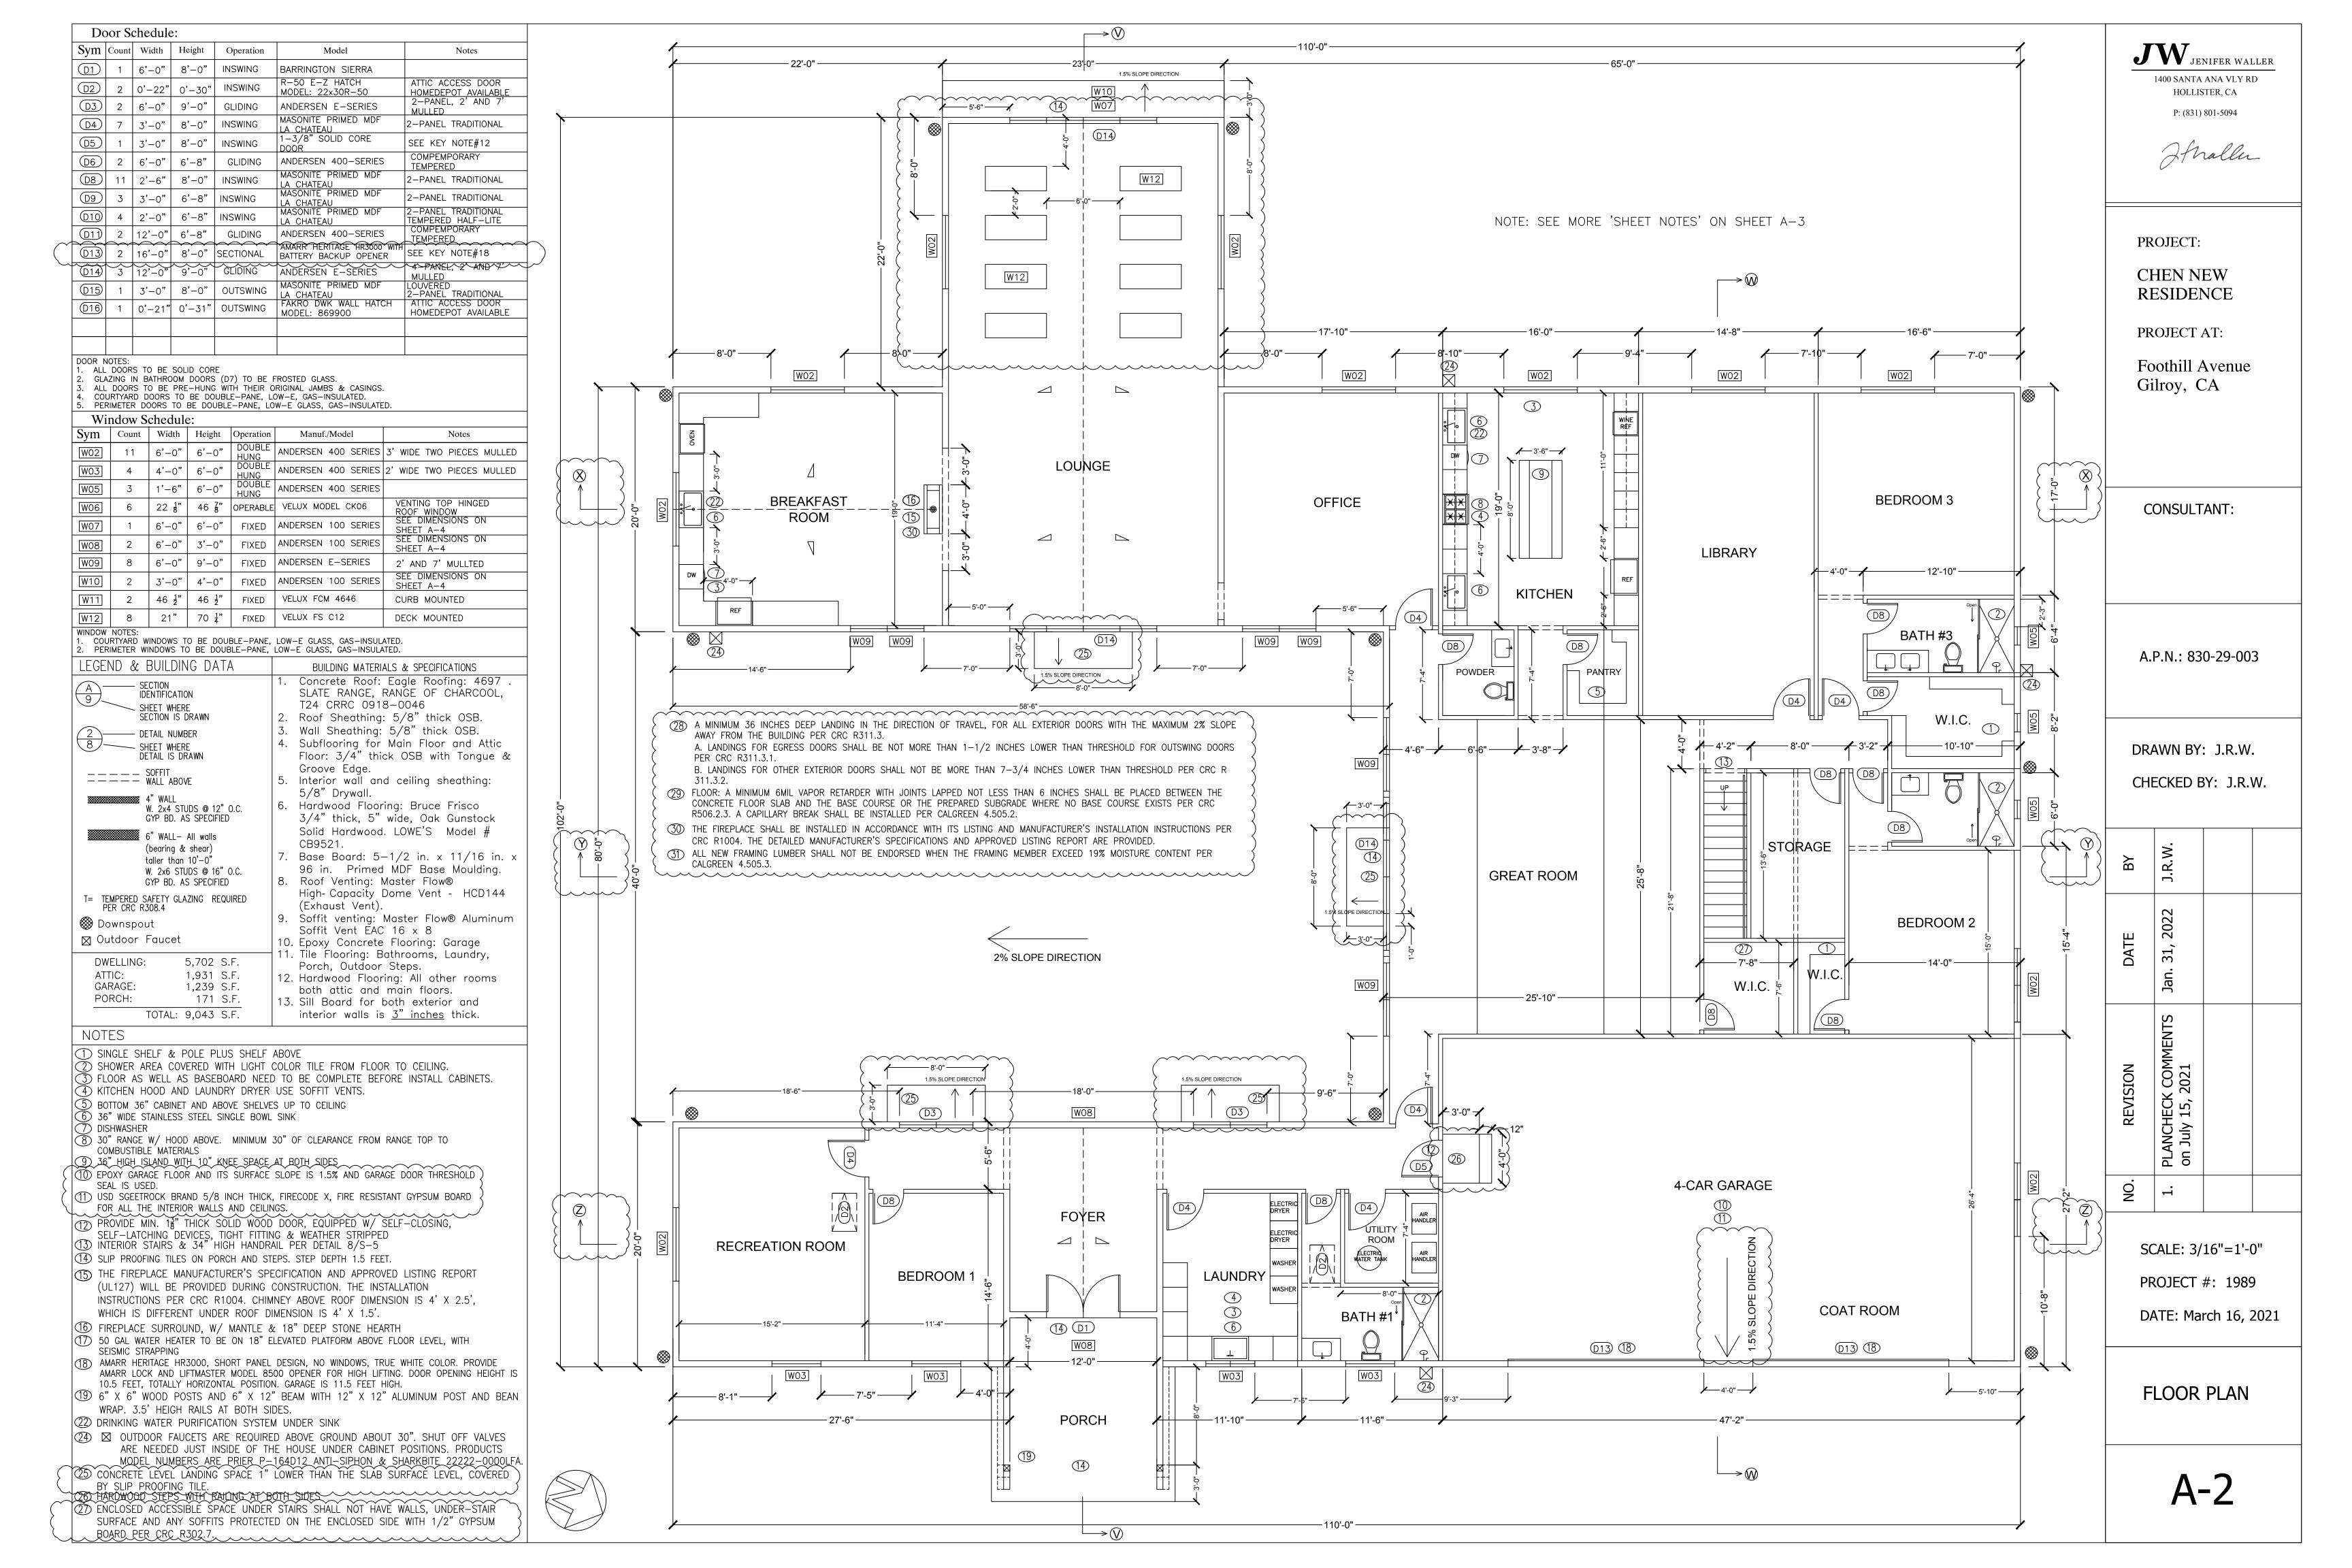

ВҮ	J.R.W.	
DATE	Jan. 31, 2022	
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NO.	1.	

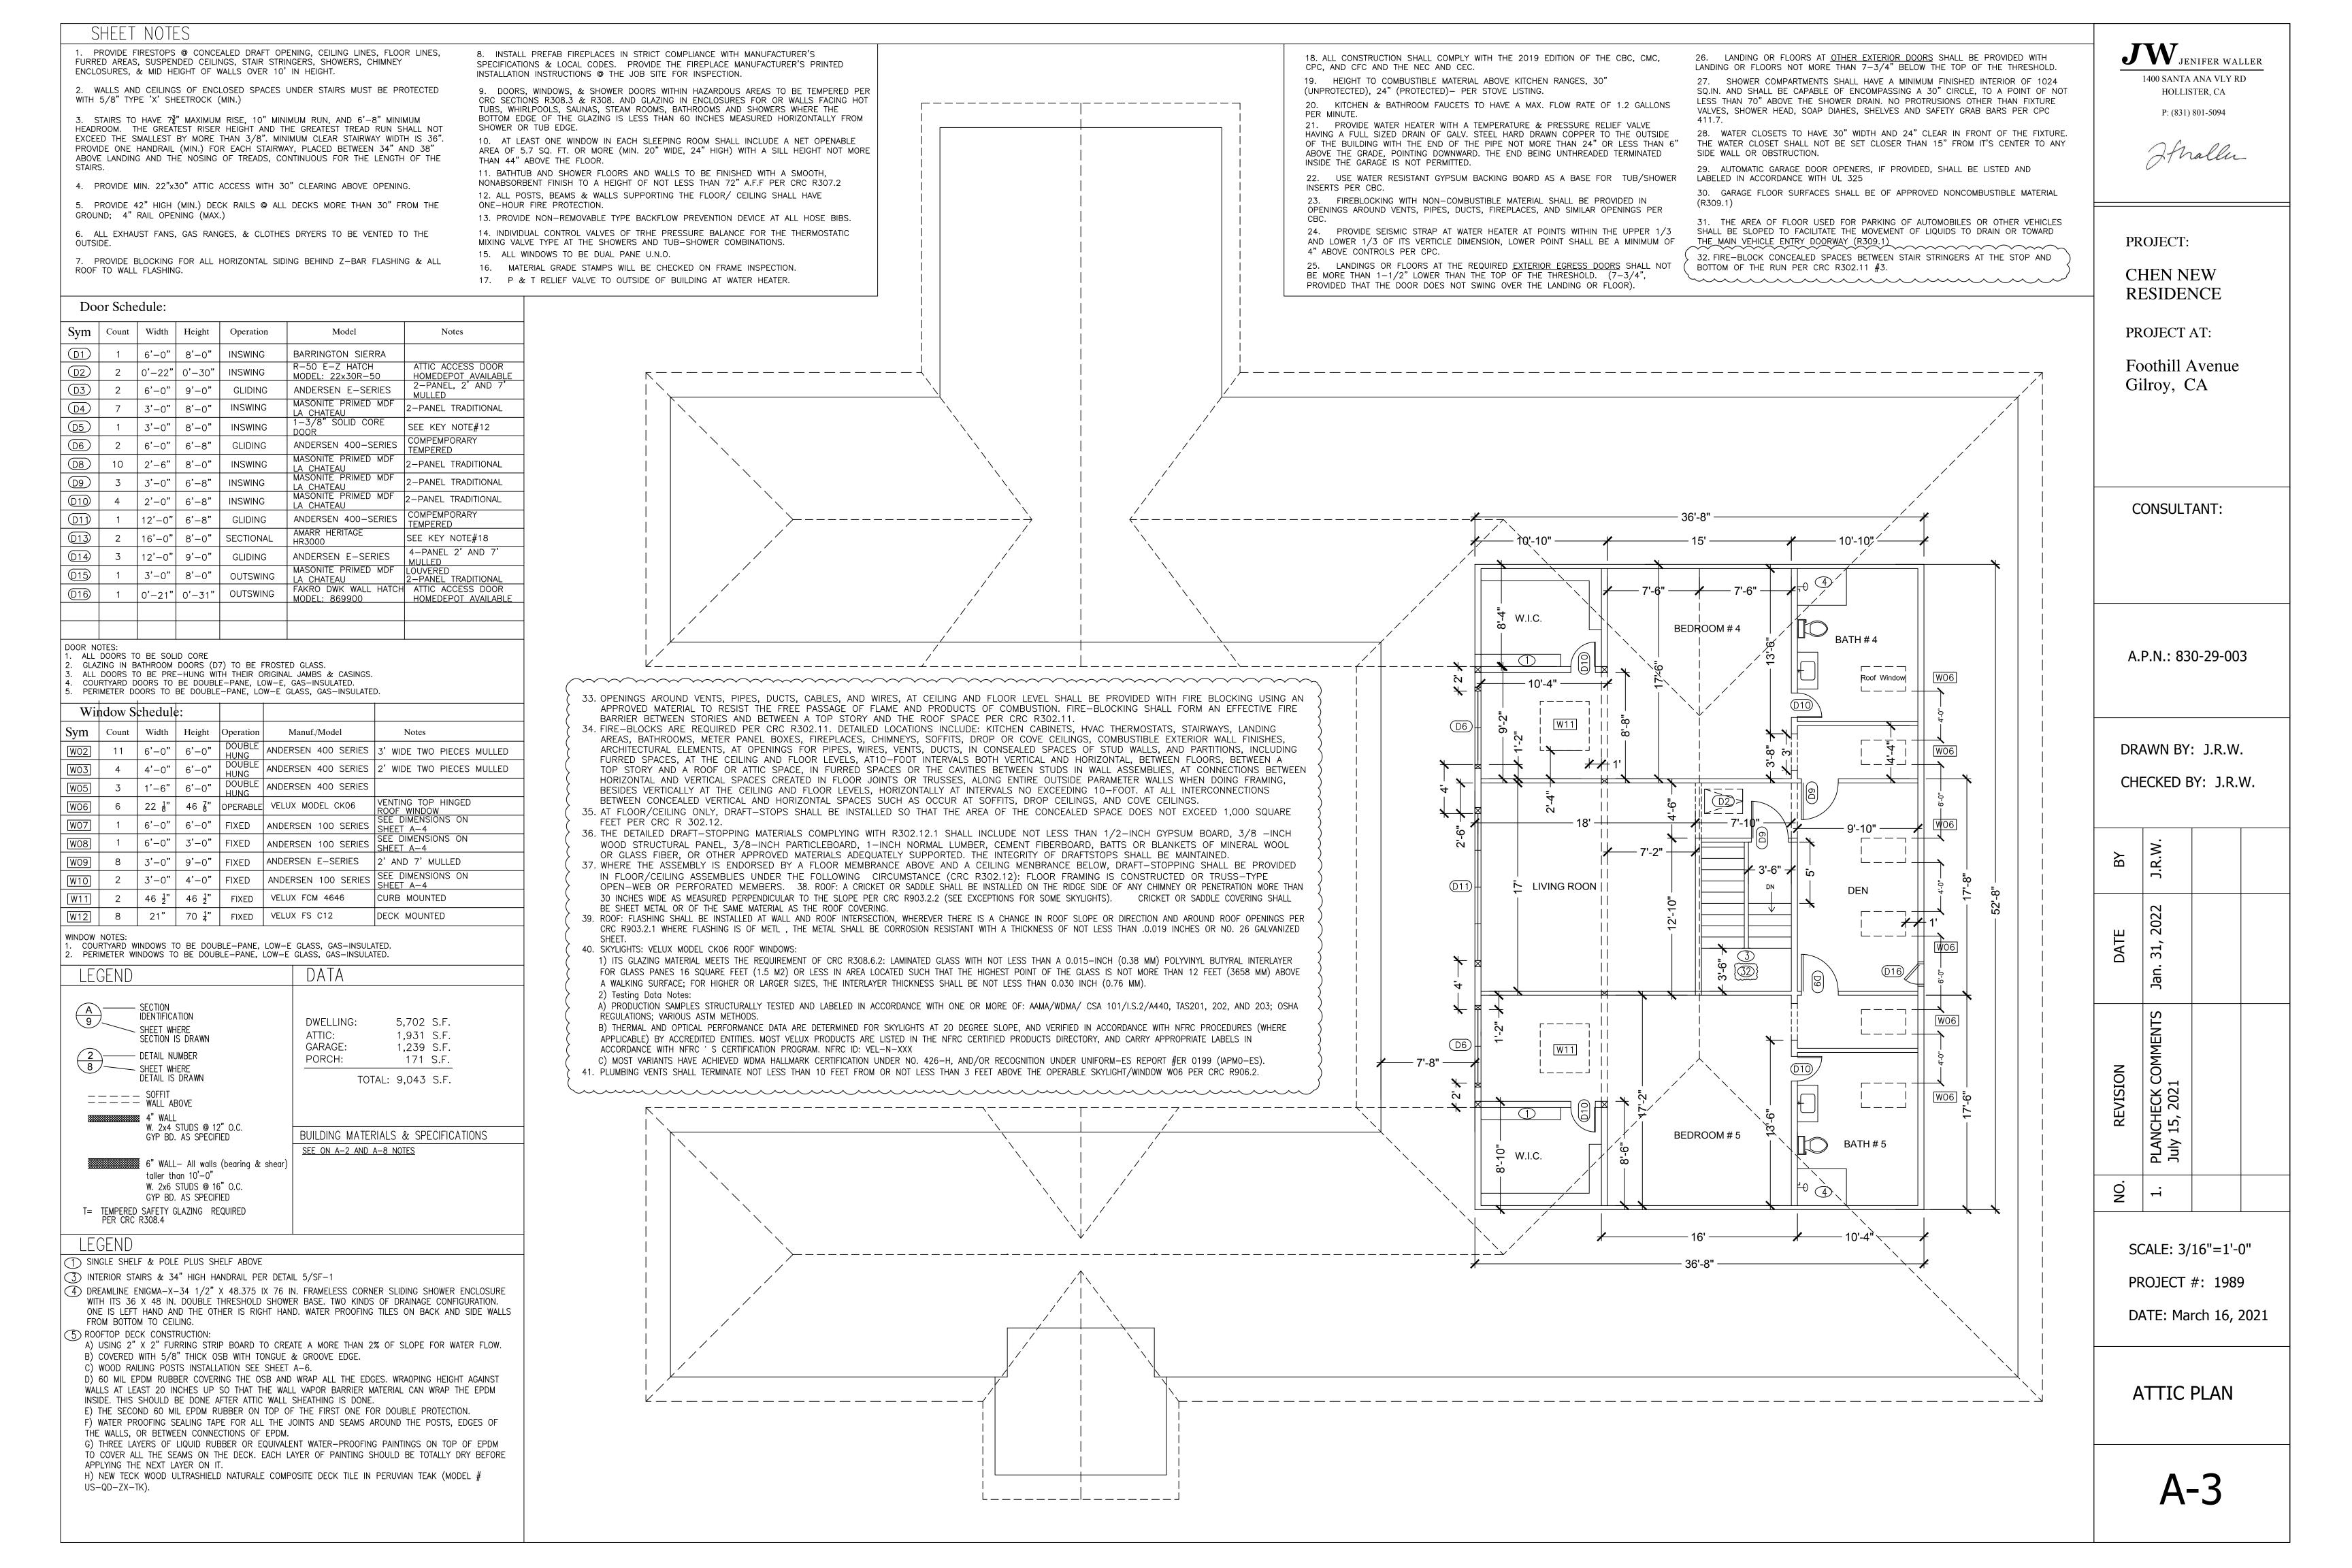

COURTYARD-LEFT IS OPEN TO OUTSIDE

JW JENIFER WALLER

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HOLLISTER, CA

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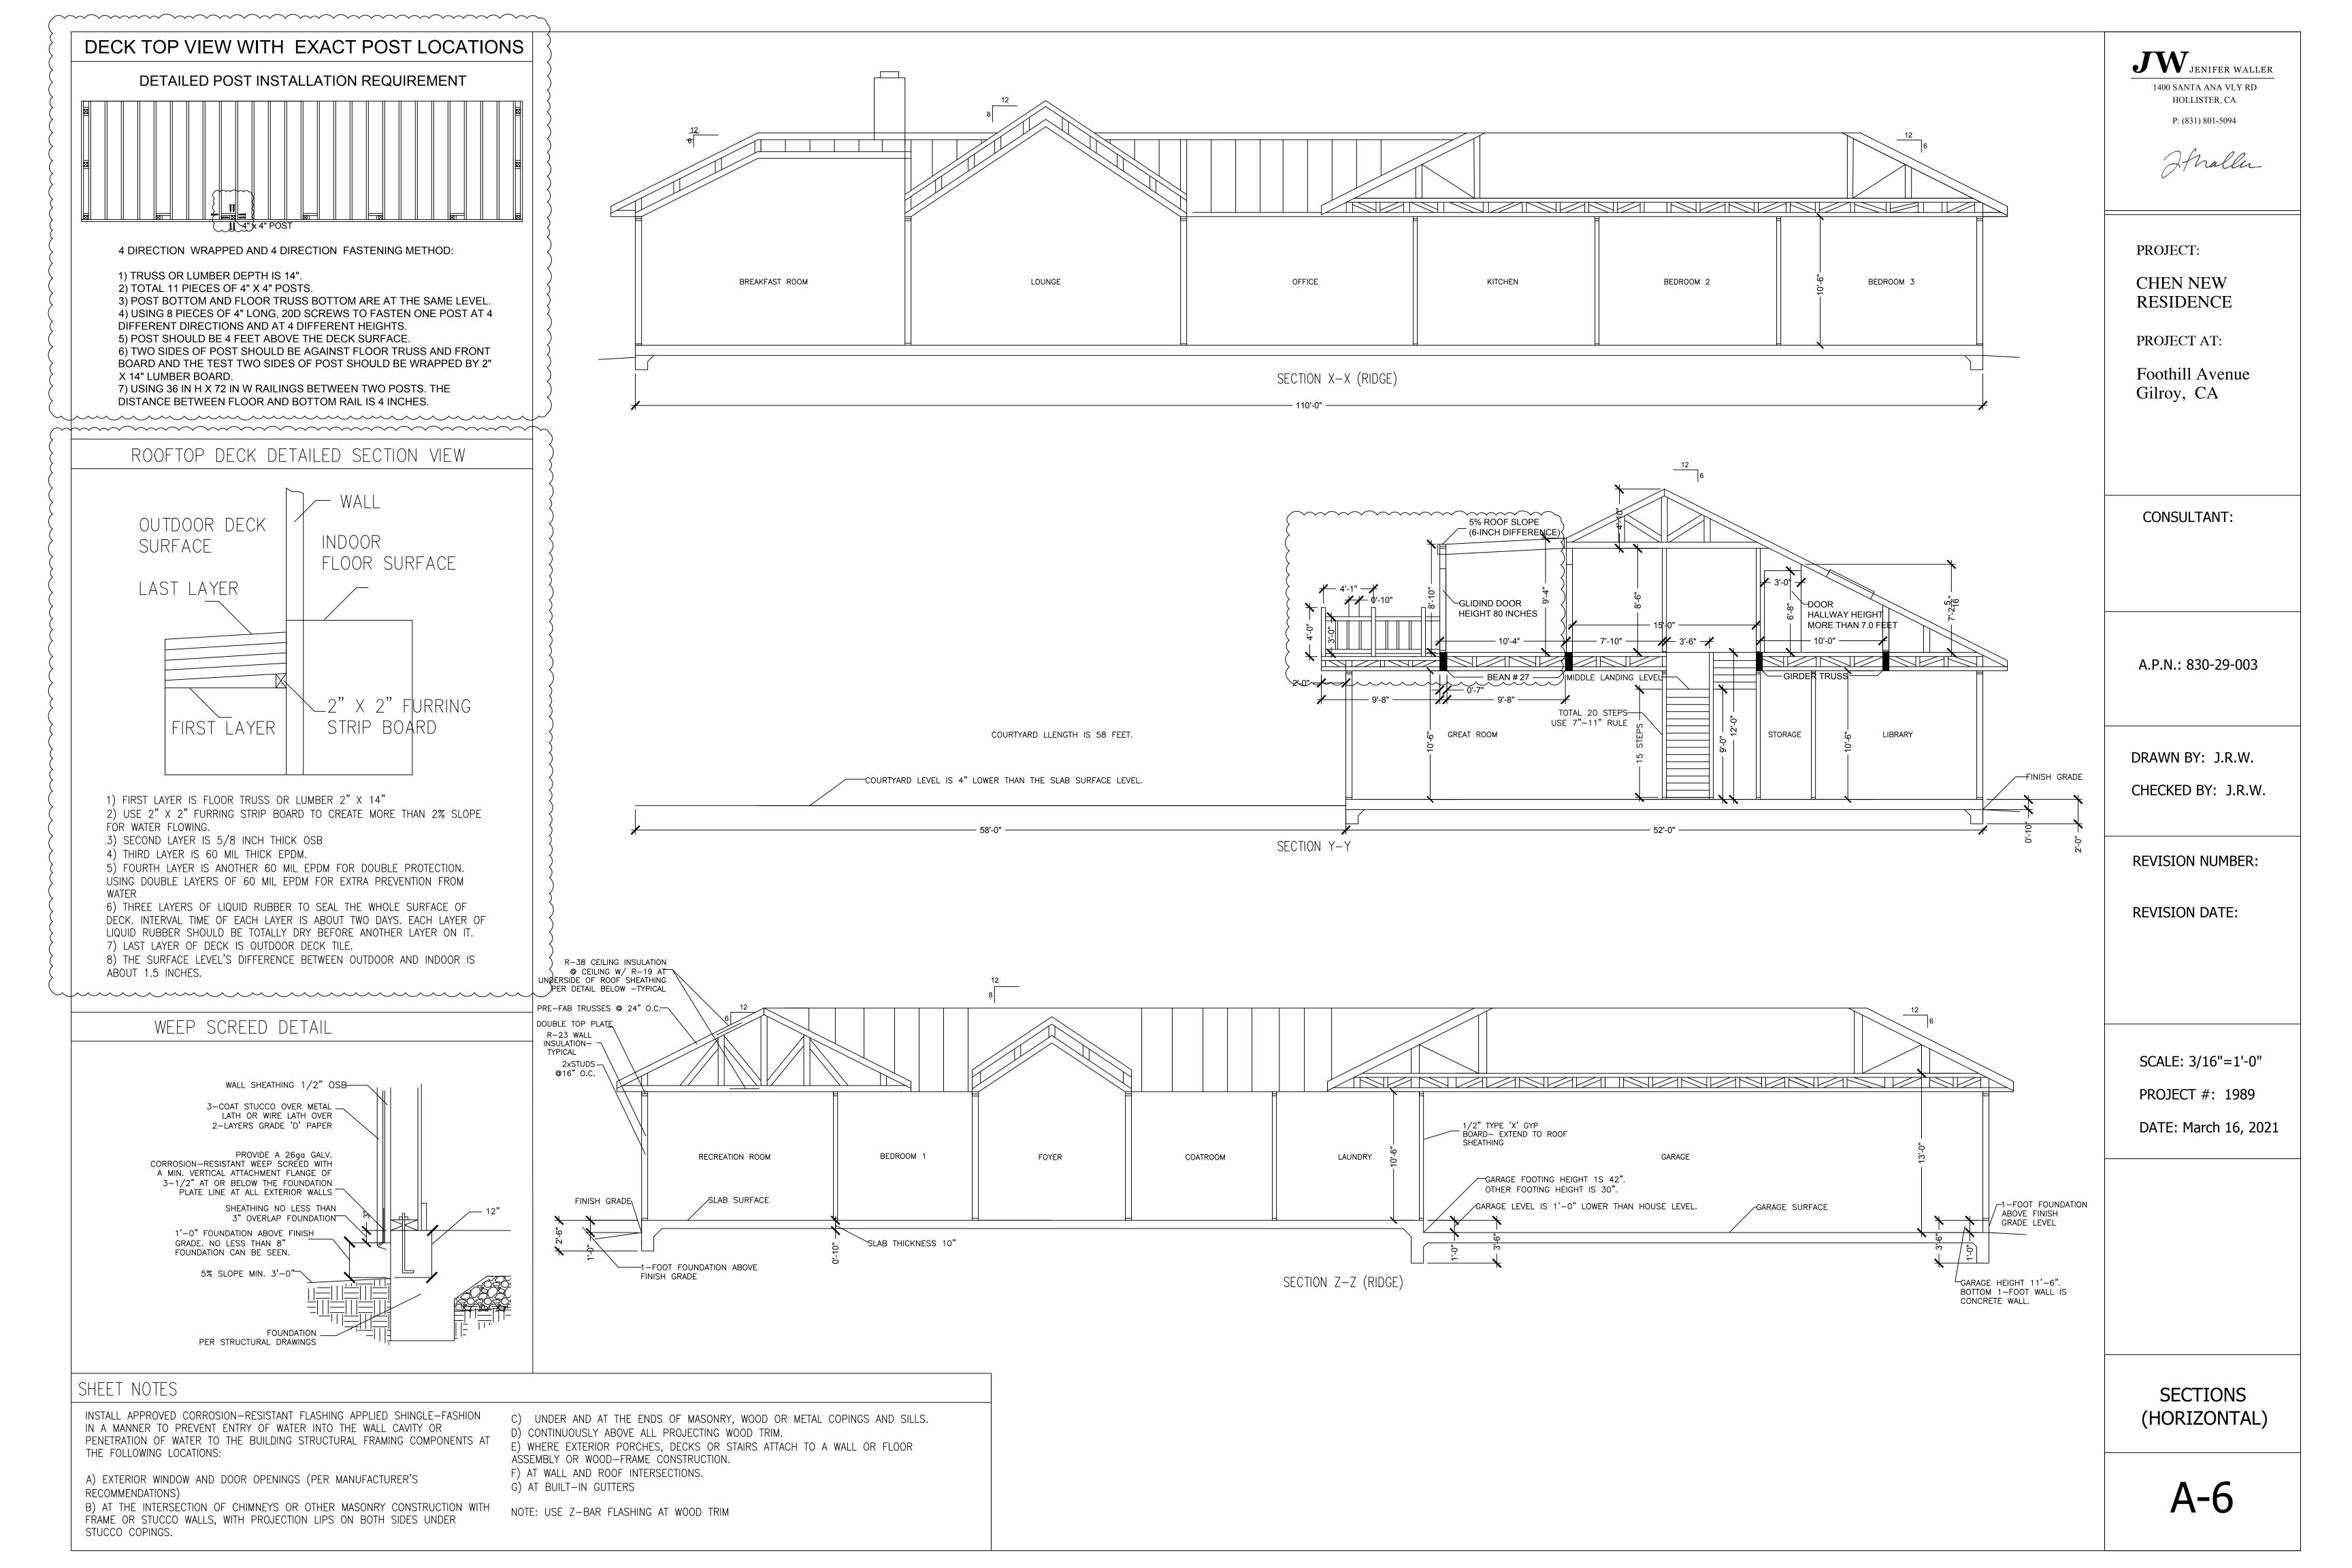
NO. REVISION DATE BY 1. PLANCHECK COMMENTS Jan. 31, 2022 J.R.W. on July 15, 2021
PLANCHECK COMMENTS on July 15, 2021
No.


SCALE: 3/16"=1'-0"

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EXTERIOR ELEVATIONS





SECTION V-V (RIDGE)

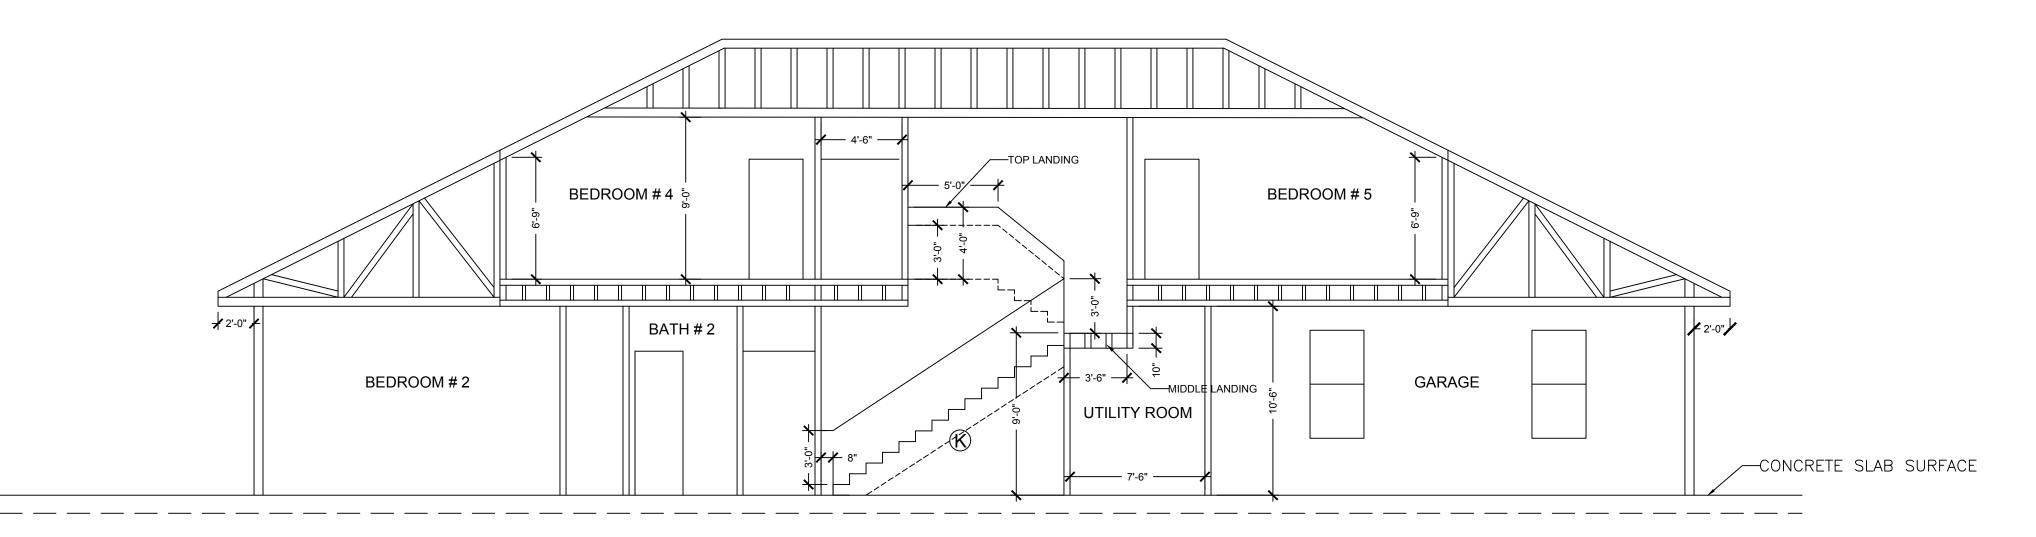STAIRS:

1) WIDTH PER CRC R311.7.1

- 2) TREADS, RISERS, AND PROFILES PER CRC R311.7.5
- 3) LANDINGS PER CRC R311.7.6
- 4) HANDRAILS PER CRC R311.7.8
- 5) GUARDS PER CRC R312.
- HANDRAILS:
- 1) HANDRAIL EXTENDS CONTINUOUSLY FROM A POINT DIRECTLY ABOVE THE TOP RISER TO A POINT DIRECTLY ABOVE THE LOWEST RISER, AND TERMINATE IN NEWEL POSTS OR SAFETY TEMINALS PER CRC R311.7.8.4 2) PROVIDE 1-1/2 INCH SPACE BETWEEN THE WALL AND HANDRAIL PER CRC R311.7.8.3
- 3) HANDRAILS HAVE A 1-1/4 TO 2 INCH GRIPPABLE SCROSS SECTION WITH NO SHARP CORNERS PER CRC R311.7.8.5

(K) KEY NOTES

- STAIRS SPECIFICATIONS:
- 1) STAIR WIDTH IS 3.5 FEET.
- 2) STAIR RISER IS 7-1/8 INCH.
- 3) STAIR RUN IS 11 INCH.
- 4) MIDDLE LANDING AREA: 4.0 FEET X 7.333 FEET.
- 5) TOP LANDING AREA: 4.0 FEET X 3.5 FEET.
- 6) TOP LANDING SIDE WALL HEIGHT IS 4 FEET FOR THE OPEN SIDE OF STAIRWAY.
- 7) HANDRAIL HEIGHT IS 3 FEET. THERE IS 1-1/2 INCH SPACE BETWEEN THE WALL AND HANDRAIL.

1) THE GREATEST RISER HEIGHT WITHIN ANY FLIGHT OF STAIRS SHALL NOT EXCEED THE SMALLEST BY MORE THAN 3/8 INCH PER CRC R311.7.5.1.



SECTION W-W (RIDGE)

JW JENIFER WALLER 1400 SANTA ANA VLY RD HOLLISTER, CA

P: (831) 801-5094

PROJECT:

CHEN NEW RESIDENCE

PROJECT AT:

Foothill Avenue Gilroy, CA

CONSULTANT:

A.P.N.: 830-29-003

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NO.	1.	

SCALE: 3/16"=1'-0"

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SECTIONS (VERTICAL)

NOTES: 1'-6" 🚜 🔏 // // 1'6" INSULATION: ROCKWOOL ITEM #291368 R23 THICKNESS 5.5 WIDTH 15.25 LENGTH 47 FRAME 16" OC ROCKWOOL ITEM #294340 R38 THICKNESS 9.5 WIDTH 23.0 LENGTH 47 FRAME 24" OC 3 ROCKWOOL ITEM #291365 Safe'n'Sound THICKNESS 3 WIDTH 15.25 LENGTH 47 16" OC ROCKWOOK ITEM #292897 Safe'n'Sound THICKNESS 6 WIDTH 15.25 LENGTH 47 16" OC 5 ROCKWOOK ITEM #292908 Safe'n'Sound THICKNESS 6 WIDTH 23 LENGTH 47 24" OC INSULATION MATERIAL SHALL FOLLOW THE FOLLOWING RULES: 1) ALL THE EXTERIOR WALLS: #1 R23. THICKNESS 5.5 INCHES. | Roof Window Roof Window 2) BOTH SIDE WALLS OF LOUNGE AND FOYER: #1 R23. THICKNESS 5.5 INCHES. 2) ALL THE ROOFS: #2 R38 INCLUDING FLAT ROOF. THICKNESS 9.5 INCHES. 3) ALL THE INTERIOR WALLS: #3 SAFE N SOUND PROOFING. THICKNESS 3 INCHES. 4) THE CEILINGS BETWEEN FIRST FLOOR AND ATTIC FLOOR (BETWEEN FLOOR TRUSSES): #4 + #4 = DOUBLE #4 SAFE N SOUND PROOFING. THICKNESS 12 INCHES. 5) THE REST CEILINGS: #5 SAFE N SOUND PROOFING. THICKNESS 6 INCHES. 6) INSULATION MATERIAL USED FOR CATHEDRAL CEILINGS SHALL MEET THE REQUIREMENTS OF CRC R806.5. VAPOR BARRIER NEEDS TO COVER THE INSULATION MATERIAL ON ALL THE EXTERIOR WALLS. RAFTER BAFFLES ARE NEEDED. Roof Window ALL THE INSULATION MATERIAL MENTIONED ABOVE ARE PER TITLE-24 CALCULATIONS. Roof Window DRYWALL: 1) ALL THE INTERIOR WALLS AND CEILINGS USE USG SHEETROCK BRANK 5/8 INCH THICK, FIRECODE X FIRE-RESISTANT GYPSUM BOARD. **∠**8:12 8:12 🔪 EAGLE ROOFING: 4697 STALE RANGE - RANGE OF CHARCOOL THIS CONCRETE ROOF MEETS CATHEDRAL CEILING COOL ROOF REQUIREMENTS IN CALIFORNIA AND OTHER COMPLIANCE PROGRAMS. THE CRRC 0918-0046. extstyle = 1VENTILATION: 1) FOR CATHEDRAL/VAULTED AREAS OF THE ROOF, INSULATION MATERIAL USED IN THIS PROJECT SHALL MEET THE REQUIREMENTS OF CRC R806.5. ALL OTHER CRC R806.5 REQUIREMENTS SHALL BE SATISFIED BY THE INSULATION CONTRACTOR. AIR IMPERMEABLE INSULATION OR OPEN EXTRA VENTS POSSIBLE. 2) UPPER ROOF VENTILATORS SHALL BE LOCATED NOT MORE THAN 3 FEET BELOW THE RIDGE OR HIGHEST POINT OF THE SPACE, MEASURED VERTICALLY. VENT / VENT / 3) NOT LESS THAN 40 PERCENT AND NOT MORE THAN 50 PERCENT OF THE REQUIRED CATHEDRAL CEILING VENTILATING AREA SHALL BE PROVIDED BY VENTILATORS LOCATED IN THE UPPER PORTION OF THE ATTIC OR RAFTER SPACE. SHEATHING: **∕**8:12 8:12 🔪 1) ALL THE EXTERIOR WALLS USE: ADVANTECH ROOF/WALL SHEATHING, 5/8 INCHES, SPECIFICATION: 5/8" X 4' X 8' 2) ALL THE ROOFS USE: ADVANTECH ROOF/WALL SHEATHING, 5/8 INCHES, SPECIFICATION: 5/8" X 4' X 8' SUBFLOOR: 1) BOTH MAIN FLOOR AND ATTIC FLOOR USE: ADVANTECH SUBFLORRING, FLOOR PANEL SPECIFICATION: 23/32" X 4' X 8' WITH TONGUE AND GROVE SUBFLOOR UNDERLAYMENT: 1) 6 MIL VAPOR BARRIER SHALL COVER THE CONCRETE SLAB BEFORE INSTALL SUBFLOOR. 6 INCHES OVERLAP IS REQUIRED. HARDWOOD FLOOR: 1) DETAILED SPECIFICATIONS SHALL BE CONFIRMED WITH OWNER BEFORE PURCHASING. HARDWOOD FLOOR UNDERLAYMENT: 1) CORK UNDERLAYMENT IS REQUIRED BETWEEN HARDWOOD FLOOR AND SUBFLOOR. SPECIFICATION: 48 IN X 50 FT X 1/4 IN THICH NATURAL CORK UNDERLAYMENT ROLL. PV SYSTEMS: 1) TESLA SOLAR PANEL 7.2 KW SYSTEMS: 20 SOLAR PANELS. 2) AZIMUTH OF THE SYSTEM FACE SHALL MEET CF1R ASSUMPTION. **SOLAR PANEL** SYSTEM AREA 8:12 8:12 VENT | CATHEDRAL CEILING VENT VENT VENT \ VENT VENT \ \square **FOYER**

CATHEDRAL CEILING

PORCH

1'-6"

1'-6"

JW JENIFER WALLER

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Roof Window

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ROOF PLAN