GENERAL NOTES & CONDITIONS

- THE BUILDING PLANS PREPARED BY GHY CONSULTING ENGINEERS, INC. .THE DESIGNER. ARE INTENDED FOR USE ONLY ON THE PROPERTY FOR WHICH THEY WERE DESIGNED AND SHALL REMAIN THE PROPERTY OF GHY CONSULTING ENGINEERS. THE BUILDING PLANS ARE NOT INTENDED TO BE COMPREHENSIVE AND IT SHALL BE THE RESPONSIBILITY OF THE GENERAL CONTRACTOR AND SUBCONTRACTORS TO NOTIFY THE OWNER AND / OR THE DESIGNER OR ANY NECESSARY CLARIFICATIONS OR MODIFICATIONS.
- ALL INFORMATION PERTAINING TO THE SITE SHALL REMAIN THE OWNERS RESPONSIBILITY SITE INFORMATION SHALL INCLUDE LEGAL DESCRIPTION, DEED RESTRICTIONS, EASEMENTS, SITE SURVEYS, STREET AND UTILITY IMPROVEMENTS. GEOTECHNICAL INVESTIGATIONS AND REPORTS, GRADING AND EXCAVATION, LANDSCAPING, DRAINAGE, AND
- THE OWNER SHALL BE RESPONSIBLE FOR NOTIFYING THE DESIGNER AND/OR ENGINEER FOR ANY UNUSUAL OR UNFORESEEN STRUCTURAL CONDITIONS. DISCREPANCIES OR OMISSIONS WITHIN THE CONSTRUCTION DOCUMENTS OR ANY DEVIATIONS OR CHANGES FROM THE DOCUMENTS BEFORE PROCEEDING WITH THE WORK INVOLVED; OTHERWISE THEY WILL BE CONSIDERED ADEQUATE FOR PROPER COMPLETION OF THE PROJECT.
- THE GENERAL CONTRACTOR AND EACH SUPERVISOR SHALL BE RESPONSIBLE FOR CHECKING AND VERIFYING ALL DIMENSIONS AND MEASUREMENTS PRIOR TO COMMENCEMENT OF ANY WORK. CONTRACTOR SHALL BRING ANY DISCREPANCIES TO THE DESIGNER AND OWNER'S ATTENTION PRIOR TO COMMENCING ANY WORK. IN THE EVENT WORK COMMENCED WITH FAILURE TO NOTIFY BOTH THE DESIGNER AND OWNER. THE CONTRACTOR IS SOLELY RESPONSIBLE FOR ANY AND ALL, CORRECTIVE MEASURES OR ERRORS.
- THE GENERAL CONTRACTOR SHALL HOLD HARMLESS, INDEMNIFY AND DEFEND THE DESIGNER AND ENGINEER FROM ANY ACTION INITIATED BY THE INITIAL OWNER OR ANY SUBSEQUENT OWNERS FOR CONSTRUCTION DEFICIENCIES. MODIFICATIONS OR SUCH CONDITIONS WHICH MAYBE BEYOND THE CONTROL OF THE DESIGNER OR ENGINEER.
- THESE DOCUMENTS ARE INTENDED FOR USE IN NEGOTIATED CONSTRUCTION CONTRACT AND, THEREFORE, MAY NOT SPECIFICALLY DETAIL OR SPECIFY MATERIALS AND / OR MANUFACTURERS. THE GENERAL CONTRACTOR SHALL PROVIDE ALL SAMPLES AS REQUIRED. TO ASSIST THE OWNER IN MAKING MATERIAL OR EQUIPMENT SELECTIONS OR COMPARISON. FOR THE PURPOSE OF ESTIMATING, THE GENERAL CONTRACTOR SHALL USE MATERIALS SELECTED BY THE OWNER. OR IN THE ABSENCE OF OWNER, HE SHALL PROVIDE AN ALLOWANCE AMOUNT. AND SO CONDITION ANY COST ESTIMATE. ALL MATERIALS SPECIFIED IN THESE DOCUMENTS SHALL BE INCLUDED IN ANY ESTIMATES.
- THE GENERAL CONTRACTOR SHALL REVIEW AND RECORD ALL EXISTING CONDITIONS. INCLUDING PAVED AREAS. HE SHALL MAKE KNOWN ALL EXISTING DAMAGED OR DISREPAIRED ITEMS AND CONDITIONS THAT MAY WORSEN DUE TO THE PROPOSED CONSTRUCTION. ALL EXISTING ITEMS AND CONDITIONS IN GOOD CONDITION SHALL BE MAINTAINED IN THEIR PRESENT CONDITION AND ANY REPAIR OR DAMAGE WHICH OCCURS DURING CONSTRUCTION SHALL BE THE RESPONSIBILITY OF THE GENERAL CONTRACTOR.
- 8. THE CONSTRUCTION DOCUMENTS SHALL NOT BE CONSIDERED COMPLETE AND READY FOR CONSTRUCTION UNTIL A BUILDING PERMIT HAS BEEN ISSUED.
- EXAMINATION OF SITE: THE GENERAL CONTRACTOR SHALL THOROUGHLY EXAMINE THE SITE AND SATISFY HIMSELF AS TO THE CONDITION UNDER WHICH THE THESE SITE. ALL MEASUREMENTS AFFECTING HIS WORK AND SHALL BE RESPONSIBLE FOR CORRECTNESS OF SAME. NO EXTRA COMPENSATION WILL BE ALLOWED TO THE CONTRACTOR FOR ANY EXPENSES DUE TO NEGLECT TO EXAMINE OR FAILURE TO DISCOVER CONDITIONS WHICH MAY AFFECT HIS WORK.
- 10. EXAMINATION OF EXISTING PLUMBING AND ELECTRICAL; IN ANY CASE WHERE A NEW LINE MAY TIE INTO AN EXISTING LINE WITHIN THE LIMITS OF THE RENOVATION WORK. THE GENERAL CONTRACTOR OR HIS SUBCONTRACTOR SHALL EXAMINE THE ENTIRE EXISTING LINE. AND DETERMINE WHETHER THE NEW WORK WILL ADVERSELY BE AFFECTED BY IT. AND NOTIFY THE OWNER AND THE DESIGNER OF ANY SUCH DEFECT BEFORE COMMENCING WORK.

Cully PI Crumbl - Camder Takeout • Delivery	The Home Depot Con Union
Camden Ave	Hillsd
Union Ave	Weeth Dr. Weeth
Cambrian Park	Oster Elementary School

VICINITY MAP

CALL 8II BEFORE YOU DIG

APPLICABLE CODES AND REGULATIONS: 2022 CALIFORNIA BUILDING CODE 2022 CALIFORNIA RESIDENTIAL CODE 2022 CALIFORNIA MECHANICAL CODE 2022 CALIFORNIA PLUMBING CODE 2022 CALIFORNIA ELECTRIC CODE

2022 CALIFORNIA FIRE CODE 2022 CALIFORNIA ENERGY CODE 2022 CALIFORNIA GREEN BUILDING STANDARDS CODE

SANTA CLARA COUNTY MUNICIPAL CODE

PROJECT DATA

ADDRESS: 14361 Lenray Ln. San Jose, CA 95124

APN: 419-11-003

SCOPE OF WORK: I. ROOM ADDITION ON FIRST FLOOR TO CREATE A BEDROOM, BATHROOM, KITCHEN AND FAMILY ROOM.

2. ROOM ADDITION ON SECOND FLOOR TO CREATE 2 BEDROOMS AND 2 BATHROOMS. 3. ADD NEW ENTRY PORCH.

4. UPGRADE ELECTRICAL PANEL TO 400 AMP. 5. DEMO (E) 2-CAR GARAGE ATTACHED TO WORKSHOP. 6. ADD NEW 2-CAR GARAGE IN FRONT OF HOUSE.

Owner:	Phone:		Email:				
SHU-WEI HSU & HUEI-CHING LU 14361 Lenray Ln, San Jose, CA 95124		(530) 601-3858		fantaisie1982@gmail.com			
Zoning District: R1-20-n5 Land Use: Low Density	Gross Lot Area: 10863 sq. ft.		Occupancy Gro R3 & U		Type of Construct V-B	ction:	
Residential (1-5 DU/AC)	Lot Width:	65.35', 92.35'	Lot [Depth:	132.65', 151.07'		
	PTION OF PROJEC REMODEL. SEE SC	N OF PROJECT: IODEL. SEE SCOPE OF WORK.		(Fire Sprinkler		r (Yes or No ?) YES	
	DE\	VELOPMENT ST	ANDARDS		- (_)/ (_) (
STANDARD	EXIS	STING	CODE REQUI	REMENT	PROP	OSED	
SETBACKS:	SANT	TA CLARA COUN	ITY ZONING OR	DINANCE, CHAP	PTER 2.30.030, 3.4	TER 2.30.030, 3.40.070	
	FIRST FLOOR	SECOND FLOOR	FIRST FLOOR	SECOND FLOOR	FIRST FLOOR	SECOND FLOOR	
FRONT	31.0'	N/A	30'	30'	31.0'	41.5'	
REAR	82.0'	N/A	25'	25'	52.8'	71.8'	
SIDE (LEFT)	8.47'	N/A	8'	8'	8.25'	9.0'	
SIDE (RIGHT)	26.20'	N/A	8'	8'	8.2' GARAGE	25.5'	
TOTAL COMBINED SIDE	n/a	N/A	n/a	n/a	n/a	n/a	
GARAGE/PARKING:		SANTA CLARA C	COUNTY ZONING	G ORDINANCE, (CHAPTER 4.30.07	0	
# OF PARKING SPACES		2		2	2		
INTERIOR GARAGE DIMENSIONS	19'-2"	19'-2" x 19'-3"		'x18'	18'-5" x 20'-0"		
HEIGHT:		SANTA CLARA COUNTY ZONING ORDINANCE, CHAPTER 2.30.030					
MAIN BUILDING HEIGHT	14	14.5'		5.0'	22.5'		
ENTRY FEATURE HEIGHT	8	3.0'	n/a		13.8'		
LOT COVERAGE:		SEE DI	AGRAM SHEET	A4.0 - CHAPTER	2.30.030		
TOTAL LOT COVERAGE	<<	50%	r	n/a		41.0%	
FLOOR AREA RATIO	<<	<< 45%		n/a 32.9%		9%	
FLOOR AREA CALCS	EXISTING	(E) TO BE REMOVED		PROPOSED	SUBTOTAL		
FIRST FLOOR LIVING AREA (EXCLUDING GARAGE)	1,181 S.F.	0		1,002 S.F.	2,183 S.F.		
SECOND FLOOR	0	0 0		986 S.F.	986 S.F.		
TOTAL FLOOR AREA				1,988 S.F.	3,169 S.F.		
(E) GARAGE	407 S.F.	407 S.F407		0 S.F.	0 S.F.		
NEW GARAGE	0 S.F.	0 S.F. 0		394 S.F.	S.F. 394 S.F.		
(E) ENTRY PORCH	106 S.F.	106 S.F106		0 S.F. 0 S.F.		.F.	
NEW ENTRY PORCH	0 S.F.	0.5	S.F.	105 S.F.	105	S.F.	
WORKSHOP	742 S.F.	0 9	S.F.	0 S.F.	742 S.F.		
TOTAL LOT COVERAGE	2.426.6.5	N 1/A		NI/A	2.044.0.5		

LIST OF DRAWINGS

TOTAL LOT COVERAGE

AI.O: SITE PLAN & GENERAL NOTES

2,436 S.F.

AI.I: CLEAN BAY BLUEPRINT

A2.0: EXISTING & DEMO FLOOR PLAN

A3.0: PROPOSED FIRST FLOOR PLAN

A3.1: PROPOSED SECOND FLOOR PLAN

A4.0: FLOOR AREA DIAGRAM

A5.0: ROOF PLAN

A6.0: EXISTING EXTERIOR ELEVATIONS

A6.1: EXISTING EXTERIOR ELEVATIONS

A6.2: PROPOSED EXTERIOR ELEVATIONS-I

A6.3: PROPOSED EXTERIOR ELEVATIONS-2

A6.4: SECTIONS & DETAILS

BI.O: BOUNDARY & TOPO SURVEY PLAN

EI.O: IST FLOOR ELECTRICAL PLAN & NOTES

EI.I: 2ND FLOOR ELECTRICAL PLAN & NOTES

S-0: STRUCTURAL NOTES

S-I: FOUNDATION PLAN

S-2: FLOOR & CEILING FRAMING PLAN

S-3: LOWER ROOF FRAMING PLAN

S-4: 2ND FLOOR ROOF FRAMING PLAN

S-5: STRUCTURAL DETAILS-I

S-6: STRUCTURAL DETAILS-2

S-7: STRONG WALL DETAILS-I S-8: STRONG WALL DETAILS-2

T-I: TITLE 24 COMPLIANCE-I

T-2: TITLE 24 COMPLIANCE-2


T-3: TITLE 24 COMPLIANCE-3

CG-I: CALGREEN MANDATORY REQUIREMENTS

CG-2: CALGREEN MANDATORY REQUIREMENTS ES-I: EROSION CONTROL PLAN

BMP-1: LEROSION-CONTROL-DETAILS-1

BMP-2: EROSION CONTROL DETAILS-2

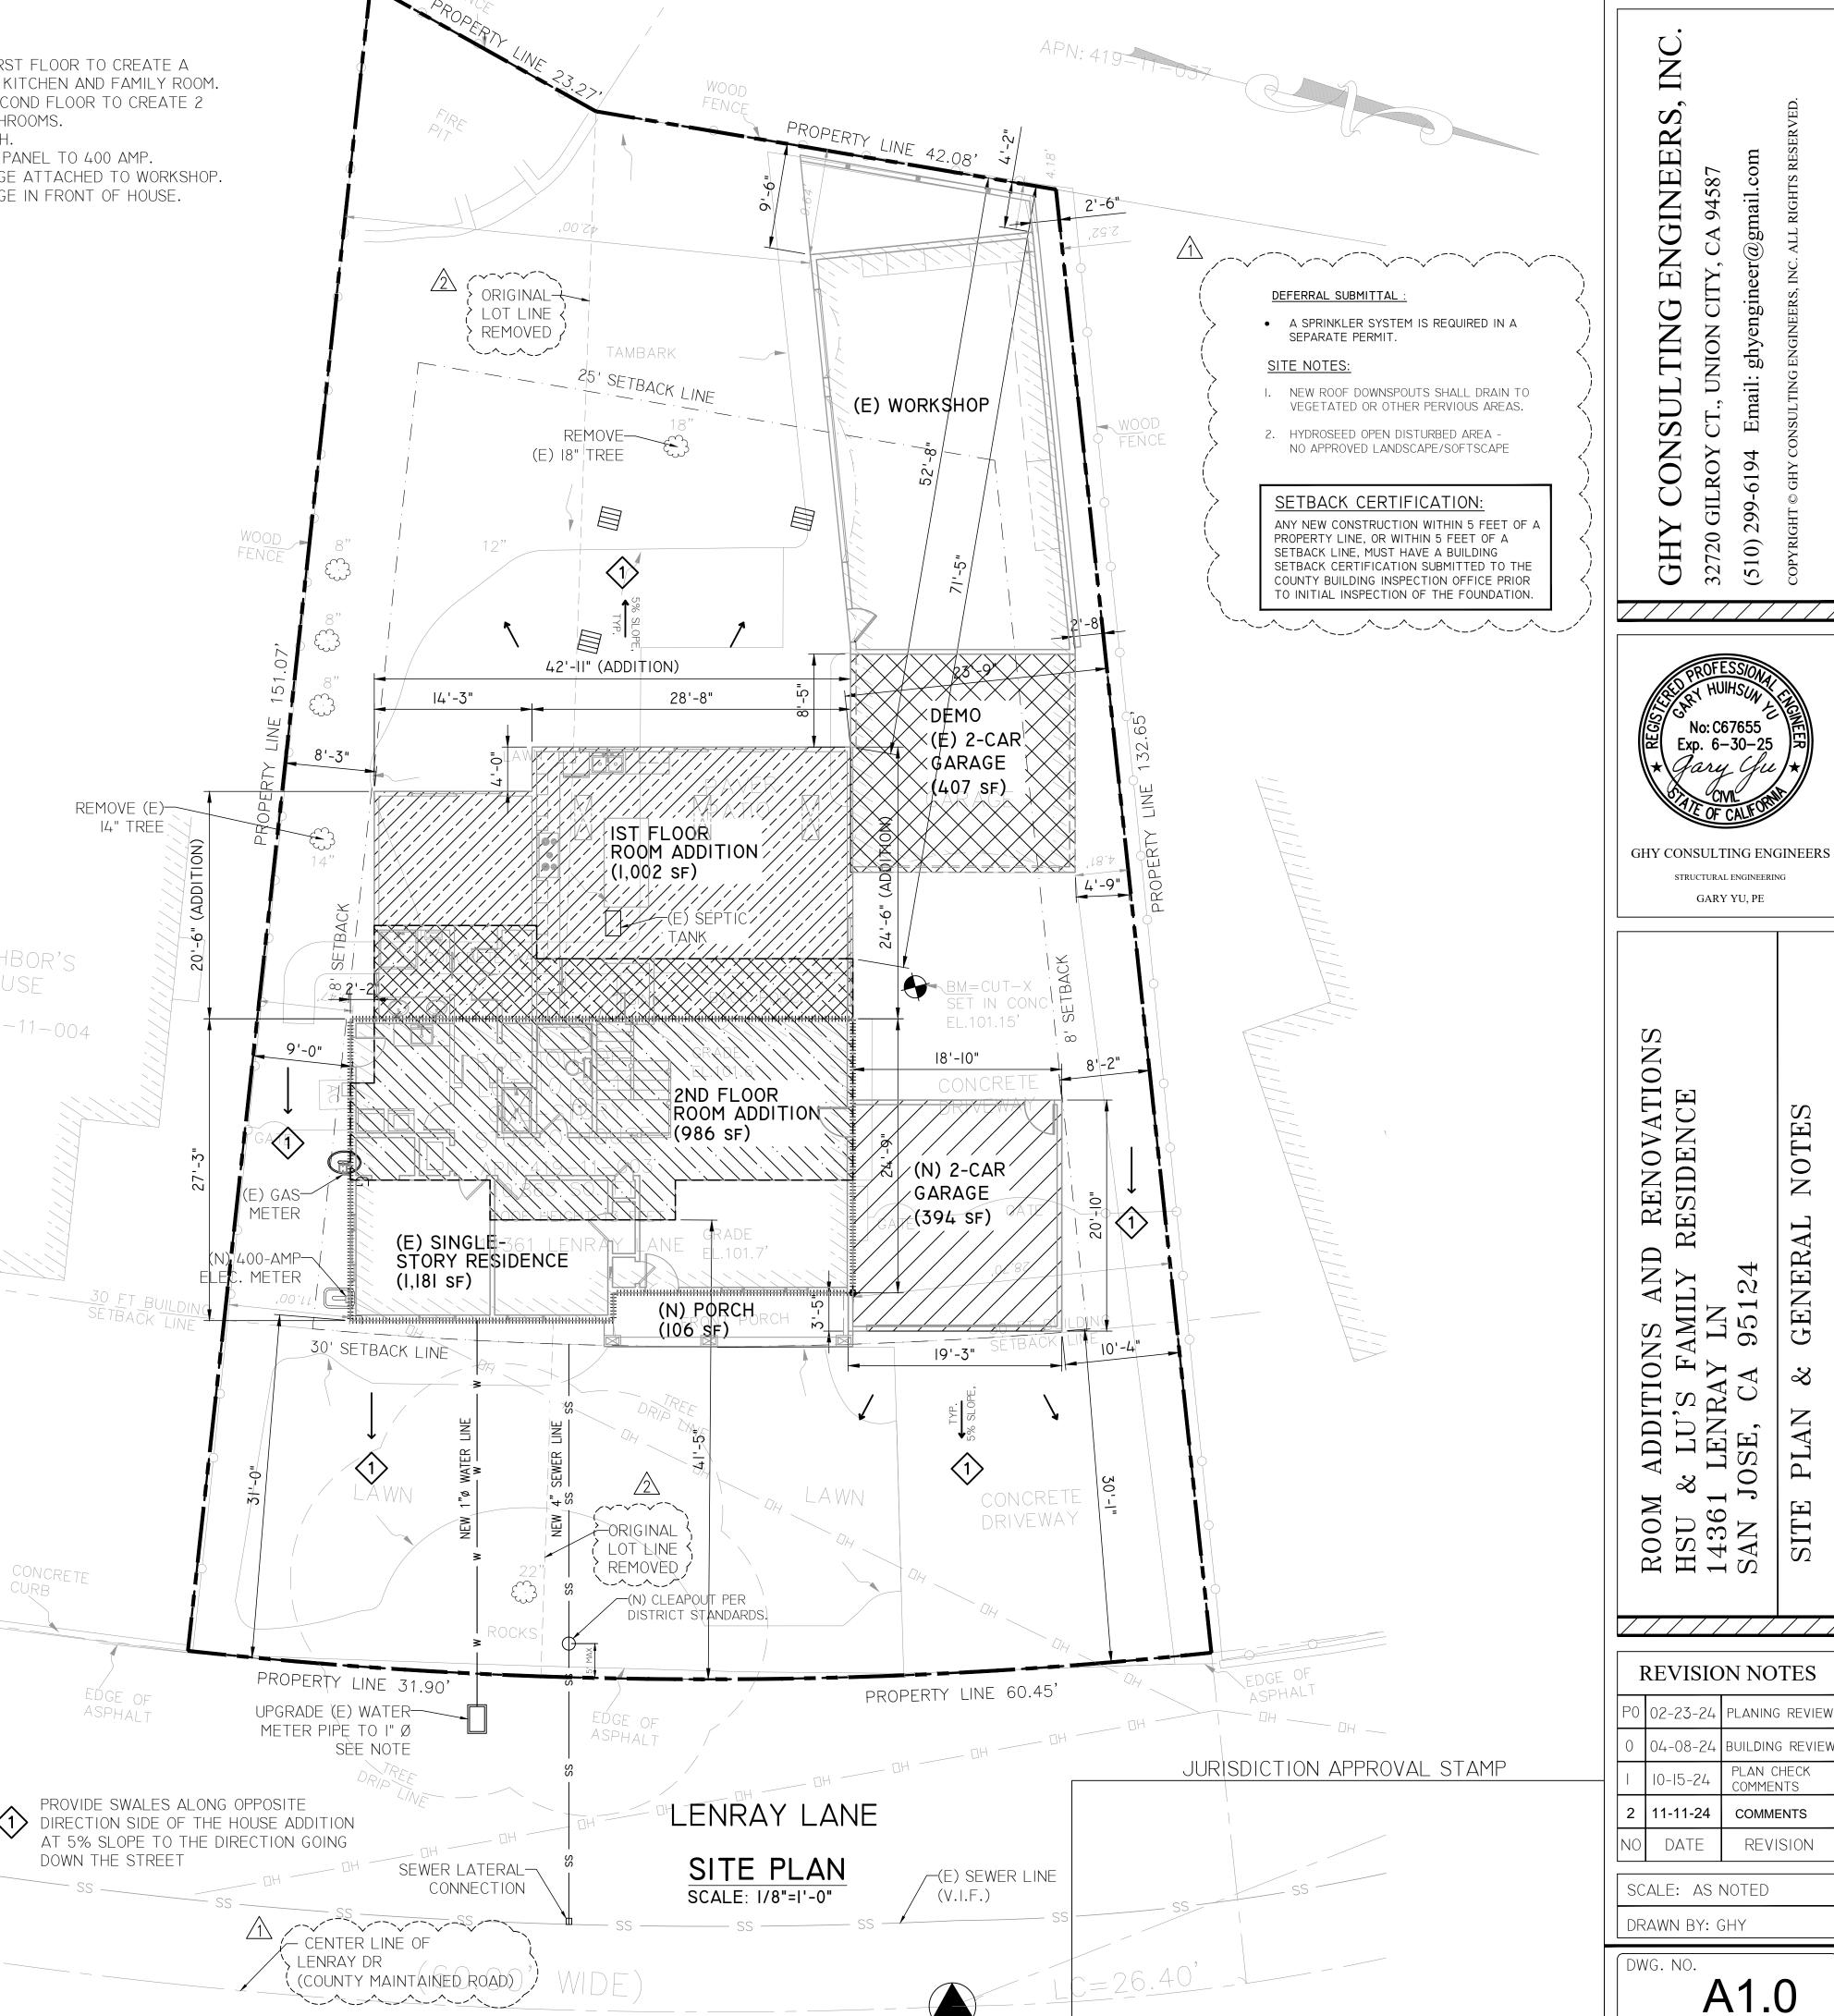

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PLAN CHECK

COMMENTS

COMMENTS


REVISION

Clean Bay Blue Print

Francisco Bay. Construction activities can directly affect the health of creeks and the Bay unless contractors

and crews plan ahead to keep dirt, debris, and other construction waste away from storm drains and local

creeks. Following these guidelines and the project specifications will ensure your compliance with City of

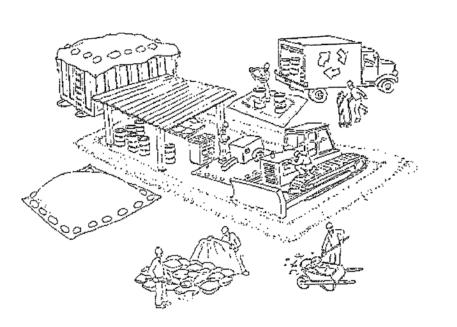

Materials storage & spill cleanup

Non-hazardous materials management

- ✓ Sand, dirt, and similar materials must be stored at least 10 feet (3 meters) from catch basins. All construction material must be covered with a tarp and contained with a perimeter control during wet weather or when rain is forecasted or when not actively being used within 14 days.
- Use (but don't overuse) reclaimed water for dust control as needed.
- ✓ Sweep or vacuum streets and other paved areas daily. Do not wash down streets or work areas with water!
- Recycle all asphalt, concrete, and aggregate base material from demolition activities. Comply with **City of Fremont** Ordinances for recycling construction materials, wood, gyp board, pipe, etc.
- ✓ Check dumpsters regularly for leaks and to make sure they are not overfilled. Repair or replace leaking dumpsters promptly.
- Cover all dumpsters with a tarp at the end of every work day or during wet weather.

Hazardous materials management

- Label all hazardous materials and hazardous wastes (such as pesticides, paints, thinners, solvents, fuel, oil, and antifreeze) in accordance with city, county, state, and federal regulations.
- ✓ Store hazardous materials and wastes in water tight containers, store in appropriate secondary containment, and cover them at the end of every work day or during wet weather or when rain is forecasted.
- ✓ Follow manufacturer's application instructions for hazardous materials and be careful not to use more than necessary. Do not apply chemicals outdoors when rain is forecasted within 24 hours.
- ✓ Be sure to arrange for appropriate disposal of all hazardous wastes.

Spill prevention and control

- ✓ Keep a stockpile of spill cleanup materials (rags, absorbents, etc.) available at the construction site at all times.
- ✓ When spills or leaks occur, contain them immediately and be particularly careful to prevent leaks and spills from reaching the gutter, street, or storm drain. Never wash spilled material into a gutter, street, storm drain, or creek!
- Dispose of all containment and cleanup materials properly.
- Report any hazardous materials spills immediately! Dial 911

Construction Entrances and Perimeter

- Establish and maintain effective perimeter controls and stabilize all construction entrances and exits to sufficiently control erosion and sediment discharges from site and tracking off site.
- ✓ Sweep or vacuum any street tracking immediately and secure sediment source to prevent further tracking.

Vehicle and equipment

maintenance & cleaning

Fremont requirements.

- Inspect vehicles and equipment for leaks
- frequently. Use drip pans to catch leaks until repairs are made; repair leaks promptly.
- ✓ Fuel and maintain vehicles on site only in a bermed area or over a drip pan that

is big enough to prevent runoff.

- ✓ If you must clean vehicles or equipment on site, clean with water only in a bermed area that will not allow
- rinse water to run into gutters, streets, storm drains, or creeks. ✓ Do not clean vehicles or equipment

steam cleaning equipment, etc.

on-site using soaps, solvents, degreasers,



Earthwork & contaminated soils

- Keep excavated soil on the site where it will not collect in the street.
- ✓ Transfer to dump trucks should take place on the site, not in the street.
- ✓ Use fiber rolls, silt fences, or other control measures to minimize the flow of silt off the site.



- ✓ Earth moving activities are only allowed during dry weather by permit and as approved by the City Inspector in the Field.
- ✓ Mature vegetation is the best form of erosion control. Minimize disturbance to existing vegetation whenever possible. ✓ If you disturb a slope during construction, prevent erosion by securing the soil with
- erosion control fabric, or seed with fastgrowing grasses as soon as possible. Place fiber rolls down-slope until soil is secure.
- ✓ If you suspect contamination (from site history, discoloration, odor, texture, abandoned underground tanks or pipes, or buried debris), call the Engineer for help in determining what should be done, and manage disposal of entaminated soil according to their instructions.

Dewatering operations

- ✓ Effectively manage all run-on, all runoff within the site, and all runoff that discharges from the site. Run-on from off site shall be directed away from all disturbed areas or shall collectively be in compliance.
- ✓ Reuse water for dust control, irrigation, or another on-site purpose to the greatest extent possible.
- ▶ Be sure to notify and obtain approval from the Engineer before discharging water to a street, gutter, or storm drain. Filtration or diversion through a basin, tank, or sediment trap may be required
- ✓ In areas of known contamination, testing is required prior to reuse or discharge of groundwater. Consult with the Engineer to determine what testing is required and how to interpret results. Contaminated groundwater must be treated or hauled off-site for proper disposal.

Saw cutting

- ✓ Always completely cover or barricade storm drain inlets when saw cutting. Use
- filter fabric, catch basin inlet filters, or sand/gravel bags to keep slurry out of the storm drain system.
- ✓ Shovel, absorb, or vacuum saw-cut slurry and pick up all waste as soon as you are finished in one location or at the end of each work day (whichever is sooner!).
- ✓ If saw cut slurry enters a catch basin, clean it up immediately.

Paving/asphalt work



- ✓ Always cover storm drain inlets and manholes when paving or applying seal coat, tack coat, slurry seal, or fog seal.
- ✓ Protect gutters, ditches, and drainage courses with sand/gravel bags, or earthen berms. ✓ Do not sweep or wash down excess sand from sand sealing into gutters, storm drains,
- or creeks. Collect sand and return it to the stockpile, or dispose of it as trash. ✓ Do not use water to wash down fresh asphalt
- concrete pavement.

Concrete, grout, and mortar storage & waste disposal

- ✓ Store concrete, grout, and mortar under cover, on pallets, and away from drainage areas. These materials must never reach a storm drain.
- ✓ Wash out concrete equipment/trucks off-site or into contained washout areas that will not allow discharge of wash water onto the underlying soil or onto the surrounding areas.



✓ Collect the wash water from washing exposed aggregate concrete and remove it for appropriate disposal off site.

Painting

- ✓ Never rinse paint brushes or materials in a gutter or street!
- ✓ Paint out excess water-based paint before rinsing brushes, rollers, or containers in a sink.
- ▶ Paint out excess oil-based paint before cleaning brushes in thinner. Filter paint thinners and solvents for reuse whenever possible.
- Dispose of oil-based paint sludge and unusable thinner as hazardous waste.

Landscape Materials

- ✓ Contain, cover, and store on pallets all stockpiled landscape materials (mulch, compost, fertilizers, etc.) during wet weather or when rain is forecasted or when not actively being used within 14 days.
- ✓ Discontinue the application of any erodible landscape material within 2 days of forecasted rain and during wet weather.

For references and more detailed information: www.cleanwaterprogram.org www.cabmphandbooks.com

JURISDICTION APPROVAL STAMP

0 03-22-24 BUILDING REVIEW DATE REVISION

REVISION NOTES

PO 02-23-24 PLANING REVIEW

ROOM HSU 8 14361 SAN J

CONSULTING ENGINEERS

CITY

(510)

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GHY CONSULTING ENGINEERS

STRUCTURAL ENGINEERING

GARY YU, PE

O RENOVATION RESIDENCE

SCALE: AS NOTED DRAWN BY: GHY

DWG. NO. A-1.1



Storm drain polluters may be liable for fines of \$10,000 or more per day!


Santa Clara County REBUILD Threshold ^a

Existing Residence Wall Modifications b c d


Total Lineal footage of all existing legally established	Total Lineal footage of all walls proposed to be demolished	Total Lineal footage of walls to remain (R)	% Demolished = D/E (If this is over 50%, then project
exterior and interior walls (E)	(D) ^e	wans to remain (it)	will be classified as a "REBUILD")
268.5	29.6	238.9	11%

Footnotes:

- a See County Ordinance # NS-1100.136
- b Lineal Feet measured to outside face or end of wall. Lengths of intersecting walls at corners may not be double counted.
- c All legally established interior & exterior walls including framed openings (doors & windows).
- d The project will be classified as a "REBUILD" if the % Demolished exceeds 50%.
- e A Demolished wall is a wall where the sill plate, studs, and double top plates have been removed or disconnected from adjacent roof/floor framing.
- New framed openings in the wall, such as doors or windows, are not considered a demolished wall.

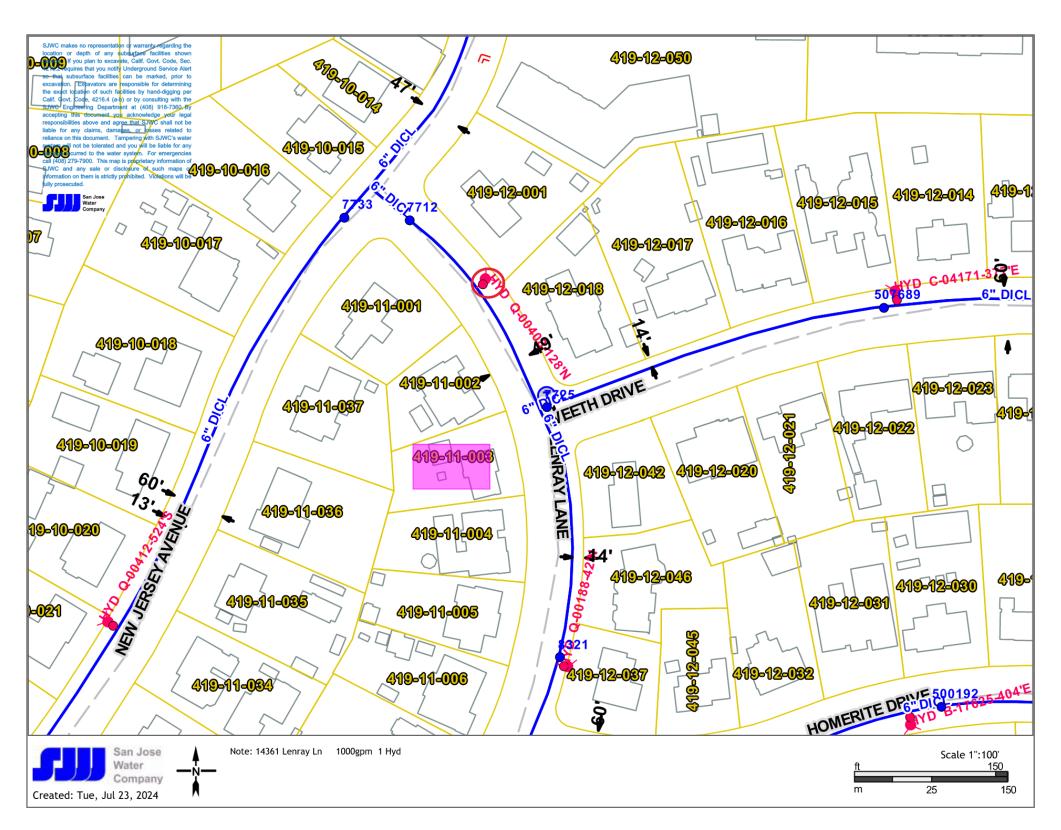

FIRE HAYDRANT MAP

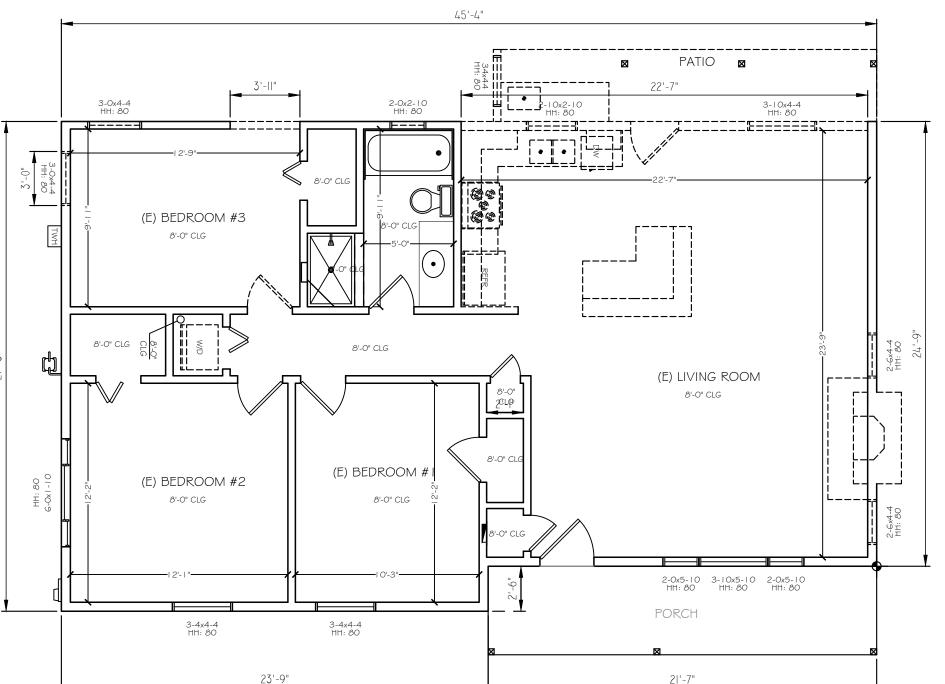

EXISTING & DEMO FLOOR PLAN

SCALE: 3/16" = 1'-0"

LEGENDS:

: INDICATES EXIST. WALL

: INDICATES NEW 2X4 STUD WALL

: INDICATES NEW 2X6 STUD WALL

: INDICATES NEW WALL

=== : INDICATES (E) WALL TO BE REMOVED

E⊟∃ : INDICATES (E) WINDOW TO BE REMOVED

HH:80 : HEADER HEIGHT: 80"

6046
(E) WINDOW W/SIZE INDICATION: 6'-0"W x 4'-6"H

3-I0X4-I0 (E) WINDOW W/SIZE INDICATION: 3'-I0"W x 4'-I0"H

JURISDICTION APPROVAL STAMP

L<u>L</u> 2468)

(E)WORKSHOP TO REMAIN

DEMO (E) GARAGE

DOOR W/SIZE INDICATION: 2'-4"W x 6'-8"H

No: C67655
Exp. 6-30-25

AGRICULTURE OF CALFORNIA

GHY CONSULTING ENGINEERS

CONSULTING ENGINEERS

STRUCTURAL ENGINEERING

GARY YU, PE

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D RENOVATION RESIDENCE

124) FLOOR PLAN

JOSE, CA 95124 STING & DEMO FL

REVISION NOTES

PO 02-23-24 PLANING REVIEW

0 04-08-24 BUILDING REVIEW
1 08-15-24 PLAN CHECK COMMENTS

REVISION

SCALE: AS NOTED

DRAWN BY: GHY

DATE

DWG. NO.

PROPOSED FIRST FLOOR PLAN

SCALE: 1/4"=1'-0"

INDICATES NEW 2X6 STUD WALL

DOOR W/SIZE INDICATION: 2'-4"W x 6'-8"H

SINGLE HUNG WINDOW

: SLIDING DOOR

: INDICATES & THK. TYPE X GYP. BD. FIRE-RESISTANCE WALL. EXTEND FROM FOOTING TO THE UNDERSIDE OF ROOF SHEATHING. SEE SECTIONS FOR WALL ASSEMBLY DETAILS.

TO HAVE A SMOOTH, HARD, NONABSORBENT SURFACE OVER A MOISTURE RESISTANT UNDERLAYMENT TO A HEIGHT OF 72 INCHES ABOVE THE DRAIN INLET

: INDICATES NEW WINDOWS U-FACTOR MAX. 0.30 SHGC MAX. 0.23

MAX 44" SILL HEIGHT ABOVE F.F. MIN 5.7 SF. NET CLEAR OPENING AREA EXCEPT: GRADE FLOOR OPENING NOT > 44" ABOVE OR BELOW FINISHED GRADE LEVEL CAN BE MIN 5.0 SF. MIN 24" NET CLEAR OPENING HEIGHT MIN 20" NET CLEAR OPENING WIDTH

LEGENDS:

: INDICATES EXIST. WALL

: INDICATES NEW 2X4 STUD WALL

: INDICATES NEW WALL

: INDICATES (E) WALL TO BE REMOVED

3-6X4-10 (E) WINDOW W/SIZE INDICATION: 3'-6"W x 4'-10"H

NEW WINDOW W/SIZE INDICATION: 6'-0"W x 4'-6"H

TEMPERED GLAZE

: INDICATES SHOWER AND TUB/SHOWER WALLS

INDICATES EGRESS WINDOWS

SKYLIGHTS INSTALLED IN A ROOF WITH A PITCH FLATTER THAN 3:12 SHALL BE MOUNTED ON A CURB EXTENDING NOT LESS THAN 4 INCHES ABOVE THE ROOF UNLESS OTHERWISE SPECIFIED IN THE MANUFACTURER'S INSTALLATION INSTRUCTIONS PER CRC R308.6.8

JURISDICTION APPROVAL STAMP

Exp. 6-30-25 **GHY CONSULTING ENGINEERS** STRUCTURAL ENGINEERING

D RENOVATION RESIDENCE

ENGINEERS

CONSULTING

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GARY YU, PE

PLAN

FLOOR PROPOSED

LN 95124 ROOM ADDI HSU & LU' 14361 LENI SAN JOSE,


REVISION NOTES

PO 02-23-24 PLANING REVIEW 0 04-08-24 BUILDING REVIEW PLAN CHECK 08-26-24 COMMENTS

> DATE REVISION

SCALE: AS NOTED DRAWN BY: GHY

DWG. NO. A3.0

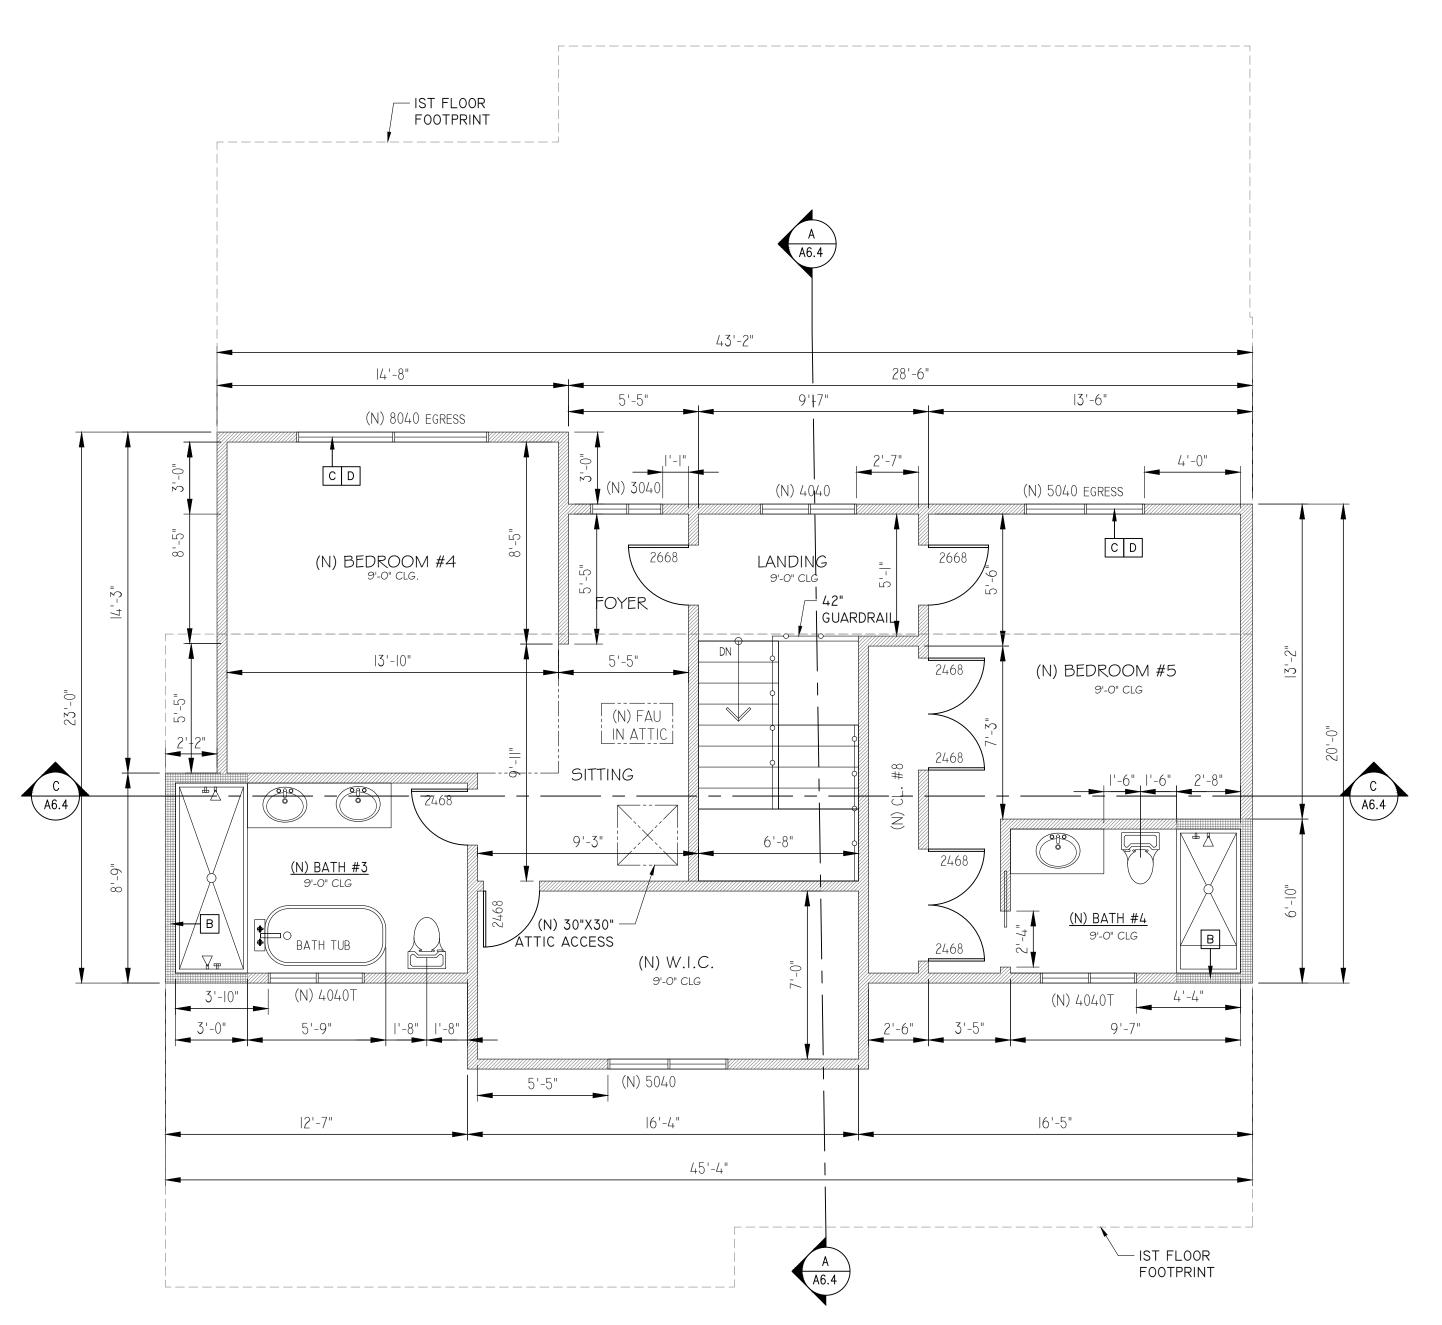

PROPOSED SECOND FLOOR PLAN SCALE: 1/4"=1'-0"

LEGENDS:

: INDICATES NEW 2X6 STUD WALL

: INDICATES NEW WALL

∑ = ∃ : INDICATES (E) WALL TO BE REMOVED

6046

NEW WINDOW W/SIZE INDICATION: 6'-0"W x 4'-6"H

: SLIDING DOOR

: INDICATES \(\frac{5}{8} \) THK. TYPE X GYP. BD. ONE-HOUR FIRE-RESISTANCE FIRE SEPARATION WALL. EXTEND FROM FOOTING TO THE UNDERSIDE OF ROOF SHEATHING. SEE

: INDICATES SHOWER AND TUB/SHOWER WALLS TO HAVE A SMOOTH, HARD, NONABSORBENT

UNDERLAYMENT TO A HEIGHT OF 72 INCHES ABOVE THE DRAIN INLET

U-FACTOR MAX. 0.30 SHGC MAX. 0.23

MIN 24" NET CLEAR OPENING HEIGHT MIN 20" NET CLEAR OPENING WIDTH

JURISDICTION APPROVAL STAMP

: INDICATES EXIST. WALL

: INDICATES NEW 2X4 STUD WALL

∑⊟∃⇒ : INDICATES (E) WINDOW TO BE REMOVED

(E) WINDOW W/SIZE INDICATION: 3'-6"W x 4'-10"H

DOOR W/SIZE INDICATION: 2'-4"W x 6'-8"H

: TEMPERED GLAZE : SINGLE HUNG WINDOW

SECTIONS FOR WALL ASSEMBLY DETAILS.

SURFACE OVER A MOISTURE RESISTANT

: INDICATES NEW WINDOWS

: INDICATES EGRESS WINDOWS MAX 44" SILL HEIGHT ABOVE F.F. MIN 5.7 SF. NET CLEAR OPENING AREA EXCEPT: GRADE FLOOR OPENING NOT > 44" ABOVE OR BELOW FINISHED GRADE LEVEL CAN BE MIN 5.0 SF.

GHY CONSULTING ENGINEERS STRUCTURAL ENGINEERING GARY YU, PE

(510)

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ENGINEERS

CONSULTING

D RENOVATION RESIDENCE

PLAN FLOOR

REVISION NOTES


PO 02-23-24 PLANING REVIEW 0 04-08-24 BUILDING REVIEW REVISION DATE

SCALE: AS NOTED

DWG. NO.


DRAWN BY: GHY

A3.1

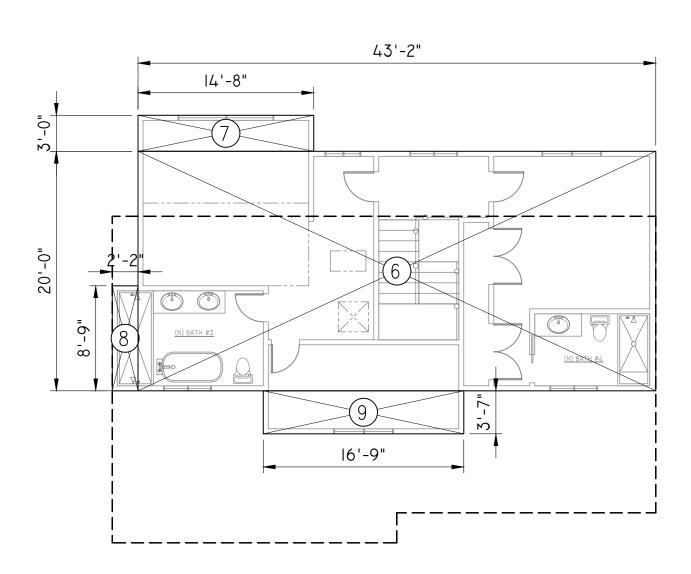

2nd FLOOR FLOOR AREA DIAGRAM SCALE: 1/8"=1'-0"

FLOOR AREA CALCS				
ITEM	BLOCK	LENGTH (FT)	WIDTH (FT)	AREA (SQ. FT.)
(E) 1ST FLOOR	1	23.8	2.5	59.4
	2	45.3	24.8	1122.0
(E) 1ST FLOOR AREA	A0			1181.4
1ST FLOOR ADDITION	3	43.2	13.3	572.0
	4	42.9	7.3	314.7
	5	28.8	4.0	115.0
TOTAL 1ST ADDITION AREA	A1			1001.7
2ND FLOOR ADDITION	6	43.2	20.0	863.3
	7	14.7	3.0	44.0
	8	8.8	2.2	19.0
	9	16.8	3.6	60.0
TOTAL 2ND ADDITION AREA	A2			986.3
PROPOSED ADDITION AREA	A1 + A2			1988.0
TOTAL PROPOSED FLOOR AREA	A0 + A1 + A2			3169.4
DEMO (E) GARAGE AREA	10	20.3	20.1	406.7
NEW GARAGE	11	20.8	18.8	392.4
	12	3.4	0.4	1.4
TOTAL NEW GARAGE	A3			393.8
ENTRY PORCH	13	21.2	4.8	102.3
	14	1.4	0.4	0.6
	15	2.3	0.8	1.9
TOTAL ENTRY PORCH	A4			104.8
(E) WORKSHOP AREA	16	36.8	20.2	742.0
TOTAL FLOOR AREA	A0 + A1 + A2 + A3			3563.2
NET LOT AREA				10863
MAX F.A.R. (50% OF LOT AREA)			50%	5431.5
FLOOR AREA RATIO				32.8%
				(OK)

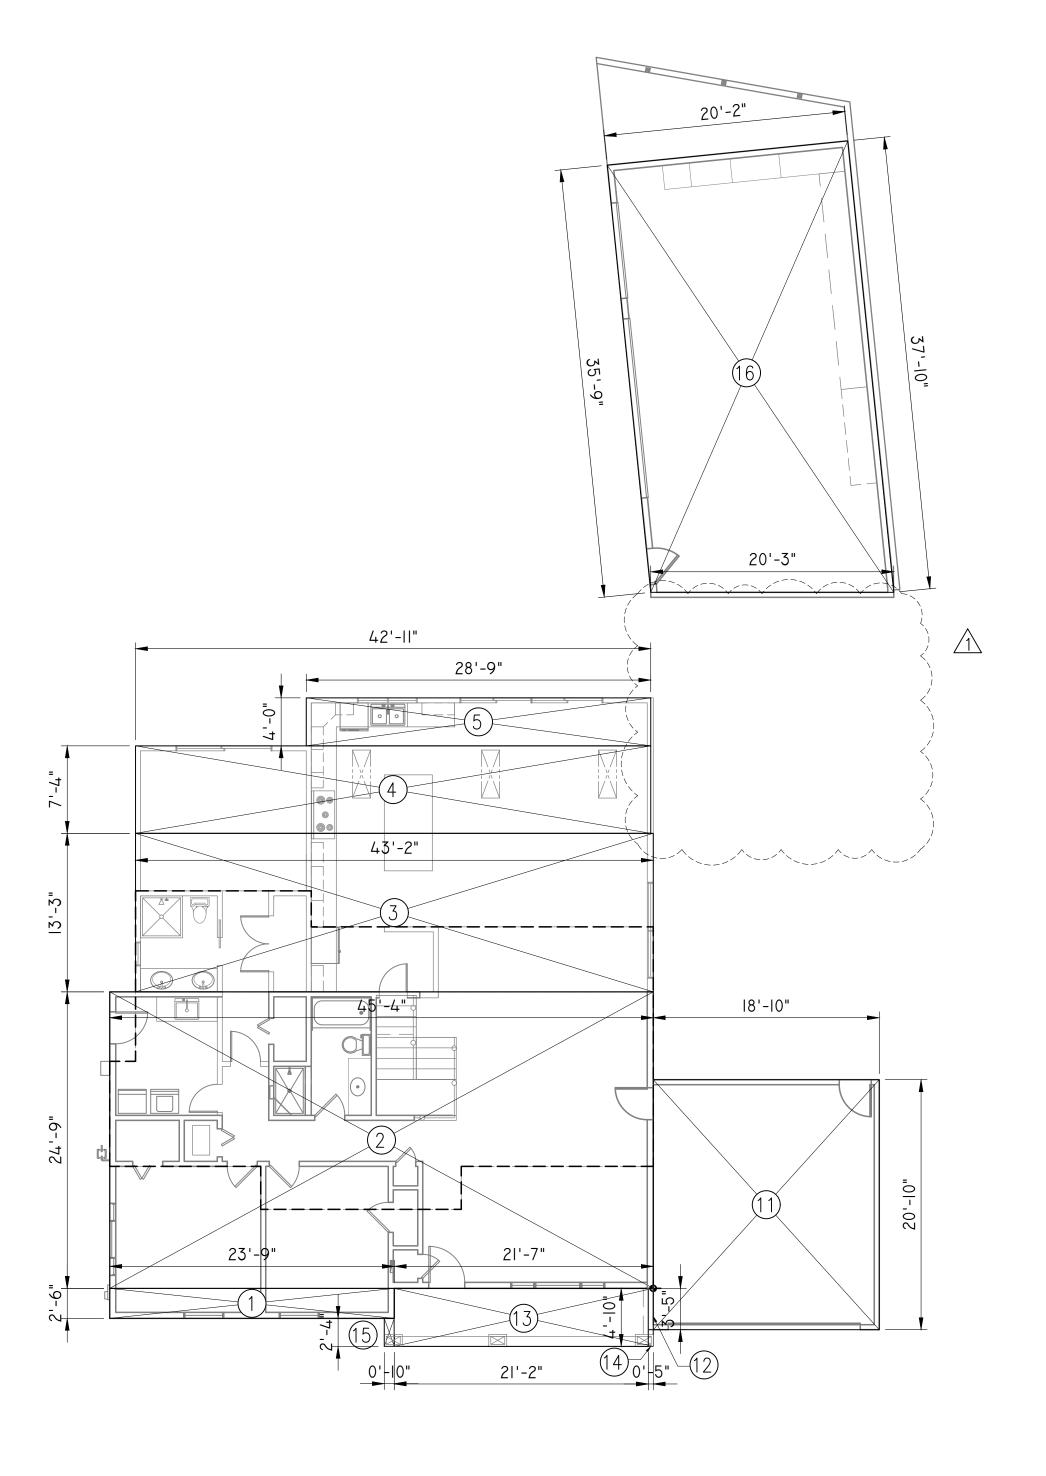

1st FLOOR
FLOOR AREA DIAGRAM
SCALE: 1/8"=1'-0"

JURISDICTION APPROVAL STAMP

HY CONSULTING ENGINEERS, INC. 720 GILROY CT., UNION CITY, CA 94587

10) 299-6194 Email: ghvengineer@gmail.com

No: C67655
Exp. 6-30-25

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GHY CONSULTING ENGINEERS

STRUCTURAL ENGINEERING
GARY YU, PE

ROOM ADDITIONS AND RENOVATION HSU & LU'S FAMILY RESIDENCE 14361 LENRAY LN SAN JOSE, CA 95124
FLOOR AREA DIAGRAM

REVISION NOTES

PO 02-23-24 PLANING REVIEW

0 04-08-24 BUILDING REVIEW

1 08-15-24 PLAN CHECK COMMENTS

NO DATE REVISION

SCALE: AS NOTED

DRAWN BY: GHY

DWG. NO. A4.0


ROOF SPECIFICATIONS:

- I. SPECIFICATION: ROOFING MATERIAL TO MATCH EXISTING.
- 2. UNDERLAYMENT: 2 LAYERS OF 30 LBS FELT OR BETTER APPLICATION: PER MANUFACTURES WRITTEN SPECIFICATIONS
- 3. FIRE REQUIREMENT: ROOF SHALL BE FIRE STOPPED TO PRECLUDE ENTRY OF FLAME OR EMBERS UNDER ROOF COVERING.
- 4. MIN. UNDERLAYMENT REQUIREMENT SHOULD BE TWO 30 POUND FELTS, BLIND NAILED 18" FOR SLOPES GREATER THAN 3/12 NO INTERPLAY ASPHALT SHOULD BE NECESSARY.
- 5. ROOFING CONTRACTOR SHALL VERIFY THE ABOVE SPECIFICATIONS WITH ROOFING MANUFACTURER'S WRITTEN SPECIFICATIONS.

ROOF NOTES:


- ROOF PITCH, SLOPE 4 IN 12 AND VARIES TO BE VERIFIED IN FIELD.
- PROVIDE VALLEY FLASHING PER 2022 CRC;
- PROVIDE FLASHING AT JUNCTION BETWEEN ROOFS & WALLS PER 2022 CRC;
- INSTALL RADIANT BARRIER ON THE WARM SIDE OF ALL THE ATTIC/CEILING INSULATION.

			NEW 2ND FLOOR	ATTIC VENT CALCULATIONS		
ITEM	VENTILATION TYPE	ATTIC VENT CALCS (R806)	NEW ROOF DATA	(N) ROOF ATTIC AREA	X 144 SQ. IN	ATTIC VENT REQUIRED DEVIDED BY 150
(1)	NEW			986 (SQ. FT.)	141984 (SQ. IN.)	947 (SQ. IN.)
	2" DIA. VENT HOLE	RAFTER BLOCK'G LENGTH	VENT HOLE SPACING	NO. OF BLK'G	(3)-2" VENT HOLE/NFVA	TOTAL VENT HOLE NFVA
(2)		71.0 (FT)	4.0 (FT)	18	9.42 (SQ. IN.)	170 (SQ. IN.)
	GABLE LOUVER VENT	MAKE/MODEL	SIZE	NO. OF LOUVER	LOUVER NFVA	TOTAL LOUVER NFVA
(3)		GIBRALTAR	14"X24"	4	147 (SQ. IN.)	588 (SQ. IN.)
	EYEBROW VENT MODEL	SIZE	NFVA	NO. OF HIGH VENT	NO. OF LOW VENT	TOTAL EYEBROW NFVA
(4)	O'HAGIN-TAPERED	LOW-PROFILE	72	2	2	288 (SQ. IN.)
(5)	TOTAL VENT PROVIDED				(5) = (2) + (3) + (4)	1046 (SQ. IN.)
	*NFVA =	NET FREE VENTILATION AREA			(5) > = (1)	(OK)
			NEW GARAGE A	TTIC VENT CALCULATIONS		
ITEM	VENTILATION TYPE	ATTIC VENT CALCS (R806)	NEW ROOF DATA	(N) ROOF ATTIC AREA	X 144 SQ. IN	ATTIC VENT REQUIRED DEVIDED BY 150
(1)	NEW			394 (SQ. FT.)	56736 (SQ. IN.)	378 (SQ. IN.)
	2" DIA. VENT HOLE	RAFTER BLOCK'G LENGTH	VENT HOLE SPACING	NO. OF BLK'G	(3)-2" VENT HOLE/NFVA	TOTAL VENT HOLE NFVA
(2)		38.0 (FT)	4.0 (FT)	10	9.42 (SQ. IN.)	94 (SQ. IN.)
	GABLE LOUVER VENT	MAKE/MODEL	SIZE	NO. OF LOUVER	LOUVER NFVA	TOTAL LOUVER NFVA
(3)		GIBRALTAR	14"X24"	1	147 (SQ. IN.)	147 (SQ. IN.)
	EYEBROW VENT MODEL	SIZE	NFVA	NO. OF HIGH VENT	NO. OF LOW VENT	TOTAL EYEBROW NFVA
(4)	O'HAGIN-TAPERED	LOW-PROFILE	72	1	1	144 (SQ. IN.)
(5)	TOTAL VENT PROVIDED				(5) = (2) + (3) + (4)	385 (SQ. IN.)
	*NFVA =	NET FREE VENTILATION AREA			(5) >= (1)	(OK)
NOTE:	ANY EXISTING VENTS BLOCKED	BY THE ADDITION SHALL BE	PROVIDED IN KIND	AT THE NEW STRUCTURE.		

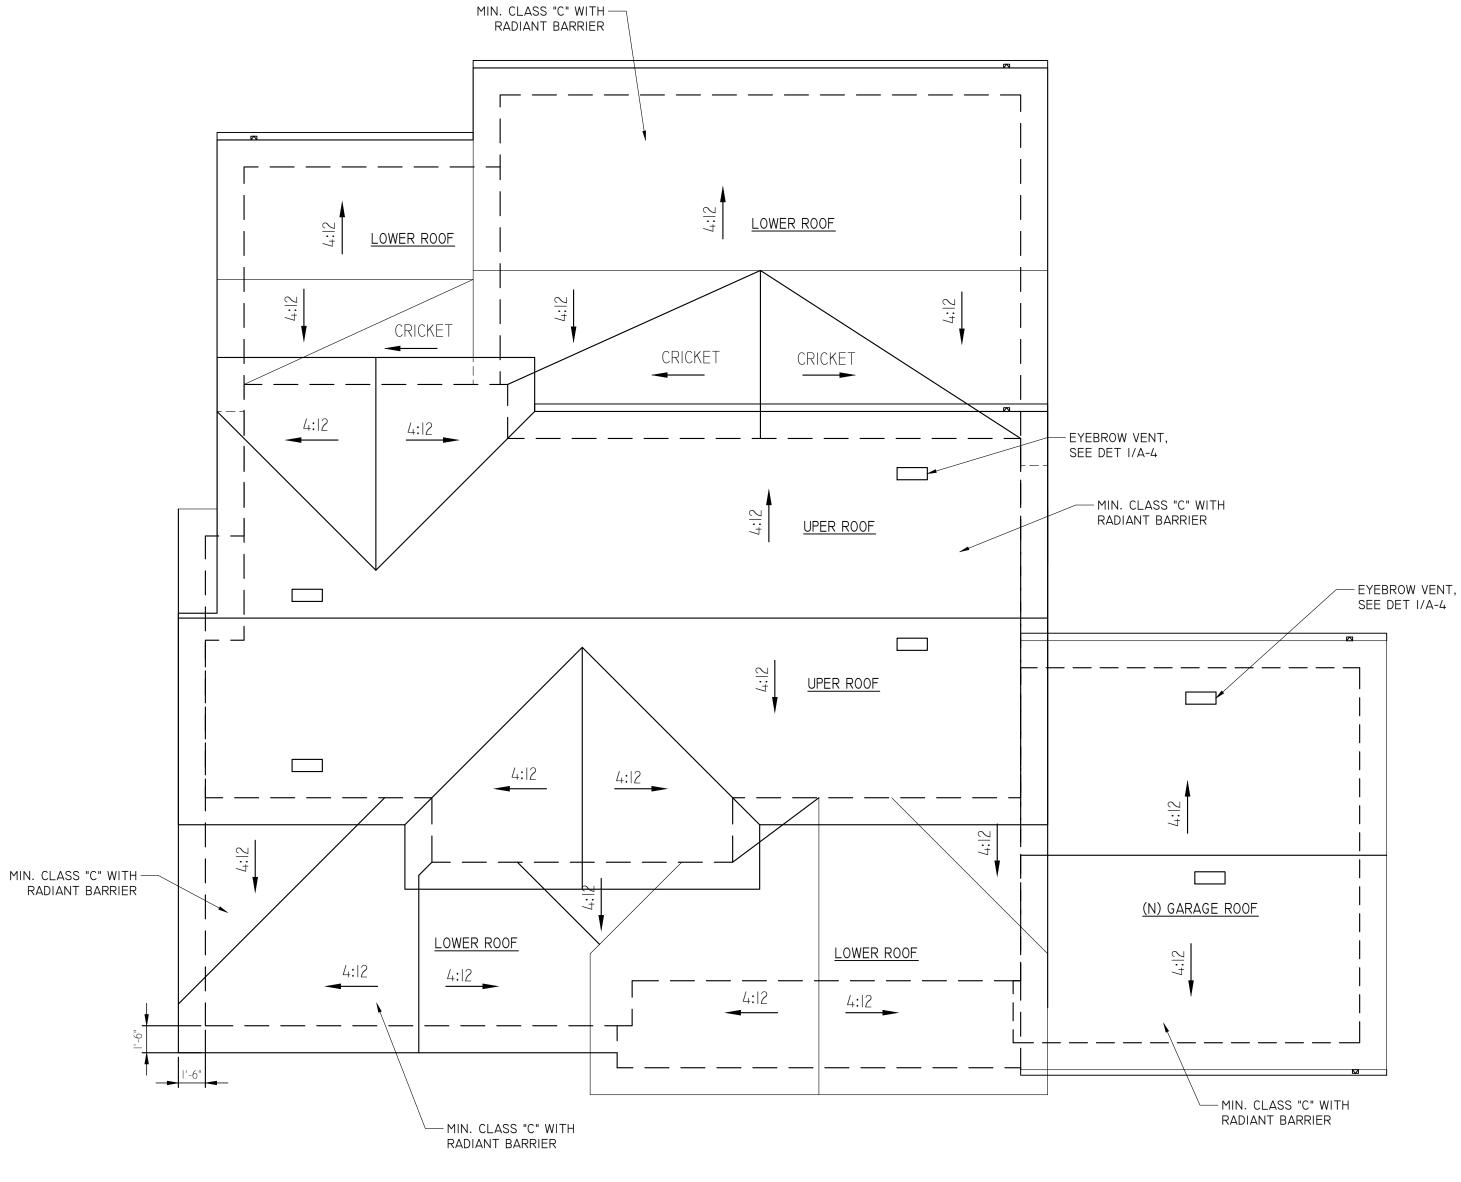

PROPOSED ROOF PLAN

SCALE: 3/16"=1'-0"

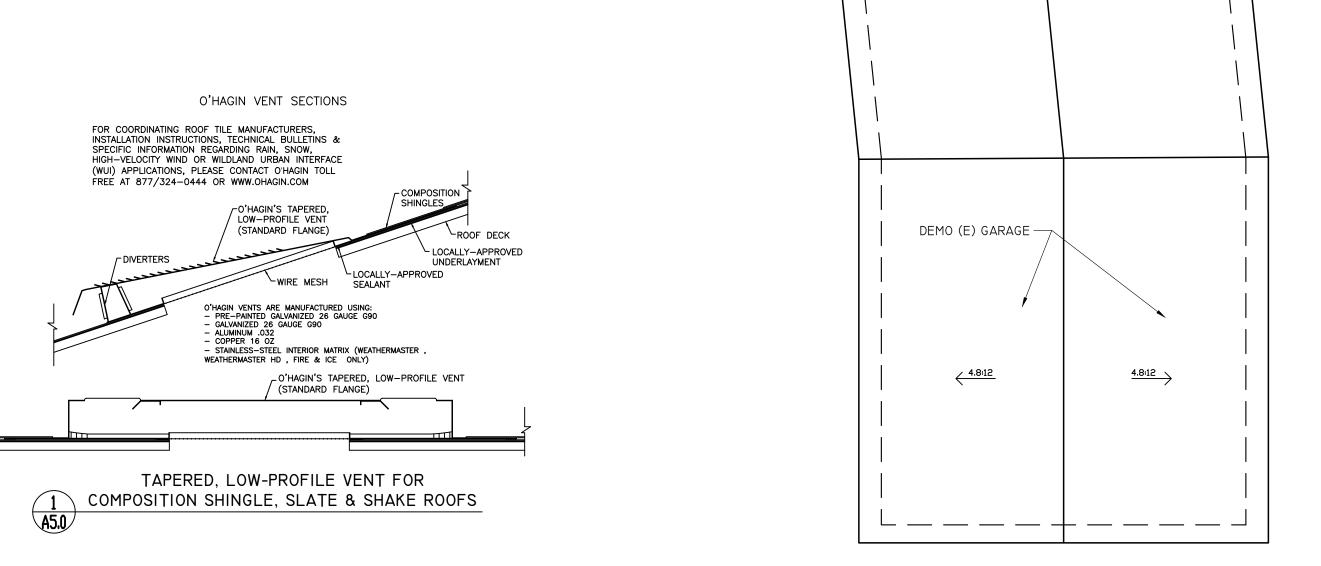


(E) WORK ROOF -TO REMAIN

. _ _ _ + _ _ _ _

4.8:12


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DETACHED GARAGE

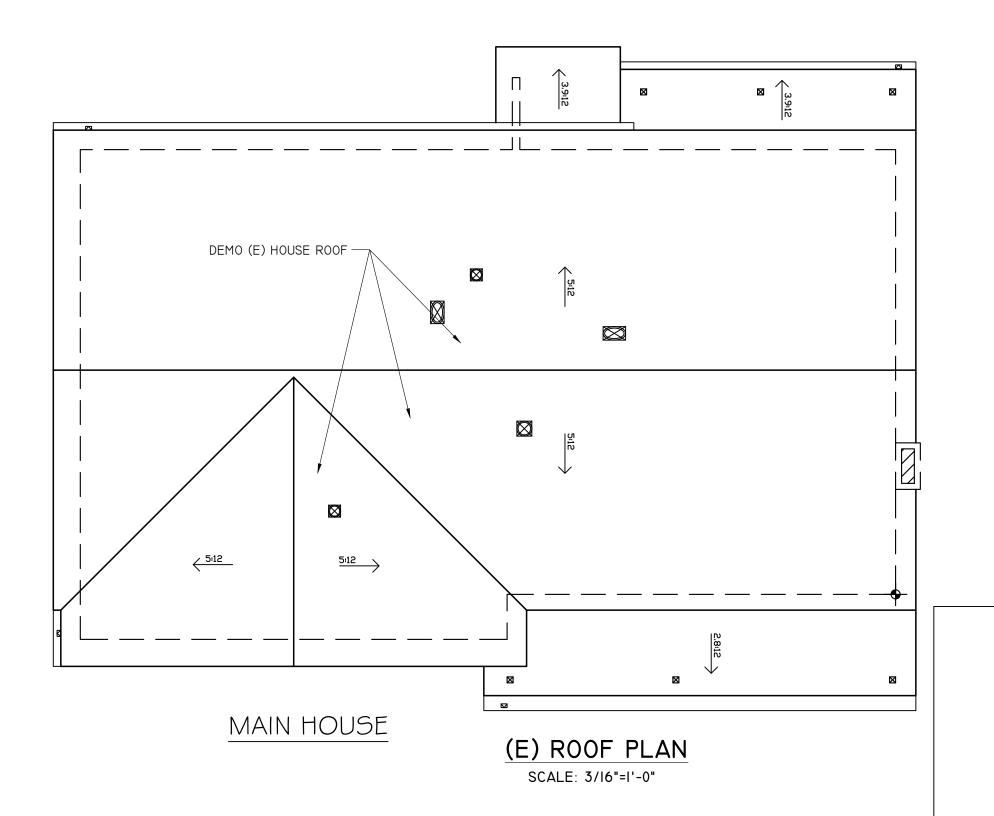

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GHY CONSULTING ENGINEERS STRUCTURAL ENGINEERING GARY YU, PE

ROOM ADDITIONS AND RENOVATION HSU & LU'S FAMILY RESIDENCE 14361 LENRAY LN SAN JOSE, CA 95124 ROOF PROPOSED

REVISION NOTES PO 02-23-24 PLANING REVIEW

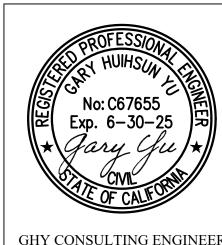0 04-08-24 BUILDING REVIEW REVISION DATE

SCALE: AS NOTED DRAWN BY: GHY

DWG. NO. A5.0 (E) FRONT ELEVATION


SCALE: 1/4"=1'-0"

EAST

PL. HT. 2812

(E) RIGHT ELEVATION
SCALE: 1/4"=1'-0"


NORTH

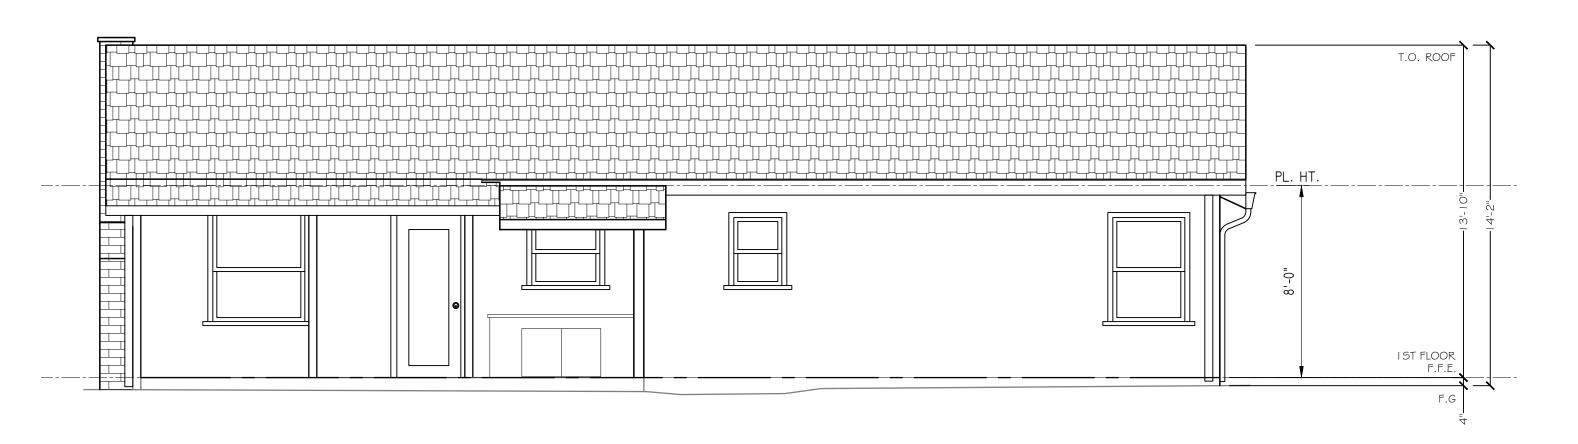

(E) REAR ELEVATION

SCALE: 1/4"=1'-0"

WEST

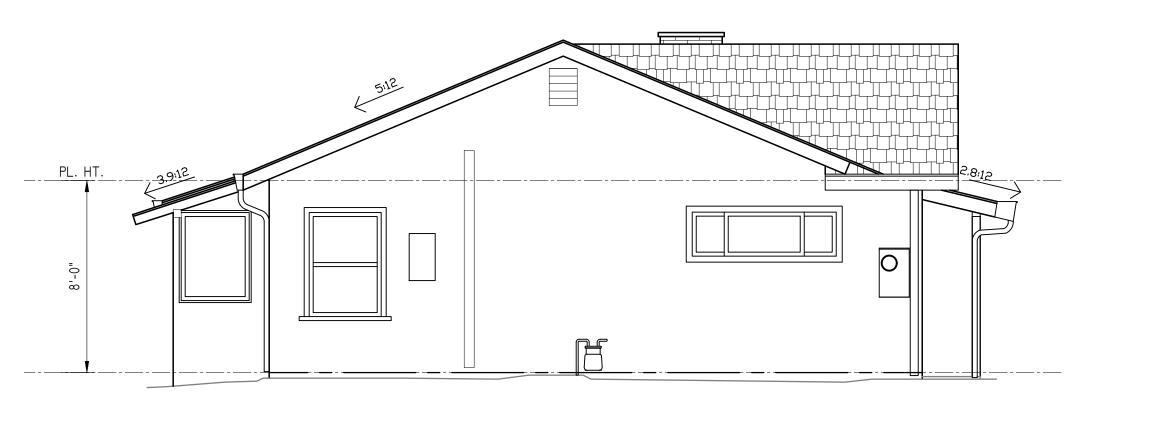

(E) LEFT ELEVATION
SCALE: 1/4"=1'-0"

SOUTH

JURISDICTION APPROVAL STAMP

REVISION NOTES

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PO 02-23-24 PLANING REVIEW


0 03-22-24 BUILDING REVIEW


NO DATE REVISION

SCALE: AS NOTED


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DWG. NO.




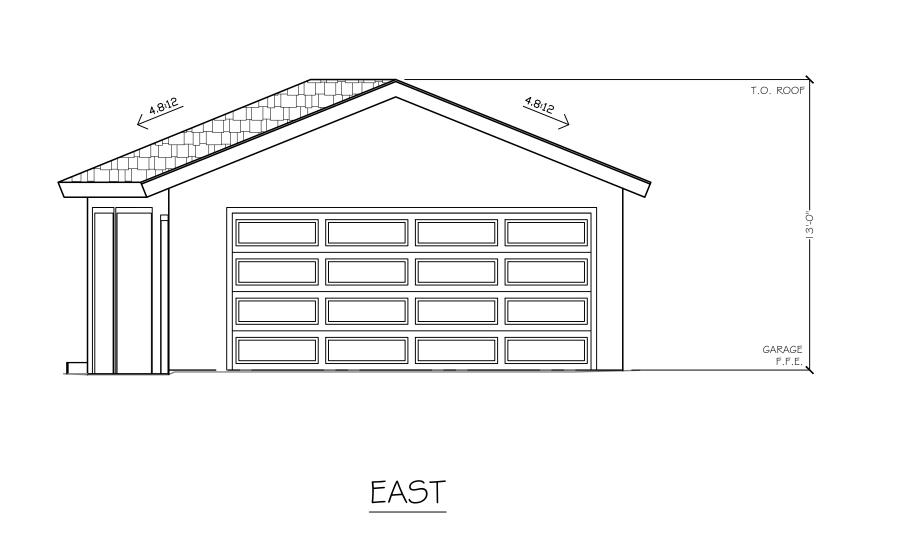

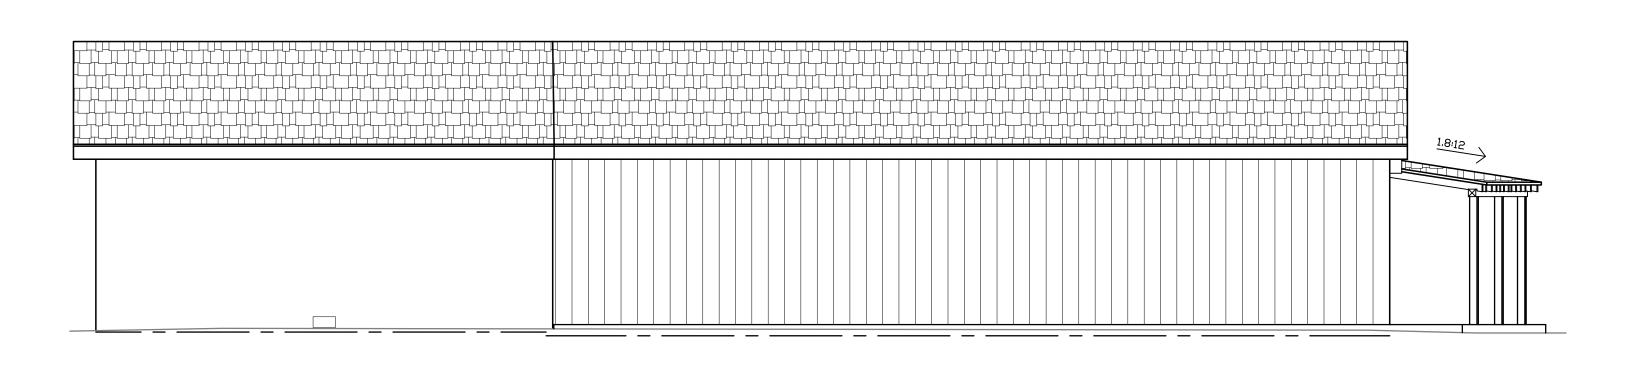NORTH

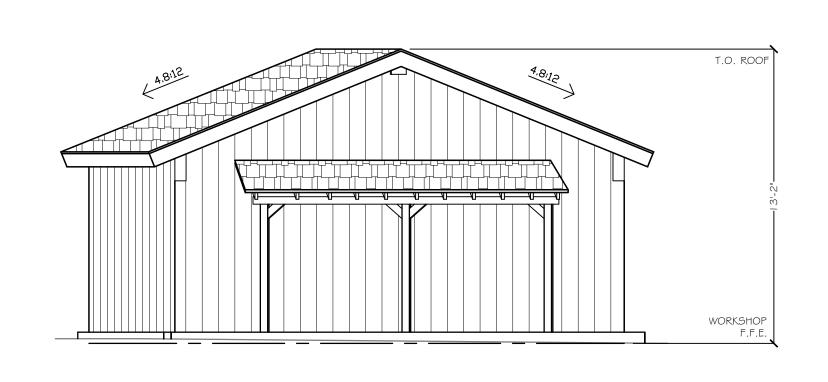

WEST

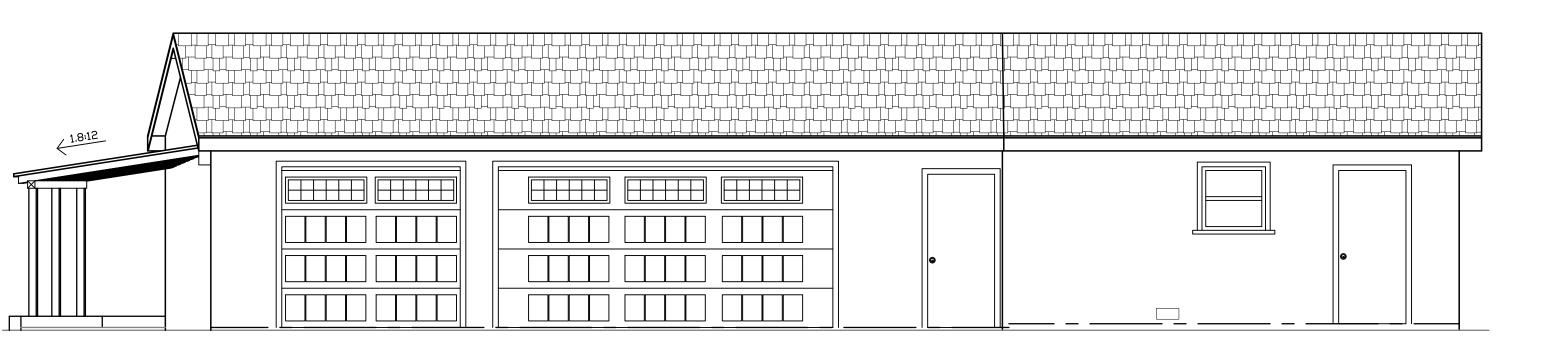

SOUTH

JURISDICTION APPROVAL STAMP

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STRUCTURAL ENGINEERING GARY YU, PE

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ROOM ADDITIONS AND RENOVATION HSU & LU'S FAMILY RESIDENCE 14361 LENRAY LN SAN JOSE, CA 95124

REVISION NOTES

PO 02-23-24 PLANING REVIEW 0 03-22-24 BUILDING REVIEW

SCALE: AS NOTED DRAWN BY: GHY

REVISION


DWG. NO.

DATE

PROPOSED FRONT ELEVATION

SCALE: 1/4"=1'-0"

EAST

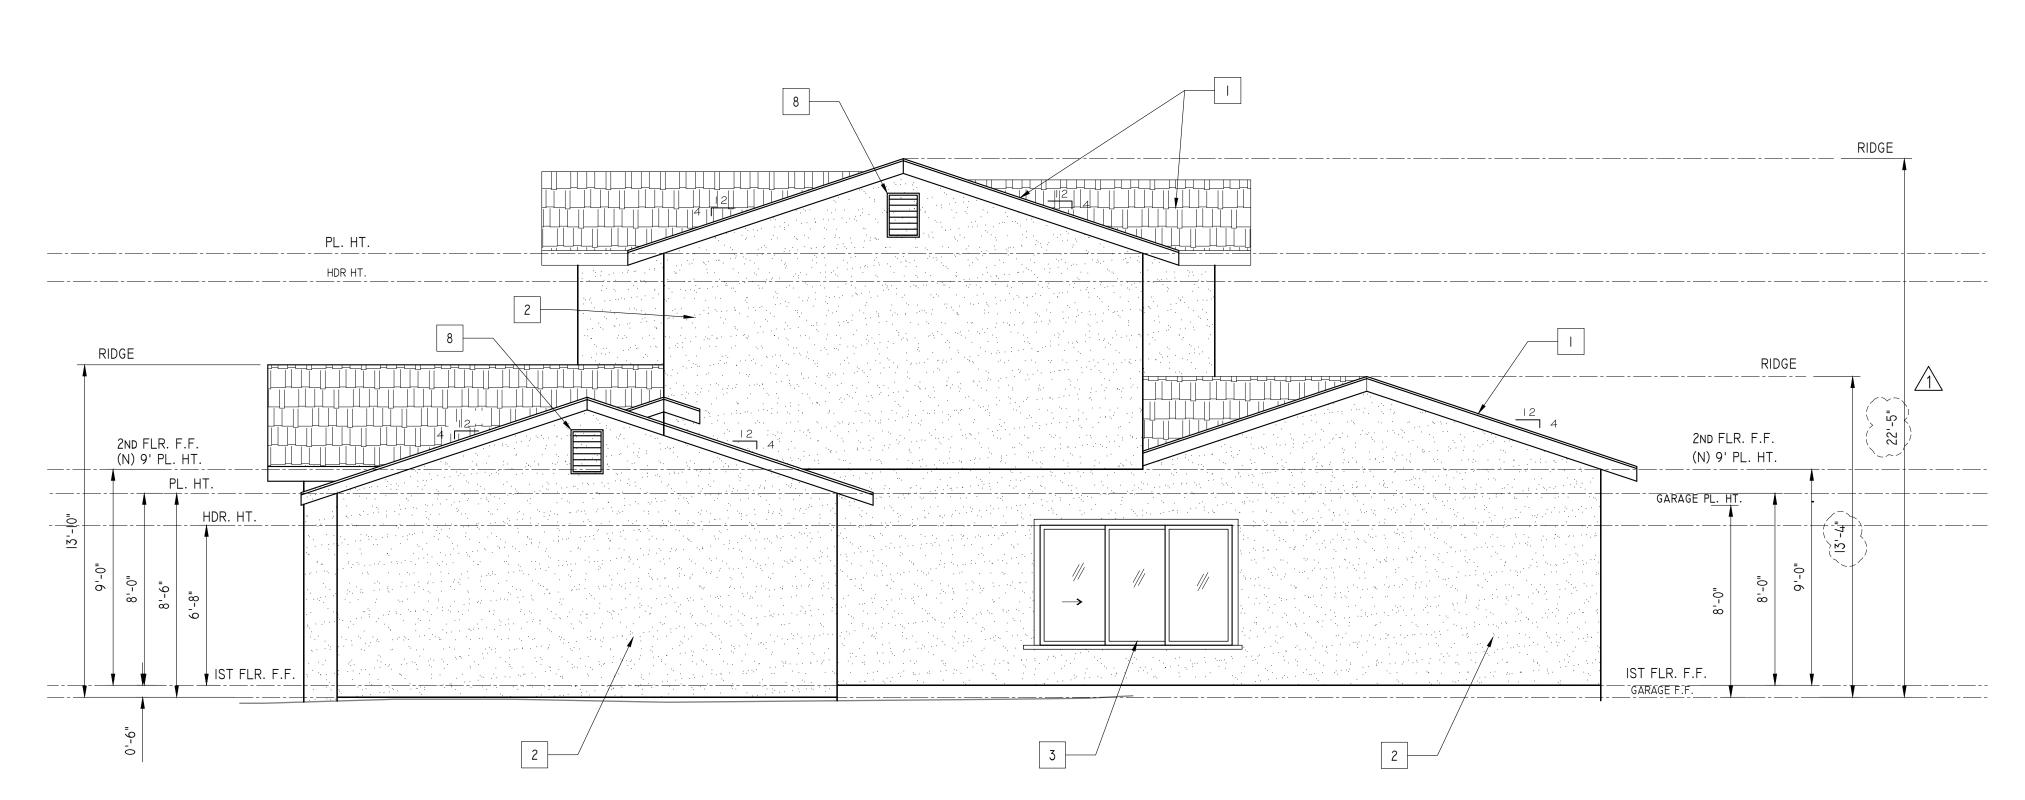

PROPOSED RIGHT ELEVATION SCALE: 1/4"=1'-0"

NORTH

- COMPOSITE ROOF SHINGLE TO MATCH EXISTING (N) COMPOSITE SHINGLE ROOF WITH DOUBLE LAYER 30# FELT UNDER ROOFING MATERIAL.
- ALL EXTERIOR MATERIAL FOR THE NEW ADDITION TO MATCH THE EXTERIOR OF THE EXISTING DWELLING.
 - PROVIDE: a. STUCCO, 3—COAT, 7/8—INCH MINIMUM THICK b. PROVIDE 26 GAUGE GALVANIZED WEEP SCREED AT FOUNDATION PLATE LINE AT LEAST 4" ABOVE GRADE (OR
 - 2" ABOVE CONCRETE OR PAVING) c. TWO LAYERS OF GRADE D PAPER UNDER STUCCO OVER PLYWOOD SHEATHING.

JURISDICTION APPROVAL STAMP

- 3 VINYL FRAME WINDOWS WITH DUAL PANE GLAZING.
- 4 SOLID CORE WOOD SWING ENTRY DOOR.
- TEMPERED GLASS DOOR
- HOME ADDRESS NUMBER SHALL BE MINIMUM 4 INCHES HIGH WITH MINIMUM STROKE WIDTH OF ½" INCH AND SHALL CONTRAST WITH THE BACKGROUND. CRC R319
- 7 WALL MOUNTED LIGHT W/ MOTION SENSOR CONTROL
- 8 14"X24" METAL LOUVER VENT
- 9 SKYLIGHT

SHEET NOTES:

- . "EMERGENCY ESCAPE AND RESCUE OPENING SHALL MEET THE CALIFORNIA FIRE CODE CHAPTER 10 SECTION 1030.
- 2. EMERGENCY ESCAPE AND RESCUE OPENINGS SHALL OPEN DIRECTLY INTO PUBLIC WAY OR TO A YARD OR COURT THAT OPENS TO A PUBLIC WAY.
- 3. MINIMUM OF 5.7 SQUARE FEET OF NET CLEAR OPENING WITH A MINIMUM DIMENSION OF 24" IN HEIGHT AND 20" IN WIDTH. THE NET CLEAR OPENING DIMENSION SHALL BE THE RESULT OF NORMAL OPERATION OF THE OPENING. THE BOTTOM OF THE CLEAR OPENING SHALL NOT BE GREATER THAN 44" MEASURED FORM THE FLOOR.

ELEVATION KEY NOTES:

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Exp. 6-30-25

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GHY CONSULTING ENGINEERS STRUCTURAL ENGINEERING

GARY YU, PE

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PROPOSED

REVISION NOTES PO 02-23-24 PLANING REVIEW 0 04-08-24 BUILDING REVIEW

PLAN CHECK COMMENTS DATE REVISION

SCALE: AS NOTED DRAWN BY: GHY

DWG. NO.

PROPOSED REAR ELEVATION

SCALE: 1/4"=1'-0"


WEST

ELEVATION KEY NOTES:

- COMPOSITE ROOF SHINGLE TO MATCH EXISTING (N) COMPOSITE SHINGLE ROOF WITH DOUBLE LAYER 30# FELT UNDER ROOFING MATERIAL.
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- 5 TEMPERED GLASS DOOR
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- 8 14"X24" METAL LOUVER VENT
- 9 SKYLIGHT


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PROPOSED LEFT ELEVATION SCALE: 1/4"=1'-0"

SOUTH

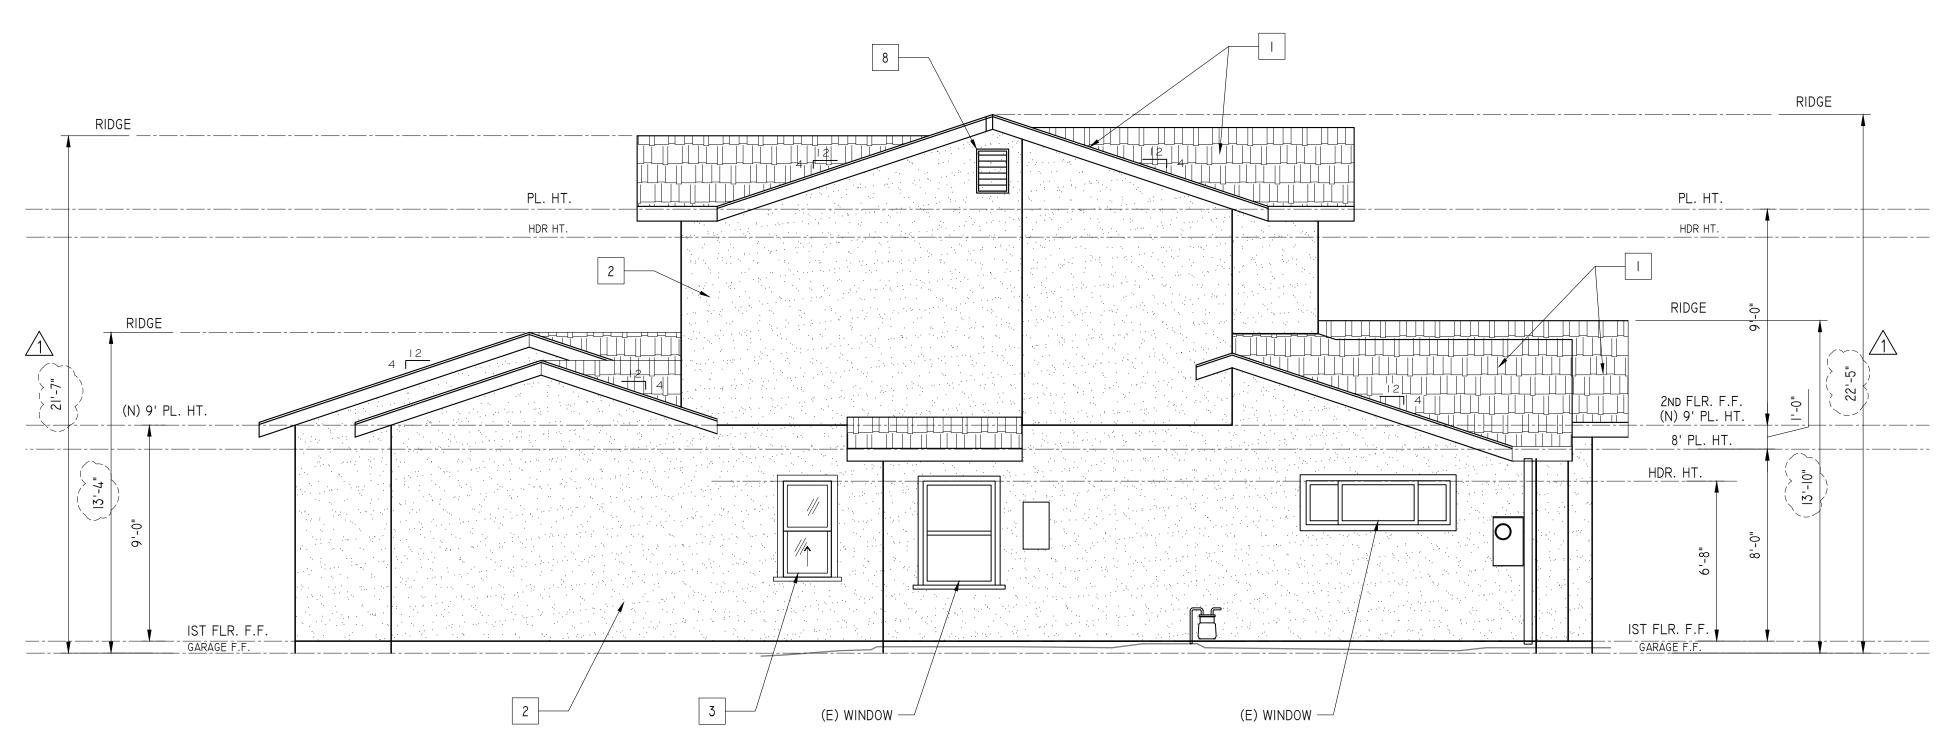

JURISDICTION APPROVAL STAMP

DATE REVISION

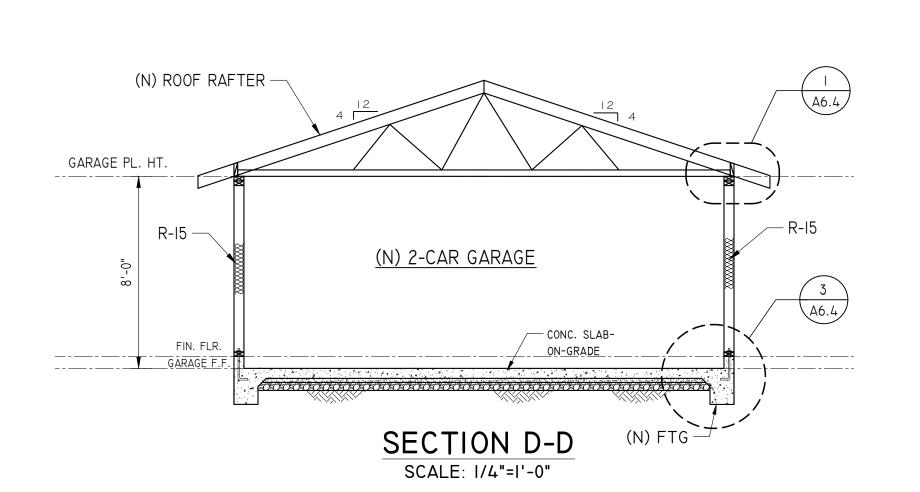REVISION NOTES

P0 02-23-24 PLANING REVIEW

0 04-08-24 BUILDING REVIEW

PLAN CHECK COMMENTS

SCALE: AS NOTED DRAWN BY: GHY

DWG. NO. A6.3

D RENOVATION RESIDENCE

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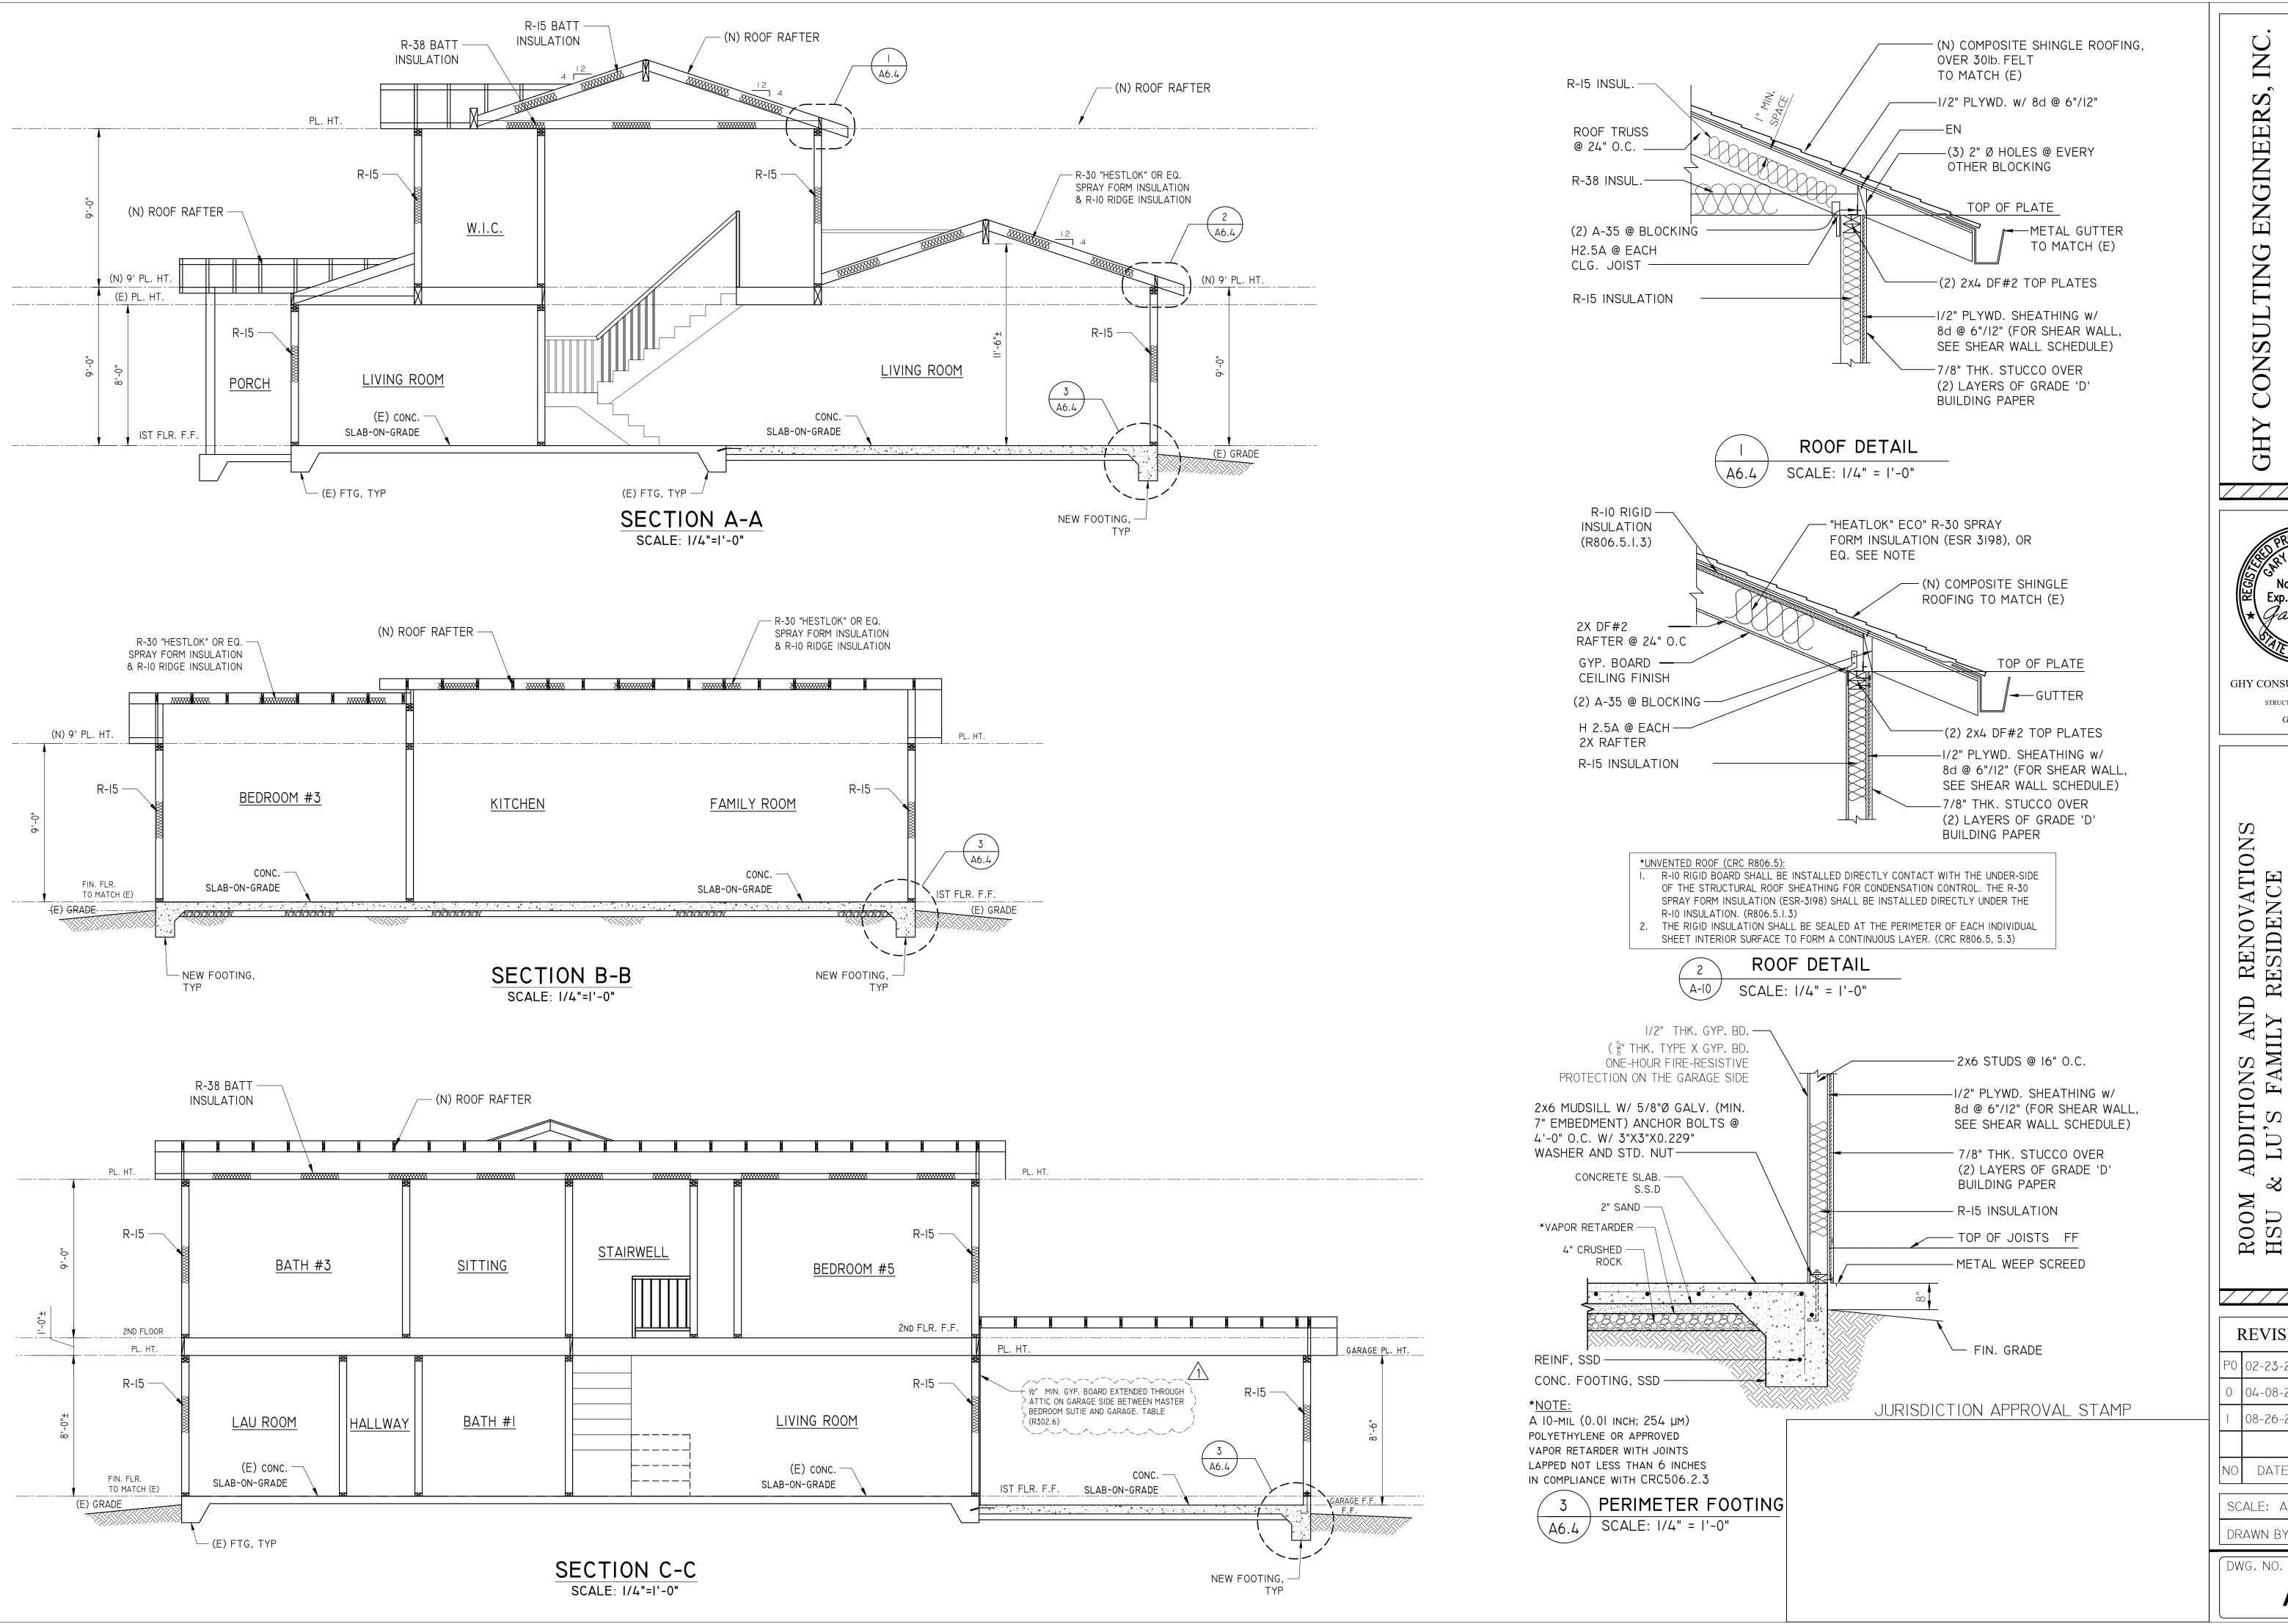
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ELEVATIONS EXTERIOR PROPOSED



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Exp. 6-30-25**GHY CONSULTING ENGINEERS** STRUCTURAL ENGINEERING

GARY YU, PE

D RENOVATION RESIDENCE M ADDITIONS AND

& LU'S FAMILY R

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JOSE, CA 95124 DETAILS SECTIONS ROOM HSU 2 14361 SAN J

REVISION NOTES P0 02-23-24 PLANING REVIEW 0 04-08-24 BUILDING REVIEW PLAN CHECK 1 08-26-24 COMMENTS

DATE REVISION SCALE: AS NOTED

DRAWN BY: GHY

